



Revision	Description	Date
5		
4		
3		
2	ISSUED FOR CONSTRUCTION	2017/06/09
1	99% CONSTRUCTION DOCUMENT	2017/03/27
0	50% CONSTRUCTION DOCUMENT	2017/02/17

**CORRECTIONAL SERVICES CANADA**  
SASKATOON, SASKATCHEWAN


Project title: **Correctional Service Canada (CSC) Regional Psychiatric Centre**

**Kitchen/Dining Renovations**

Designed by: **TS** / Conçu par  
Drawn by: **CB/JL** / Dessiné par  
Approved by: **SS** / Approuvé par  
PWSSC Project Manager: **BRET WARD** / Administrateur de Projets TPSOC


**PARTIAL KITCHEN/DINING AREA CONSTRUCTION PLAN, LEGENDS, DOOR HARDWARE AND INTERIOR ELEVATIONS**

Project no./No. du projet	Drawing no./No. du dessin	Revision no.
<b>R.079453.001</b>	<b>A1</b>	<b>2</b>

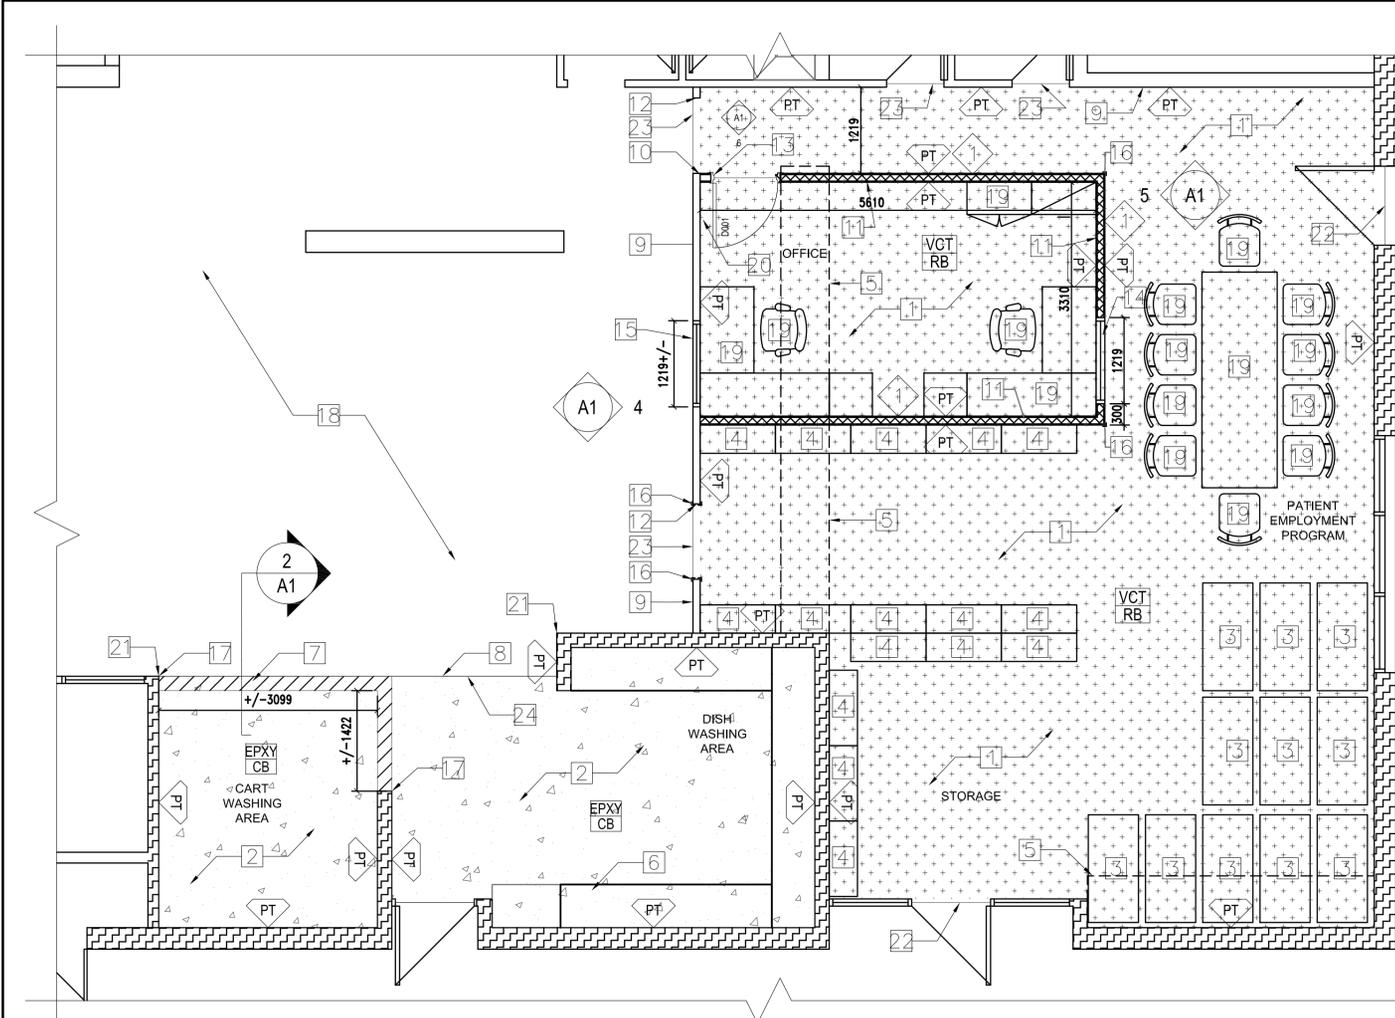

**1 KITCHEN PLAN**  
A1 SCALE 1:50


**WALL TYPES**

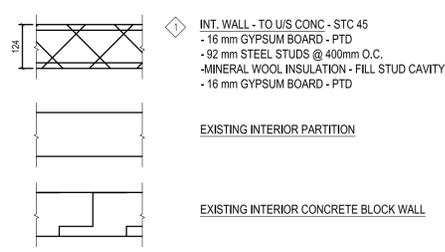

**DEMOLITION GENERAL NOTES:**

- REMOVE ALL WALL MOUNTED ITEMS MOUNTED ON WALLS TO BE DEMOLISHED AND OFFER TO DEPARTMENTAL REPRESENTATIVE FOR FIRST RIGHT OF REFUSAL.
- REMOVE FLOORING AND BASE THROUGHOUT AREA OF RENOVATION UNLESS OTHERWISE INDICATED; REMOVE ADHESIVES AND ANY RESIDUE TO PROVIDE CLEAN SURFACE PRIOR TO NEW FLOORING INSTALL.
- PROTECT ALL SURFACES, SYSTEMS, AND EQUIPMENT FROM DAMAGE, DEBRIS, AND DUST THROUGHOUT DEMOLITION AND CONSTRUCTION.
- PROTECT EXISTING FIRE PROTECTION OF STRUCTURAL STEEL THROUGHOUT DEMOLITION AND CONSTRUCTION.

**DRAWING LEGEND:**

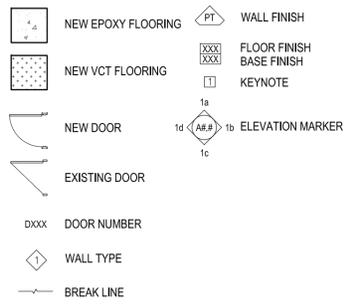


**GENERAL NOTES:**

- REFER TO KITCHEN PLAN FOR WALL FINISHES.
- DIMENSIONS TO FACE OF FINISHED GWB UNLESS OTHERWISE INDICATED.
- ALL ACOUSTICALLY INSULATED WALLS TO EXTEND TO THE UNDERSIDE OF THE FLOOR STRUCTURE OR DECK ABOVE UNLESS OTHERWISE NOTED. PROVIDE FOAM DAMPENING AT RUN OF HEADER AND FOOTER STUD. SEAL WITH ACOUSTIC CAULKING AT PERIMETER ON BOTH SIDES AND AT ALL PENETRATIONS. REFER TO DETAILS AND REFLECTED CEILING PLANS.
- ACOUSTICALLY SEPARATE BACK TO BACK ELECTRICAL BOXES THAT CANNOT BE SEPARATED BY A MIN. 600mm, BY ATTACHING A DOUBLE LAYER OF 16mm GWB TO SIDE OF STUD FROM FLOOR TO 1200mm HIGH. SEAL WITH ACOUSTIC CAULK ON ALL SIDES.
- PROVIDE SLIP-JOINTS FOR ALL FULL HEIGHT PARTITIONS AT U/S SLAB. MAINTAIN FIRE RESISTANCE RATINGS AND SMOKE SEPARATIONS.
- ALL WALL MOUNTED EQUIPMENT, MILLWORK, ETC. INCLUDING FUTURE AND NIC ITEMS INDICATED ON DRAWINGS. TO HAVE APPROPRIATE BLOCKING WITHIN WALLS PRIOR TO FINISHING WALL CONSTRUCTION. PROVIDE CORNER GUARDS AT ALL OUTSIDE GWB CORNERS UP TO 1200mm AFF.
- PROVIDE NEW PAINT FINISH THROUGHOUT.
- PAINT FINISH ALL METAL DOORS AND FRAMES IN AREA OF RENOVATION UNLESS OTHERWISE INDICATED.
- AT CONDUITS COMING UP THROUGH FLOOR, SCAN CONCRETE SURFACE TO LOCATE EXISTING REINFORCING STEEL. HAMMER DRILL HOLE FOR REQUIRED CONDUIT. DO NOT CORE. LOCATE TO AVOID EXISTING REINFORCING STEEL. DO NOT CUT OR DAMAGE EXISTING REINFORCING STEEL.
- OFFSET DOOR OPENINGS 100MM FROM ADJACENT WALL UNLESS OTHERWISE INDICATED.
- EXISTING DISHWASHER TO BE RELOCATED TEMPORARILY TO ALLOW FOR WORK TO BE DONE - COORDINATE WITH DEPARTMENTAL REPRESENTATIVE.
- PATCH, REPAIR AND MAKE GOOD WALLS & FLOOR AT LOCATIONS AFFECTED BY DEMOLITION.
- PROVIDE FIRESTOPPING AS REQUIRED FOR CONTINUITY OF FIRE SEPARATIONS AS INDICATED ON DRAWINGS. WHERE FIRE SEPARATIONS AND FIRE PROTECTION ARE DAMAGED SO AS TO AFFECT THEIR INTEGRITY, THEY SHALL BE REPAIRED SO THAT THE INTEGRITY OF THE FIRE SEPARATION IS MAINTAINED.


**KEYNOTES:**

- NEW VCT FLOORING W/ RUBBER BASE
- NEW EPOXY FLOORING W/ COVED BASE
- EXISTING MEAL CART (NIC)
- DRY STORAGE (NIC)
- REMOVE EXISTING MILLWORK
- EXISTING DISHWASHER & STAINLESS COUNTER TO REMAIN. TEMPORARILY REMOVE AND CAP-OFF DISHWASHER AND ASSOCIATED FIXTURES. RELOCATE TEMPORARILY PRIOR TO INSTALLATION OF NEW FLOORING. REINSTALL AND RECONNECT AFTER COMPLETION OF WORK. COORDINATE WITH DEPARTMENTAL REPRESENTATIVE REGARDING TEMPORARY LOCATION FOR EQUIPMENT.
- 13mm HIGH CONCRETE CURB UNDER EPOXY FLOORING
- EXTENT OF NEW FLOORING
- EXISTING WALL TO REMAIN. PATCH & REPAIR AS REQUIRED.
- ALIGN FACE OF NEW WALL WITH EDGE OF EXISTING OPENING
- NEW PARTITION TO UNDERSIDE OF CONCRETE ABOVE
- EXISTING OPENING TO REMAIN
- NEW DOOR AND FRAME
- NEW VIEWING WINDOW COMPLETE WITH WELDED HOLLOW METAL FRAME AND TEMPERED GLASS.
- EXISTING OPENING & STAINLESS STEEL FRAME TO REMAIN. PROVIDE NEW TEMPERED GLASS COMPLETE WITH STAINLESS STEEL STOPS.
- CORNER GUARD
- ALIGN CURB WITH EDGE OF WALL
- EXISTING FLOORING TO REMAIN
- NEW FURNITURE (NIC)
- PROVIDE NEW PLYWOOD BACKBOARD WITH INTUMESCENT PAINT FOR NEW ELECTRICAL PANEL (REFER TO 1/E-2.)
- END OF NEW PAINT
- PROVIDE TRANSITION STRIP BETWEEN EXISTING TILE FLOORING TO NEW VCT.
- PROVIDE TRANSITION STRIP BETWEEN EXISTING TILE FLOORING TO NEW VCT.
- PROVIDE TRANSITION STRIP BETWEEN EXISTING TILE FLOORING TO NEW EPOXY FLOORING. ENSURE LEVEL OF NEW EPOXY FLOORING IS FLUSH TO FINISHED FACE OF EXISTING TILE.


**DOOR SCHEDULE:**

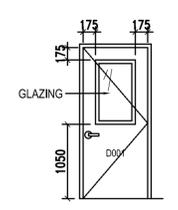


D001 (OFFICE IN FINISHING KITCHEN)  
-915w X 2135h X 44t  
-COMMERCIAL RATED METAL HALF LIGHT DOOR & FRAME - PAINT  
-STC RATINGS: N/A  
-FIRE RATING: N/A  
-GLAZING: 12MM CLEAR TEMPERED GLASS  
-HARDWARE SET REFER TO SPECIFICATIONS

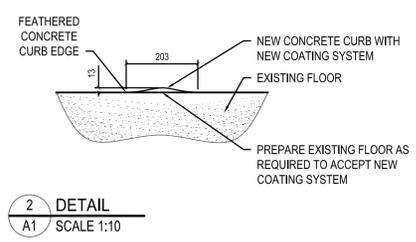


**2 DETAIL**  
A1 SCALE 1:10

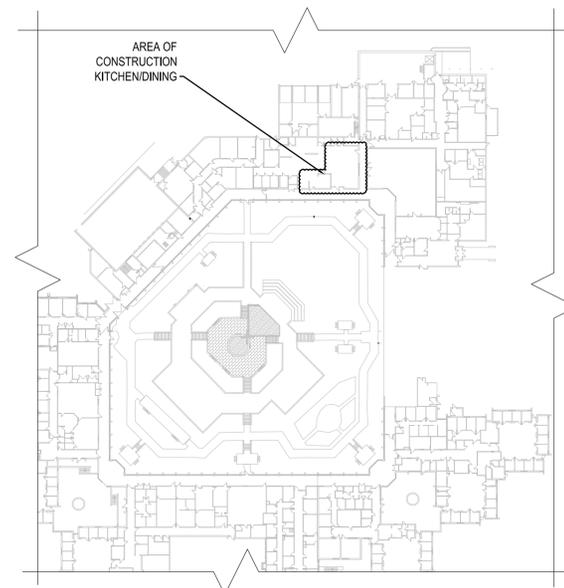


**3 KEY PLAN**  
A1 SCALE 1:1000

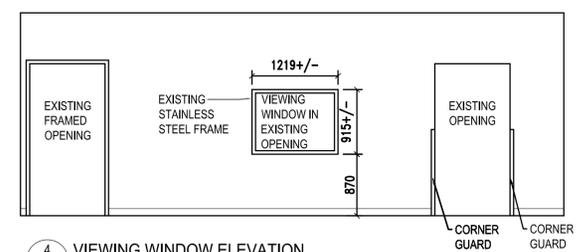

**4 VIEWING WINDOW ELEVATION**  
A1 SCALE 1:50

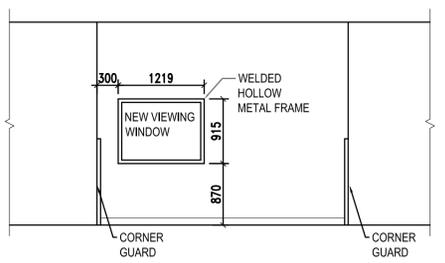

**5 VIEWING WINDOW ELEVATION**  
A1 SCALE 1:50

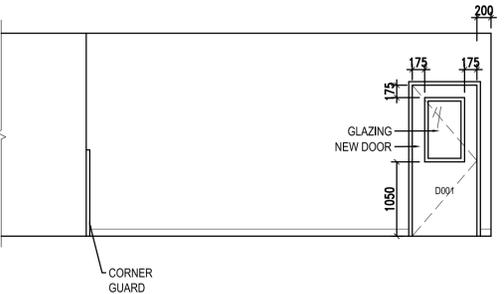

**6 NEW DOOR ELEVATION**  
A1 SCALE 1:50