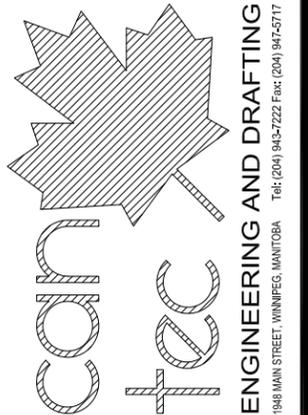


INTERIOR / EXTERIOR RENOVATIONS HOUSE V139 POND INLET, NUNAVUT CONSTRUCTION

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1948 MAIN STREET, WINNIPEG, MANITOBA Tel: (204) 943-7222 Fax: (204) 947-5717

DRAWING LIST

- DRAWING LIST**
- A0.0 TITLE PAGE
 - A1.0 ELEVATIONS
 - A2.0 PARTIAL FLOOR PLAN
 - A3.0 SCHEDULE OF DOORS & WINDOWS / DETAIL

CONSULTANT LIST



DRAWING SYMBOLS

- NUMBERED NOTE
- WINDOW NUMBER
- WALL / ROOF IDENTIFIER
- DOOR NUMBER
- DETAIL SECTION
- DETAIL NUMBER SHEET SECTION LOCATED
- ELEVATION IDENTIFIER
- DETAIL NUMBER SHEET ELEVATION LOCATED
- DETAIL MARKER (SEE SPECIFICATION BOOK)
- GRID LINES
- DETAIL MARKER
- ELEVATION MARKER
- ROOM NUMBER MARKER
- DETAIL IDENTIFICATION
- DETAIL NUMBER
- CURRENT SHEET
- PAGE ORIENTATION

ABBREVIATION LIST

ACOUSTIC	ACST	DRYWALL	DW	LAVATORY	LAV	ROOM	RM
ADHESIVE	ADH	EACH	EA	LAY-IN ACOUSTIC TILE	LAT	ROUGH OPENING	RO
ADJUSTABLE	ADJ	EACH WAY	EW	LEFT HAND	LH	RUBBER	RB
AGGREGATE	AGGR	EAST	E	LEFT HAND REVERSE	LHR	RVT	RESILIENT SHEET FLOORING
AIR VAPOUR BARRIER	AVB	ELECTRICAL	ELEC	LENGTH	LG	SCHEDULE	SCHED
ALTERNATE	ALT	ELEVATION	EL	LIGHT	LT	SCREW	SCR
ALUMINUM	ALUM	ELEVATOR	ELEV	LOUVRE	LVR	SECTION	SECT
APARTMENT	APT	EPOXY	EP	MANUFACTURE	MFG	SELF ADHESIVE	SA
APPROXIMATE	APPROX	EQUAL	EQ	MARK	MK	SHEATHING	SHTG
ARCHITECTURE	ARCH	EQUALLY SPACED	EQ SP	MASONRY OPENING	MO	SHEET	SHT
BEAM	BM	EQUIPMENT	EQUIP	MATERIAL	MAT	SHEET VINYL	SV
BENCH MARK	BM	EXISTING	EXIST	MECHANICAL	MECH	SIMILAR	SIM
BETWEEN	BTWN	EXPANSION	EXP	MINIMUM	MIN	SOLID CORE	SC
BLOCK	BLK	EXTERIOR	EXT	MISCELLANEOUS	MISC	SOUTH	S
BOARD	BD	EXTRUDE	EXTR	NEAR FACE	NF	SPECIFICATION	SPEC
BOTH SIDES	BS	FACE TO FACE	F/F	NEAR SIDE	NS	SPRUCE	SPR
BOTH WAYS	BW	FAR SIDE	FS	NORTH	N	SPRUCE, PINE OR FIR	S/P/F
BOTTOM	BOT	FIBREBOARD	FBRBD	NOT APPLICABLE	N/A	STAIN	ST
BUILDING	BLDG	FINISH	FIN	NOT IN CONTRACT	NIC	STAINLESS STEEL	SS
CARPET	CPT	FLOOR	FL	NOT TO SCALE	NTS	STANDARD	STD
CAST IRON	CI	FLOOR DRAIN	FD	NUMBER	NO	STEEL	STL
CEILING	CLG	FLOORING	FLG	ON CENTRE	O/C	STRUCTURAL	STRUCT
CEMENT BOARD	CBD	FLUORESCENT	FLR	OUT TO OUT	O/O	SQUARE FEET	SF
CENTRE	CTR	FOOTING	FTG	OUTSIDE DIAMETER	OD	TEMPORARY	TEMP
CENTRE TO CENTRE	C/C	FOUNDATION	FDN	OUTSIDE FACE	OF	THROUGH	THRU
CERAMIC TILE	CT	FULL SIZE	FS	OVERHEAD	OH	TO MATCH EXISTING	TME
CIRCLE	CIRC	GALVANIZED	GALV	PAINT	PT	TONGUE AND GROOVE	T&G
CLEAR	CLR	GALVANIZED IRON	GI	PAINTED	PTD	TOP AND BOTTOM	T&B
COLUMN	COL	GAUGE	GA	PARTITION	PTN	TOP OF	T/O
COMPLETE WITH	CW	GLASS	GL	PLYWOOD	PLYWD	TYPICAL	TYP
CONCRETE	CONC	HARDWARE	HDW	PRECAST	PC	UNDER SIDE	U/S
CONCRETE BLOCK	CBLK	HEIGHT	HGT	PRECAST CONCRETE	PC CONC	UNDERCUT	UCUT
CONSTRUCTION	CONST	HEXAGON	HEX	PREFABRICATION	PREFAB	URINAL	UR
CONTINUOUS	CONT	HOLLOW CORE	HC	PREFINISHED	PREFIN	VAPOUR BARRIER	VB
CONTROL JOINT	CJ	HOLLOW METAL	HM	PRESSED STEEL	PS	VERTICAL	VERT
COUNTERSINK	CSK	HORIZONTAL	HORIZ	QUANTITY	QTY	VINYL ASBESTOS TILE	VAT
COVED SHEET VINYL	CSV	INCLUSIVE	INCL	QUARRY TILE	QT	VINYL COVE BASE	VCB
DETAIL	DTL	INSIDE DIAMETER	ID	RADIUS	R	VINYL TILE	VT
DEMOLISH	DEMO	INSIDE FACE	IF	RAINWATER LEADER	RWL	VINYL WALL COVERING	VWC
DIAGONAL	DIAG	INSULATE	INSUL	REFERENCE	REF	WATER CLOSET	WC

PROJECT TITLE
HOUSE RENOVATIONS V139

SHEET TITLE
TITLE PAGE

DATE
17-07-11

SCALE
AS NOTED

CHECKED BY
RS

DRAWN BY
RQS

LOCATION
POND INLET, NUNAVUT


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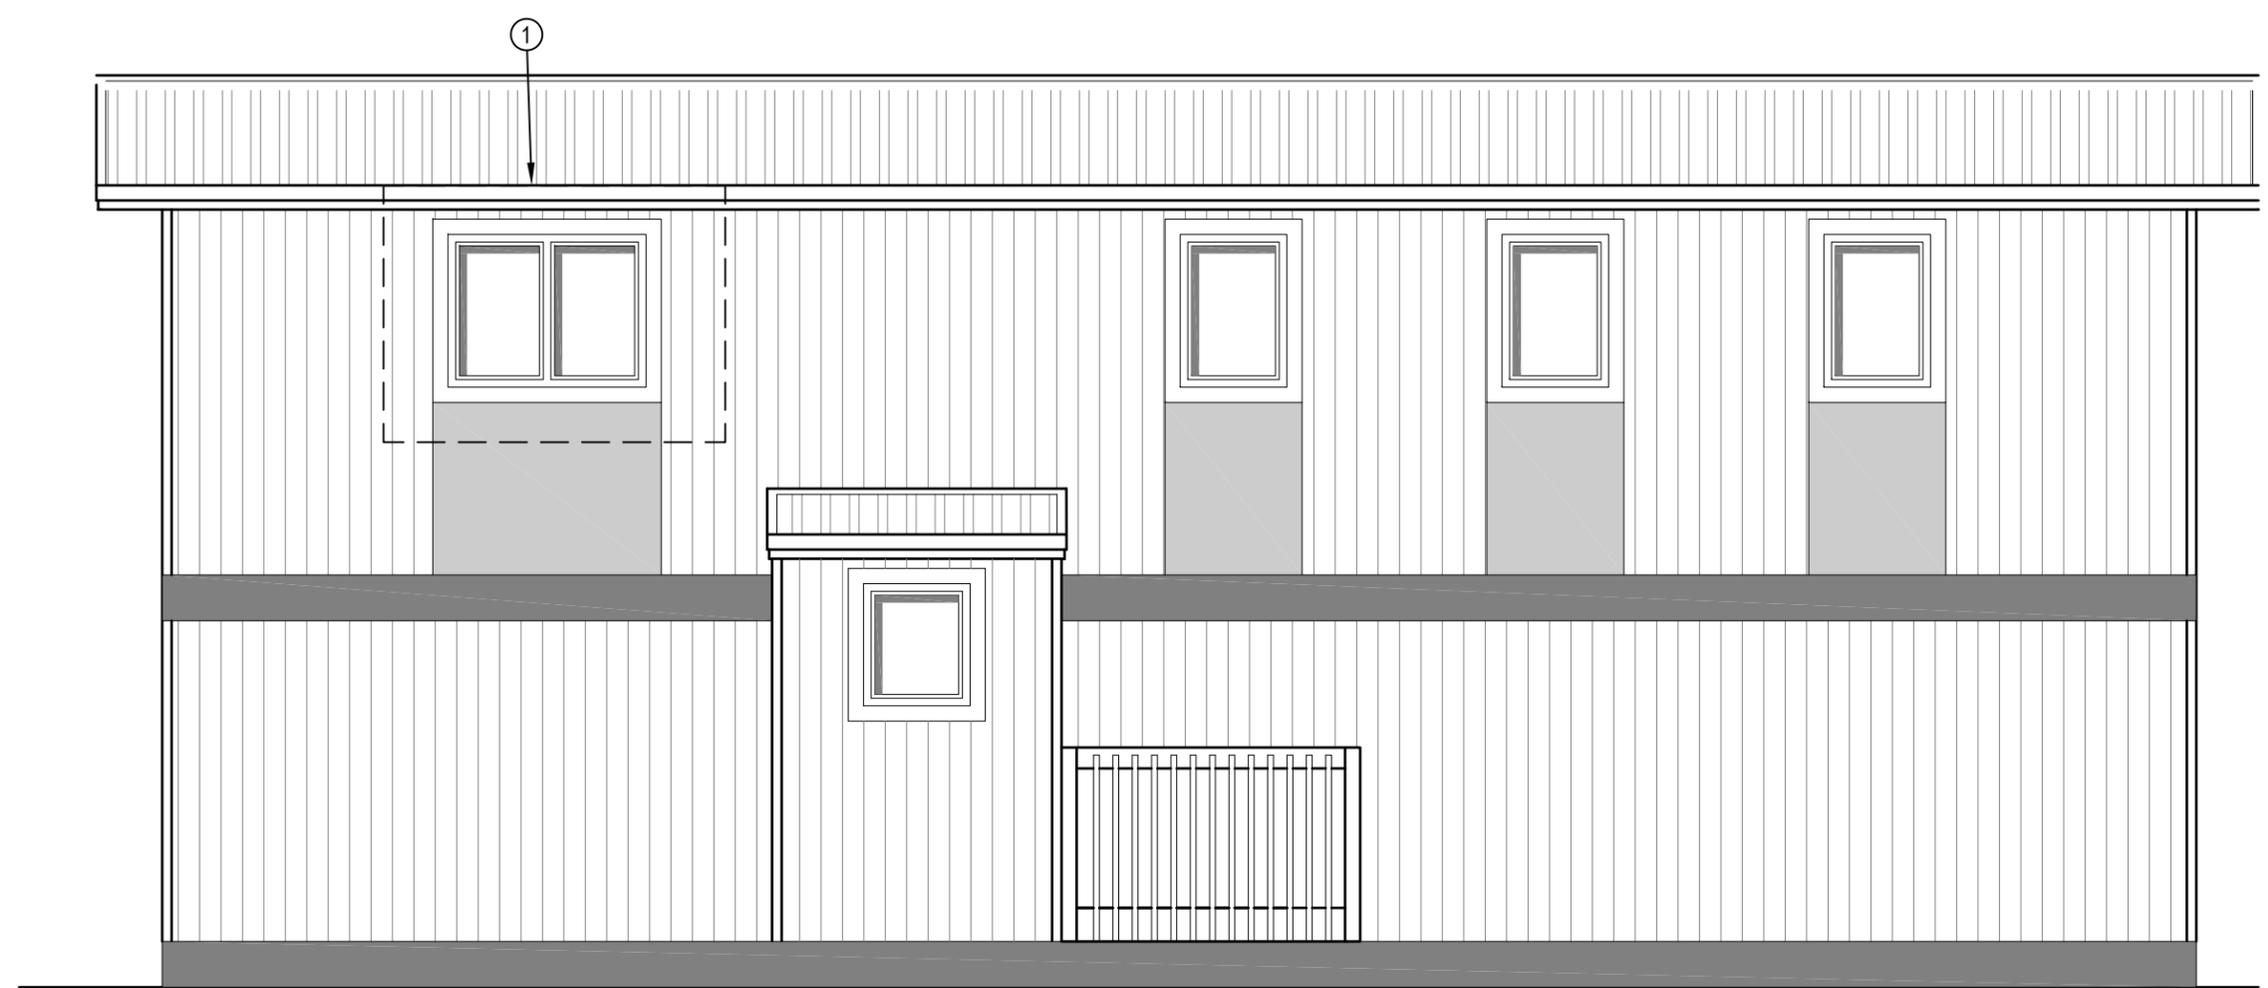
JOB NO.
17-024-01-30

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ENGINEERING AND DRAFTING
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1 REAR ELEVATION
 A3.0 SCALE: 1/4"=1'-0"

DRAWING NOTES:

1. REMOVE EXISTING WINDOW AND INSTALL NEW WINDOW, INTERIOR CASING AND EXTERIOR TRIM.

PROJECT TITLE
HOUSE RENOVATIONS V139

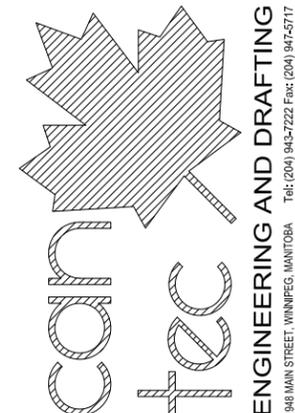SHEET TITLE
ELEVATIONS

DATE
 17-07-11

SCALE
 AS NOTED

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LOCATION
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1 PARTIAL FLOOR PLAN
A2.0 SCALE: 1/4"=1'-0"


DRAWING NOTES: #

1. INSTALL NEW WINDOW, INTERIOR CASING AND EXTERIOR TRIM.
2. REMOVE AND REPAIR DAMAGED DRYWALL UNDER WINDOW.
3. REPAINT ENTIRE WALL COLOR TO MATCH EXISTING



2 DAMAGE TO EXISTING SILL
A2.0 SCALE: NTS

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PROJECT TITLE
HOUSE RENOVATIONS V139

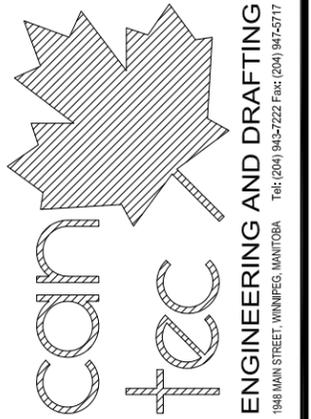SHEET TITLE
FLOOR PLAN AND DETAILS

DATE
17-07-11

SCALE
AS NOTED

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RQS


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A2.0


JOB NO.
17-024-01-30




WINDOW SCHEDULE

NOTES:

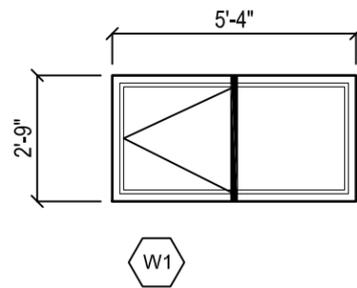1. 6 MIL POLY RETURNED INTO ROUGH WINDOW OPENING AND SEALED TO WOOD FRAMING
2. AIR BARRIER RETURNED INTO ROUGH WINDOW OPENING AND SEALED TO WOOD FRAMING
3. SPRAY FOAM INSULATION INTO SPACES BETWEEN WINDOW AND ROUGH OPENING
4. PROVIDE PRE FINISHED POST FORMED GALVANIZED STEEL FLASHING FULL WIDTH OF WINDOW AT TOP OF WINDOW
5. BEDROOM WINDOWS MUST MEET NBC EGRESS REQUIREMENTS AS PER 9.7.1.3.2
6. INSTALL NEW WINDOW AND DOOR CASING TO ALL UNITS BEING REPLACED.

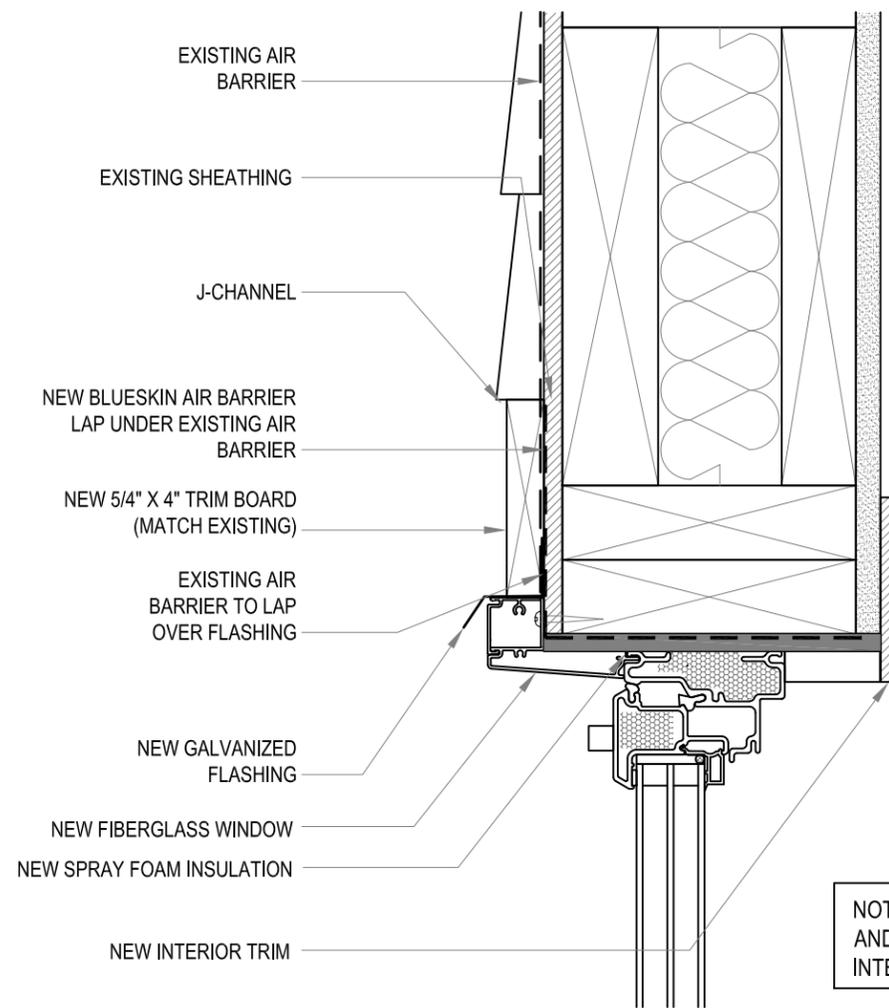


1
A4.0 **WINDOW HEAD DETAIL**
SCALE: 3/16"=1'-0"

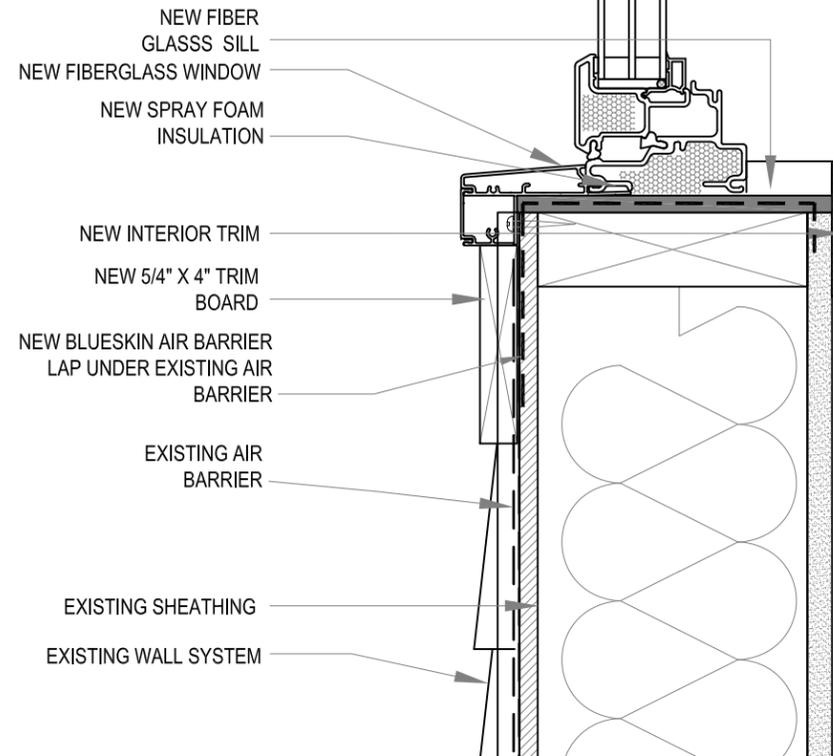

NOTE: ENSURE THAT THE SPRAY FOAM AND THE BLUE SKIN CONNECT TO THE INTERIOR AIR VAPOUR BARRIER

2
A4.0 **WINDOW SILL DETAIL**
SCALE: 3/16"=1'-0"

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PROJECT TITLE
HOUSE RENOVATIONS V139

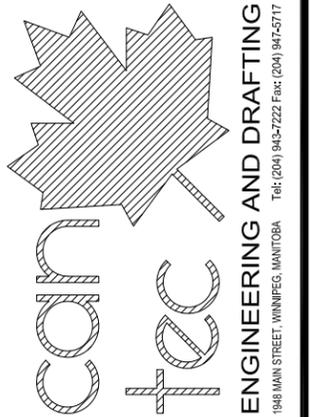SHEET TITLE
SCHD. OF DOORS & WINDOWS/DETAIL

DATE
17-07-11

SCALE
AS NOTED

LOCATION
POND INLET, NUNAVUT

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REVISION NO. 00
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A3.0

JOB NO.
17-024-01-30


INTERIOR / EXTERIOR RENOVATIONS -V140

HOUSE V-140

POND INLET, NUNAVUT

CONSTRUCTION

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DRAWING LIST

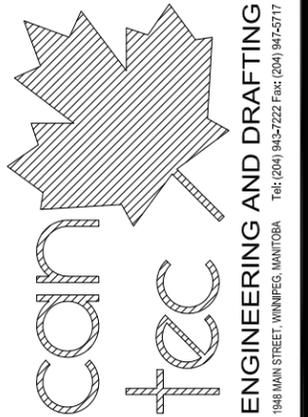DRAWING LIST	
A0.0	TITLE PAGE
A1.0	ELEVATIONS - DEMOLITION
A1.1	MAIN FLOOR PLAN - DEMOLITION
A2.0	MAIN FLOOR PLAN
A3.0	ELEVATIONS
A4.0	SCHEDULE OF DOORS & WINDOWS / DETAIL
A4.1	REAR HAND RAIL REPLACEMENT

CONSULTANT LIST



DRAWING SYMBOLS

	NUMBERED NOTE		DETAIL SECTION
	WINDOW NUMBER		DETAIL NUMBER
	WALL / ROOF IDENTIFIER		SHEET SECTION LOCATED
	DOOR NUMBER		ELEVATION IDENTIFIER
			DETAIL NUMBER
			SHEET ELEVATION LOCATED
			DETAIL MARKER (SEE SPECIFICATION BOOK)
	GRID LINES		
	DETAIL MARKER		
	ELEVATION MARKER		
	ROOM NUMBER MARKER		
	DETAIL IDENTIFICATION		
	DETAIL NUMBER		
	CURRENT SHEET		
	PAGE ORIENTATION		

ABBREVIATION LIST

ACOUSTIC	ACST	DRYWALL	DW	LAVATORY	LAV	ROOM	RM
ADHESIVE	ADH	EACH	EA	LAY-IN ACOUSTIC TILE	LAT	ROUGH OPENING	RO
ADJUSTABLE	ADJ	EACH WAY	EW	LEFT HAND	LH	RUBBER	RB
AGGREGATE	AGGR	EAST	E	LEFT HAND REVERSE	LHR	RVT	RESILIENT SHEET FLOORING
AIR VAPOUR BARRIER	AVB	ELECTRICAL	ELEC	LENGTH	LG	SCHEDULE	SCHED
ALTERNATE	ALT	ELEVATION	EL	LIGHT	LT	SCREW	SCR
ALUMINUM	ALUM	ELEVATOR	ELEV	LOUVRE	LVR	SECTION	SECT
APARTMENT	APT	EPOXY	EP	MANUFACTURE	MFG	SELF ADHESIVE	SA
APPROXIMATE	APPROX	EQUAL	EQ	MARK	MK	SHEATHING	SHTG
ARCHITECTURE	ARCH	EQUALLY SPACED	EQ SP	MASONRY OPENING	MO	SHEET	SHT
BEAM	BM	EQUIPMENT	EQUIP	MATERIAL	MAT	SHEET VINYL	SV
BENCH MARK	BM	EXISTING	EXIST	MECHANICAL	MECH	SIMILAR	SIM
BETWEEN	BTWN	EXPANSION	EXP	MINIMUM	MIN	SOLID CORE	SC
BLOCK	BLK	EXTERIOR	EXT	MISCELLANEOUS	MISC	SOUTH	S
BOARD	BD	EXTRUDE	EXTR	NEAR FACE	NF	SPECIFICATION	SPEC
BOTH SIDES	BS	FACE TO FACE	F/F	NEAR SIDE	NS	SPRUCE	SPR
BOTH WAYS	BW	FAR SIDE	FS	NORTH	N	SPRUCE, PINE OR FIR	S/P/F
BOTTOM	BOT	FIBREBOARD	FBRBD	NOT APPLICABLE	N/A	STAIN	ST
BUILDING	BLDG	FINISH	FIN	NOT IN CONTRACT	NIC	STAINLESS STEEL	SS
CARPET	CPT	FLOOR	FL	NOT TO SCALE	NTS	STANDARD	STD
CAST IRON	CI	FLOOR DRAIN	FD	NUMBER	NO	STEEL	STL
CEILING	CLG	FLOORING	FLG	ON CENTRE	O/C	STRUCTURAL	STRUCT
CEMENT BOARD	CBD	FLUORESCENT	FLR	OUT TO OUT	O/O	SQUARE FEET	SF
CENTRE	CTR	FOOTING	FTG	OUTSIDE DIAMETER	OD	TEMPORARY	TEMP
CENTRE TO CENTRE	C/C	FOUNDATION	FDN	OUTSIDE FACE	OF	THROUGH	THRU
CERAMIC TILE	CT	FULL SIZE	FS	OVERHEAD	OH	TO MATCH EXISTING	TME
CIRCLE	CIRC	GALVANIZED	GALV	PAINT	PT	TONGUE AND GROOVE	T&G
CLEAR	CLR	GALVANIZED IRON	GI	PAINTED	PTD	TOP AND BOTTOM	T&B
COLUMN	COL	GAUGE	GA	PARTITION	PTN	TOP OF	T/O
COMPLETE WITH	CW	GLASS	GL	PLYWOOD	PLYWD	TYPICAL	TYP
CONCRETE	CONC	HARDWARE	HDW	PRECAST	PC	UNDER SIDE	U/S
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CONSTRUCTION	CONST	HEXAGON	HEX	PREFABRICATION	PREFAB	URINAL	UR
CONTINUOUS	CONT	HOLLOW CORE	HC	PREFINISHED	PREFIN	VAPOUR BARRIER	VB
CONTROL JOINT	CJ	HOLLOW METAL	HM	PRESSED STEEL	PS	VERTICAL	VERT
COUNTERSINK	CSK	HORIZONTAL	HORIZ	QUANTITY	QTY	VINYL ASBESTOS TILE	VAT
COVED SHEET VINYL	CSV	INCLUSIVE	INCL	QUARRY TILE	QT	VINYL COVE BASE	VCB
DETAIL	DTL	INSIDE DIAMETER	ID	RADIUS	R	VINYL TILE	VT
DEMOLISH	DEMO	INSIDE FACE	IF	RAINWATER LEADER	RWL	VINYL WALL COVERING	VWC
DIAGONAL	DIAG	INSULATE	INSUL	REFERENCE	REF	WATER CLOSET	WC

PROJECT TITLE
HOUSE RENOVATIONS - V140

SHEET TITLE
TITLE PAGE

DATE
17-07-11

LOCATION
POND INLET, NUNAVUT

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RS

DRAWN BY
RQS

SCALE
AS NOTED


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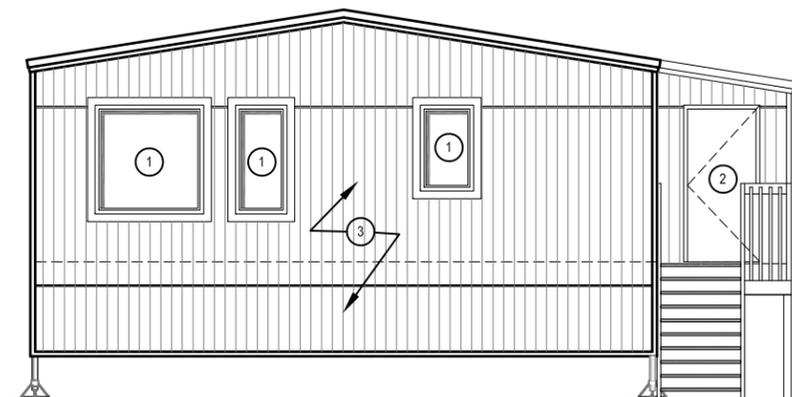
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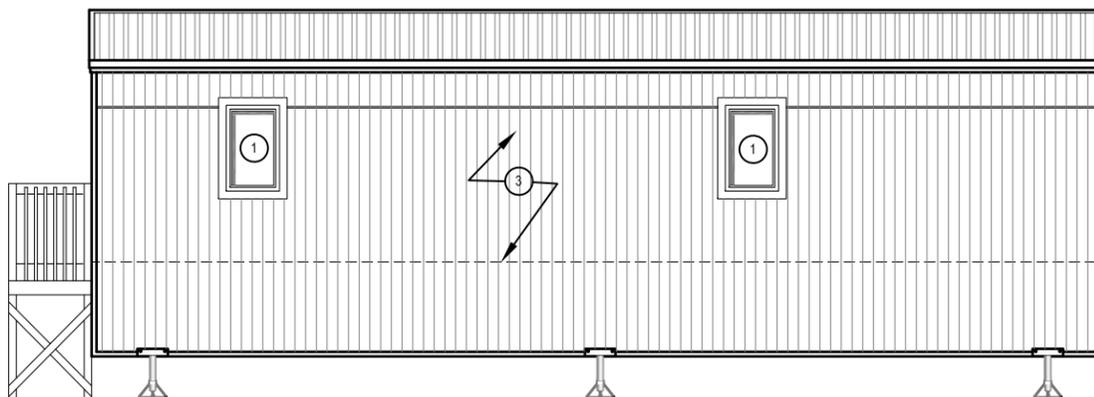
<http://www.can-tecservices.ca/>




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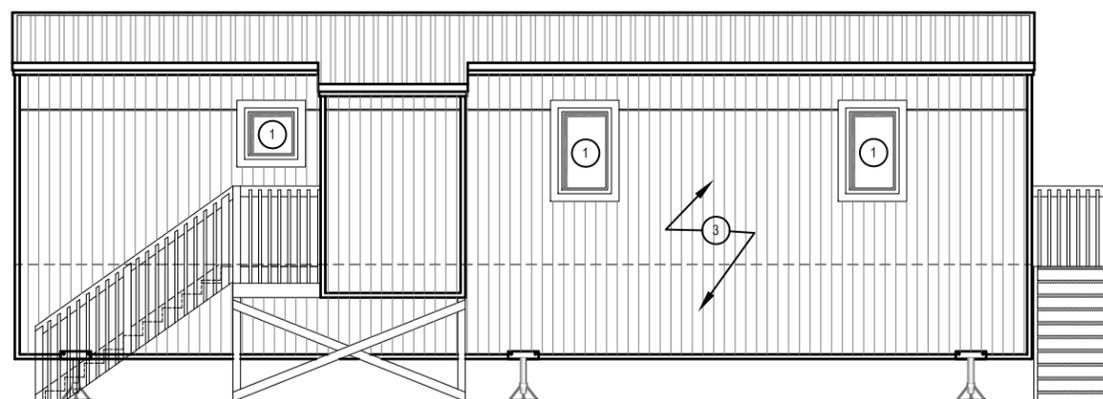
1 FRONT ELEVATION
 A1.0 SCALE: 1/8"=1'-0"



2 LEFT SIDE ELEVATION
 A1.0 SCALE: 1/8"=1'-0"

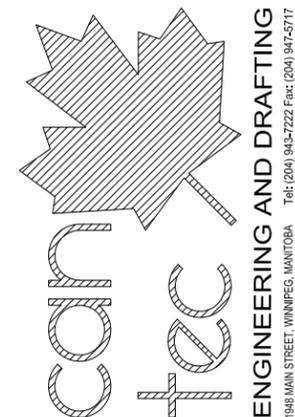

3 REAR ELEVATION
 A1.0 SCALE: 1/8"=1'-0"

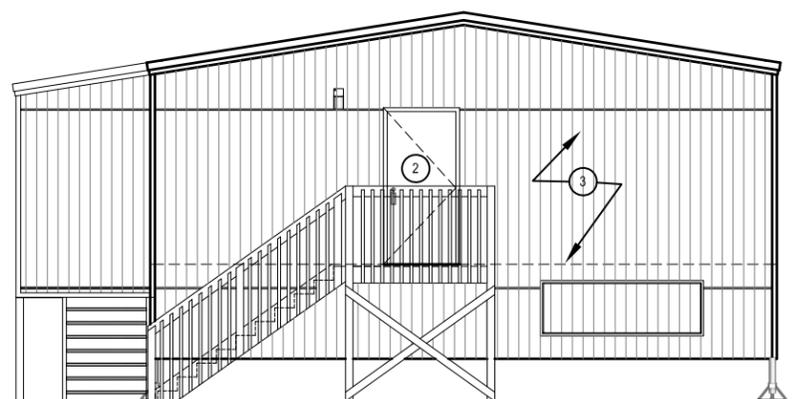

4 RIGHT ELEVATION
 A1.0 SCALE: 1/8"=1'-0"

DRAWING NOTES:


1. REMOVE WINDOW, EXTERIOR AND INTERIOR TRIM. TRIM SIDING AS REQUIRED TO ALLOW FOR INSTALLATION OF NEW WINDOW
2. REMOVE EXTERIOR DOORS AND INTERIOR TRIM
3. SCRAPE AND REPAIR SIDING FOR PAINTING

PROJECT TITLE: HOUSE RENOVATIONS - V140
 SHEET TITLE: ELEVATIONS - DEMOLITION
 DATE: 17-07-11
 SCALE: AS NOTED
 DRAWN BY: RQS
 CHECKED BY: RS
 LOCATION: POND INLET, NUNAVUT

REVISION NO. 00
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A1.0

JOB NO.
 17-024-01-30

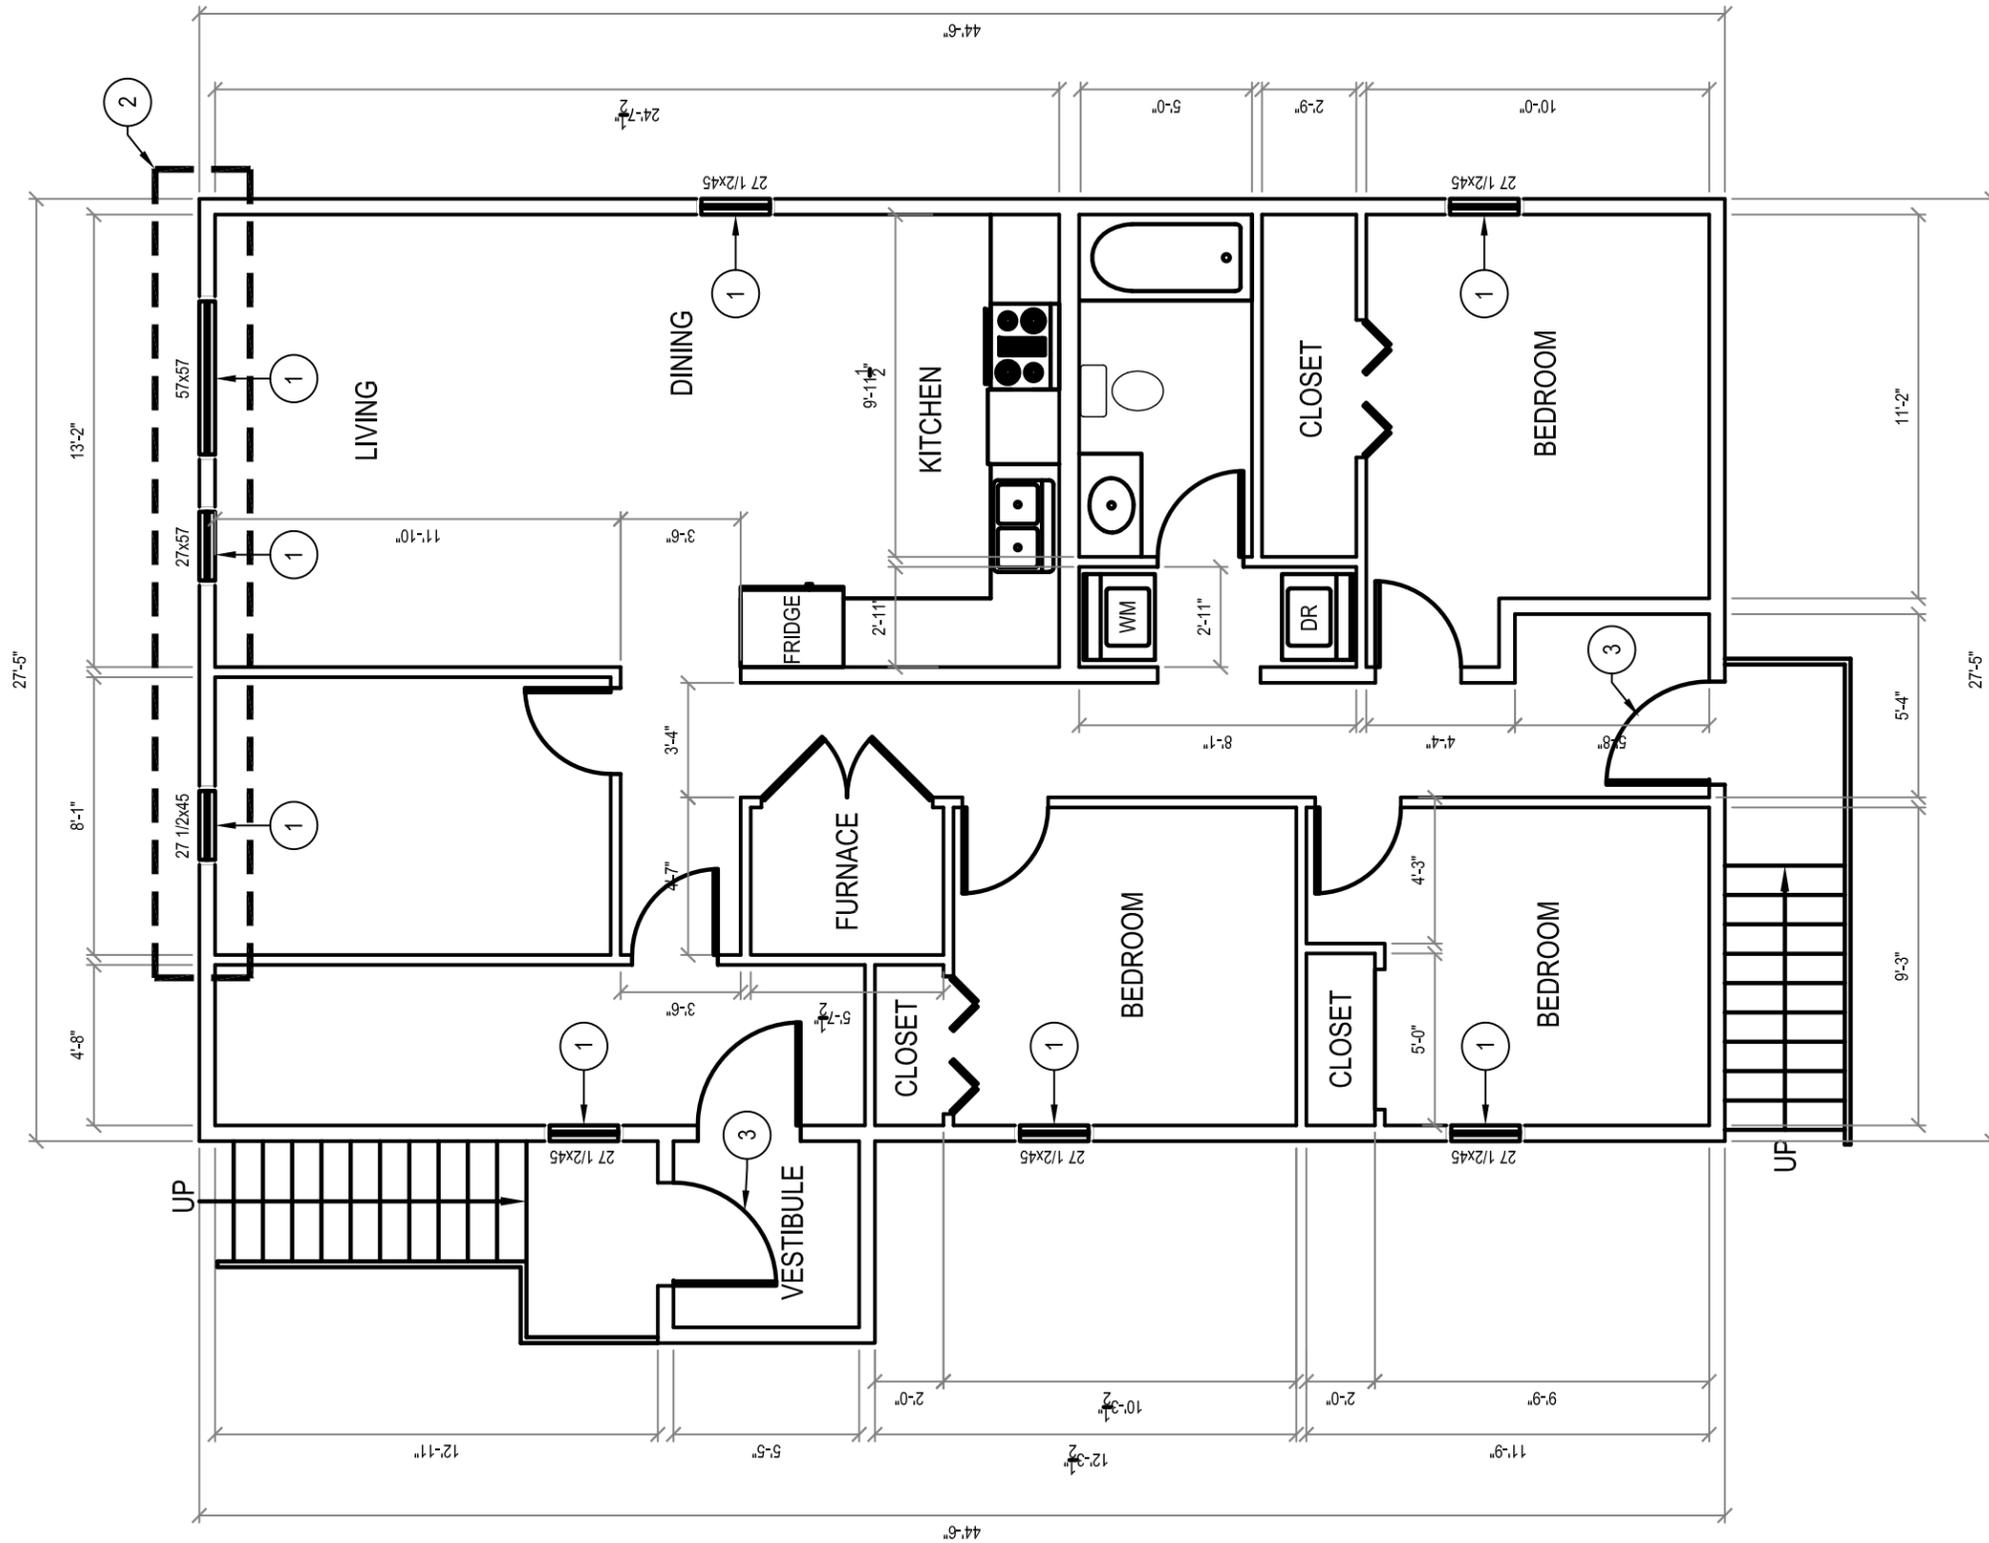

1 MAIN FLOOR PLAN-DEMOLITION
SCALE: 3/16"=1'-0"

- DEMOLITION NOTES** #
1. REMOVE WINDOW AND INTERIOR TRIM
 2. REMOVE DRYWALL, AVB AND INSULATION
 3. REMOVE EXTERIOR DOOR AND FRAME

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PROJECT TITLE
HOUSE RENOVATIONS - V140

SHEET TITLE
MAIN FLOOR PLAN-DEMOLITION

DATE
17-07-11

SCALE
AS NOTED

DRAWN BY
RQS


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LOCATION
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A1.1

JOB NO.
17-024-01-30



2 MAIN FLOOR PLAN-(PROPOSED)
SCALE: 3/16"=1'-0"

DRAWING NOTES: #

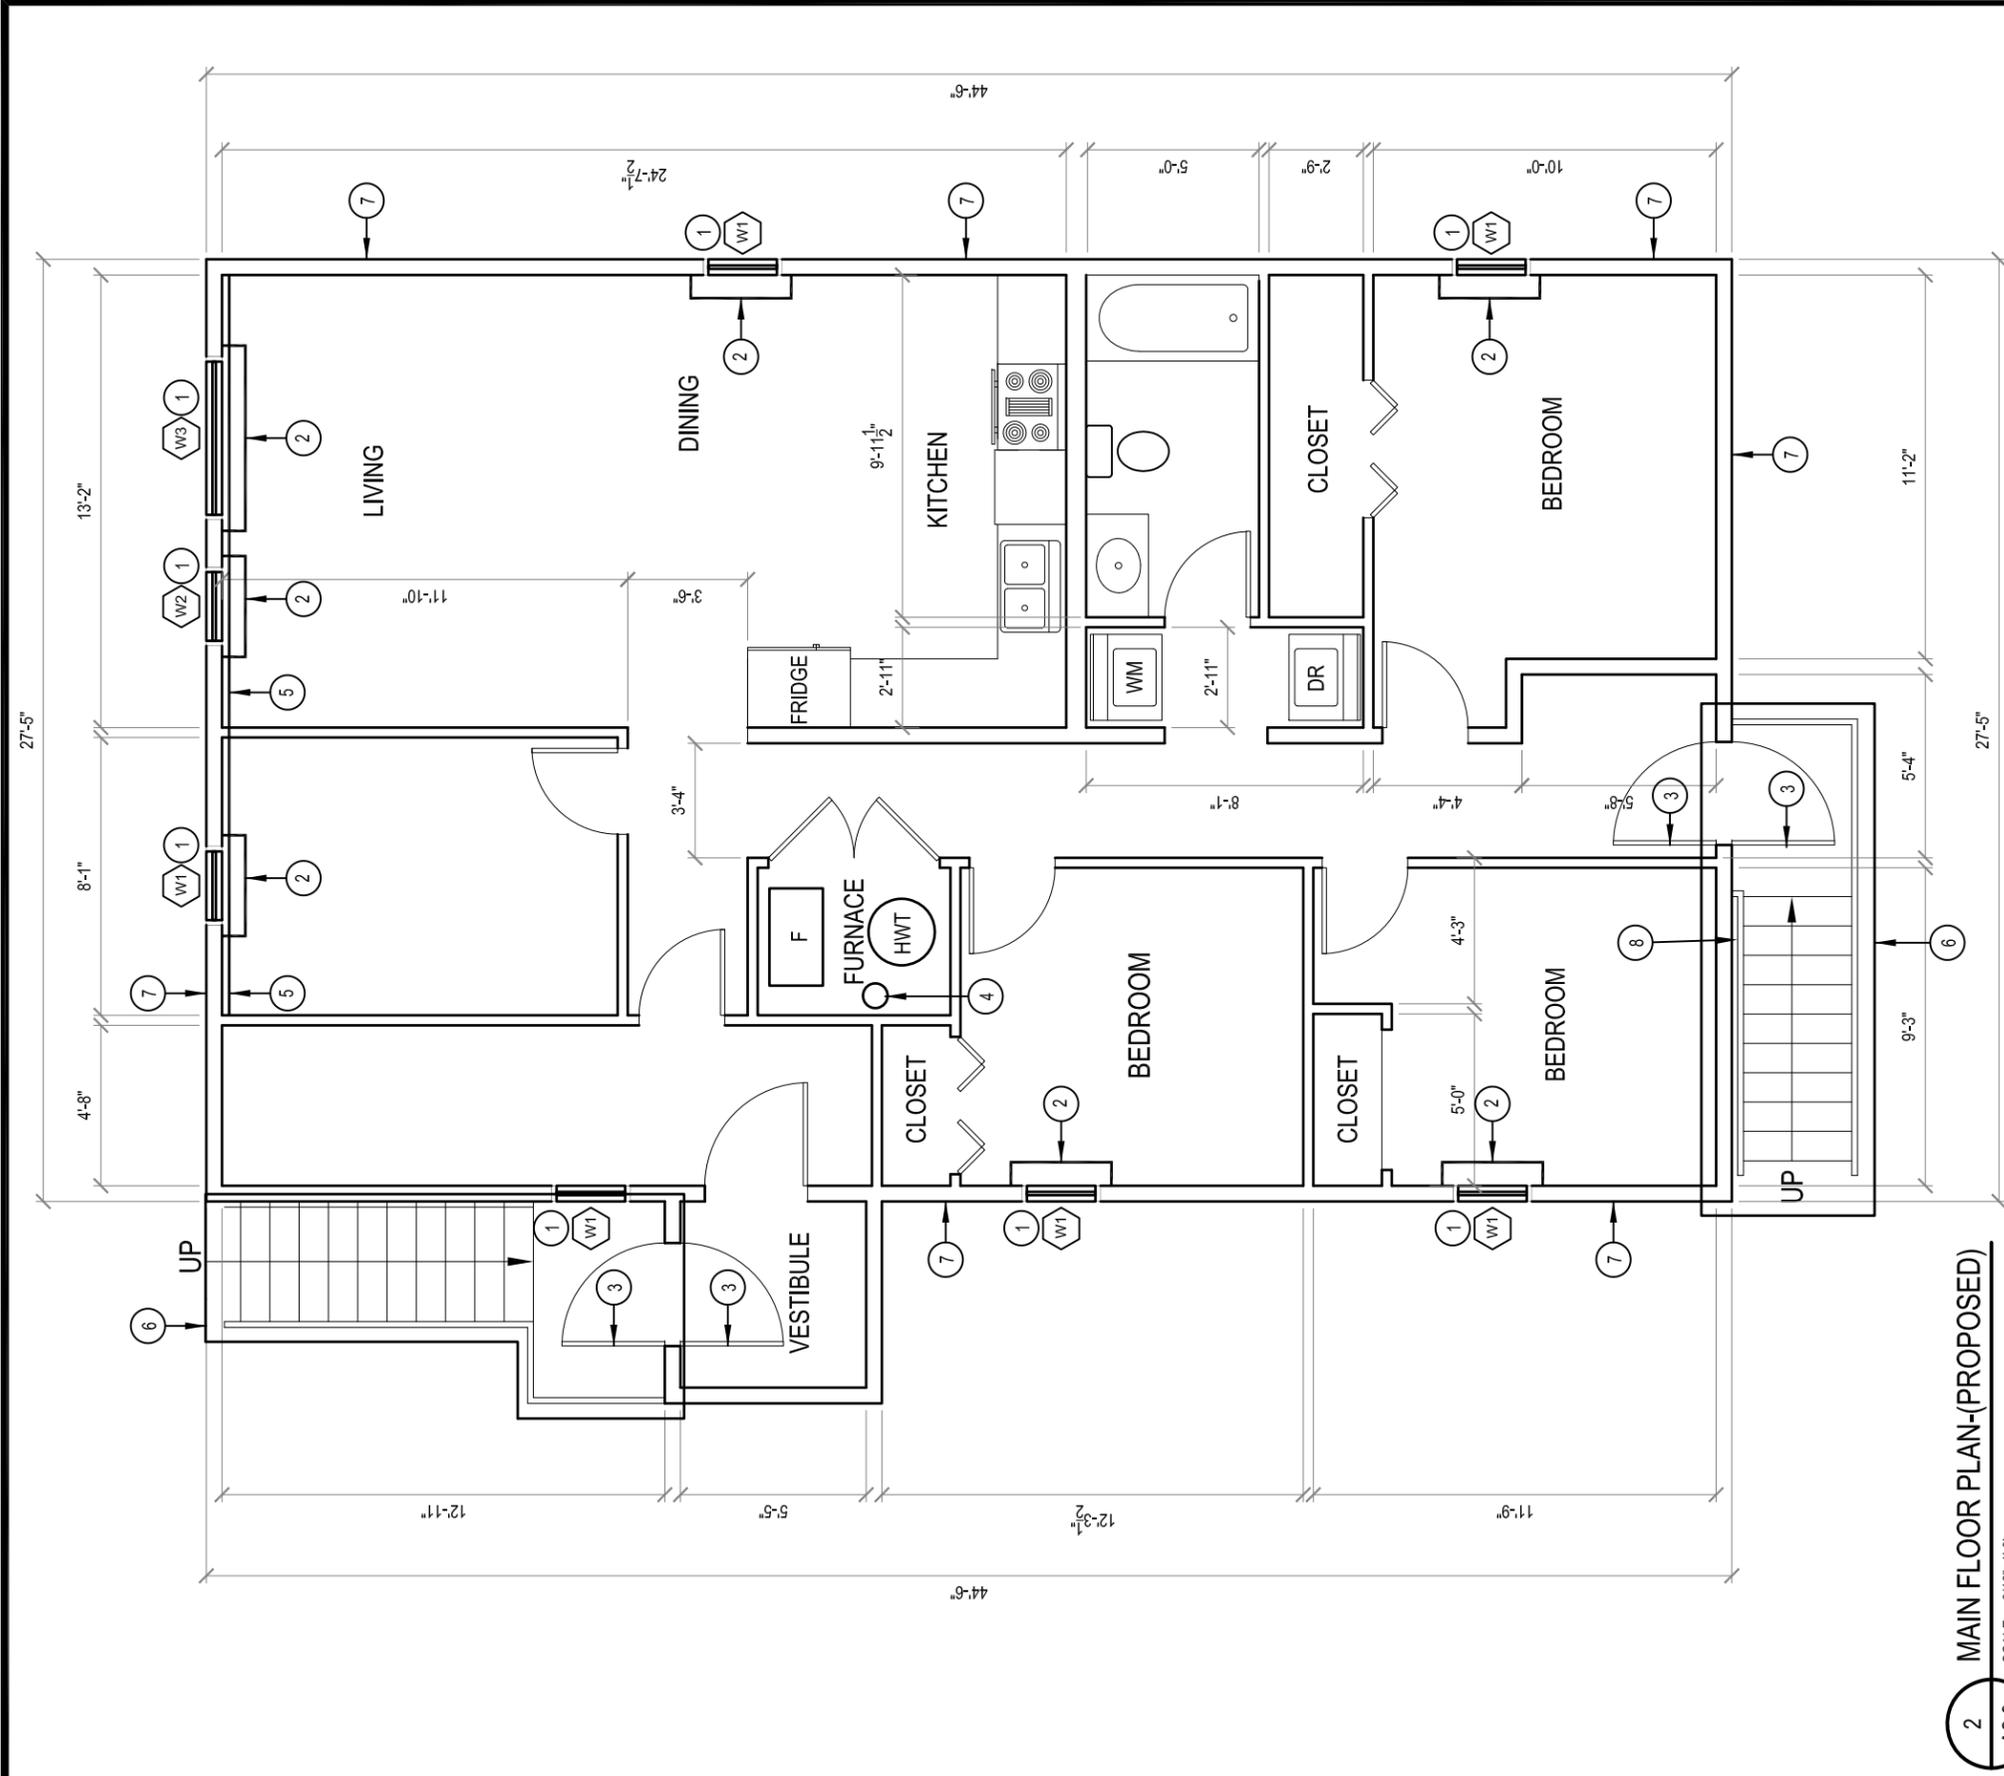1. INSTALL NEW WINDOW, INTERIOR CASING AND EXTERIOR TRIM. REPAINT ENTIRE WALL THAT WINDOW IS PART OF. MATCH EXISTING COLOR.
2. INSTALL NEW DUAL ROLLER BLACKOUT BLINDS.
3. INSTALL NEW EXTERIOR DOOR AND NEW STORM DOOR C/W 1/2 LITE.
4. REMOVE AND REPLACE EXISTING CHIMNEY. CHIMNEY TO INCLUDE ALL NEW CHIMNEY, TIE DOWNS, CAP, COLLARS AND ALL CAULKING. SEE PHOTOS FOR EXISTING CONDITION
5. INSTALL NEW ROXUL INSULATION, 6MIL AVB AND DRYWALL TO REPAIR WALL. REPAINT ENTIRE WALL COLOR TO MATCH EXISTING.
6. STRIP AND REPAINT STAIRS AND DECK.
7. REPAINT EXISTING SIDING AND ALL TRIM
8. INSTALL NEW WOOD HAND RAIL ON HOUSE SIDE OF STAIRS.

GENERAL NOTES:

1. HOUSE TO BE RE-LEVELLED. SUPPLY SHOP DRAWING SHOWING EXISTING ELEVATIONS OF ALL SCREW JACKS AND FINAL ELEVATIONS OF ALL SCREW JACKS ONE LEVELING IS COMPLETE
2. ALL FURNACE DUCTWORK IS TO BE CLEANED AND VACUUMED.
3. ALL EXISTING FLOOR AND WALL SUPPLY VENTS ARE TO BE REMOVED AND REPLACED. SITE VISIT TO VERIFY NUMBER. ASSUME MINIMUM OF 16 FLOOR REGISTERS.
4. EXISTING DUCT BOOTS ARE TO BE CLEANED TO AS FAR AS A VACUUM HOSE CAN REACH.


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PROJECT TITLE
HOUSE RENOVATIONS - V140

SHEET TITLE
MAIN FLOOR PLAN

DATE 17-07-11
SCALE AS NOTED
DRAWN BY RQS
CHECKED BY RS
LOCATION POND INLET, NUNAVUT




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http://www.cantecservices.ca/
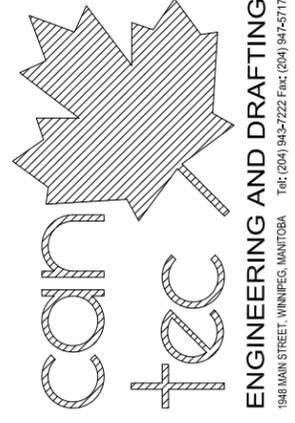
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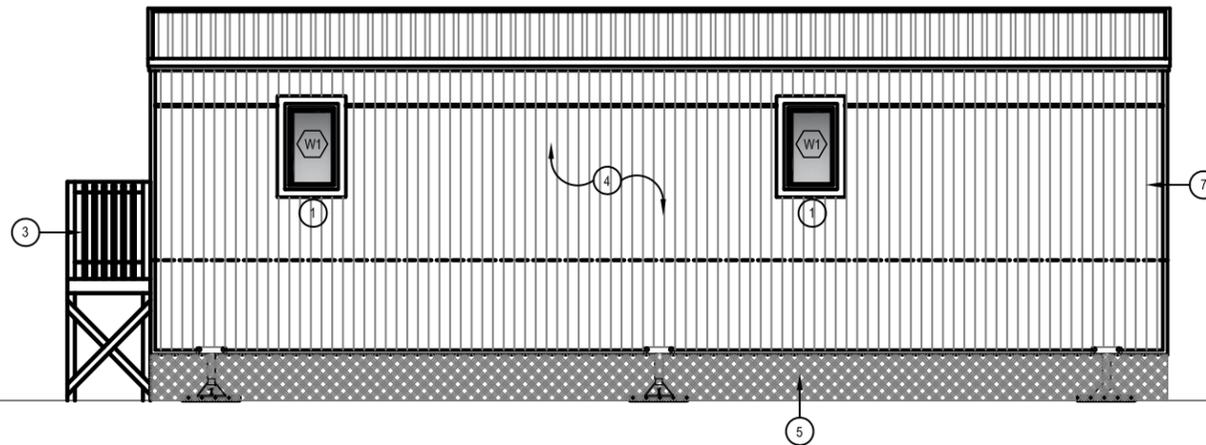
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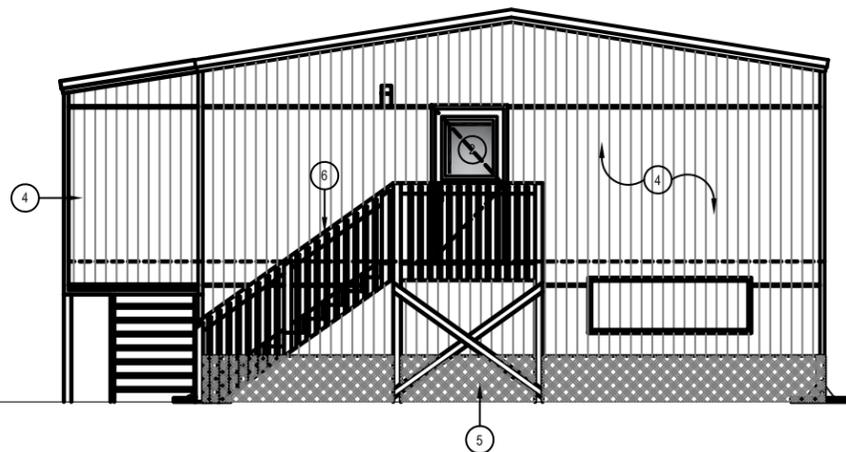
1948 MAIN STREET, WINNIPEG, MANITOBA Tel: (204) 943-7222 Fax: (204) 947-5717




1 FRONT ELEVATION
 A3.0 SCALE: 1/8"=1'-0"

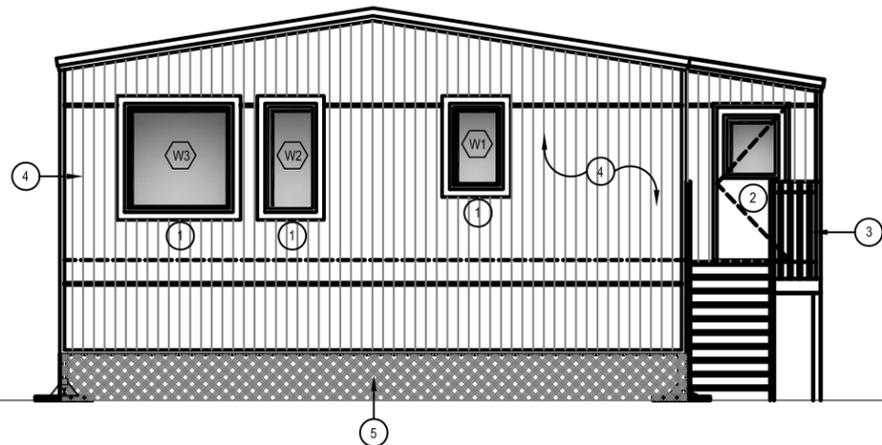

2 LEFT SIDE ELEVATION
 A3.0 SCALE: 1/8"=1'-0"



3 REAR ELEVATION
 A3.0 SCALE: 1/8"=1'-0"

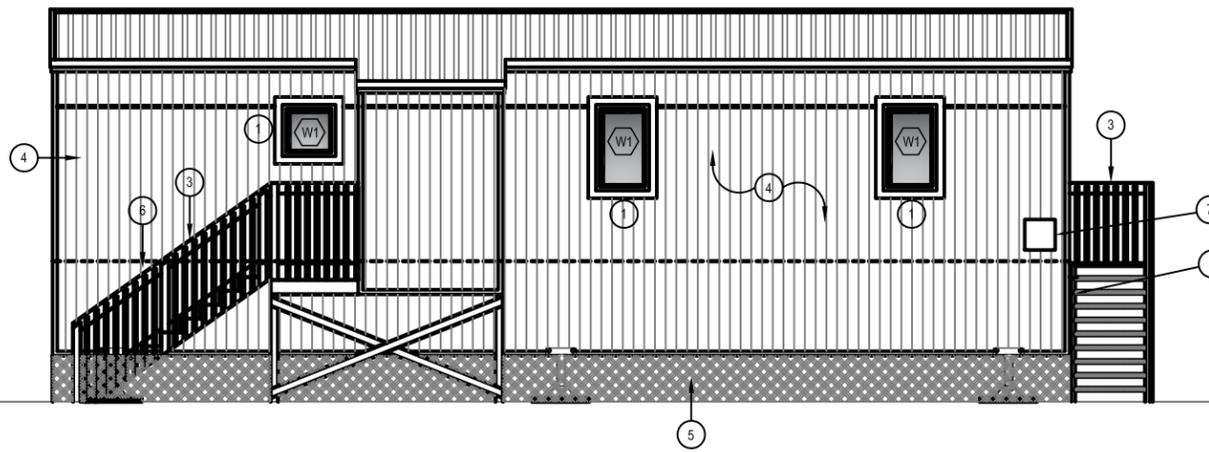

4 RIGHT ELEVATION
 A3.0 SCALE: 1/8"=1'-0"

NOTES:

1. NEW TRIM TO BE CAPE CAPE CODE 1 1/4" X 4 1/4". COLOR TO BE SELECTED FROM MANUFACTURERS STANDARD COLOR SET
2. REVIEW ALL EXTERIOR SIDING AND TRIM. RE-FASTEN ANY LOOSE SECTIONS AND RE-CAULK. (INCLUDE 8 MAN HOURS IN CONTRACT)
3. REVIEW ROOFING, EAVES, SOFFIT AND RE-FASTEN ANY LOOSE SECTIONS. RE-CAULK AS REQUIRED. (INCLUDE 8 MAN HOURS IN CONTRACT)

DRAWING NOTES: #

1. INSTALL NEW WINDOW, INTERIOR CASING AND EXTERIOR TRIM.
2. INSTALL NEW EXTERIOR DOOR STORM DOOR C/W 1/2 LITE.
3. STRIP AND REPAINT STAIRS AND DECK.
4. REPAINT EXISTING SIDING AND ALL TRIM
5. NEW SKIRTING SEE DETAIL. (1/A4.0)
6. INSTALL SECOND HAND RAIL ON HOUSE SIDE OF STAIRS
7. INSTALL NEW 24"X24" PWF SATELLITE BACKER BOARD. CAULK ALL AROUND TO EXISTING SIDING AND PAINT TO MATCH TRIM COLOR

PROJECT TITLE HOUSE RENOVATIONS - V140

SHEET TITLE ELEVATIONS

DATE 17-07-11

SCALE AS NOTED

LOCATION POND INLET, NUNAVUT


CHECKED BY RS

DRAWN BY RQS

REVISION NO. 00
 ISSUED FOR CONSTRUCTION

A3.0


JOB NO. 17-024-01-30

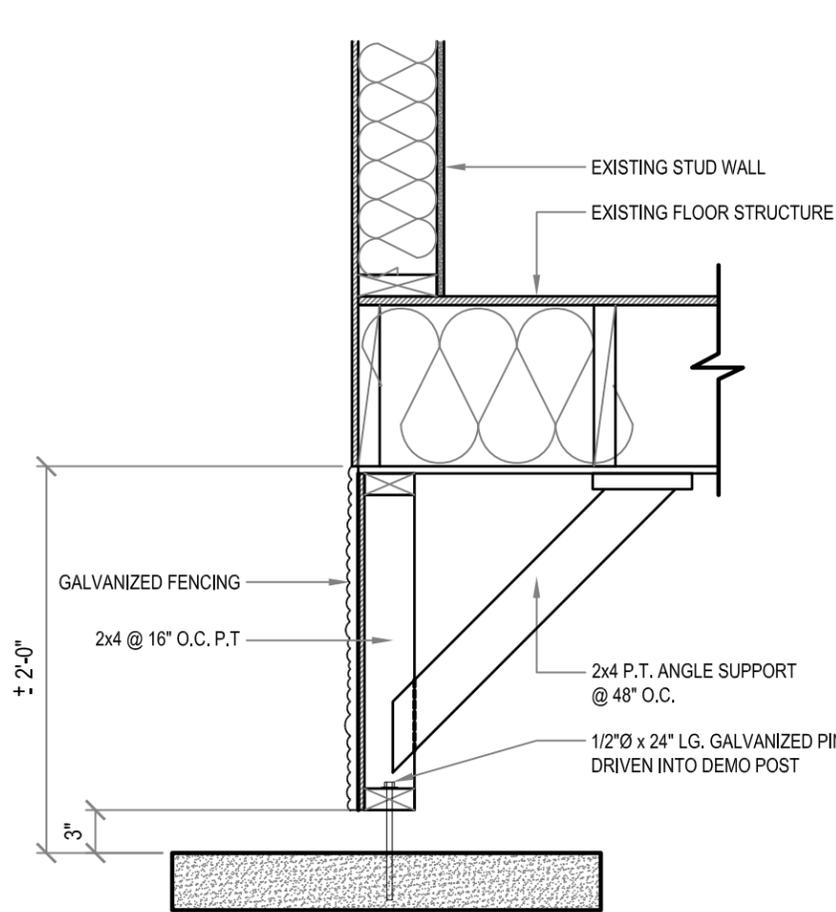


1 DETAIL OF SKIRTING
A4.0 SCALE: 3/16"=1'-0"

NOTES:

1. 6 MIL POLY RETURNED INTO ROUGH WINDOW OPENING AND SEALED TO WOOD FRAMING
2. AIR BARRIER RETURNED INTO ROUGH WINDOW OPENING AND SEALED TO WOOD FRAMING
3. SPRAY FOAM INSULATION INTO SPACES BETWEEN WINDOW AND ROUGH OPENING
4. PROVIDE PRE FINISHED POST FORMED GALVANIZED STEEL FLASHING FULL WIDTH OF WINDOW AT TOP OF WINDOW
5. BEDROOM WINDOWS MUST MEET NBC EGRESS REQUIREMENTS AS PER 9.7.1.3.2
6. INSTALL NEW WINDOW AND DOOR CASING TO ALL UNITS BEING REPLACED.

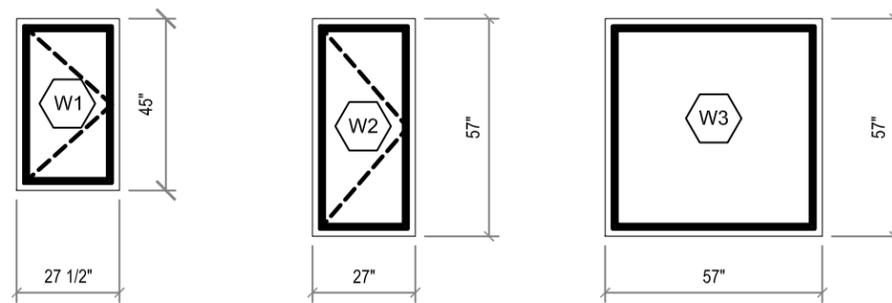


WINDOW ELEVATION

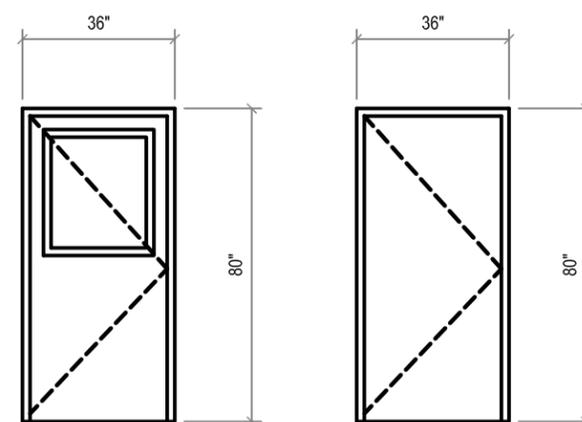


STORM DOOR

EXT. DOOR

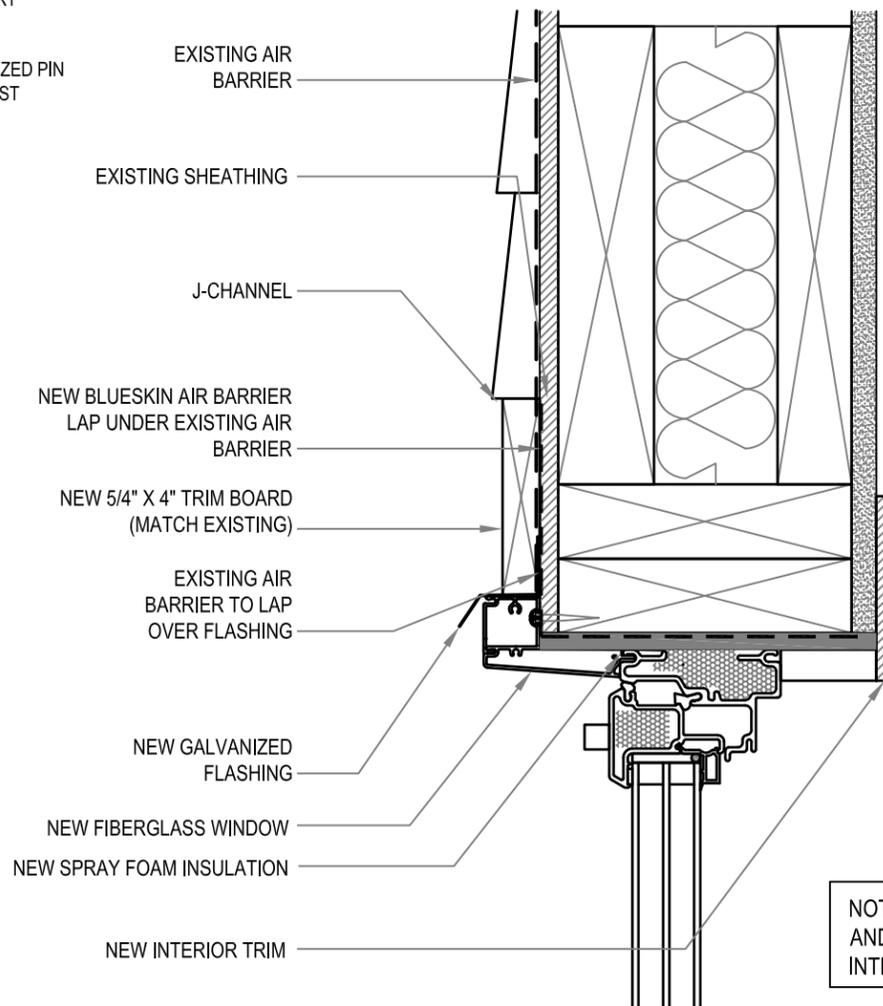

2 WINDOW HEAD DETAIL
A4.0 SCALE: 3/16"=1'-0"

NOTE: ENSURE THAT THE SPRAY FOAM AND THE BLUE SKIN CONNECT TO THE INTERIOR AIR VAPOUR BARRIER

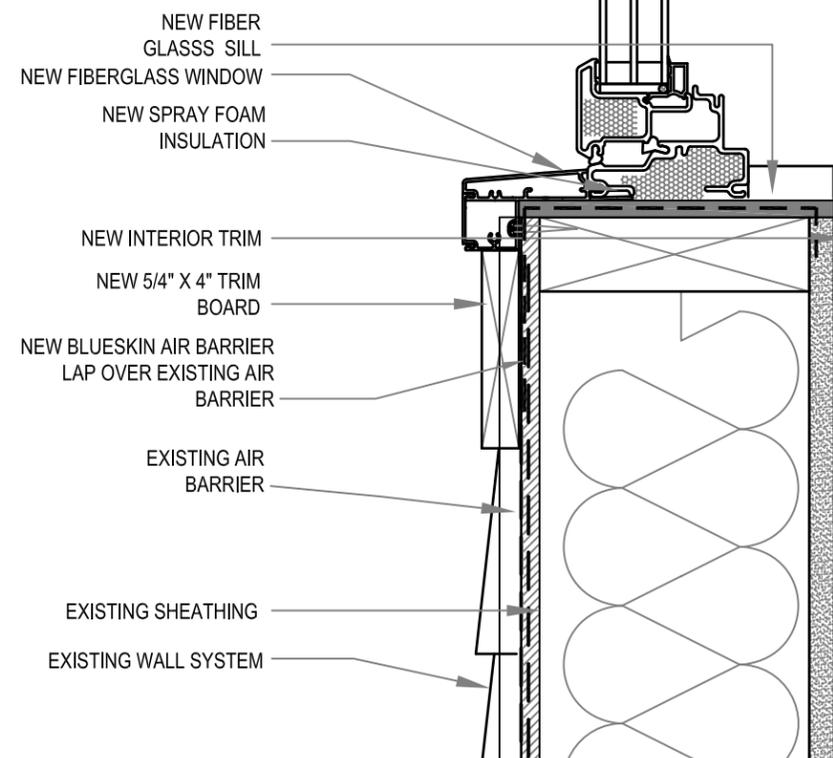

3 WINDOW SILL DETAIL
A4.0 SCALE: 3/16"=1'-0"

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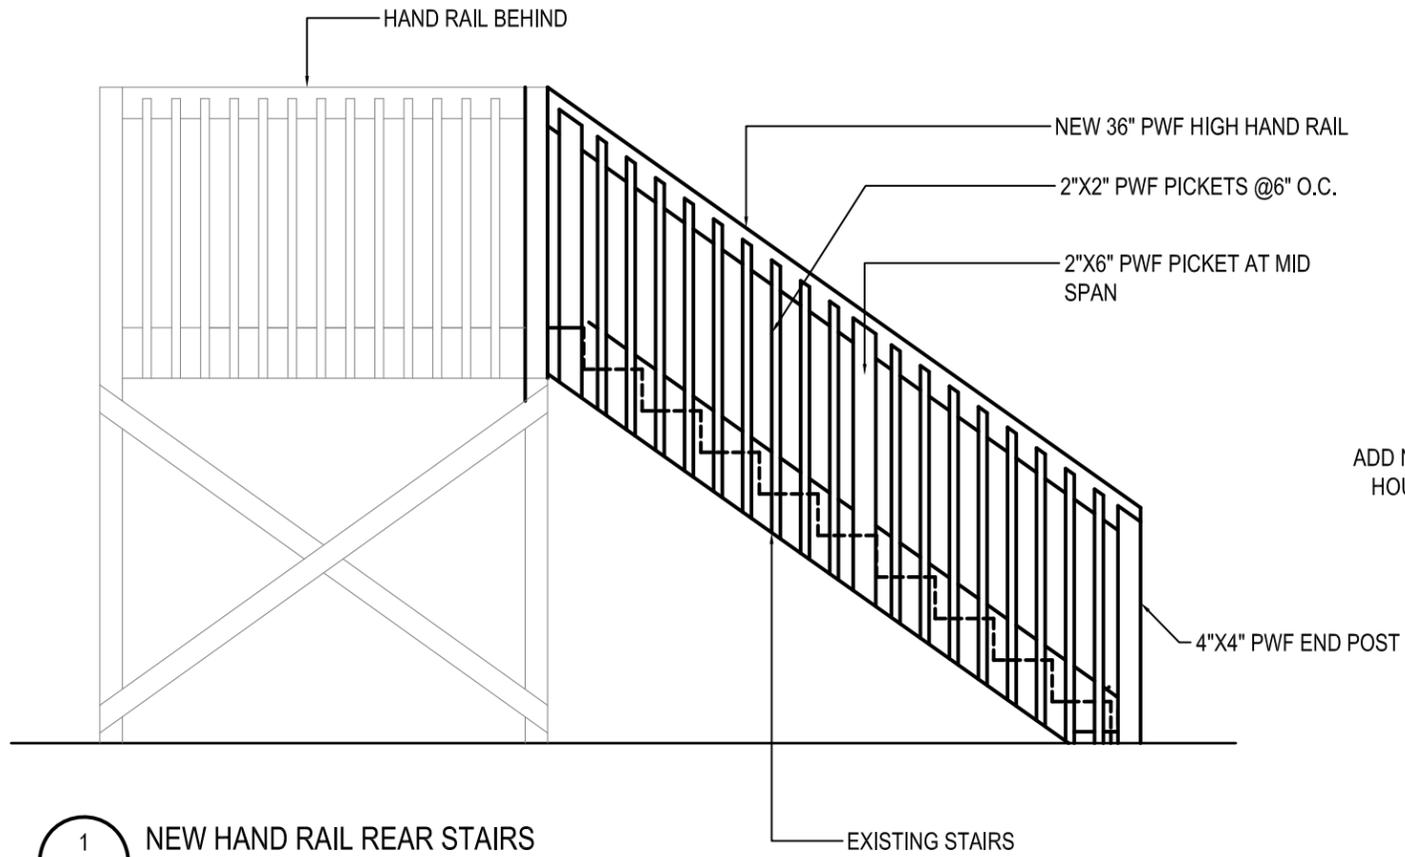


PROJECT TITLE: HOUSE RENOVATIONS - V140
SHEET TITLE: SCHD. OF DOORS & WINDOWS/DETAIL
DATE: 17-07-11
LOCATION: POND INLET, NUNAVUT
CHECKED BY: RS
DRAWN BY: RQS
SCALE: AS NOTED

REVISION NO. 00
ISSUED FOR CONSTRUCTION

A4.0

JOB NO. 17-024-01-30




ADD NEW HAND RAIL TO HOUSE SIDE OF STAIR



1 NEW HAND RAIL REAR STAIRS
A4.1 SCALE: 3/8"=1'-0"

2 EXISTING REAR STAIR PHOTO
A4.1 SCALE: NTS

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PROJECT TITLE
HOUSE RENOVATIONS - V140

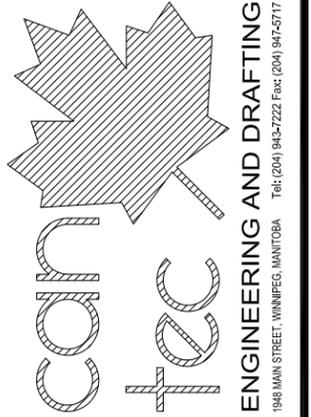SHEET TITLE
REAR HAND RAIL REPLACEMENT

DATE
17-06-09

SCALE
AS NOTED

LOCATION
POND INLET, NUNAVUT

DRAWN BY
RQS

CHECKED BY
RS

REVISION NO. 00
ISSUED FOR CONSTRUCTION

A4.1

JOB NO.
17-024-01-30