

Public Works Government Services Canada

Architectural and Engineering Services

Ontario Region

### Travaux publics Services gouvernementaux Canada

Services d'architecture et de génie

Région de l'Ontario

# X-Ray and Dental Rooms Collins Bay (Min) Building FF32N



Kingston Ontario
Correctional Service Canada
R.079534.002
Canadä

JITEOTI IDAI

CASEWORK

LIST OF DRAWINGS

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ARCHITECTURAL

DIALOG
2 BLOOR ST. EAST, SUITE 1100


TORONTO, ON. M4W 1A8


(647)966-0220 Fax: (416)966-02

DIALOG
2 BLOOR ST. EAST, SUITE 1100
TORONTO, ON. M4W 1A8

ELECTRICAL ENGINEER
DIALOG

2 BLOOR ST. EAST, SUITE 1100 TORONTO, ON. M4W 1A8

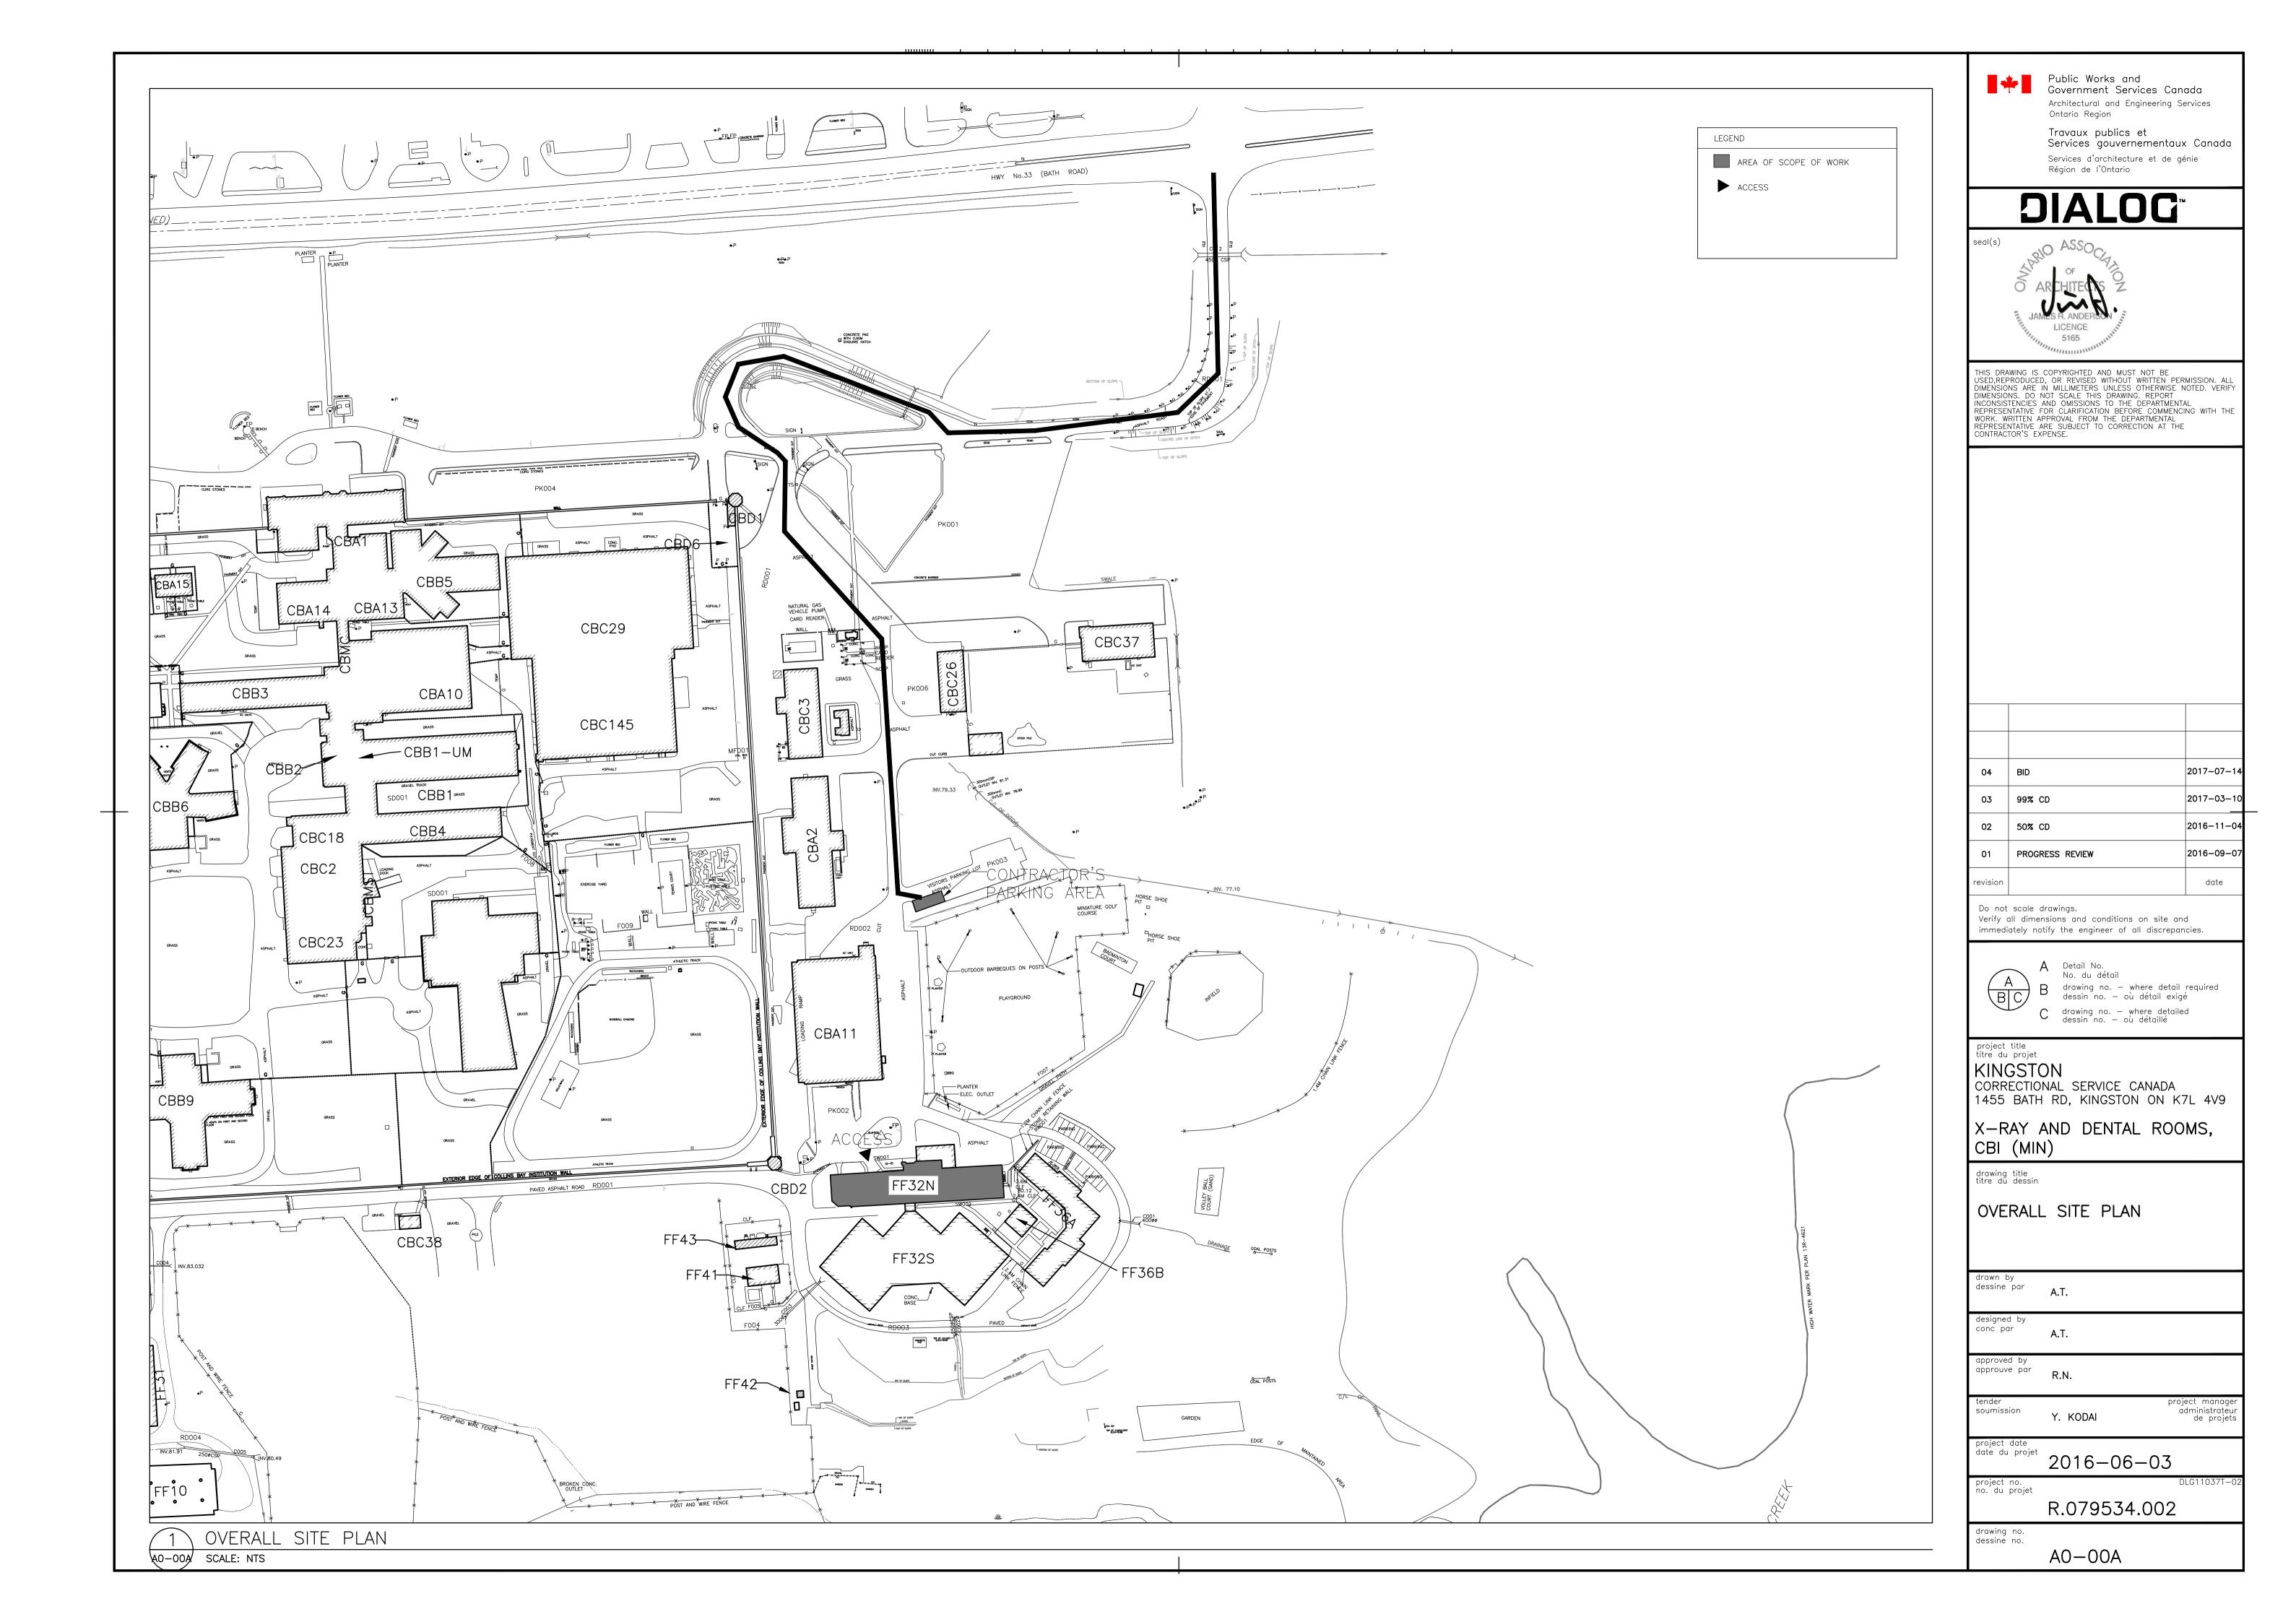

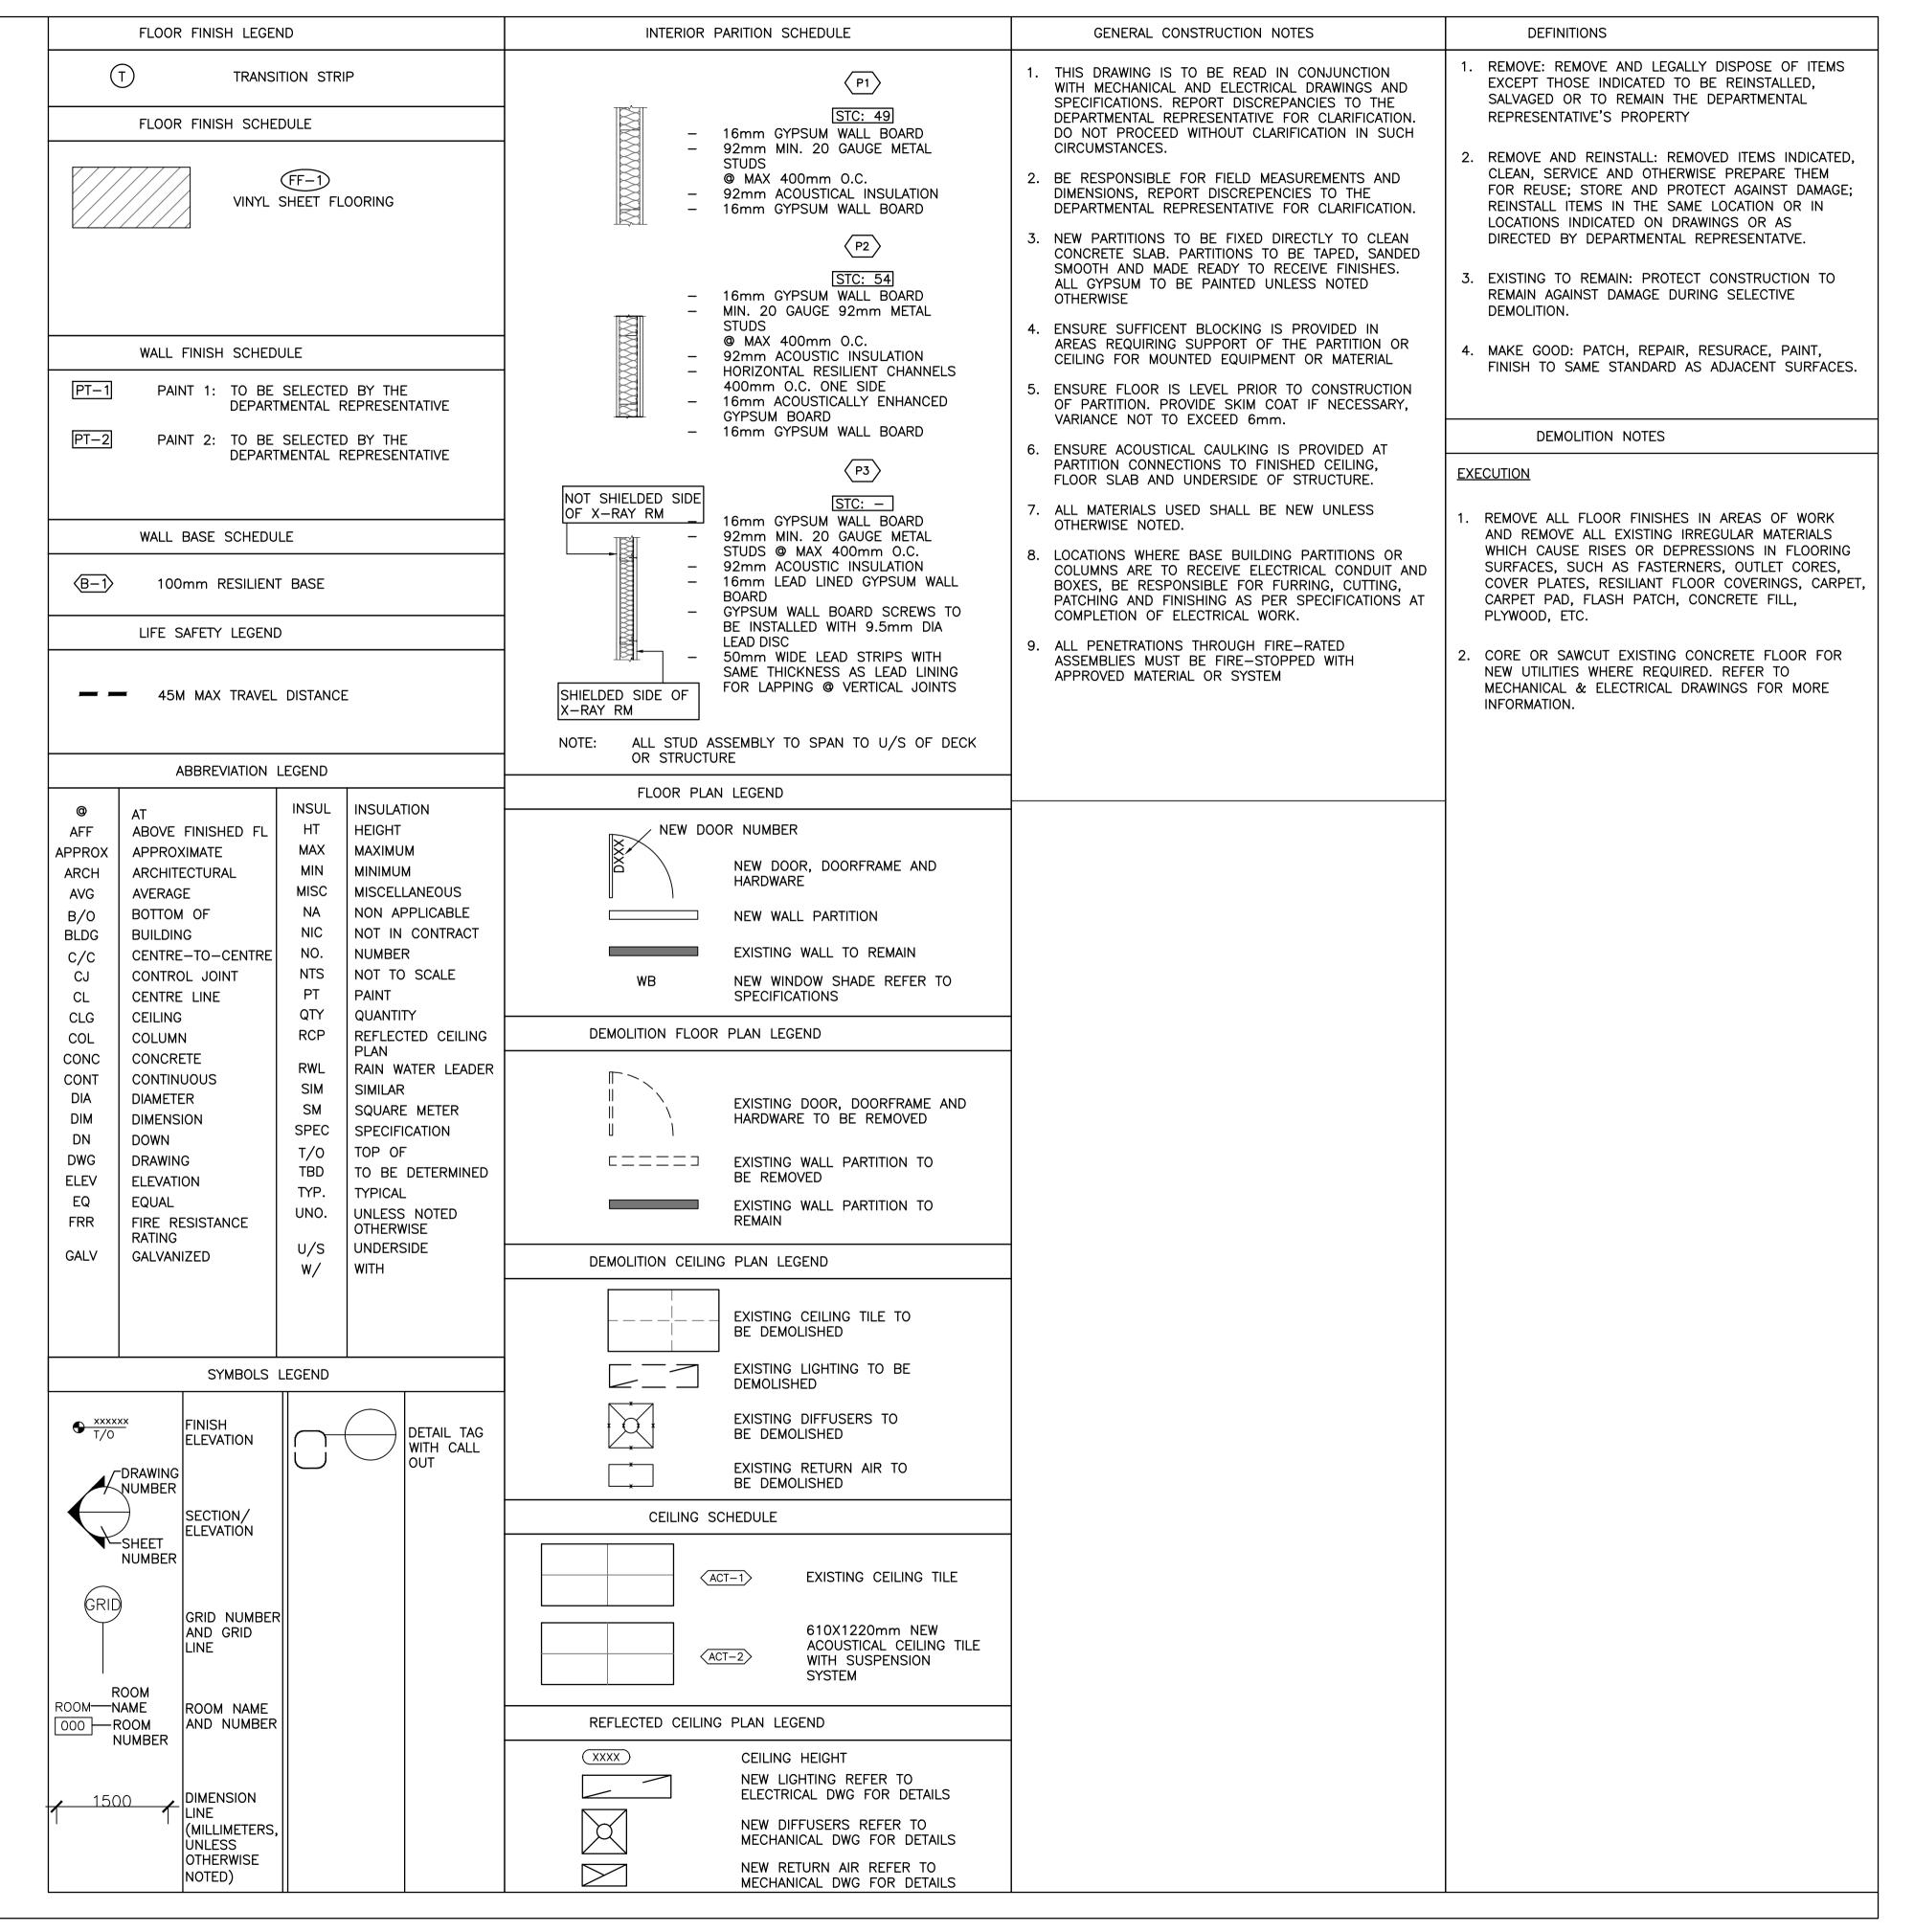

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 04
 BID
 2017-07-14

 03
 99% CD
 2017-03-10

 02
 50% CD
 2016-11-04

 01
 PROGRESS REVIEW
 2016-09-07

 revision
 date

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A Detail No.
No. du détail
B drawing no. — where detail required dessin no. — où détail exigé
C drawing no. — where detailed dessin no. — où détaillé

project title
titre du projet

KINGSTON

CORRECTIONAL SERVICE CANADA

1455 BATH RD, KINGSTON ON K7L 4V9

X-RAY AND DENTAL ROOMS, CBI (MIN)

drawing title titre du dessin

LEGENDS, SCHEDULES AND ABBREVIATIONS

drawn by dessine par

A.T.

designed by conc par

A.T.

approved by approuve par

R.N.

tender project managements

soumission

Y. KODAI

administrateur
de projets

project date

2016-06-03

project no. no. du projet

R.079534.002

drawing no. dessine no.

A0-01


DOOR	DESCRIPTIO	N AND ROOM NAME				DOORS				F	RAMES						GENERAL
OOR NO.	ROOM NO.	ROOM NAME	WIDTH	HEIGHT	TYPE	MATERIAL	FINISH	GLASS	NEW/EXT.	MATERIAL	FINISH	TYPE	NEW/EXT.	JAMB	HARDWARE	FRR	COMMENTS
D201	201	EXISTING CORRIDOR	915	2150	В	HM	PAINT	FG	NEW	НМ	PAINT	F2	NEW	J4	#1		CD, LM, M
D201A	201	EXISTING CORRIDOR	915	2150	В	НМ	PAINT	FG	NEW	НМ	PAINT	F2	NEW	J4	#1		CD, LM, M
D240	240	X-RAY SUITE	915	2150	С	LLHM	PAINT		NEW	LLHF	PAINT	F1	NEW	J1	<b>#</b> 1		CD, SG, LM, M
D240A	240A	VESTIBULE	915	2150	В	НМ	PAINT	TG	NEW	НМ	PAINT	F1	NEW	J1	#1		CD, SG, LM, M
D242	242	NURSING STATION	915	2150	С	НМ	PAINT		NEW	НМ	PAINT	F1	NEW	J1	#1		CD, SG, LM, M
D242A	242A	STORAGE ROOM	915	2150	С	НМ	PAINT		NEW	НМ	PAINT	F1	NEW	J1	#2		CD, SG, LM, M
D243-E	243	DENTAL TREATMENT	915	2150	Α	НМ	PAINT	TG	EXISTING	PSF	PAINT	F1	EXISTING	J3	EXISTING		
D243B	243B	STORAGE ROOM	915	2150	С	НМ	PAINT		NEW	НМ	PAINT	F1	NEW	J2	#2		CD, SG, LM, M


#### DOOR & FRAME SCHEDULE NOTES

- 1. PROVIDE PAINT TO ALL NEW AND EXISTING DOORS
- 2. PROVIDE PAINT TO ALL NEW AND EXISTING FRAMES
- 3. PROVIDE NEW HARDWARE FOR ALL DOORS AS SPECIFIED
- 4. CONTRACTOR TO VERIFY THAT CONDITION OF ALL DOORS TO BE RETAINED ARE IN SATISFACTORY CONDITIONS. ANY DISCREPENCIES TO BE BROUGHT TO THE ATTENTION OF THE DEPARTMENTAL REPRESENTATIVE

### 1 DOOR AND HARDWARE SCHEDULE

A0-02 SCALE: NTS

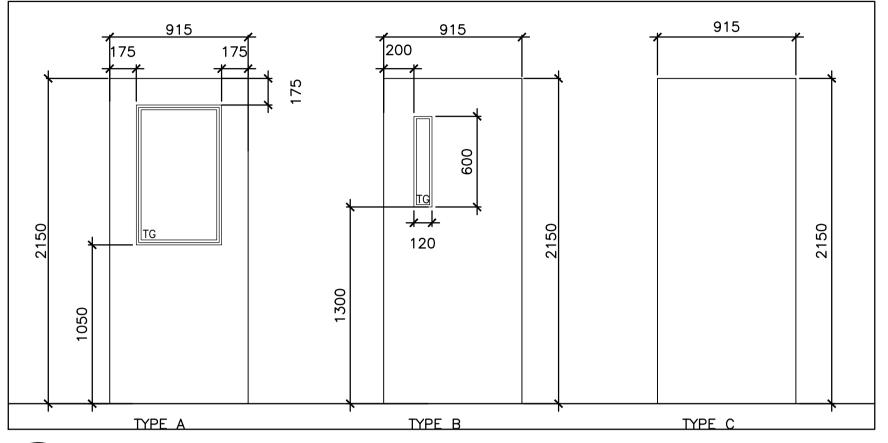


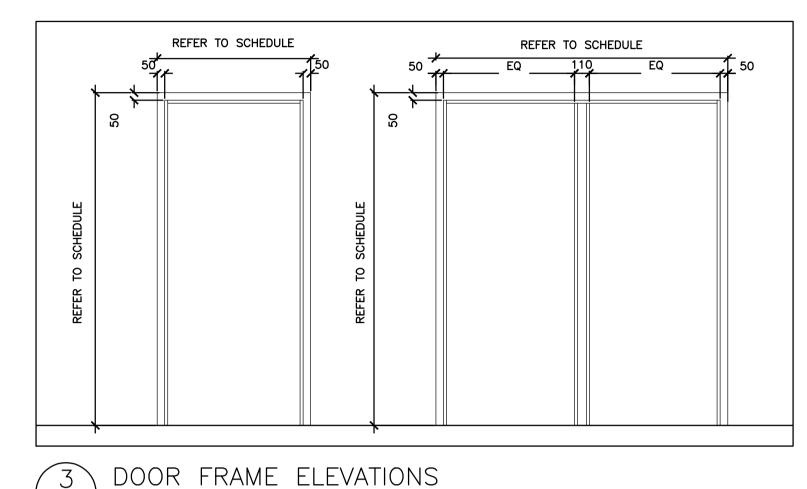


#### **LEGEND** ACOUSTICAL CEILING TILE HOLLOW METAL FRAME НМ FG FIRE RATED GLASS LEAD LINED HOLLOW METAL FRAME LLHF LLHM LEAD LINED HOLLOW METAL DOOR LLGL LEAD LINED GLAZING PRESSED STEEL FRAME PSF SCW SOLID CORE WOOD SWING DOOR MANUAL LOCK ELECTRIC LOCK MANUAL DETENTION DOORS - SWING CD COMMERICAL DOORS TG TEMPERED SAFETY GLASS

### 2 DOOR TYPES ELEVATIONS

A0-02 SCALE: 1:25

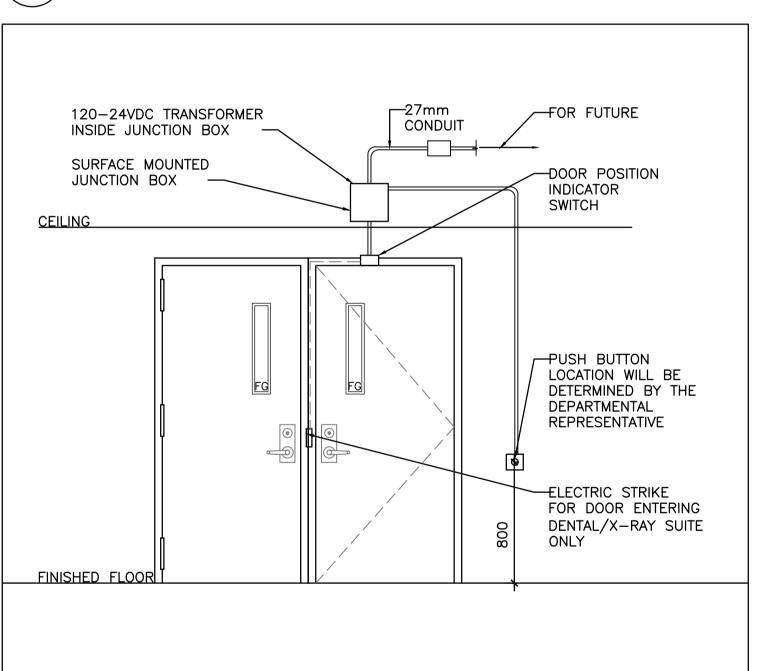

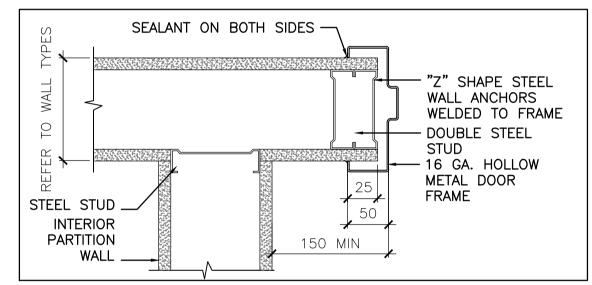



- HOLLOW CORE

METAL DOOR

- ELECTRIC STRIKER REFER TO HARDWARE SCHEDULE FOR LOCATION

SCALE: 1:25

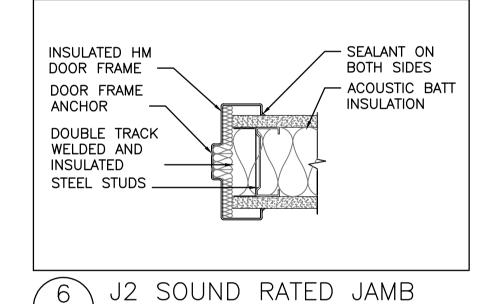

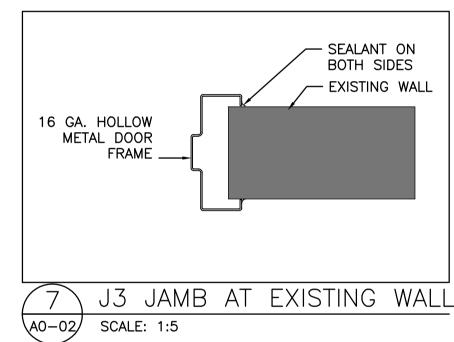

5 J1 JAMB AT INTERIOR WALL

A0-02 SCALE: 1:5

EXISTING CORRIDOR SIDE

110

DENTAL/X-RAY

SUITE ŚIDE

HOLLOW CORE METAL DOOR - \A0-02/

LEAD SHIELDING
AT INSIDE OF
FRAME PROFILE

200mm 20
GAUGE MIN
STEEL STUD
FRAMING

LEAD BACKED
DRY WALL


VESTIBULE

240A

VESTIBULE

240A

SCALE: 1:5

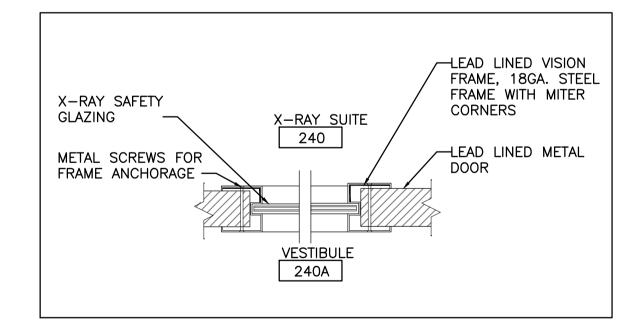

8 J4 JAMB AT CORRIDOR DOOR 40-02 SCALE: 1:5


9 SHIELDED WINDOW A0-02 SCALE: 1:10

A0-02

10 SHIELDED DOOR WITH WINDOW SCALE: 1:5

# 4 CORRIDOR DOOR SECURITY A0-02 SCALE: 1:25

DOO	R HARDWARE G	GROUP NO. #1		
	SE ON MARK/DOOR #(S D201A, D240, D240A	5):		
PROVID	DE EACH SGL DOOR(S)	WITH THE FOLLOWING:		
QTY D	ESCRIPTION	CATALOG NUMBER	FINISH	MFR
1 EA	HINGE OFFICE LOCK PRIMUS UL437-XP	L9056L 03B L583-363 ´	652 626 626	ANSI SCH SCH
	SURFACE CLOSER	1461 REG (C02011/C02041 PT-4A, PT-4C, PT-4D, PT-4F PT-4H)		ANSI
1 EA 1 EA 1 EA (SURF)	DOOR BOTTOM	WS401/402CVX (L12101) #485A (1XW 2XH) 365AA6 X DR WIDTH	626 A AA	ANSI ZER ZER

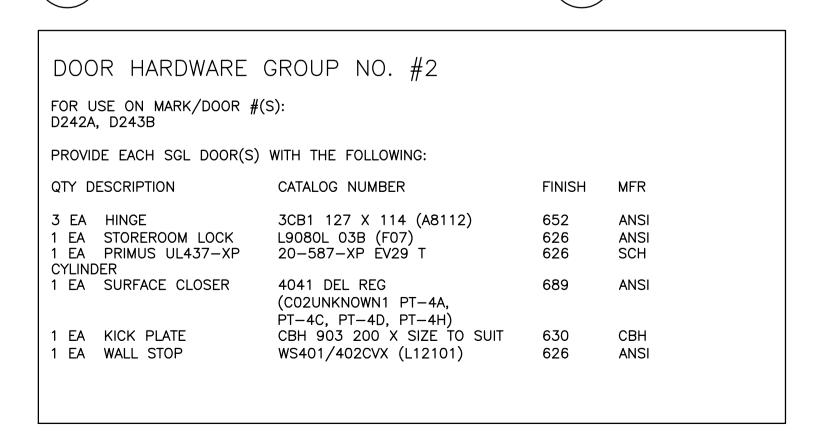




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KINGSTON

CORRECTIONAL SERVICE CANADA

1455 BATH RD, KINGSTON ON K7L 4V9
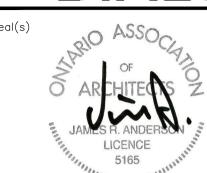
# X-RAY AND DENTAL ROOMS, CBI (MIN)

drawing title titre du dessin


DOOR AND FRAME SCHEDULE

drawn by dessine par	A.T.	
designed by conc par	A.T.	
approved by approuve par	R.N.	
tender soumission	Y. KODAI	project manag administrate de proje
project date		

2016-06-03

DLG11037T-0 R.079534.002

drawing no. dessine no. A0-02

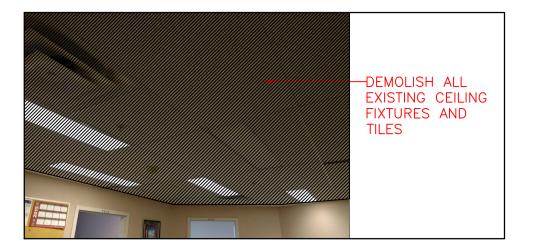

EXISTING RM 240 CEILING

A2-00

SCALE: 1:50

ALL EXISTING WINDOWS TO REMAIN WINDOW TRIM TO BE PAINTED TO MATCH NEW EXISTING WALL TO REMAIN, APPLY NEW PAINT

EXISTING RM 240B


SCALE: 1:50

\A2-00/




BE DEMOLISHED -ALL EXISTING CEILING FIXTURES AND TILES TO BE DEMOLISHED EXISTING WALL TO REMAIN, APPLY NEW PAINT ALL EXISTING WINDOWS TO REMAIN WINDOW TRIM TO BE PAINTED TO MATCH NEW PERIMETER RADIATORS TO REMAIN

EXISTING RM 240D \A2-00/ SCALE: 1:50

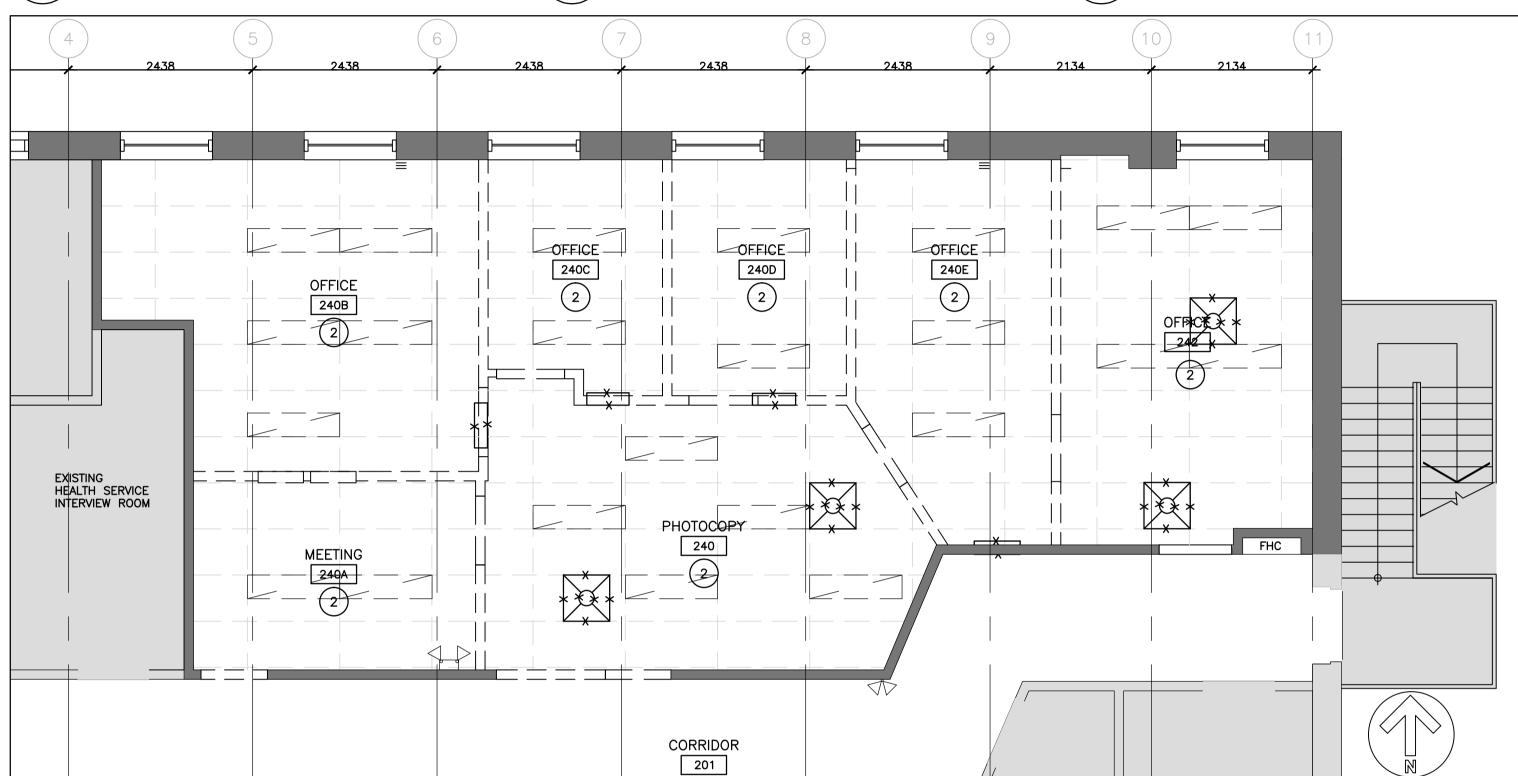

DEMOLITION REFLECTED CEILING PLAN

\A2-00/ SCALE: 1:50

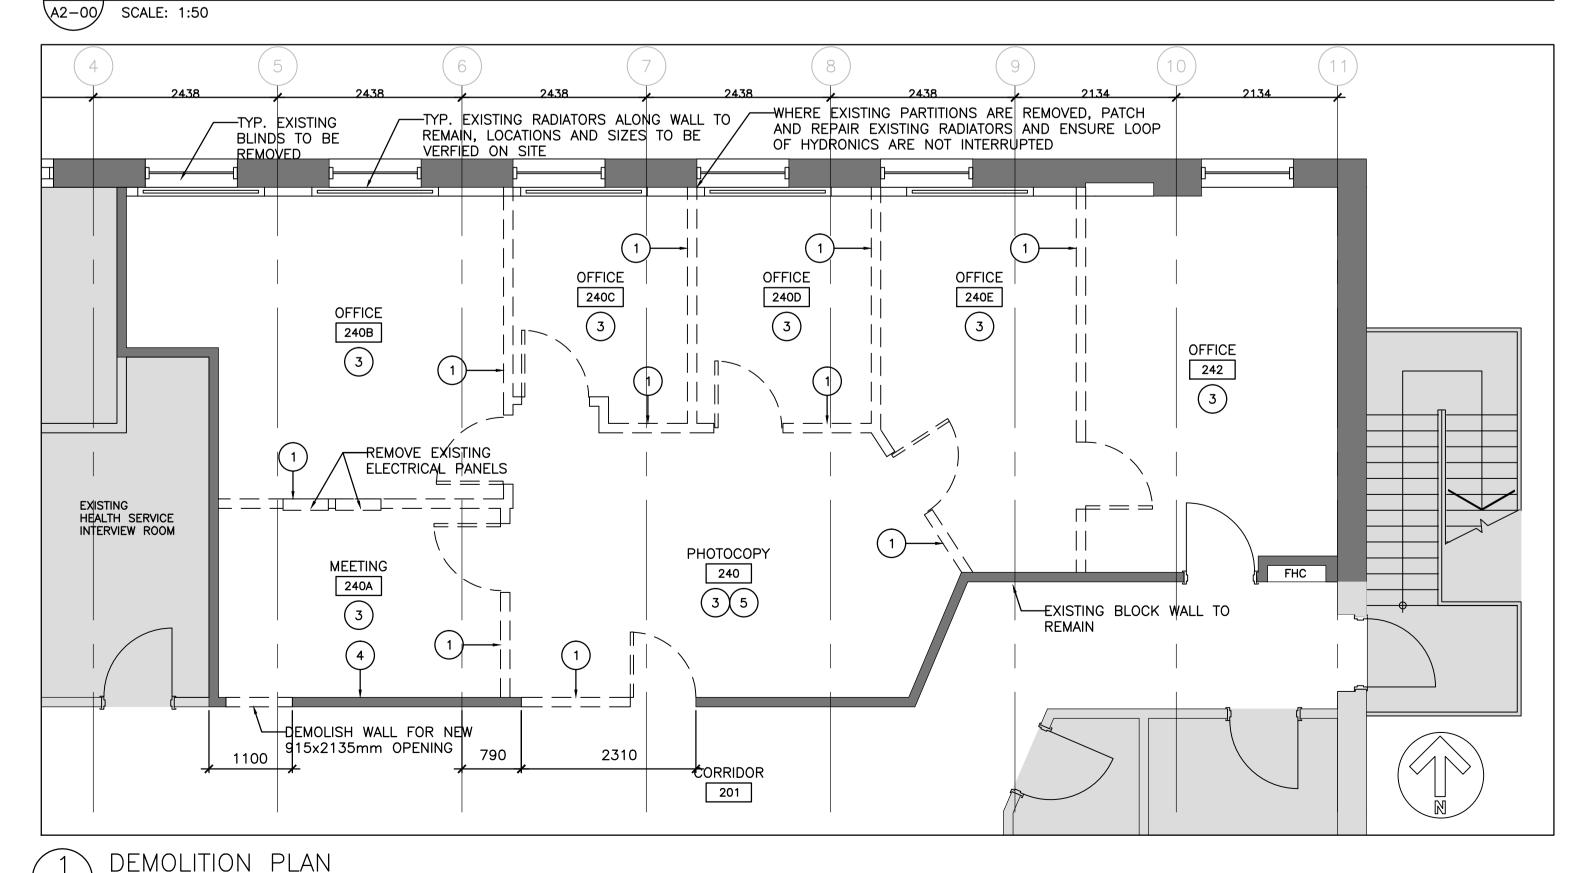

EXISTING DOOR, DOORFRAME AND HARDWARE TO BE REMOVED


BE REMOVED

EXISTING WALL PARTITION TO

EXISTING WALL PARTITION TO

DEMOLITION CEILING PLAN LEGEND

DEMOLITION FLOOR PLAN LEGEND

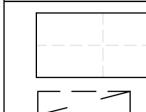

EXISTING CEILING TILE TO BE DEMOLISHED

EXISTING LIGHTING TO BE DEMOLISHED

EXISTING RETURN AIR TO BE DEMOLISHED

EXISTING DIFFUSERS TO

BE DEMOLISHED

**DEFINITIONS** 

- REMOVE: REMOVE AND LEGALLY DISPOSE OF ITEMS EXCEPT THOSE INDICATED TO BE REINSTALLED, SALVAGED OR TO REMAIN THE DEPARTMENTAL REPRESENTATIVE'S PROPERTY
- 2. REMOVE AND REINSTALL: REMOVED ITEMS INDICATED, CLEAN, SERVICE AND OTHERWISE PREPARE THEM FOR REUSE; STORE AND PROTECT AGAINST DAMAGE; REINSTALL ITEMS IN THE SAME LOCATION OR IN LOCATIONS INDICATED ON DRAWINGS OR AS DIRECTED BY DEPARTMENTAL REPRESENTATVE.
- EXISTING TO REMAIN: PROTECT CONSTRUCTION TO REMAIN AGAINST DAMAGE DURING SELECTIVE DEMOLITION.
- 4. MAKE GOOD: PATCH, REPAIR, RESURACE, PAINT, FINISH TO SAME STANDARD AS ADJACENT SURFACES.

DEMOLITION NOTES

#### **EXECUTION**

- REMOVE ALL FLOOR FINISHES IN AREAS OF WORK AND REMOVE ALL EXISTING IRREGULAR MATERIALS WHICH CAUSE RISES OR DEPRESSIONS IN FLOORING SURFACES, SUCH AS FASTERNERS, OUTLET CORES, COVER PLATES, RESILIANT FLOOR COVERINGS, CARPET, CARPET PAD, FLASH PATCH, CONCRETE FILL, PLYWOOD, ETC.
- 2. CORE OR SAWCUT EXISTING CONCRETE FLOOR FOR NEW UTILITIES WHERE REQUIRED. REFER TO MECHANICAL & ELECTRICAL DRAWINGS FOR MORE INFORMATION.

#### DEMOLITION KEYNOTES

DEMO KEY NOTES TO BE READ IN CONJUNCTION WITH ALL DOCUMENTS INCLUDING ARCHITECTURAL, MECHANICAL, ELECTRICAL AND DRAWINGS AND SPECIFICATIONS.

- 1.) REMOVE EXISTING INTERIOR WALL PARTITIONS INCLUDING CLADDING, SUPPORTING STRUCTURE, DOORS, AND SIMILAR ITEMS FROM FLOOR TO STRUCTURE ABOVE. CONTRACTOR SHALL ASSUME THAT MANY PARTITIONS ARE FROM ORIGINAL CONSTRUCTION. WORK SHALL INCLUDE REMOVAL OF T&B PLATES AND INFILL OF ANY DEPRESSIONS IN FLOOR AFTER REMOVAL OF PLATES.
- ( 2.) REMOVE EXISTING CEILINGS; SUSPENDED ACOUSTIC igcup TILE AND GRID SYSTEM AND SUSPENDED GYPSUMBOARD CEILINGS. REMOVE ALL FRAMING ABOVE FOR SUSPENDED CEILINGS. REMOVE THE REMAINDER OF THE ORIGINAL SUSPENDED CEILING SYSTEM FROM UNDERSIDE OF STEEL STRUCTURE.
- ( 3. ) REMOVE EXISTING VINYL TILE INCLUDING ADHESIVE FROM EXISTING CONCRETE FLOOR SLAB. PREPARE EXISTING CONCRETE SUBSTRATE TO ACCEPT NEW FLOORING.
- (4.) REMOVAL OF EXISTING FINISHES TO EXPOSE THE ✓ STRUCTURAL SYSTEM
- (5.) ASSUMED FLOOR CONSTRUCTION CONCRETE TOPPING ON STEEL PAN DECKING ON O.W.S.J. WITH SUSPENDED CEILING BELOW

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Detail No. No. du détail drawing no. — where detail required

drawing no. — where detailed

project title titre du projet KINGSTON CORRECTIONAL SERVICE CANADA 1455 BATH RD, KINGSTON ON K7L 4V9

X-RAY AND DENTAL ROOMS, CBI (MIN)

drawing title titre du dessin

DEMOLITION FLOOR AND REFLECTED CEILING PLAN

drawn by dessine par conc par A.T approuve par

soumission Y. KODAI


2016-06-03

ádministratéur

R.079534.002

drawing no. dessine no.


A2 - 00

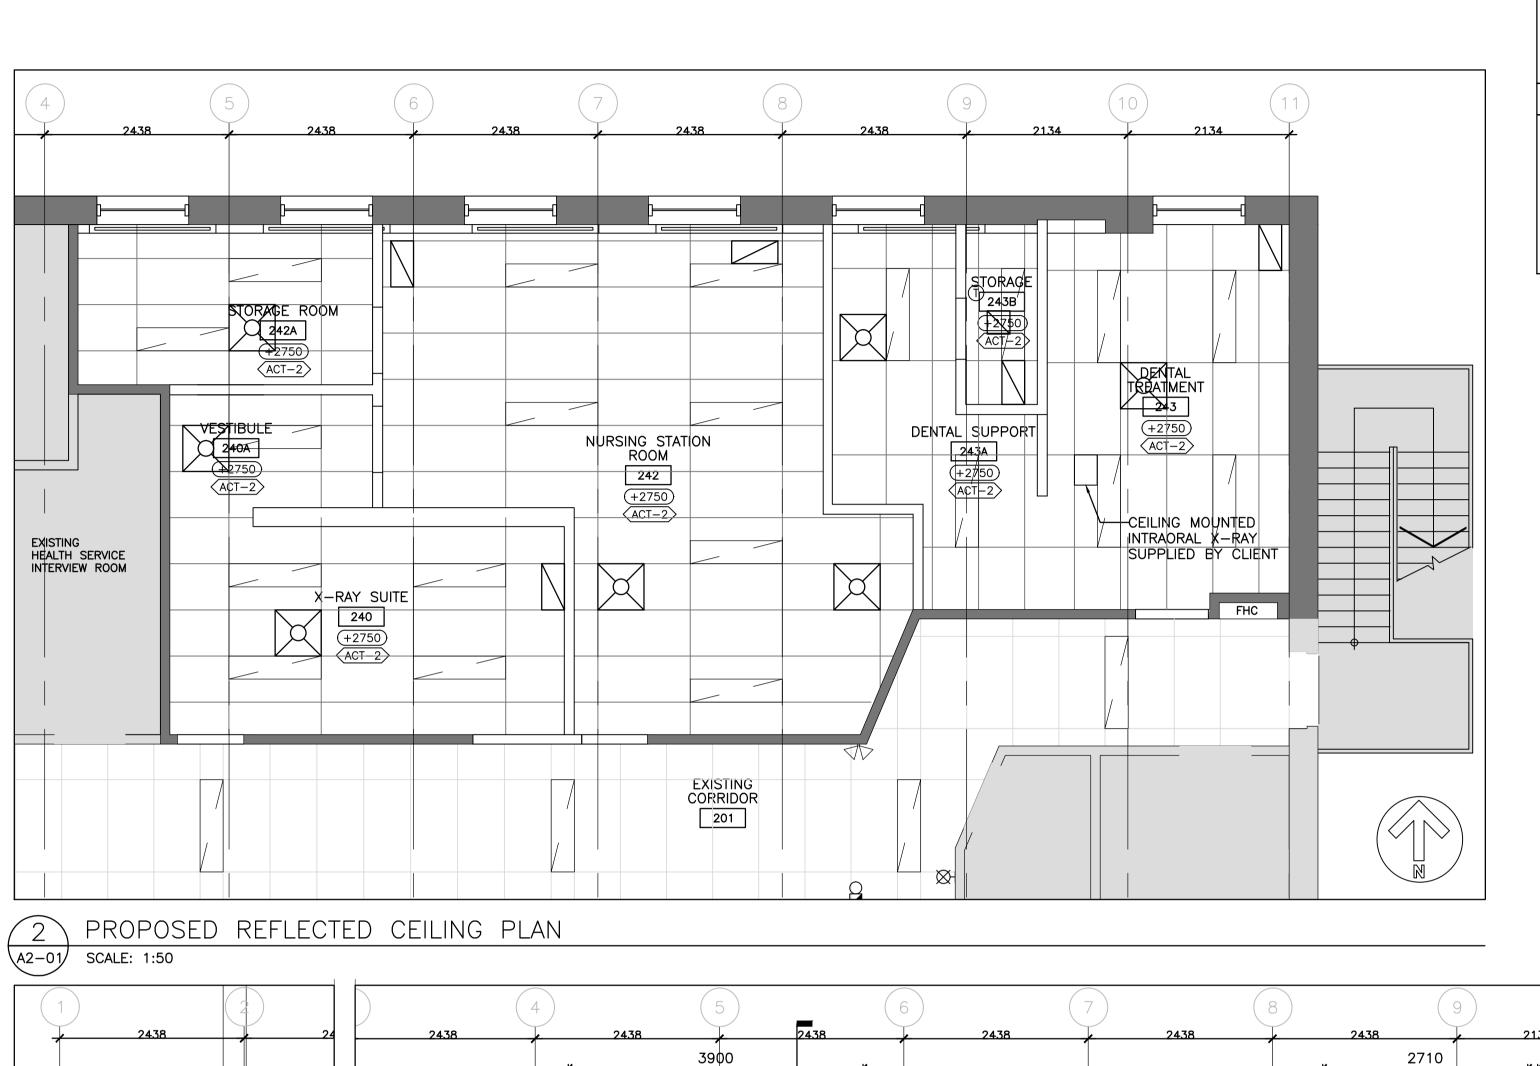

PROPOSED FLOOR PLAN

\A2-01/

SCALE: 1:50

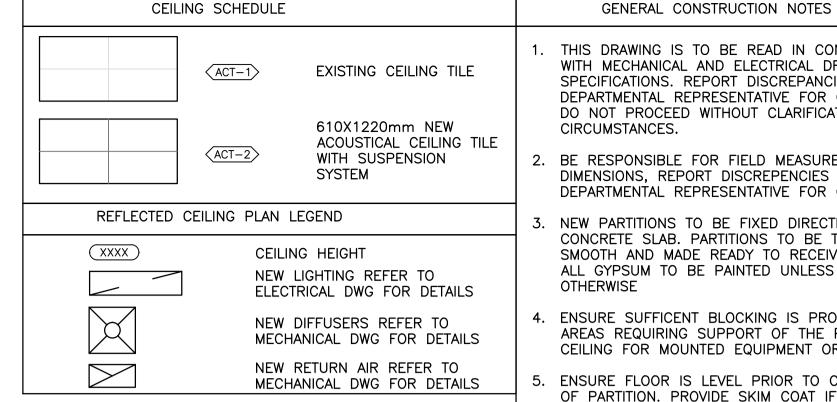

1. THIS DRAWING IS TO BE READ IN CONJUNCTION WITH MECHANICAL AND ELECTRICAL DRAWINGS AND SPECIFICATIONS. REPORT DISCREPANCIES TO THE DEPARTMENTAL REPRESENTATIVE FOR CLARIFICATION. DO NOT PROCEED WITHOUT CLARIFICATION IN SUCH CIRCUMSTANCES.

2. BE RESPONSIBLE FOR FIELD MEASUREMENTS AND DIMENSIONS, REPORT DISCREPENCIES TO THE DEPARTMENTAL REPRESENTATIVE FOR CLARIFICATION.

3. NEW PARTITIONS TO BE FIXED DIRECTLY TO CLEAN CONCRETE SLAB. PARTITIONS TO BE TAPED, SANDED SMOOTH AND MADE READY TO RECEIVE FINISHES. ALL GYPSUM TO BE PAINTED UNLESS NOTED OTHERWISE

4. ENSURE SUFFICENT BLOCKING IS PROVIDED IN AREAS REQUIRING SUPPORT OF THE PARTITION OR CEILING FOR MOUNTED EQUIPMENT OR MATERIAL

5. ENSURE FLOOR IS LEVEL PRIOR TO CONSTRUCTION OF PARTITION. PROVIDE SKIM COAT IF NECESSARY, VARIANCE NOT TO EXCEED 6mm.

PARTITION CONNECTIONS TO FINISHED CEILING, FLOOR SLAB AND UNDERSIDE OF STRUCTURE.

6. ENSURE ACOUSTICAL CAULKING IS PROVIDED AT

7. ALL MATERIALS USED SHALL BE NEW UNLESS OTHERWISE NOTED.

8. LOCATIONS WHERE BASE BUILDING PARTITIONS OR COLUMNS ARE TO RECEIVE ELECTRICAL CONDUIT AND BOXES, BE RESPONSIBLE FOR FURRING, CUTTING, PATCHING AND FINISHING AS PER SPECIFICATIONS AT COMPLETION OF ELECTRICAL WORK.

9. ALL PENETRATIONS THROUGH FIRE-RATED ASSEMBLIES MUST BE FIRE-STOPPED WITH APPROVED MATERIAL OR SYSTEM

#### INTERIOR PARITION SCHEDULE

16mm GYPSUM WALL BOARD 92mm MIN. 20 GAUGE METAL STUDS

@ MAX 400mm O.C. 92mm ACOUSTICAL INSULATION 16mm GYPSUM WALL BOARD

 $\langle P2 \rangle$ 

P1

16mm GYPSUM WALL BOARD MIN. 20 GAUGE 92mm METAL STUDS

@ MAX 400mm O.C. 92mm ACOUSTIC INSULATION HORIZONTAL RESILIENT CHANNELS 400mm O.C. ONE SIDE 16mm ACOUSTICALLY ENHANCED

GYPSUM BOARD 16mm GYPSUM WALL BOARD

P3

NOT SHIELDED SIDE OF X-RAY RM

STC: -16mm GYPSUM WALL BOARD 92mm MIN. 20 GAUGE METAL STUDS @ MAX 400mm O.C. 92mm ACOUSTIC INSULATION 16mm LEAD LINED GYPSUM WALL GYPSUM WALL BOARD SCREWS TO BE INSTALLED WITH 9.5mm DIA LEAD DISC 50mm WIDE LEAD STRIPS WITH

SAME THICKNESS AS LEAD LINING

FOR LAPPING @ VERTICAL JOINTS

SHIELDED SIDE OF X-RAY RM

ALL STUD ASSEMBLY TO SPAN TO U/S OF DECK OR STRUCTURE

#### FLOOR PLAN LEGEND

NEW DOOR NUMBER

WB

NEW DOOR, DOORFRAME AND HARDWARE

NEW WALL PARTITION

EXISTING WALL TO REMAIN

NEW WINDOW SHADE REFER TO SPECIFICATIONS


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PROPOSED FLOOR AND REFLECTED CEILING PLAN


drawn by dessine par A.T. conc par A.T. approuve par ádministratéur soumission

Y. KODAI

2016-06-03

R.079534.002 drawing no. dessine no.

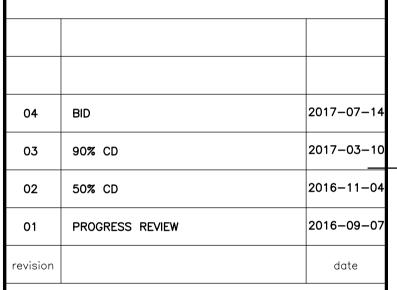A2 - 01

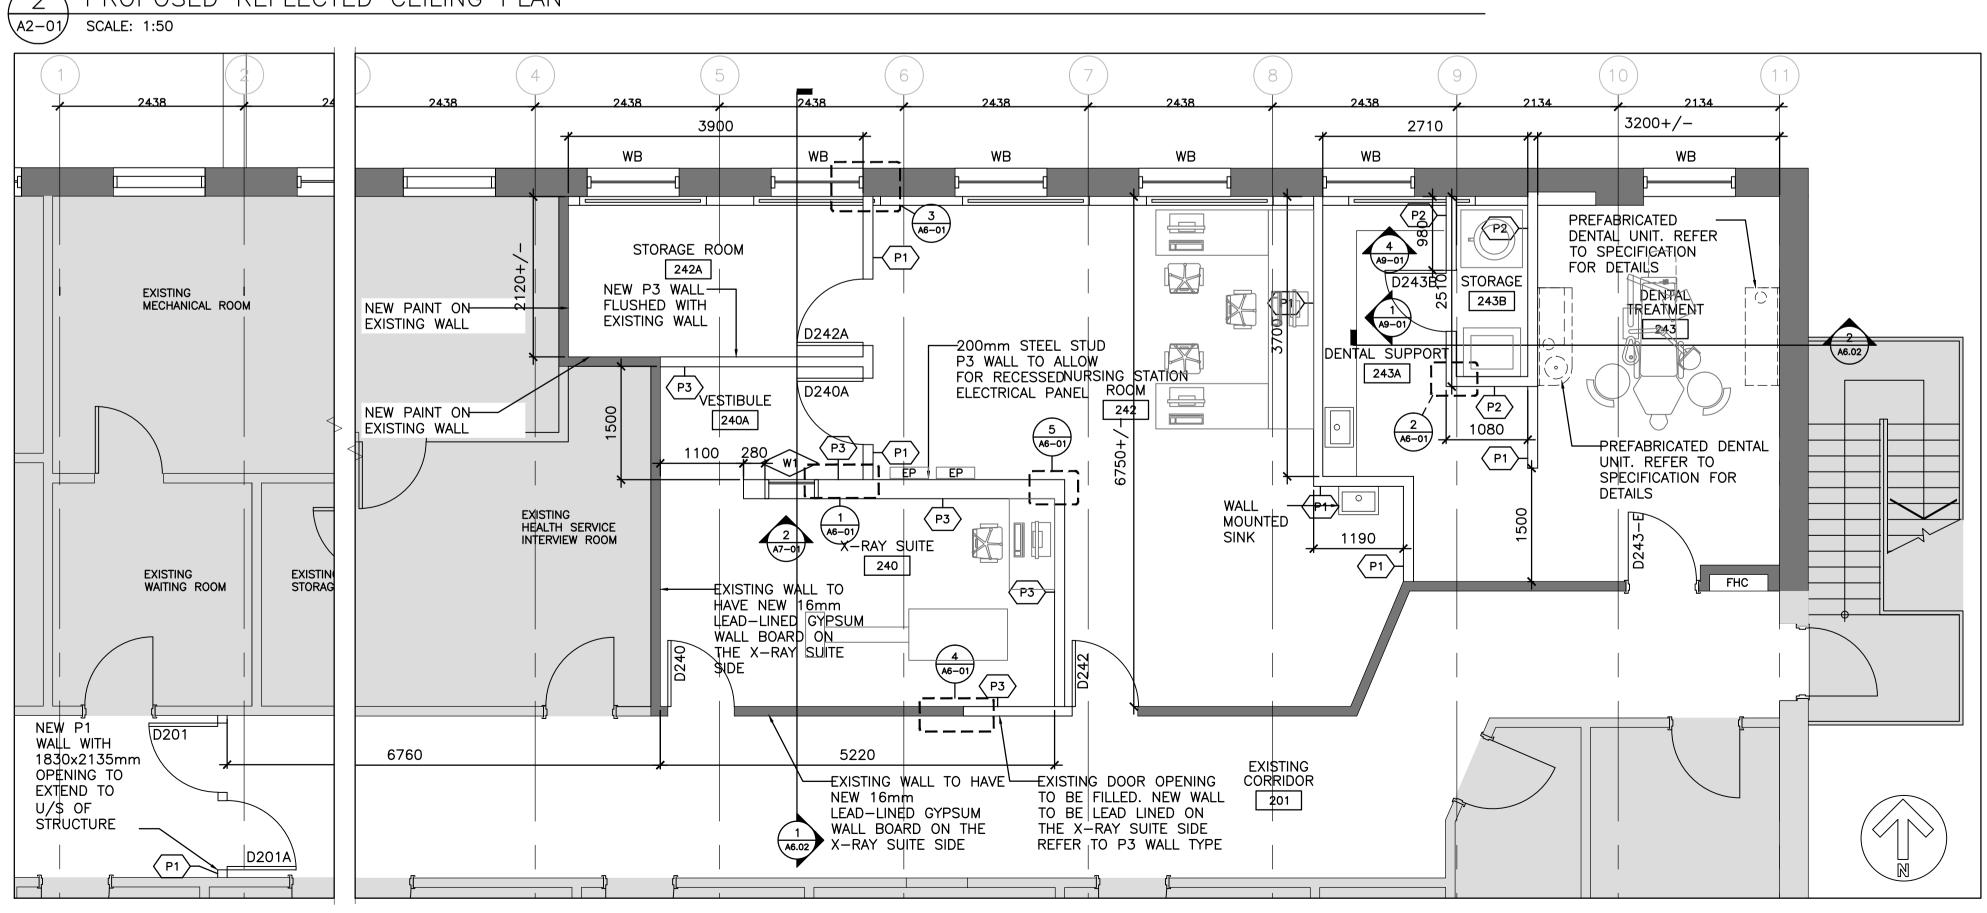

### NEW ROOF TOP UNIT NEW 150×150 SLEEPERS UNDER R.T.U. OFFSET 'D' - SEE DETAIL Y ✓ WHEN OFFSET DIMENSION D => 150mm PROVIDE NEW DOUBLE ANGLES PROVIDE TEMPORY -2-L'S 55x55x5 DIAGONALS SHORING TO JOISTS TO THE NEAREST JOIST DURING WELDING BOTTOM CHORD PANEL POINT. TYPICAL SECTION X DETAIL TYPICAL WEB ANGLE CONNECTION

#### ROOF FRAMING PLAN NOTES

- 1. CONTRACTOR IS TO PROVIDE ADEQUATE SHORING AND ALL TEMPORARY WORKS DURING CONSTRUCTION FOR THE SAFE INSTALLATION OF ALL CONSTRUCTION MATERIALS. DESIGN AND CONSTRICTION OF SUCH SHORING AND TEMPORARY WORKS SHALL BE THE RESPONSIBILITY OF THE CONTRACTOR.
- 2. FOR REFERENCE ONLY: TOP OF EXISTING ROOF DATUM ELEVATION @ HIGH POINT = TOP OF STEEL ELEVATION =  $\pm 7300$ ABOVE FINISHED GROUND FLOOR (TO BE SITE VERIFIED).
- 3. EXISTING INFORMATION OBTAINED FROM AS-BUILT DRAWINGS PREPARED BY R. W. CATTO-CHIEF DATED MARCH 1961. SITE VERIFY ALL CRITICAL SHOP DRAWING INFORMATION AND REPORT TO THE CONSULTANT DISCREPANCIES THAT HAVE THE POTENTIAL TO AFFECT THE WORK AND OBTAIN INSTRUCTIONS PRIOR TO PROCEEDING WITH THE WORK.
- 4. ROOF DESIGN LIVE LOAD = Ss(Cb)(Ca)(Cs)+Sr =2.1(0.8)(1)(1)+0.4 = 2.08 KPa. ADDITIONAL SNOW LOAD FROM SNOW PILING (IF ANY) IS SHOWN ON PLAN AS 'ASL'
- 5. ROOF DESIGN DEAD LOAD PARAMETERS:


BALLASTED EPDM ROOFING = 0.53 KPa = 0.08 KPa 12mm FIBREBOARD = 0.02 KPa 38mm INSULATION 22mm T&G SHEATHING = 0.14 KPa2×4 LAMINATED DECK = 0.43 KPa = 0.05 KPa 2×6 NAILING STRIP MECHANICAL + ELECTRICAL = 0.15 KPa T-BAR CEILING & MISC. <u>= 0.10 KPa</u>

TOTAL DEAD LOAD FOR THE DESIGN OF STEEL JOISTS (EXCLUSIVE OF JOIST = 1.50 KPa SELF WEIGHT)


- TOTAL DEAD + LIVE LOAD ON EXISTING ROOF JOISTS = 2.08 kPa + 1.50 kPa = 3.58 kPaTOTAL UNIFORM LOADING ON EXISTING ROOF JOISTS SPACED @ 2438mm O/C = 8.72 KN/mEXISTING ROOF JOISTS HAVE BEEN DESIGNED FOR A TOTAL UNIFORM LOADING LOADING OF 9.34 KN/m (PER EXISTING RECORD DRAWINGS).
- 7. NEW ROOF TOP MECHANICAL UNIT RTU-1 HAS DIMENSIONS OF 1725mm x 1100mm x 1350 mm HIGH (INCLUDES CURB HEIGHT OF 350mm). THE EFFECTS OF THE ROOF TOP MECHANICAL UNIT ACTING AS AN OBSTRUCTION ON THE SNOW LOADING CAN BE IGNORED SINCE THE LENGTH OF RTU-1 (b=1.725 m) < (S\*Ss/3)=2.1 m. NO ADDITIONAL SNOW ACCUMULATION AROUND THE UNIT.


THE OPERATING WEIGHT OF THE NEW RTU-1 IS 320 Kg. THE EXISTING ROOF JOIST CAPACITY IS ADEQUATE TO SUPPORT THE NEW RTU-1 WEIGHTING 320 Kg. ADDITIONAL DIAGONAL MEMBERS MAY BE REQUIRED DEPENDING ON THE LOCATION OF THE RTU-1 WITH RESPECT TO THE EXISTING JOIST TOP CHORD PANEL POINTS. REFER TO STRUCTURAL DETAIL X ON THIS SHEET.

- 8. ALL STRUCTURAL STEEL MEMBERS TO BE 300W AND SHALL CONFORM TO CSA G40.21-04.
- STRUCTURAL DESIGN IS BASED ON LIMIT STATES DESIGN AS PER 2012 BUILDING CODE COMPENDIUM, STRUCTURAL
- STEEL TO CAN/CSA-S16-09, DESIGN OF STEEL STRUCTURES 10. TIMBER DESIGN INCLUDING ALL STRUCTURAL COMPOSITE LUMBER (SUCH AS LVL, PSL ETC) CONFORMS TO CAN/CSA-086-09

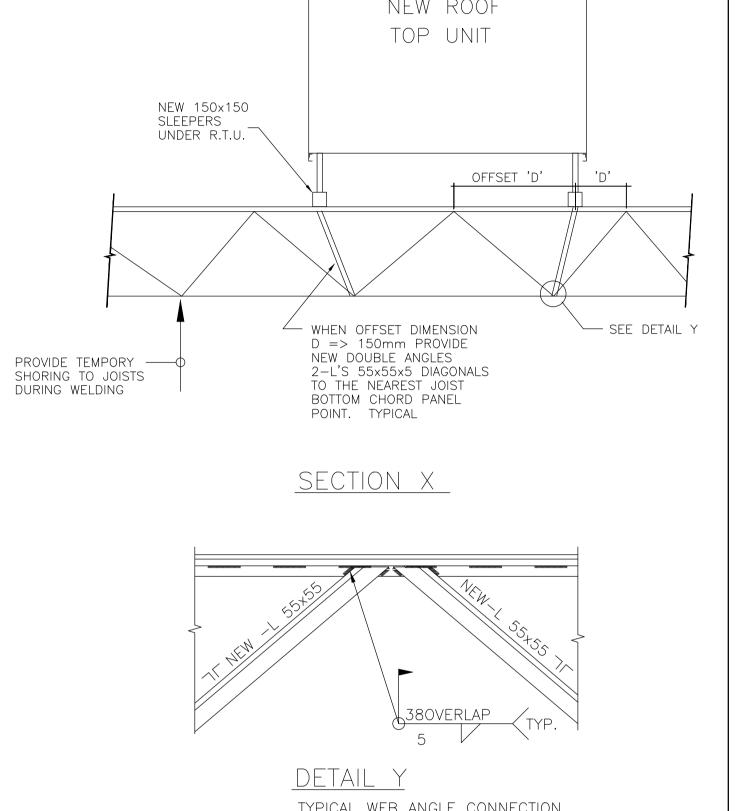

RTU SLEEPER SUPPORT A2-02 SCALE: 1:50

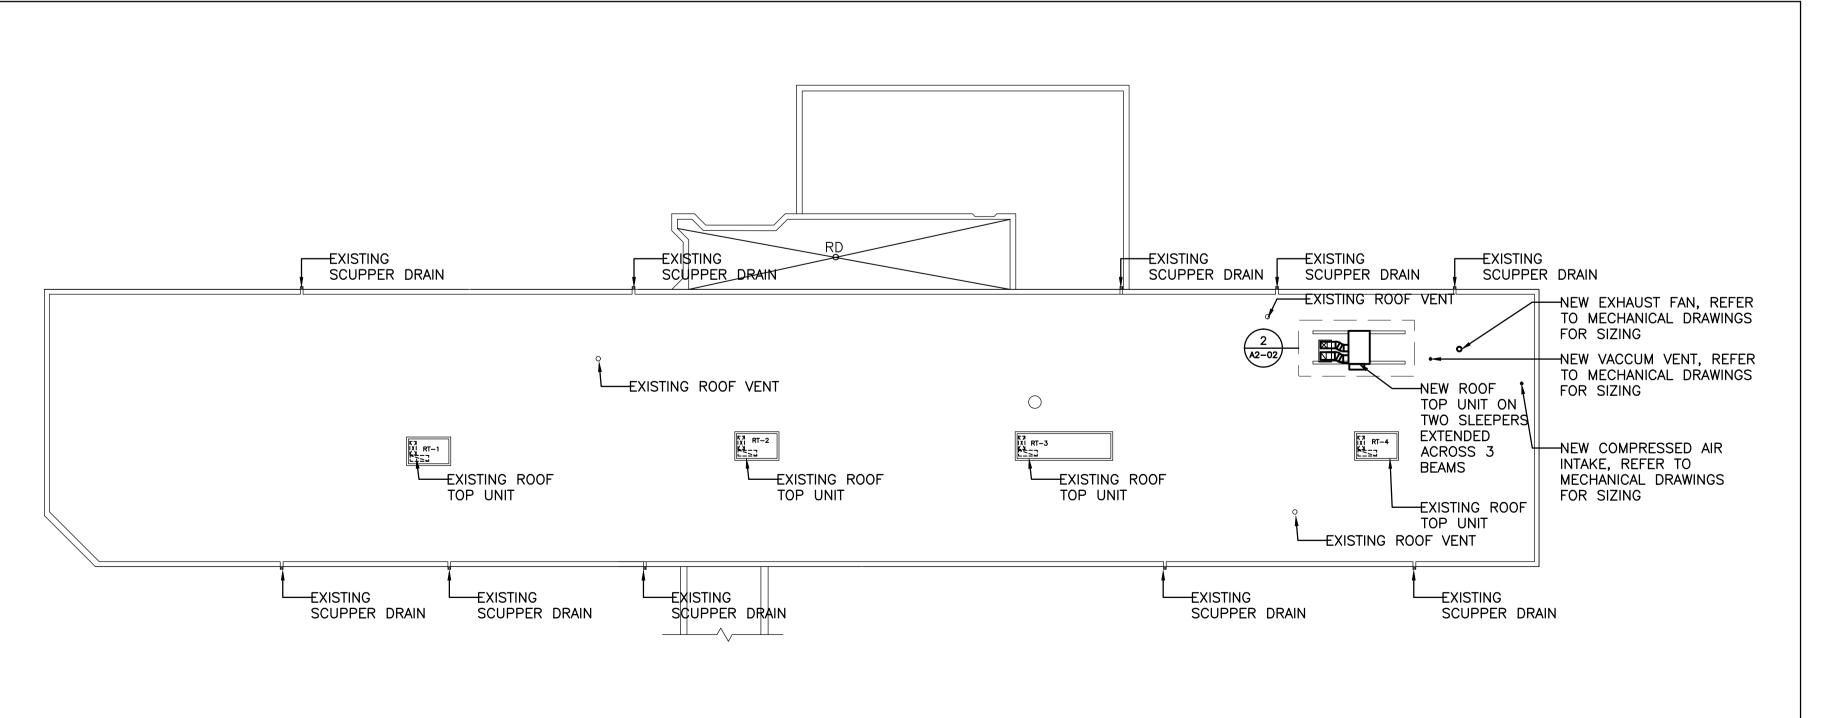

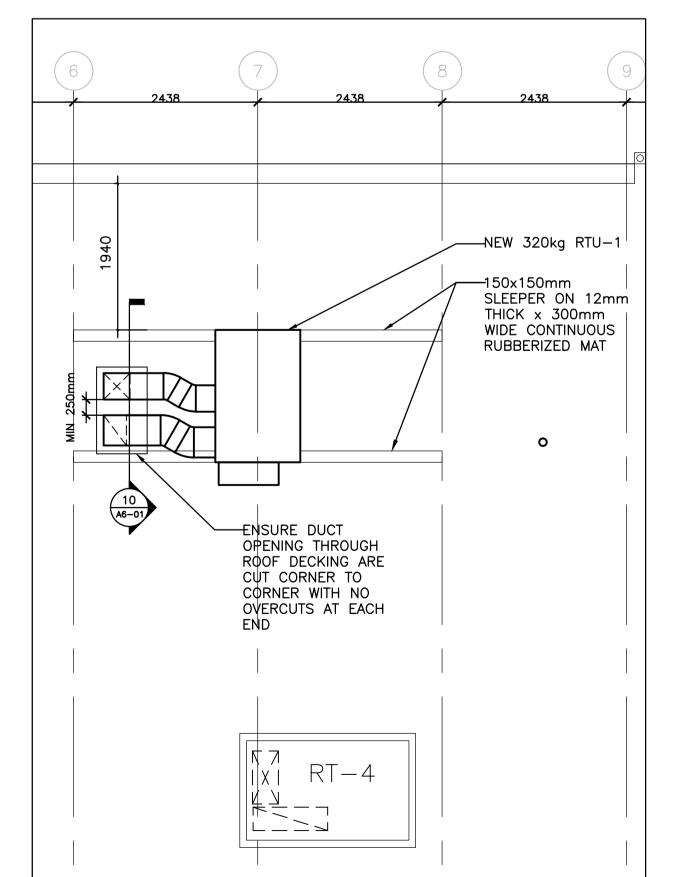

ENLARGED RTU \A2-02/ SCALE: 1:50

PROPOSED ROOF PLAN \A2-02/ SCALE: 1:200

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### **DIALOG**



A bhi D.J. KHACHI 07/10/2017

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02	50% CD	2016-11-04
01	PROGRESS REVIEW	2016-09-07
revision		date

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project title titre du projet

A Detail No. No. du détail B drawing no. — where detail required

drawing no. — where detailed

KINGSTON CORRECTIONAL SERVICE CANADA 1455 BATH RD, KINGSTON ON K7L 4V9

X-RAY AND DENTAL ROOMS, CBI (MIN)

drawing title titre du dessin

PROPOSED ROOF PLAN


drawn by dessine par A.T. designed by conc par A.T. approuve par project manager administrateur soumission Y. KODAI

2016-06-03 project no. no. du projet


R.079534.002

drawing no. dessine no.

A2 - 02

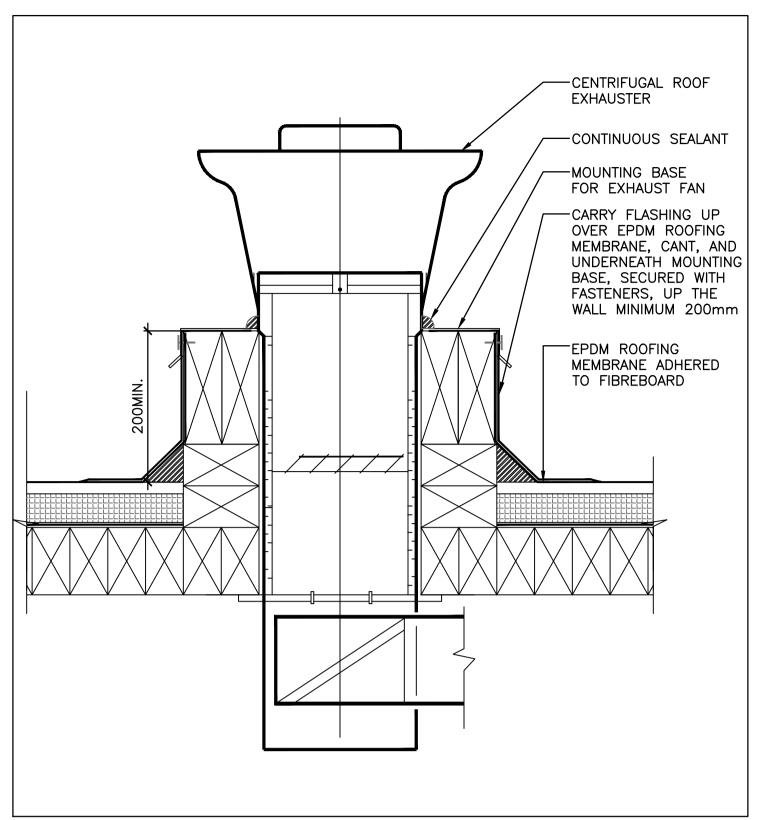


ROOF MOUNTED EXHAUST FAN

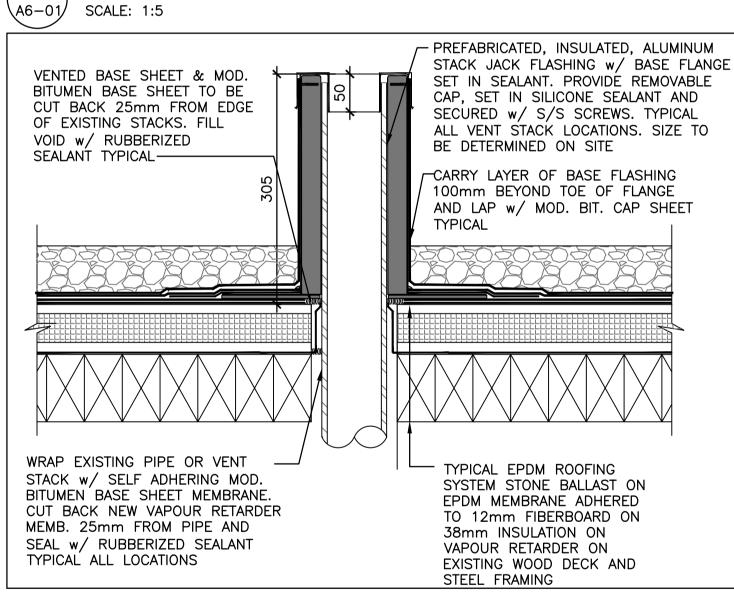


VENT STACK DETAIL

\A6-01\ SCALE: 1:5

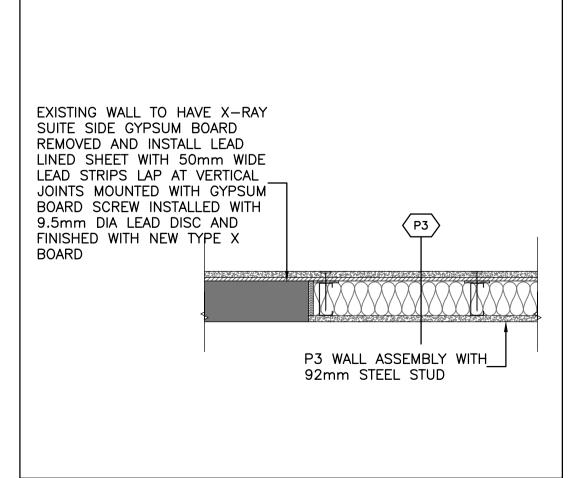


EXISTING WALL AT P3

∖A6−01/ SCALE: 1:10

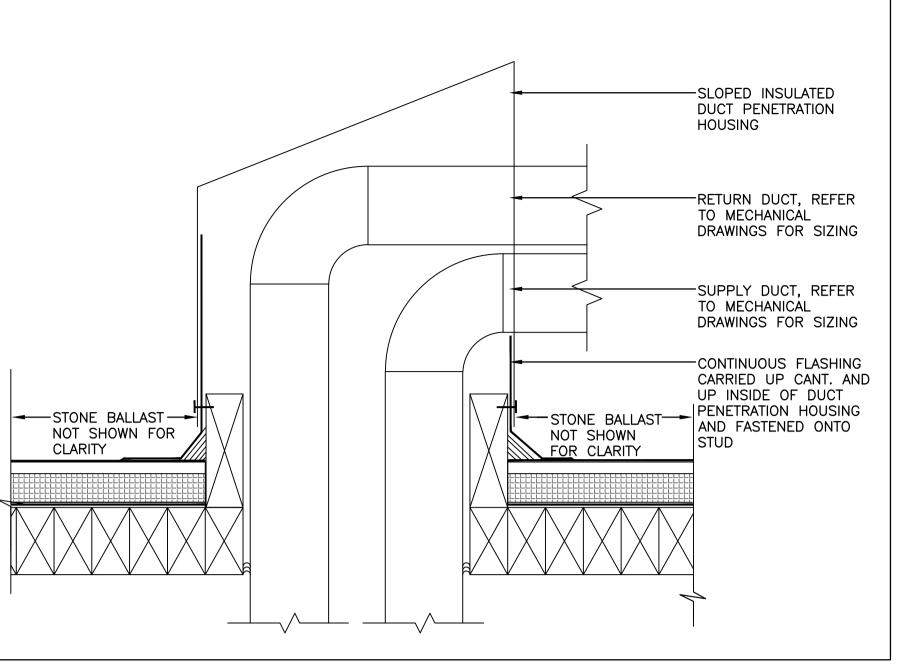


ROOF DUCT PENENTRATION \A6-01/ SCALE: 1:5 SPARE


SCALE: 1:50

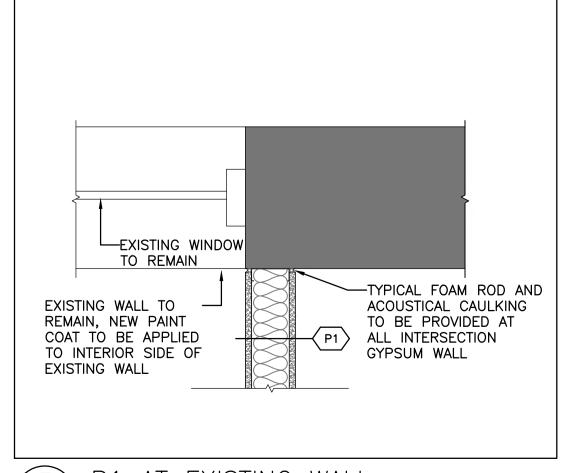


P1 AT EXISTING WALL ∖A6-01/ SCALE: 1:10

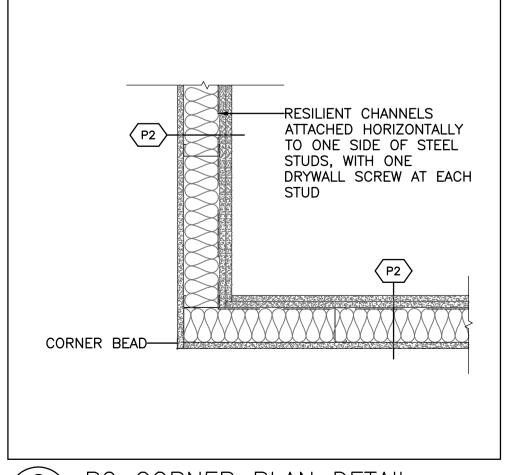

P2 CORNER PLAN DETAIL A6-01 SCALE: 1:10

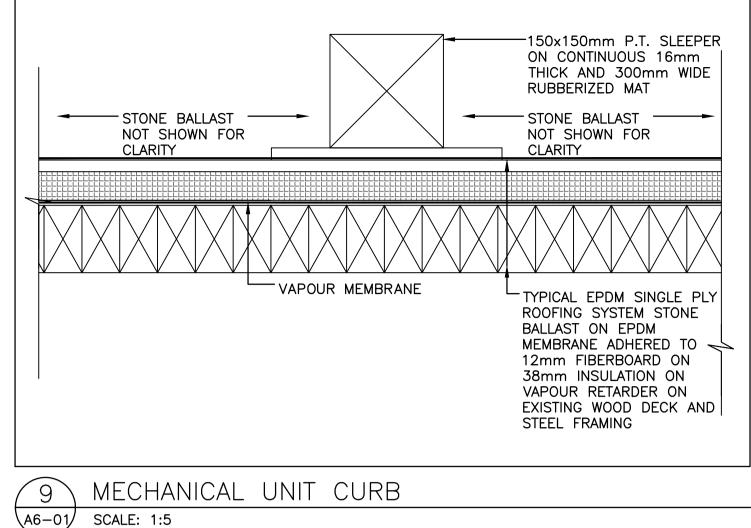


A6-01 SCALE: 1:5

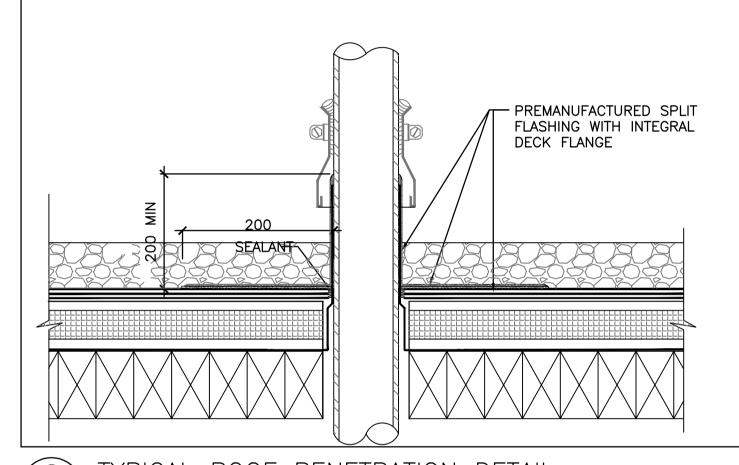


TYPICAL ROOF PENETRATION DETAIL

A6-01 SCALE: 1:5

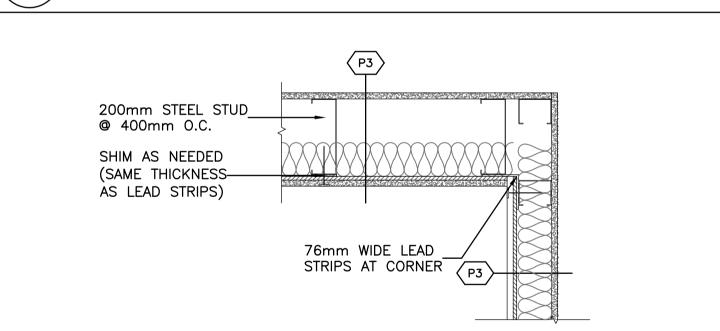

INSIDE CORNER STUDS OF P3

A6-01 SCALE: 1:10

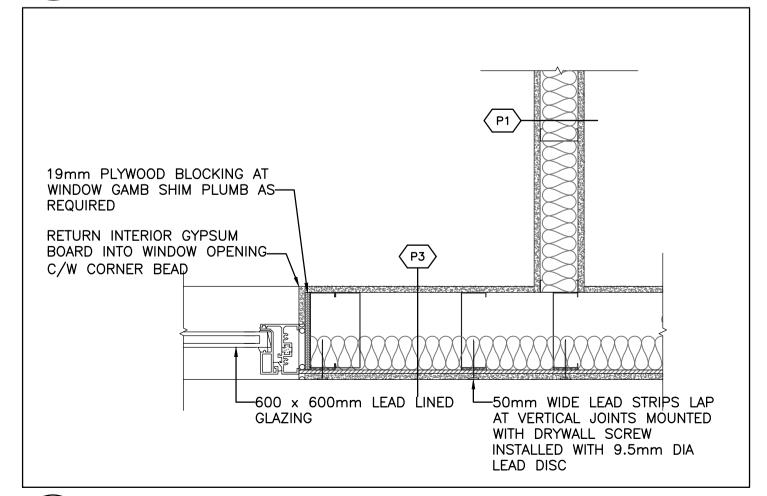

P1 WALL INTERSECTING P3 WALL PLAN DETAIL \A6-01 SCALE: 1:10

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Travaux publics et Services gouvernementaux Canada Services d'architecture et de génie Région de l'Ontario

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01	PROGRESS REVIEW	2016-09-07
revision		date
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Detail No. No. du détail drawing no. — where detail required dessin no. — où détail exigé drawing no. — where detailed

project title titre du projet KINGSTON CORRECTIONAL SERVICE CANADA 1455 BATH RD, KINGSTON ON K7L 4V9

X-RAY AND DENTAL ROOMS, CBI (MIN)

drawing title titre du dessin


PLAN DETAILS AND SECTION

drawn by dessine par	A.T.	
designed by conc par	A.T.	
approved by approuve par	R.N.	
tender soumission	Y. KODAI	project manager administrateur de projets
project date date du projet	2016-06-0	7


2016-06-03 project no. no. du projet

R.079534.002

drawing no. dessine no. A6 - 01

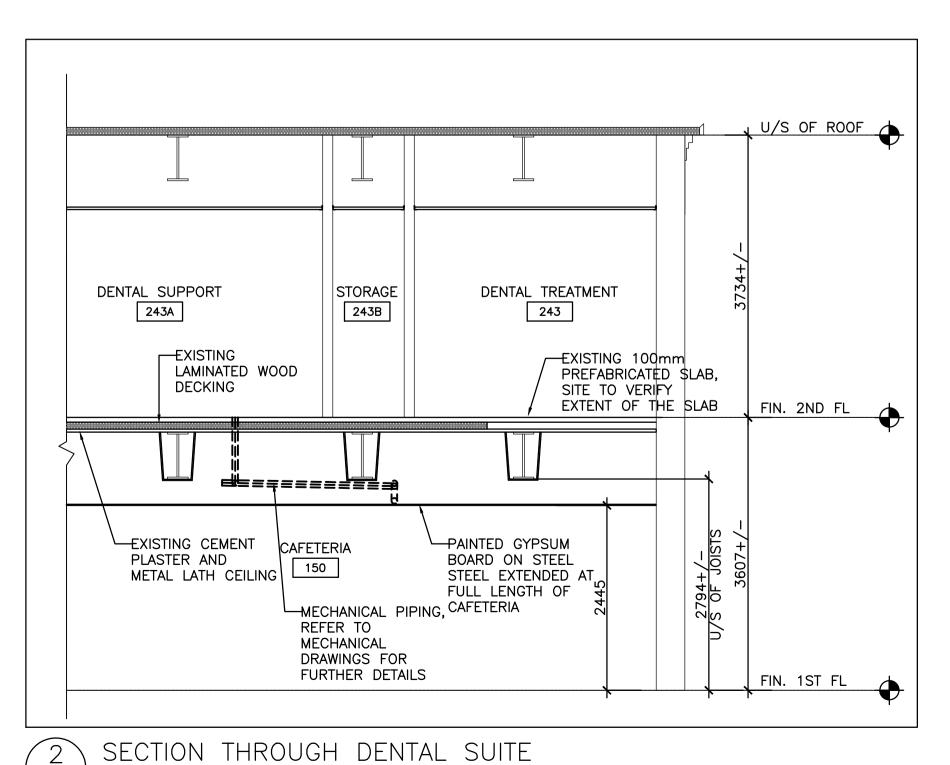

A6-02 SCALE: 1:50

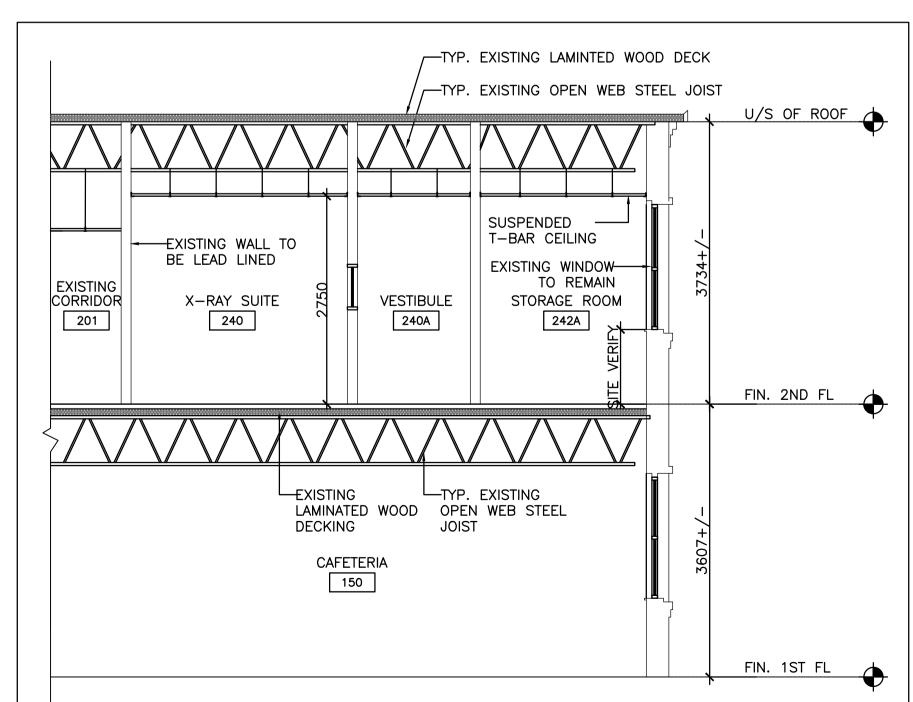

SECTION THROUGH X-RAY AND STORAGE ROOM A6-02 SCALE: 1:50

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03 02 O1 BID 2017-07-14 date revision

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A Detail No. No. du détail B drawing no. – where detail required C drawing no. — where detailed dessin no. — où détaillé

project title titre du projet KINGSTON CORRECTIONAL SERVICE CANADA 1455 BATH RD, KINGSTON ON K7L 4V9

X-RAY AND DENTAL ROOMS, CBI (MIN)

drawing title titre du dessin

SECTION

drawn by dessine par A.T.

A.T.

approved by approuve par R.N.

project manager administrateur de projets soumission Y. KODAI


designed by conc par

project date date date du projet 2016-06-03


project no. no. du projet R.079534.002

drawing no. dessine no.

A6 - 02

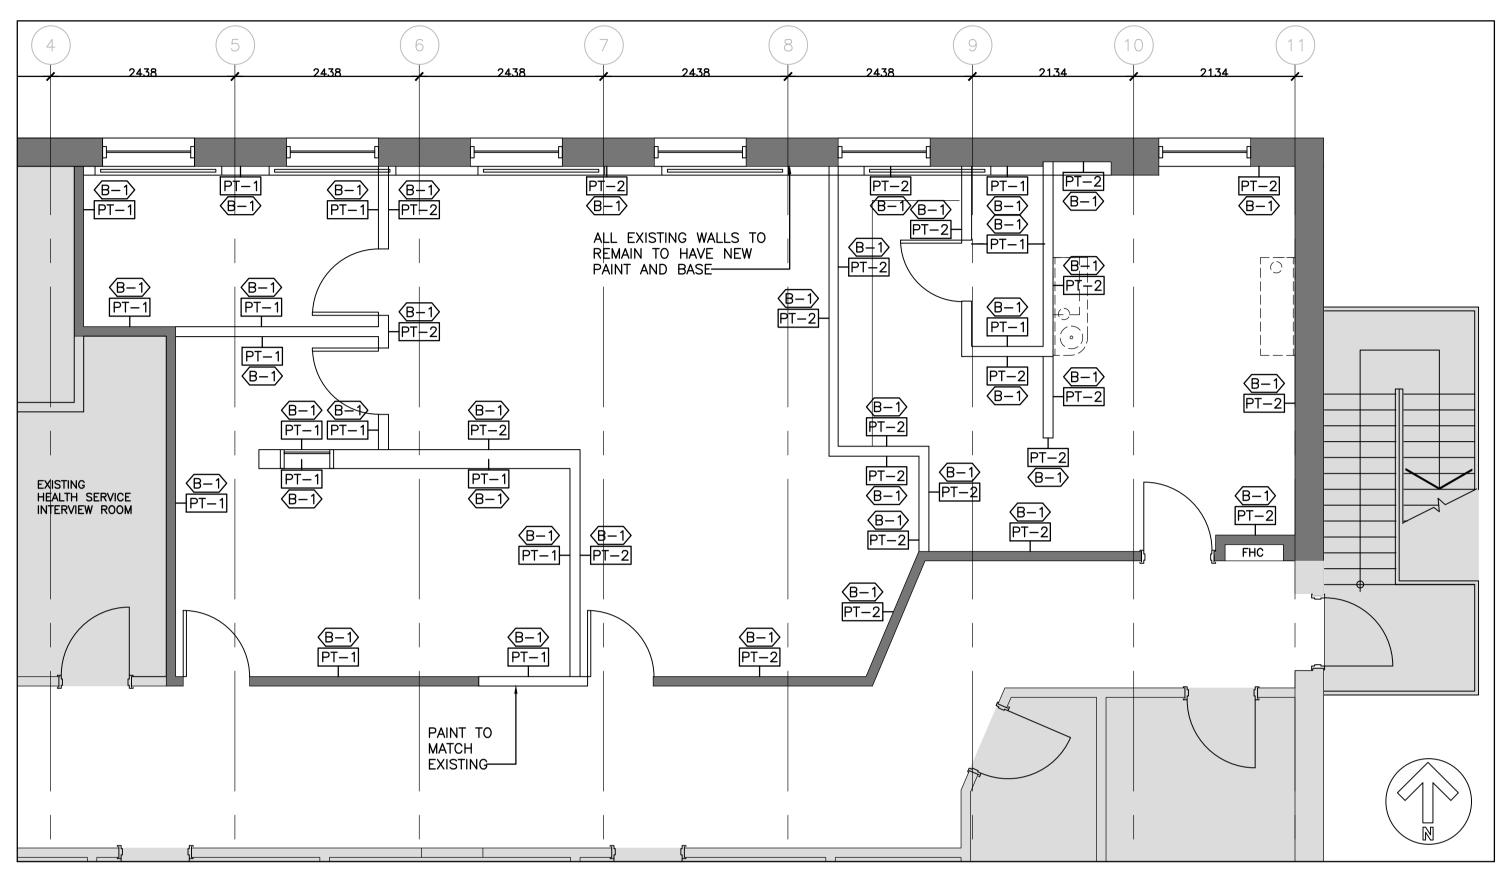

PROPOSED REFLECTED CEILING PLAN \A2-01/ SCALE: 1:50

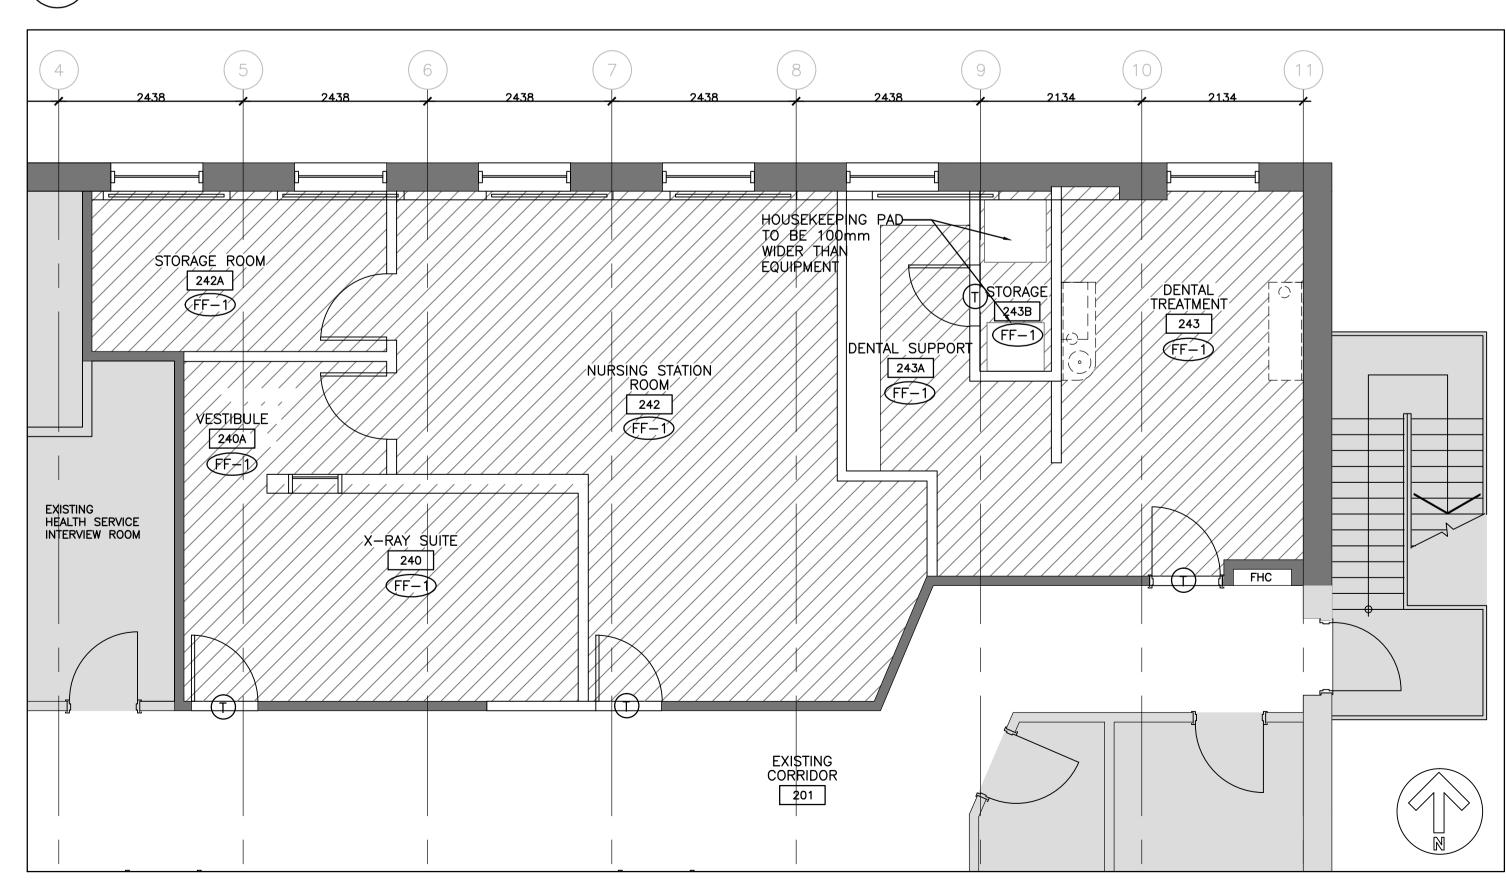

PROPOSED FLOOR PLAN SCALE: 1:50 \A2-01/

#### GENERAL CONSTRUCTION NOTES

- THIS DRAWING IS TO BE READ IN CONJUNCTION WITH MECHANICAL AND ELECTRICAL DRAWINGS AND SPECIFICATIONS. REPORT DISCREPANCIES TO THE DEPARTMENTAL REPRESENTATIVE FOR CLARIFICATION. DO NOT PROCEED WITHOUT CLARIFICATION IN SUCH CIRCUMSTANCES.
- BE RESPONSIBLE FOR FIELD MEASUREMENTS AND DIMENSIONS, REPORT DISCREPENCIES TO THE DEPARTMENTAL REPRESENTATIVE FOR CLARIFICATION.
- 3. NEW PARTITIONS TO BE FIXED DIRECTLY TO CLEAN CONCRETE SLAB. PARTITIONS TO BE TAPED, SANDED SMOOTH AND MADE READY TO RECEIVE FINISHES. ALL GYPSUM TO BE PAINTED UNLESS NOTED OTHERWISE
- 4. ENSURE SUFFICENT BLOCKING IS PROVIDED IN AREAS REQUIRING SUPPORT OF THE PARTITION OR CEILING FOR MOUNTED EQUIPMENT OR MATERIAL
- 5. ENSURE FLOOR IS LEVEL PRIOR TO CONSTRUCTION OF PARTITION. PROVIDE SKIM COAT IF NECESSARY, VARIANCE NOT TO EXCEED 6mm.
- ENSURE ACOUSTICAL CAULKING IS PROVIDED AT PARTITION CONNECTIONS TO FINISHED CEILING, FLOOR SLAB AND UNDERSIDE OF STRUCTURE.
- 7. ALL MATERIALS USED SHALL BE NEW UNLESS OTHERWISE NOTED.
- B. LOCATIONS WHERE BASE BUILDING PARTITIONS OR COLUMNS ARE TO RECEIVE ELECTRICAL CONDUIT AND BOXES, BE RESPONSIBLE FOR FURRING, CUTTING, PATCHING AND FINISHING AS PER SPECIFICATIONS AT COMPLETION OF ELECTRICAL WORK.
- 9. ALL PENETRATIONS THROUGH FIRE-RATED ASSEMBLIES MUST BE FIRE-STOPPED WITH APPROVED MATERIAL OR SYSTEM

FLOOR FINISH LEGEND

TRANSITION STRIP

FLOOR FINISH SCHEDULE



(FF-1) VINYL SHEET FLOORING

WALL FINISH SCHEDULE

PAINT 1: TO BE SELECTED BY THE

PAINT 2: TO BE SELECTED BY THE DEPARTMENTAL REPRESENTATIVE

DEPARTMENTAL REPRESENTATIVE

WALL BASE SCHEDULE

100mm VINYL WALL BASE



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drawing no. — where detailed

project title titre du projet KINGSTON CORRECTIONAL SERVICE CANADA

1455 BATH RD, KINGSTON ON K7L 4V9 X-RAY AND DENTAL ROOMS,

drawing title titre du dessin

CBI (MIN)

FLOOR AND WALL FINISH PLAN

drawn by dessine par A.T.

conc par A.T.

approuve par


project manager administrateur soumission Y. KODAI


2016-06-03

R.079534.002

drawing no. dessine no.

A8 - 01

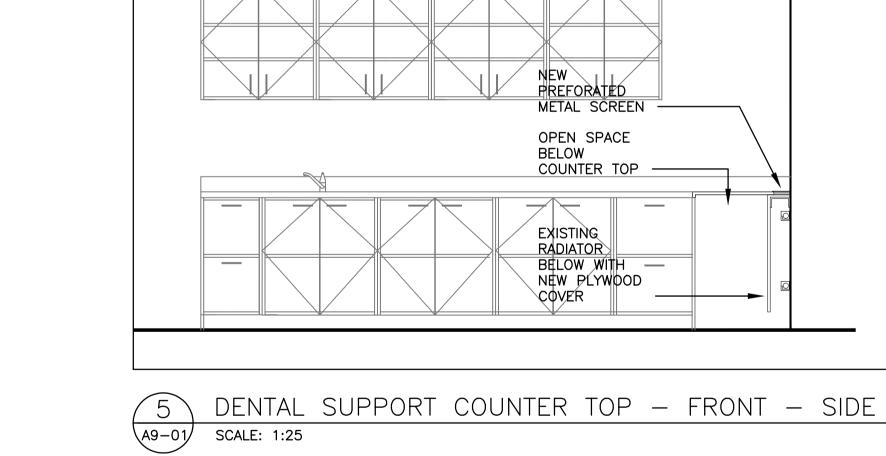

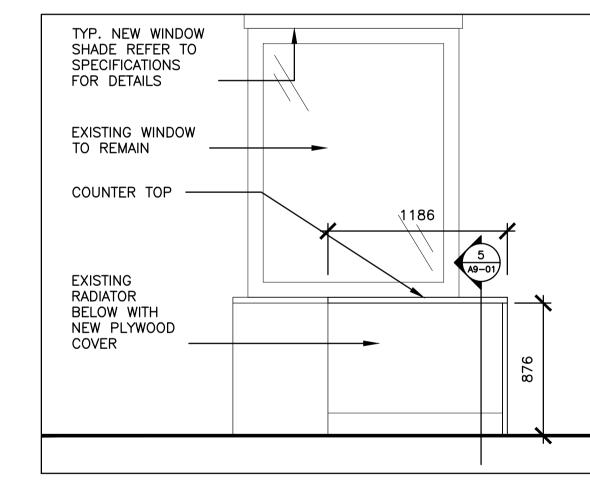

DENTAL SUPPORT COUNTER TOP A9-01 SCALE: 1:25

324 ADJUSTABLE SHELVES
WITH ML1 FINISH ON
METAL PINS AND **FERRULES** PROVIDE BLOCKING IN PARTITION TO SUPPORT MILLWORK AS REQUIRED — TYP. UNDER COUNTER MOUNT SINK SHELF WITH ML1 FINISH
ON METAL PINS AND
FERRULES 76

A9-01

3048 762 COUNTER TOP -FAUCET 100mm BACKSPLASH PROVIDE CLEAR
SILICONE CAULKING
BETWEEN THE SINK
AND COUNTER TOP. KICK AT BASE CABINETS TO BE INSTALLED AS CONTINUOUS PIECE AFTER CABINETS INSTALLED

DENTAL SUPPORT UPPER AND BASE CABINET SCALE: 1:25



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	03 02 01	03 99% CD  02 50% CD  01 PROGRESS REVIEW

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CORRECTIONAL SERVICE CANADA 1455 BATH RD, KINGSTON ON K7L 4V9 X-RAY AND DENTAL ROOMS, CBI (MIN)

drawing title titre du dessin

CASEWORK

drawn by dessine par	A.T.	
designed by conc par	A.T.	
approved by approuve par	R.N.	
tender soumission	Y. KODAI	project manag administrate de proje
project date		

2016-06-03

R.079534.002 drawing no. dessine no.

A9 - 01

	ITEMS AND DESCRIPTION	
ITEM	DESCRIPTION	LOCATION
PL1	HIGH PRESSURE LAMINATE COLOUR: TO BE DETERMINE BY DEPARTMENTAL REPRESENTATIVE	CABINETS
SS1	SOLID SURFACE COUNTER TOP COLOUR: TO BE DETERMINE BY DEPARTMENTAL REPRESENTATIVE	COUNTER TOP AND BACKSPLASH
ML1	MELAMINE COLOUR: TO BE DETERMINE BY DEPARTMENTAL REPRESENTATIVE	INSIDE OF CASEWORK
VN	VINYL KICK PLATE	BASE CABINETS

NOTES: CABINETS TO BE CONSTRUCTED OF 20mm THICK MATERIAL. REFER TO SPECIFICATIONS FOR MATERIALS.

CASEWORK SCHEDULE

A9-01 SCALE: NTS

UPPER AND BASE CABINET ELEVATION - SIDE A9-01 SCALE: 1:25

#### MECHANICAL LEGEND

#### MEDICAL PIPING AND SYSTEMS

—— — —— MA—— — DENTAL AIR PIPING

#### PLUMBING AND PIPING

FCO ⊕ FLOOR CLEANOUT \_\_ COI | CLEANOUT TF----- RUNNING TRAP DRAIN - FLOOR/AREA ———— DRAIN – ROOF ---- METER HB + → HOSE BIBB - C/W ISOLATION VALVE WC-1 PLUMBING FIXTURE TAG ---- BACKWATER VALVE ----SAN---- SANITARY SEWER - BELOW GRADE ----- SANITARY SEWER - VENT STORM SEWER - ABOVE GRADE ——··——DHW——··—— DOMESTIC HOT WATER DHWR DOMESTIC HOT WATER RECIRC. HEAT TRACED PIPING

#### PIPE VALVES AND FITTINGS

PIPE DROP PIPE RISE 2-WAY CONTROL VALVE ----- 3-WAY CONTROL VALVE SOLENOID VALVE --- PISTON OPERATED VALVE — MOTOR OPERATED VALVE ISOLATION VALVE GATE VALVE - HAND OPERATED GLOBE VALVE — HAND OPERATED BALANCING VALVE ---- PLUG VALVE - HAND OPERATED CHECK VALVE BUTTERFLY VALVE ANGLE VALVE — HAND OPERATED PRESSURE REDUCING VALVE STRAINER SUPERVISED ISOLATION VALVE BACKFLOW PREVENTOR PUMP (SCHEMATIC) PIPE ANCHOR AND GUIDES RELIEF 

SAFETY VALVE OR RELIEF VALVE

R — PRESSURE REGULATOR

#### AIR DISTRIBUTION

/ DN UP EXHAUST AIR DUCT // DN UP RELIEF AIR DUCT UP OUTSIDE AIR DUCT \_\_\_\_ BALANCING DAMPER \_\_ BACK DRAFT DAMPER MOTORIZED DAMPER ----- FIRE DAMPER — SMOKE DAMPER FSF——— FIRE STOP FLAP TURNING VANES ACOUSTIC LINED DUCTWORK FLEX CONNECTION ----- AIR TERMINAL BOX AIR TERMINAL BOX TAG BOX NO. - MIN. DESIGN AIRFLOW (L/S) — COIL (KW) NOTE : FLOW INDICATED ON THIS TAG IS MINIMUM DESIGN AIRFLOW. MAXIMUM DESIGN AIRFLOW IS THE SUM OF ALL DIFFUSER AIRFLOWS CONNECTED TO THIS TERMINAL BOX. MAXIMUM DESIGN AIRFLOW IS NOT INDICATED ON THIS TAG. AIR OUTLET TAG

TYPE SUPPLY TYPE S

SIZE RETURN TYPE R

FLOW (L/S) EXHAUST TYPE E EQUIPMENT TAG U/C DOOR UNDERCUT

UP SUPPLY AIR DUCT

UP RETURN AIR DUCT

DOOR GRILLE (SIZE NOTED)

ROUND DUCT

SINGLE LINE DUCT REPRESENTATION

DUCT DIMENSIONING (CLEAR INSIDE DUCT DIMENSION)

OVAL DUCT (WHERE 300 IS THE VISIBLE DIM.)

RECTANGULAR DUCT (WHERE 300 IS THE VISIBLE DIM.)

—

→

DIRECTION OF AIR FLOW

#### RENOVATION/DEMO.

- -----300ø ----- - - -

—300/200 OV—

---- EXISTING TO REMAIN X EXISTING TO BE DEMOLISHED ----- NEW SPRINKLER HEAD - EXISTING SPRINKLER HEAD — NEW

#### MECHANICAL DRAWING LIST

MO.01 MECHANICAL SCHEDULE & DRAWING LIST

M1.01 MECHANICAL FIRE PROTECTION AND HVAC DEMOLITION WORK PLAN

M2.01 MECHANICAL FIRE PROTECTION AND HVAC NEW WORK PLAN

M2.02 MECHANICAL PLUMBING NEW WORK PLAN

M2.03 MECHANICAL MEDICAL GAS NEW WORK PLAN

M2.04 MECHANICAL ROOF PLAN M3.01 MECHANICAL SCHEMATICS

M4.01 MECHANICAL SCHEDULES M5.01 MECHANICAL DETAILS

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project title titre du projet

KINGSTON CORRECTIONAL SERVICE CANADA 1455 BATH RD, KINGSTON ON K7L 4V9

X-RAY AND DENTAL ROOMS, CBI (MIN)

MECHANICAL LEGENDS, SCHEDULE & DRAWING LIST

drawn by dessine par

DM/RD

approuve par R.NORTHCOTT

soumission Y. KODAI

project date date date du projet 2016-06-03

R.079534.002

drawing no. dessine no.

M0.01

PHOTOCOPY

240|

CORRIDO 201

FHC

E===

240<u>A</u>

#### FIRE PROTECTION **DEMOLITION GENERAL NOTES**

- 1. DEMOLISH EXISTING SPRINKLER HEADS AND PIPE CONNECTIONS AS SHOWN.
- 2. CONTRACTOR IS TO REVIEW THE SITE DUCT ROUTING AND SITE CONDITION AND IDENTIFY AREAS OF POTENTIAL INTERFERENCE. CONTRACTOR IS TO PROVIDE CLEARLY LABELLED SKETCHES TO DEPARTMENT REPRESENTATIVE THAT IDENTIFIES INTERFERENCES WITH NEW WORK.

#### HVAC DEMOLITION GENERAL NOTES

- 1. DEMOLISH EXISTING DIFFUSERS, GRILLES, DUCTWORK, DUCT FITTINGS, CONTROLS, TERMINAL BOXES AS SHOWN.
- 2. CONTRACTOR IS TO REVIEW THE SITE DUCT ROUTING AND SITE CONDITION AND IDENTIFY AREAS OF POTENTIAL INTERFERENCE. CONTRACTOR IS TO PROVIDE CLEARLY LABELLED SKETCHES TO DEPARTMENT REPRESENTATIVE THAT IDENTIFIES INTERFERENCES WITH NEW WORK. SUBMIT PRIOR TO ANY NEW CONSTRUCTION.
- 3. REMOVE ALL DEBRIS AND RUBBISH AT EVERY
- SCHEDULED CLEAN UP.
- 4. ALL DEMOLISHED BRANCH DUCTWORK NOT USED FOR RECONNECTION SHALL BE CUT-BACK AND CAPPED AT MAIN AIRTIGHT.
- 5. PROVIDE 50 mm THICK PLEATED FILTERS ON EXISTING RETURN AIR DUCT MAIN FOR DURATION OF CONTRACT. REMOVE UPON COMPLETION.

#### **KEYNOTES**

- (1) CUT BACK AND CAP DUCTWORK AS INDICATED.
- DISCONNECT AND RELOCATE THERMOSTAT AND ASSOCIATED LOCKABLE COVER.
- DEMOLISH EXISTING RETURN AIR GRILLE AND ASSOCIATED DUCTWORK. (TYPICAL)
- TEST AND RECORD TRAVERSE READING OF SUPPLY AIR DUCT WHEN RT-4 IS OPERATING IN NORMAL CONDITION. UPON CONSTRUCTION COMPLETION, CONTRACTOR SHALL RE-BALANCE THE SYSTEM AND RE-SHEAVE THE FAN TO MATCH TRAVERSE READINGS RECORDED BEFORE DEMOLITION. CONTRACTOR SHALL SUBMIT RECORDED DATA BEFORE DEMOLITION AND POST CONSTRUCTION BALANCING AS PART OF FULL BALANCING REPORT AS PER SPECIFICATIONS.

SUBMIT PRIOR TO ANY NEW CONSTRUCTION.

R. A. DOMINGUEZ ANEDA 100088380

Public Works and

Travaux publics et

Région de l'Ontario

DIALOG

Ontario Region

Government Services Canada Architectural and Engineering Services

Services d'architecture et de génie

Services gouvernementaux Canada

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04     BID REVIEW     2017-04-21       03     99% CD     2017-03-10       02     50% CD     2016-11-04			
04     BID REVIEW     2017-04-21       03     99% CD     2017-03-10       02     50% CD     2016-11-04       01     PROGRESS REVIEW     2016-09-07			
03 99% CD 2017-03-10 02 50% CD 2016-11-04 01 PROGRESS REVIEW 2016-09-07	05	BID	2017-07-14
02 50% CD 2016-11-04 01 PROGRESS REVIEW 2016-09-07	04	BID REVIEW	2017-04-21
01 PROGRESS REVIEW 2016-09-07	03	99% CD	2017-03-10
	02	50% CD	2016-11-04
revision date	01	PROGRESS REVIEW	2016-09-07
	revision		date

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project title titre du projet

KINGSTON

A Detail No. No. du détail B drawing no. - where detail required dessin no. — où détail exigé

drawing no. — where detailed

CORRECTIONAL SERVICE CANADA 1455 BATH RD, KINGSTON ON K7L 4V9

X-RAY AND DENTAL ROOMS, CBI (MIN)

drawing title titre du dessin MECHANICAL FIRE PROTECTION AND HVAC DEMOLITION WORK PLAN

dessine par JPK DM/RD

approuve par R.NORTHCOTT


project manage soumission Y. KODAI


project date date du projet

2016-06-03

R.079534.002

drawing no. dessine no. M1.01

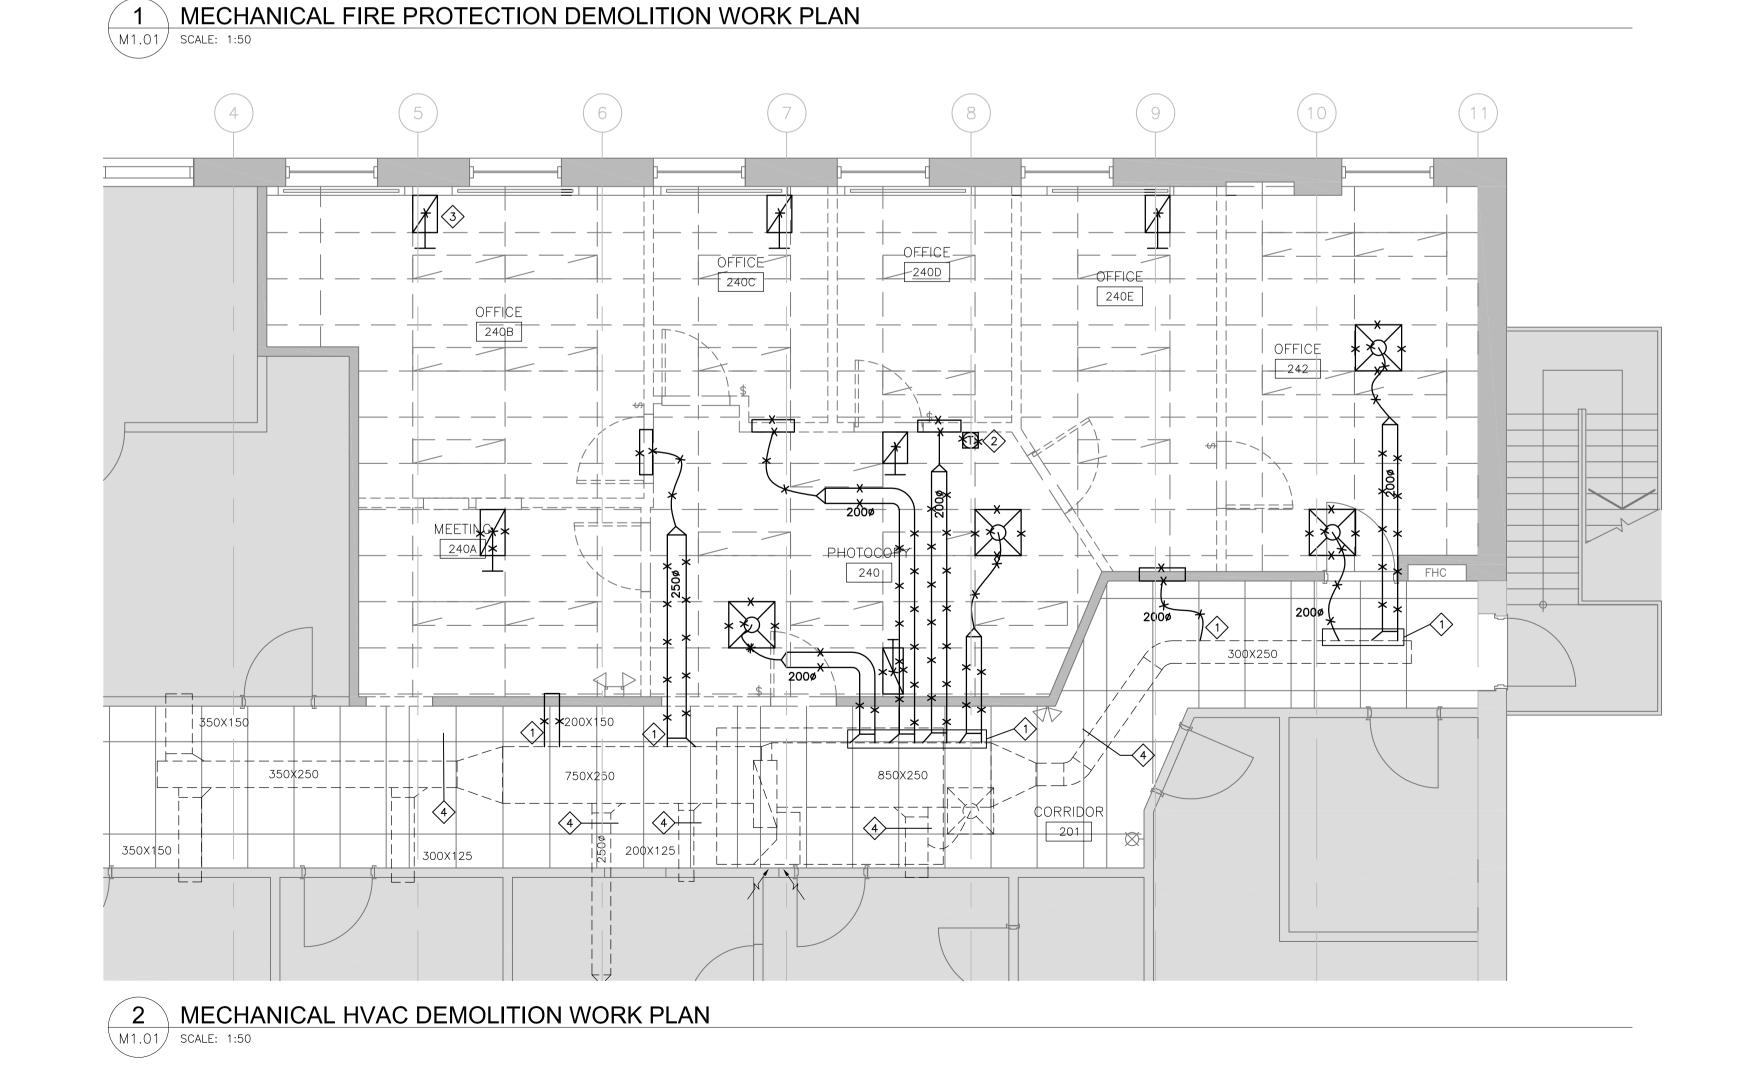

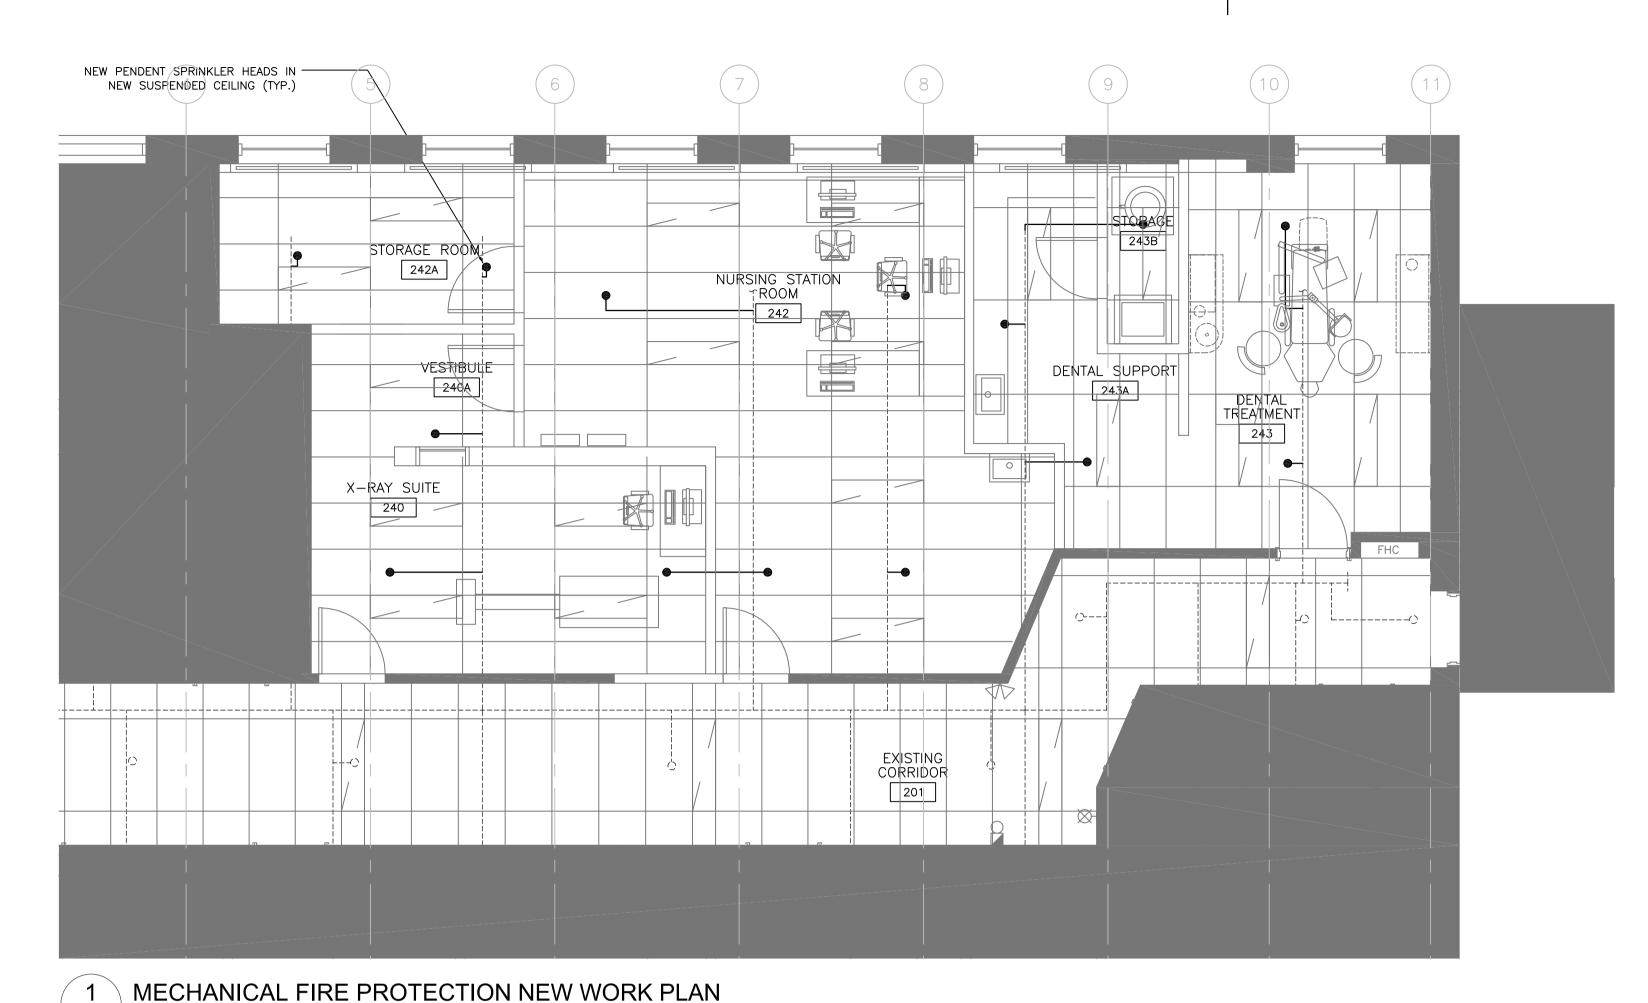

#### FIRE PROTECTION GENERAL NOTES

- 1. PROVIDE NEW SPRINKLER HEADS AND PIPING MODIFICATIONS AS INDICATED AND AS REQUIRED TO COMPLETE THE WORK. CONTRACTOR TO VERIFY SIZE OF EXISTING PIPING ON SITE. CONTRACTOR TO COORDINATE PLACEMENT OF SPRINKLER HEADS TO AVOID
- 2. INSTALL NEW SPRINKLER HEADS AND PIPING IN ACCORDANCE WITH NFPA 13 AND REQUIREMENTS OF AUTHORITY HAVING JURISDICTION. REFER TO
- 5 THIS DRAWING INDICATES GENERAL INTENT OF DESIGN ONLY. CONTRACTOR TO VERIFY SITE CONDITION BEFORE COMMENCING WORK. REPORT TO ENGINEER ANY
- 6 COORDINATE FINAL LOCATION OF PIPING AND

### **HVAC GENERAL NOTES**

- 1. PROVIDE NEW DUCTWORK, EQUIPMENT, DIFFUSERS, FITTINGS, AND ACCESSORIES AS INDICATED AND AS REQUIRED TO COMPLETE WORK.
- 2. REMOVE ALL DEBRIS AND RUBBISH ONCE WORK IS COMPLETE.
- 3. THIS DRAWING INDICATES GENERAL INTENT OF DESIGN ONLY. CONTRACTOR TO VERIFY SITE CONDITION BEFORE COMMENCING WORK. REPORT TO ENGINEER ANY DISCREPANCIES.
- 4 COORDINATE FINAL LOCATION OF PIPING AND SPRINKLERS WITH FIRE PROTECTION, PLUMBING, AND ELECTRICAL TRADES.
- 5 DUCT TAKEOFFS TO MATCH DIFFUSER NECK SIZE UNLESS INDICATES OTHERWISE.

#### **KEYNOTES**

- 1 TRANSFER AIR DUCTS COMPLETE WITH ACOUSTIC LINING
- 2 RETURN AIR DUCT WITH ACOUSTIC LINING
- 3 350X350 S/A AND 400X300 R/A DUCT UP TO RTU-1
- PROVIDE SOUND BAFFLE AT PERIMETER CONVECTOR. REFER TO DETAIL3/M5.01.
- 5 BALANCE AND RESHEAVE RT-4 TO MATCH RECORDED READINGS PRIOR TO DEMOLITION.

- INTERFERENCE WITH OTHER WORK.
- SPECIFICATIONS FOR FURTHER DETAILS.
- 3. REMOVE ALL DEBRIS AND RUBBISH DAILY AND ONCE WORK IS COMPLETE.
- 4. SPRINKLER CONTRACTOR TO SUBMIT LETTER STATING ALL SPRINKLER WORK IS COMPLETE AND IN ACCORDANCE WITH NFPA 13. LETTER IS TO BE SIGNED AND STAMPED BY A LICENSED PROFESSIONAL ENGINEER.
- DISCREPANCIES.
- SPRINKLERS WITH HVAC, PLUMBING AND ELECTRICAL

R. A. DOMINGUEZ ANEDA 100088380

ONTRACTOR'S EXPENSE.

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DIALOG

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drawing no. — where detailed

KINGSTON CORRECTIONAL SERVICE CANADA 1455 BATH RD, KINGSTON ON K7L 4V9

X-RAY AND DENTAL ROOMS, CBI (MIN)

drawing title titre du dessin

MECHANICAL FIRE PROTECTION AND HVAC NEW WORK PLAN

dessine par JPK

DM/RD

approuve par R.NORTHCOTT

project manage soumission Y. KODAI


project date date du projet

2016-06-03

R.079534.002

drawing no. dessine no.


M2.01

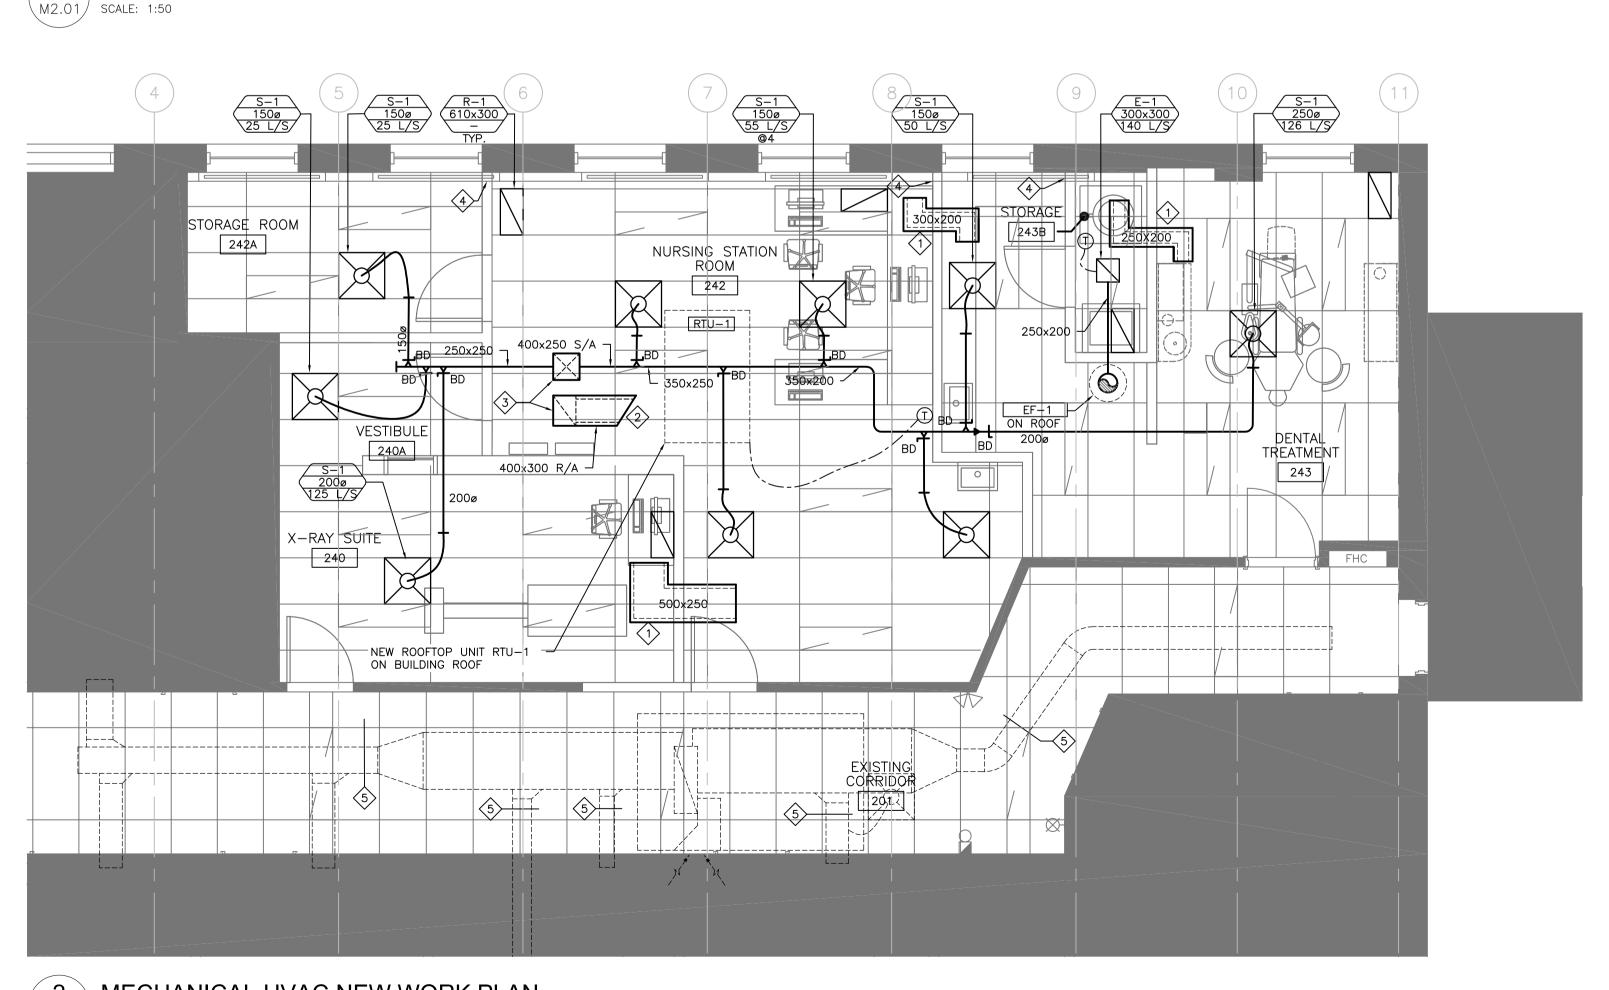

2 MECHANICAL HVAC NEW WORK PLAN M2.01 SCALE: 1:50

#### **GENERAL NOTES**

- BETWEEN EXISTING AND DESIGN DRAWINGS.
- 3. COORDINATE FINAL LOCATION OF EQUIPMENT AND NEW WORK WITH ALL TRADES.

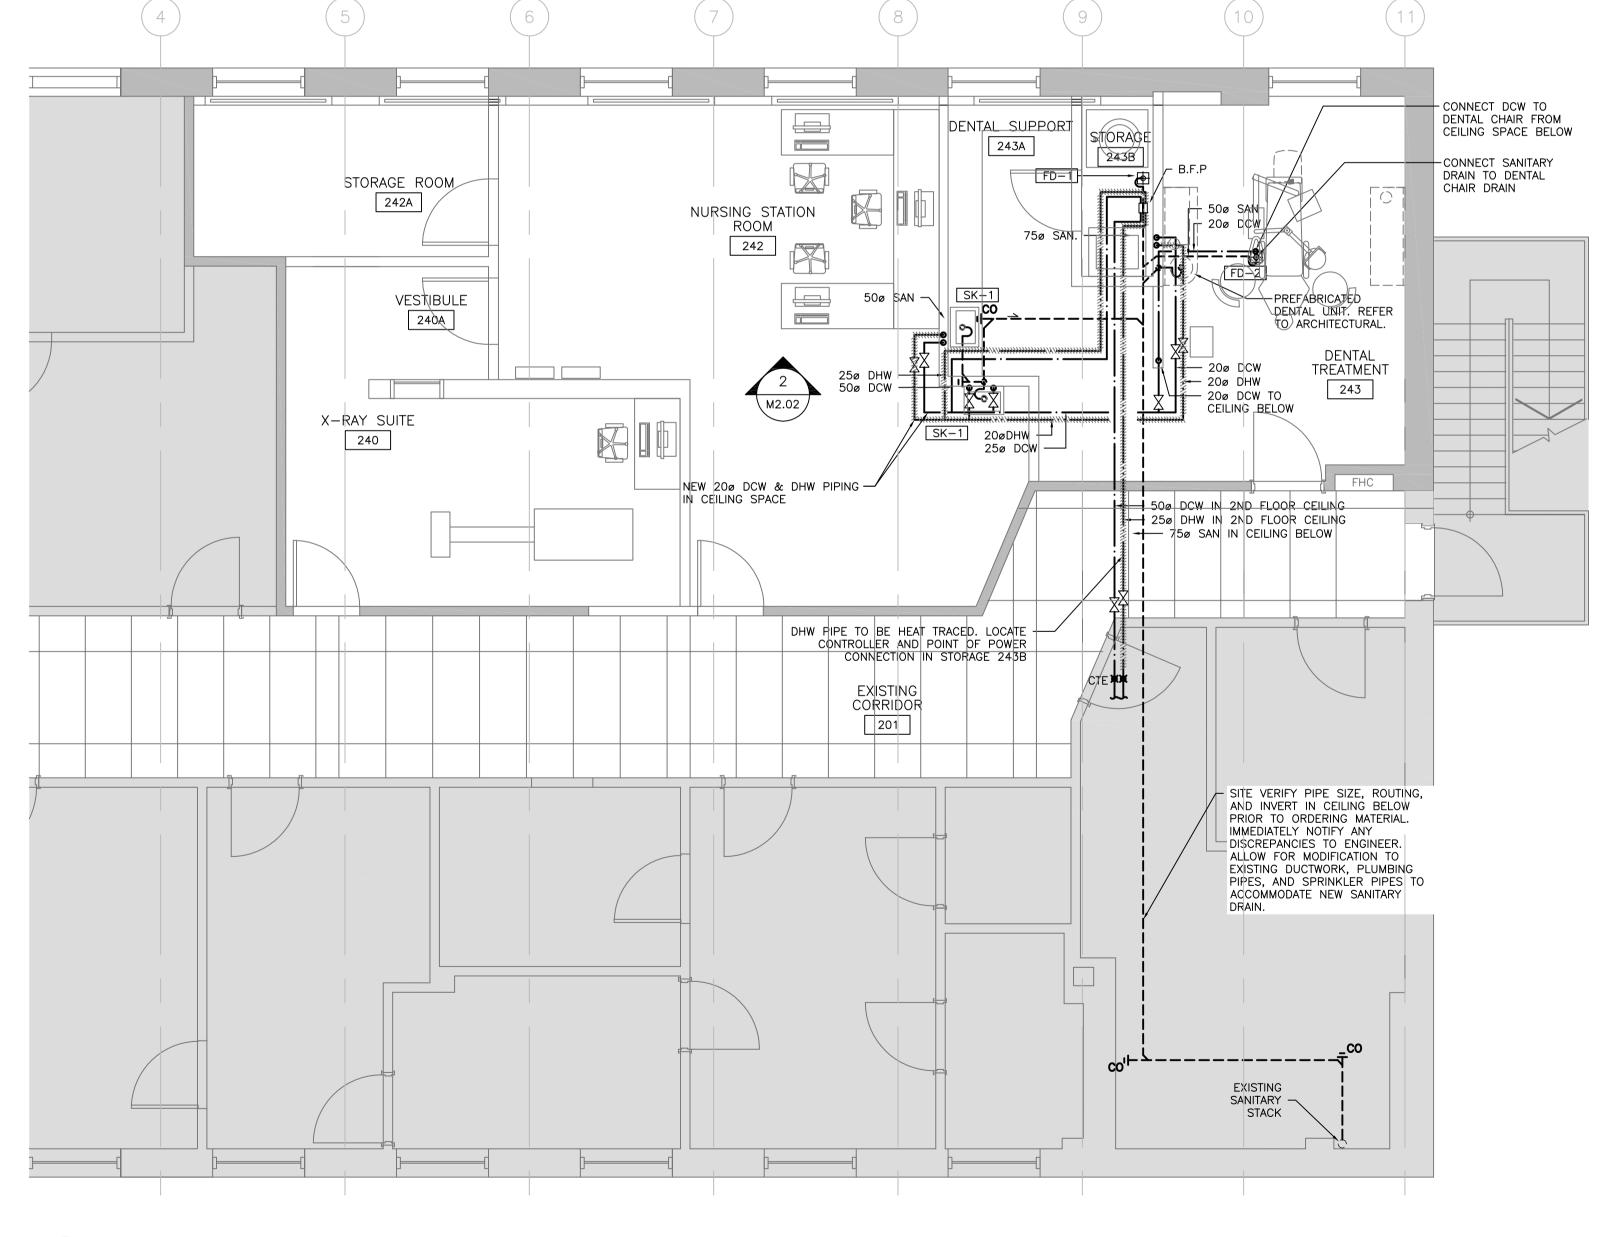

- 1. THIS DRAWING INDICATES GENERAL INTENT OF DESIGN ONLY. CONTRACTOR TO VERIFY SITE CONDITION BEFORE ORDERING MATERIALS AND COMMENCING WORK. REPORT TO DEPARTMENTAL REPRESENTATIVE ANY DISCREPANCIES
- 2. PROVIDE NEW EQUIPMENT INCLUDING PIPING, VALVES, FITTINGS, FIXTURES AND ACCESSORIES AS INDICATED.
- 4. ALL PLUMBING FIXTURES SHALL BE VENTED AND ALL TRAPS SHALL BE PRIMED AS PER NATIONAL PLUMBING CODE.

DIALOG

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dessin<sup>\*</sup>no. — où détail exigé C drawing no. — where detailed dessin no. — où détaillé

project title titre du projet KINGSTON CORRECTIONAL SERVICE CANADA 1455 BATH RD, KINGSTON ON K7L 4V9

X-RAY AND DENTAL ROOMS, CBI (MIN)

drawing title titre du dessin

MECHANICAL PLUMBING NEW WORK PLAN

dessine par

conc par DM/RD

JPK

approuve par R.NORTHCOTT

soumission Y. KODAI

project date date du projet


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project manage

R.079534.002

drawing no. dessine no.

M2.02

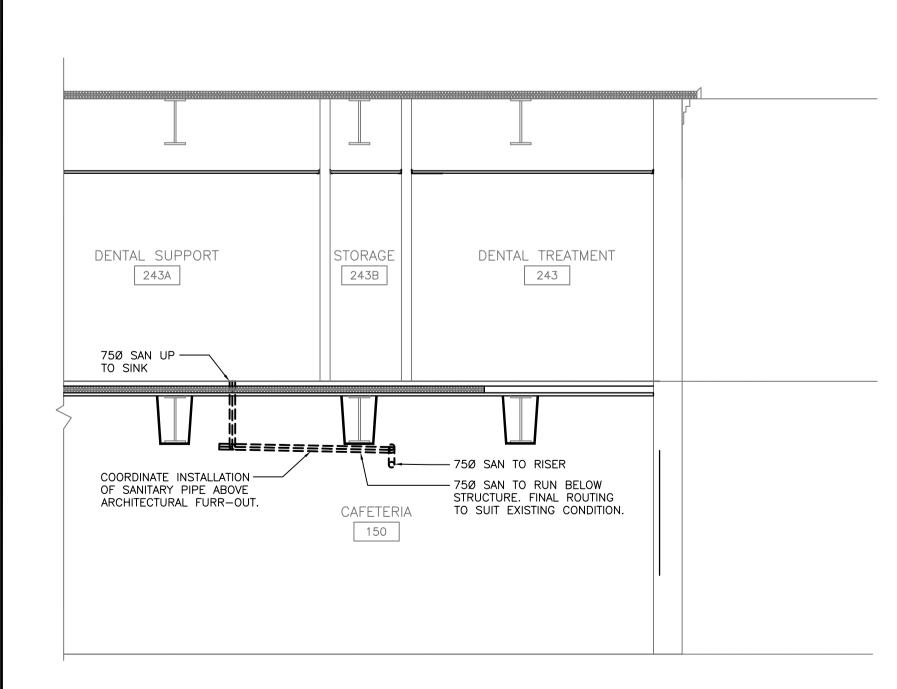


GROUND FLOOR SECTION M2.02 SCALE: 1:50

MECHANICAL PLUMBING NEW WORK PLAN M2.02 | SCALE: 1:50


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CAD FILE:

2016-09-07

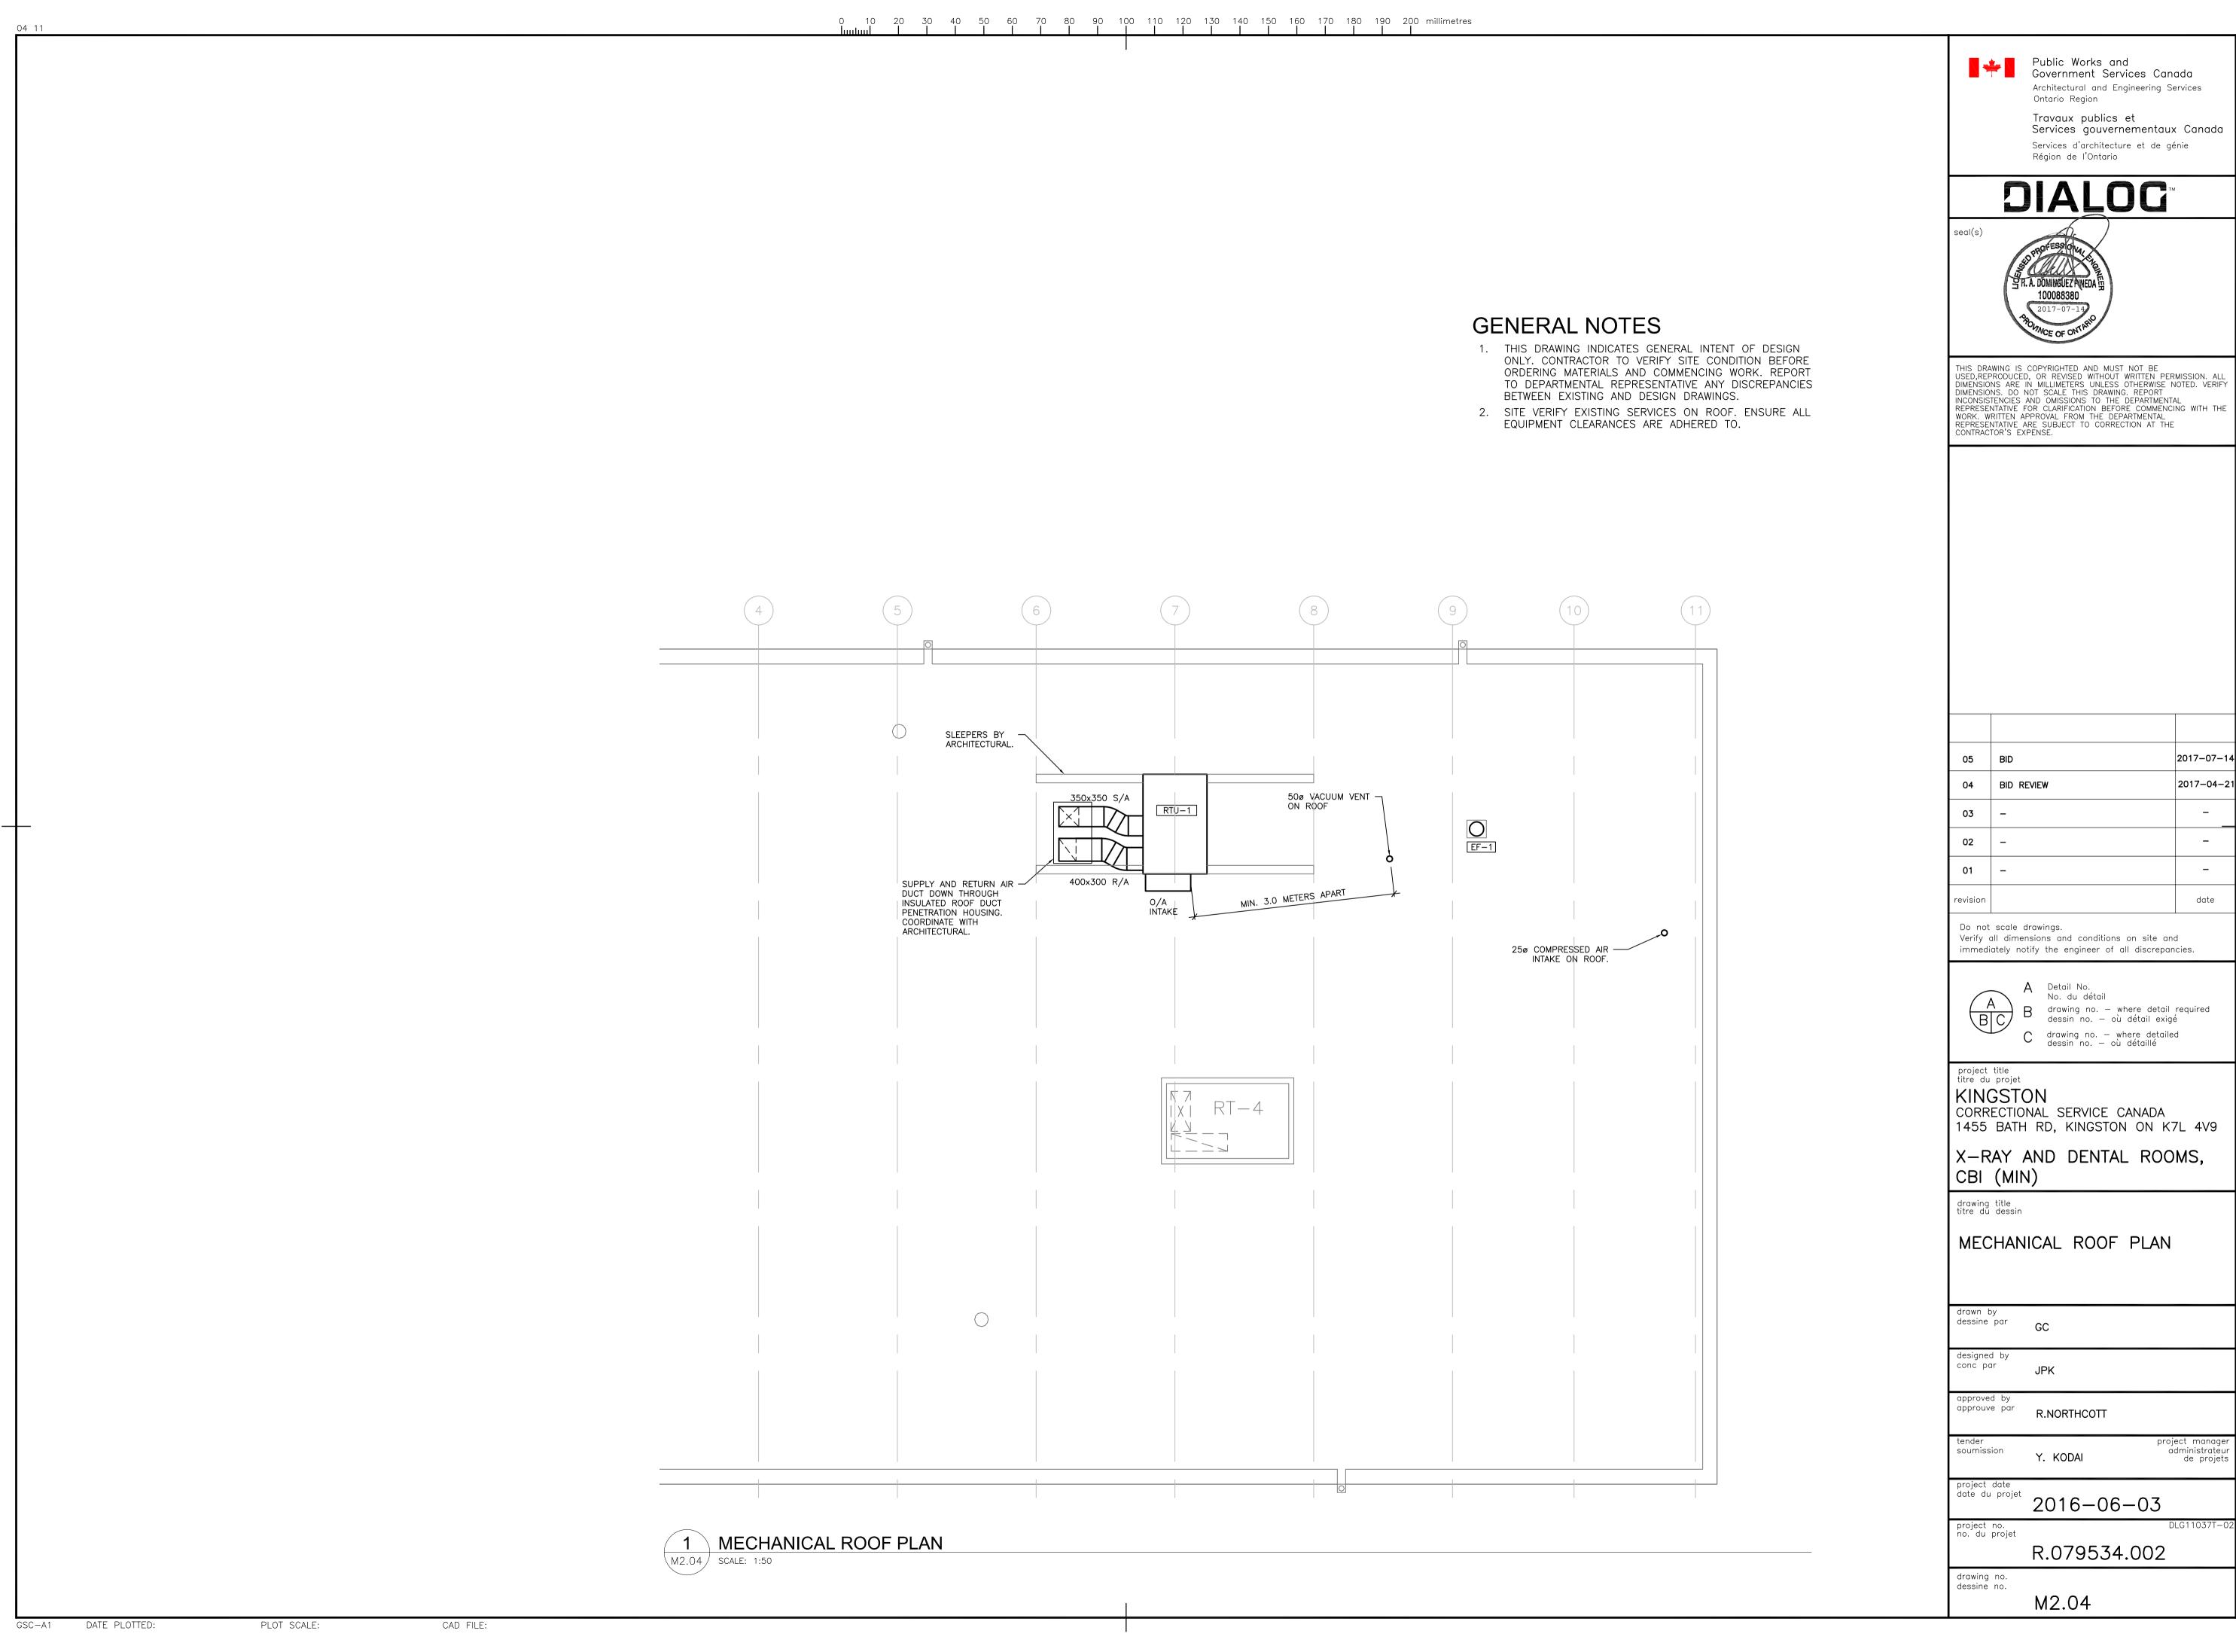

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PLOT SCALE:

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M3.01

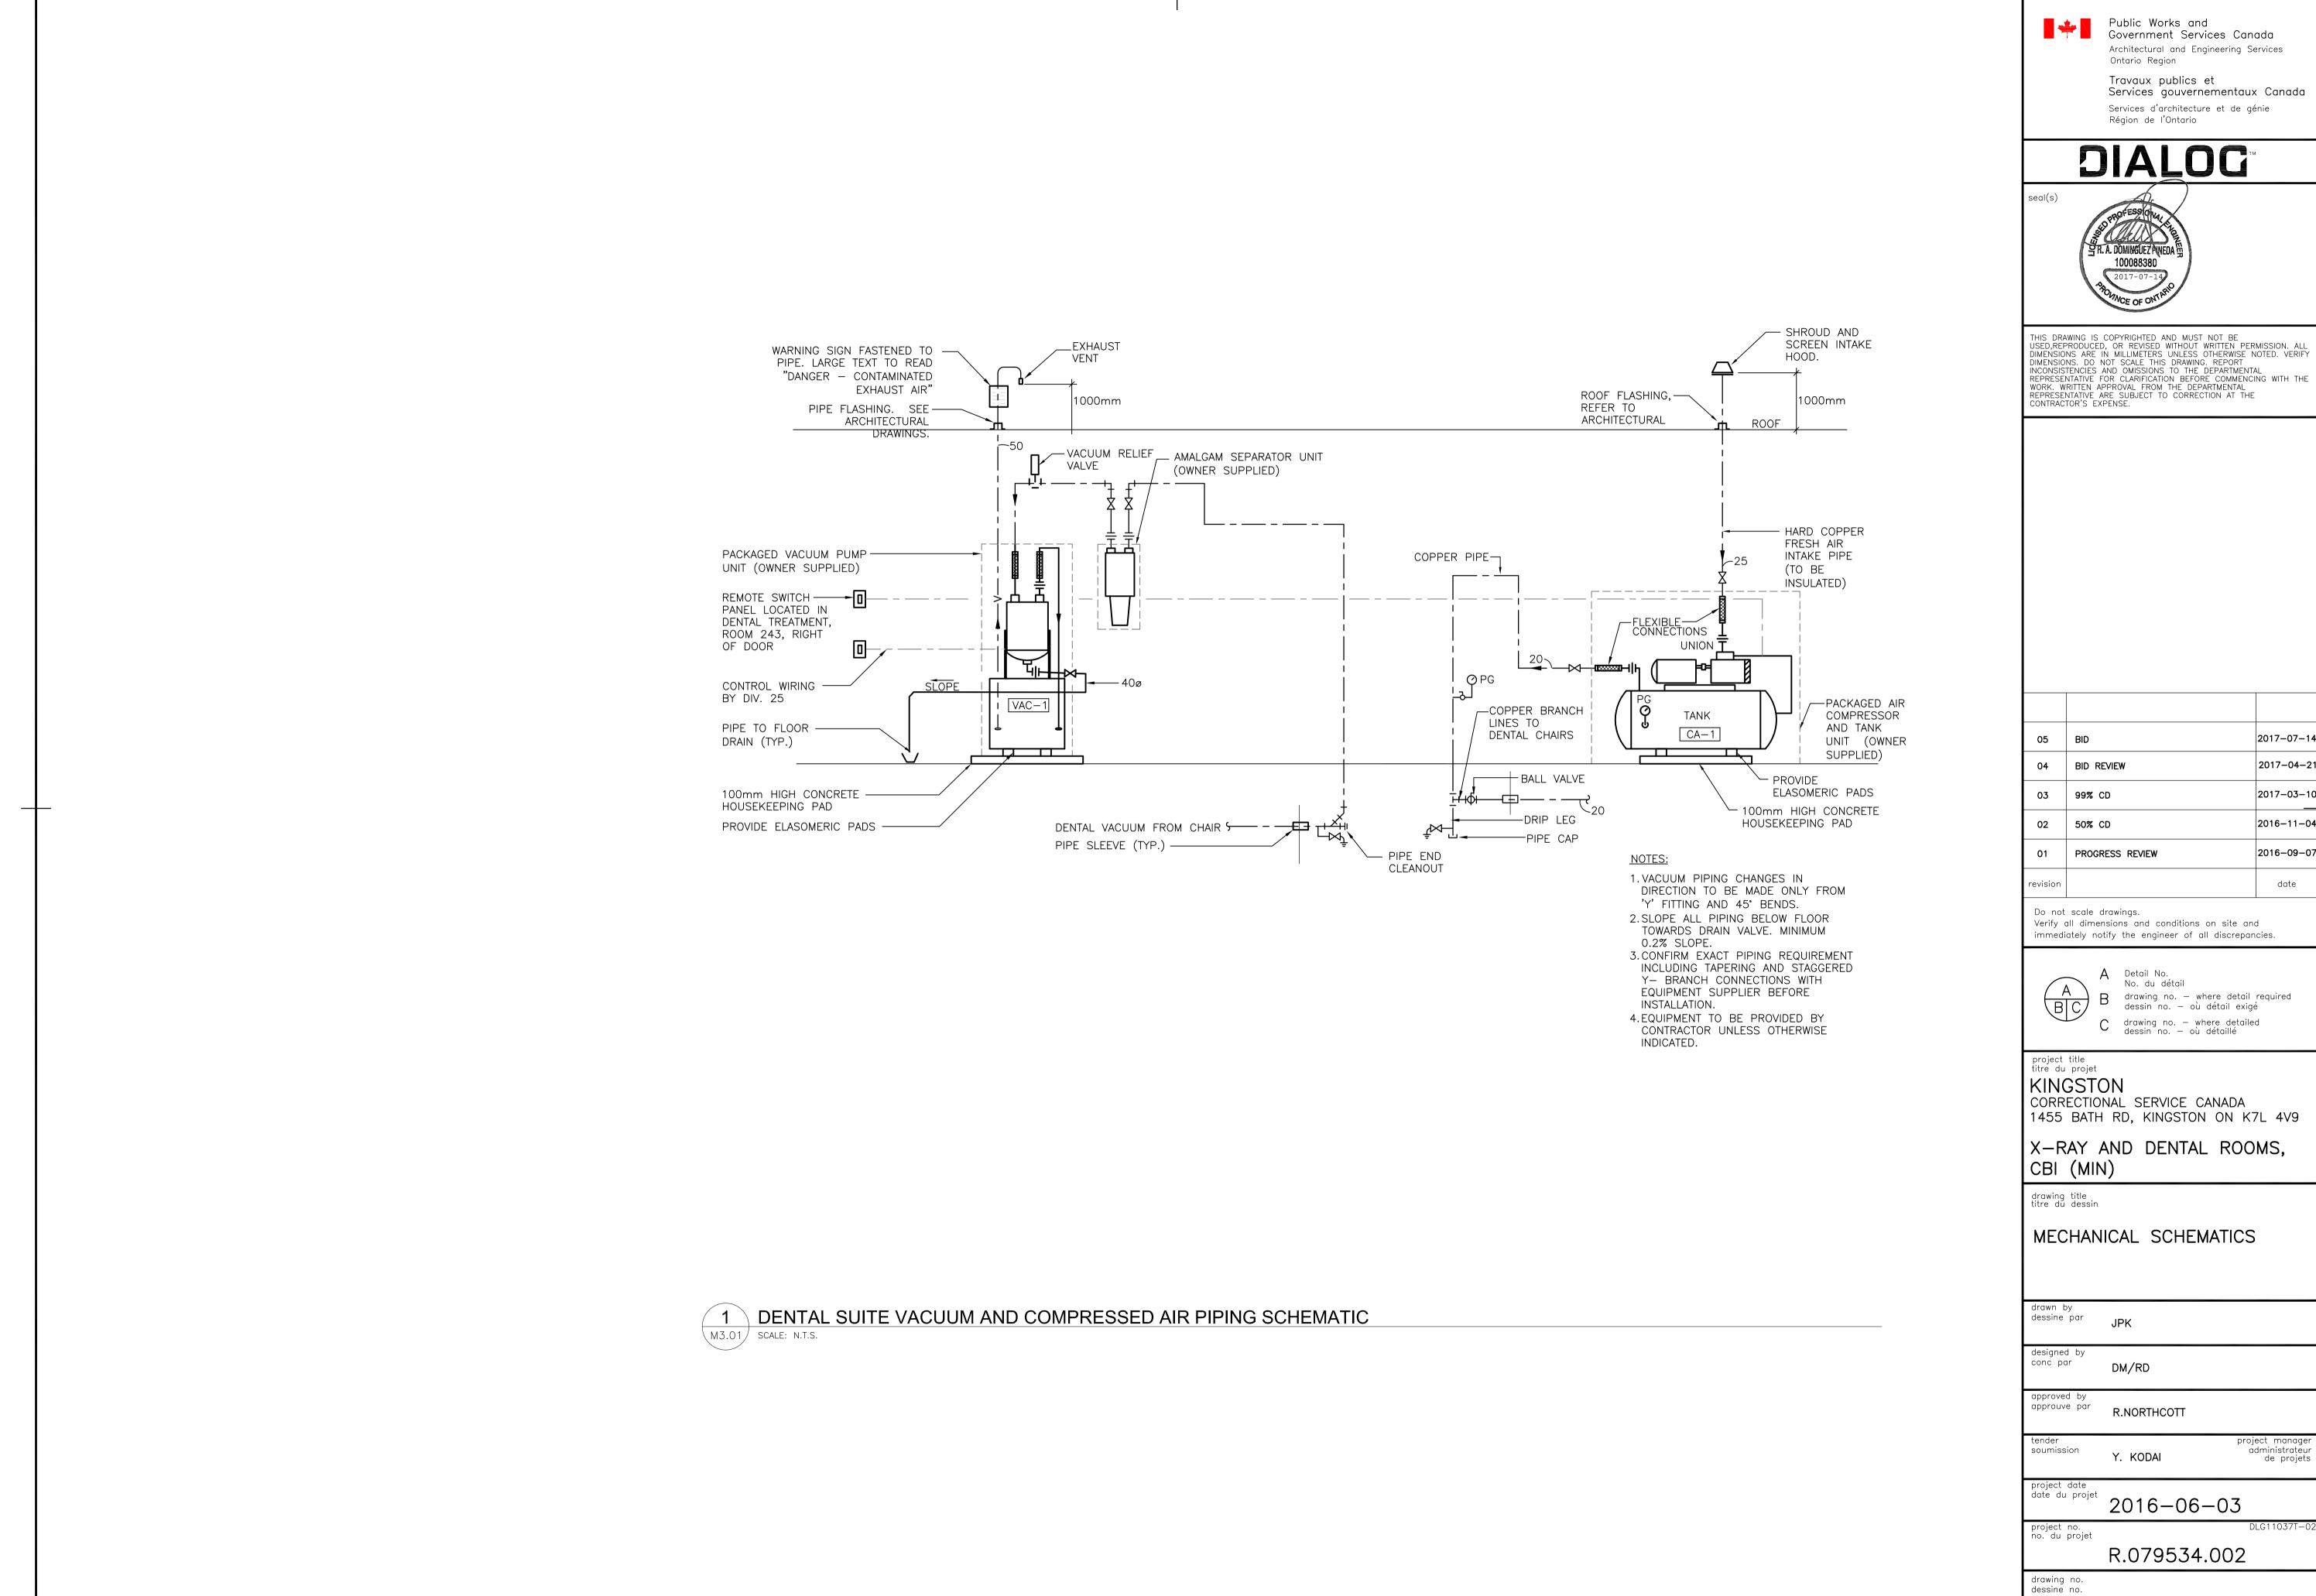PLUMB	ING FIXTURE SC	HEDULE
TAG	FIXTURE	DESCRIPTION/TRIM
FD-1	FLOOR DRAIN	EPOXY COATED CAST IRON FLOOR DRAIN, ANCHOR FLANGE, REVERSIBLE MEMBRANE CLAMP WITH PRIMARY AND SECONDARY WEEPHOLES, 6MM THICK ADJUSTABLE NICKEL BRONZE STRAINER.
FD-2	FUNNEL FLOOR DRAIN	EPOXY COATED CAST IRON FLOOR DRAIN, ANCHOR FLANGE, REVERSIBLE MEMBRANE CLAMP WITH PRIMARY AND SECONDARY WEEPHOLES, 6MM THICK ADJUSTABLE NICKEL BRONZE STRAINER, 100MMX225MM OVAL NICKEL BRONZE FUNNEL.
SK-1	WALL HUNG SINK	SINK: 457 MM (18") X 381 MM (15") X 178 MM (7"), RECTANGULAR, 16 GA. (1.5 MM) TYPE 304 STAINLESS STEEL SEAMLESS WELD CONSTRUCTION, SATIN FINISH, 76 MM (3") HIGH BACKSPLASH, 1-1/2" (38 MM) DIAMETER DRAIN PUNCHING, MOUNTING BRACKET PROVIDED. OFF-FLOOR, WALL OUTLET, SINGLE TEMPERATURE AIR—CONTROL, METERING, DECK MOUNTED SPOUT, 1.4 GPM (5.4 LPM), INSTALLED ON FINISHED WALL FROM THE FRONT SIDE, INSTALLER SHALL SUPPLY MOUNTING SCREWS AND ANCHOR SHIELDS, CONFORM WITH LEAD—FREE REQUIREMENTS FOR NSF61, SECTION 9, 1997 AND CHSC 116875. PROVIDE ACCESS TO VALVE FOR INSTALLATION AND SERVICE.  BELOW DECK MECHANICAL WATER MIXING VALVE: BRONZE BODY, TEMPERATURE ADJUSTING DIAL, 10 MM (3/8") INLETS AND OUTLET COMPRESSION FITTINGS, HIGH TEMPERATURE THERMOSTATIC LIMIT STOP, SHUT—OFF WITH AUTOMATIC RESET WHEN TEMPERATURE EXCEEDS 120 °F (48.8 °C), INTEGRAL CHECKS, OFFER TEMPERATURE RANGE FROM FULL COLD THROUGH 46 °C (114.8 °F). PROVIDE TEE, ADAPTORS AND FLEX. COPPER TUBING TO SUIT INSTALLATION.  OPEN GRID DRAIN: CAST BRASS ONE PIECE TOP, 17 GA. (1.5 MM) TUBULAR 32 MM (1-1/4") TAILPIECE.  FAUCET SUPPLIES: CHROME PLATED FINISH POLISHED BRASS, COMMERCIAL DUTY 1/4 TURN BALL VALVE ANGLE STOPS, 13 MM (1/2") I.D. INLET X 127 MM (5") HORIZONTAL EXTENSION TUBES, COMBINATION V.P. LOOSE KEY HANDLES, ESCUTCHEON AND FLEXIBLE COPPER RISERS.  P-TRAP, HEAVY CAST BRASS ADJUSTABLE BODY, WITH SLIP NUT, 32 MM (1-1/4") SIZE, SHALLOW WALL FLANGE AND SEAMLESS TUBULAR WALL BEND.  FIXTURE CARRIER, MOUNTED ON CONCRETE FLOOR, EPOXY COATED TOP AND BOTTOM UNIVERSAL STEEL HANGER PLATES, HEAVY GAUGE EPOXY COATED STEEL OFFSET UPRIGHTS WITH WELDED FEET SUPPORTS. FOR ONE UNIT: 102 MM (4") FOR TWO TO SIX UNITS IN A ROW: 152 MM (6") FINISHED METAL STUD WALL TO BACK OF PIPE SPACE.

ROOFT	OP UNIT SCH	EDULE								
TAG	SERVICE	SUPPLY AIR FLOW (L/S)	OUTDOOR AIR FLOW (L/S)	TOTAL COOLING CAPACITY	TOTAL ELECTRIC HEATING CAPACITY	E.S.P (PA)	MOTOR (KW)	V/PH/HZ	MOP (AMP)	NOTES
RTU-1	240, 242 & 243	566	170	10.9 KW	18 KW	125.00	0.53	575/3/60	25	1. PROVIDE NEW SLEEPERS ON ROOF. INSTALL AND COORDINATE WITH ROOFING CONTRACTOR. 2. BALANCE OUTDOOR AIR DAMPER TO ACHIEVE MINIMUM OUTDOOR AIRFLOW VALUE AS SHOWN. 3. PROVIDE NEW MERV 13 FILTER UPON CONSTRUCTION COMPLETION 4. PROVIDE NEW 7 DAY PROGRAMMABLE THERMOSTAT. 5. PROVIDE WEATHER PROOF CONVENIENCE OUTLET, 120V. COORDINATE WITH ELECTRICAL.

EXHAUS	EXHAUST FAN SCHEDULE									
TAG	SERVICE	AIR FLOW (L/S)	E.S.P (PA)	MOTOR (KW)	V/PH/HZ	MOTOR (RPM)	NOTES			
EF-1	STORAGE 243B	140	75.00	0.07	115/1/60	_	C/W VIBRATION ISOLATION. PROVIDE FACTORY MOUNTED SPEED CONTROLLER, AND REVERSE ACTING THERMOSTAT, PREMANUFACTURED ROOF CURB AS RECOMMENDED BY MANUFACTURER.			

DIFFUSE	DIFFUSER, GRILLE SCHEDULE								
TAG	SERVICE	MOUNTING	COLOUR	NOTES					
S-1	S/A	T-BAR	WHITE	SQUARE PLAQUE DIFFUSER, 610X610 IMPERIAL MODULE, STEEL CONST., POWDER COAT FIN					
R-1	R/A	T-BAR	WHITE	EGG CRATE FACE R/A GRILLE, 610x305 ALUMINUM CONST., POWDER COAT FIN					
E-1	E/A	T-BAR	WHITE	EGG CRATE FACE E/A GRILLE, ALUMINUM CONST., POWDER COAT FIN					

PLUMBING FIXTURE CONNECTION SCHEDULE							
FIXTURE	CAST IRON	RAIN DWV COPPER	VENT	COLD WATER	HOT WATER		
SINK	40ø	40ø	32ø	15ø	15ø		
FLOOR DRAIN	75ø	_	_	_	_		

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project title titre du projet

KINGSTON CORRECTIONAL SERVICE CANADA 1455 BATH RD, KINGSTON ON K7L 4V9

X-RAY AND DENTAL ROOMS, CBI (MIN)

drawing title titre du dessin

MECHANICAL SCHEDULE

drawn by dessine par JPK

designed by conc par DM/RD

approved by approuve par R.NORTHCOTT


project manager administrateur de projets soumission Y. KODAI


drawing no. dessine no.

project date date date du projet 2016-06-03

project no. no. du projet R.079534.002


M4.01

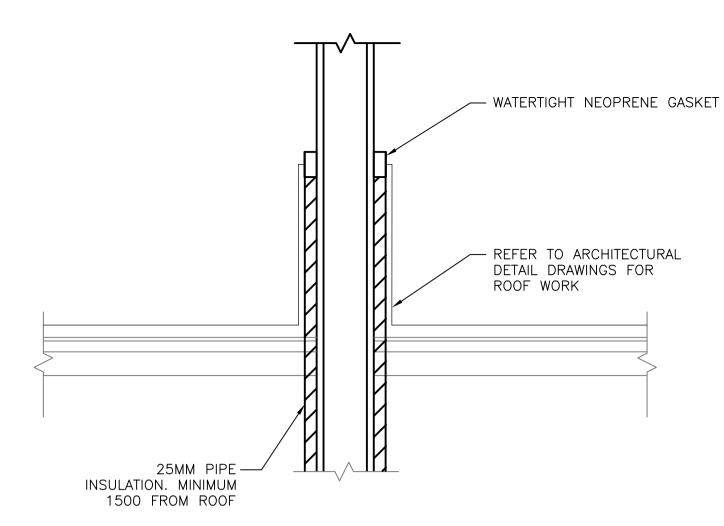

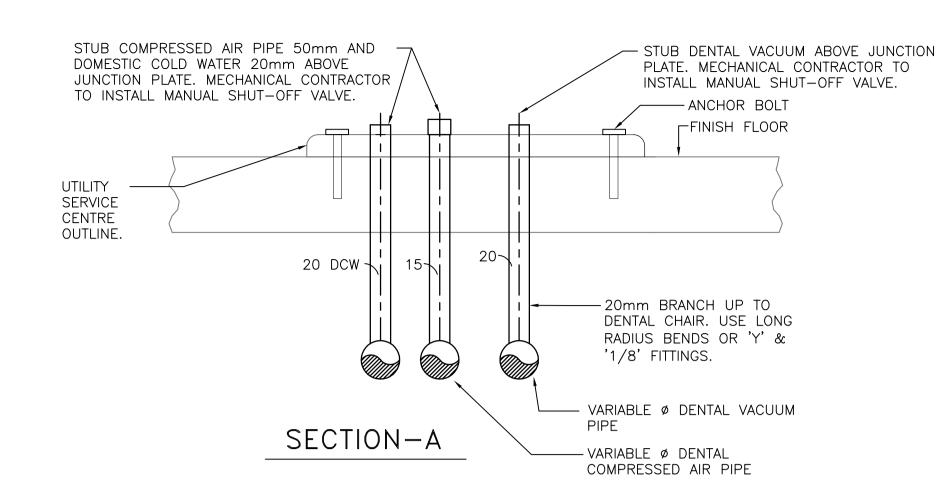


2 DENTAL CHAIR UTILITY CENTRE DETAIL

\ M5.01 / SCALE: 1:50

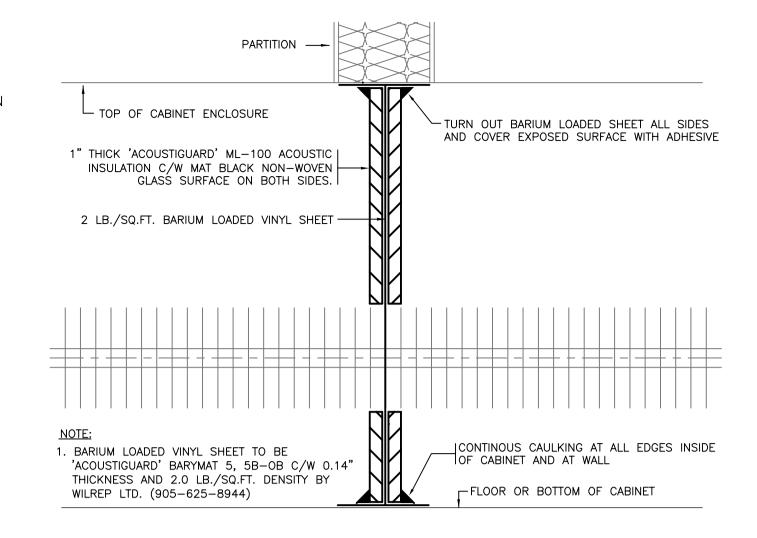


SOUND BAFFLE AT PERIMETER CONVECTOR M5.01 SCALE: NTS




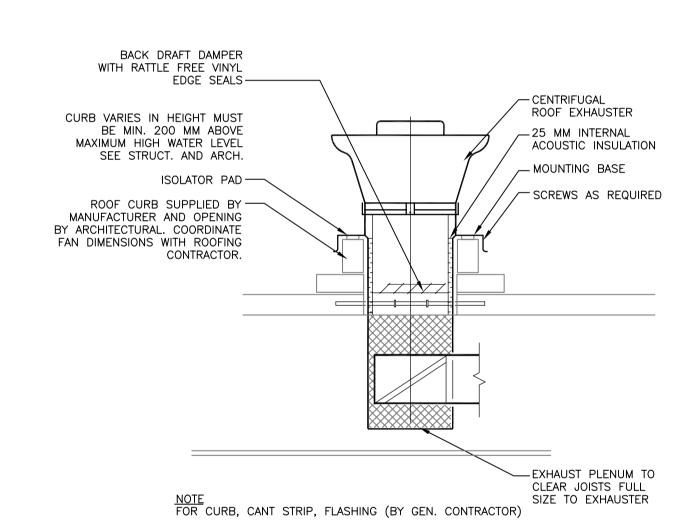

ROOF MOUNTED EXHAUST FAN DETAIL M5.01 SCALE: N.T.S.

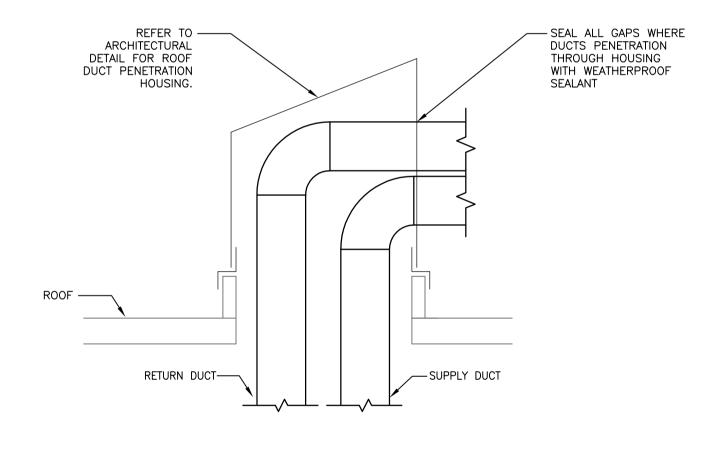

ROOF DUCT PENETRATION DETAIL M5.01 SCALE: N.T.S.

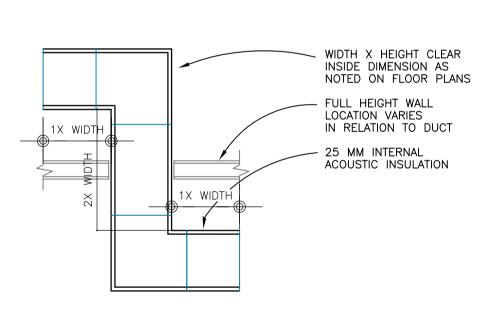

6 Z-DUCT DETAIL M5.01 SCALE: N.T.S.

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KINGSTON CORRECTIONAL SERVICE CANADA 1455 BATH RD, KINGSTON ON K7L 4V9

X-RAY AND DENTAL ROOMS, CBI (MIN)

drawing title titre du dessin


MECHANICAL DETAILS

drawn by dessine par JPK DM/RD approuve par R.NORTHCOTT soumission Y. KODAI


project date date du projet 2016-06-03


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M5.01

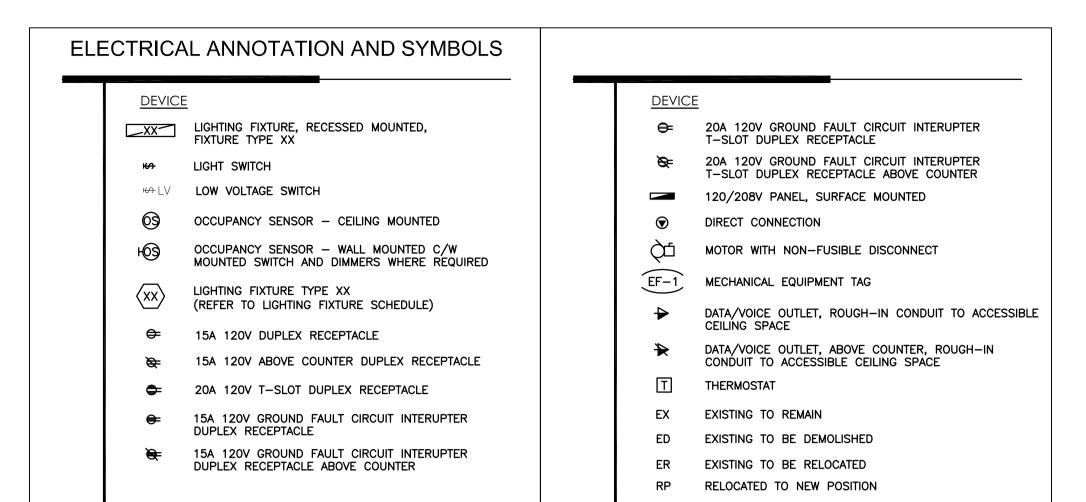


MECHANICAL EQUIPMENT SCHEDULE								
TAG	UNIT DESCRIPTION	SIZE (W)	VOLTAGE PHASE	SUPPL OF DE M		SUPPL DISCO M		REMARKS
RTU-1	ROOF TOP UNIT		600V/3ø	Χ	_	X	_	MOP: 25A
EF-1	EXHAUST FAN	70W	120V/1ø	Χ	_	Х	_	MOP: 15A



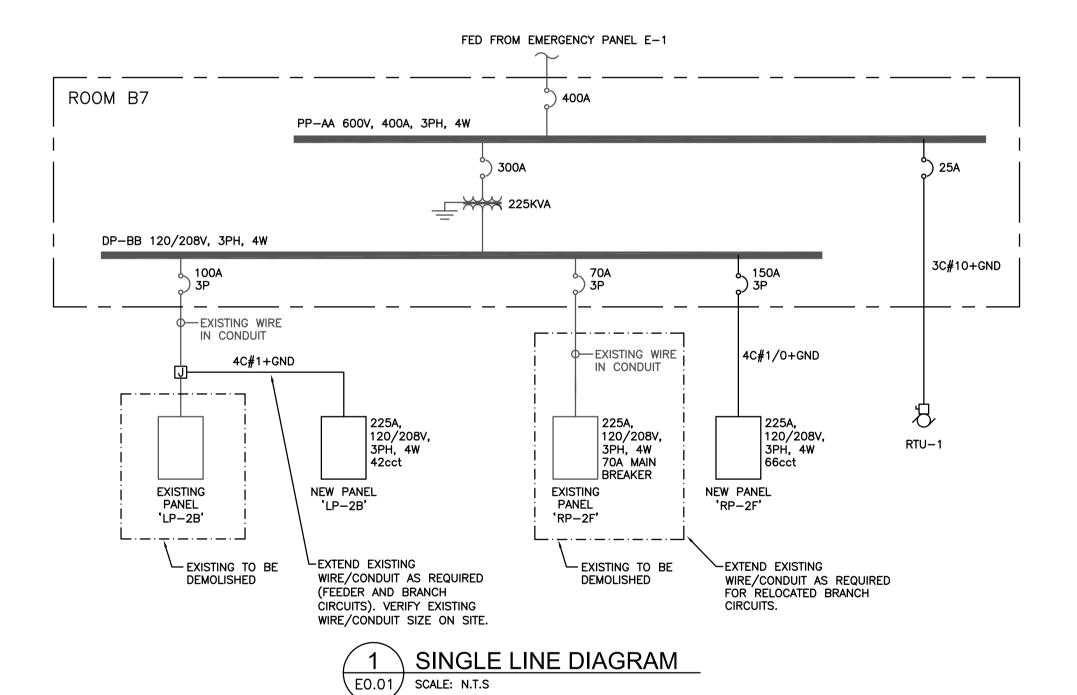

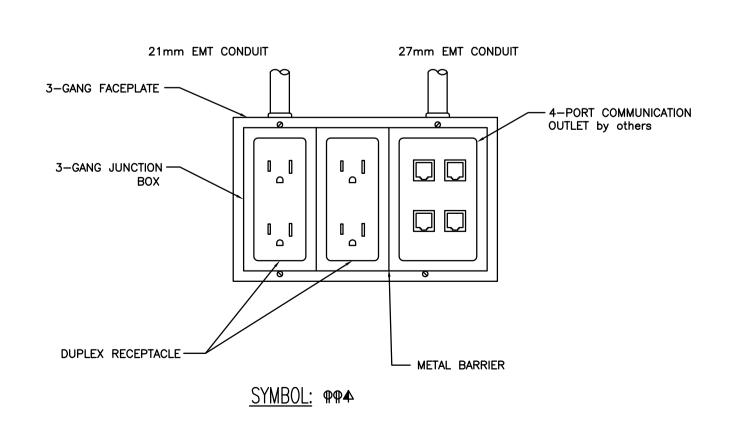TYPICAL WALL MOUNTED POWER AND DATA OUTLETS DETAIL

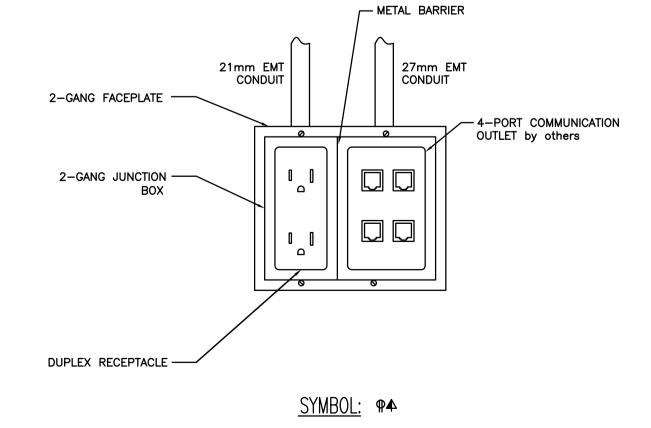

3	TYPICAL WALL MOUNTED POWER AND DATA OUTLETS
E0.01	SCALE: N.T.S

ELEC	TRICAL DRAWING LIST
E0-01	ELECTRICAL LEGEND, SCHEDULES, DETAILS & DRAWING LIST
E1-01	ELECTRICAL DEMOLITION PLAN
E2-01	LIGHTING AND POWER & SYSTEMS PLANS
E2-02	ELECTRICAL ROOF PLAN

		PANE	L NUMBI	ER: LI	P-2B								
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37	EXISTING LOADS					Α				EXISTING	LOADS		38
39	EXISTING LOADS					В				EXISTING	LOADS		40
41						С				EXISTING	LOADS		42
	CONNECTED LOAD		LC	DAD 1	TYPE			DIVERS	SITY		DEMAND		
								FAC	TOR				
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hase C:		kVA		CEP OTOR		:		kVA	0.5				kVA kVA
TOTAL :		kVA		ATE		:		kVA	0.7				kVA
Summer Load:		kVA	01	THER	S	:		kVA	1.0	TOT:: 5-			kVΔ
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7		EXISTING LOADS				Α				EXISTING	LOADS	8
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17						С				EXISTING	LOADS	18
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21		EXISTING LOADS				В				EXISTING	LOADS	22
23		EXISTING LOADS				С				EXISTING	LOADS	24
25		EXISTING LOADS				Α				EXISTING	LOADS	26
27		EXISTING LOADS				В				EXISTING	LOADS	28
29						С				EXISTING	LOADS	30
31						Α				EXISTING	LOADS	32
33						В						34
35						С						36
37	REC.	RECEPTACLES RM 240		0.80	15A	Α	20 <i>A</i>	1.50	REC.	PORTABL	E X-RAY MACHINE	38
39	REC.	WORKSTATION RM 240,	242	0.60	15A	В		0.60				40
41	REC.	RECEPTACLES RM 242A,		0.40	15A	С	2P			VAC-1		42
43		NURSING STATION RM		0.80	15A	Α	15 <i>A</i>		MTR.			44
45	REC.	NURSING STATION RM		0.60	15A	В	2P			CA-1		46
47	REC.	WORKSTATION RM 243A		0.40	15A	С	15A		REC.	CEILING	MTD. X-RAY MACH.	48
49		GFI RECEPTACLES RM 24		0.60	15A	Α		0.50		DENTAL C		50
51	REC.	RECEPTACLES RM 243A	-	0.60	15A	В			MTR.	EF-1		52
53	REC.	WORKSTATION RM 243		0.80	15A	c	15A	0.20			I RECEPTACLE	54
55	REC.	RECEPTACLES RM 243		0.60	15A	A	15A	0.50			R THERMOSTAT	56
57	REC.	RECEPTACLES RM 243		0.60	15A	В			отн.	230101		58
59		THE PROPERTY OF THE PROPERTY O		0.00	10/1	c	2P		отн.	HEAT TRA	ACING	60
61						A	<u> </u>	0.00	J.11.			62
63						В						64
65						С						66
00												] 00
		CONNECTED LOAD		LOAD 1	TYPE			DIVER	SITY		DEMAND	
						<u> </u>		FAC	TOR			
Phase Phase			kVA kVA	LIGHTI			10.7	·\$	1.0 0.5		5 A	kVA kVA
Phase			kVA	MOTOR		<u> </u>	3.3		0.3			kVA
TOTAL			kVA	HEATE		:			0.7			kVA
Summer Winter L			kVA kVA	OTHER	3	:		KVA	1.0	TOTAL DE	MAND:	kVA
	UM:	1	kVA	TOTAL		1	14.0	kVA				kVA

Public Works and Government Services Canada Architectural and Engineering Services Ontario Region

Travaux publics et Services gouvernementaux Canada Services d'architecture et de génie Région de l'Ontario

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4	BID	2017-07-14
3	99% CD	2017–03–10
2	50% CD	2016-11-04
1	PROGRESS REVIEW	2016-09-07
ision		date

Do not scale drawings. Verify all dimensions and conditions on site and immediately notify the engineer of all discrepancies.



project title titre du projet KINGSTON CORRECTIONAL SERVICE CANADA 1455 BATH RD, KINGSTON ON K7L 4V9

X-RAY AND DENTAL ROOMS, CBI (MIN)

ELECTRICAL LEGENDS, SCHEDULES AND DRAWING LIST

R.NORTHCOTT

project manager administrațeur soumission Y. KODAI

project date date du projet 2016-06-03


project no. no. du projet

R.079534.002 drawing no. dessine no.

E0 - 01

DATE PLOTTED: PLOT SCALE: CAD FILE:

E0.01 SCALE: N.T.S

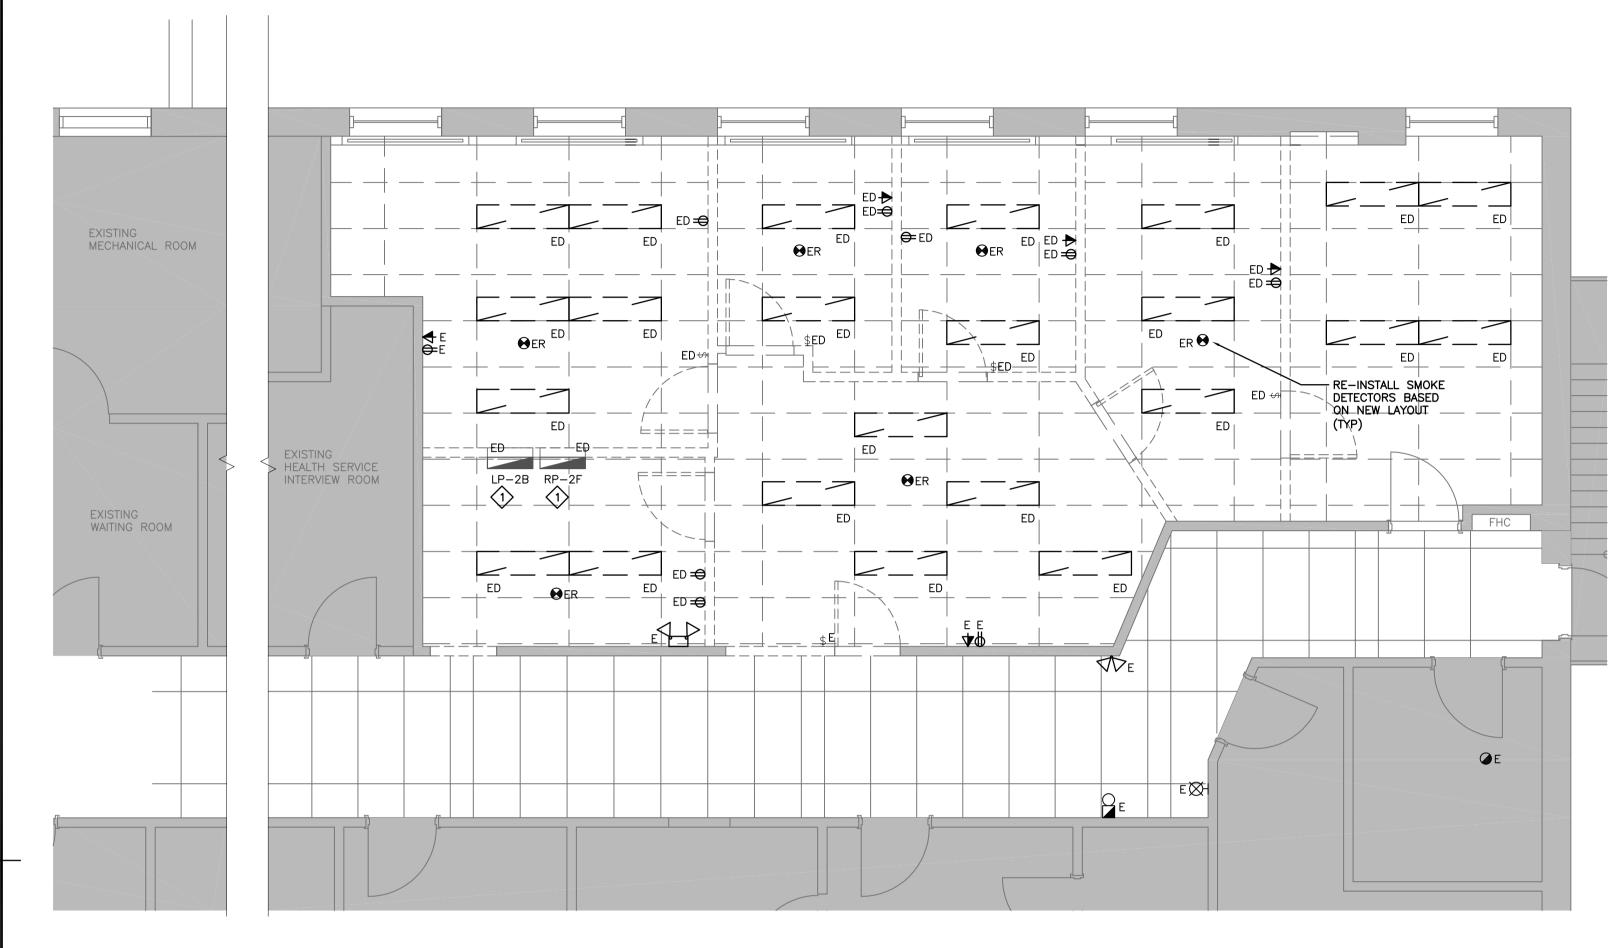

ELECTRICAL DEMOLITION PLAN E1-01 SCALE: 1:50

#### **GENERAL NOTES:**

- UNLESS OTHERWISE INDICATED, ALL ELECTRICAL CEILING DEVICES, WALL DEVICES, AND EQUIPMENT CONNECTIONS NO LONGER REQUIRED SHALL BE DEMOLISHED. CONTRACTOR TO REVIEW SITE FOR EXACT QUANTITIES OF DEVICES PRIOR TO SUBMITTING BID PRICE.
- WHERE EQUIPMENT IS INDICATED FOR DEMOLITION, DEMOLISH ALL BREAKERS, WIRING, CONDUIT, STARTERS, DISCONNECTS AND ALL ANCILLARY DEVICES UNLESS OTHERWISE INDICATED.
- 3. REMOVE ALL REDUNDANT WIRING BACK TO SOURCE.

#### KEYNOTES:

1) EXISTING PANEL TO BE DEMOLISHED. NEW PANEL TO BE LOCATED NEARBY. EXTEND & SPLICE ALL INCOMING & OUTGOING WIRING/CONDUIT AS REQUIRED TO SUIT NEW PANEL LOCATION & FINAL LOADS. REFER TO 1/E0.01.

Public Works and Government Services Canada Architectural and Engineering Services Ontario Region

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04	BID	2017-07-14
03	99% CD	2017-03-10
02	50% CD	2016-11-04
01	PROGRESS REVIEW	2016-09-07
revision		date

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Detail No. No. du détail drawing no. — where detail required

project title titre du projet KINGSTON CORRECTIONAL SERVICE CANADA 1455 BATH RD, KINGSTON ON K7L 4V9

X-RAY AND DENTAL ROOMS, CBI (MIN)

drawing title titre du dessin

ELECTRICAL DEMOLITION PLAN

R.NORTHCOTT


tender soumission Y. KODAI

project manager administrateur de projets

project date date du projet 2016-06-03

project no. no. du projet R.079534.002

E1 - 01

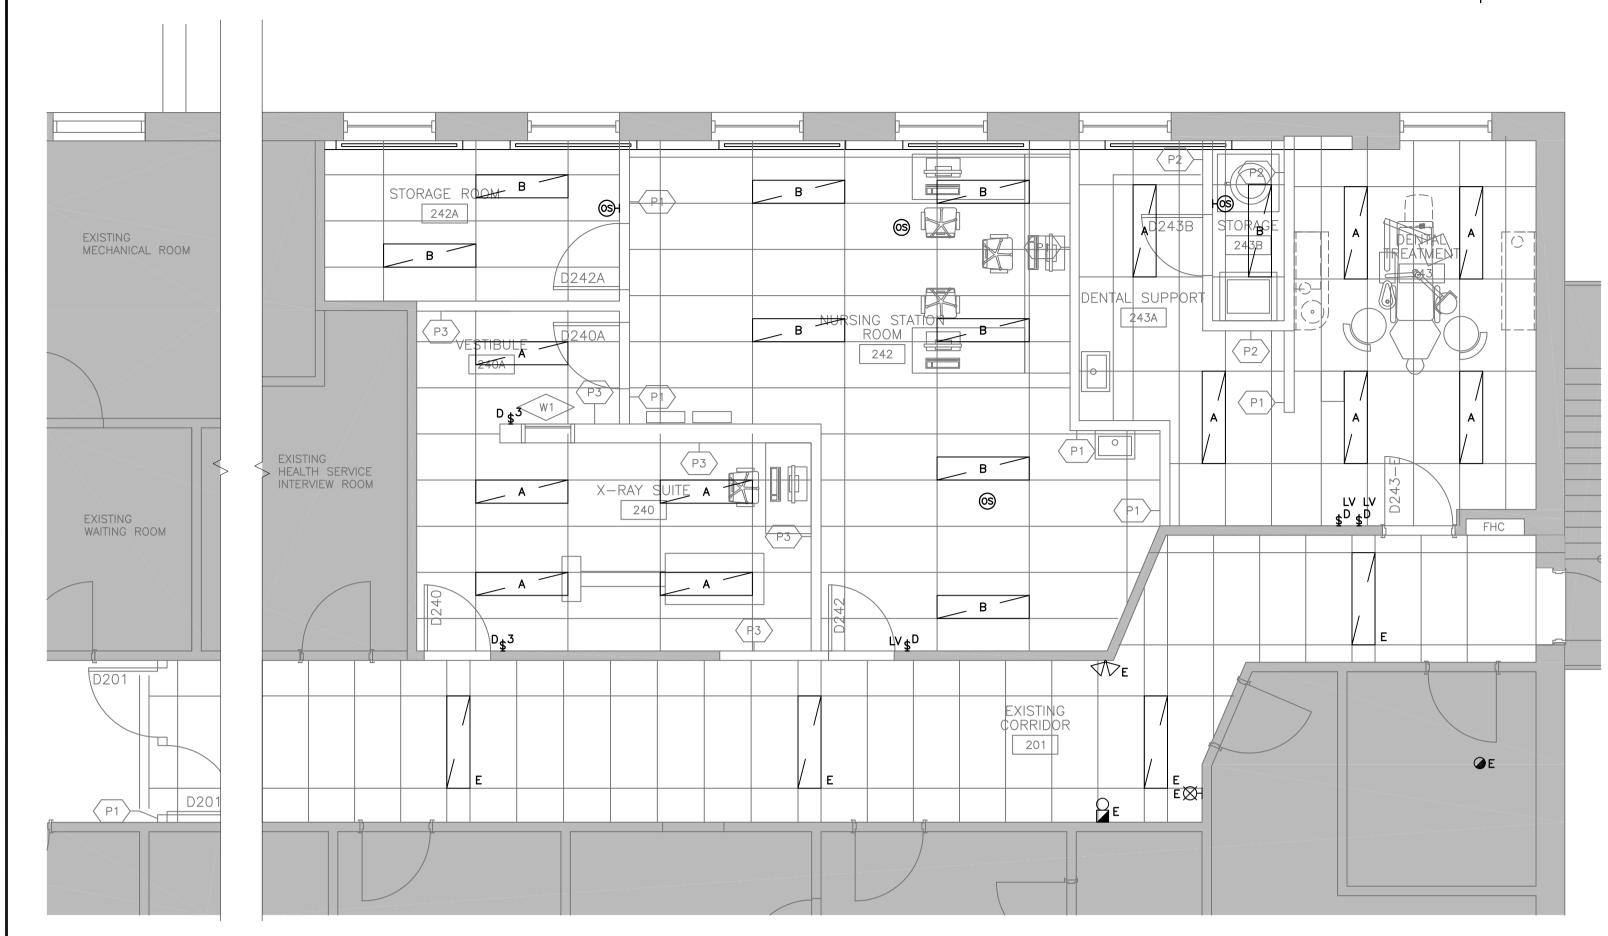

LIGHTING PLAN

SCALE: 1:50

SCALE: 1:50

PLOT SCALE:

CAD FILE:

DATE PLOTTED:

#### **GENERAL NOTES:**

RE-USE EXISTING LIGHTING CIRCUITS. RE-ARRANGE CIRCUITING AS REQUIRED TO ENSURE MAX LOAD PER CIRCUIT 1200W.

LIGHTING FIXTURE SCHEDULE:						
	TYPE	DESCRIPTION	VOLTS	LAMPS	REMARKS	
	Α	CEILING RECESSED CONFINEMENT FIXTURE. 1220X305 DIE FORMED COLD ROLLED STEEL, SINGLE BODY HOUSING, ONE PIECE OVERLAPPING DOOR FRAME, POLYCARBONATE SECURITY LENSING, TAMPER RESISTANT FASTENERS.	120V	LED 3500 LUMENS COLOUR TEMPERATURE TO MATCH EXISTING	0-10V DIMMING WHERE DIMMING SWITCH IS INDICATED	
	В	CEILING RECESSED DIRECT/INDIRECT FIXTURE. 1200X305 COLD ROLLED STEEL, SHALLOW BODY, SMOOTH ACRYLIC LENS.	120V	LED 3100 LUMENS COLOUR TEMPERATURE TO MATCH EXISTING	0-10V DIMMING WHERE DIMMING SWITCH IS INDICATED	

#### GENERAL NOTES:

- X-RAY/SCAN SLAB PRIOR TO ANY CORING OR TRENCHING. COORDINATE WORK WITH DEPARTMENTAL REPRESENTATIVE.
- DENTAL TREATMENT 243 AND X-RAY SUITE 240 ARE CONSIDERED AN INTERMEDIATE PATIENT CARE AREA UNDER CSA Z32.15.
- ELECTRICAL INSTALLATION IN PATIENT CARE AREAS FLOOR TO CEILING TO MEET REQUIREMENTS OF CSA Z32.15 AND OESC.
- ALL PATIENT CARE AREA RECEPTACLES SHALL BE INSTALLED AND TESTED ACCORDING TO CSA STANDARD Z32.15 REQUIREMENTS. REFER ALSO TO SPECIFICATIONS FOR FURTHER REQUIREMENTS.

#### **KEYNOTES:**

- RELOCATE ALL EXISTING BRANCH CIRCUITS TO NEW PANEL. EXTEND & SPLICE ALL INCOMING & OUTGOING WIRING/CONDUIT AS NEEDED TO SUIT NEW PANEL LOCATION & FINAL LOADS. REFER TO 1/E0.01.
- ELECTRICAL CONTRACTOR TO COORDINATE WITH EQUIPMENT VENDOR AND PROVIDE UNDER-FLOOR CONDUITS, MOUNTING BOX AND QUAD
- CONFIRM ON SITE FOR THE EXACT RECEPTACLE CONFIGURATION PRIOR TO ROUGH-IN.

RECEPTACLES FOR DENTAL CHAIR.

Public Works and Government Services Canada Architectural and Engineering Services Ontario Region

Travaux publics et Services gouvernementaux Canada Services d'architecture et de génie Région de l'Ontario

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04	BID	2017-07-14
03	99% CD	2017-03-10
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01	PROGRESS REVIEW	2016-09-07
revision		date

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KINGSTON

Detail No. No. du détail drawing no. — where detail required

drawing no. — where detailed

project title titre du projet

CORRECTIONAL SERVICE CANADA 1455 BATH RD, KINGSTON ON K7L 4V9 X-RAY AND DENTAL ROOMS,

CBI (MIN) drawing title titre du dessin

LIGHTING AND POWER & SYSTEMS PLANS

dessine par

conc par

approuve par R.NORTHCOTT

soumission

project manager administrațeur Y. KODAI

DLG11037T-02

project date date du projet

2016-06-03

project no. no. du projet R.079534.002

drawing no. dessine no.

E2 - 01

