

CORRECTIONAL SERVICE CANADA

MOUNTAIN INSTITUTION HEALTH CARE EXPANSION

4732 CEMETERY ROAD, AGASSIZ, BC

Public Works and
Government Services
Canada

Traux publics et
Services gouvernementaux
Canada

REAL PROPERTY SERVICES

Pacific Region

SERVICES IMMOBILIERS

Région de Pacifique

MGBA
MALLEN GOWING BERZINS
ARCHITECTURE




(Professional Seal)

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PRIME CONSULTANT

- ARCHITECTURAL
- MGB ARCHITECTURE

CONSULTANTS

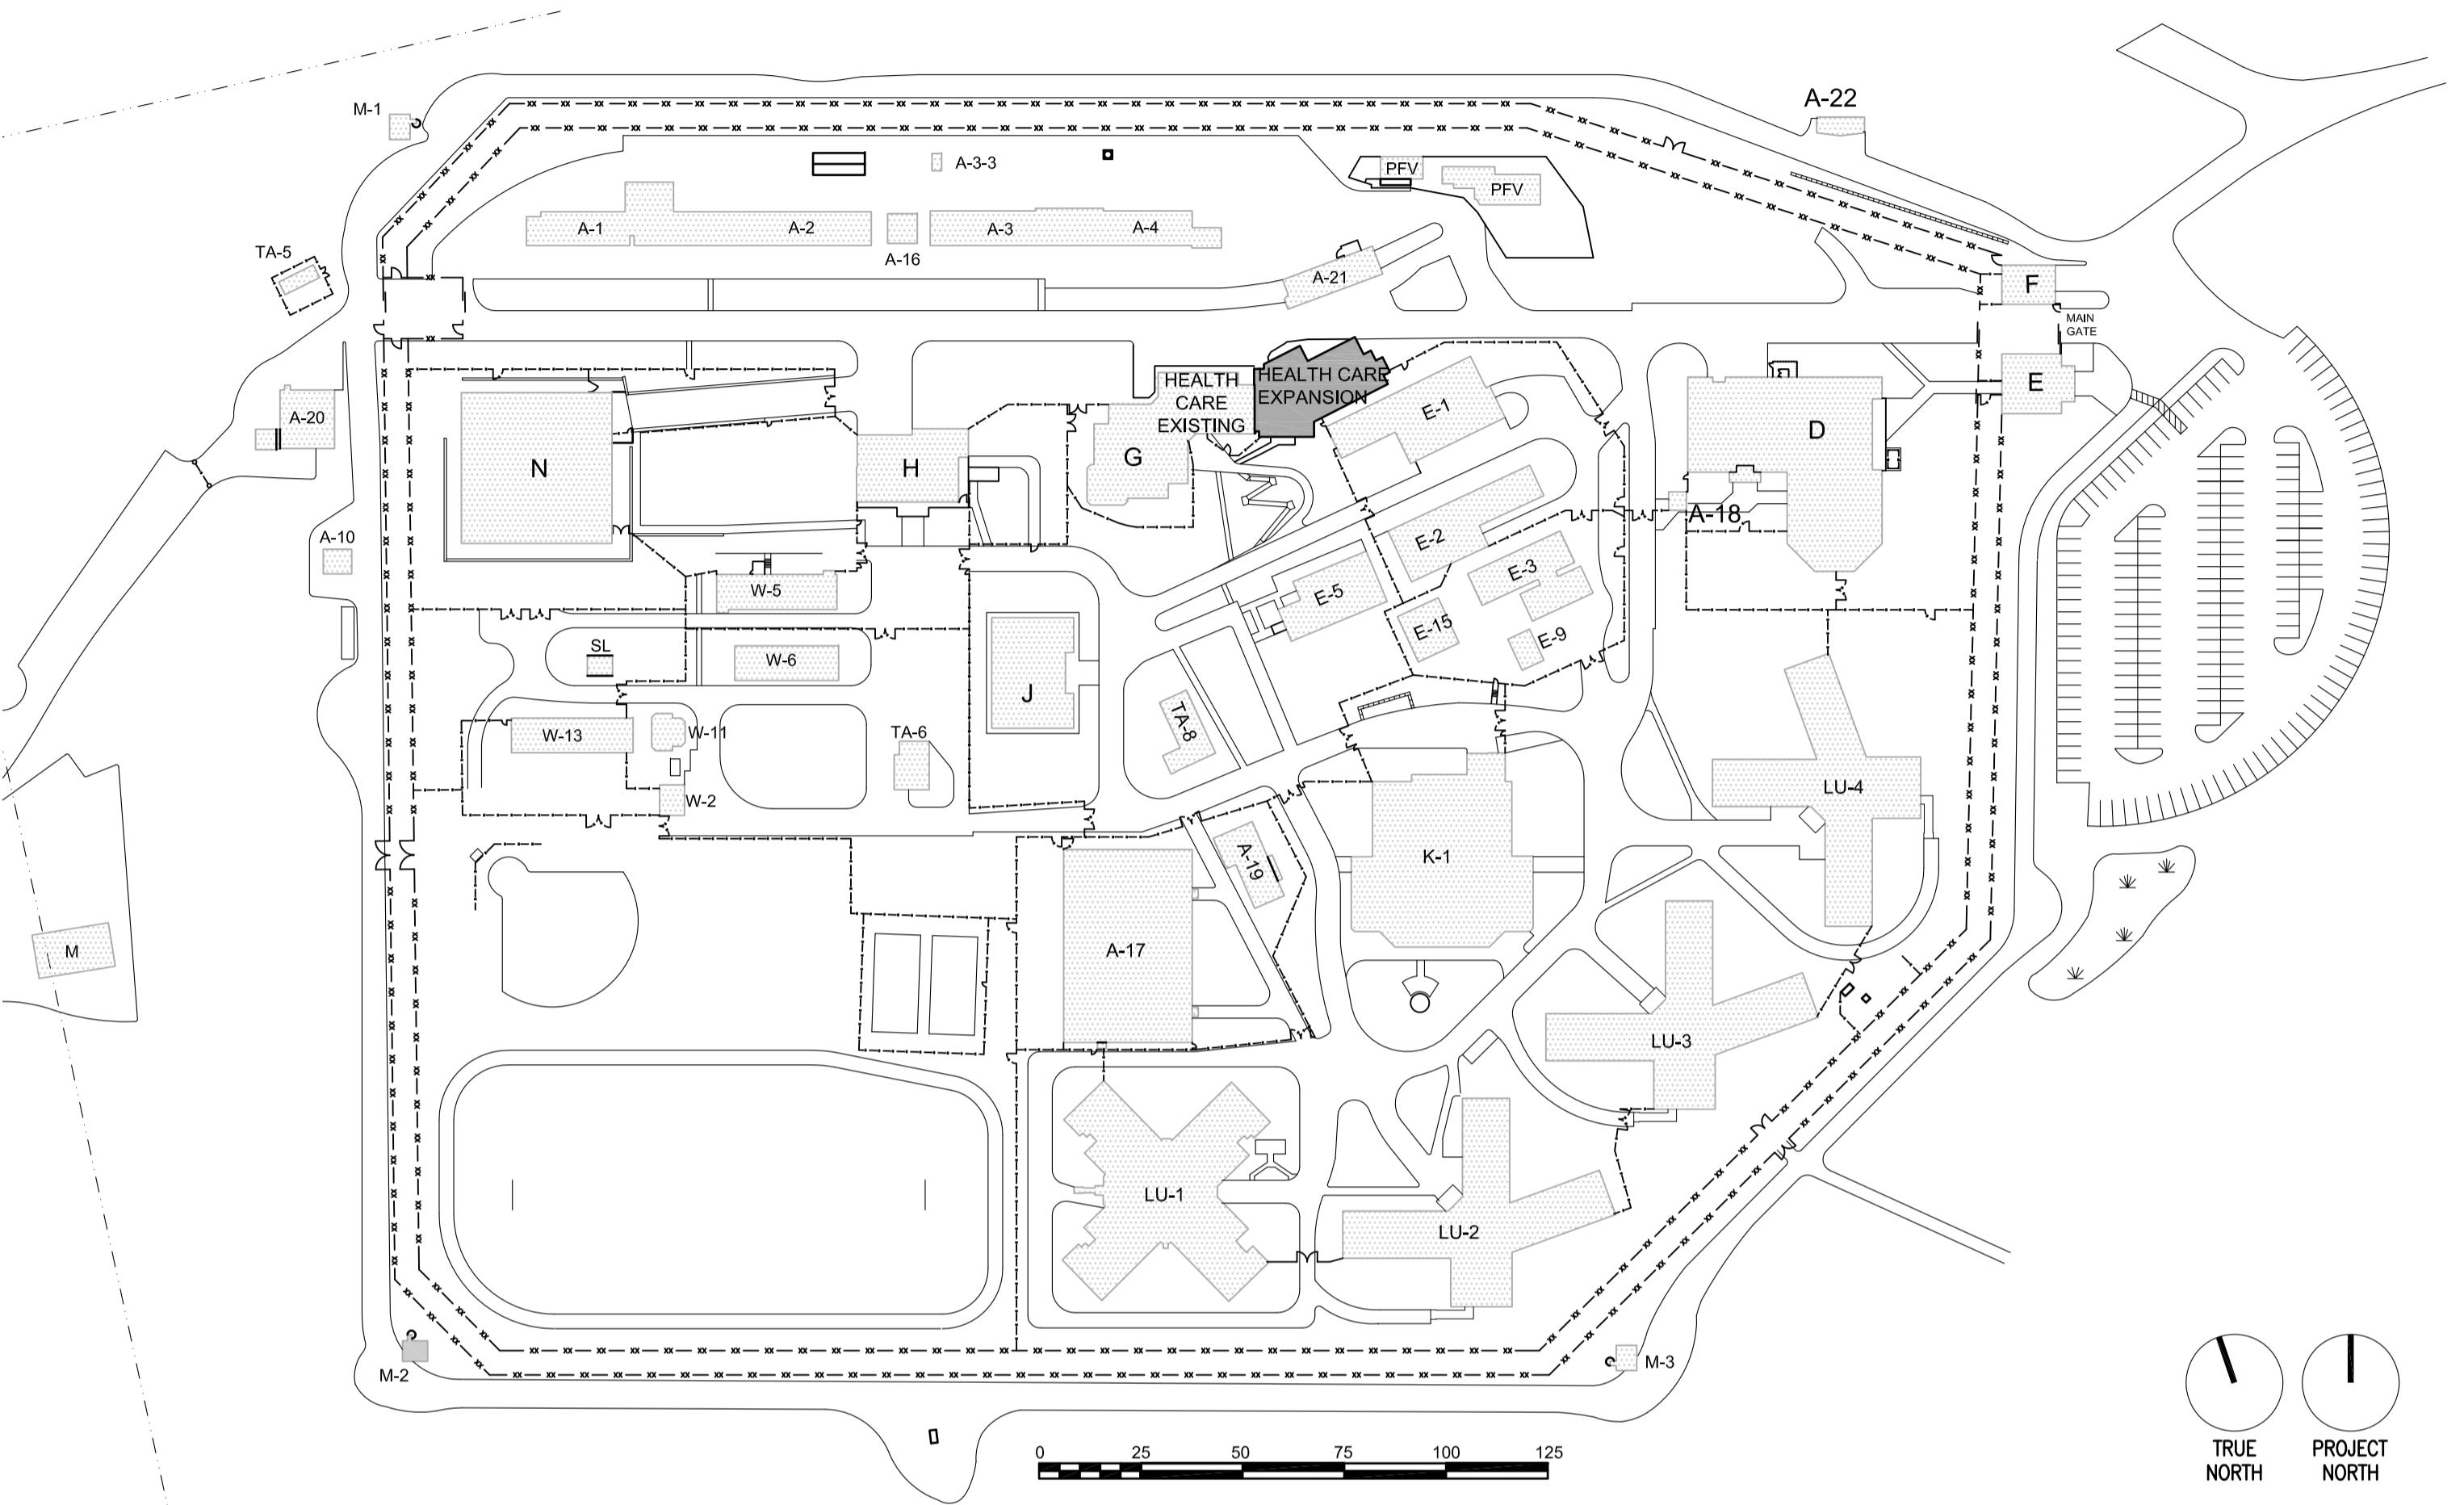- STRUCTURAL
- BUSH, BOHLMAN & PARTNERS LLP

MECHANICAL / PLUMBING / FIRE PROTECTION

- JM BEAN & CO. LTD.
- MEMBER OF INTEGRAL GROUP

ELECTRICAL

- AES ENGINEERING LTD.

CIVIL

- WEDLER ENGINEERING

GEOTECHNICAL

- BRAUN GEOTECHNICAL

EQUIPMENT CONSULTANT

- CAROLINE WEBSTER CONSULTING INC.

SPECIFICATIONS

- SPECTECH CONSULTING LTD.

QUANTITY SURVEYOR

- TURNER & TOWNSEND

PROJECT MANAGER

- PWGSC
- PUBLIC WORKS AND GOVERNMENT SERVICES CANADA

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**CORRECTIONAL
SERVICE OF
CANADA**

Project Title/Titre du projet
AGASSIZ, BRITISH COLUMBIA
4732 CEMETERY ROAD PO BOX 1600
MOUNTAIN INSTITUTION

**MOUNTAIN INSTITUTION
HEALTH CARE EXPANSION**

Consultant Signature Only

Designed by/Concept par
EDWIN BERZINS

Drawn by/Dessiné par
MING HSU

PWGSC Project Manager/Administrateur de Projets TPSGC
TONY TANG

Regional Manager, Architectural and Engineering Services
Gestionnaire régionale, Services d'architecture et de génie, TPSGC
PREETPAL PAUL

Drawing title/Titre du dessin

**TITLE SHEET &
OVERALL SITE PLAN**


Project No./No. du projet	Sheet/Feuille no.	Revision no./ Révision no.
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PROJECT LOCATION:

CIVIC ADDRESS:
4732 CEMETERY ROAD
AGASSIZ, BRITISH COLUMBIA
V0M 1A0

LEGAL ADDRESS:
SUB-DIVISION OF DISTRICT LOT 2678, GROUP1
& FRACTIONAL LEGAL SUB-DIVISIONS 11, 13
& 14 OF SECTION 34, TP.3, RANGE 29, W6M,
NEW WESTMINSTER DISTRICT

SYMBOLS:

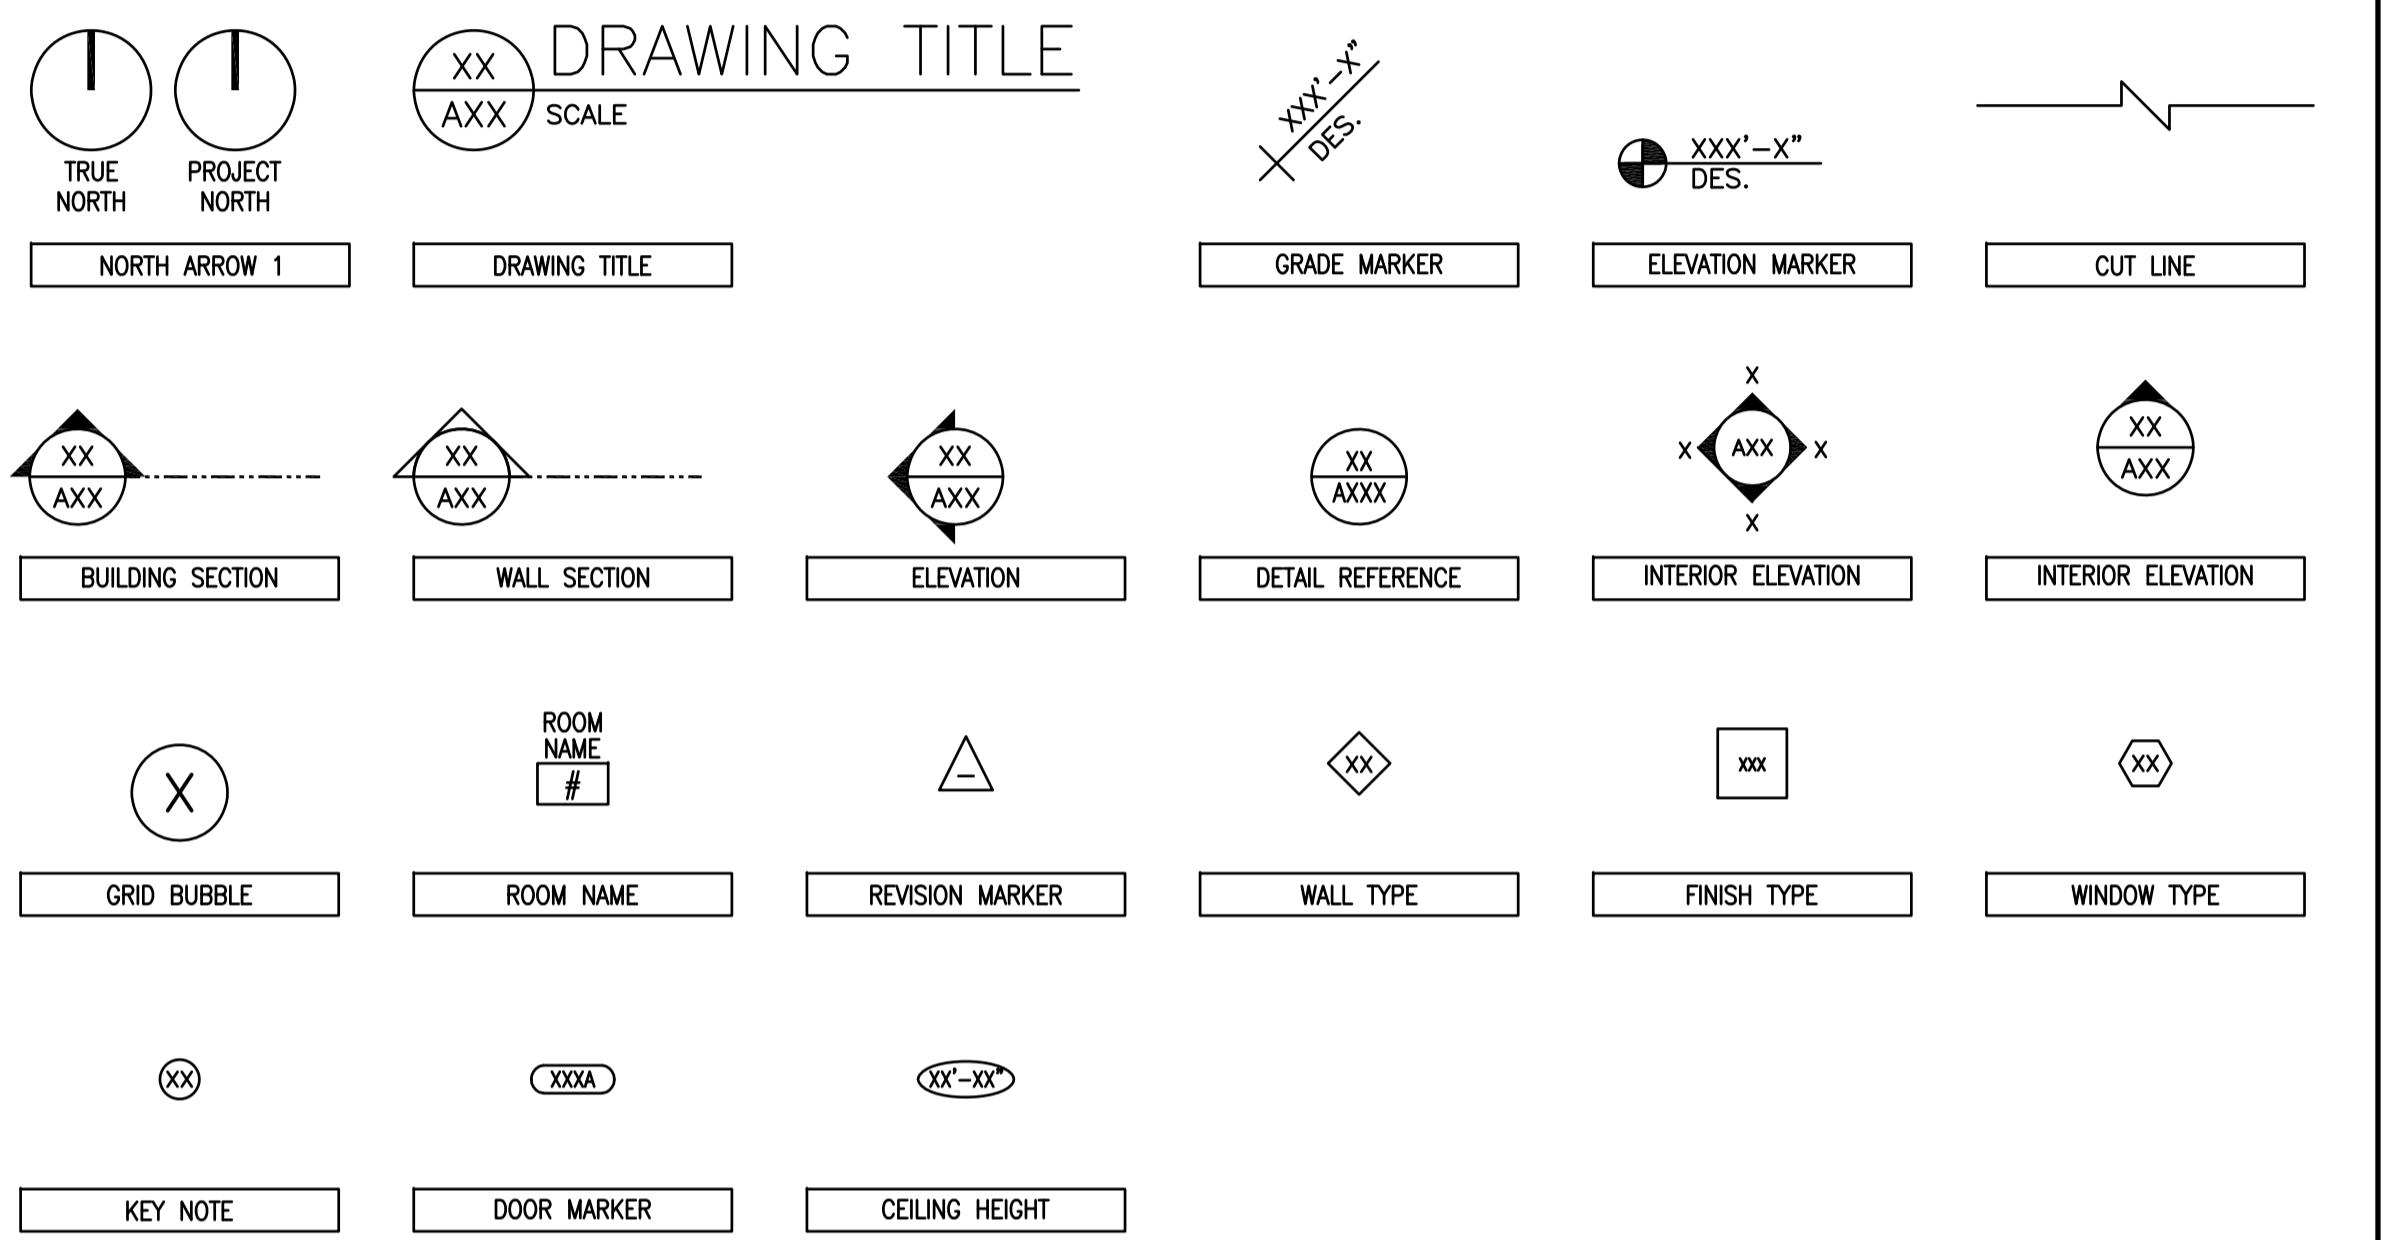

ABBREVIATIONS:

ACT	ACOUSTICAL CEILING TILE	GA	GAUGE	STD	STANDARD
AFF	ABOVE FINISHED FLOOR	GAL	GALVANIZED	STL	STEEL
ALUM	ALUMINUM	GEN	GENERAL	S/S	STEEL STUD
ALT	ALTERNATE	GR	GRADE	STRUC	STRUCTURAL
ANOD	ANODIZED	GWB	GYPSUM WALL BOARD	SUSP	SUSPENDED
ARCH	ARCHITECTURAL	HB	HOSE BIBB	THOLD	THRESHOLD
BLK	BLOCK	HC	HANDICAPPED	THRU	THROUGH
BO	BOTTOM OF	HM	HOLLOW METAL	TO	TOP OF
C/W	COMPLETE WITH	HORZ	HORIZONTAL	TOM	TOP OF MASONRY
CG	CORNER GUARD	HR	HOUR	TOW	TOP OF WALL
CL	CENTER LINE	HT	HEIGHT	TYP	TYPICAL
CLG	CEILING	INSUL	INSULATION	UNO	UNLESS NOTED OTHERWISE
CJ	CONTROL JOINT	IHM	INSULATED HOLLOW METAL	U/S	UNDERSIDE
CLR	CLEAR	LB	POUND	VARIES	VAR
CMU	CONCRETE MASONRY UNIT	MAX	MAXIMUM	VERT	VERTICAL
CO	CLEAN OUT	MECH	MECHANICAL	VR	VAPOR RETARDER
COL	COLUMN	MEP	MECHANICAL, ELECTRICAL, & PLUMBING	VTR	VENT THROUGH
CONC	CONCRETE	MEZZ	MEZZANINE	W/	WITH
CONST	CONSTRUCTION	MTL	METAL	W/O	WITHOUT
CONT	CONTINUOUS	MIR	MIRRORED	WD	WOOD
COORD	COORDINATE	MIN	MINIMUM		
CTR	CENTER(ED)	MISC	MISCELLANEOUS		
DEMO	DEMOLITION	MPS	METAL PANEL SOFFIT		
DET	DETAIL	NA	NOT APPLICABLE		
DIA	DIAMETER	NIC	NOT IN CONTRACT		
DIM	DIMENSION	NO	NUMBER		
DN	DOWN	NOM	NOMINAL		
DR	DOOR	NTS	NOT TO SCALE		
DS	DOWN SPOUT	OC	ON CENTER		
DWG	DRAWING	OH	OVERHEAD		
EIFS	EXTERIOR INSULATION	PLAM	PLASTIC LAMINATE		
	FINISH SYSTEM	PLW	PLYWOOD		
ELEC	ELECTRICAL	PREFIN	PREFINISHED		
EQUIP	EQUIPMENT	PT	PRESSURE TREATED		
EXH	EXHAUST	REFER	REFERENCE		
EXIST	EXISTING	RAD	RADIUS		
EXT	EXTERIOR	RB	RUBBER		
FD	FLOOR DRAIN	RCP	REFLECTED CEILING PLAN		
FDN	FOUNDATION	RD	ROOF DRAIN		
FE	FIRE EXTINGUISHER	REFER	REFERENCE		
FEC	FIRE EXTINGUISHER CABINET	REQ	REQUIRED		
FHC	FIRE HOSE CABINET	RL	RAIN LEADER		
FE	FINISH ELEVATION	RM	ROOM		
FF	FINISH FLOOR	RO	ROUGH OPENING		
FOC	FACE OF CONCRETE	SC	SOLID CORE		
FOF	FACE OF FINISH	SCW	SOLID CORE WOOD		
FOM	FACE OF MASONRY	SF	SQUARE FOOT		
FOS	FACE OF STUD	SIM	SIMILAR		
FOW	FACE OF FOUNDATION WALL	SPEC	SPECIFICATION(S)		
LAM	LAMINATE	SST	STAINLESS STEEL		
FRR	FIRE RESISTANCE RATING				
FRT	FIRE RETARDANT TREATED				

GENERAL NOTES

- ALL CONSTRUCTION SHALL COMPLY WITH LOCAL APPLICABLE CODES, NATIONAL BUILDING CODE 2015, NATIONAL FIRE CODE 2015, CSC STANDARD ACCESSIBLE DESIGN FOR THE BUILT ENVIRONMENT B615-12.
- THESE DRAWINGS ARE SUPPLIED TO THE CONTRACTOR AND OTHERS FOR THEIR USE FOR THIS SPECIFIC PROJECT. ALL COPIES OF THESE DRAWINGS SHALL REMAIN THE PROPERTY OF MALLEN GOWING BERZINS ARCHITECTURE INC. (MGBA) AND SHALL NOT BE REUSED OR REPRODUCED WITHOUT PERMISSION OF MGBA.
- THE ORGANIZATION OF DOCUMENTS ARE NOT INTENDED TO CONTROL THE DIVISION OF WORK. DIVISION OF WORK SHALL BE THE SOLE RESPONSIBILITY OF THE CONTRACTOR.
- CONTRACTOR SHALL VERIFY DIMENSIONS, REQUIRED CLEARANCES, AND POWER & PLUMBING REQUIREMENTS. NOTIFY ARCHITECT OF ANY DISCREPANCIES PRIOR TO COMMENCEMENT OF WORK. PROCEEDING WITH THE WORK CONSTITUTES ACCEPTANCE OF EXISTING CONDITIONS BEING SUBSTANTIALLY AS SHOWN.
- ALL CONSULTANTS & ARCHITECT'S DRAWINGS AND SPECIFICATIONS ARE TO BE READ IN CONJUNCTION WITH EACH OTHER.
- CONTRACTOR SHALL NOTIFY ARCHITECT OF ANY DISCREPANCIES BETWEEN DRAWINGS AND SPECIFICATIONS PRIOR TO CONSTRUCTION.
- CONTRACTOR TO SUPPLY ORIGINAL LETTERS OF ASSURANCE FOR ALL DEVICES/ITEMS REQUIRED TO BE SEISMICALLY RESTRAINED.
- EXAMINE SITE AND ALL APPLICABLE DRAWINGS FOR EVERYTHING NECESSARY FOR COMPLETION OF WORK. FAILURE TO ADEQUATELY REVIEW THE EXISTING CONDITIONS BEFORE PROCEEDING WITH WORK WILL NOT ENTITLE THE CONTRACTOR OR ITS SUB-CONTRACTORS TO ANY ADDITIONAL COMPENSATION.
- IT IS THE GENERAL CONTRACTOR'S RESPONSIBILITY WHEN PREPARING FOR, AND PROCEEDING WITH CONSTRUCTION ON THE PREMISES, TO COMPLY WITH ALL REQUIREMENTS OF ALL APPLICABLE LAWS CONCERNING HAZARDOUS SUBSTANCES. THE GENERAL CONTRACTOR SHALL NOT PERMIT THE INSTALLATION OF ANY HAZARDOUS SUBSTANCES IN ANY COMPONENT OF THE PREMISES DURING ITS TENANCY.
- IT IS THE GENERAL CONTRACTOR'S RESPONSIBILITY TO OBTAIN ALL APPLICABLE PERMITS. CSC MAINTAINS THE HIGHEST LEVEL OF GOVERNING JURISDICTION.
- IT IS THE GENERAL CONTRACTOR'S RESPONSIBILITY TO COORDINATE ALL INSPECTIONS WITH THE CITY BUILDING/ PLUMBING/ELECTRICAL INSPECTORS, RCA, FIRE MARSHALL, CONSULTANTS, ETC. THESE INCLUDE BUT ARE NOT LIMITED TO: UNDERLAY WORK, ROOFING AS REQUIRED, METAL STUDS BEFORE BOARDING UP, FIRE SUPPRESSION, FIRE ALARM VERIFICATION, COMMISSIONING, ETC. CSC MAINTAINS THE HIGHEST LEVEL OF GOVERNING JURISDICTION.
- ALL EXISTING BUILDING DIMENSIONS AND ASSEMBLIES TO BE CONFIRMED ON SITE. CONTRACTOR TO NOTIFY ARCHITECT OF ANY DISCREPANCIES.
- THE CONTRACTOR SHALL SUBMIT A SAFETY PLAN FOR THE EXCAVATION AND PROTECTION OF THE EXISTING UNDERGROUND ELECTRICAL DUCT BANK TO REMAIN. THE CONTRACTOR SHALL MAINTAIN STRICT PROTECTION OF THE EXISTING UNDERGROUND ELECTRICAL DUCT BANK AS IT SERVES OTHER PORTIONS OF THE CAMPUS NECESSARY FOR OPERATIONS. HAND DIG ALL WORK WITHIN TWO METERS, FLAG AREA FOR PROTECTION FOR THE DURATION OF THE PROJECT; SEE E001 FOR ELECTRICAL SITE PLAN. THE CONTRACTOR SHALL BE RESPONSIBLE FOR ALL DIRECT AND INDIRECT COSTS ASSOCIATED WITH ANY DAMAGE TO THESE LINES OR THEIR SERVICE DISRUPTION.
- PROVIDE MISCELLANEOUS STUDS, FURRING AND BLOCKING AS REQUIRED TO SUIT THE INTENT OF THE DESIGN.
- PROVIDE BLOCKING AS REQ'D TO SUPPORT AND FASTEN SURFACE MOUNTED FIXTURES, CABINETS, SHELVING, EQUIPMENT AND OTHER SURFACE MOUNTED DEVICES.
- EXCEPT WHERE SUSPENDED METAL FURRING IS USED FOR GYPSUM BOARD OR ACOUSTIC TILE CEILINGS, PROVIDE FURRING AS REQUIRED FOR ALL CEILINGS AND BULKHEADS AS SHOWN ON CEILING PLANS
- PROVIDE 19MM FIRE RETARDANT PLYWOOD AS BACKER FOR SERVICE ROOM EQUIPMENT PANELS. (PAINTED)
- FOR WASHROOMS REPLACE GYPSUM BOARD WITH CEMENT PANELS. CEMENT BOARD IS REQUIRED IN ALL WET ZONES. ALL JOINTS TO BE CAULKED, REFER TO ROOM FINISH SCHEDULE FOR ALL WALL FINISHES.
- REFER TO DETAILS FOR ADDITIONAL FINISHES AND SPECIAL CONDITIONS.
- FURR AROUND ALL STRUCTURE EITHER PARALLEL OR PERPENDICULAR TO WALLS AS REQUIRED TO PROVIDE CONTINUITY OF GYPSUM BOARD.
- THE 'R' SUFFIX IS FOR 1HR OR 2HR RATED ASSEMBLY. PARTITION RATINGS ARE NOTED ON DRAWING A001.
- FIRE BLOCK ALL FIRE-RATED WALLS.
- ALL PENETRATIONS OF RATED WALL ASSEMBLIES TO BE SEALED WITH ULC LISTED FIRESTOPPING TO MAINTAIN THE FIRE-RATING. PROVIDE MECHANICAL DAMPERS AT ALL DUCTWORK PENETRATIONS. THIS INCLUDES ALL EXISTING PENETRATIONS AS REQUIRED.
- FOR RATED WALLS, CARRY WALL RATED ASSEMBLY ABOVE CEILING FINISH TO U/S OF ROOF OR FLOOR STRUCTURE ABOVE. PROVIDE FIRE STOPPING & SEALING AS REQUIRED TO MAINTAIN CONTINUITY OF FIRE RATED ASSEMBLIES.
- ALL WALLS TO HAVE 16mm GYPSUM BOARD TYPE 'X'.
- ALL GWB ON WF WALL TYPES SHALL CONTINUE UPFACE OF WALL TO U/S OF GWB CEILING ASSEMBLY, AS OCCURS. ALL OTHER GWB SHALL CONTINUE UP THE FACE OF WALL TO U/S OF STRUCTURE.
- WHERE WALL TYPES ARE SCHEDULED TO BE USED AS A FURRING OR AS A NON-RATED ENCLOSING WALL OF A DUCT OR DEAD SPACE – GYPSUM BOARD REQUIRED ONE SIDE ONLY, IF USED WITH INSULATION FOR THESE APPLICATIONS PROVIDE 22 mm FURRING CHANNELS @ 600 O.C. MAX. OR AS REQUIRED TO RETAIN INSULATION. USE FULL STUD DEPTH INSULATION FOR THESE CASES.
- EXISTING WALL ASSEMBLIES ARE TO BE PREPARED FOR NEW CONSTRUCTION. MAKE GOOD ANY DISTURBED AREAS, RATINGS AND FINISHES.
- WALL TYPES ARE ASSUMED TO BE CONTINUOUS BELOW AND ABOVE WINDOWS, AND ABOVE DOORS U.N.O.
- ALL NEW PARTITIONS SHALL EXTEND FULL HEIGHT TO UNDERSIDE OF STRUCTURAL DECK UNLESS NOTED OTHERWISE.
- ALL DIMENSIONS ARE TO FACE OF STUD, FACE OF CONCRETE OR FACE OF CONCRETE BLOCK FOR NEW CONSTRUCTION AND FACE OF FINISH OF EXISTING CONSTRUCTION UNLESS NOTED OTHERWISE.
- PROVIDE FRP (FIBREGLASS REINFORCED PANEL) SURROUND TO 1200MM AFF AT ALL JANITOR SINKS. ALL WALLS.
- PROVIDE ACOUSTICAL SEALANT AT PERIMETER OF ALL ACOUSTICALLY RATED WALLS (FILL GAP BETWEEN FLOOR & GWB AND CEILING & GWB AND AT GWB & GWB CORNERS).
- PROVIDE ACOUSTICAL SEALANT AND WRAPS AT ALL ELECTRICAL BOXES AND SIMILAR PENETRATIONS IN ALL ACOUSTICALLY RATED WALLS AND CEILINGS.
- ACCESS PANELS / COVER PLATES TO BE PROVIDED IN ALL WALLS TO ACCESS ALL VALVES CLEANOUTS & OTHER SERVICEABLE DEVICES.
- COORDINATE ALL ACCESS DOOR LOCATIONS (FOR CONCEALED ITEMS) WITH APPROPRIATE CONTRACTOR.
- ALL GYPSUM BOARD FINISH TO HAVE LEVEL 4 FINISH TYPICAL, UNLESS NOTED OTHERWISE.
- PROVIDE MOISTURE TESTS ON ALL NEW CONCRETE SUBSTRATES PRIOR TO INSTALLING FINISHES. NEW FINISHES TO BE INSTALLED BASED ON MANUFACTURER'S RECOMMENDATIONS.
- IN ADDITION TO SPECIFIC REQUIREMENTS AS LISTED IN THE DOOR SCHEDULE, ENSURE ALL DOORS ARE EQUIPPED WITH DOOR STOPS.
- UNLESS OTHERWISE EXPLICITLY NOTED, ALL NEW EQUIPMENT, PRODUCTS, DEVICES AND MATERIAL SHALL BE SUPPLIED AND INSTALLED BY THE CONTRACTOR. THE CONTRACTOR SHALL RELOCATE AND REINSTALL THE EXISTING EQUIPMENT & FURNITURE AS INDICATED ON THE A900 DRAWING SERIES.
- PROVIDE MINIMUM 100MM WALL RETURN AT HINGE SIDE OF DOOR, UNLESS NOTED OTHERWISE.



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Revision/ Revision	Description/Description	Date/Date
Client/Client	CORRECTIONAL SERVICE OF CANADA	

Project Title/Titre du projet
AGASSIZ, BRITISH COLUMBIA
4732 CEMETERY ROAD PO BOX 1600
MOUNTAIN INSTITUTION

MOUNTAIN INSTITUTION
HEALTH CARE EXPANSION

Consultant Signature Only
Designed by/Conception par
EDWIN BERZINS
Drawn by/Desiné par
BEN MONROE (2017-09-28)
PWGSC Project Manager/Administrateur de Projets TPSGC
TONY TANG
Regional Manager, Architectural and Engineering Services
Gestionnaire régionale, Services d'architecture et de génie, TPSGC
PREETPAL PAUL
Drawing title/Titre du dessin

GENERAL NOTES

- DEMOLITION / ADDITION / RENOVATION TO AN EXISTING FACILITY:
CONSTRUCT A +/- 502 SQ.M. ADDITION AND 750 SQ.M. RENOVATIONS TO EXISTING. PROJECT IS CONFINED TO THE HEALTH CARE WING OF THE FACILITY ONLY. CONSTRUCTION CONSISTS OF STEEL FRAME CONSTRUCTION WITH CONCRETE FOUNDATIONS TO MATCH EXISTING; WORK INCLUDES BUT IS NOT LIMITED TO THE ADDITION OF NEW ACCESSIBLE WASHROOMS, STAFF BREAK ROOM, OPEN AND ENCLOSED OFFICES, EXAM ROOMS, TREATMENT ROOMS, MEDICATION STORAGE, MEDICATION DISPENSARY, AND OTHER SUPPORT SPACES. SITE IMPROVEMENTS ARE ALSO INCLUDED IN SCOPE AS IS SELECTIVE DEMOLITION TO EXISTING FACILITY. PROJECT COMPRISSES ARCHITECTURAL, CIVIL, STRUCTURAL, MECHANICAL, PLUMBING, AND ELECTRICAL DISCIPLINES.
- FACILITY IS TO REMAIN OPERATIONAL DURING CONSTRUCTION. A TWO PHASED CONSTRUCTION PERIOD IS PROPOSED.

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WALL TYPES GENERAL NOTES:

1. ENSURE ALL MEMBRANES AND METAL PANELS APPLIED TO WALLS AND SLOPED ROOFS ARE APPLIED WITH POSITIVE LAPING TO SHED WATER.
2. FOR NON-FIRE RATED PARTITIONS, FILL VOIDS WITH SAFING INSULATION INCLUDING, BUT NOT LIMITED TO, FLUTES IN METAL DECK PENETRATIONS OF DUCTWORK, ELECTRICAL CONDUIT, PIPING, ETC.
3. GYPSUM WALL BOARD USED IN FIRE-RESISTIVE CONSTRUCTION MUST BEAR A FIRE RESISTIVE MARKING.
4. FOR FIRE RATED PARTITIONS, DETAILS MUST RESIST THE PASSAGE OF SMOKE. CARRY WALL RATED ASSEMBLY ABOVE FIRE STOPPING TO US OF ROOF OR FLOOR STRUCTURE ABOVE. PENETRATIONS AND VOIDS SHALL BE FIRESTOPPED AND ALL HEAD-TO-WALL JOINTS AND FLOOR-TO-WALL JOINTS SHALL BE SEALED IN ACCORDANCE WITH THE SPECIFICATIONS.
5. PROVIDE MISCELLANEOUS STUDS, FURNING AND BLOCKING AS REQUIRED BY THE DESIGN.
6. PROVIDE BLOCKING AS RECD TO SUPPORT AND FASTEN SURFACE MOUNTED FIXTURES, CABINETS, SHELVING, EQUIPMENT AND OTHER SURFACE MOUNTED DEVICES.
7. WALL TYPES ARE ASSUMED TO BE CONTINUOUS BELOW AND ABOVE WINDOWS, AND ABOVE DOORS U.N.O.
8. ALL GWTB SHALL CONTINUE UP THE FACE OF WALL TO US OF ROOF DECK.
9. ALL NEW PARTITIONS SHALL EXTEND FULL HEIGHT TO UNDERSIDE OF STRUCTURAL DECK UNLESS NOTED OTHERWISE.
10. PROVIDE ACOUSTICAL SEALANT AT PERIMETER OF ALL ACOUSTICALLY RATED WALLS (FILL GAP BETWEEN FLOOR & GWTB AND CEILING & GWTB AND AT GWTB & GWTB CORNERS).
11. PROVIDE ACOUSTICAL SEALANT AND WRAPS AT ALL ELECTRICAL BOXES AND SIMILAR PENETRATIONS IN ALL ACOUSTICALLY RATED WALLS AND CEILINGS.
12. ALL GYPSUM BOARD FINISH TO HAVE LEVEL 4 FINISH TYPICAL, UNLESS NOTED OTHERWISE.
13. AT ALL SECURITY RATED WALLS, CONCRETE FILL ALL VOIDS AND FLUSS FILL ALL SEAMS WITH SECURITY CULKING AND AROUND ALL UTILITY AND STRUCTURAL PENETRATIONS.
14. A SC2 SECURE BUILDING ENVELOPE IS REQUIRED AROUND THE ENTIRE BUILDING EXTERIOR AND AROUND SELECT ROOMS. THIS INCLUDES ALL FOUR SIDES AND THE CEILING / ROOF AND SLABS UNDERNEATH, AND PROPER TREATMENT OF ALL PENETRATIONS AND OPENINGS. SEE A103, A104, A105B, A108, AND A301 FOR DETAILS. THE SC2 SECURE ENVELOPE MUST BE CONTINUOUS AND ALL OPENINGS IN CEILINGS, FLOORS, OR ROOFS - JOINTS MUST BE CLOSED, EITHER WITH STEEL PLATES, STEEL ANGELS OR CONCRETE. SEE DETAILS. ALL SMALL GAPS AT JOINTS MUST BE SEALED WITH SECURITY SEALANT. SEE MECHANICAL DOCUMENTS FOR SECURITY GRILLS. SEE STRUCTURAL FOR WALL AND ROOF ASSEMBLY COMPONENTS FOR REINFORCEMENT.

EXTERIOR WALL ASSEMBLIES

WALL TYPES	DESCRIPTION	TEST NUMBER	STC	TEST NUMBER
E1	<p>PREFINISHED METAL PANEL SYSTEM 25 mm METAL CHANNELS @ 400 mm OC 25 mm AIR SPACE 50mm VERTICAL Z-GIRTS @ 600 mm OC WITH 50 mm EXPANDED POLYSTYRENE INSULATION (RSI 3.52) 50 mm HORIZONTAL Z-GIRTS @ 600 mm OC WITH 50 mm EXPANDED POLYSTYRENE INSULATION (RSI 3.52) SELF ADHERED MEMBRANE (VAPOUR / AIR BARRIER) POSITIVE LAPED TO SHED WATER 190 mm FULLY GROUTED CONCRETE MASONRY H-BLOCK WALL UNITS WITH 15M VERTICAL REINFORCEMENT @ 400 OC MIN. [SC2 SECURE CONSTRUCTION]</p>	1 HOUR	55	NCMA TEK 13-1C

ROOF ASSEMBLIES

(METAL DECK - SLOPED)	DESCRIPTION	TEST NUMBER	STC	TEST NUMBER
R1	<p>PREFINISHED 24 GA STEEL 25 mm DOUBLE-LOCK STANDING SEAM ROOF CLADDING @ 400 mm O.C. CAN FASTENING SYSTEM ON SLIP SHEET</p> <p>13 MM INSULATION OVERLAY BOARD, MECHANICALLY FASTENED 64mm Z' GIRTS PERPENDICULAR TO ROOF SLOPE WITH 64mm POLYISOCYANURATE BOARD INSULATION (RSI 2.64 MIN.) 64mm Z' GIRTS RUNNING WITH ROOF SLOPE 64 mm WITH 64 mm POLYISOCYANURATE VAPOUR RETARDER</p> <p>13 mm ROOF SHEATHING, MECHANICALLY FASTENED 3.5 mm SHEET STEEL FASTENED W/ #12 SCREWS @ 400 MAX. O.C. TO 40 (NOM) X 0.91 GALVANIZED STEEL DECKING [SC2 SECURE CONSTRUCTION] STEEL STRUCTURE (REFER TO STRUCTURAL)</p>			
R2	<p>SBS ROOF MEMBRANE SYSTEM 13 mm COMPOSITE COVER BOARD, ADHERED TAPERED FULLY ADHERED POLYISOCYANURATE INSULATION BOARDS 2 LAYERS OF FULLY ADHERED POLYISOCYANURATE INSULATION BOARDS 13 mm DECK THICKNESS = 100 MM. RSI 2.68 SELF ADHERED VAPOUR RETARDER 13mm DECK SHEATHING, ADHERED 65 mm CONCRETE TOPPING SLAB/R/W 10m @ 300 mm OC E.W. MID DEPTH [SC2 SECURE CONSTRUCTION] 40 (NOM) X 0.91 GALVANIZED STEEL DECKING STRUCTURAL STEEL FRAMING (REFER TO STRUCTURAL)</p>			

FLOOR ASSEMBLIES

MAIN FLOOR - SLAB ON GRADE	DESCRIPTION	TEST NUMBER	STC	TEST NUMBER
F1	<p>130 OR 150 mm CONCRETE FLOOR SLAB (REFER TO STRUCTURAL) CAV 10M @ 300 E.W. MID DEPTH 0.25 mm POLYETHYLENE VAPOUR RETARDER 75 mm HIGH COMPRESSIVE STRENGTH POLYSTYRENE INSULATION (RSI 2.64) - PERIMETER INSTALLATION - EXTEND 600mm MIN FROM SLAB EDGE AND 600mm VERTICALLY AT PERIMETER AND CRAWL SPACE WALL. 100 mm MIN. CLEAR CRUSHED GRAVEL COMPACTED FILL</p>			
F2	<p>130 mm REINFORCED CONCRETE FLOOR SLAB ON 75 (NOM) X 0.91 COMPOSITE STEEL DECK R/W 10m @ 300 E.W. MID DEPTH STRUCTURAL STEEL FRAMING (REFER TO STRUCTURAL) 50mm (RSI 2.64 MIN.) SPRAY FOAM THERMAL INSULATION / AIR AND VAPOUR BARRIER FULLY COAT COMPLETE UNDERSIDE OF SLAB AND FLOOR STRUCTURE AND FLOOR STRUCTURE BEARING POCKETS SPRAY APPLIED THERMAL BARRIER OVER ALL INSULATION</p>			
F3	<p>50 mm CONCRETE SEAL SLAB (REFER TO STRUCTURAL) 0.25 mm POLYETHYLENE VAPOUR RETARDER 75 mm HIGH COMPRESSIVE STRENGTH POLYSTYRENE INSULATION (RSI 2.64) - EXTERIOR PERIMETER INSTALLATION - EXTEND 1200mm MIN FROM SLAB EDGE ON EXTERIOR WALL 100 mm MIN. CLEAR CRUSHED GRAVEL COMPACTED FILL</p>			

INTERIOR - SECURE CEILING ASSEMBLIES

SCI	DESCRIPTION	TEST NUMBER	STC	TEST NUMBER
	<p>65 mm CONCRETE TOPPING SLAB/R/W 10m @ 300 mm OC E.W. MID DEPTH [SC2 SECURE CONSTRUCTION] 40 (NOM) X 0.91 GALVANIZED STEEL DECKING STEEL W-SECTIONS (REFER TO STRUCTURAL) SUSPENDED 16 mm TYPE 'X' GYPSUM BOARD ON STEEL CHANNELS SUPPORTS</p>			

INTERIOR RATED SHAFTWALL ASSEMBLIES

WRI	DESCRIPTION	TEST NUMBER	STC	TEST NUMBER
	<p>1.0-HOUR SHAFT WALL FIRE SEPARATION 16 mm TYPE 'X' GYPSUM BOARD 64 mm C-H SECTION VENTED STUDS @ 600 O.C. 16 mm TYPE 'X' GYPSUM BOARD</p>	1 HOUR		ULC W446 SYSTEM E

INTERIOR WALL ASSEMBLIES - LEAD LINED

WL1	DESCRIPTION	TEST NUMBER	STC	TEST NUMBER
	<p>16 mm TYPE 'X' GYPSUM BOARD .8 mm MIN. LEAD LINING - RADIATION PROTECTION TO 2113mm MIN. 13 mm PLYWOOD TO US CLG. 152 mm STEEL STUDS @ 400mm o.c. 16 mm TYPE 'X' GYPSUM BOARD ACOUSTIC SEALANT @ CEILING, FLOOR & WALL JUNCTURES & ALL PENETRATIONS</p>			
WL2	<p>16 mm TYPE 'X' GYPSUM BOARD .8 mm MIN. LEAD LINING - RADIATION PROTECTION TO 2113mm MIN. 13 mm PLYWOOD TO US CLG. ON EXISTING STEEL STUD WALL</p>			

INTERIOR WALL ASSEMBLIES

WALL TYPES	DESCRIPTION	TEST NUMBER	STC	TEST NUMBER
W1	<p>16 mm TYPE 'X' GYPSUM WALLBOARD 92 mm STEEL STUDS @ 400 O.C. 16 mm TYPE 'X' GYPSUM WALLBOARD</p>			38 NRC-TL-92-418
W2	<p>16 mm TYPE 'X' GYPSUM WALLBOARD 13 mm PLYWOOD 92 mm STEEL STUDS @ 400 O.C. 89 mm BATT ACOUSTIC INSULATION 13 mm PLYWOOD 16 mm TYPE 'X' GYPSUM WALLBOARD ACOUSTIC SEALANT @ CEILING, FLOOR & WALL JUNCTURES & ALL PENETRATIONS</p>			49 NRC-TL-92-349
W3	<p>16 mm TYPE 'X' GYPSUM WALLBOARD 152 mm STEEL STUDS @ 400 O.C. 152 mm BATT ACOUSTIC INSULATION 16 mm PLYWOOD 16 mm TYPE 'X' GYPSUM WALLBOARD ACOUSTIC SEALANT @ CEILING, FLOOR & WALL JUNCTURES & ALL PENETRATIONS</p>	1 HOUR		51 BCBC 2012 WALL #S7a
W4	<p>16 mm TYPE 'X' GYPSUM WALLBOARD 16 mm PLYWOOD 152 mm STEEL STUDS @ 400 O.C. 152 mm BATT ACOUSTIC INSULATION 16 mm TYPE 'X' GYPSUM WALLBOARD ACOUSTIC SEALANT @ CEILING, FLOOR & WALL JUNCTURES & ALL PENETRATIONS</p>			51 NRC-TL-92-298
W5	<p>16 mm TYPE 'X' GYPSUM WALLBOARD 13 mm PLYWOOD 152 mm STEEL STUDS @ 400 O.C. 152 mm BATT ACOUSTIC INSULATION 13 mm PLYWOOD 16 mm TYPE 'X' GYPSUM WALLBOARD ACOUSTIC SEALANT @ CEILING, FLOOR & WALL JUNCTURES & ALL PENETRATIONS</p>			51 NRC-TL-92-298
W6	<p>16 mm TYPE 'X' GYPSUM WALLBOARD 13 mm PLYWOOD 203 mm STEEL STUDS @ 400 O.C. 203 mm BATT ACOUSTIC INSULATION 13 mm PLYWOOD 16 mm TYPE 'X' GYPSUM WALLBOARD ACOUSTIC SEALANT @ CEILING, FLOOR & WALL JUNCTURES & ALL PENETRATIONS</p>			51 NRC-TL-92-298
W7	<p>190 mm FULLY GROUTED CONCRETE MASONRY H-BLOCK WALL UNITS WITH 15M VERTICAL REINFORCEMENT @ 400 OC MIN. [SC2 SECURE CONSTRUCTION]</p>	2 HOUR		55 NCMA TEK 13-1C
INTERIOR WALLS - FURRING/ SINGLE SIDED				
WF1	<p>16 mm GYPSUM BOARD SHIM AS RECD TO PLUMB WALL & OR ALIGN WITH EXISTING WALL</p>			
WF2	<p>16 mm GYPSUM BOARD 13 mm PLYWOOD TO US CLG. 25 mm STEEL STUDS @ 400mm O.C. SHIM AS RECD TO PLUMB WALL & OR ALIGN WITH WALL</p>			
WF3	<p>16 mm GYPSUM BOARD 92 mm STEEL STUDS @ 400mm O.C. AIR SPACE AS REQUIRED</p>			
WF4	<p>16 mm GYPSUM BOARD 16 mm PLYWOOD TO US CLG. 92 mm STEEL STUDS @ 400mm O.C. AIR SPACE AS REQUIRED</p>			
WFS	<p>16 mm GYPSUM BOARD 152 mm STEEL STUDS @ 400mm O.C. 89 mm BATT ACOUSTIC INSULATION AIR SPACE AS REQUIRED ACOUSTIC SEALANT @ CEILING, FLOOR & WALL JUNCTURES & ALL PENETRATIONS ACOUSTIC SEALANT @ CEILING, FLOOR & WALL JUNCTURES & ALL PENETRATIONS</p>			55 NRC-TL-92-288 WHEN USED OVER OPPOSING FINISHED FACE
WFS	<p>16 mm GYPSUM BOARD 16 mm PLYWOOD TO US CLG. 152 mm STEEL STUDS @ 400mm O.C. AIR SPACE AS REQUIRED</p>			55 NRC-TL-92-298 WHEN USED OVER OPPOSING FINISHED FACE
WFT	<p>16 mm GYPSUM BOARD 16 mm PLYWOOD TO US CLG. 152 mm STEEL STUDS @ 400mm O.C. 89 mm BATT ACOUSTIC INSULATION AIR SPACE AS REQUIRED ACOUSTIC SEALANT @ CEILING, FLOOR & WALL JUNCTURES & ALL PENETRATIONS</p>			55 NRC-TL-92-298 WHEN USED OVER OPPOSING FINISHED FACE
WFG	<p>16 mm GYPSUM BOARD 203 mm STEEL STUDS @ 400mm O.C. AIR SPACE AS REQUIRED</p>			
WALL TYPES				

Public Works and
Government Services
Canada
Travaux publics et
Services gouvernementaux
Canada
REAL PROPERTY SERVICES
Pacific Region
SERVICES IMMOBILIERS
Région de la Pacifique

MGBA
MALLEN GOWING BERZINS
ARCHITECTURE



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CORRECTIONAL SERVICE OF CANADA

Project Title/Titre du projet AGASSIZ, BRITISH COLUMBIA 4732 CEMETERY ROAD PO BOX 1600 MOUNTAIN INSTITUTION

MOUNTAIN INSTITUTION HEALTH CARE EXPANSION

Consultant Signature Only

Designed by/Concept par EDWIN BERZINS

Drawn by/Desiné par BEN MONROE (2017-09-28)


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Regional Manager, Architectural and Engineering Services Gestionnaire régionale, Services d'architecture et de génie, TPSGC PREETPAL PAUL


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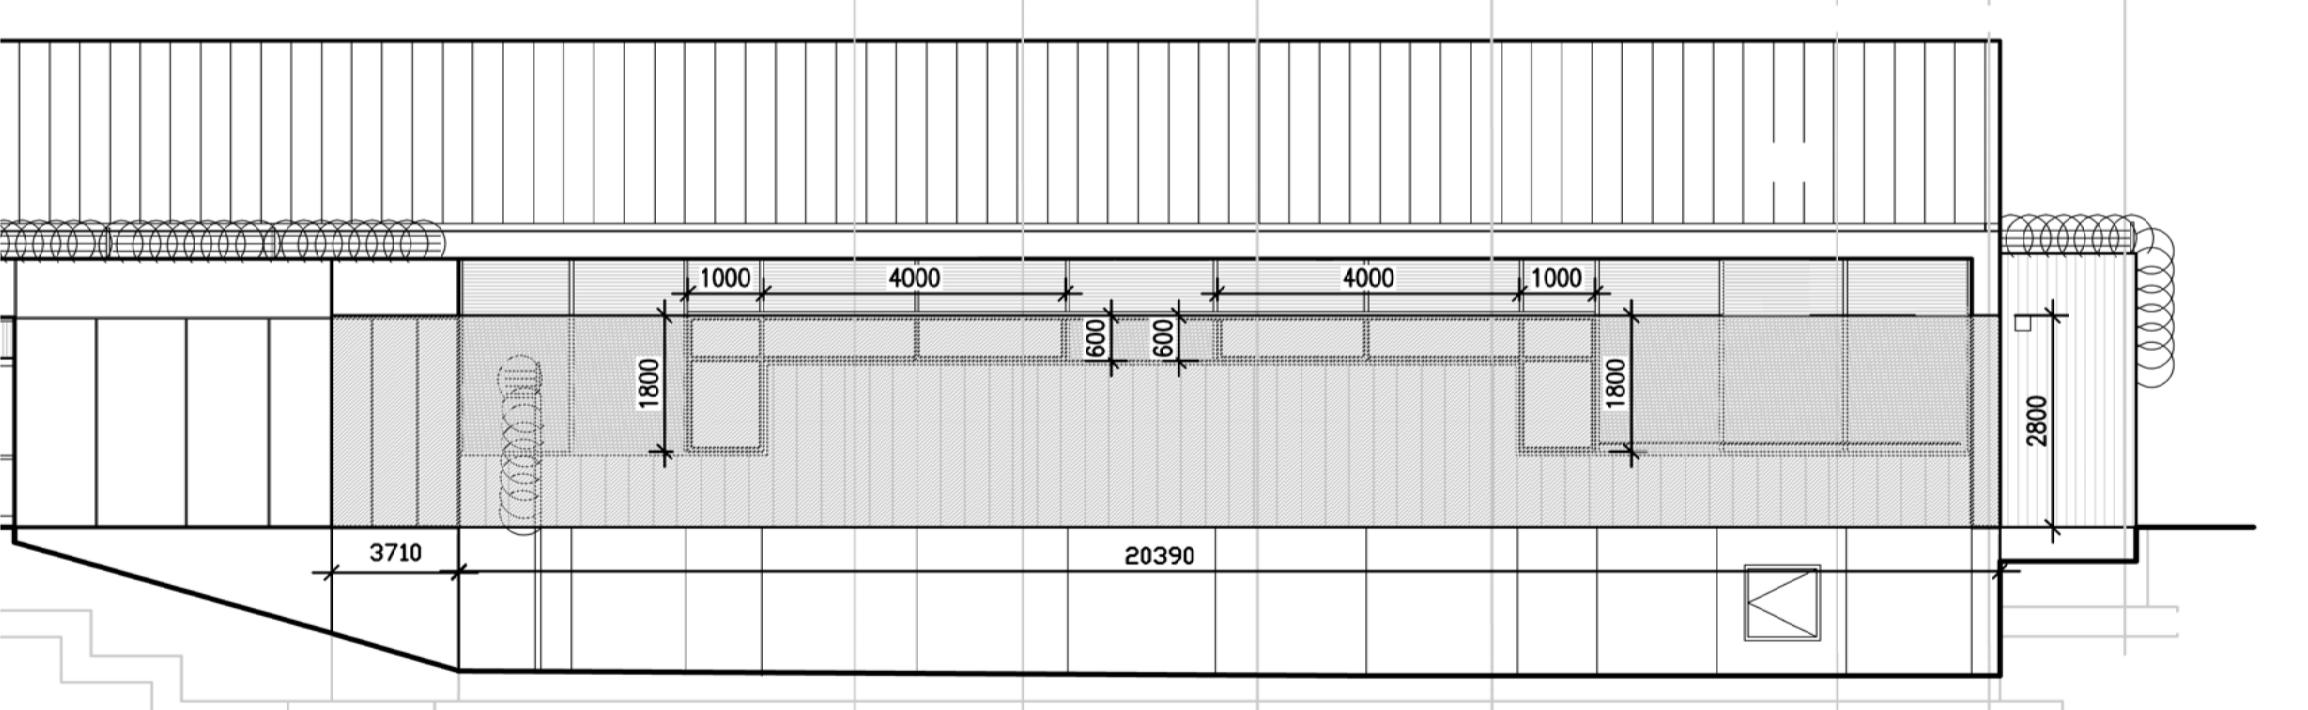
Occupancy Type:
Group B, Division 1 (3.2.2.37)
Subsidiary: Group D
Building Height: One (1) Storey
Building Area: 1232 m ² Total
(Addition) 500 m ²
Streets Facing: One (1)
Construction Type: Noncombustible
Sprinklered: Yes
Applicable Codes:
- NBC 2015, Division B
- NFC 2015, Division B
- NFPA 13



01 KEY PLAN
A001 NTS

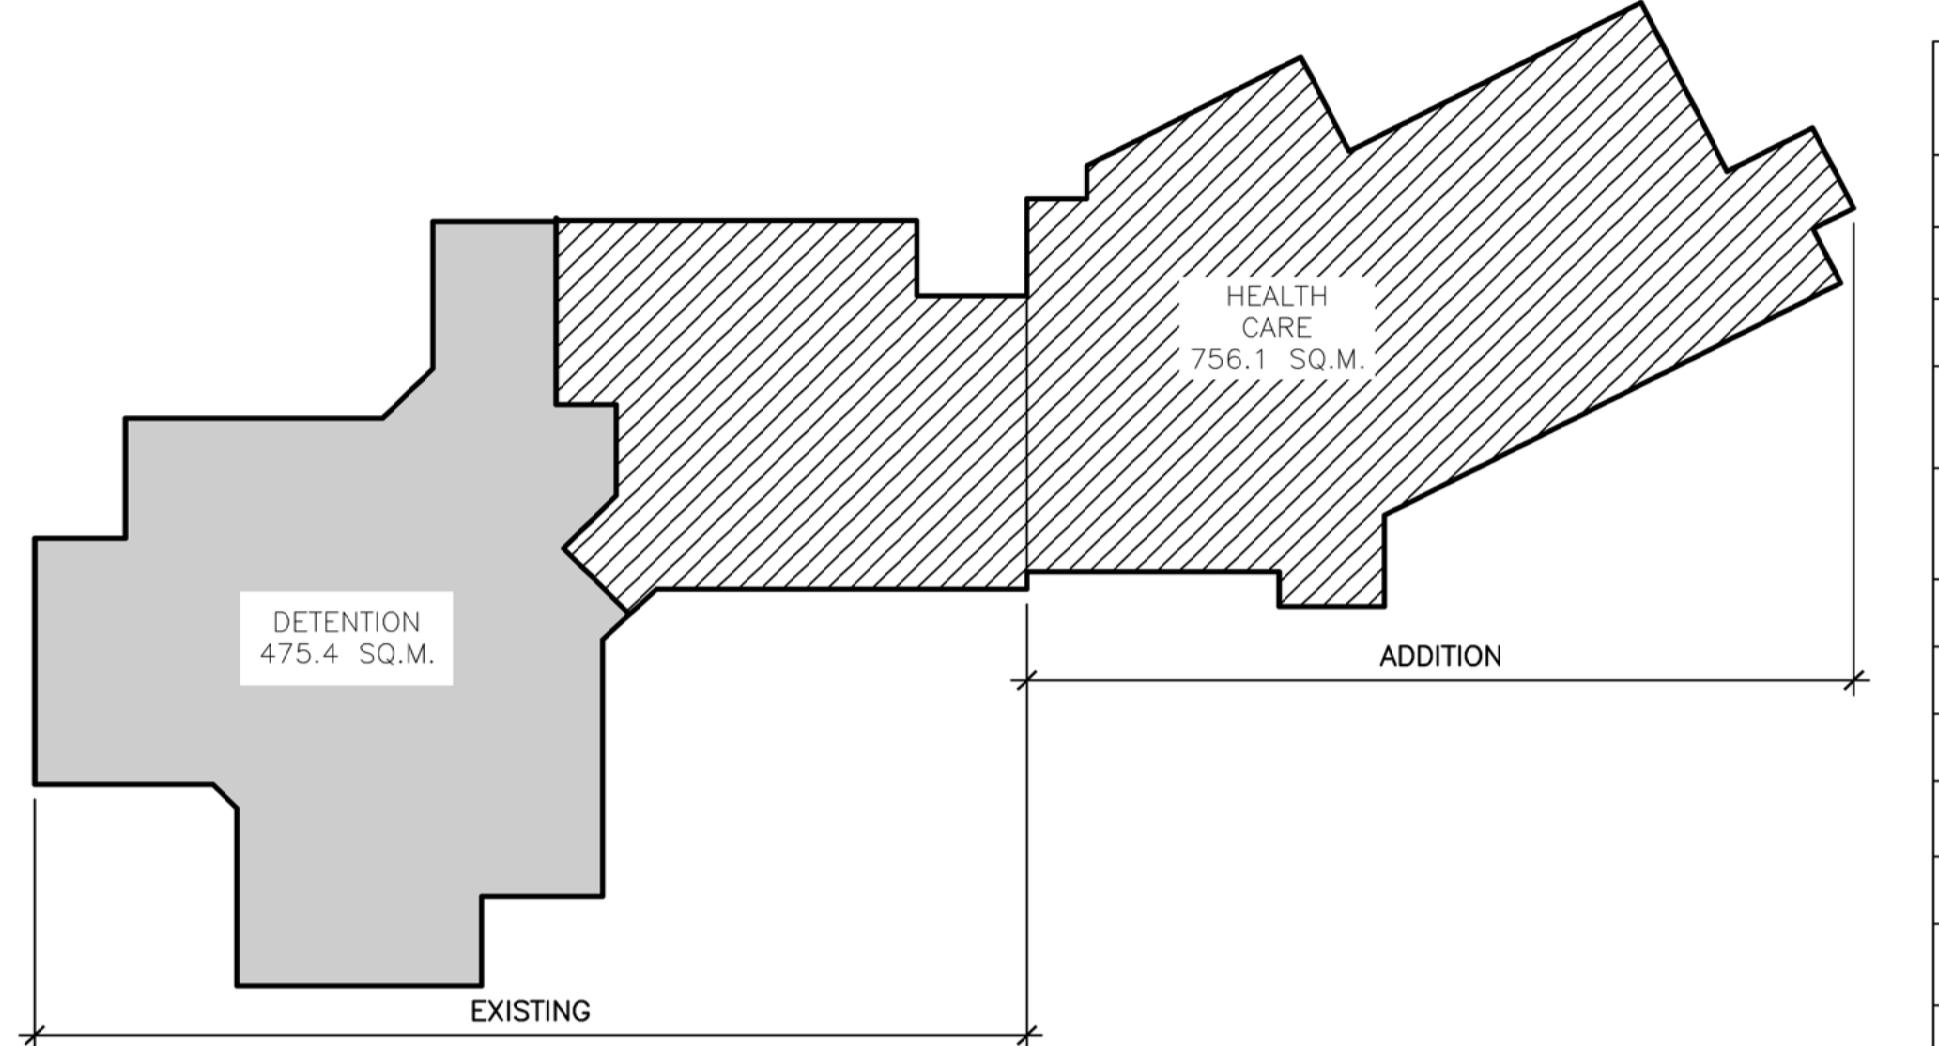

02 CODE ANALYSIS PLAN
A001 NTS

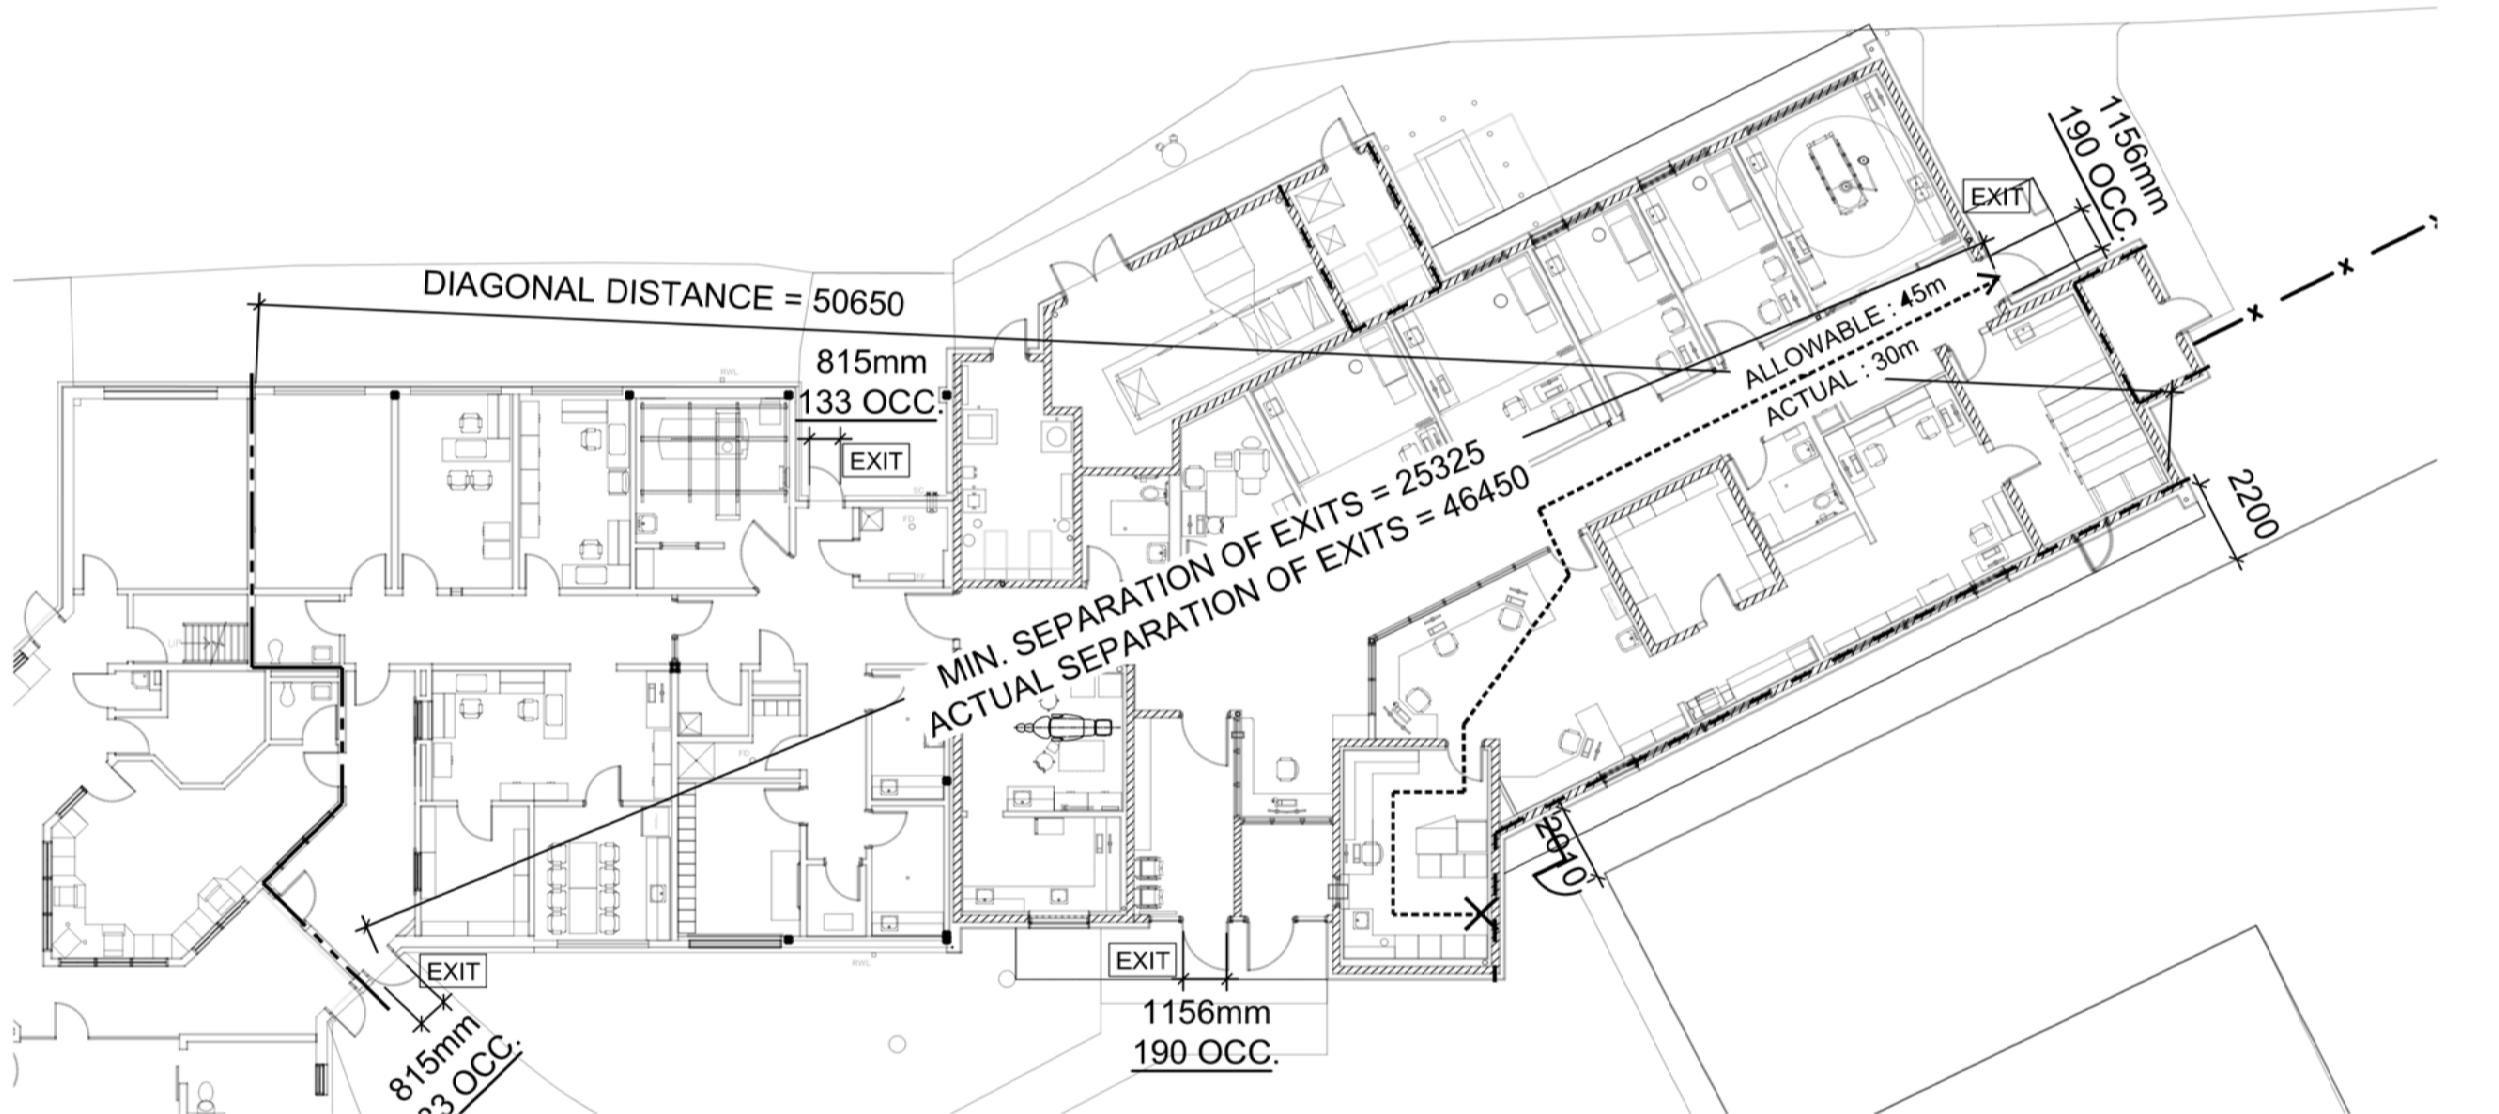

03 CODE ANALYSIS ELEVATION (SOUTH 2)
A001 NTS

Table 3.2.3.1-D
AREA OF EXPOSING BUILDING FACE 57.1m²
AREA OF UNPROTECTED OPENINGS = 14.7% = 8.4m²

CODE ANALYSIS - DETENTION (existing unchanged) & TREATMENT

TITLE	MOUNTAIN INSTITUTION HEALTH CARE EXPANSION	ALL WORK TO CONFORM TO N.B.C. 2015
PROJECT DESCRIPTION	ADDITION AND RENOVATION TO THE HEALTH CARE PORTION OF THE DETENTION CAMPUS	
PART 3 OR PART 9 BUILDING	PART 3	1.3.3.2.
MAJOR OCCUPANCY	GROUP B1 - DETENTION & GROUP D - MEDICAL OFFICE ENTIRE FACILITY HAS DETENTION FEATURES - THE MOST STRINGENT CALCULATIONS WERE USED TO DETERMINE ALL FEATURES	3.1.2.1(1)
BUILDING AREA	DETENTION: 475.4 m ² (38.6%) + OFFICE: 756.1 m ² (61.4%) = 1231.5 m ² ENTIRE FACILITY HAS DETENTION FEATURES	1.4.1.2.
GRADE ELEVATION	24.3m	
BUILDING HEIGHT	2 STOREY / 7.25 m	3.2.1.1, 3.2.2.5.
STREETS	EXISTING - FACING 1 STREET	3.2.2.10, 3.2.5.5.
CLASSIFICATION OF BUILDINGS	GROUP B1, UP TO 3 STOREYS, SPRINKLERED & GROUP D, UP TO 2 STOREYS, SPRINKLERED	3.2.2.37 & 3.2.2.63
SPRINKLER SYSTEM	REQUIRED	3.2.2.18. & 3.2.5.12.
COMBUSTIBLE OR NONCOMBUSTIBLE CONSTRUCTION	NONCOMBUSTIBLE CONSTRUCTION	3.2.2.37 & 3.2.2.40
SEPARATION OF MAJOR OCCUPANCIES	2 HR F.R.R. FIRE SEPARATION	TABLE 3.1.3.1
REQUIRED FIRE RESISTANCE RATING	FLOORS: 1 HR ROOF: NOT REQUIRED SUPPORTING MEMBERS: SAME AS SUPPORTED ASSEMBLY	3.2.2.37
Spatial Separation	SEE TABLE BELOW	3.2.3.
Travel Distance	45 m REQUIRED/ 30 m PROVIDED	3.4.2.4 & 3.4.2.5
Separation of Exits	REFER TO PLAN	3.4.2.3
Standpipe Required	NO	3.2.5.8.
Is Water Supply Adequate	EXISTING, YES	3.2.5.7.
Fire Alarm Required	YES	3.2.4.1.
Fire Alarm Installation & Testing	YES	3.2.4.5
Mezzanines	N/A	3.2.1.1 (3) & (7)
Mezzanine Exiting	N/A	3.4.2.2.
Interconnected Floor Spaces	NO	3.2.8.2
High Building	NO	3.1.13.7. & 3.2.6.
Emergency Power	REQUIRED	3.2.7.8.
Emergency Power Supply Duration	ON EMERGENCY GENERATOR, 1 HOUR MINIMUM EXCEEDED	3.2.7.8.
Emergency Lighting	YES - EXITS, ACCESS TO EXITS, AND CORRIDORS	3.2.7.3.
Exit Signs	NO	3.4.5.1.
Smoke Control Measures	N/A	3.1.8.12, 3.2.6.2., 3.2.6.9.
Fire Pump Required	NO	3.2.5.18.
Barrier Free Design	YES	3.8.
Release Hardware for Exit Doors	REQUIRED, EXCEPT FOR CONTAINED USE AREA OR AN IMPEDED EGRESS ZONE	3.4.6.16.
Crawl Space	1137 < 1800 CLEAR HEIGHT; ACCESS DOOR PROVIDED; 192.5 m ² , MAX DIMENSION 22 m, FIRE BLOCKED FROM FLOOR ABOVE, VENTILATED	3.2.2.9, 3.6.4.6, 3.1.11.1, 3.1.11.6, 6.3.1.2

SPATIAL SEPARATION

TABLE 3.2.3.1.D

WALL	AREA OF E.B.F.	L.D.	AREA OF U.O.	PROPOSED % OF OPENINGS	PERMITTED MAX % OF OPENINGS	EXPOSING BUILDING FACE FRR 3.2.3.7	TYPE OF CONSTRUCTION 3.2.3.7	TYPE OF CLADDING 3.2.3.7
SOUTH 1	36 m ²	> 9 m	13.4 m ²	37.2%	100%	0 HR	EITHER	EITHER
SOUTH 2	57.1 m ²	2.0 m	8.4 m ²	14.7%	20%	1 HR	EITHER	NONCOMBUSTIBLE
EAST 1	44.8 m ²	> 9 m	5.1 m ²	11.4%	100%	0 HR	EITHER	EITHER
EAST 2	9 m ²	2.7 m	0 m ²	0%	100%	0 HR	EITHER	EITHER
NORTH 1	72.9 m ²	> 9 m	13.6 m ²	18.6%	100%	0 MIN.	EITHER	EITHER
WEST 1	-m ²	N/A	-m ²	-%	N/A	N/A	N/A	N/A

OCCUPANT LOAD CALCULATIONS

TABLE 3.1.17.1

OCCUPANCY	AREA (s.m.)	AREA PER PERSON (m)	OCCUPANT LOAD	WASHROOMS
DETENTION, B1	475.4	11.6	EXISTING	EXISTING
OFFICE, D	756.1	9.3	82	THIS FACILITY IS LOCATED IN A B1 DETENTION CAMPUS AND THE OCCUPANCY OF THIS WING IS STRICTLY CONTROLLED. WE HAVE PROVIDED 3 FIXTURES BASED ON SPECIAL LIMITATIONS OF THE OCCUPANCY NEED PER 3.7.2.9
TOTAL	1,231.5	—	N/A	PROVIDED: 3 UNISEX

EXITING CALCULATIONS

TABLE 3.4.3.2(1)a

	REQUIRED EXITS	PROVIDED EXITS	EXIT WIDTH (mm)	OCCUPANTS PROVIDED FOR
TREATMENT	2 EXITS, REQ'D EXIT WIDTH = 82 * 6.1 = 500.2 mm	4	(2 x 815mm) + (2 x 1156mm) = 3942mm	646

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MOUNTAIN INSTITUTION HEALTH CARE EXPANSION	
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EDWIN BERZINS	
Drawn by / Dessin par	
-	
PWGSC Project Manager / Administrateur de Projets TPSGC	
TONY TANG	
PWGSC, Architectural and Engineering Resources Manager / Responsable de l'architecture et de l'ingénierie, TPSGC	
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AGASSIZ, BRITISH COLUMBIA
 4732 CEMETERY ROAD PO BOX 1600
MOUNTAIN INSTITUTE

MOUNTAIN INSTITUTE HEALTH CARE EXPANSION

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Designed by/Concept par
EDWIN BERZINS
Drawn by/Dessiné par
-

PWGS Project Manager/Administrateur de Projets TPSGC
 TONY TANG

Regional Manager, Architectural and Engineering Services
 Gestionnaire régionale, Services d'architectural et de génie, TPSGC

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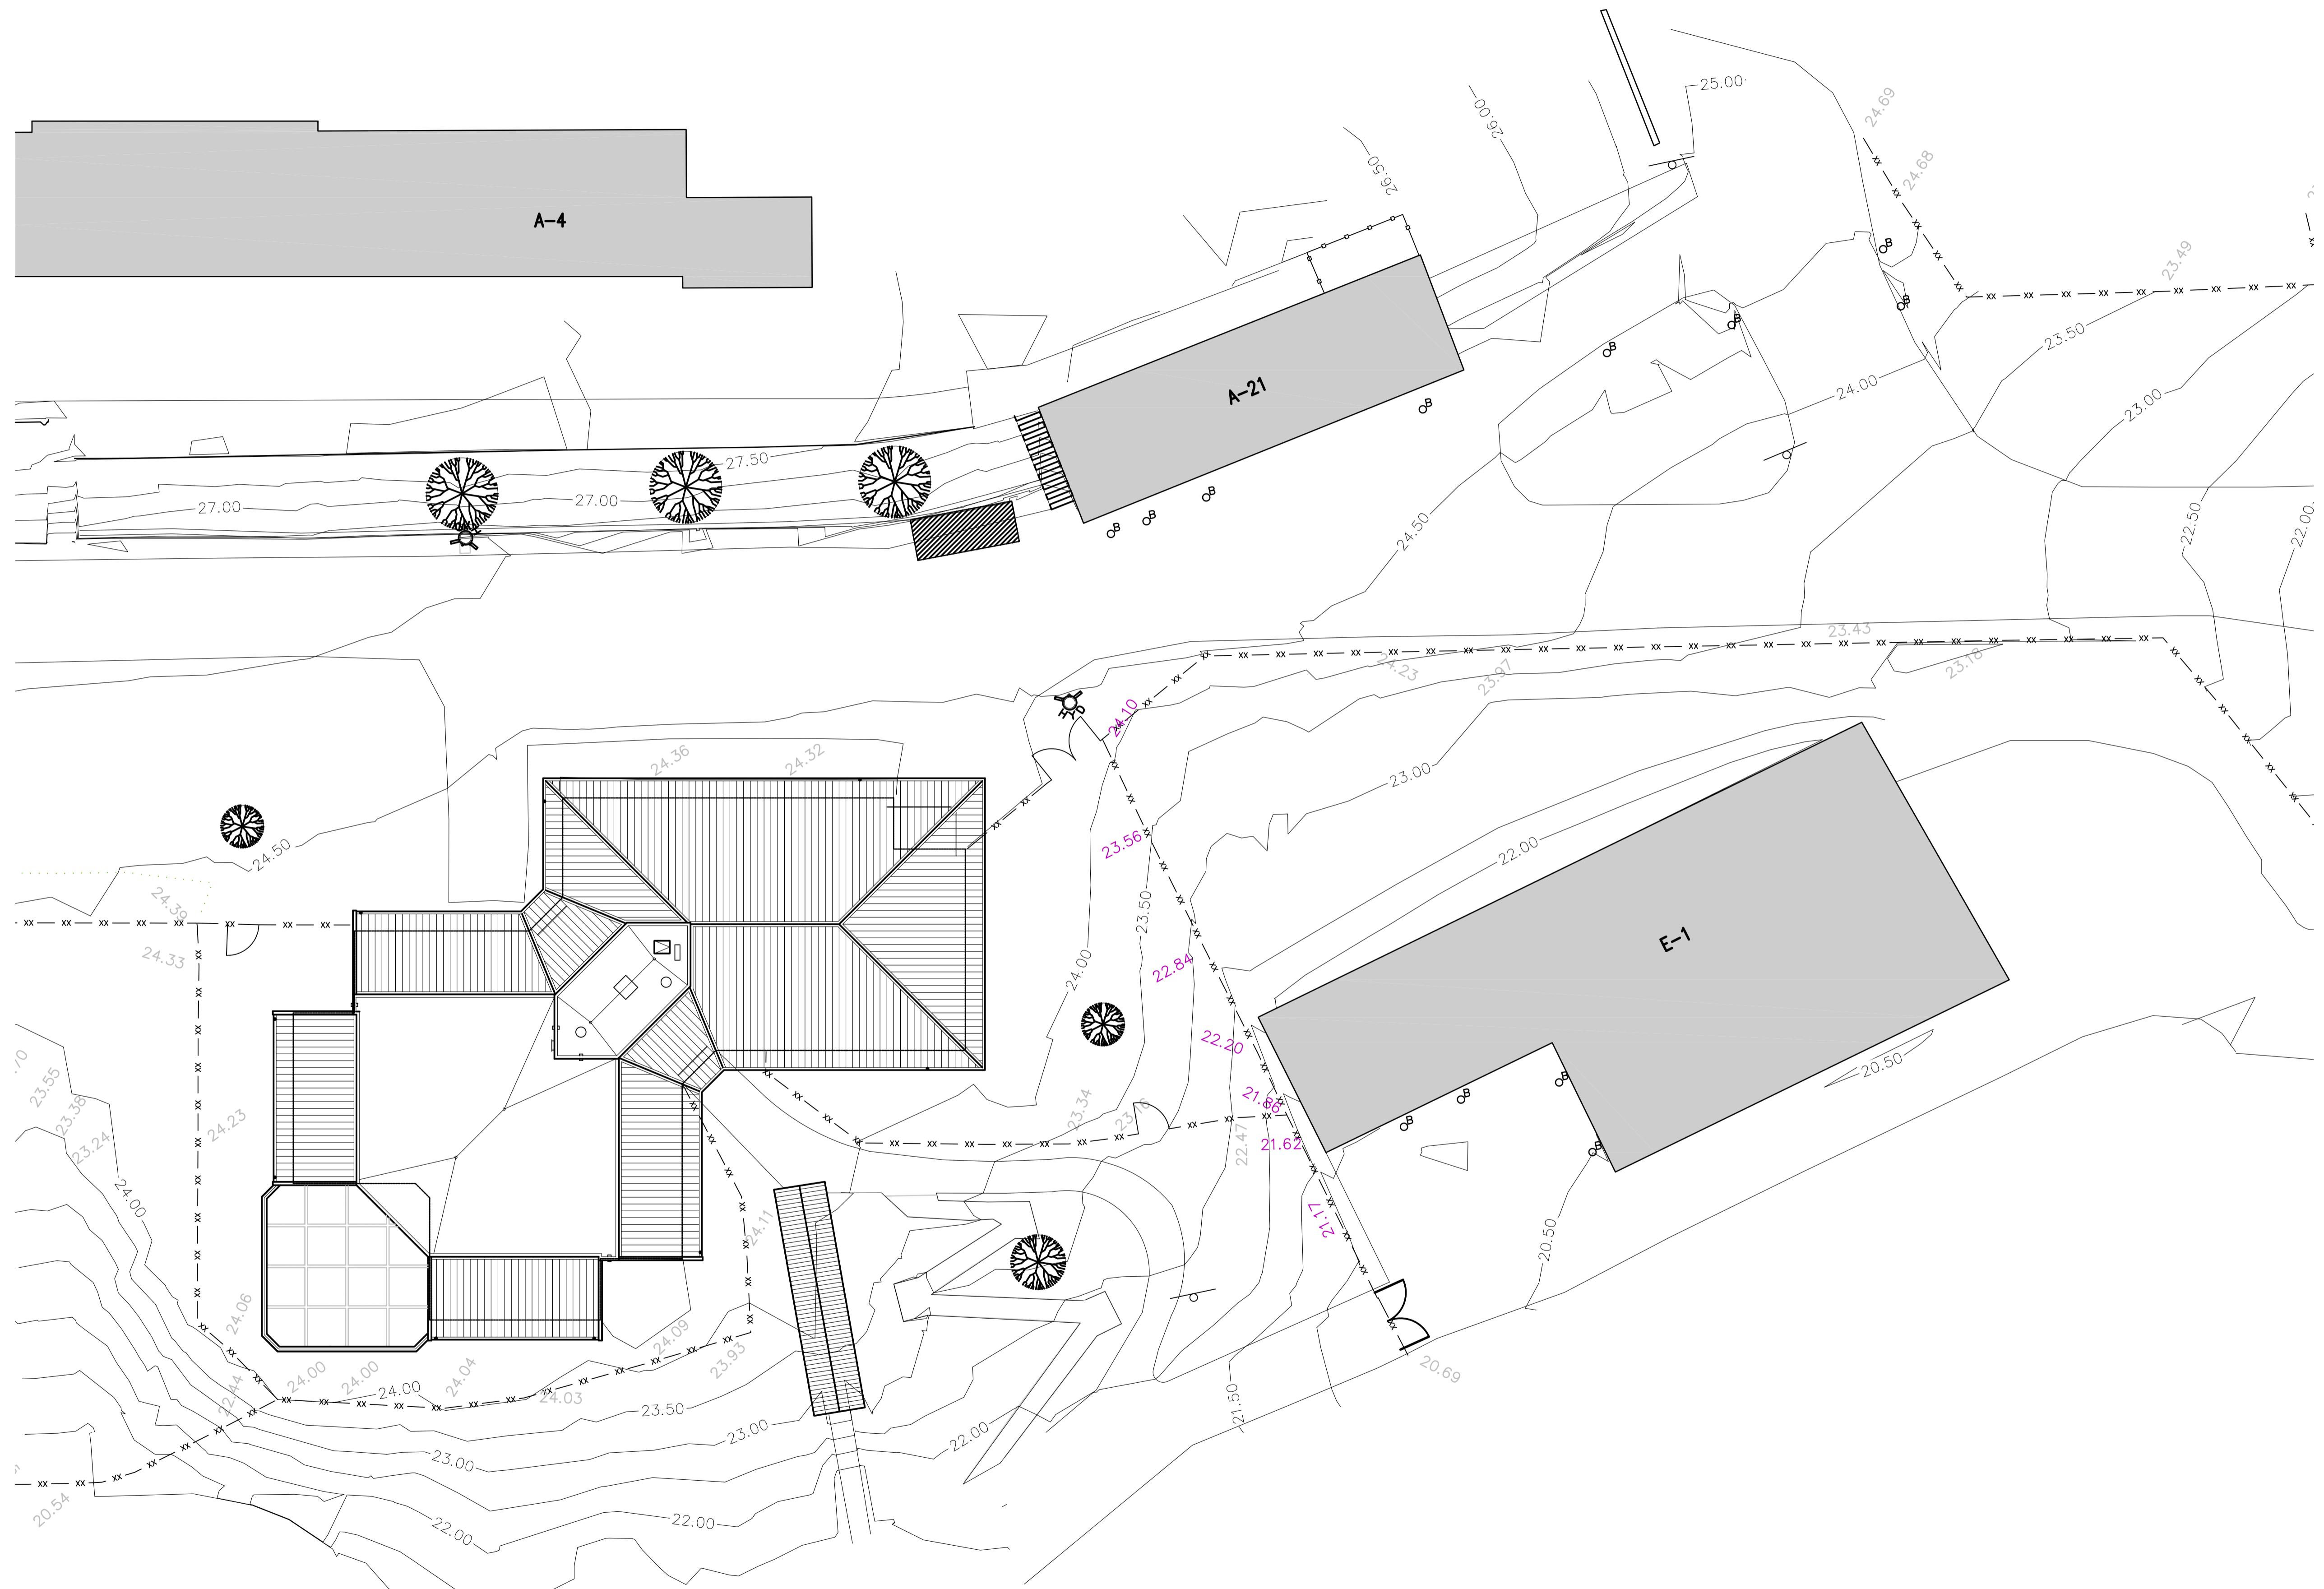
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 4732 CEMETERY ROAD PO BOX 1600
MOUNTAIN INSTITUTE


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 -
 PWGSC Project Manager/Administrateur de Projets TPSGC
TONY TANG
 Regional Manager, Architectural and Engineering Services
 Gestionnaire régionale, Services d'architectural et de génie, TPSGC
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01 EXISTING FACILITY
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00 KEY PLAN
A005 N.T.S.



01 EXTERIOR
A005



02 EXTERIOR
A005

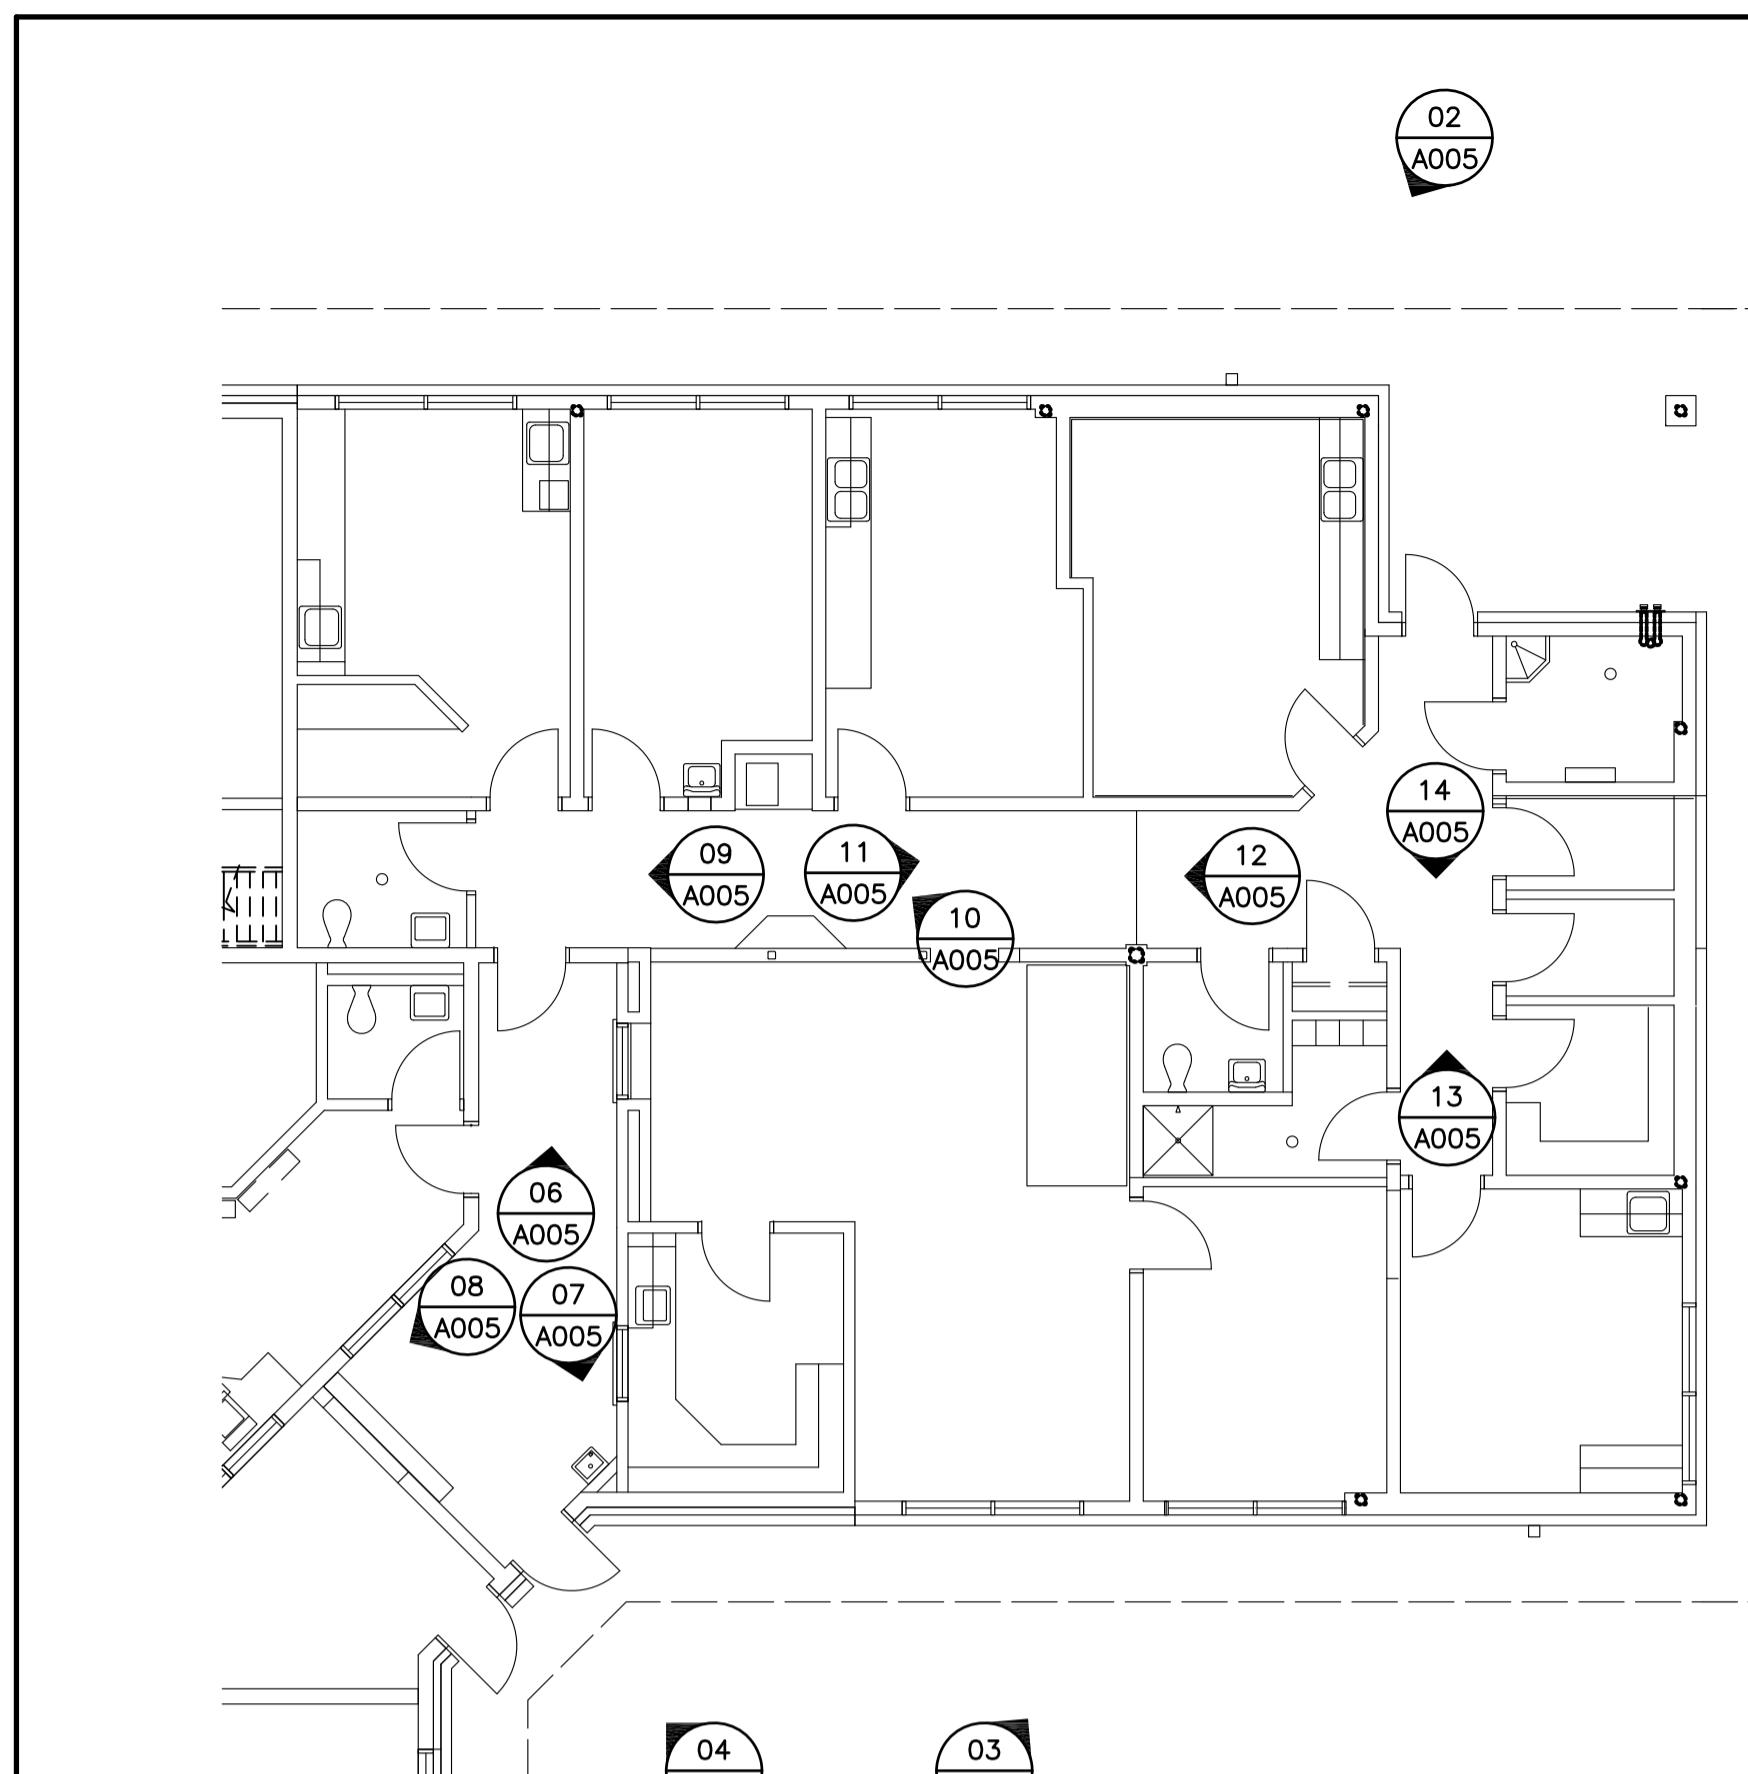

03 EXTERIOR
A005




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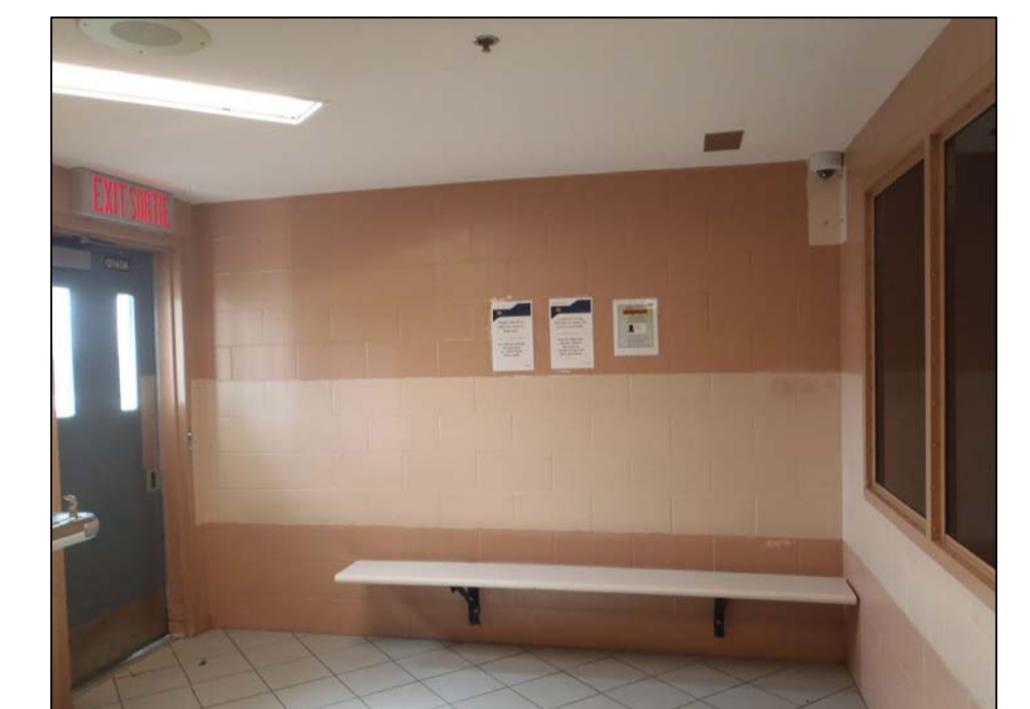
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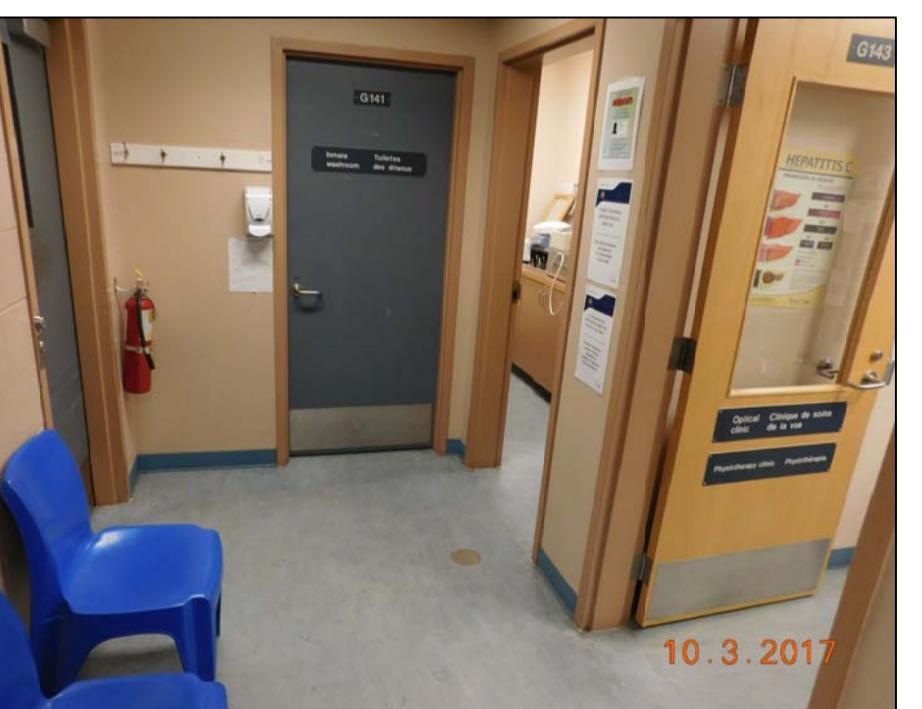
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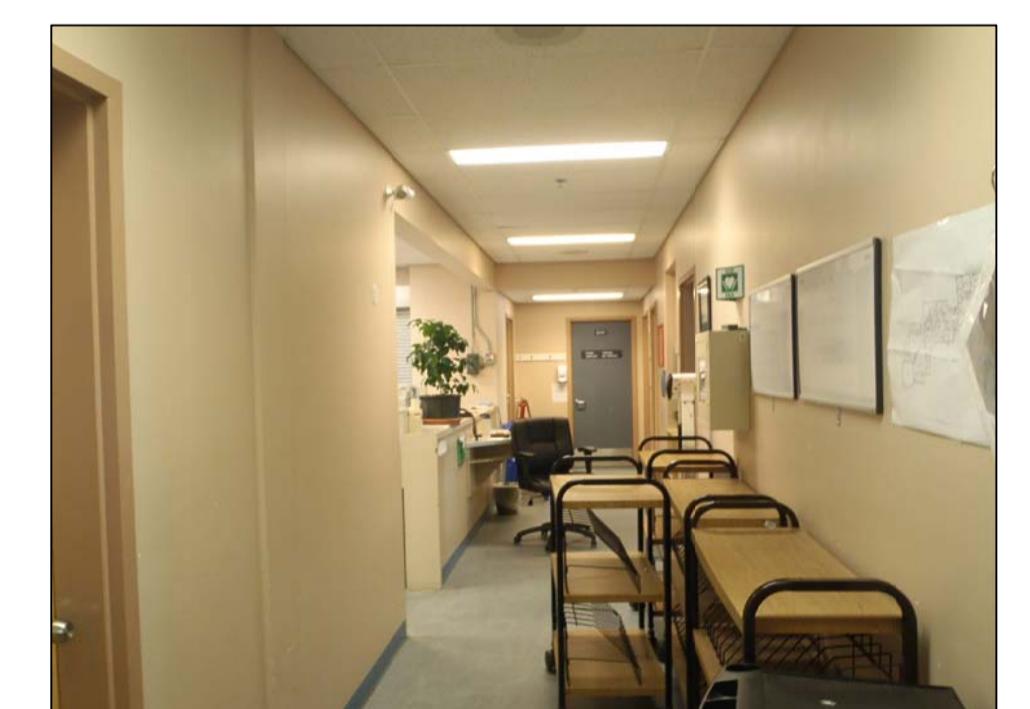
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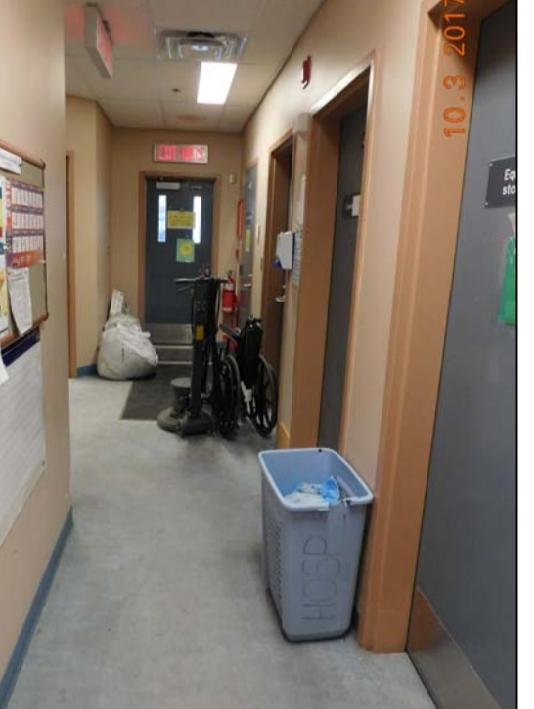
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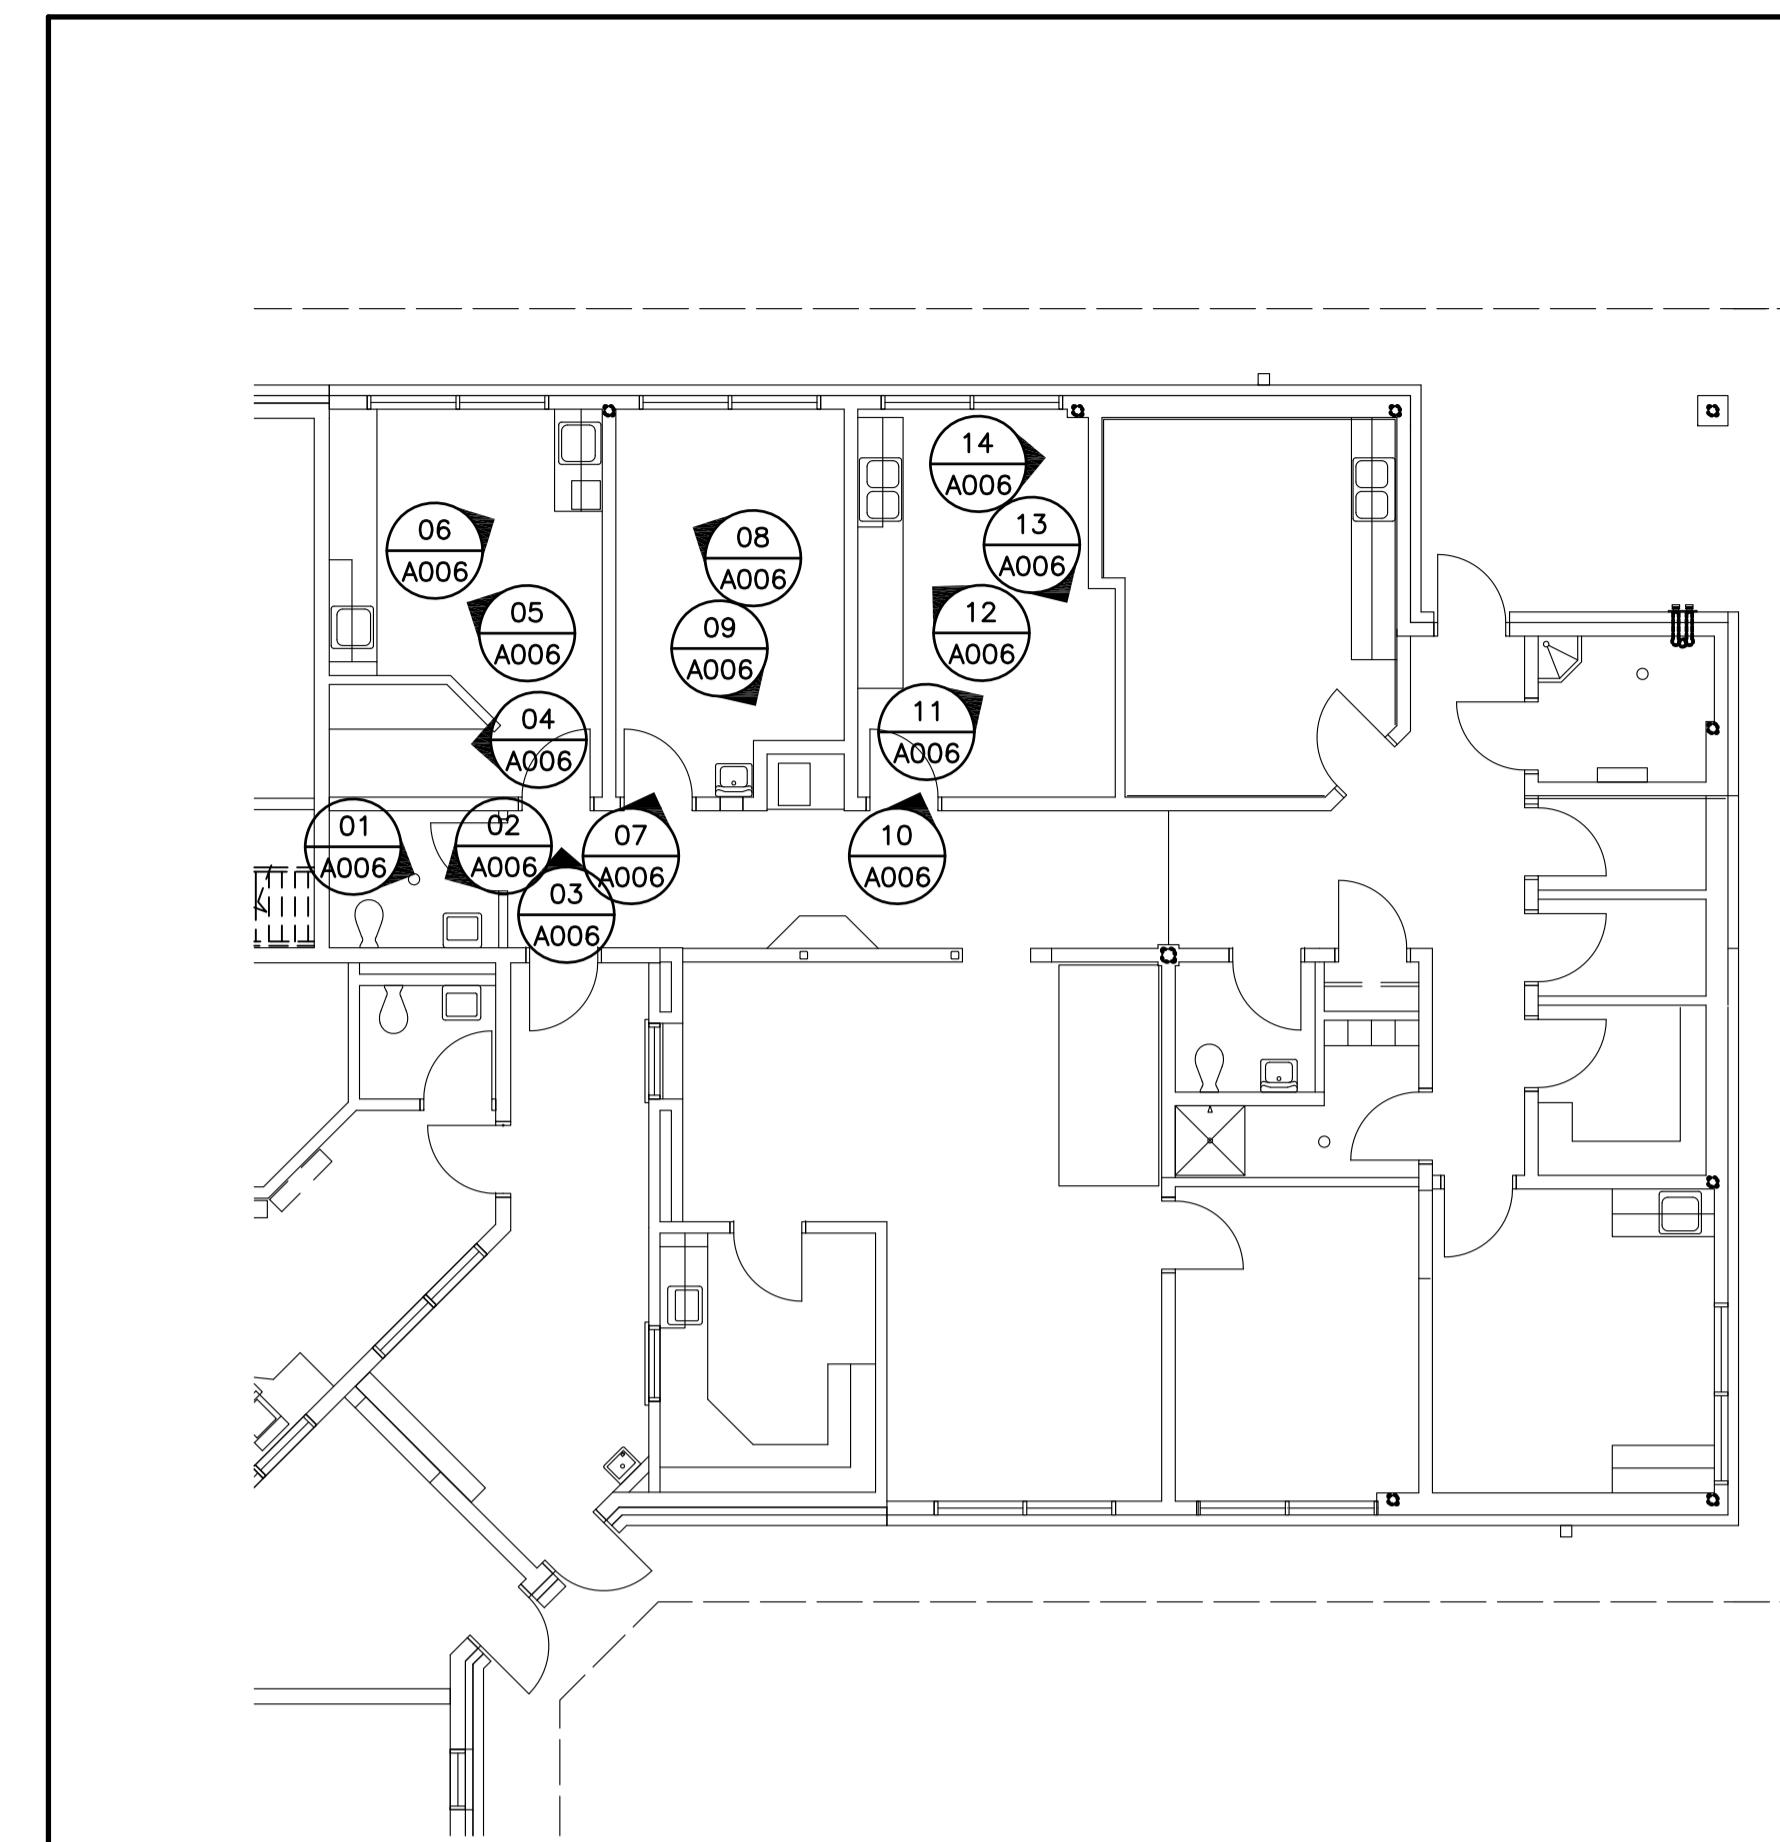
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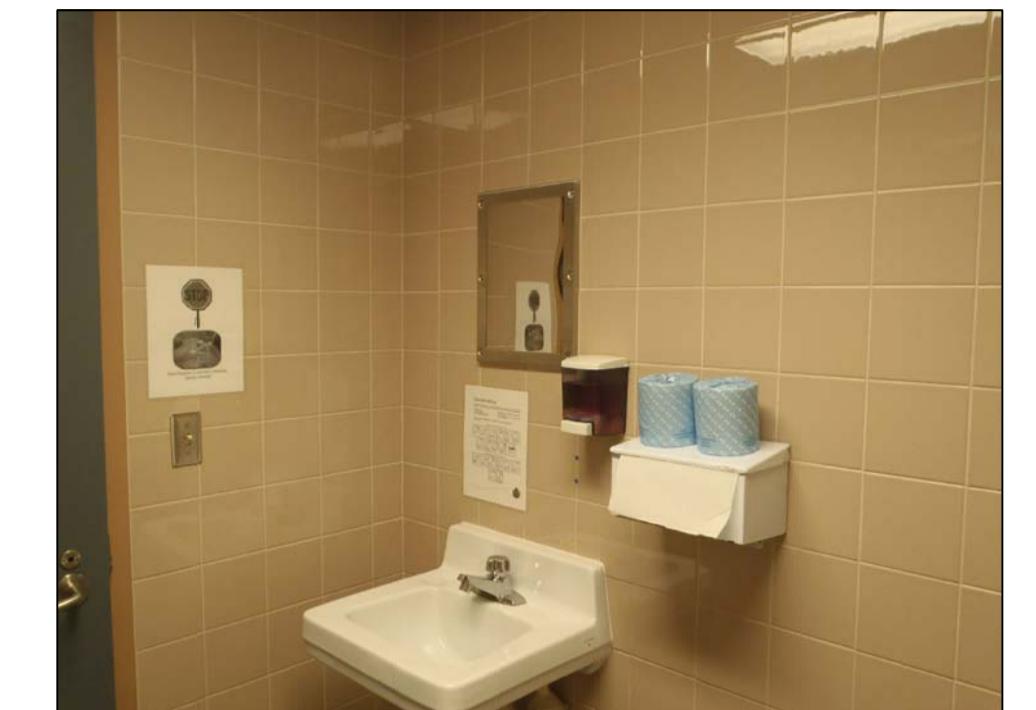
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PWGS Project Manager/Administrateur de Projets TPSGC TONY TANG
Regional Manager, Architectural and Engineering Services Gestionnaire régionale, Services d'architecture et de génie, TPSGC PREETPAL PAUL
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EXISTING CONDITIONS PHOTOS 1

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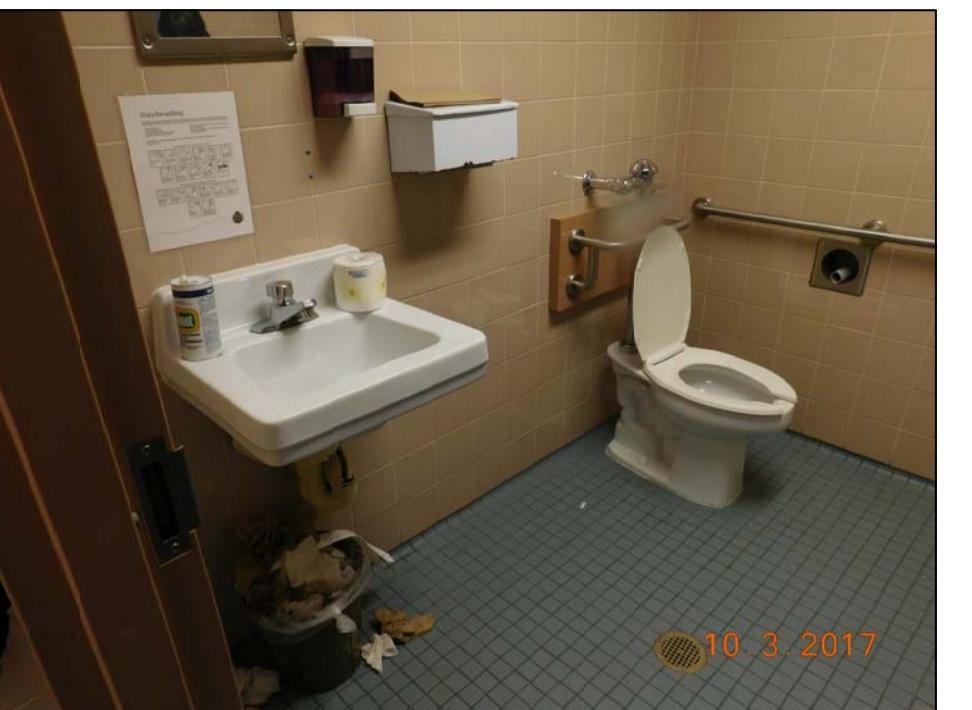
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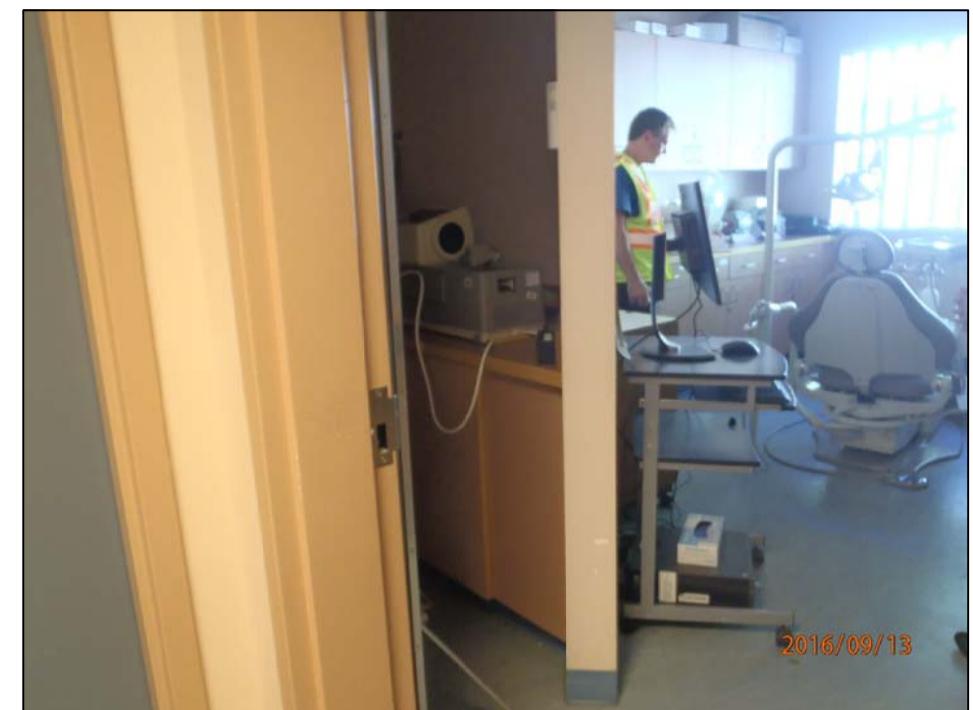
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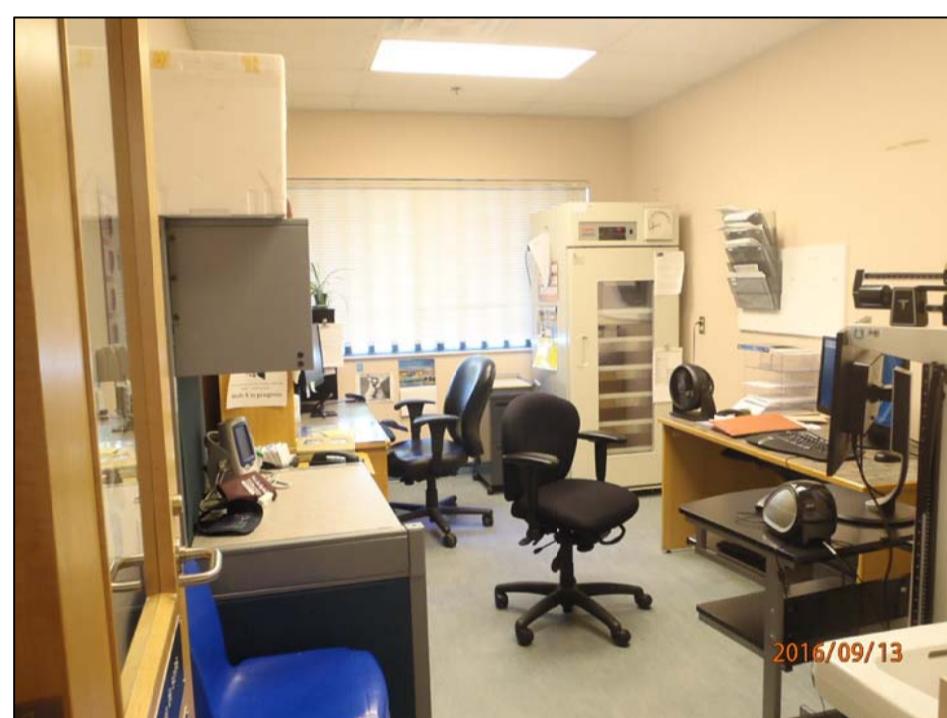
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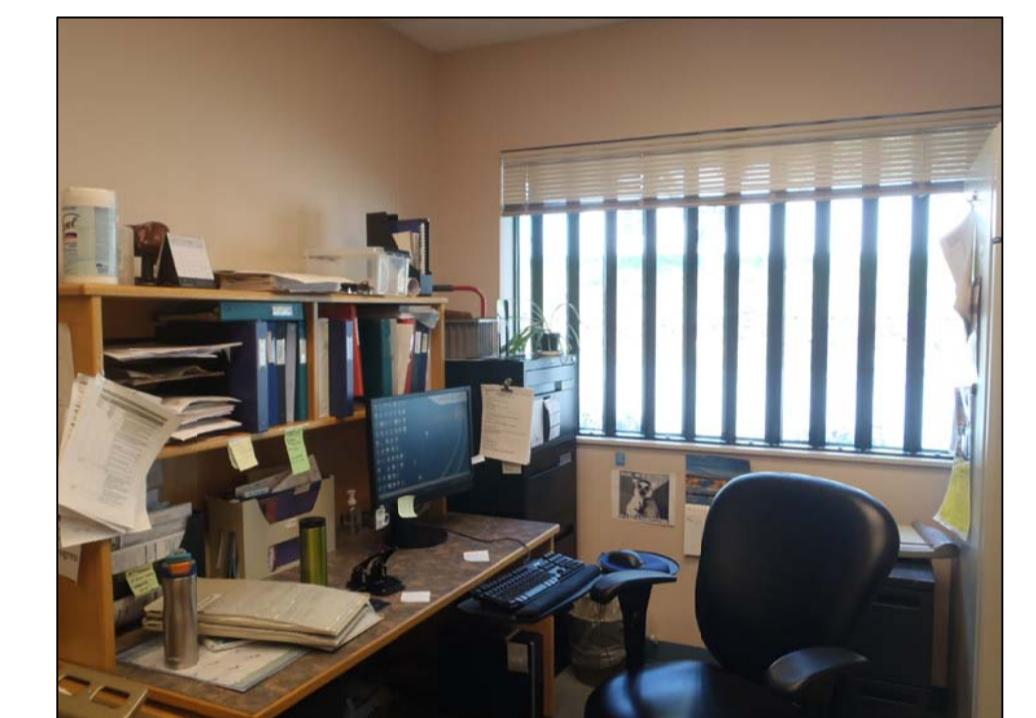
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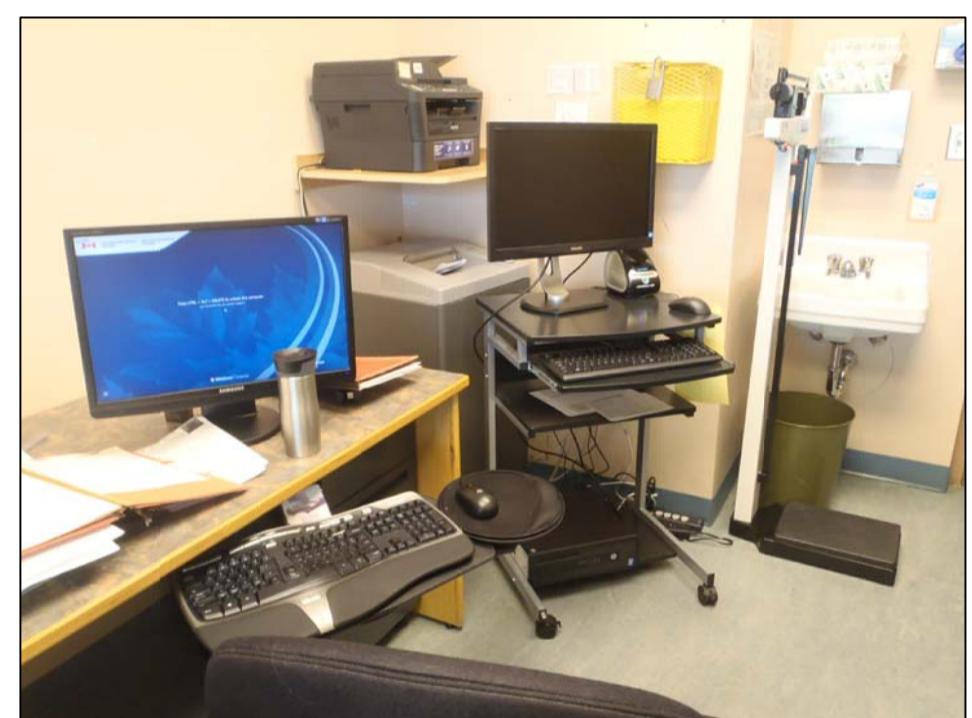
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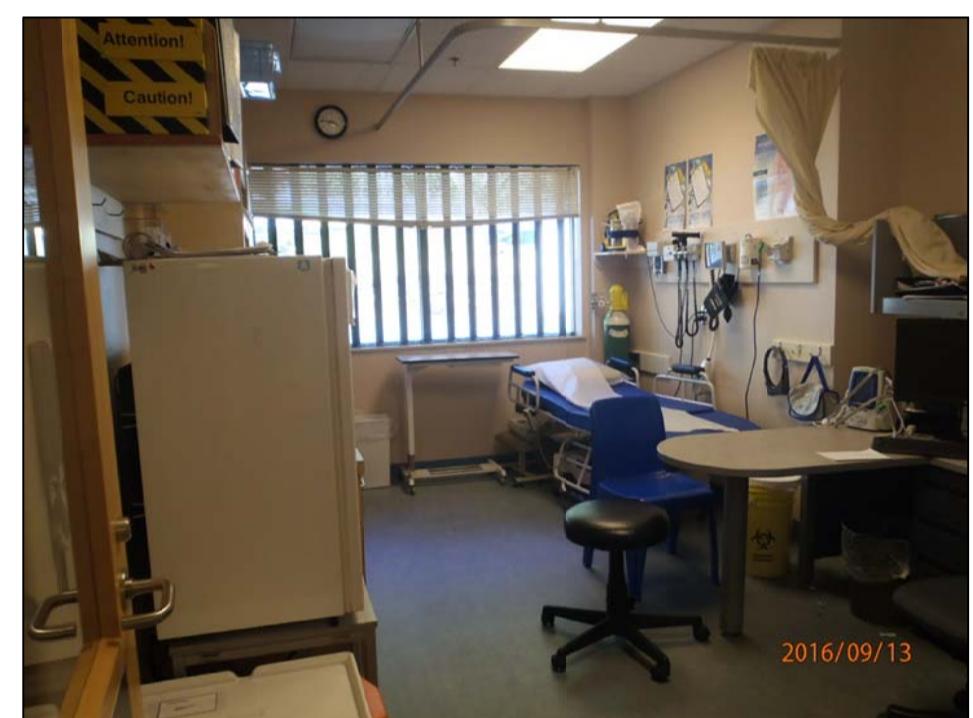
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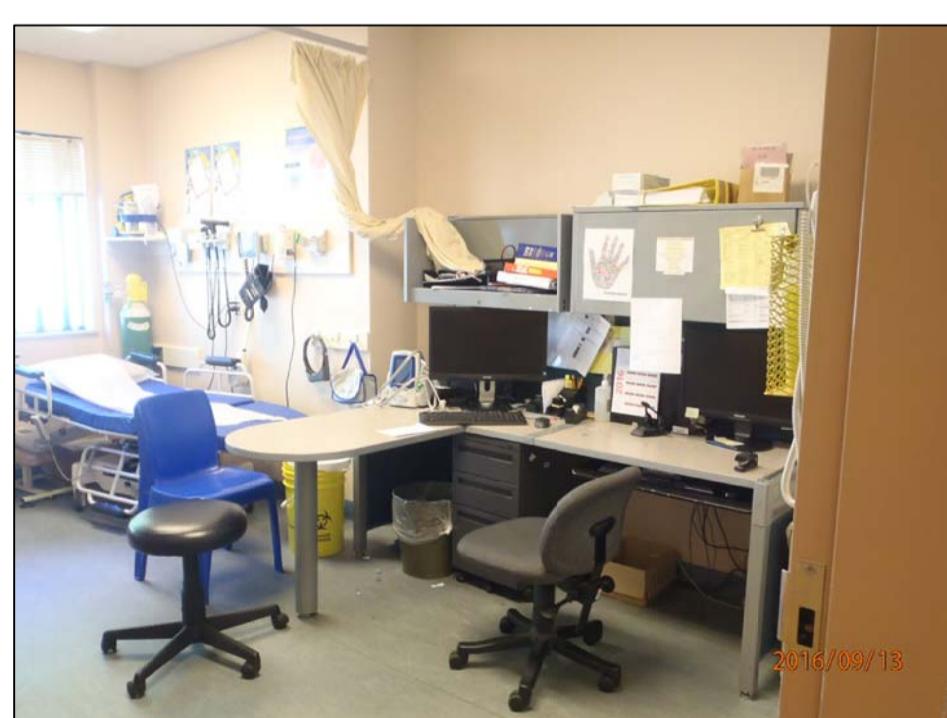
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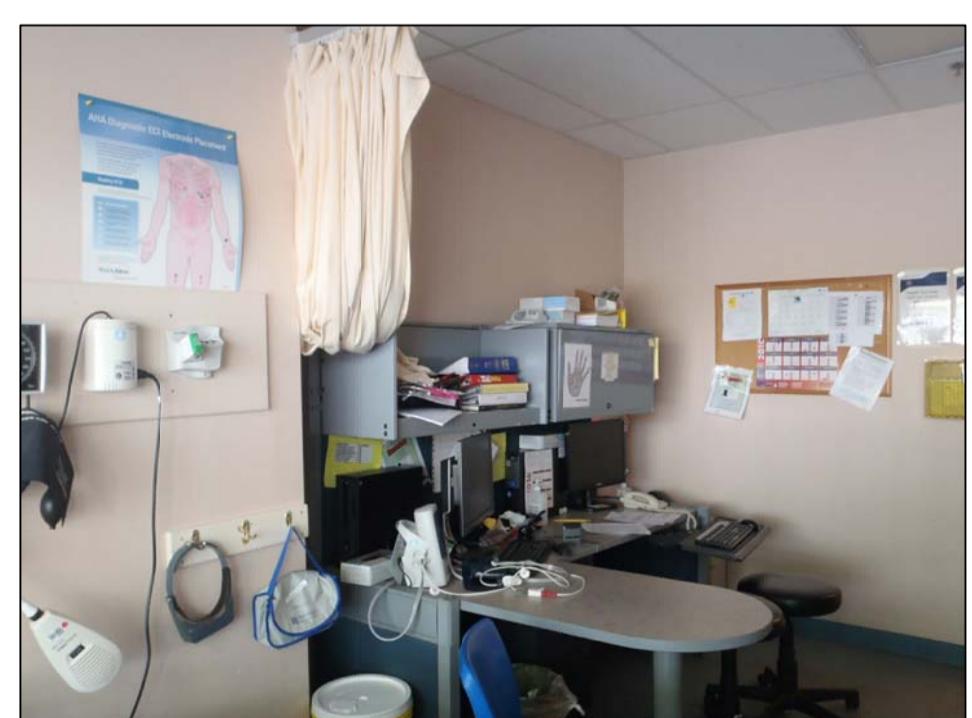
10 G145 EXAMINATION
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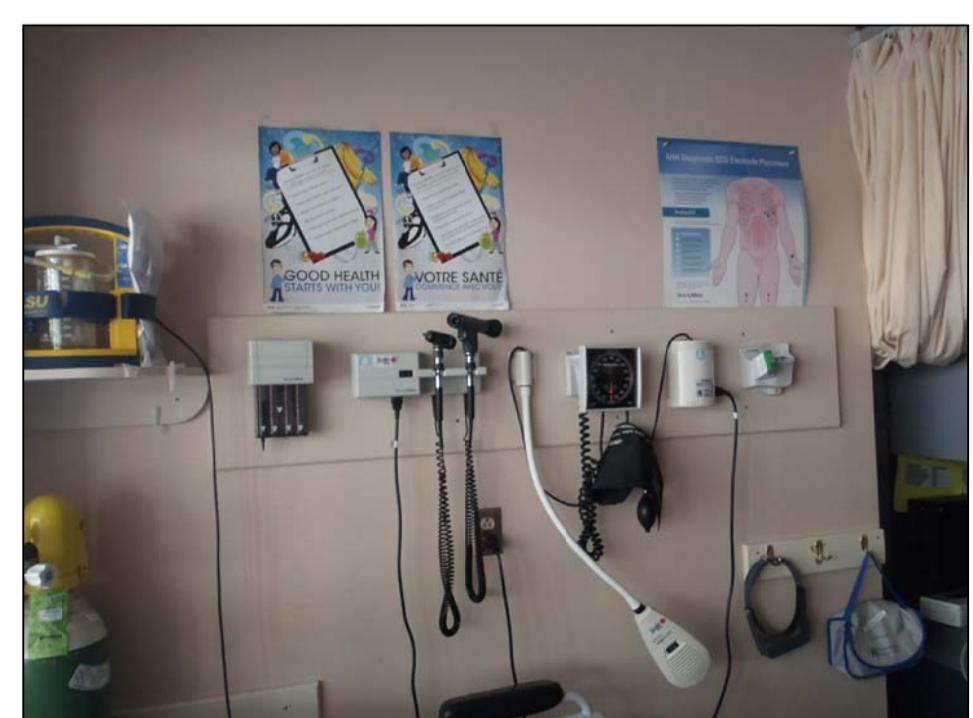
11 G145 EXAMINATION
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13 G145 EXAMINATION
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14 G145 EXAMINATION
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AGASSIZ, BRITISH COLUMBIA
4732 CEMETERY ROAD PO BOX 1600
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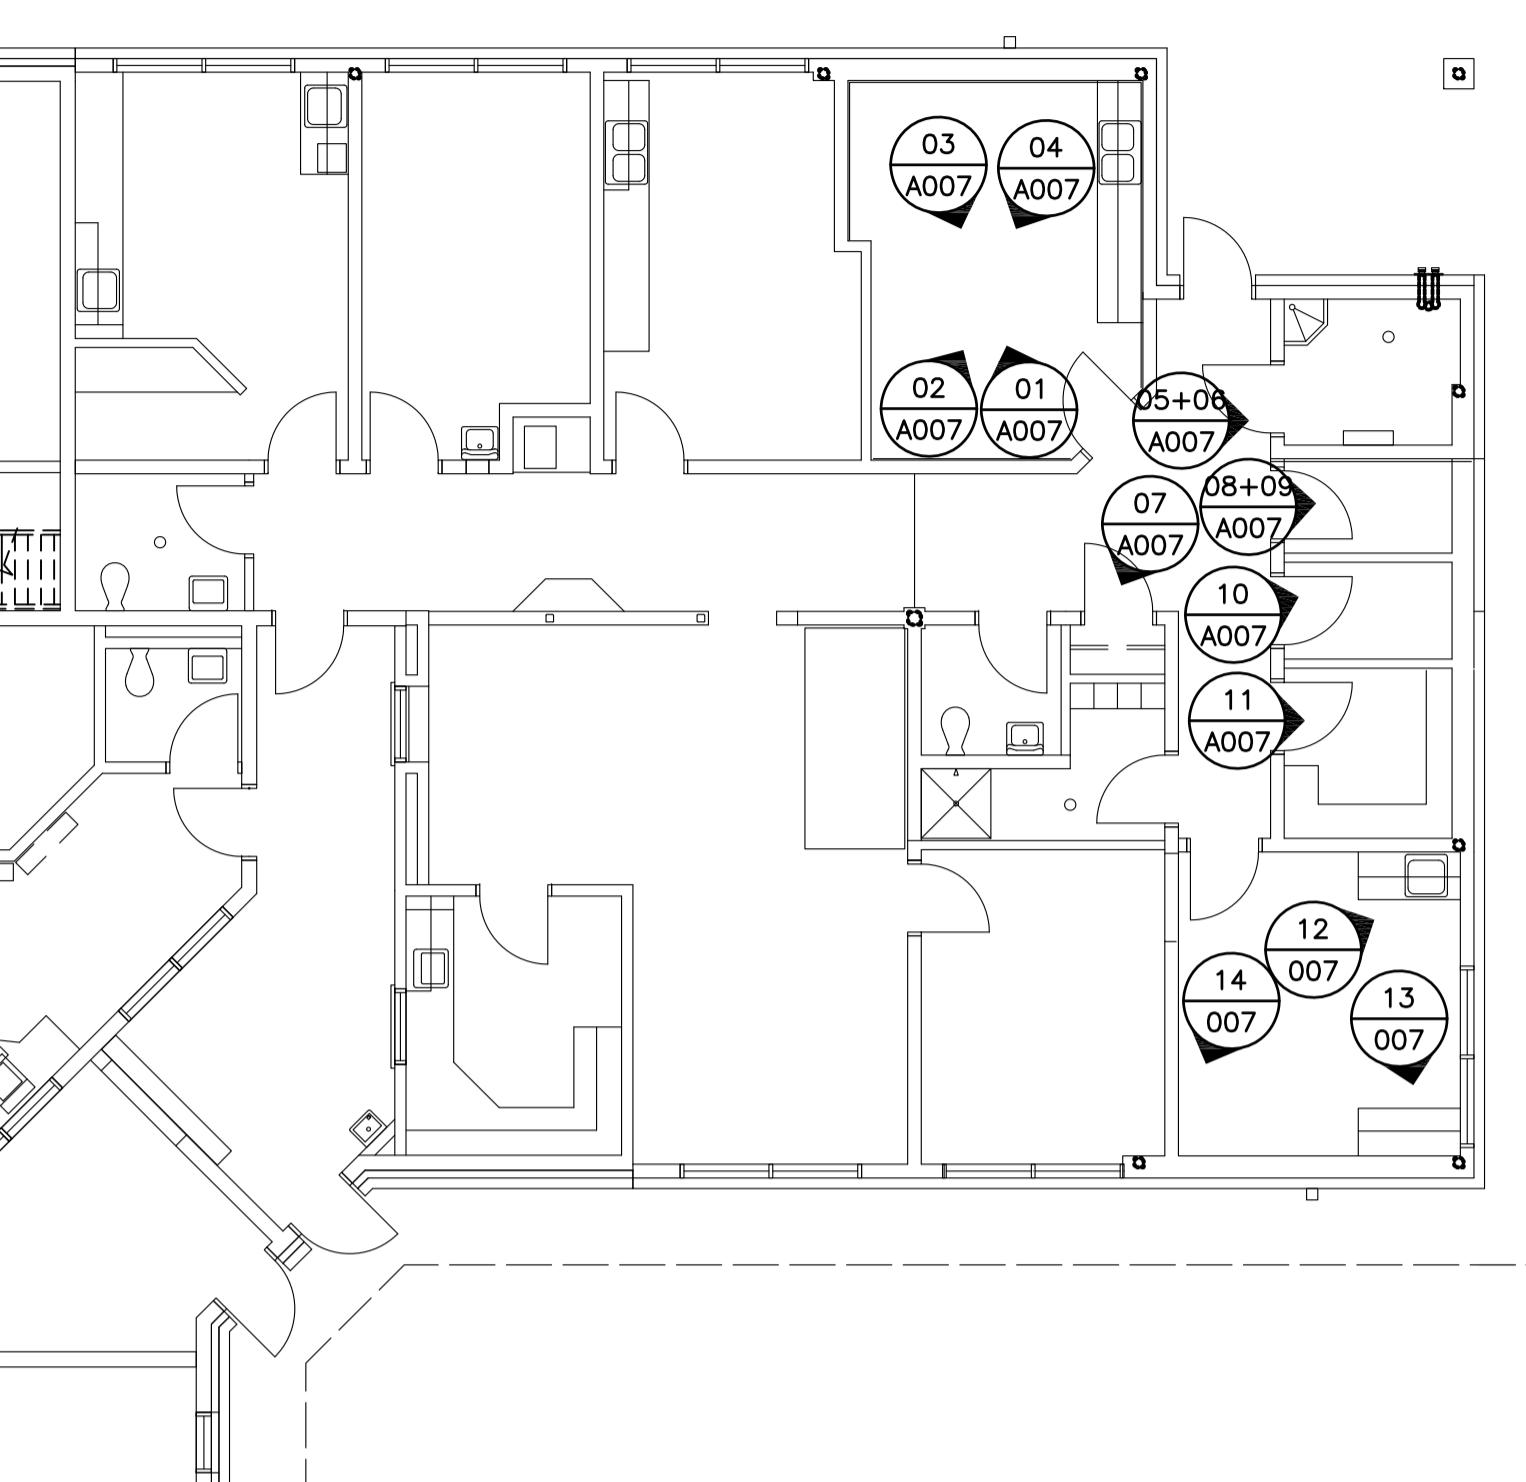
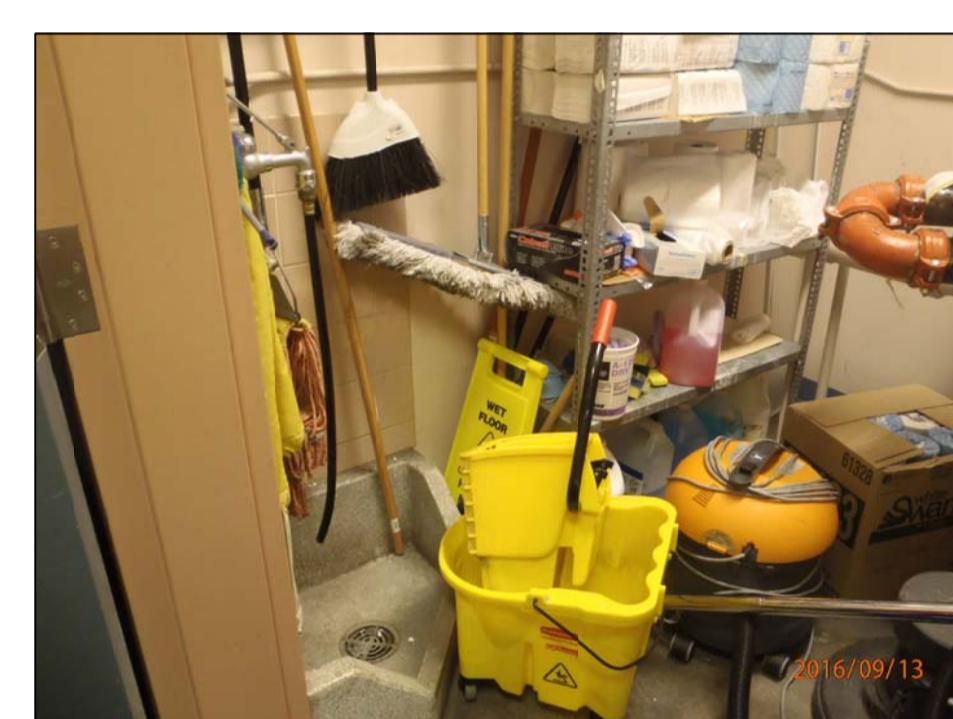
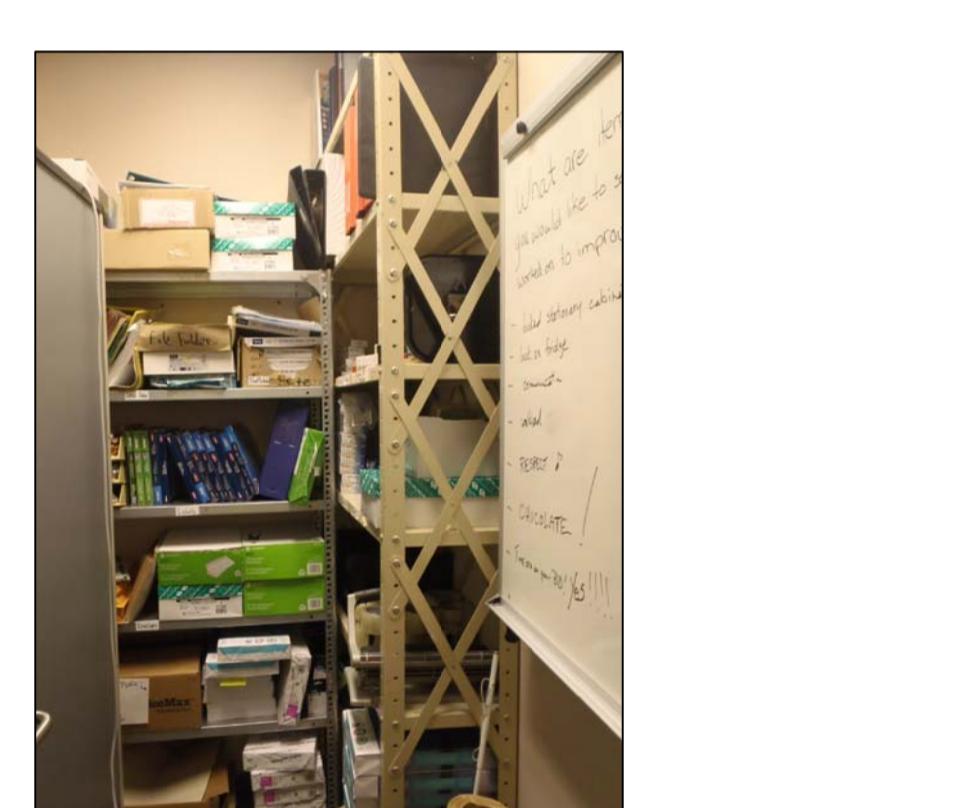
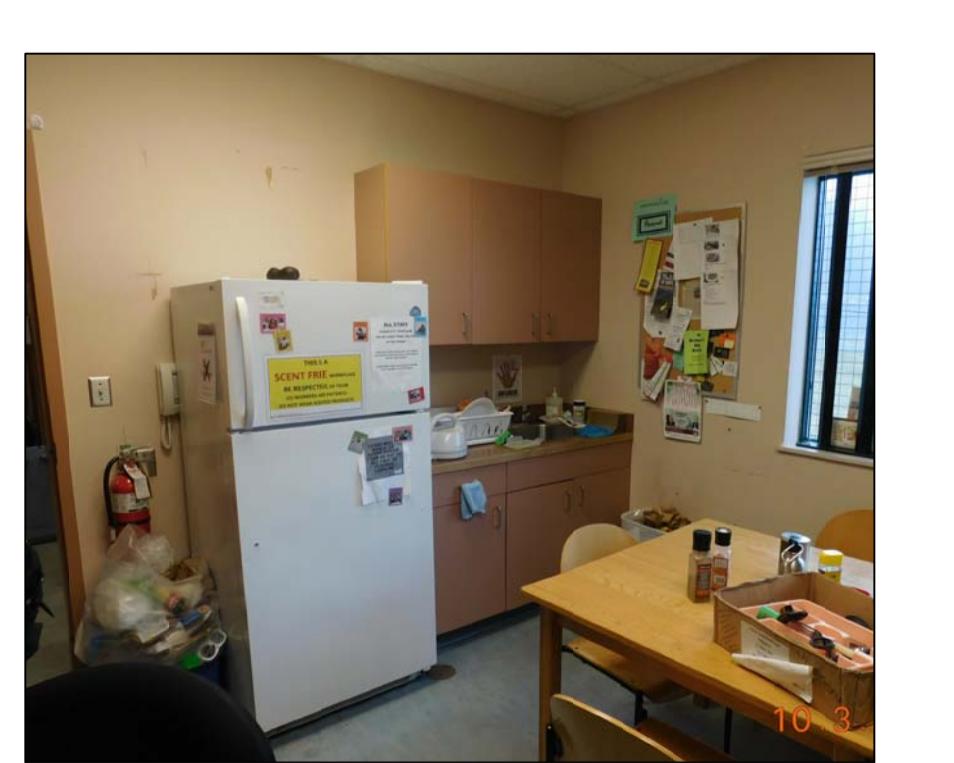
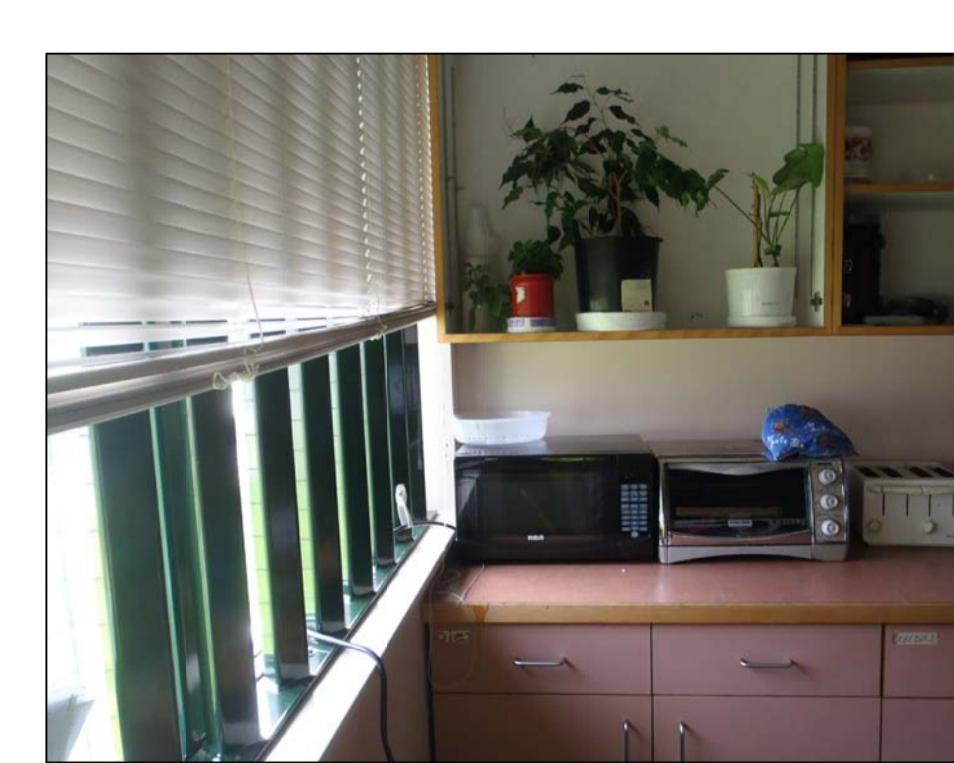
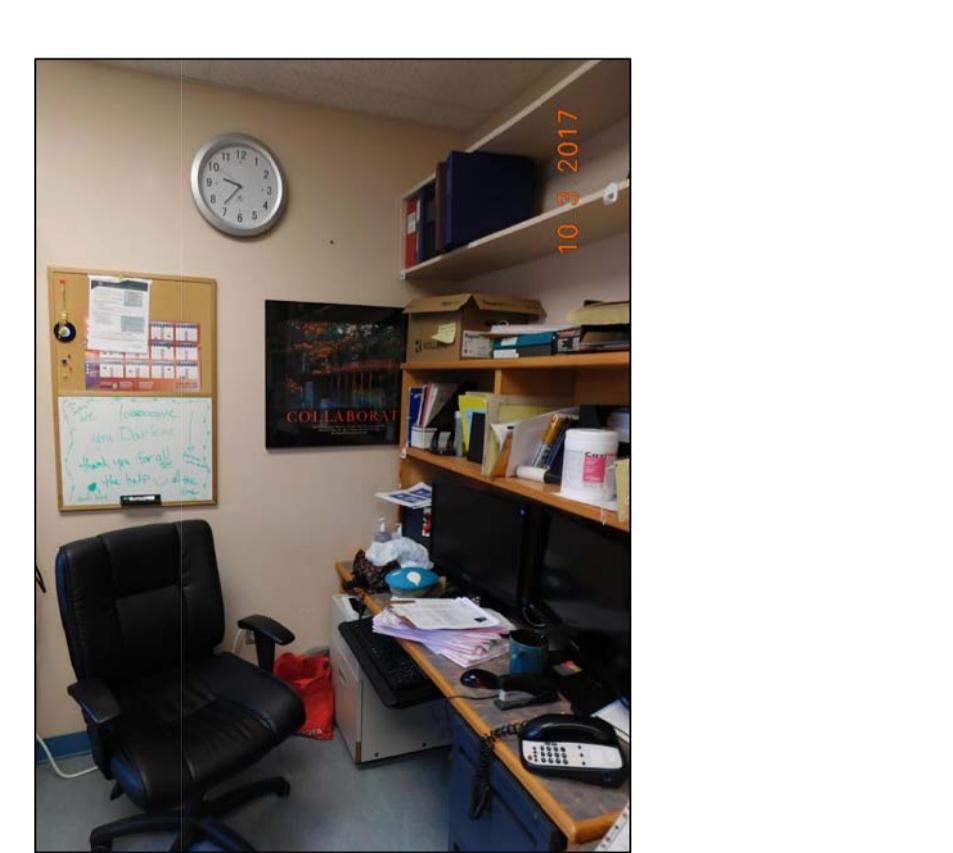
MOUNTAIN INSTITUTE HEALTH CARE EXPANSION

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Designed by/Concept par EDWIN BERZINS
Drawn by/Dessiné par BEN MONROE (2017-09-28)
PWGS Project Manager/Administrateur de Projets TPSGC DARYL SINCLAIR
Regional Manager, Architectural and Engineering Services Gestionnaire régionale, Services d'architecture et de génie, TPSGC PREETPAL PAUL
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EXISTING CONDITIONS PHOTOS 2

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		<u>01 G146 TREATMENT</u>	<u>02 G146 TREATMENT</u>	<u>03 G146 TREATMENT</u>
				
		<u>04 G146 TREATMENT</u>	<u>05 G150 SPRINKLER</u>	<u>06 G150 SPRINKLER</u>
				
<u>07 G148A CLOSET</u>		<u>08 G151 OXYGEN</u>	<u>09 G151 OXYGEN</u>	<u>10 G152 STORAGE</u>
				
<u>11 G153 MED SUPPLY</u>		<u>12 G154 STAFF LOUNGE</u>	<u>13 G154 STAFF LOUNGE</u>	<u>14 G154 STAFF LOUNGE</u>

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**MOUNTAIN INSTITUTE
HEALTH CARE EXPANSION**


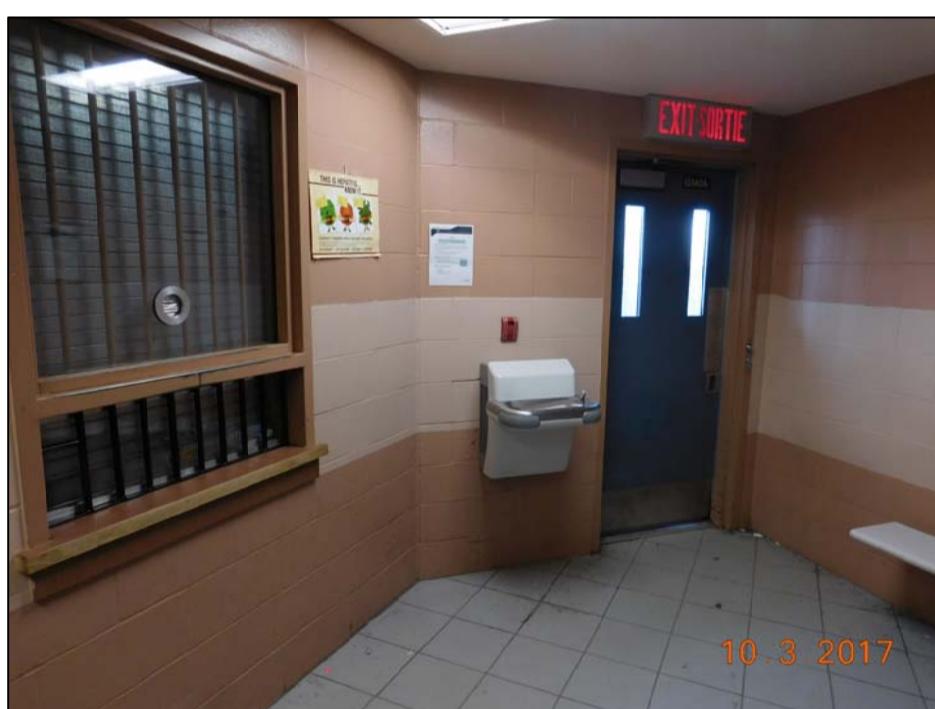
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EDWIN BERZINS
Drawn by/Dessiné par
BEN MONROE (2017-09-28)
PWGS Project Manager/Administrateur de Projets TPSGC
DARYL SINCLAIR
Regional Manager, Architectural and Engineering Services Gestionnaire régionale, Services d'architecture et de génie, TPSGC
PREETPAL PAUL


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EXISTING CONDITIONS PHOTOS 3

Project No./No. du projet	Sheet/Feuille	Revision no./ La Révision no.
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	00 KEY PLAN <small>A008 N.T.S.</small>	01 G156 SHOWER <small>A008</small>	02 G156 SHOWER <small>A008</small>	03 G156 SHOWER <small>A008</small>	04 G157 WASHROOM <small>A008</small>	05 G157 WASHROOM <small>A008</small>	06 G158 NURSING STATION <small>A008</small>	07 G158 NURSING STATION <small>A008</small>	08 G158 NURSING STATION <small>A008</small>	09 G159 DISPENSARY <small>A008</small>	10 G159 DISPENSARY <small>A008</small>	11 G159 DISPENSARY <small>A008</small>	12 G159 DISPENSARY <small>A008</small>	13 G159 DISPENSARY <small>A008</small>	14 G159A PHARMACY <small>A008</small>
															
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Project title/Titre du projet AGASSIZ, BRITISH COLUMBIA 4732 CEMETERY ROAD PO BOX 1600 MOUNTAIN INSTITUTE															
MOUNTAIN INSTITUTE HEALTH CARE EXPANSION															
Consultant Signature Only Designed by/Conçue par EDWIN BERZINS Drawn by/Dessiné par BEN MONROE (2017-09-28) PWGSC Project Manager/Administrateur de Projets TPSGC DARYL SINCLAIR Regional Manager, Architectural and Engineering Services Gestionnaire régionale, Services d'architecture et de génie, TPSGC PREETPAL PAUL Drawing title/Titre du dessin															
EXISTING CONDITIONS PHOTOS 4															
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EXTERIOR SOUTH
09 A009

SPARE
06 A009

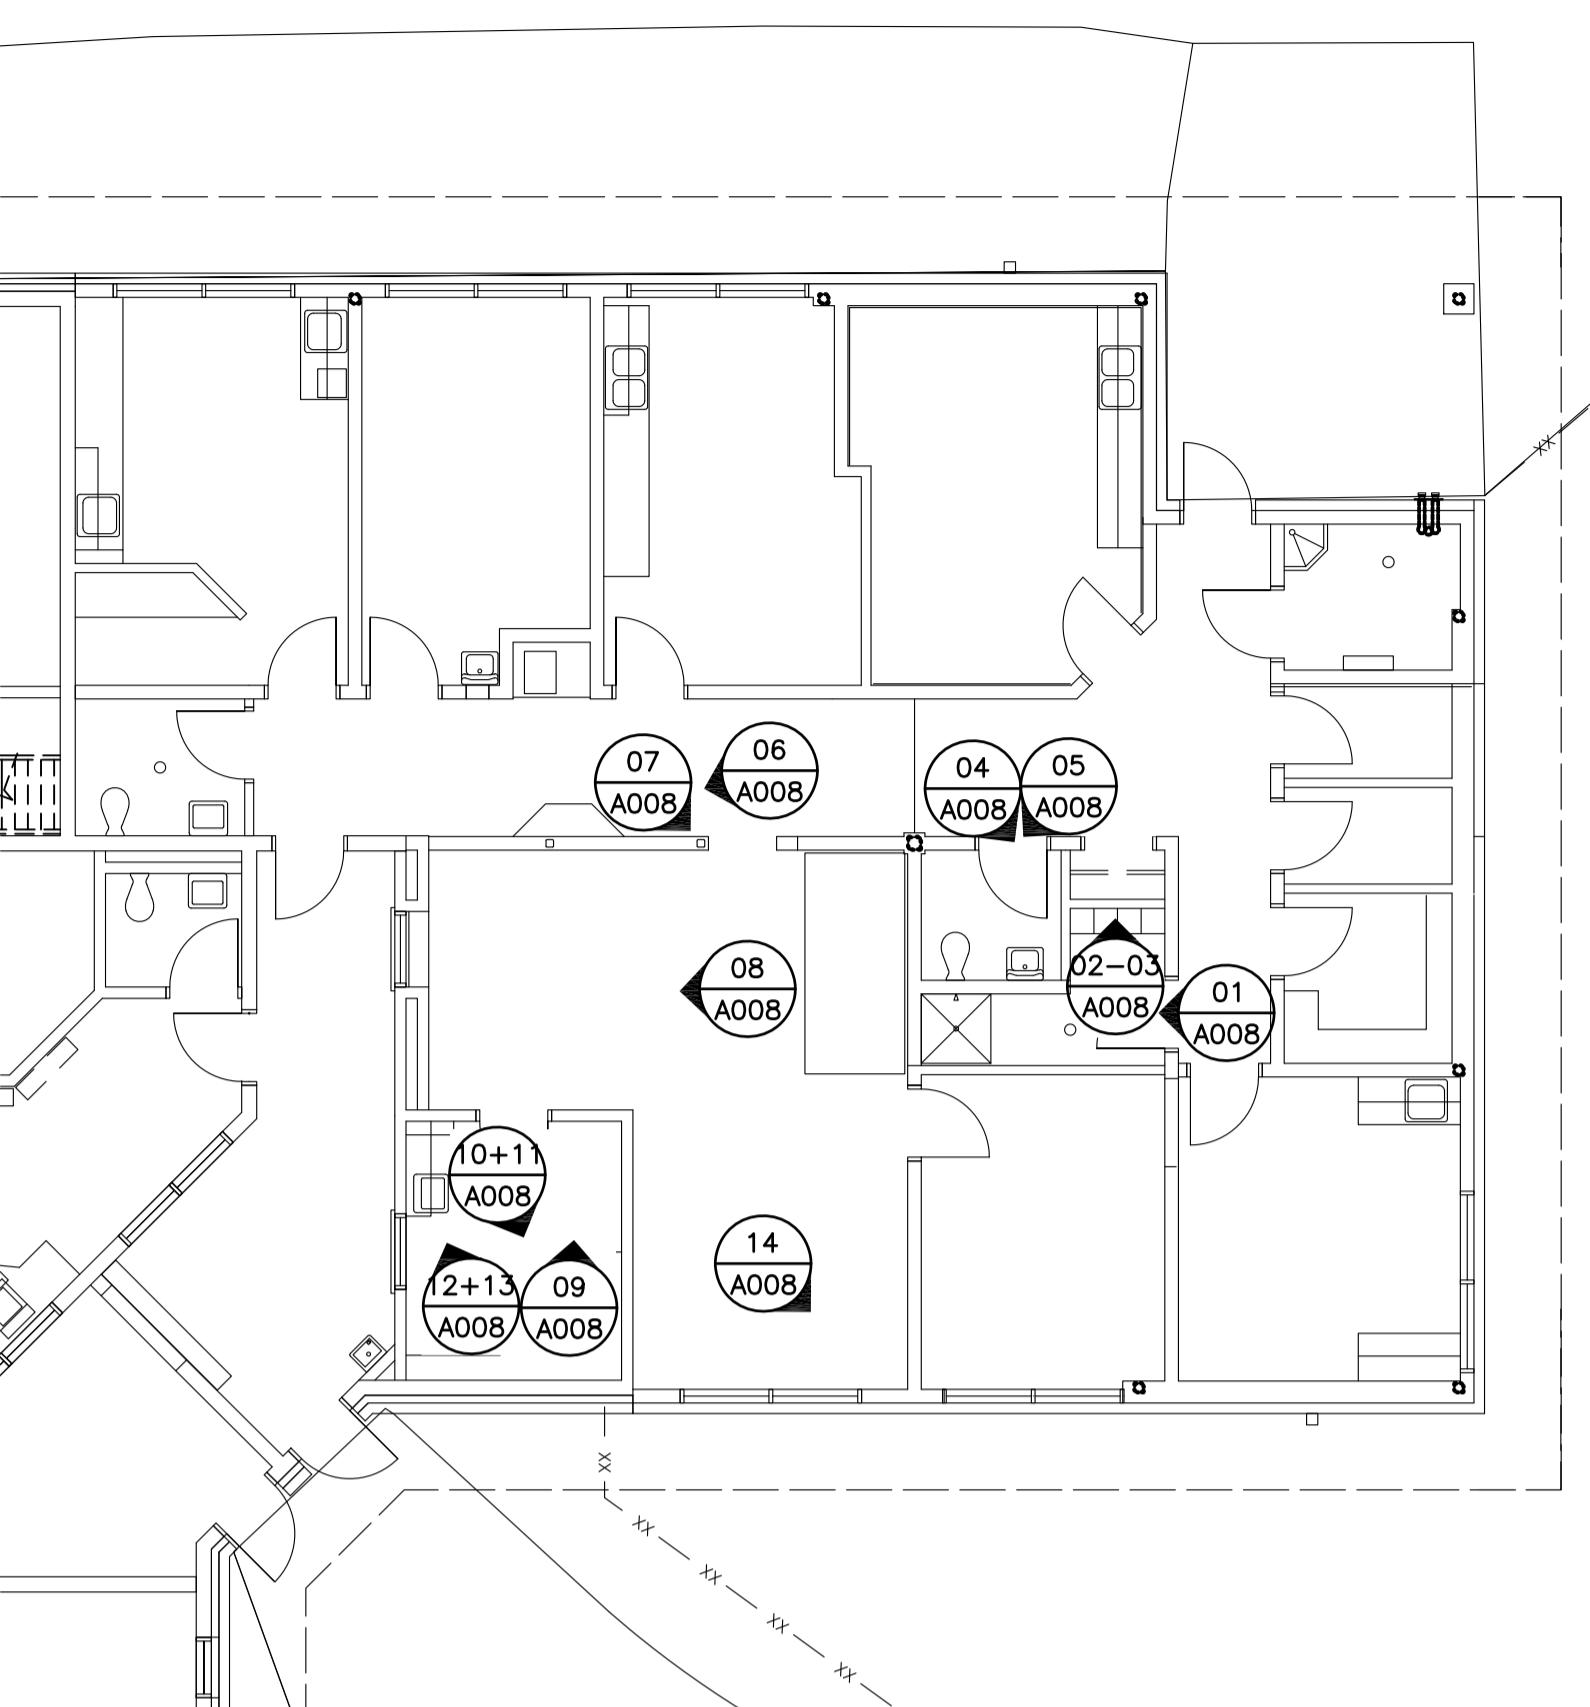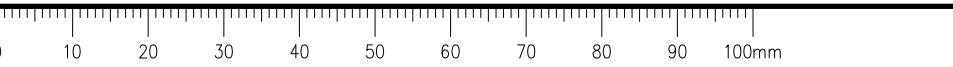

EXTERIOR NORTH
10 A009

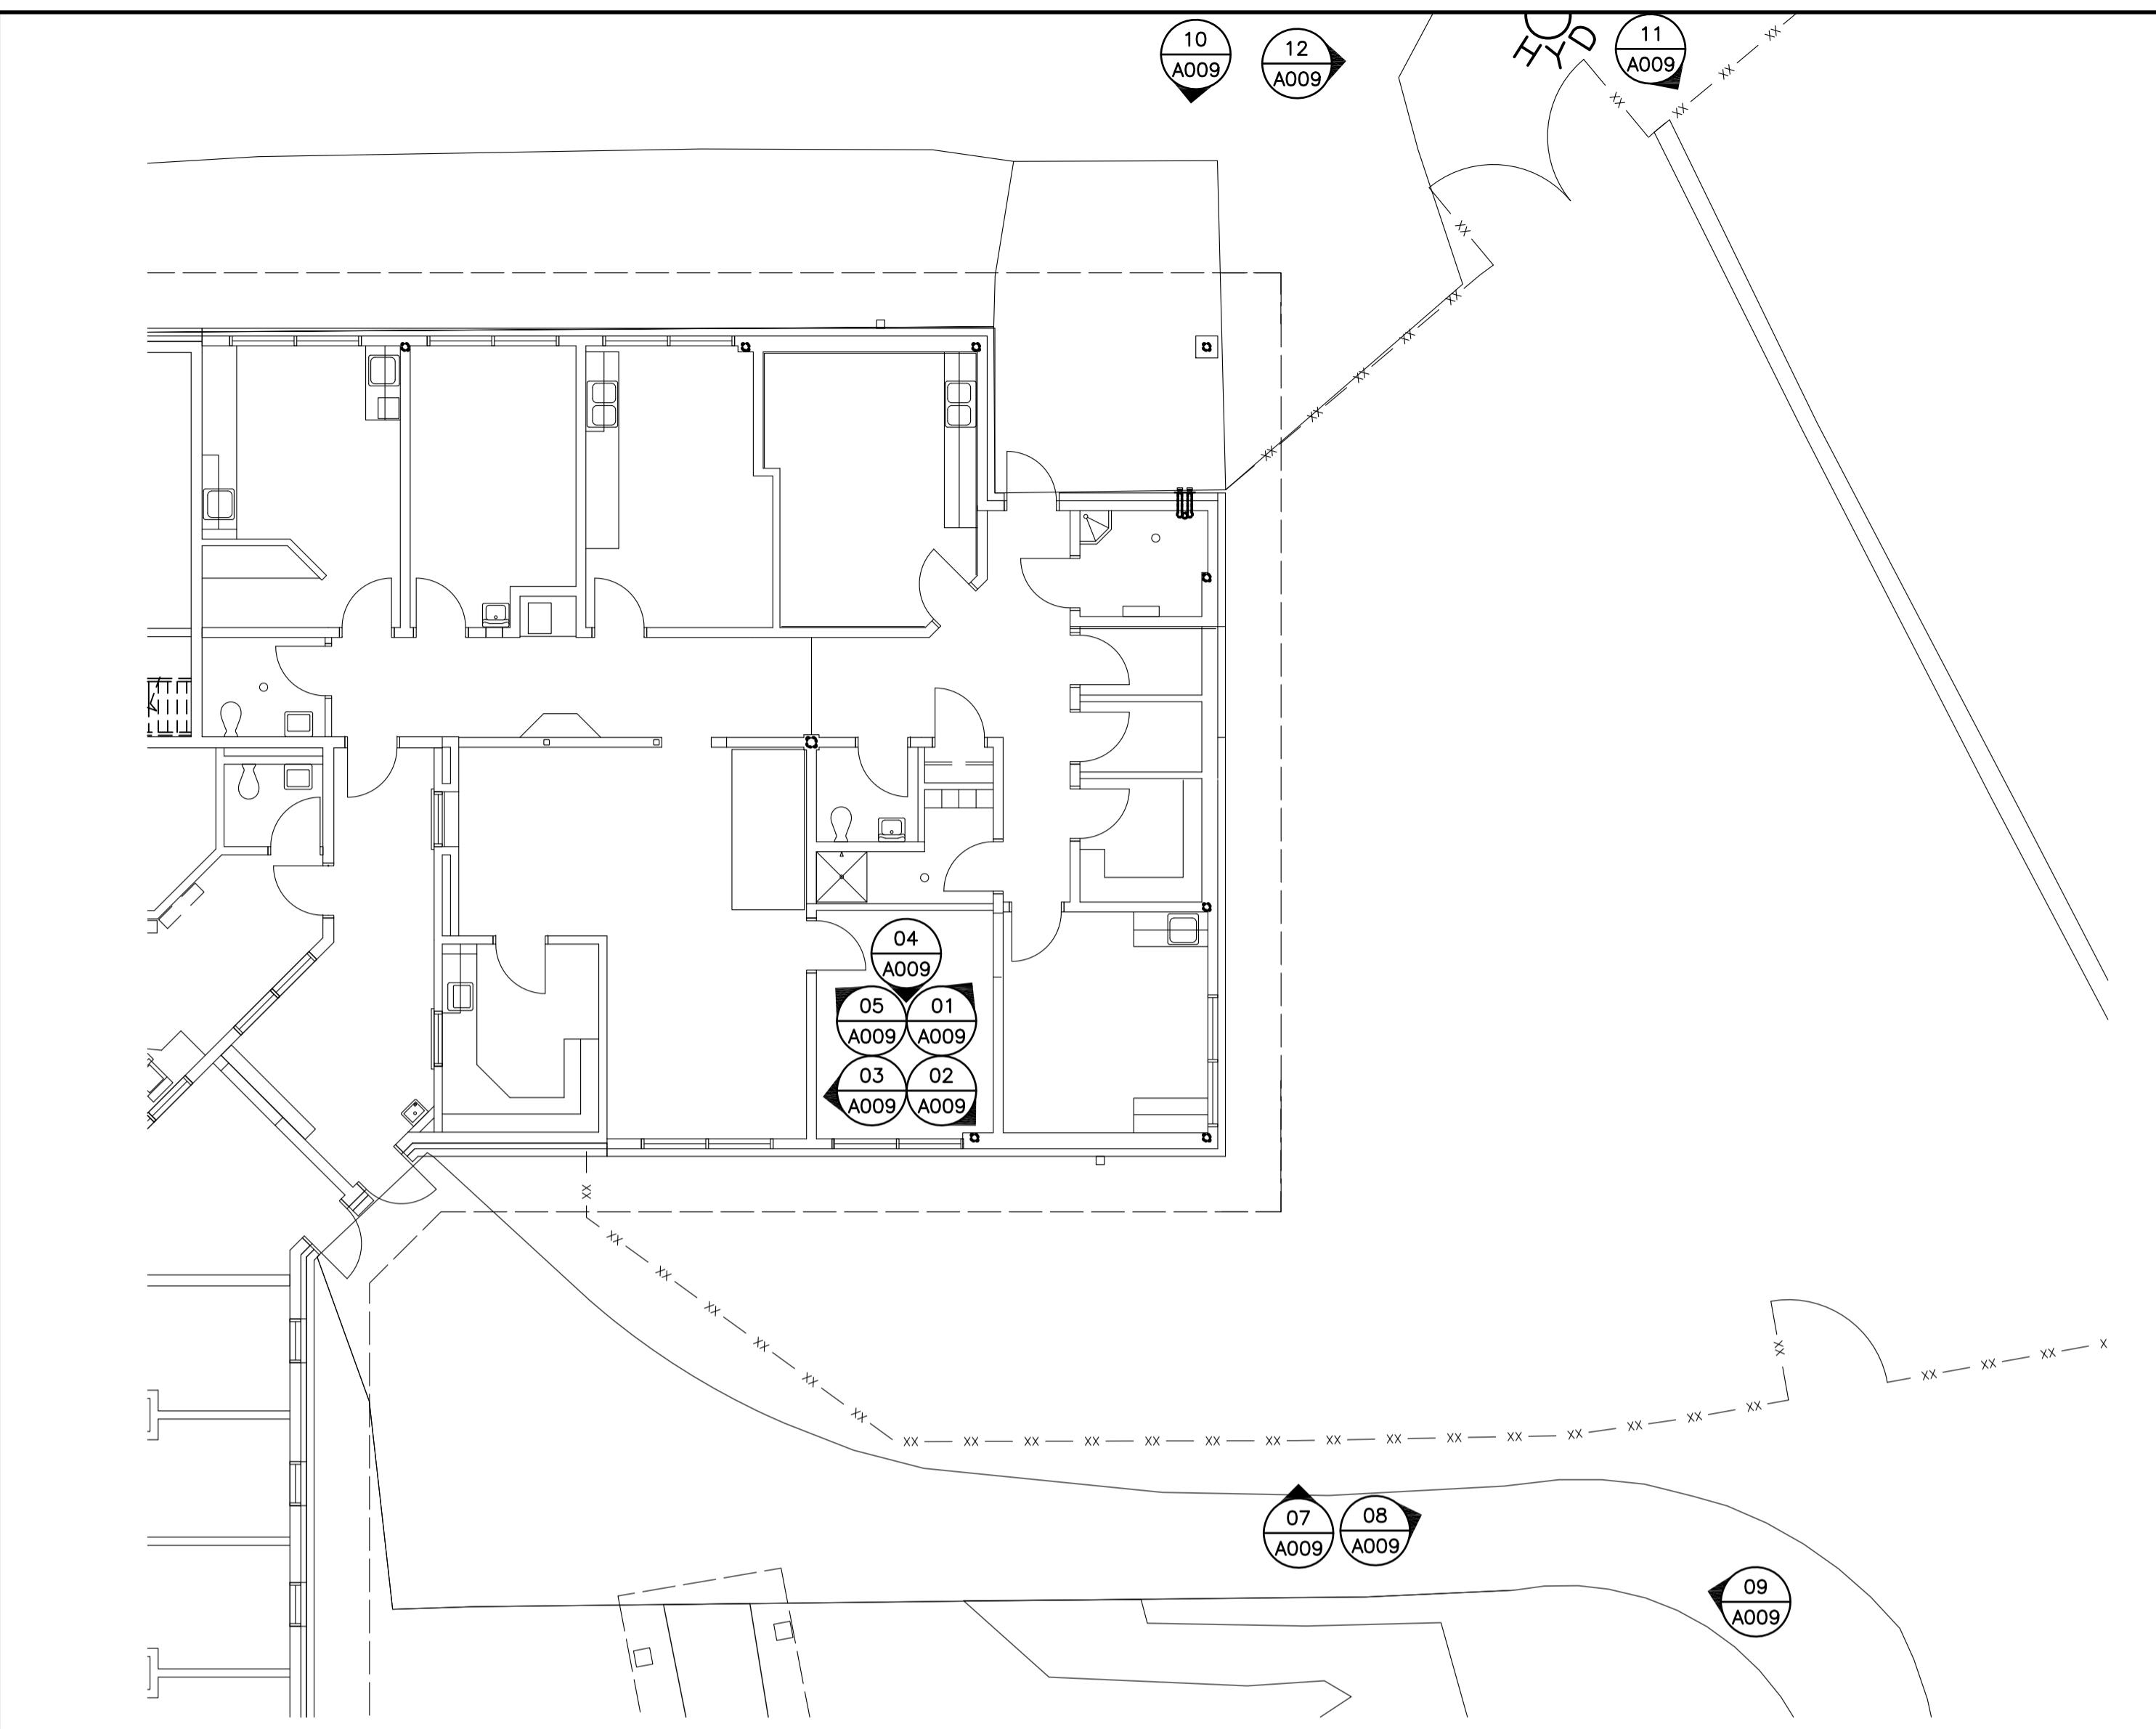

EXTERIOR NORTH
11 A009



EXTERIOR NORTH
12 A009

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MOUNTAIN INSTITUTE HEALTH CARE EXPANSION

Consultant Signature Only
EDWIN BERZINS
Designed by/Concept par
EDWIN BERZINS
Drawn by/Desiné par
BEN MONROE (2017-09-28)
PWGSC Project Manager/Administrateur de Projets TPSGC
DARYL SINCLAIR
Regional Manager, Architectural and Engineering Services
Gestionnaire régionale, Services d'architecture et de génie, TPSGC
PREETPAL PAUL
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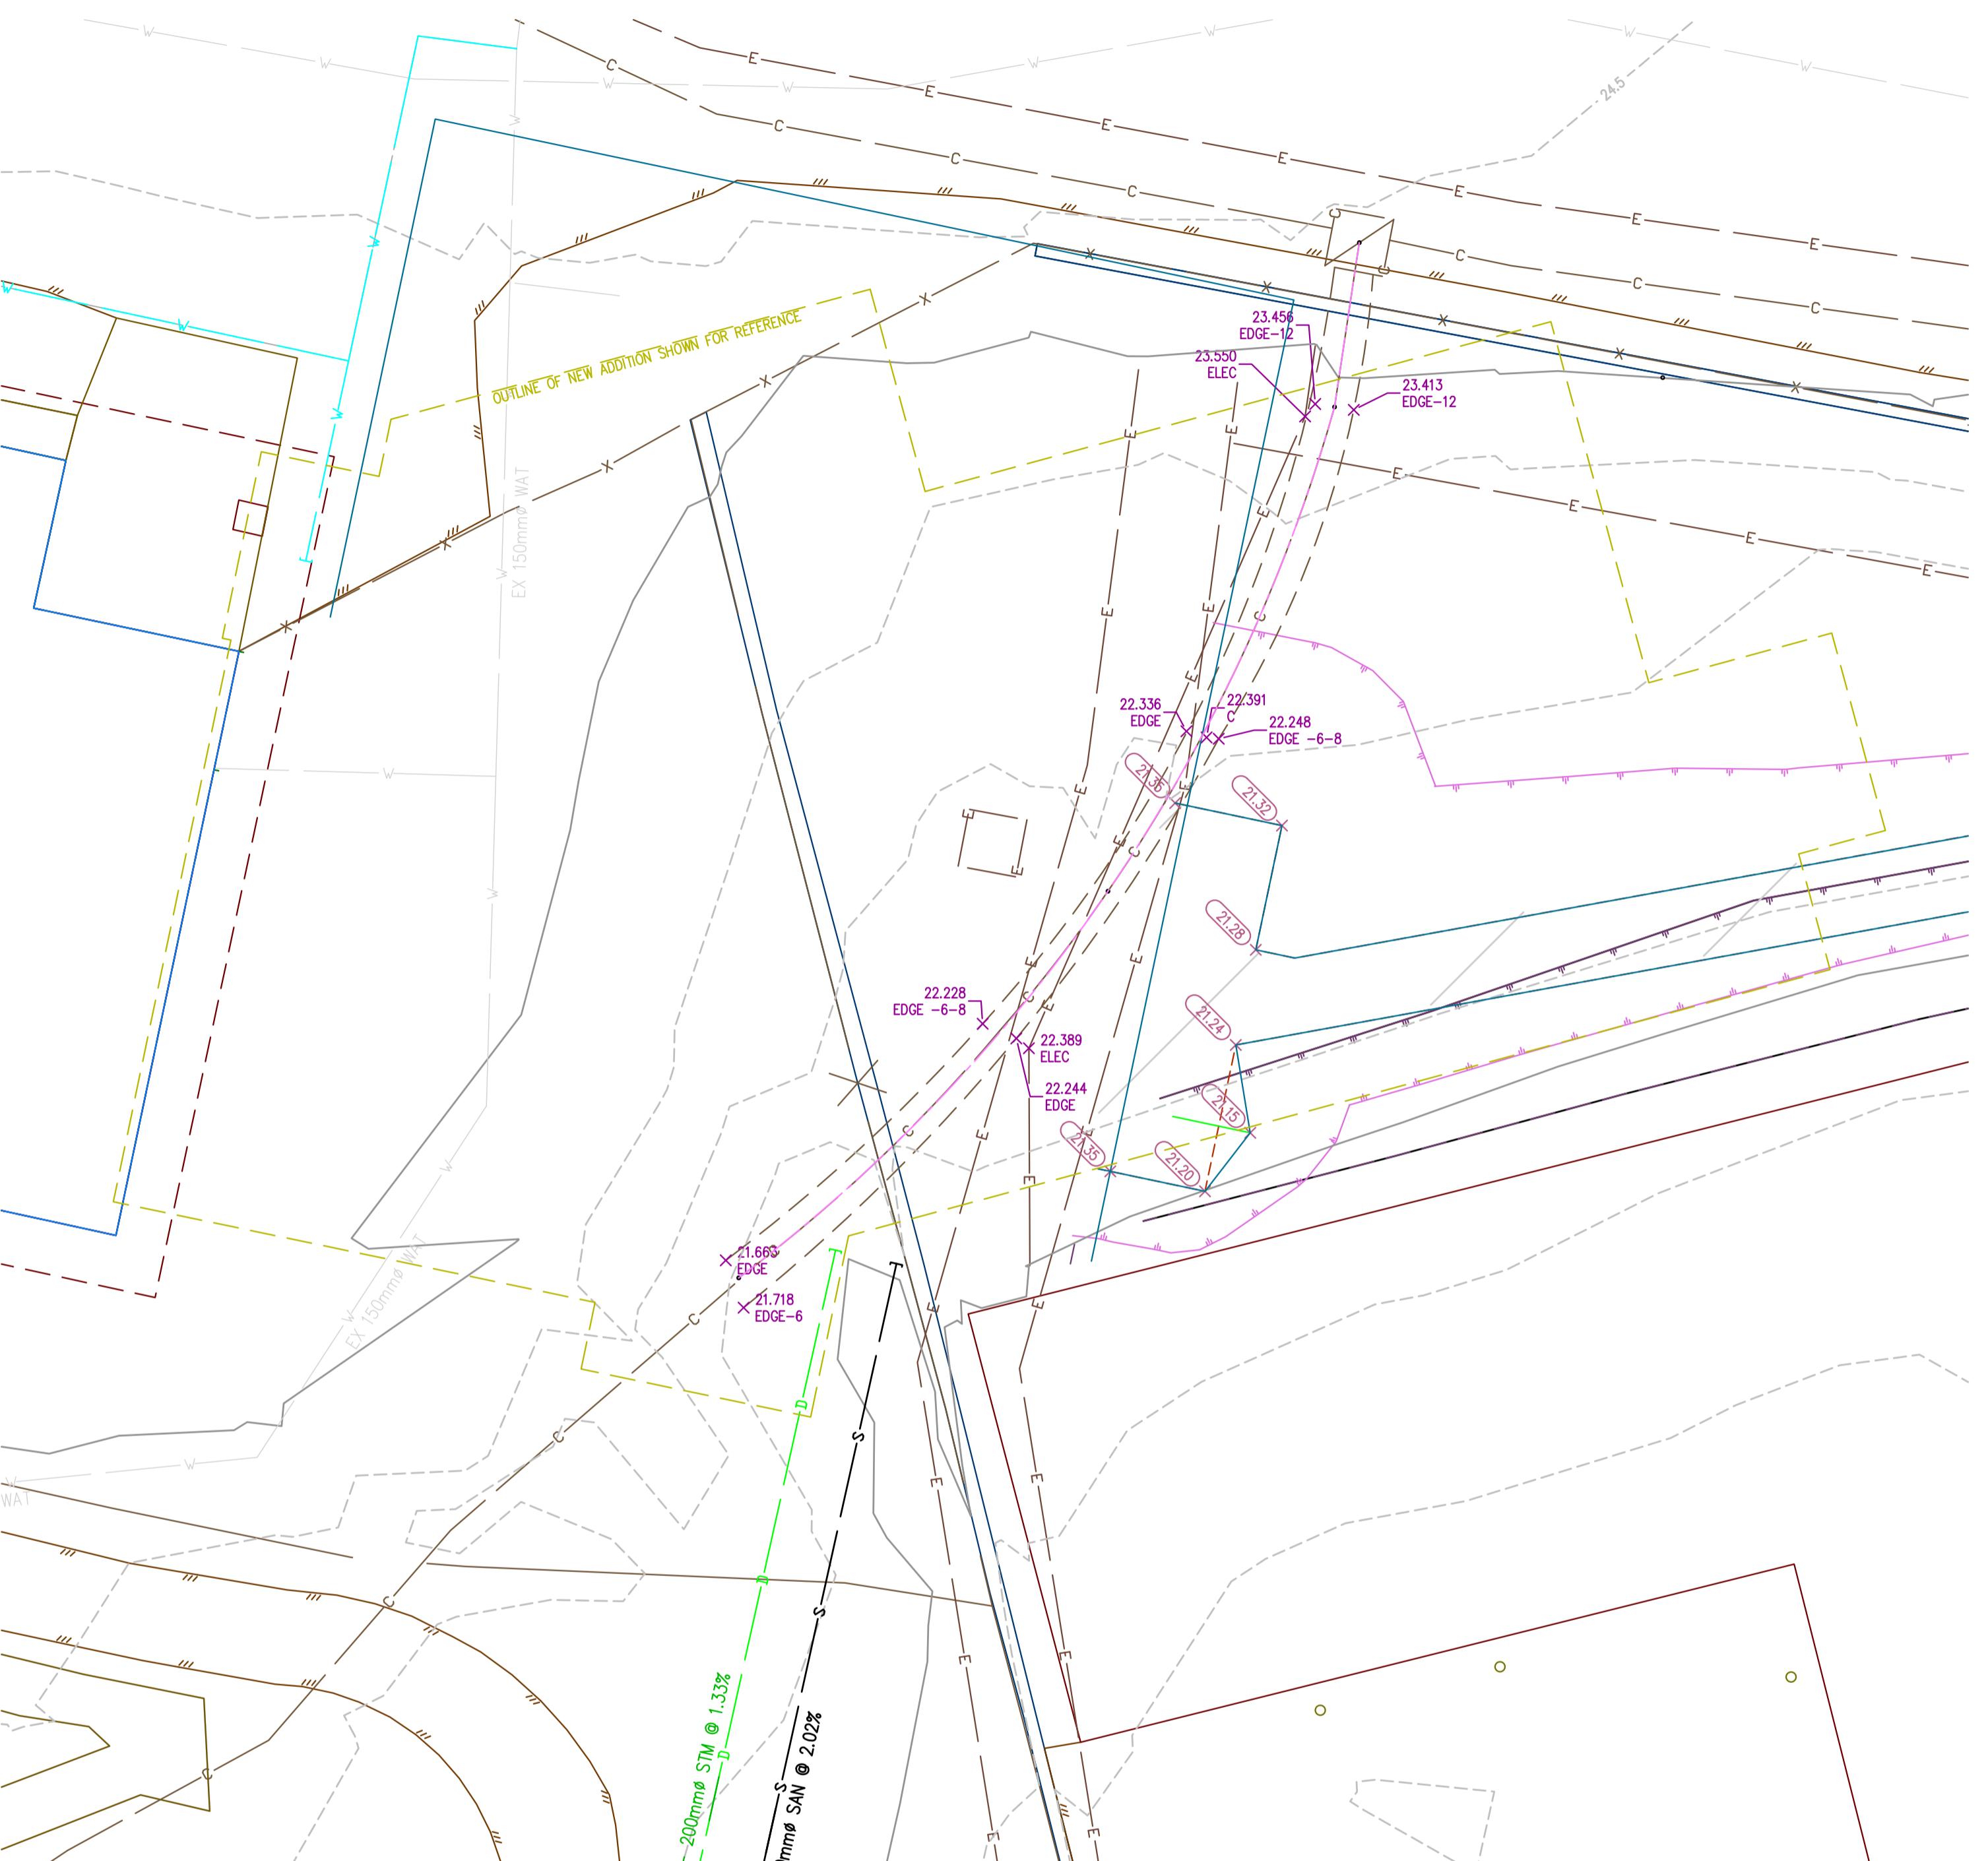
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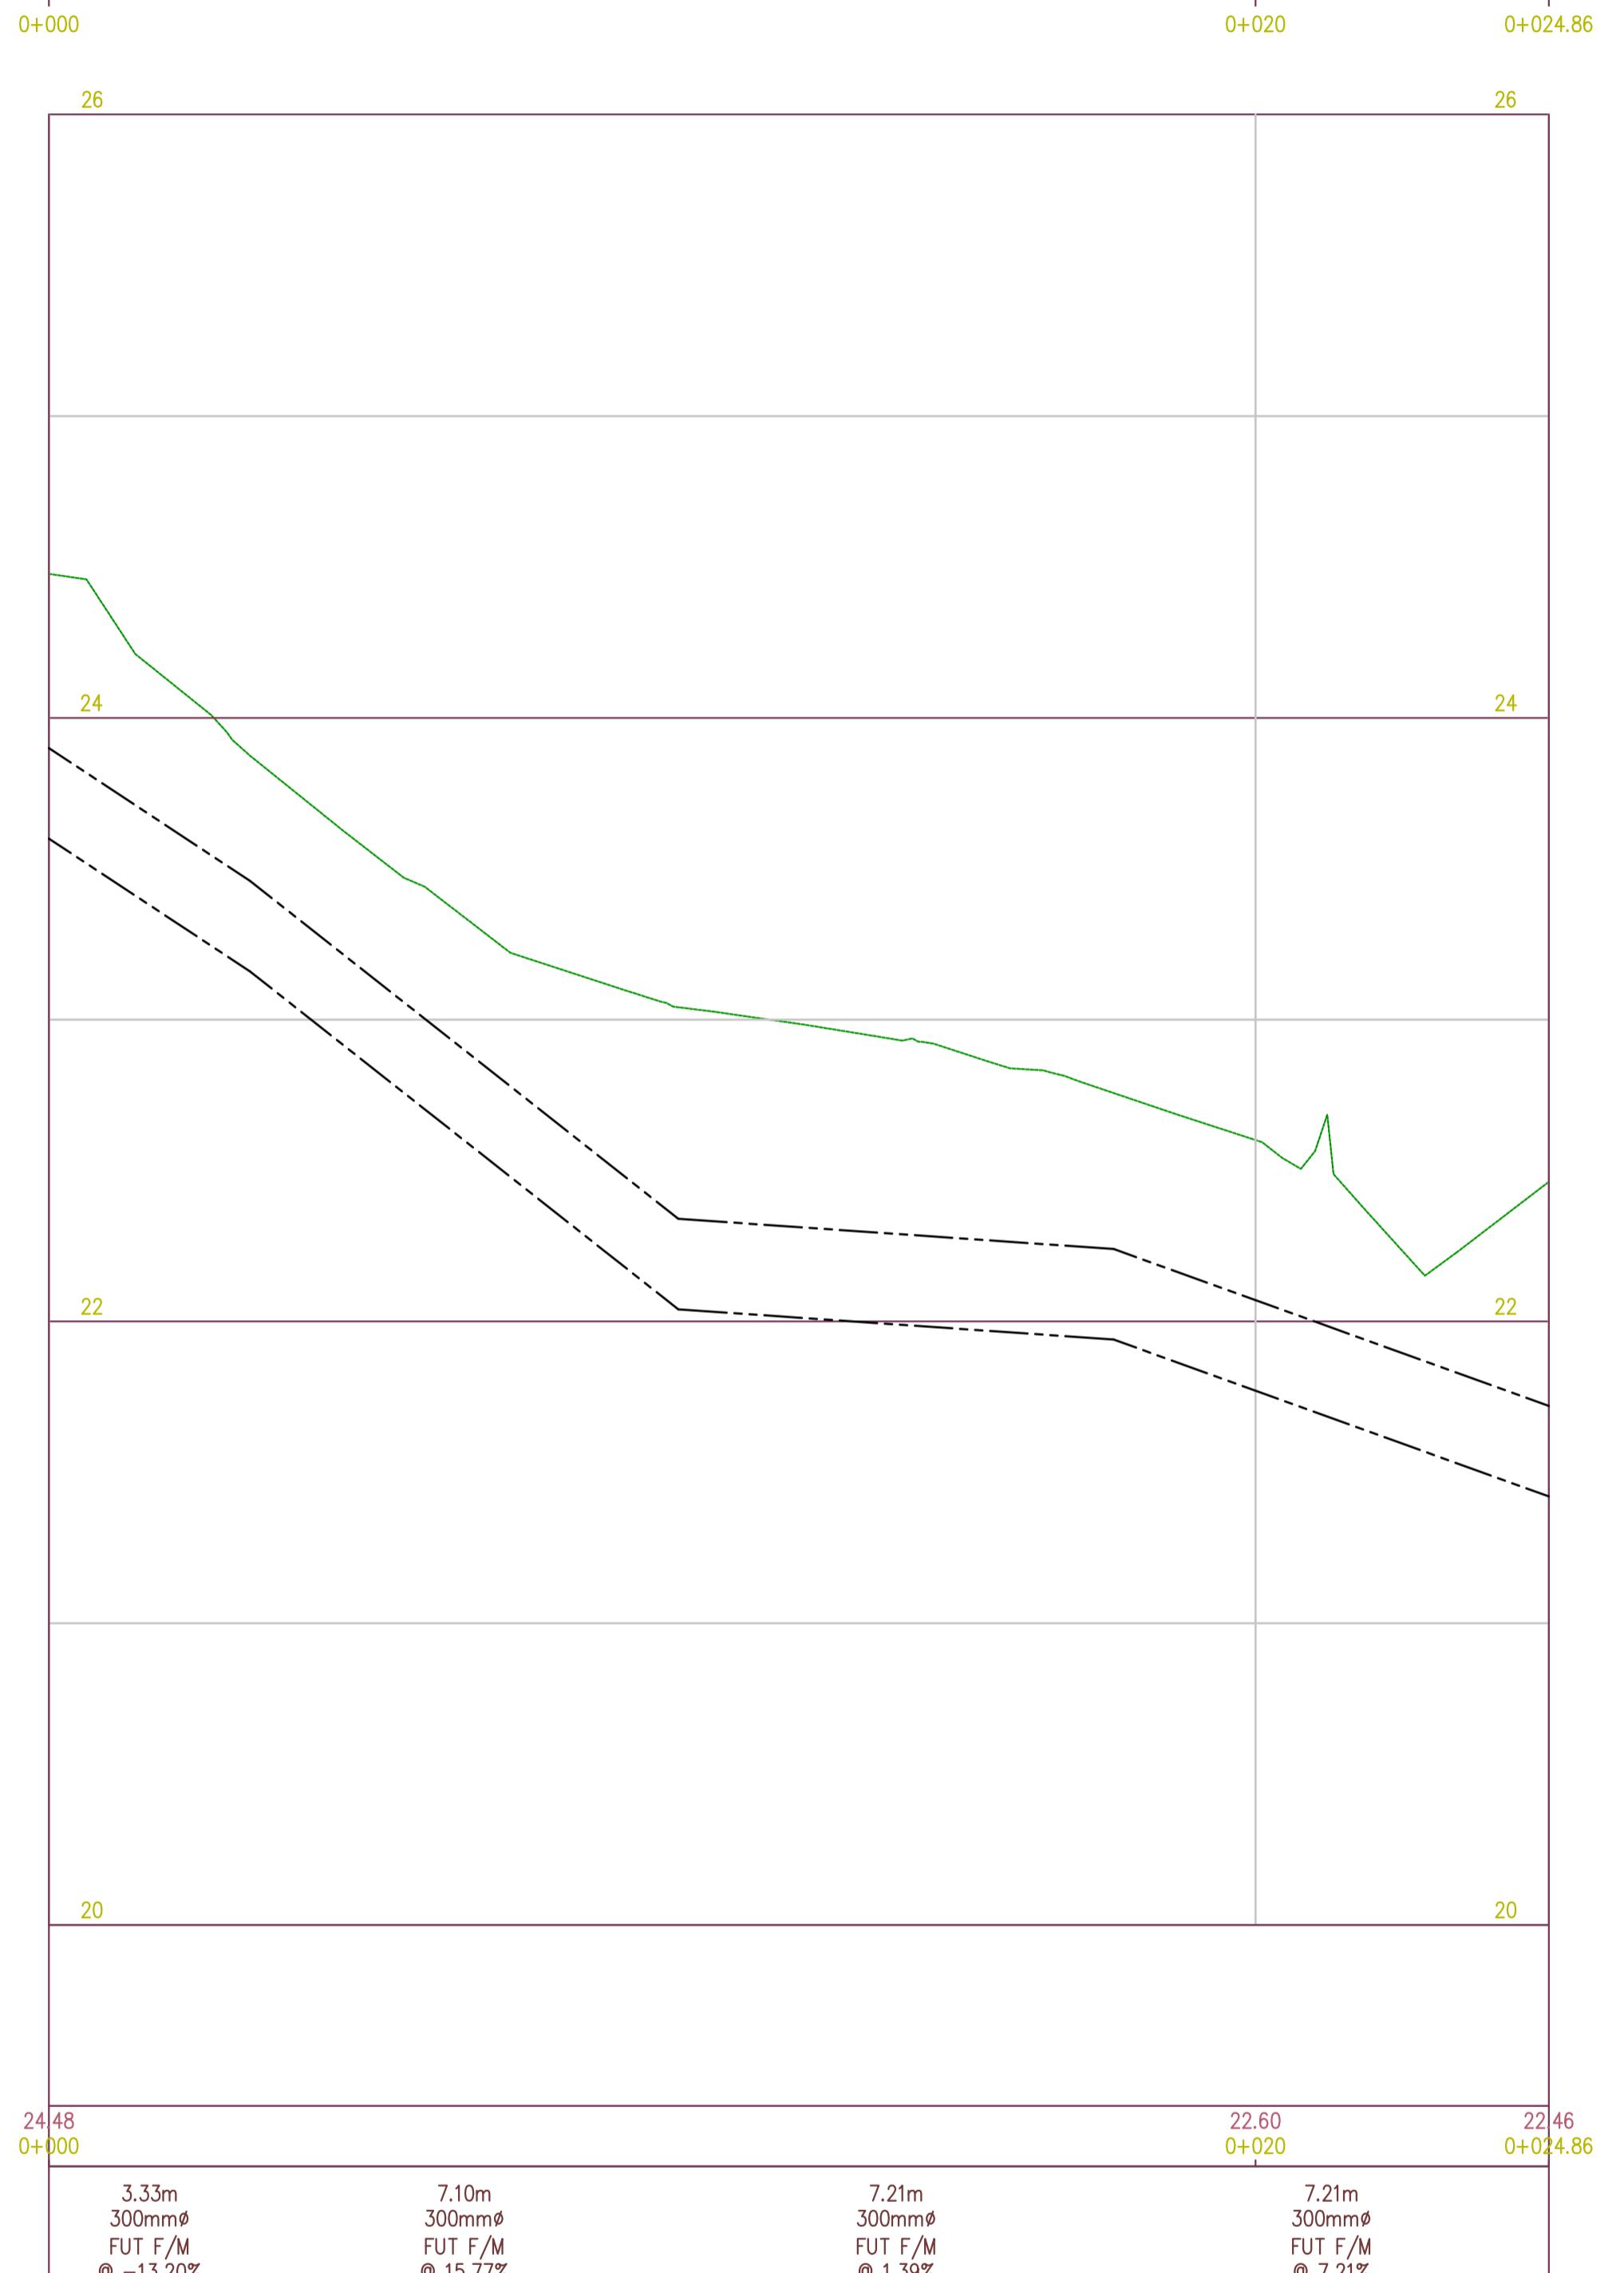
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Public Works and
Services government
Canada
Travaux publics et
Services gouvernementaux
Canada
REAL PROPERTY SERVICES
Pacific Region
SERVICES IMMOBILIERS
Région de l'Atlantique

MGBA
MALLEN GOWING BERZINS
ARCHITECTURE



01 EXISTING ELECTRICAL DUCT BANK LOCATION
A010 1:100



02 EXISTING ELECTRICAL DUCT BANK PROFILE
A010 1:100

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**MOUNTAIN INSTITUTE
HEALTH CARE EXPANSION**

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Designed by/Concept par
EDWIN BERZINS
Drawn by/Dessiné par
-

PWGS Project Manager/Administrateur de Projets TPSGC
TONY TANG
Regional Manager, Architectural and Engineering Services
Gestionnaire régionale, Services d'architecture et de génie, TPSGC
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**EXISTING ELECTRICAL
DUCT BANK PROFILE
(FOR REFERENCE ONLY)**

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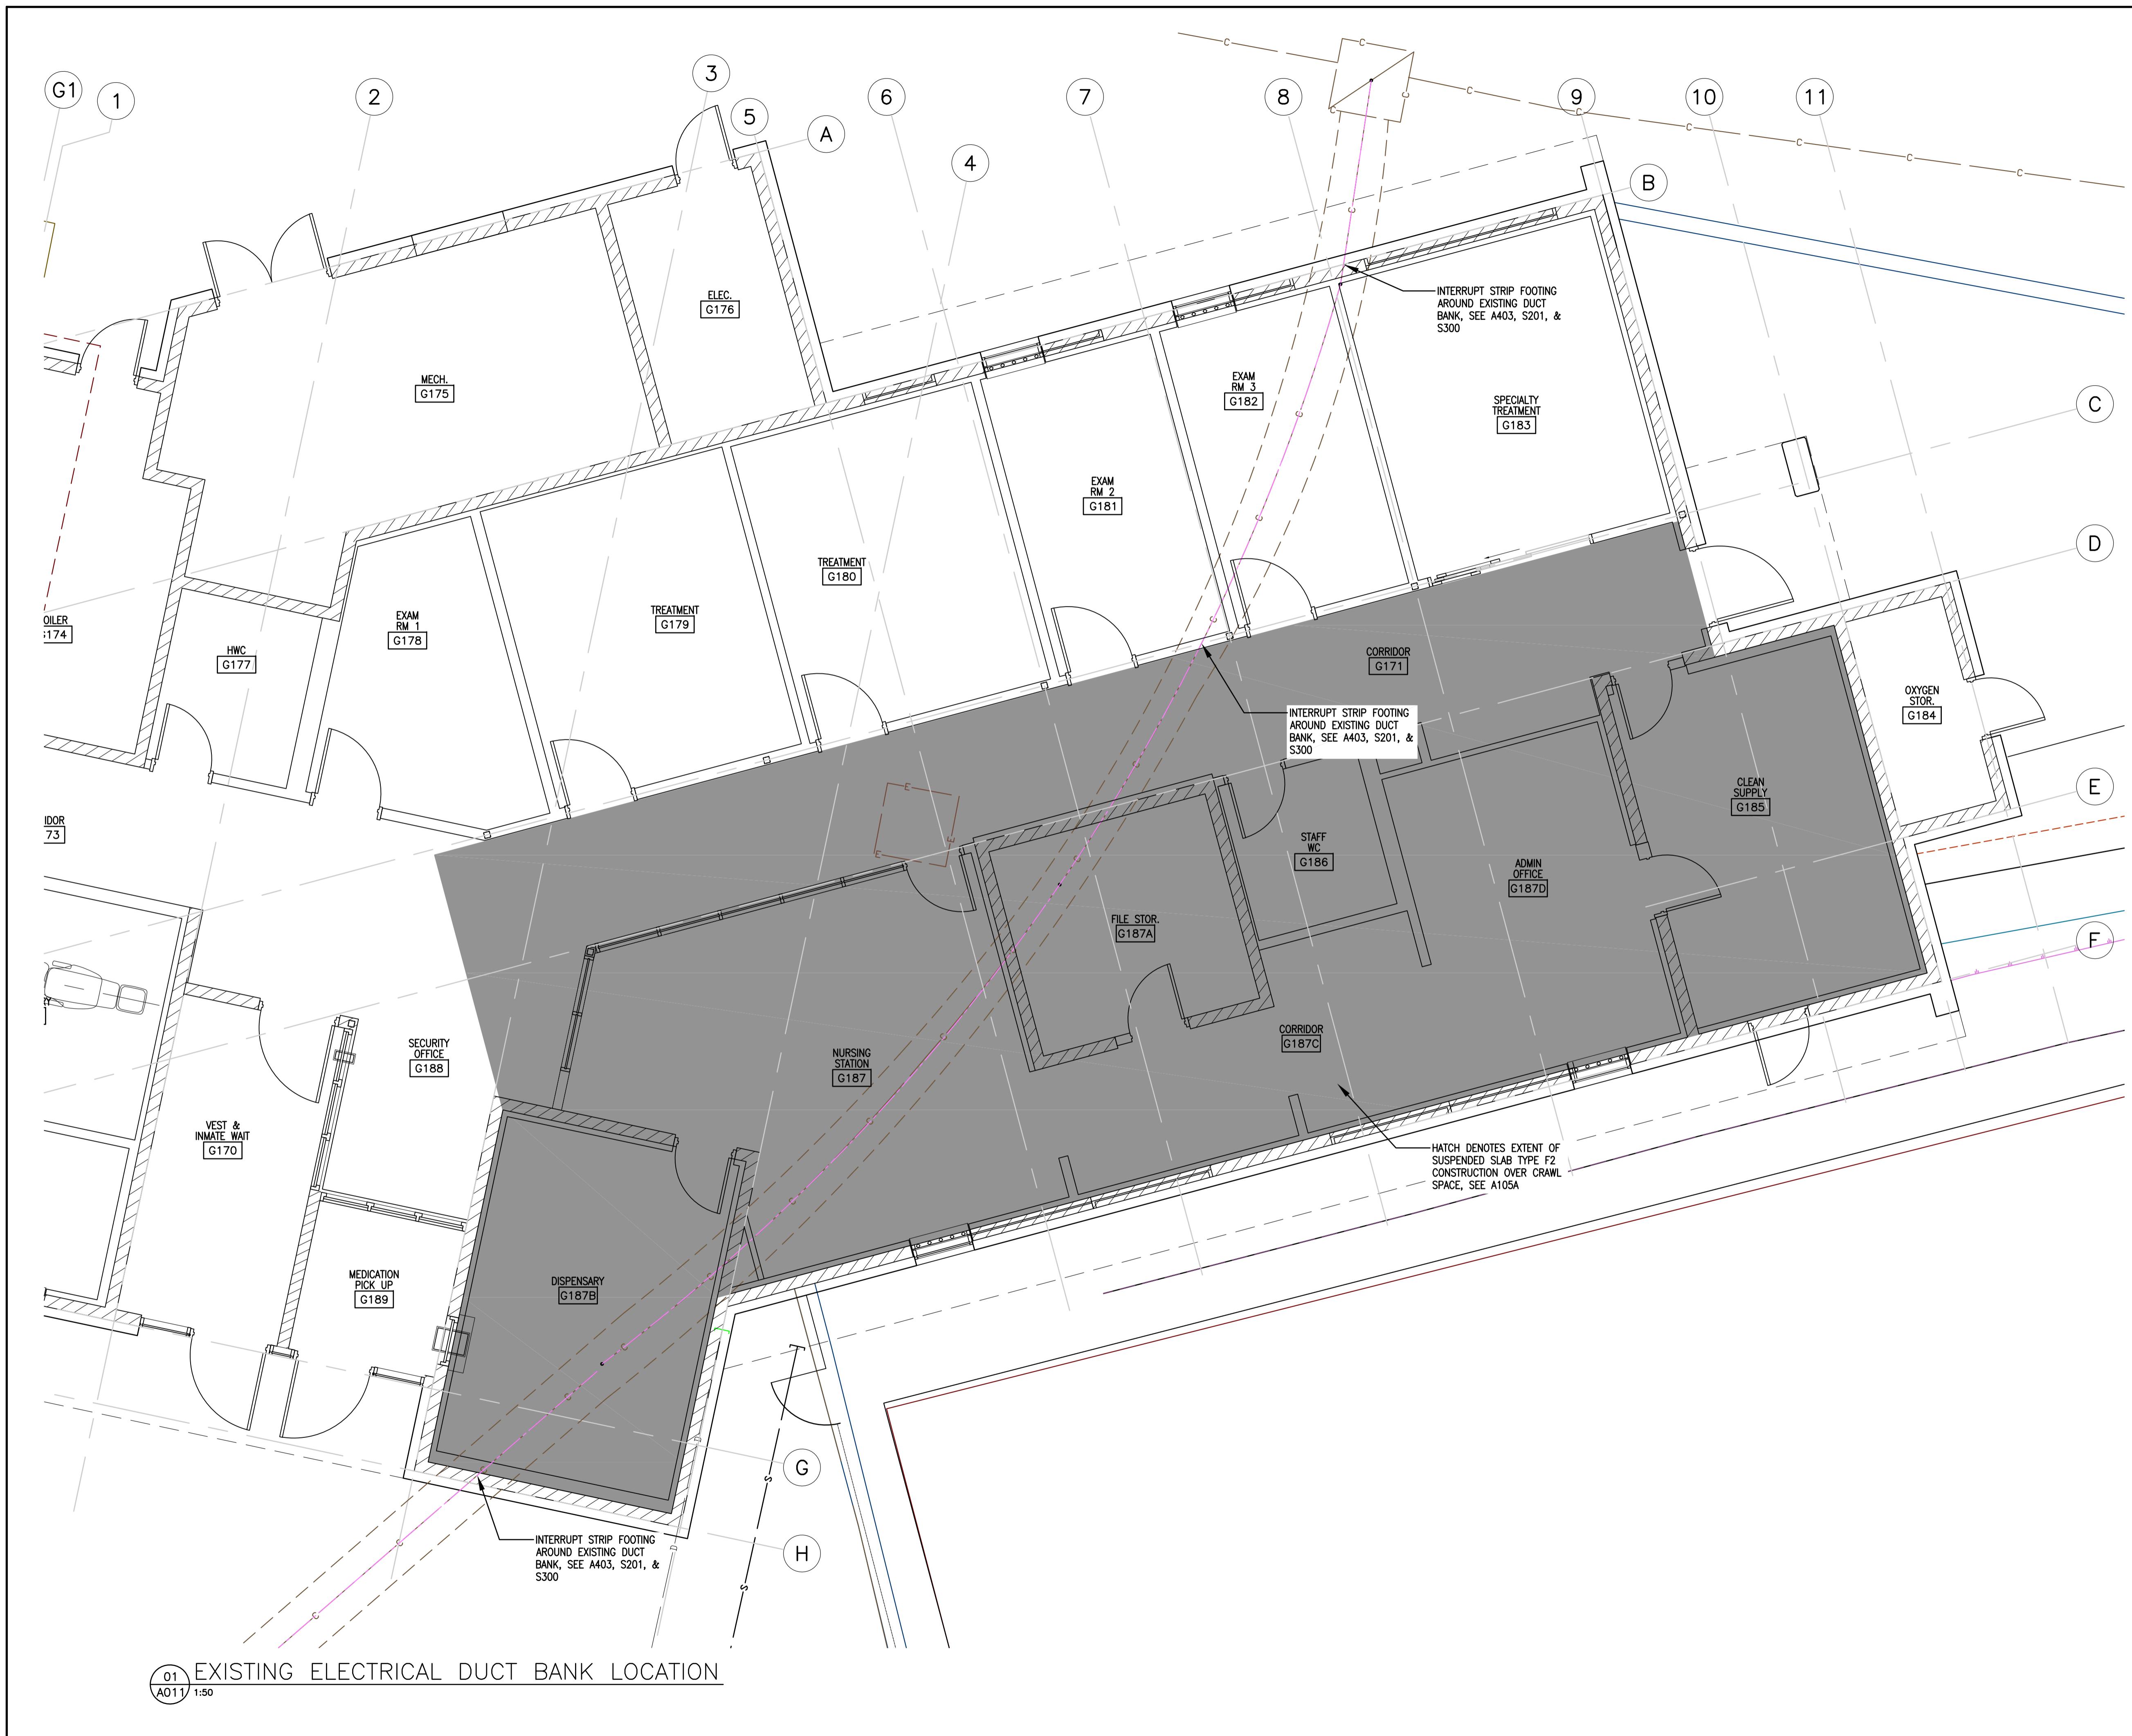
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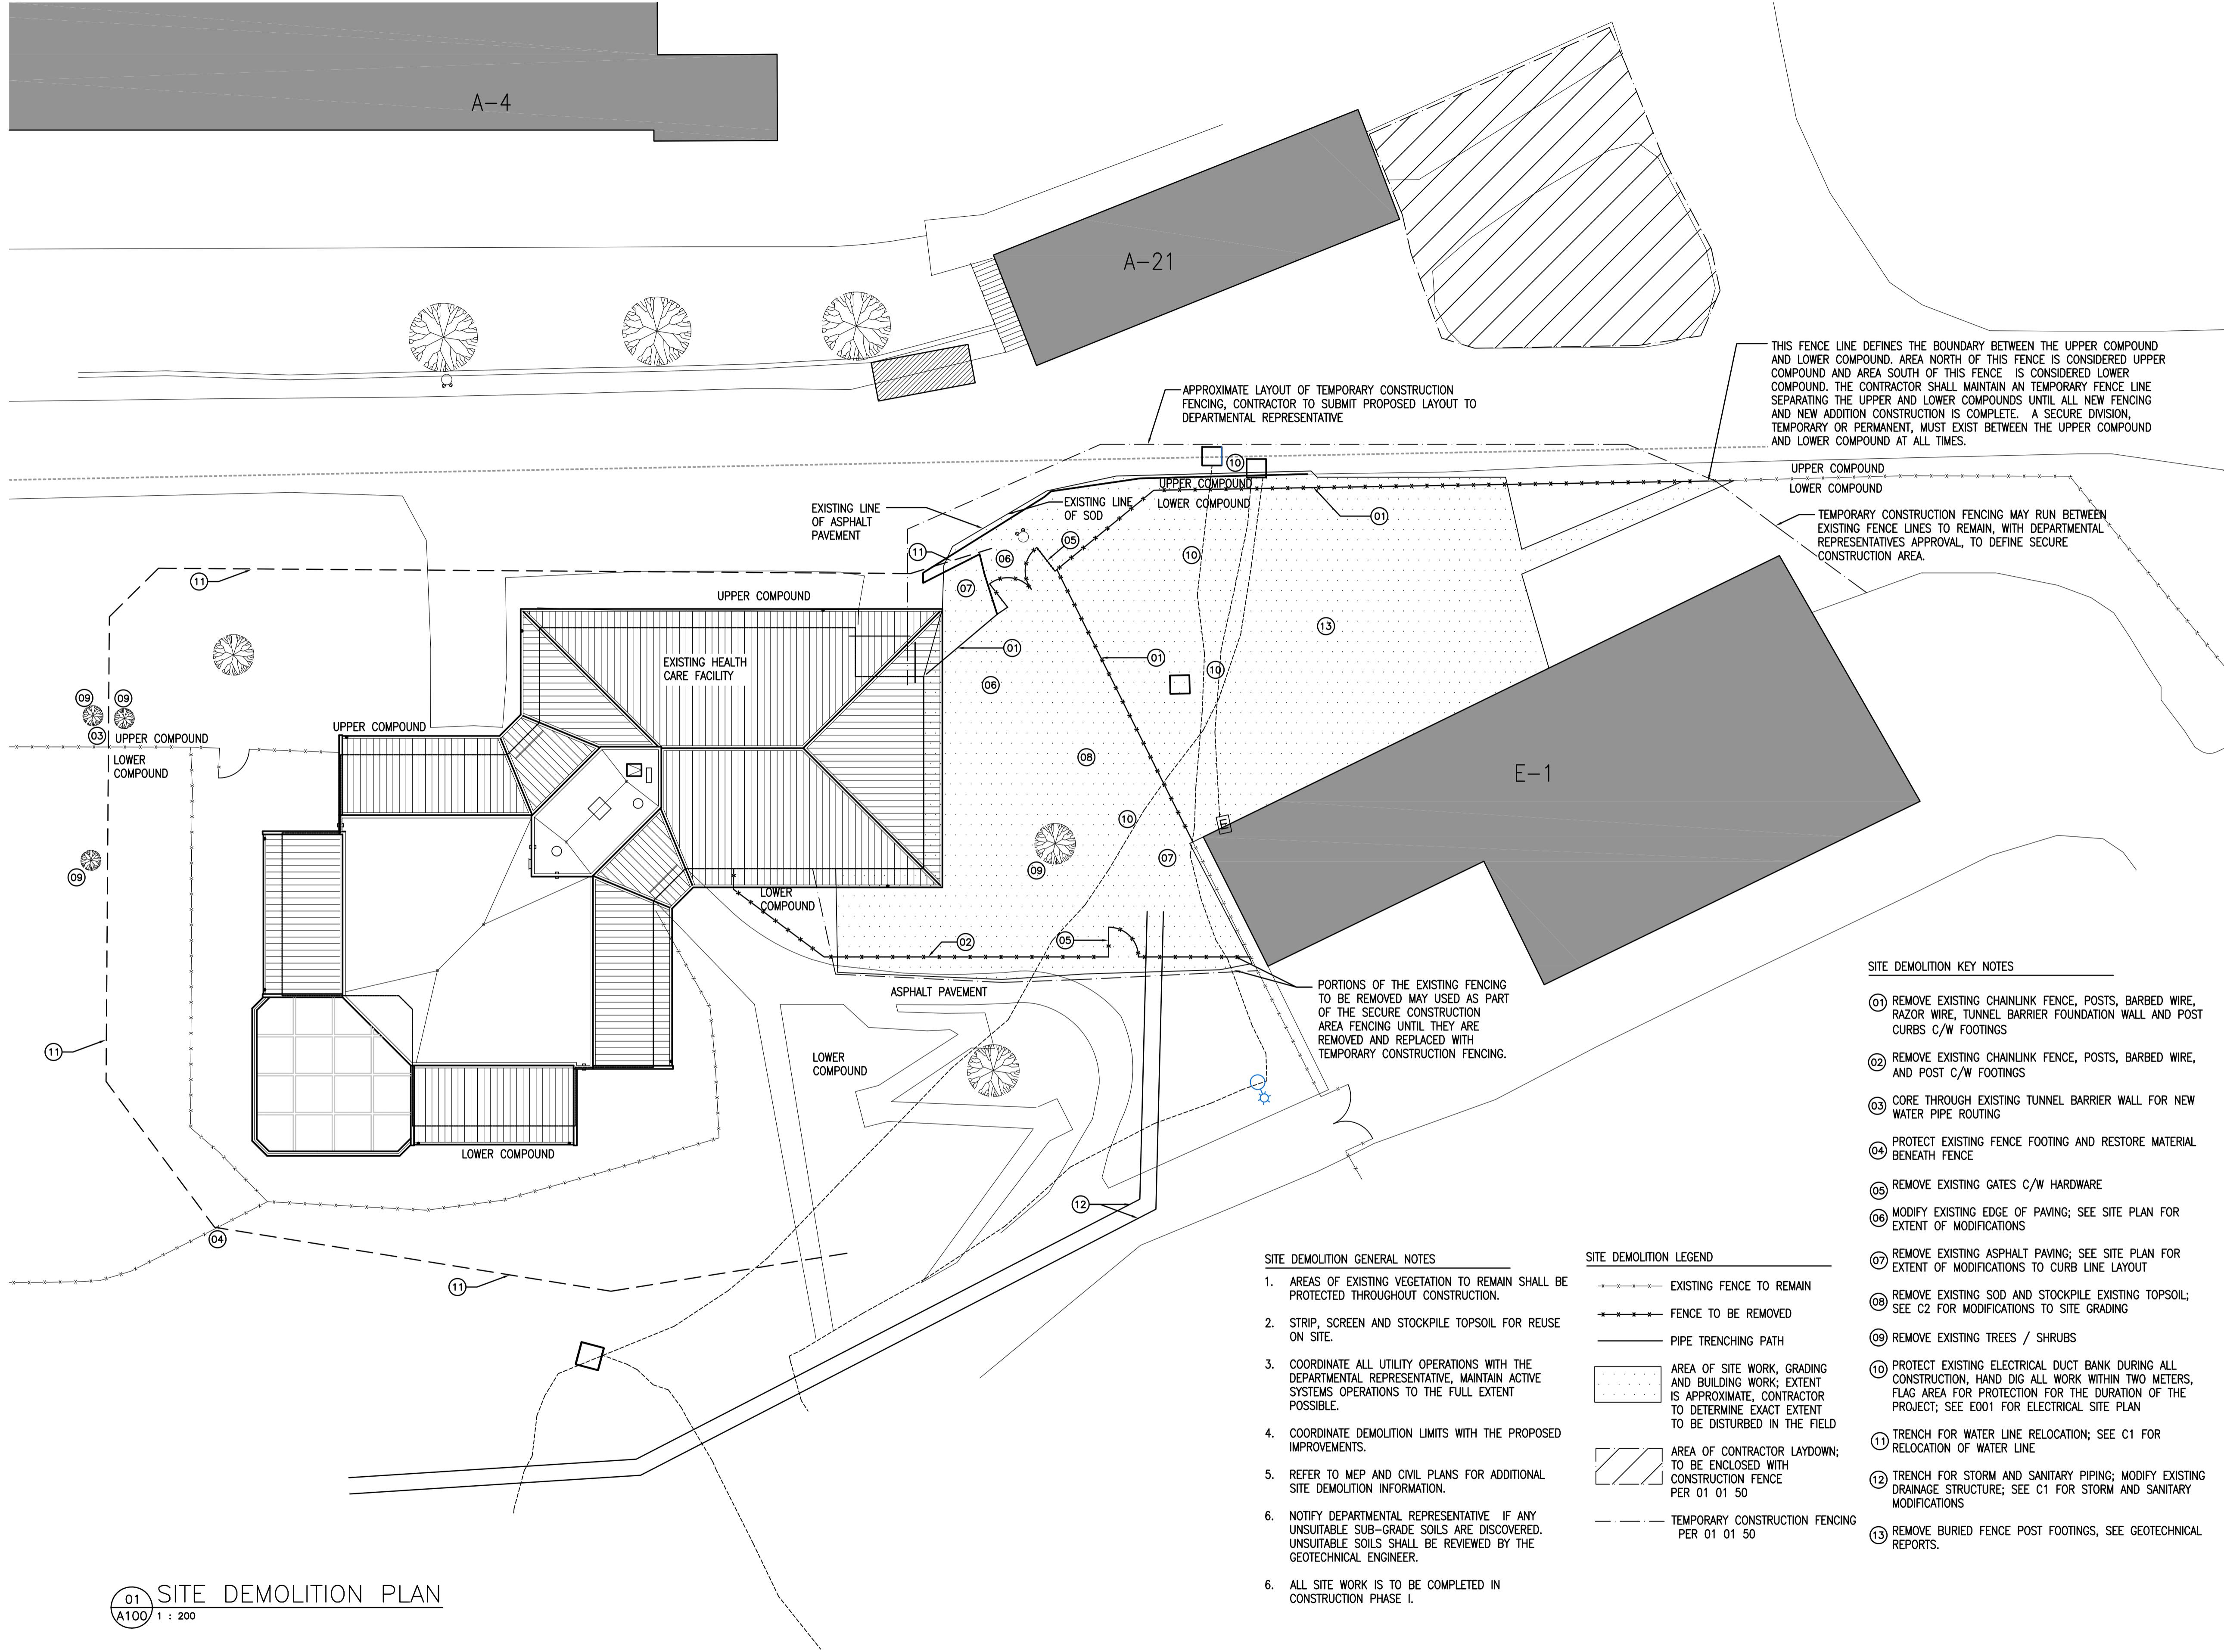
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Drawn by/Dessiné par
-
PWGS Project Manager/Administrateur de Projets TPSGC TONY TANG
Regional Manager, Architectural and Engineering Services PREETPAL PAUL
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ELECTRICAL DUCT BANK AND BUILDING RELATIONSHIP PLAN

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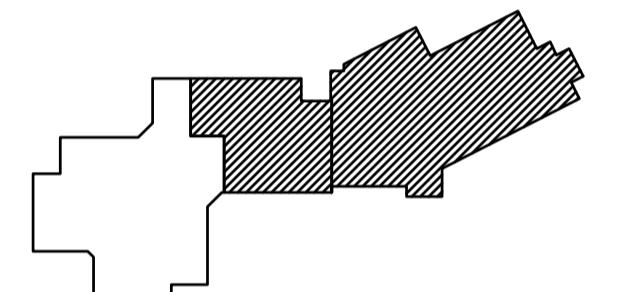
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Drawn by/Dessiné par
NORMANN BAUMANN
PWGSC Project Manager/Administrateur de Projets TPSGC
TONY TANG
Regional Manager, Architectural and Engineering Services
Gestionnaire régionale, Services d'architecture et de génie, TPSGC
PREETPAL PAUL

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SITE DEMOLITION PLAN

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MOUNTAIN INSTITUTE HEALTH CARE EXPANSION

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 EDWIN BERZINS

Drawn by/Dessiné par
 MING HSU (2017-03-28)


PWSSC Project Manager/Administrateur de Projets TPSGC
 TONY TANG

Regional Manager, Architectural and Engineering Services
 Gestionnaire régionale, Services d'architecture et de génie, TPSGC
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SITE PLAN

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GENERAL DEMOLITION NOTES:

1. THE INTENT OF THE DEMOLITION PLANS IS TO SHOW THE GENERAL NATURE OF THE DEMOLITION SCOPE. THE GENERAL CONTRACTOR IS RESPONSIBLE FOR VISITING THE JOB SITE AND VERIFYING THE EXISTING CONDITIONS. THE GENERAL CONTRACTOR SHOULD NOTIFY THE ARCHITECT IMMEDIATELY OF ANY DISCREPANCIES.
 2. COORDINATE AND VERIFY WITH THE DEPARTMENTAL REPRESENTATIVE ALL ITEMS TO BE SALVAGED PRIOR TO DEMOLITION.
 3. PATCH MAKE GOOD ALL SURFACES AFFECTED BY THE DEMOLITION.
 4. PROTECT ALL FINISHES / SURFACES / DEVICES NOT AFFECTED BY THE DEMOLITION.
 5. SEAL OFF AREAS NOT AFFECTED BY THE DEMOLITION (INCLUDING DOORS/WINDOWS). USE COMPLETELY SEALED-OFF, FULL HEIGHT SHEET PLASTIC OR GWB OR WOOD HOARDING.
 6. TEMPORARILY SEAL OFF ALL SUPPLY, RETURN AND EXHAUST GRILLES/DUCT WORK DURING CONSTRUCTION.
 7. TEMPORARILY SEAL-OFF / PROTECT ALL EXISTING EMERGENCY DEVICES TO REMAIN.
 8. CLEAN / VACUUM ALL CONSTRUCTION AREAS AT THE END OF EACH DAY TO MINIMIZE DUST CONTAMINATION OF OTHER AREAS.
 9. CONFIRM ALL DEMOLITION WITH STRUCTURAL, MECHANICAL & ELECTRICAL DWGS. ALL HVAC, ELECTRICAL AND PLUMBING ITEMS REMOVED SHALL BE CAPPED AND IDENTIFIED. REMOVE ALL ABANDONED ELECTRICAL / DATA LINES, PLUMBING AND HVAC RUNS.
 10. RELOCATE AS NECESSARY ANY PIPING, ELECTRICAL CONDUIT, OR OTHER MECHANICAL OR ELECTRICAL DEVICES EXPOSED WHEN EXISTING WALLS ARE DEMOLISHED.
 11. ALL OPENINGS WHERE EXISTING DUCTS, VENTS, PIPING OR ELECTRICAL CONDUIT HAVE BEEN REMOVED SHALL BE FILLED OR PATCHED TO MATCH THE EXISTING OR NEW FINISH DESIGNATION, INCLUDING FIRE RATINGS.
 12. FOR ADDITIONAL DEMOLITION SCOPE REVIEW ALL SITE, STRUCTURAL, CIVIL, MECHANICAL, FIRE PROTECTION, PLUMBING, AND ELECTRICAL DRAWINGS AND SPECIFICATIONS.
 13. HAZARDOUS SUBSTANCES SHALL BE DISPOSED OF IN ACCORDANCE WITH THE REGULATIONS OF THE MINISTRY OF THE ENVIRONMENT.
 14. SCAN THE AREA OF CONCRETE SLAB PRIOR TO ANY DEMOLITION OR CUTTING OF CONCRETE SLABS.
 15. REMOVE ALL ABANDONED ANCHOR BOLTS & EMBEDDED ITEMS IN CONCRETE FLOORS THAT PROTRUDE ABOVE THE CONCRETE FLOOR FINISH.
 16. PROVIDE NEW SUPPORT RACK OR HANGERS FOR ABOVE CEILING ITEMS WHICH WERE ORIGINALLY SUPPORTED BY REMOVED WALLS.
 17. REMOVE EXISTING FINISHES AS REQUIRED BY THE WORK INCLUDING ANY MECHANISM TO HOLD IN PLACE SUCH AS GLUE AND/OR FASTENERS. PREPARE SURFACES TO RECEIVE NEW FINISHES PER MANUFACTURERS RECOMMENDATIONS. SEE FINISH SCHEDULE.
 18. ALL EMERGENCY EXITS TO REMAIN UNOBSTRUCTED AND FUNCTIONAL DURING CONSTRUCTION.
 19. REMOVE AND TEMPORARILY STORE ALL BLINDS. REPAIR AS REQUIRED, CLEAN AND PREPARE FOR REINSTALLATION AT END OF CONSTRUCTION.
 20. REMOVE AND TEMPORARILY STORE ALL ITEMS THAT WILL BE RE-USED SUCH AS SIGNAGE, EQUIPMENT, FURNITURE, ACCESSORIES. CLEAN AND PREPARE FOR REINSTALLATION AT END OF CONSTRUCTION.
 21. PATCH MAKE GOOD ALL WALLS AFFECTED BY THE REMOVAL OF EQUIPMENT OR DEVICES.
 22. REMOVE EXISTING ELECTRICAL FIXTURES IN THE AREAS OF DEMOLITION INDICATED AND TURN OVER TO OWNER.
 23. EXISTING STRUCTURE TO BE SHORED UP AS REQUIRED DURING DEMOLITION AND NEW CONSTRUCTION
 - ESPECIALLY IN THE EXISTING BRACE BAY LOCATION
 - REFER TO STRUCTURAL DOCUMENTS FOR FULL EXTENT OF WORK REQUIRED
 24. REMOVE AND PRESERVE FOR REUSE ALL WALL MOUNTED EQUIPMENT AND SIGNAGE WHERE WORK IS BEING DONE AND TO PROPERLY PAINT WALLS, OTHERWISE EQUIPMENT SHALL REMAIN.

(THE FOLLOWING ITEMS ARE THE RESPONSIBILITY OF THE CONTRACTOR. KEYED ITEMS ARE TO ASSIST IN CONVEYING CONSTRUCTION EXTENT. WORK IS NOT

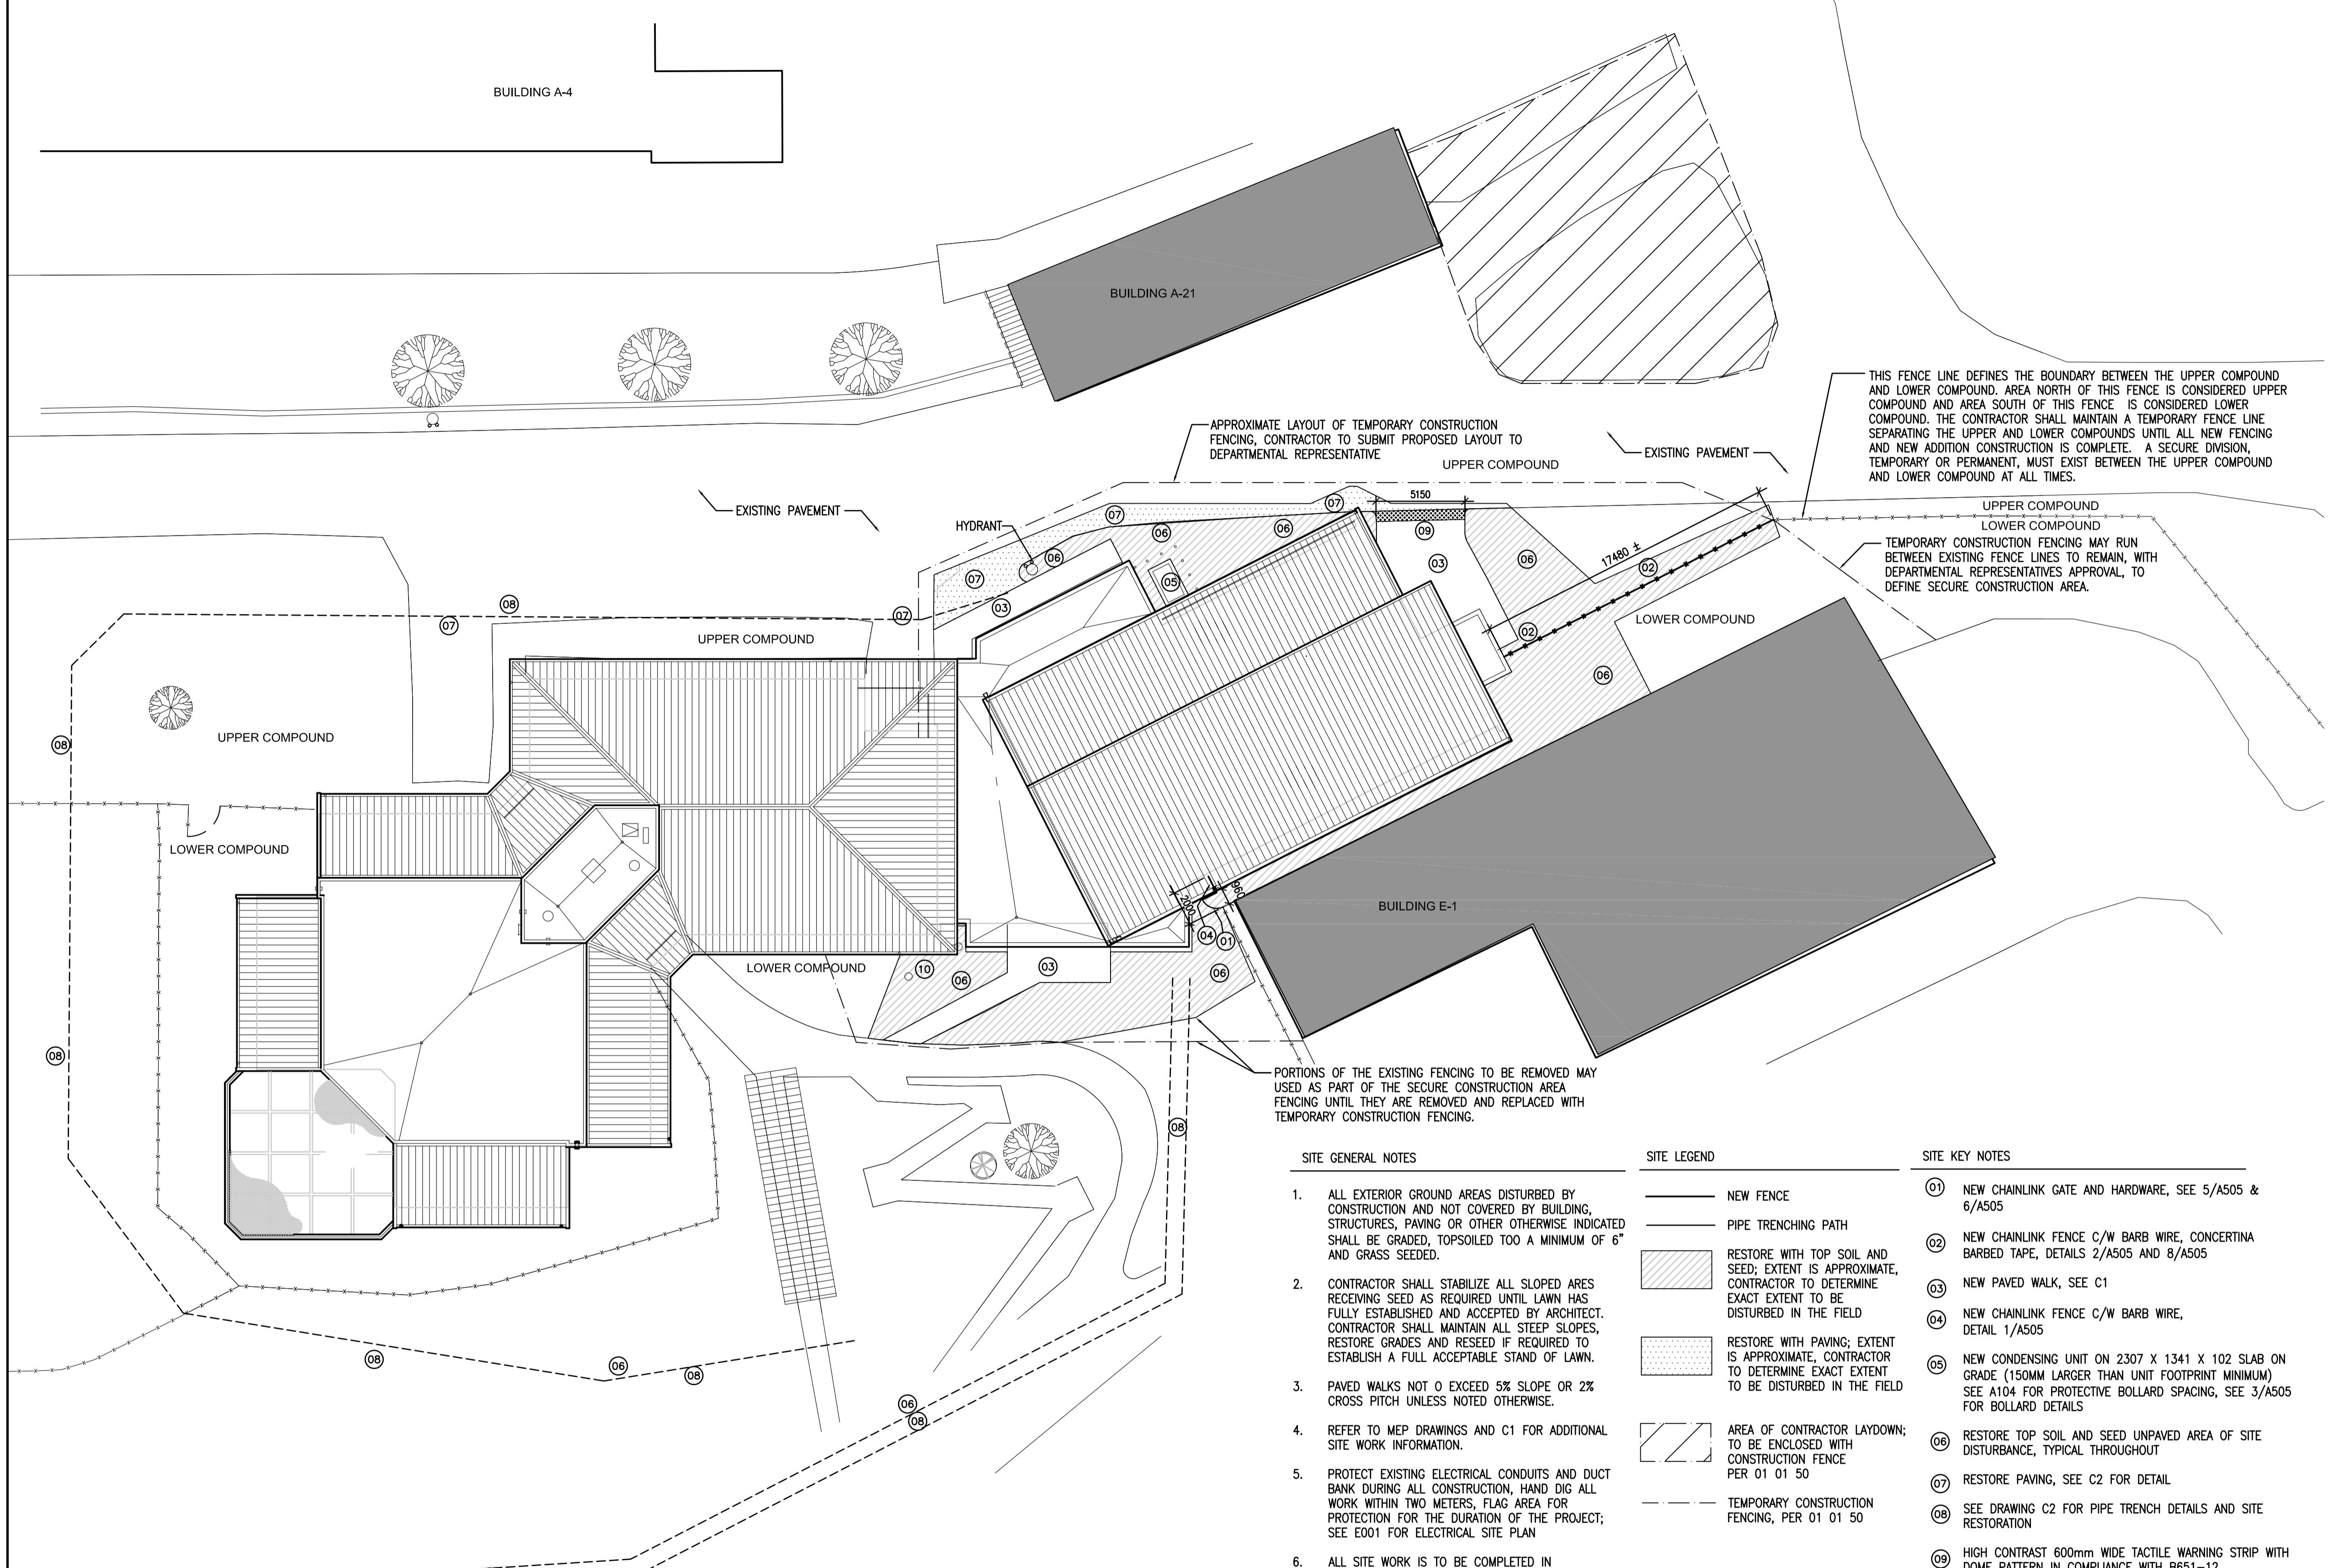LIMITED TO ITEMS TAGGED.)

- O1** REMOVE EXISTING EXTERIOR CLADDING TO THE EXTENT SHOWN, RETAIN AND PRESERVE ADEQUATE MATERIAL FOR PATCHING AND REINSTALLATION AS INDICATED.

O2 REMOVE EXISTING SOFFIT, SEE 1/A401 FOR DETAIL

O3 REMOVE EXISTING FASCIA AND GUTTER ASSEMBLY, SEE 1/A401 FOR DETAIL, SEE ROOF PLAN FOR EXTENT

O4 REMOVE EXISTING MASONRY COLUMN ENCLOSURE COMPLETE

PHASE 2 DEMOLITION KEY NOTES

- 01 REMOVE COMPLETE EXISTING WALL ASSEMBLY TO THE EXTENT SHOWN
 - 02 REMOVE EXISTING DOOR & FRAME. TURN OVER TO DEPARTMENTAL REPRESENTATIVE
 - 03 REMOVE EXISTING WINDOW, FRAME & SECURITY BARS. TURN OVER TO DEPARTMENTAL REPRESENTATIVE
 - 04 REMOVE EXISTING MILLWORK
 - 05 REMOVE EXISTING PLUMBING FIXTURES, RECONFIGURE PLUMBING AND/OR CAP OFF EXISTING LINES AS PER PLUMBING DRAWINGS
 - 06 REMOVE COMPLETE CEILING ASSEMBLY.
REFER TO RCP
 - 07 REMOVE PARTIAL CEILING ASSEMBLY.
REFER TO RCP
 - 08 REMOVE EXISTING FLOORING MATERIAL, BASE, AND ADHESIVE
 - 09 REMOVE EXISTING DRYWALL
 - 10 REMOVE EXISTING HIGH DENSITY STORAGE ROLLING SHELVES AND RAISED PLATFORM
 - 11 REMOVE EXISTING SLAB FOR PLUMBING TRENCHING; REFER TO PLUMBING DRAWINGS AND CONFIRM EXACT EXTENT ON SITE
 - 12 REMOVE EXISTING COUNTER & DEAL TRAYS;
PREPARE FRAME FOR WELDED PLATE
 - 13 LOW WALL BRACING SUPPORTS TO REMAIN TO BE INTEGRATED INTO NEW WALL ASSEMBLY.
 - 14 REMOVE EXISTING PRIVACY CURTAIN AND TRACK.
 - 15 REMOVE ROLLING STEEL SHUTTER DOOR COMPLETE
 - 16 REMOVE EXISTING WALL TILE
 - 17 REMOVE EXISTING FIXTURES AND ACCESSORIES AND PRESERVE FOR REINSTALLATION
 - 18 REMOVE EXISTING BENCH.
 - 19 EXISTING SHOWER TO REMAIN
 - 20 SAWCUT OPENING IN EXISTING WALL 2400mm IN HEIGHT. SELECTIVE DEMOLITION OF THE EXISTING SECURE TWO HOUR SEPARATION WALL SHOULD ONLY OCCUR WHEN NEW DOORS AND FRAMES AND WALL CAN BE IMMEDIATELY INSTALLED TO MAINTAIN SECURITY CONTINUITY

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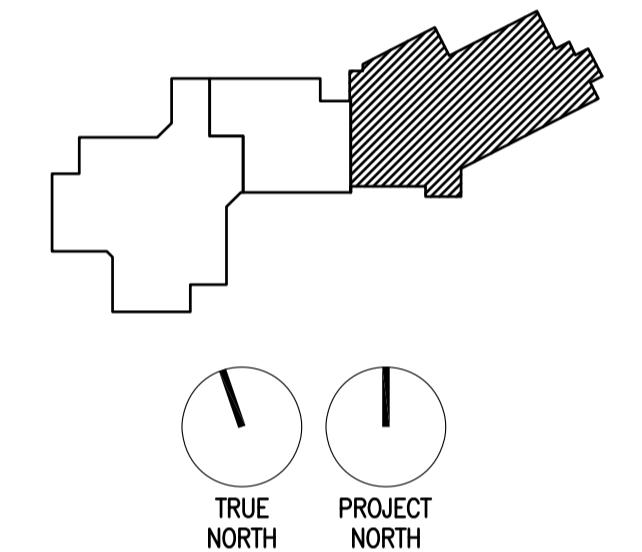
TONY TANG
Regional Manager, Architectural and Engineering Services
Gestionnaire régionale, Services d'architectural et de génie, TPSGC
PREETIPAL PAUL

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DEMOLITION PLAN

2014-15 NLS (National) Start/E-mail End

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MOUNTAIN INSTITUTE HEALTH CARE EXPANSION

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Designed by/Concept par
EDWIN BERZINS

Drawn by/Dessiné par
BEN MONROE (2017-09-28)

PSPC Project Manager/Administrateur de Projets SPAC
TONY TAN


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 Gestionnaire régionale, Services d'architecture et de génie, SPAC

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OVERALL PHASE 1 PLAN

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The diagram illustrates a stepped surface. On the left, there is a vertical boundary separating a flat region from a stepped one. The stepped region features several levels that slope downwards from left to right. Two specific areas are highlighted with different patterns: the first area, located on the second step from the left, is filled with horizontal lines; the second area, which is larger and positioned further to the right, is filled with diagonal lines sloping upwards from left to right.

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d by/Concept par
BERZINS

by/Dessiné par
MONROE (2017-09-28)

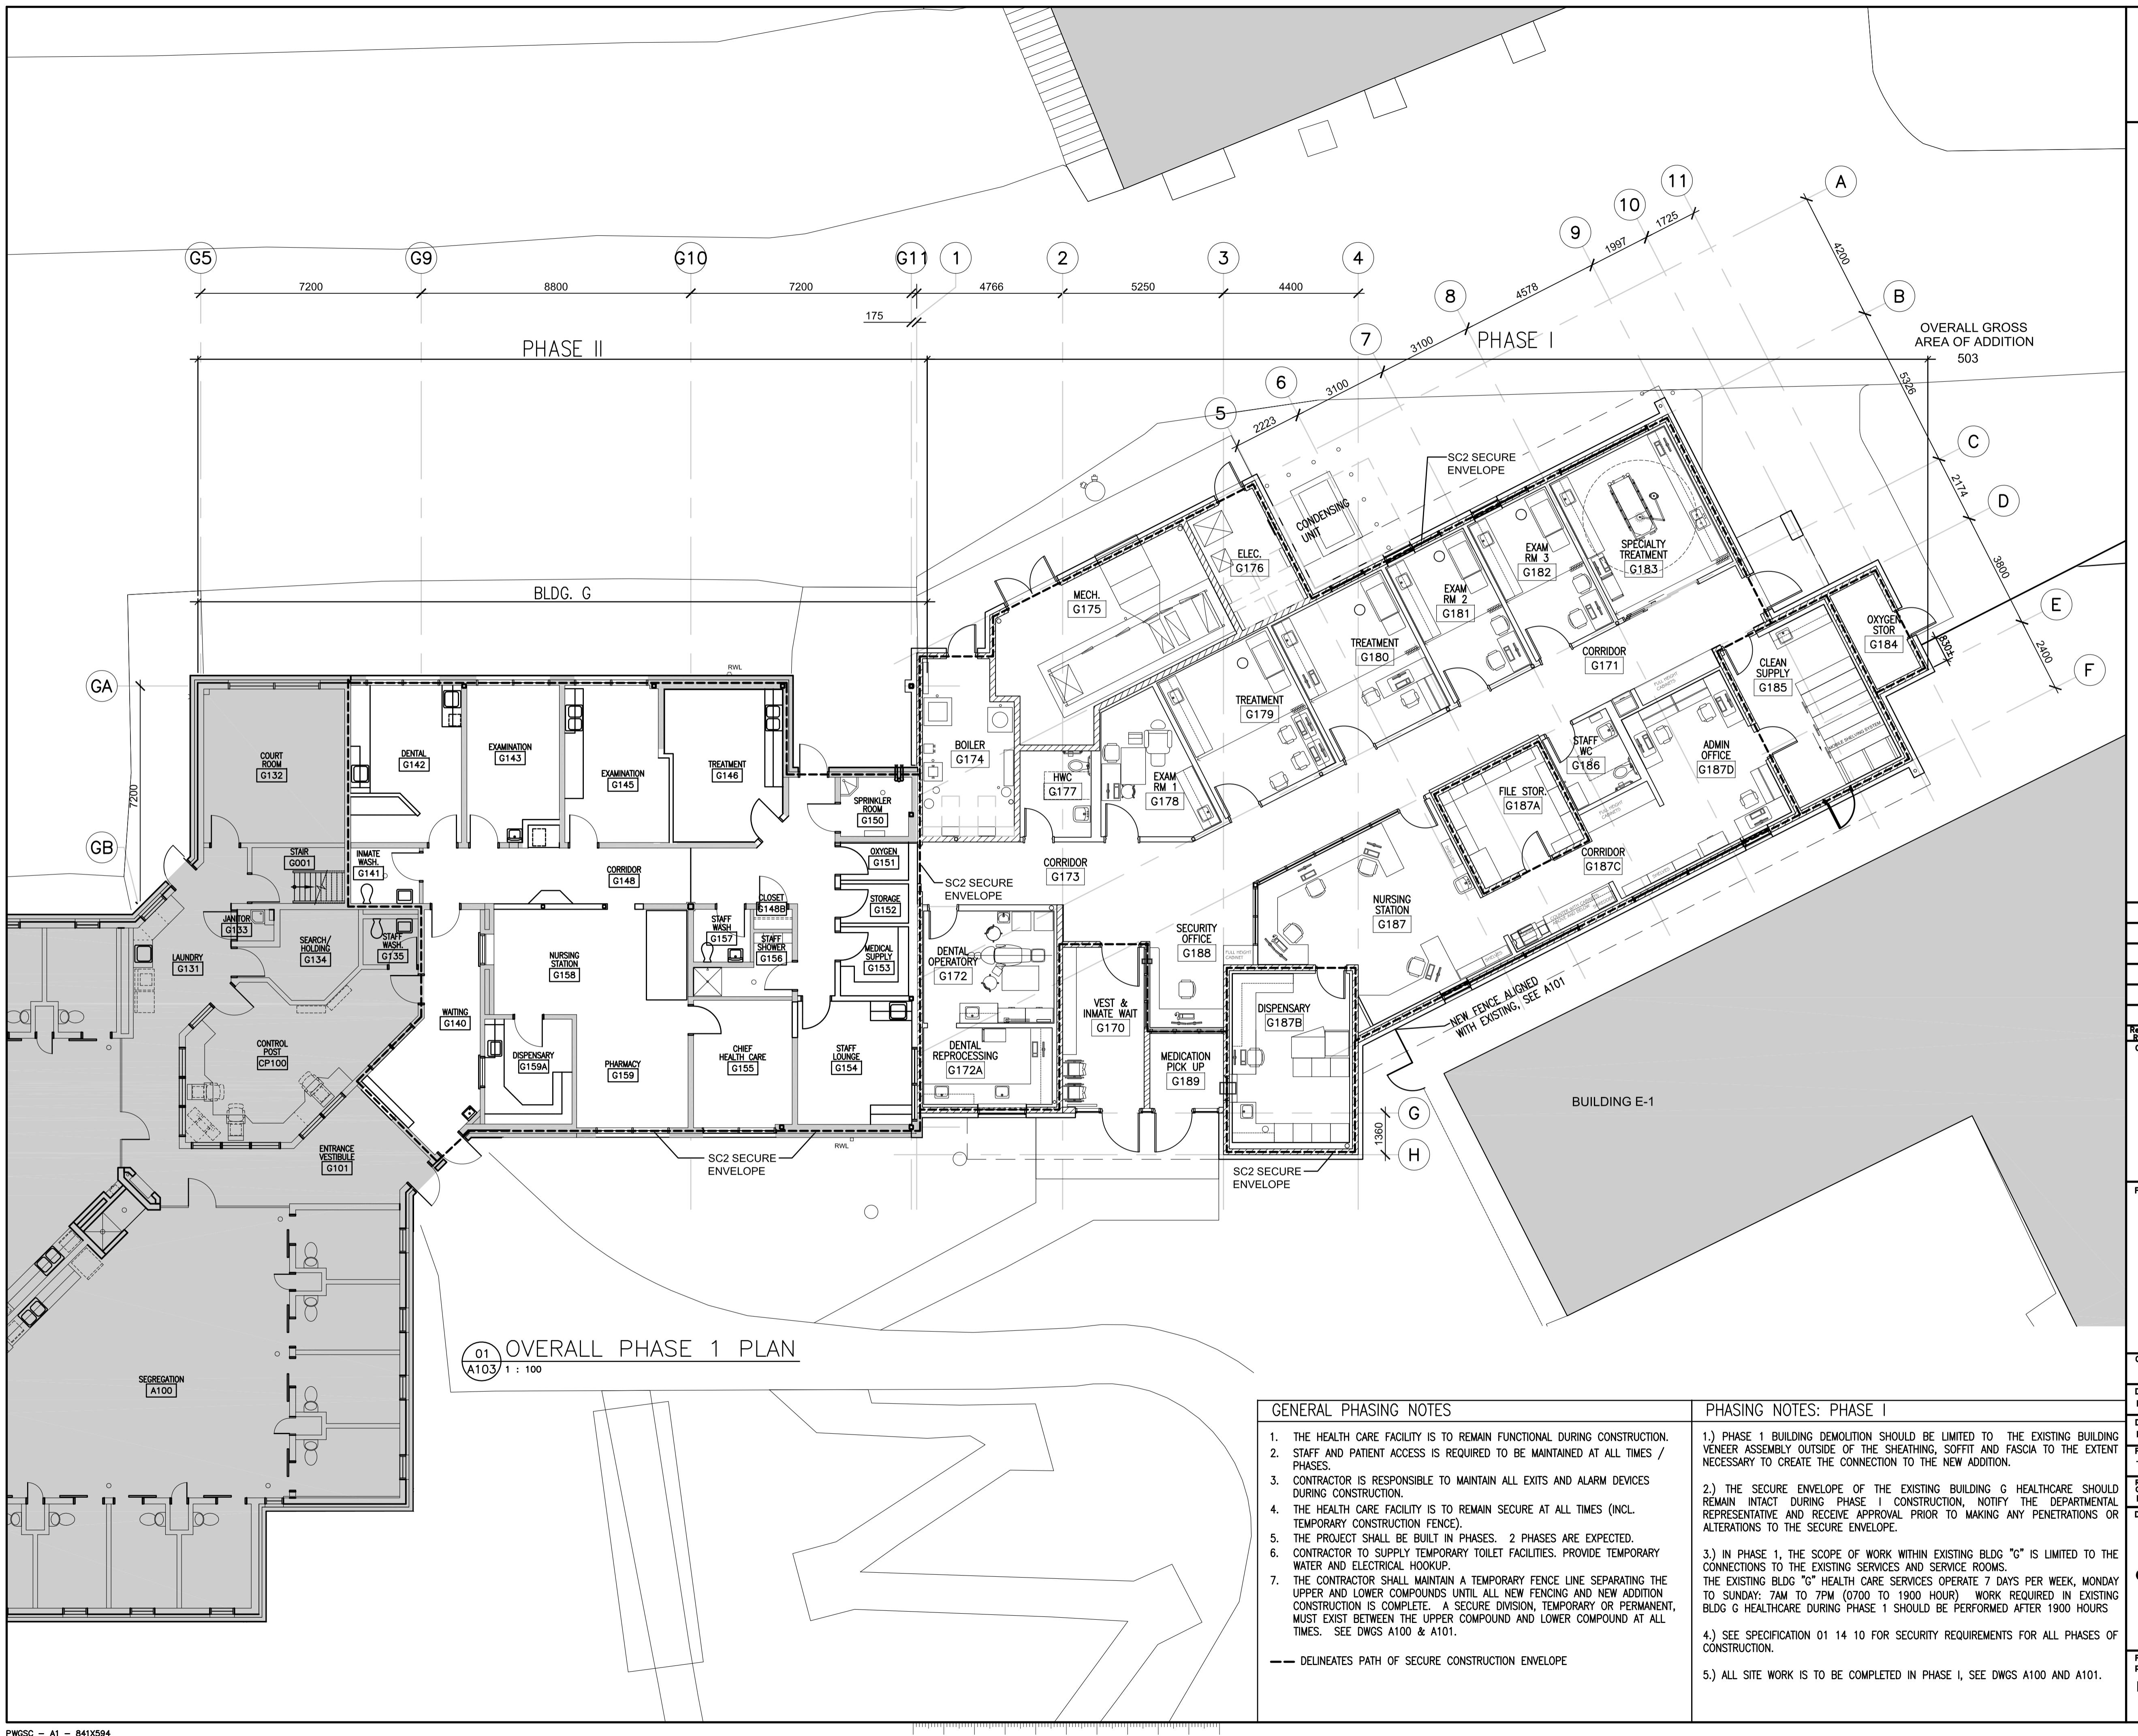Project Manager/Administrateur de Projets SPAC
FRANC

Manager, Architectural and Engineering Services
aire régionale Services d'architecture et de génie SPAC

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GENERAL PHASING NOTES

- GENERAL PLANNING NOTES**


 1. THE HEALTH CARE FACILITY IS TO REMAIN FUNCTIONAL DURING CONSTRUCTION.
 2. STAFF AND PATIENT ACCESS IS REQUIRED TO BE MAINTAINED AT ALL TIMES / PHASES.
 3. CONTRACTOR IS RESPONSIBLE TO MAINTAIN ALL EXITS AND ALARM DEVICES DURING CONSTRUCTION.
 4. THE HEALTH CARE FACILITY IS TO REMAIN SECURE AT ALL TIMES (INCL. TEMPORARY CONSTRUCTION FENCE).
 5. THE PROJECT SHALL BE BUILT IN PHASES. 2 PHASES ARE EXPECTED.
 6. CONTRACTOR TO SUPPLY TEMPORARY TOILET FACILITIES. PROVIDE TEMPORARY WATER AND ELECTRICAL HOOKUP.
 7. THE CONTRACTOR SHALL MAINTAIN A TEMPORARY FENCE LINE SEPARATING THE UPPER AND LOWER COMPOUNDS UNTIL ALL NEW FENCING AND NEW ADDITION CONSTRUCTION IS COMPLETE. A SECURE DIVISION, TEMPORARY OR PERMANENT, MUST EXIST BETWEEN THE UPPER COMPOUND AND LOWER COMPOUND AT ALL TIMES. SEE DWGS A100 & A101.

- PHASING NOTES: PHASE II

 - 1.) PHASE 2 SCOPE OF WORK SHOULD BE LIMITED TO THE INTERIOR OF THE EXISTING BUILDING AND THE CORRIDOR DOOR TO THE NEW ADDITION.
 - 2.) THE SECURE ENVELOPE OF THE NEW ADDITION SHOULD REMAIN INTACT DURING ALL PHASE II CONSTRUCTION, NOTIFY THE DEPARTMENTAL REPRESENTATIVE AND RECEIVE APPROVAL IF ANY CHANGES TO THE SECURE ENVELOPE WILL BE MADE.
MAINTAIN TEMPORARY SECURE ENCLOSURE AT OPENING UNTIL DOOR G162A IS FULLY INSTALLED.
 - 3.) THE NEW HEALTH CARE ADDITION WILL OPERATE 7 DAYS PER WEEK, MONDAY TO SUNDAY: 7AM TO 7PM (0700 TO 1900 HOUR) WORK REQUIRE IN THE NEW ADDITION DURING PHASE 2 SHOULD BE PERFORMED AFTER 1900 HOURS
 - 4.) SEE SPECIFICATION 01 14 10 FOR SECURITY REQUIREMENTS FOR ALL PHASES OF CONSTRUCTION

— Delineates path of secure construction envelope

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CORRECTIONAL SERVICE OF CANADA

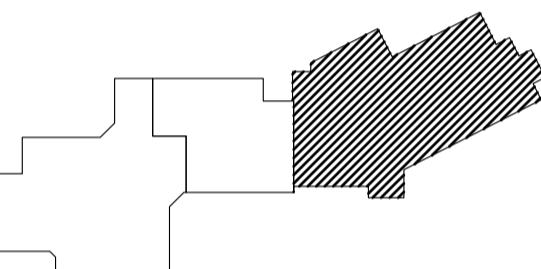Project title/Titre du projet
AGASSIZ, BRITISH COLUMBIA
 4732 CEMETERY ROAD PO BOX 1600
 MOUNTAIN INSTITUTE

MOUNTAIN INSTITUTE HEALTH CARE EXPANSION

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Designed by/Concept par
EDWIN BERZINS
Drawn by/Dessiné par
BEN MONROE (2017-09-28)
PWGS Project Manager/Administrateur de Projets TPSGC
TONY TANG
Regional Manager, Architectural and Engineering Services Gestionnaire régionale, Services d'architecture et de génie, TPSGC
PREETPAL PAUL
Drawing title/Titre du dessin


PHASE 1 CRAWL SPACE PLAN


Project No./No. du projet	Sheet/Feuille	Revision no./ La Révision no.
R.077724.001	A105A	0

OF 12

1 CRAWL SPACE PLAN

A105A 1 : 50

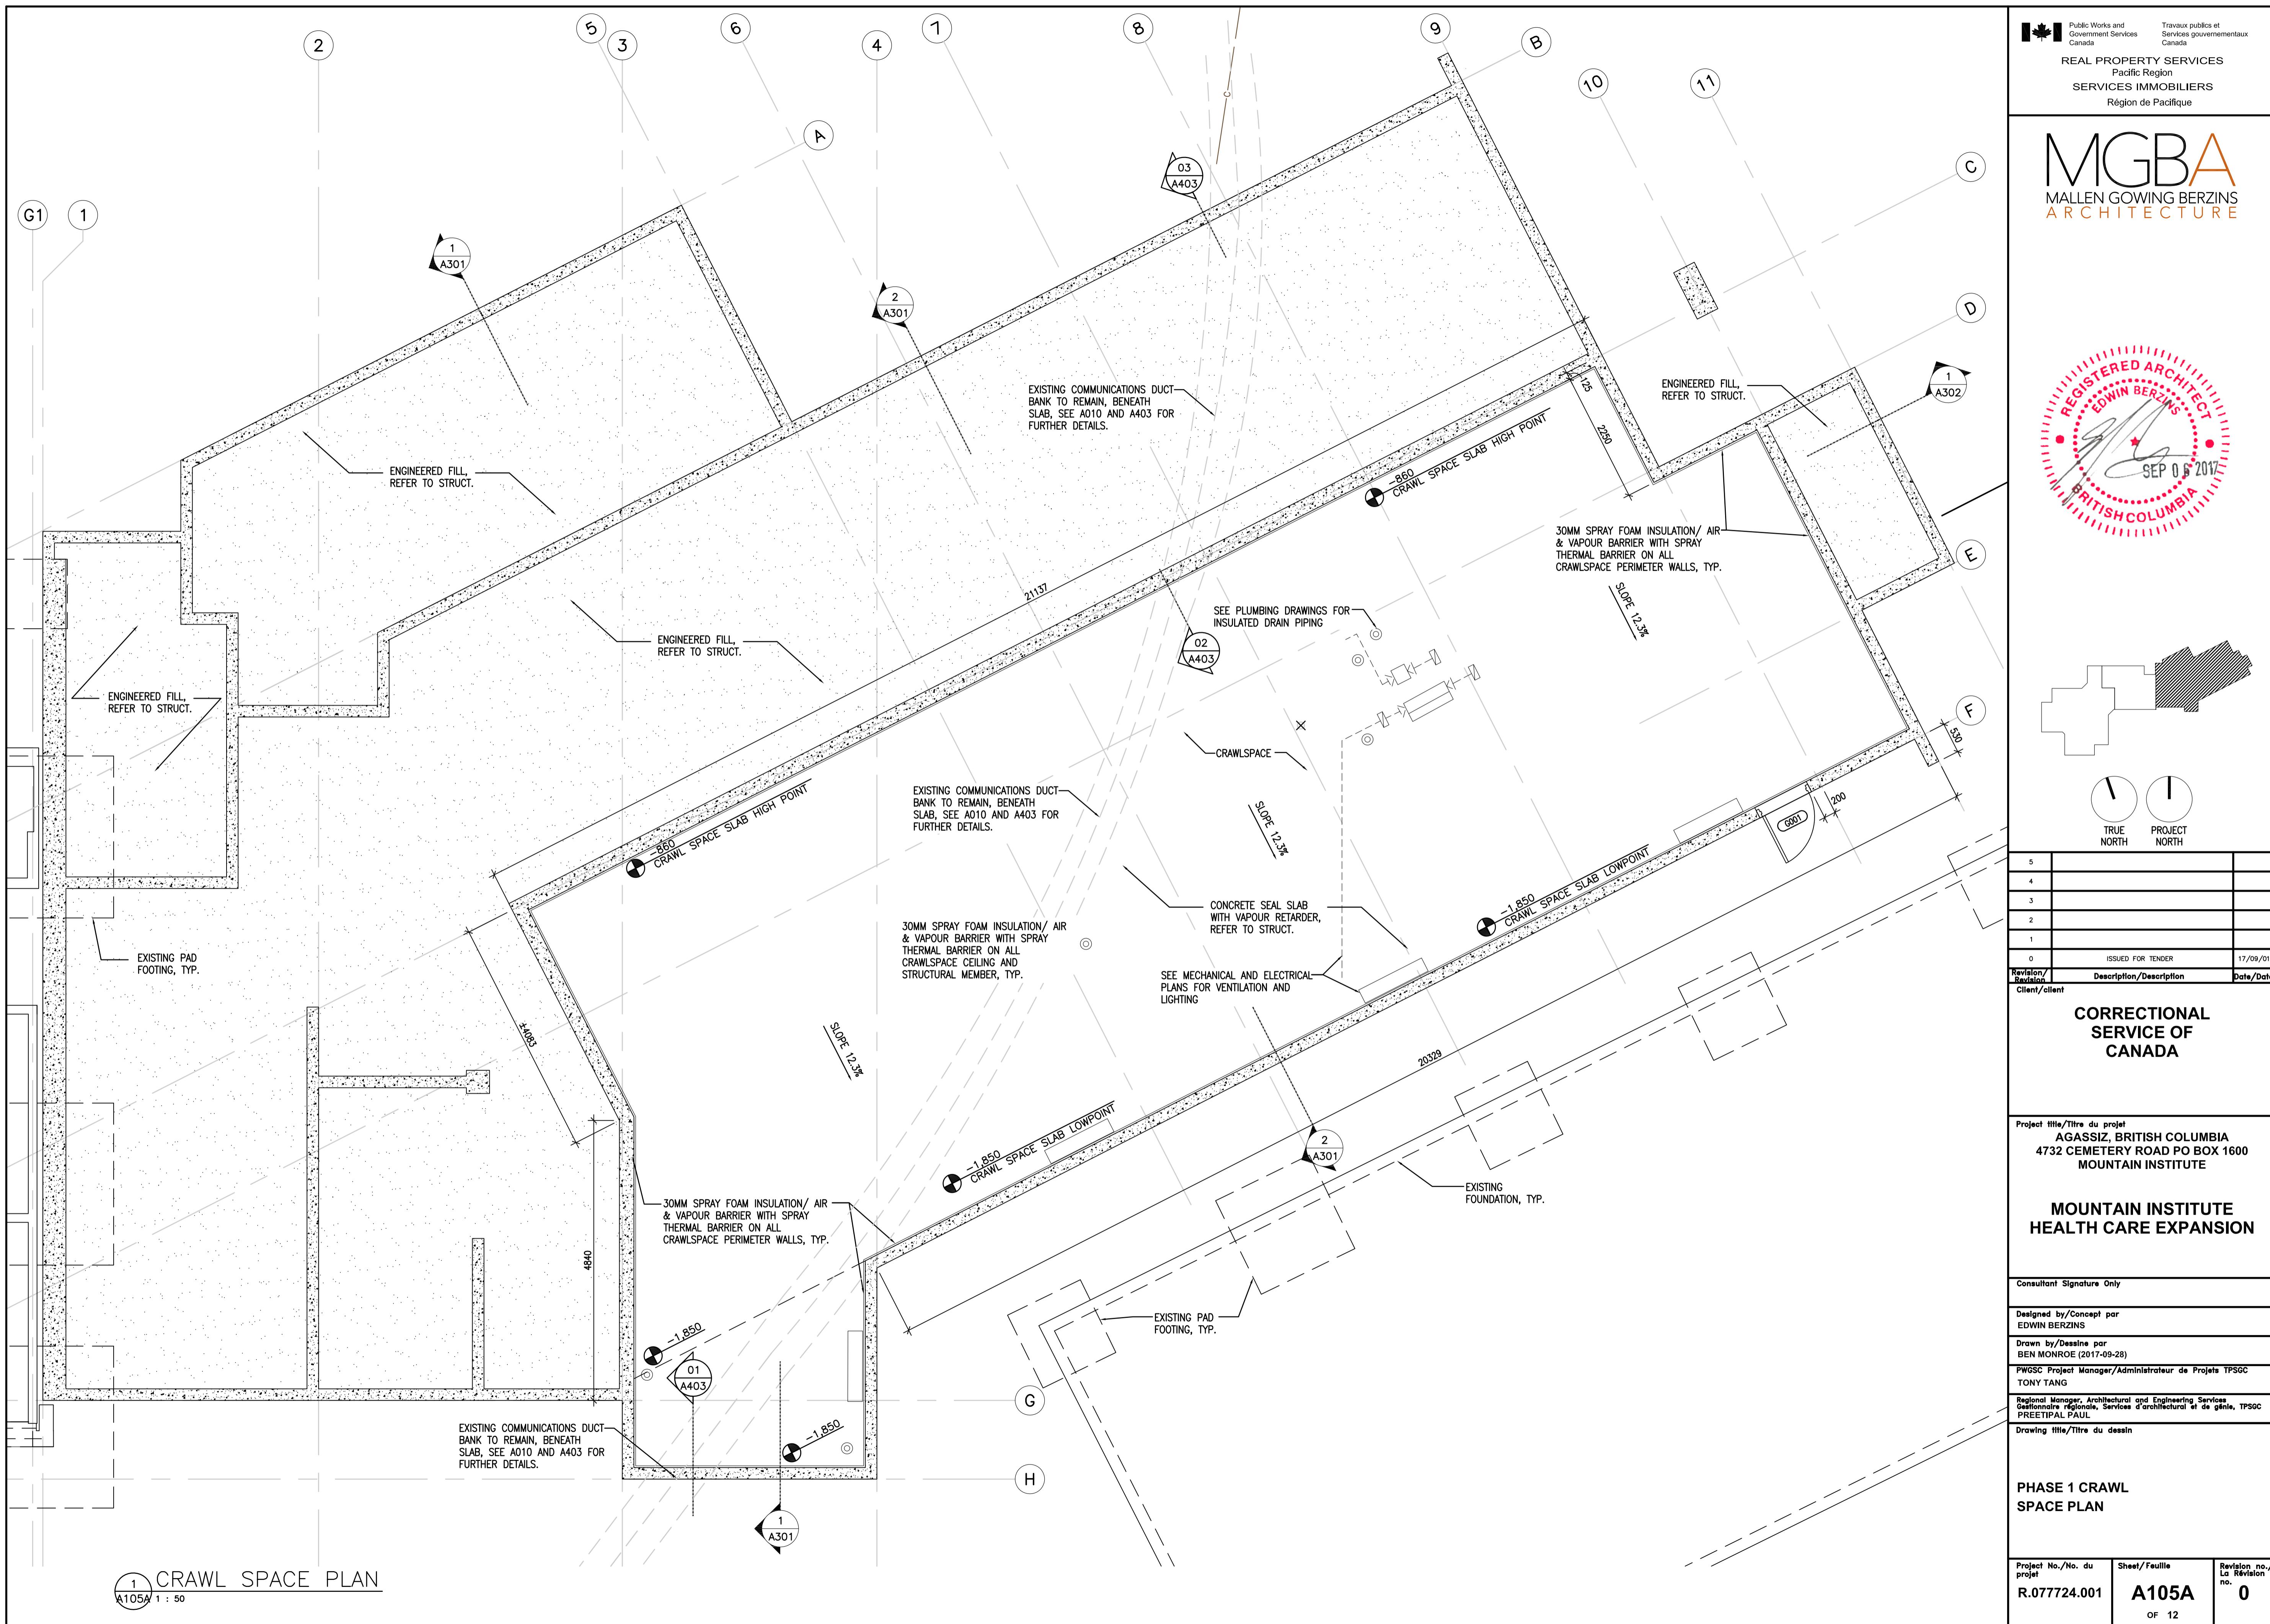

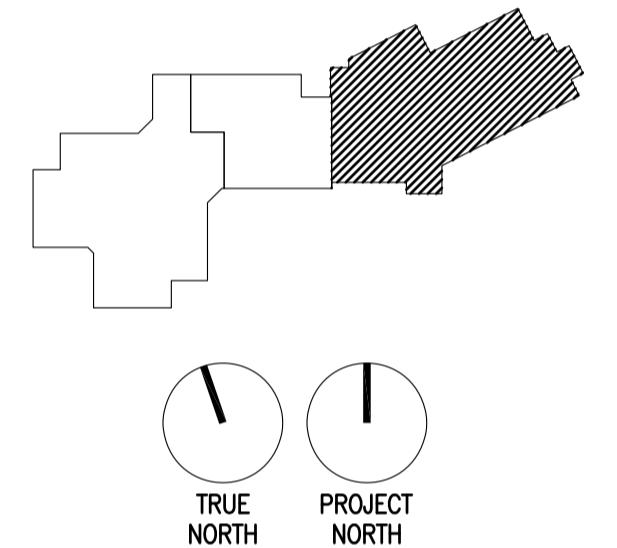

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EDWIN BERZINS

Drawn by/Dessiné par
BEN MONROE (2017-09-28)

PWGS Project Manager/Administrateur de Projets TPSGC

TONY TANG

Regional Manager, Architectural and Engineering Services
Gestionnaire régionale, Services d'architecture et de génie, TPSGC


PREETPAL PAUL

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PHASE 1 FLOOR PLAN

Project No./No. du projet R.077724.001	Sheet/Feuille A105B	Revision no./ Révision no. 0
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OF 12



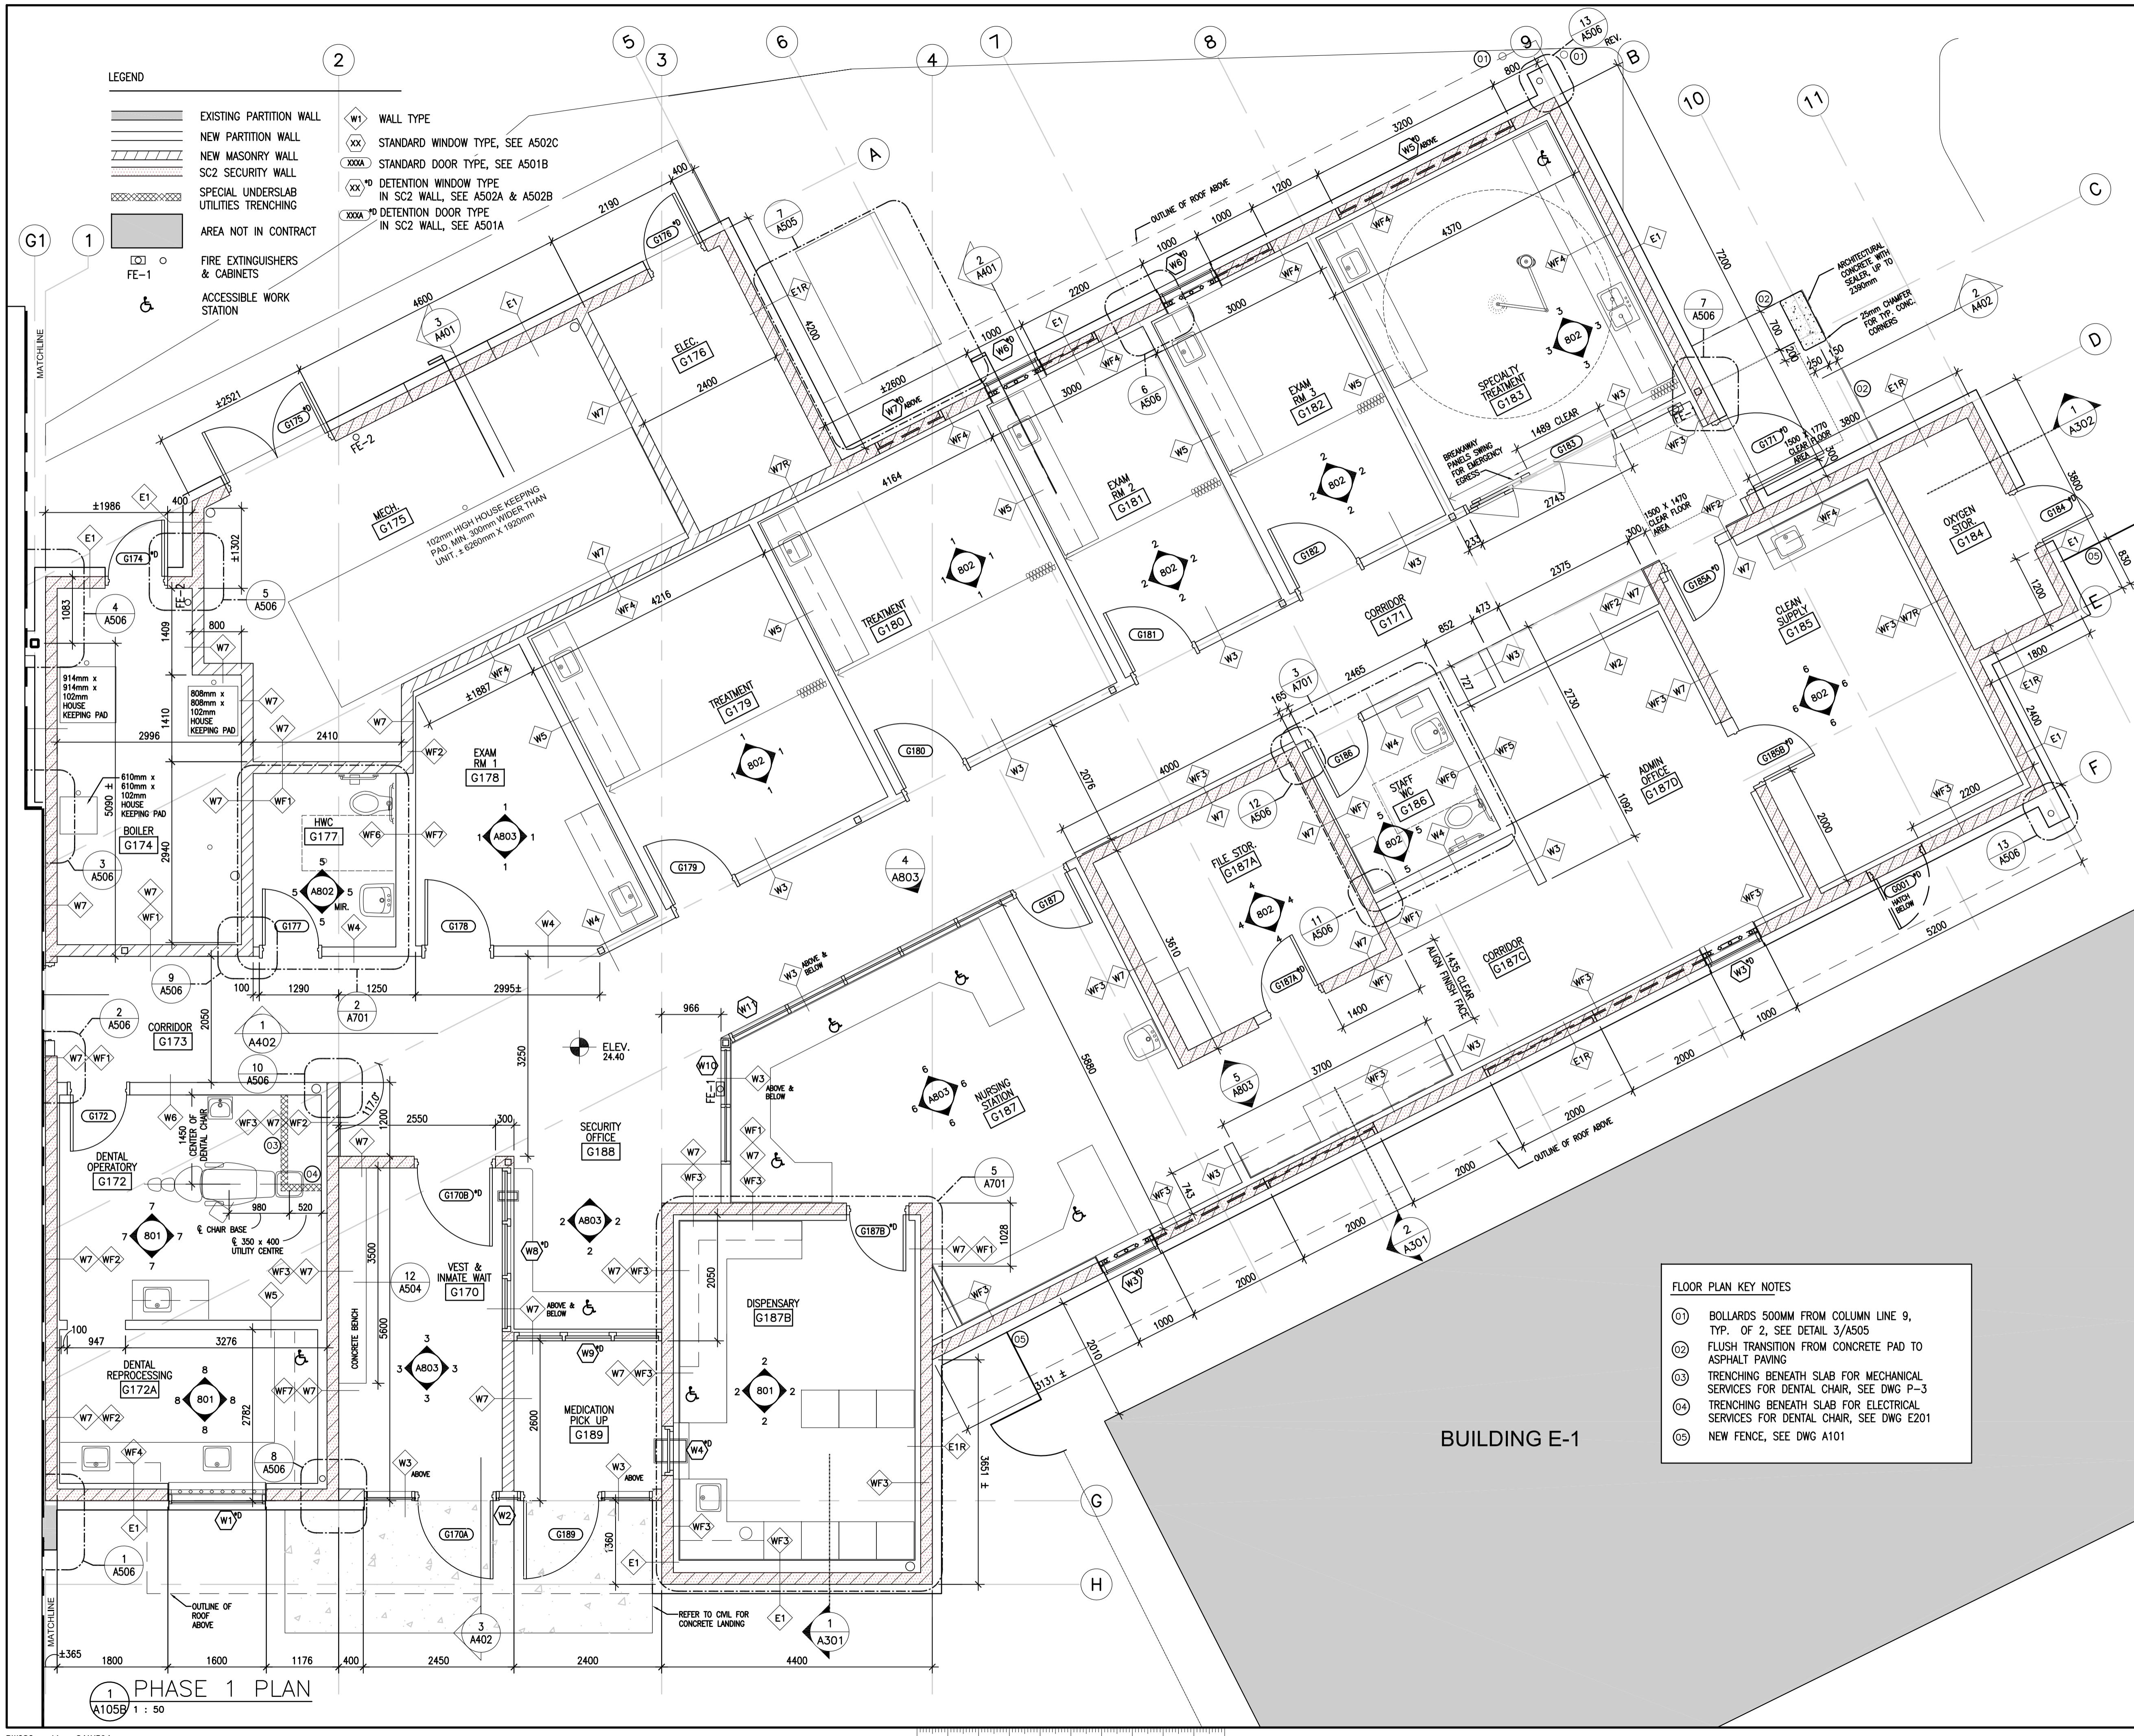

The diagram consists of two parts. The top part shows a stepped horizontal line representing Earth's surface. A rectangular area is filled with diagonal hatching, representing a specific location. The bottom part contains two circles. The left circle has a single vertical tick mark pointing downwards, labeled "TRUE NORTH". The right circle has a single vertical tick mark pointing upwards, labeled "PROJECT NORTH".

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d by/Concept par

by/Dessine par


Project Manager/Administrateur de Projets TPSGC

Manager, Architectural and Engineering Services

IPAL PAUL


SE 2 FLOOR PLAN

No./No. du	Sheet/ Feuille	Revision no./ La Révision no.
7724.001	A106	0

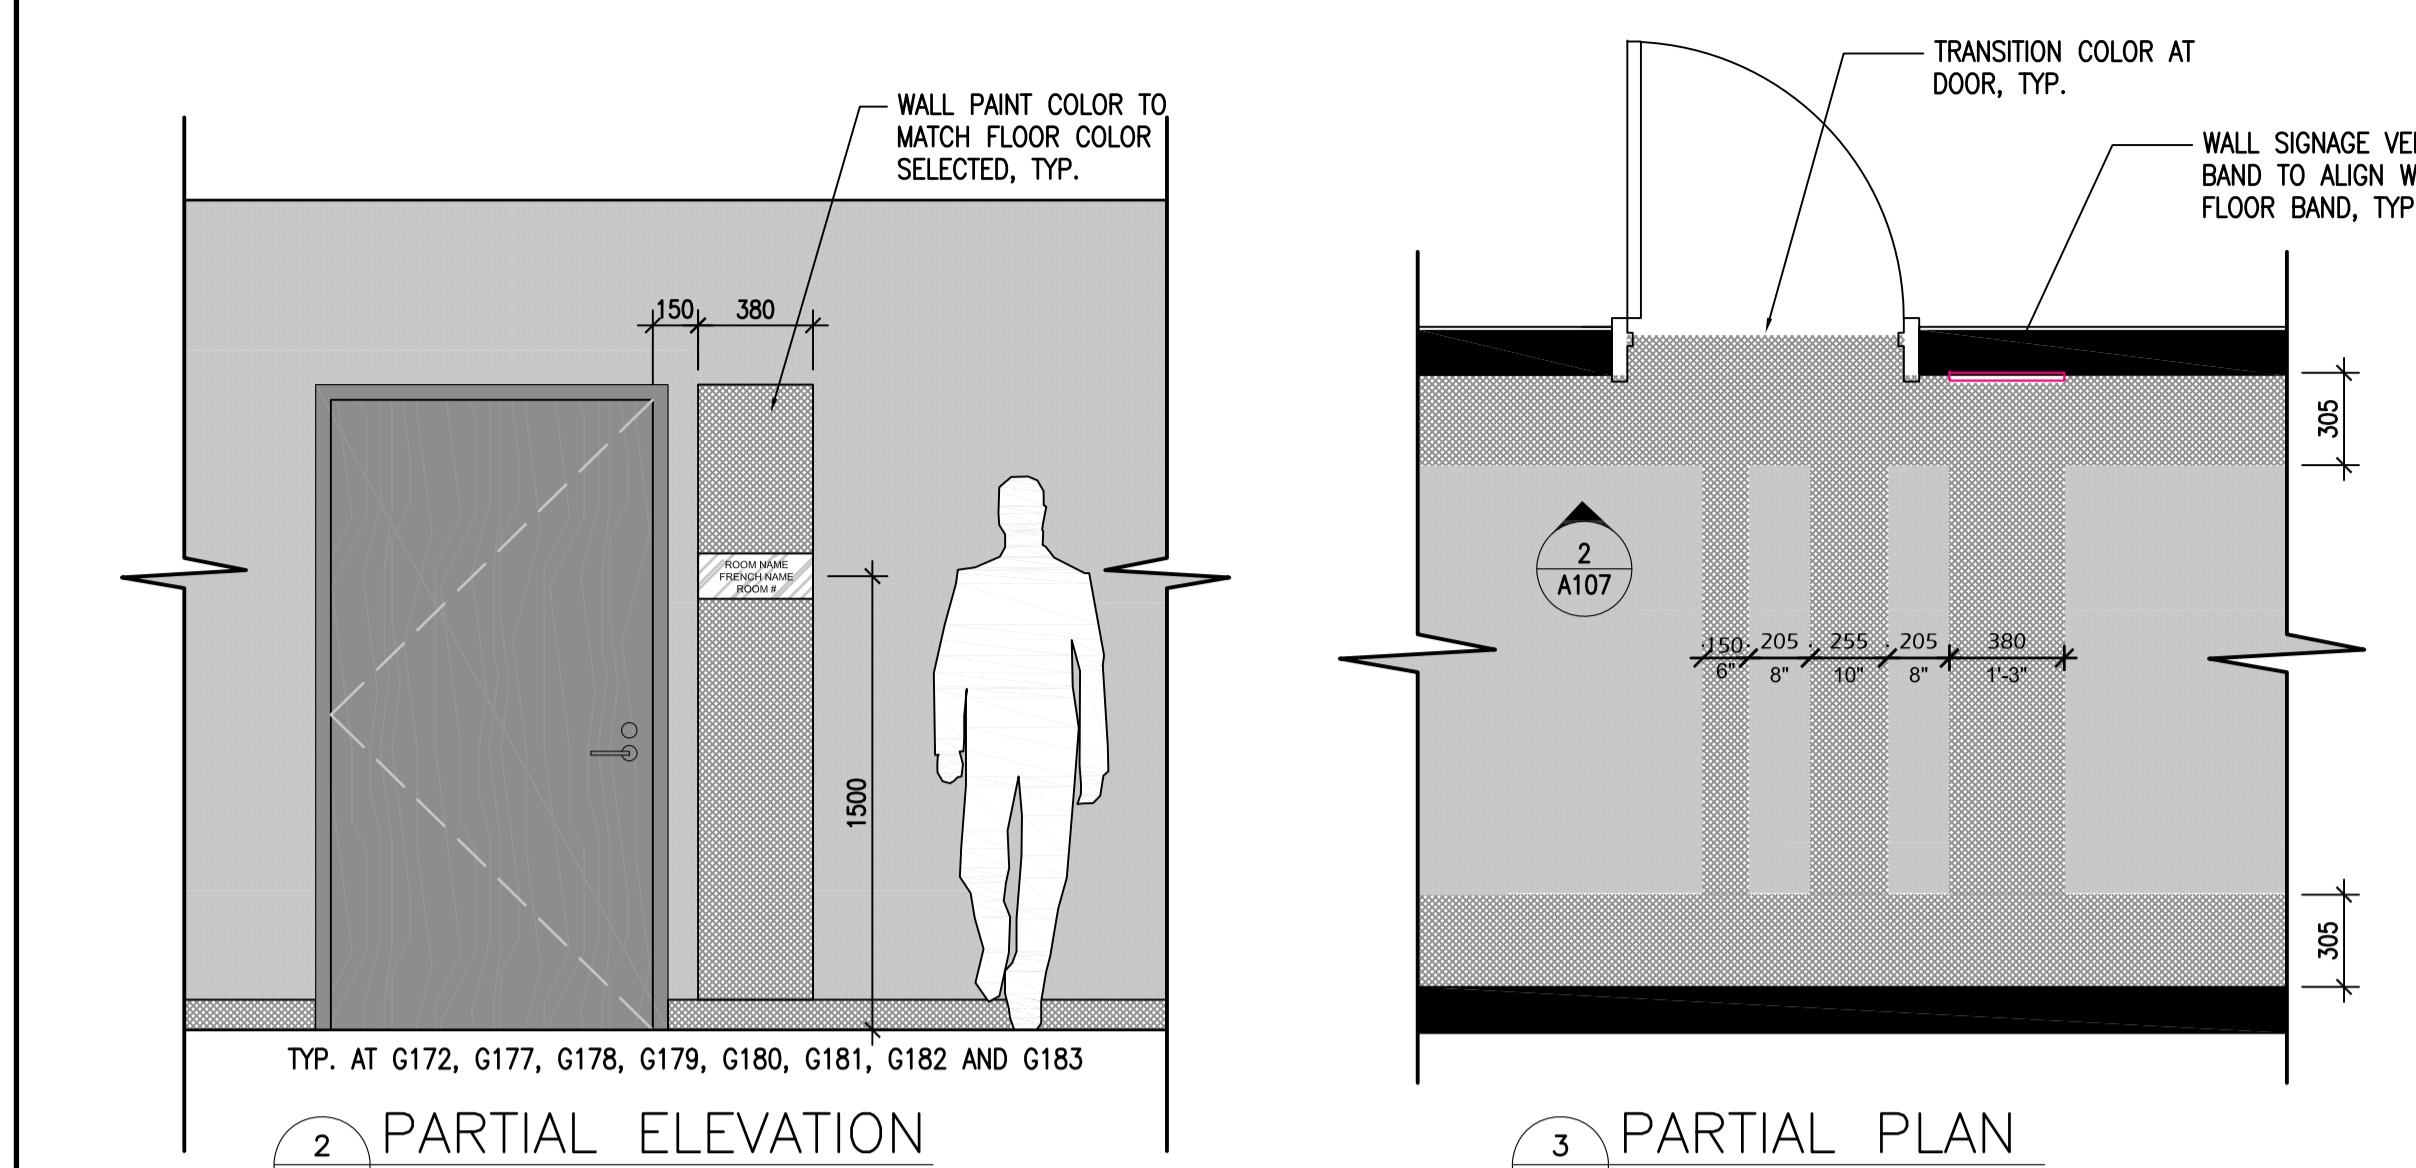


2 PARTIAL ELEVATION
 A107 1:25

3 PARTIAL PLAN
 A107 1:25

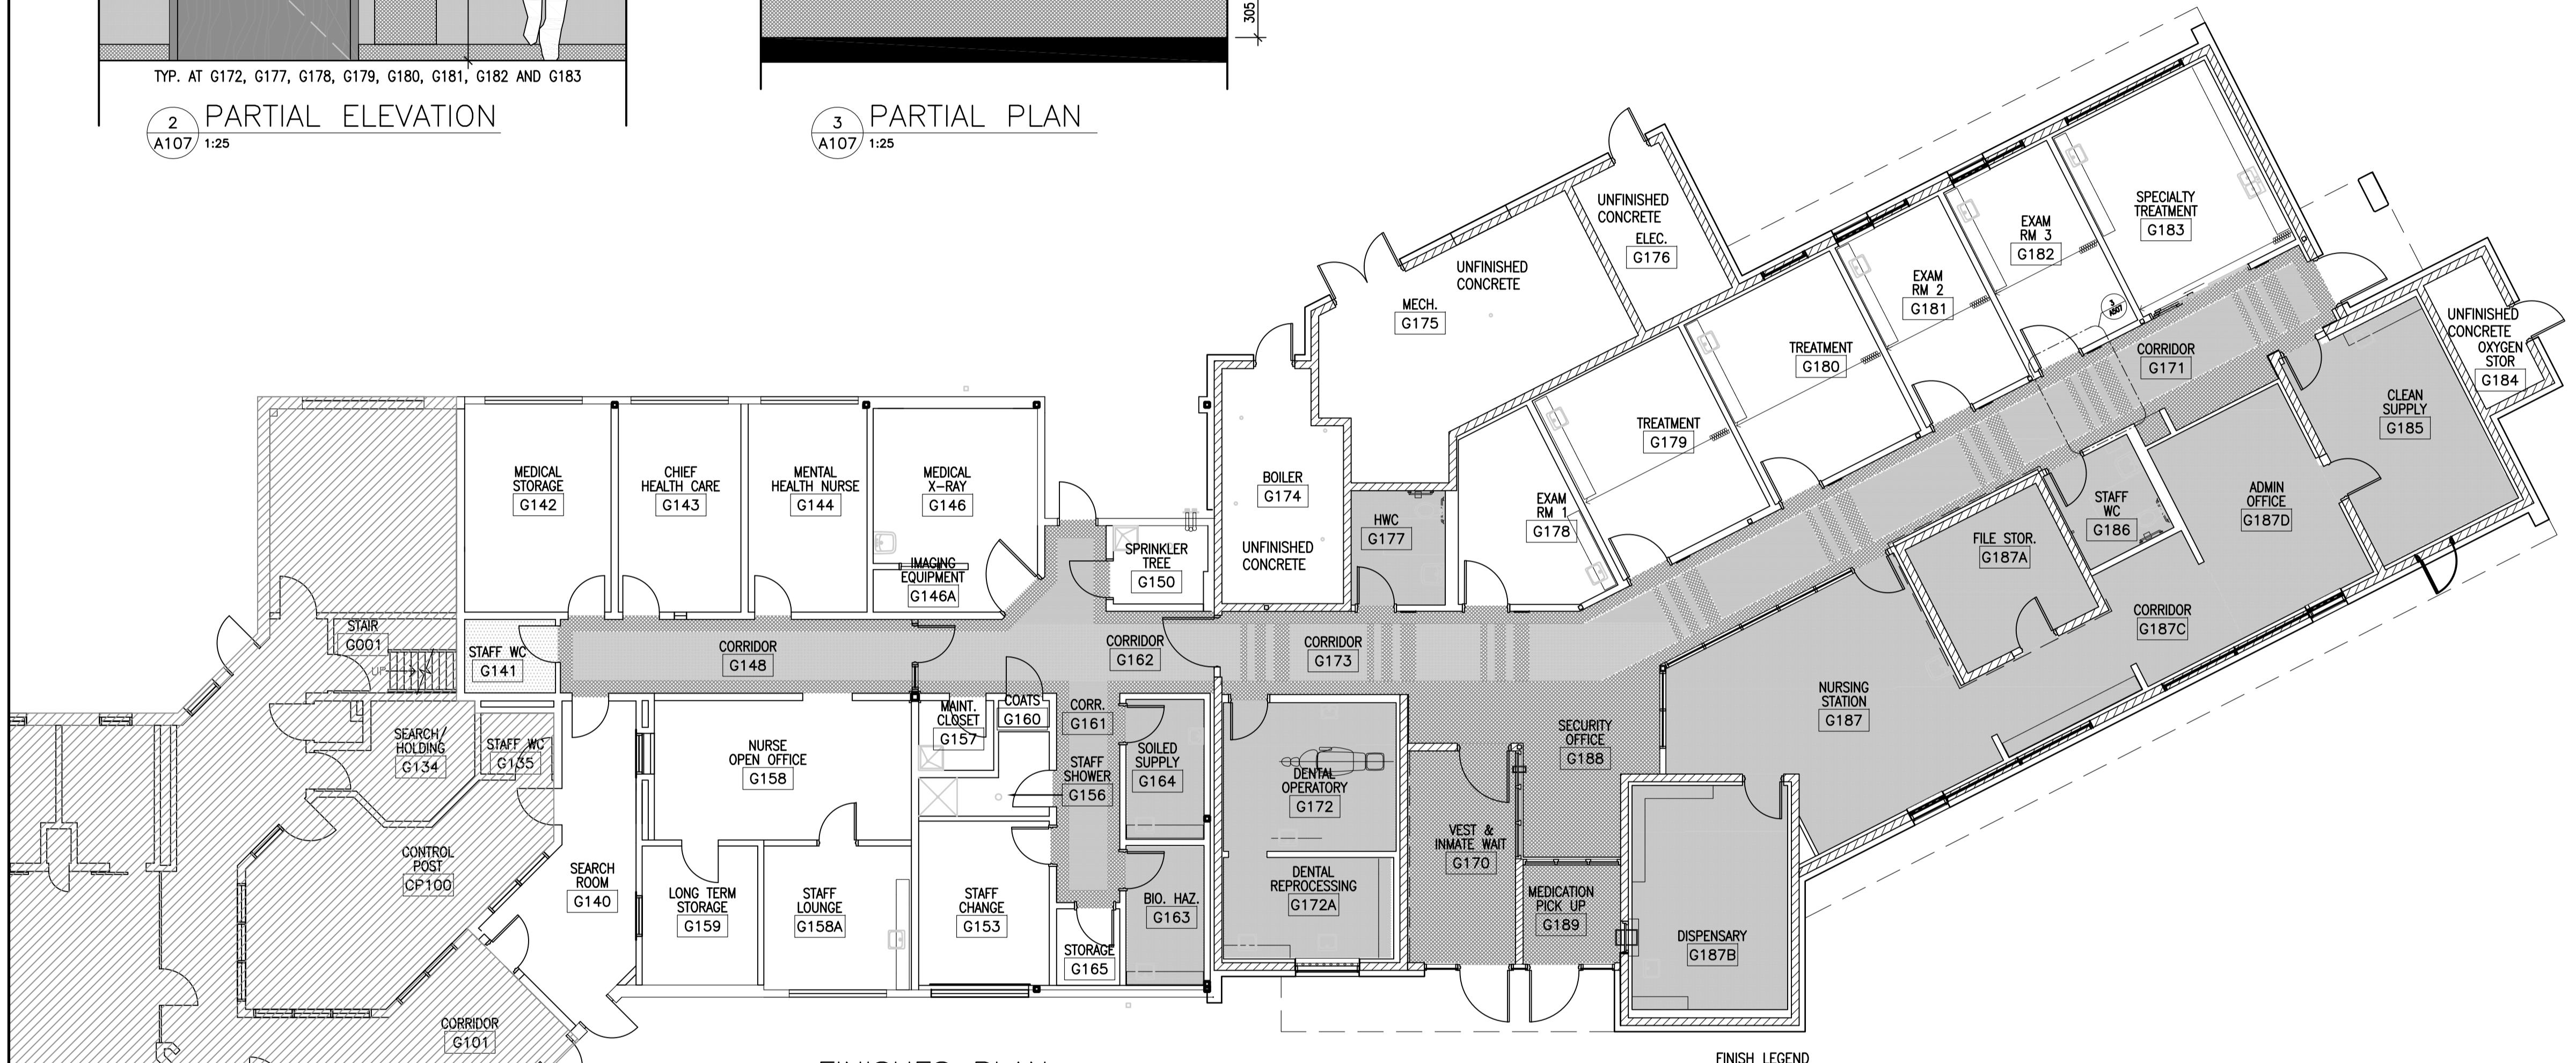


01 FINISHES PLAN
 A107 1 : 100

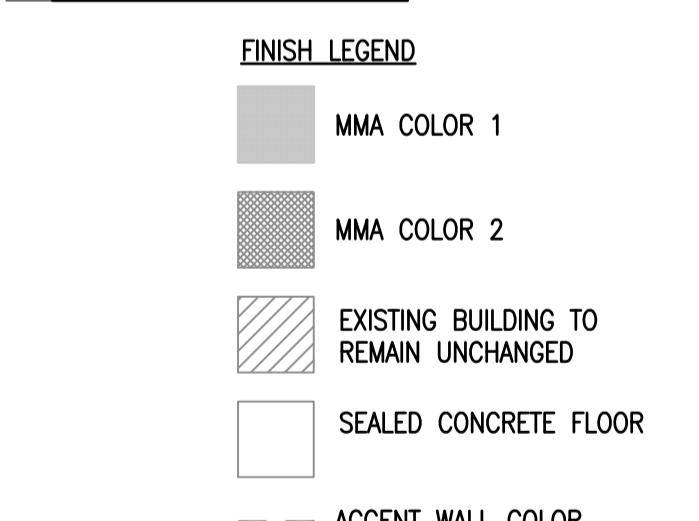

FINISHES NOTES:

1. ALL EXPOSED CONDUIT, MECHANICAL, SPRINKLER AND STRUCTURE TO BE PAINTED. REFER TO CEILING PLANS & MECHANICAL / ELECTRICAL PLANS FOR EXPOSED CEILING AREAS.
2. PREP ALL SURFACES TO RECEIVE FINISHES PER MANUFACTURER'S RECOMMENDATIONS.
3. PROVIDE MOISTURE TESTS ON ALL NEW CONCRETE SUBSTRATES. INSTAL NEW FINISHES BASED ON MANUFACTURER'S RECOMMENDATION.
4. PAINT ALL STEEL DOOR FRAMES AND STEEL DOORS IN NEW CONSTRUCTION AND AREA OF RENOVATION.

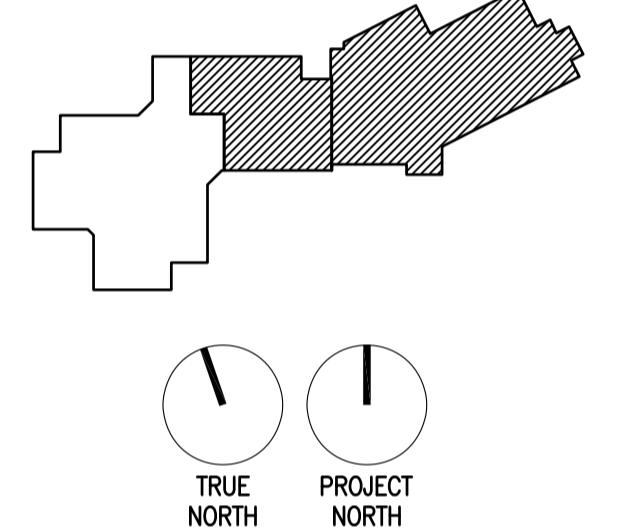

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4732 CEMETERY ROAD PO BOX 1600
MOUNTAIN INSTITUTE

MOUNTAIN INSTITUTE HEALTH CARE EXPANSION

Consultant Signature Only

Designed by/Concept par
EDWIN BERZINS

Drawn by/Dessiné par
MING HSU (2017-05-28)

PSPC Project Manager/Administrateur de Projets SPAC
TONY TANG

Regional Manager, Architectural and Engineering Services
Gestionnaire régionale, Services d'architecture et de génie, SPAC
PREETPAL PAUL

Drawing title/Titre du dessin

FINISHES PLAN

Project No./No. du projet R.077724.001	Sheet/Feuille A107	Revision no./ Révision no. 0
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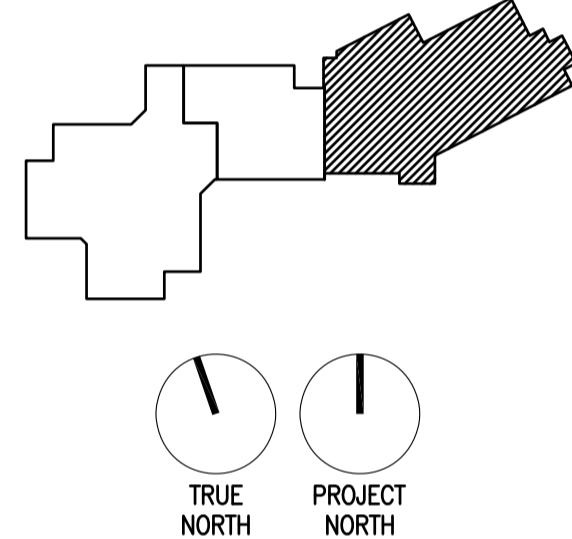
REFLECTED CEILING NOTES:

- REFER TO ENTIRE SET OF DOCUMENTS FOR FULL SCOPE OF WORK. RCP LAYOUT SHOWN FOR CO-ORDINATION ONLY. SEE MECHANICAL AND ELECTRICAL DRAWINGS FOR HVAC, SPRINKLER AND LIGHTING PROVISIONS AND ABOVE CEILING ROUTING.
- ARCHITECTURAL DRAWINGS SHALL TAKE PRECEDENT FOR LOCATING ALL FEATURES IN THE CEILING INCLUDING LIGHTS, DIFFUSERS, ALARMS, SPEAKERS AND SPRINKLER HEADS.
- ACOUSTIC TILE CEILING & SUSPENDED LIGHT FIXTURES TO BE SEISMICALLY BRAZED. CONTRACTOR TO PROVIDE LETTERS OF ASSURANCE FROM REGISTERED ENGINEER (REGISTERED IN PLACE OF WORK) AT PROJECT CLOSE.
- ACOUSTIC TILE CEILING LAYOUT TO BE CENTERED IN ROOM U.N.O. ACCESS PANELS TO BE PROVIDED IN ALL GWB CEILINGS TO ACCESS ALL FIRE DAMPERS, VALVES & OTHER SERVICEABLE DEVICES.
- IN ACOUSTIC CEILINGS, ALL FIRE DAMPER LOCATIONS, VALVES & OTHER SERVICEABLE DEVICE LOCATIONS SHALL BE IDENTIFIED ON CEILING GRID (T-BAR). SELF ADHESIVE "DOTS" ARE ACCEPTABLE.
- PROVIDE BLOCKING AS REQ'D TO SUPPORT AND FASTEN SURFACE MOUNTED FIXTURES, CABINETS, SHELVING, EQUIPMENT AND OTHER SURFACE MOUNTED DEVICES.
- FIRE STOP ALL PENETRATIONS & JOINTS THRU FIRE-RATED ASSEMBLIES. PROVIDE MECHANICAL DAMPERS AT ALL DUCTWORK PENETRATIONS.
- PROVIDE CEMENT BASED BACKER BOARD IN ALL WET LOCATIONS SUCH AS SHOWERS.
- CEILING HEIGHTS TO MATCH EXISTING UNLESS NOTED OTHERWISE.



KEY NOTES:

(THE FOLLOWING ITEMS ARE THE RESPONSIBILITY OF THE CONTRACTOR AND ARE TO BE SUPPLIED & INSTALLED U.N.O. KEYED ITEMS ARE TO ASSIST IN CONVEYING CONSTRUCTION. WORK IS NOT LIMITED TO ITEMS TAGGED.)



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MOUNTAIN INSTITUTE

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HEALTH CARE EXPANSION**

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Designed by/Conception par
EDWIN BERZINS

Drawn by/Dessiné par
BEN MONROE (2017-09-28)

PWGS Project Manager/Administrateur de Projets TPSGC
TONY TANG

Regional Manager, Architectural and Engineering Services
Gestionnaire régionale, Services d'architecture et de génie, TPSGC
PREETPAL PAUL

Drawing title/Titre du dessin


**PHASE 1
REFLECTED CEILING PLAN**

Project No./No. du projet	Sheet/Feuille	Revision no./ La Révision no.
R.077724.001	A108	0

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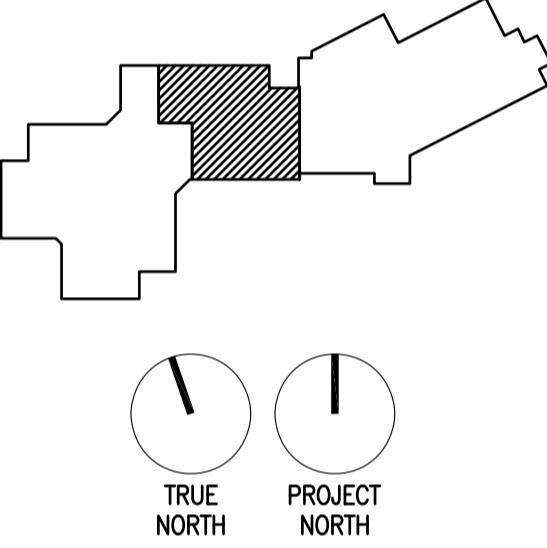
- REFER TO ENTIRE SET OF DOCUMENTS FOR FULL SCOPE OF WORK. RCP LAYOUT SHOWN FOR CO-ORDINATION ONLY. SEE MECHANICAL AND ELECTRICAL DRAWINGS FOR HVAC, SPRINKLER AND LIGHTING PROVISIONS AND ABOVE CEILING ROUTING.
- ARCHITECTURAL DRAWINGS SHALL TAKE PRECEDENCE FOR LOCATING ALL FEATURES IN THE CEILING INCLUDING LIGHTS, DIFFUSERS, ALARMS, SPEAKERS AND SPRINKLER HEADS.
- ACOUSTIC TILE CEILING & SUSPENDED LIGHT FIXTURES TO BE SEISMICALLY BRACED. CONTRACTOR TO PROVIDE LETTERS OF ASSURANCE FROM REGISTERED ENGINEER (REGISTERED IN PLACE OF WORK) AT PROJECT CLOSE.
- ACOUSTIC TILE CEILING LAYOUT TO BE CENTERED IN ROOM U.N.O.
- ACCESS PANELS TO BE PROVIDED IN ALL GWB CEILINGS TO ACCESS ALL FIRE DAMPERS, VALVES & OTHER SERVICEABLE DEVICES.
- IN ACOUSTIC CEILINGS, ALL FIRE DAMPER LOCATIONS, VALVES & OTHER SERVICEABLE DEVICE LOCATIONS SHALL BE IDENTIFIED ON CEILING GRID (T-BAR). SELF ADHESIVE "DOTS" ARE ACCEPTABLE.
- PROVIDE BLOCKING AS REQ'D TO SUPPORT AND FASTEN SURFACE MOUNTED FIXTURES, CABINETS, SHELVING, EQUIPMENT AND OTHER SURFACE MOUNTED DEVICES.
- FIRE STOP ALL PENETRATIONS & JOINTS THRU FIRE-RATED ASSEMBLIES. PROVIDE MECHANICAL DAMPERS AT ALL DUCTWORK PENETRATIONS.
- PROVIDE CEMENT BASED BACKER BOARD IN ALL WET LOCATIONS SUCH AS SHOWERS.
- CEILING HEIGHTS TO MATCH EXISTING UNLESS NOTED OTHERWISE.
- UNLESS OTHERWISE NOTED, ALL NEW EQUIPMENT, PRODUCTS, DEVICES AND MATERIAL SHALL BE SUPPLIED AND INSTALLED BY THE CONTRACTOR.
- EXISTING CEILING LAYOUT AND LOCATION OR CEILING MOUNTED DEVICES IS DIAGRAMMATIC, CONTRACTOR SHALL FIELD VERIFY THE EXISTING CONDITIONS, LOCATIONS AND QUANTITIES AS REQUIRED.
- WHERE EXISTING CEILINGS ARE TO BE REMOVED AND REPLACED, CONTRACTOR SHALL PROTECT AND PROVIDE SUPPORT FOR ALL CEILING MOUNTED EQUIPMENT TO REMAIN AND RE-INSTALL IN NEW CEILING.

LEGEND

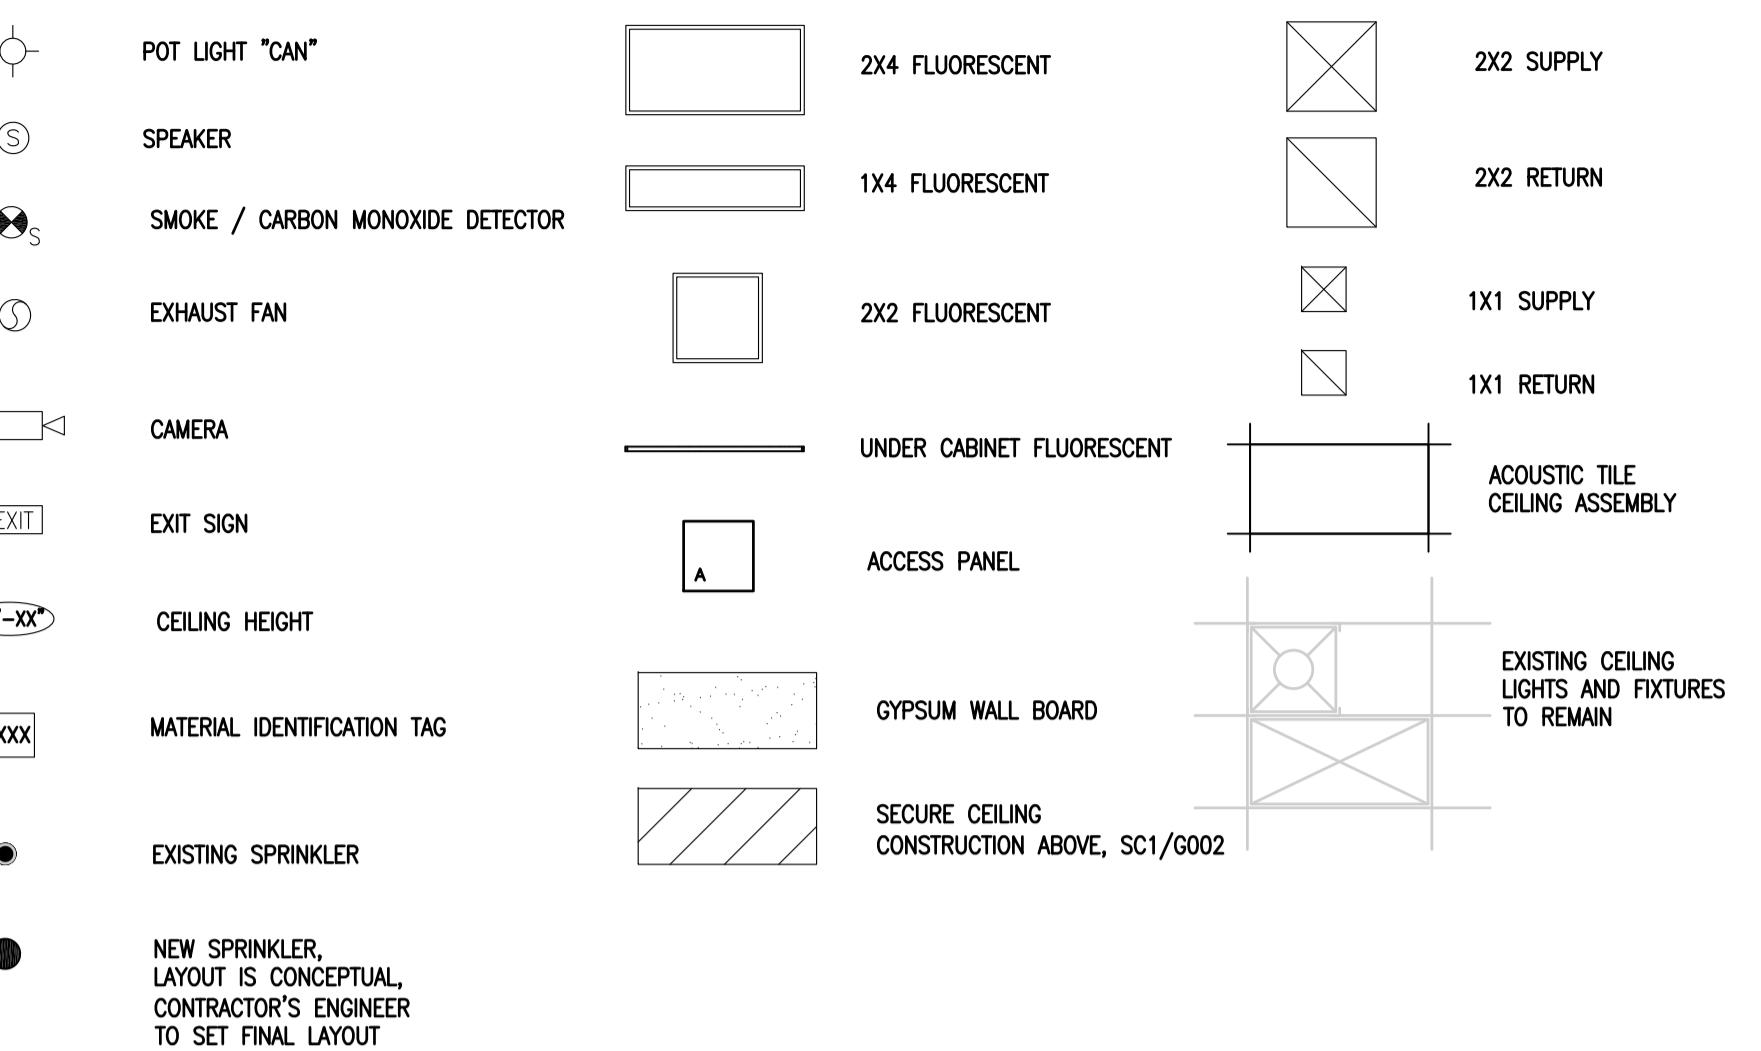

KEY NOTES:

(THE FOLLOWING ITEMS ARE THE RESPONSIBILITY OF THE CONTRACTOR AND ARE TO BE SUPPLIED & INSTALLED U.N.O. KEYED ITEMS ARE TO ASSIST IN CONVEYING CONSTRUCTION. WORK IS NOT LIMITED TO ITEMS TAGGED.)



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AGASSIZ, BRITISH COLUMBIA
4732 CEMETERY ROAD PO BOX 1600
MOUNTAIN INSTITUTE

**MOUNTAIN INSTITUTE
HEALTH CARE EXPANSION**

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Designed by/Conçue par
EDWIN BERZINS

Drawn by/Dessiné par
BEN MONROE (2017-09-28)


PWGS Project Manager/Administrateur de Projets TPSGC
TONY TANG

Regional Manager, Architectural and Engineering Services
Gestionnaire régionale, Services d'architecture et de génie, TPSGC
PREETPAL PAUL

Drawing title/Titre du dessin

**PHASE 2
REFLECTED CEILING PLAN**

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R.077724.001	A109	0

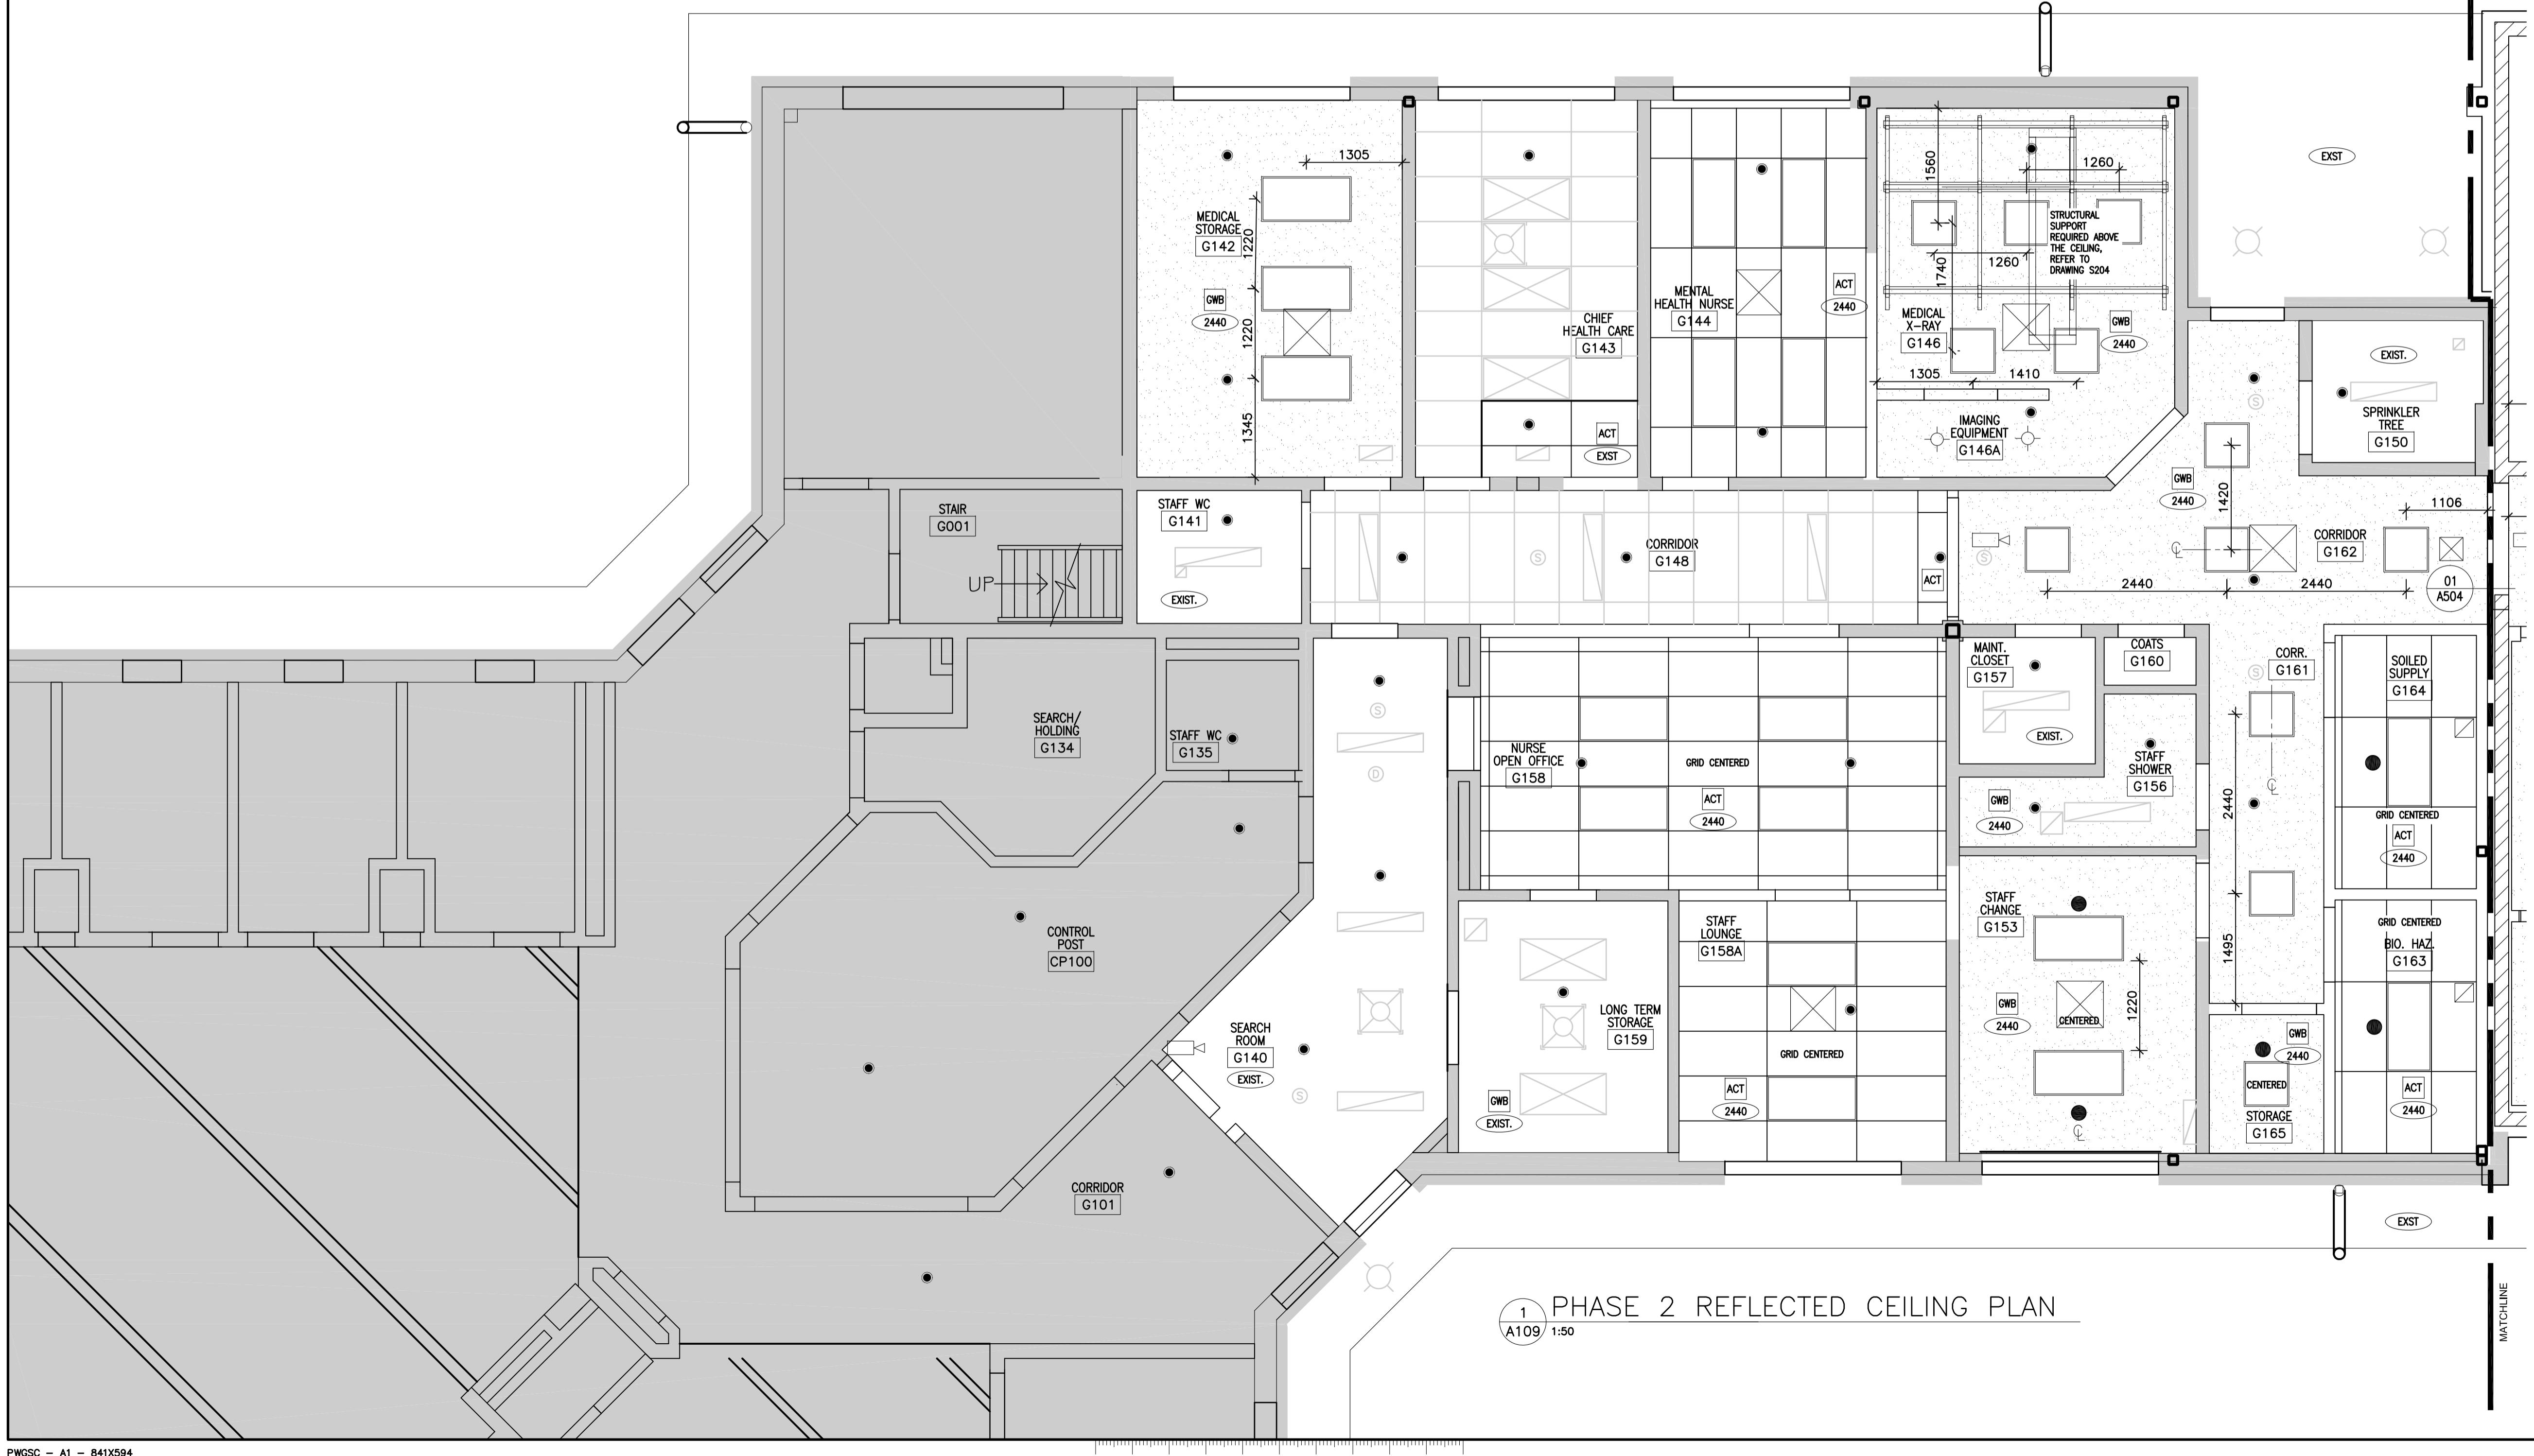

1 PHASE 2 REFLECTED CEILING PLAN
A109 1:50




ROOF PLAN LEGEND	
NOTE: REFER TO ROOF CONSTRUCTION TYPE KEY AND KEY PLAN FOR PROJECT SPECIFIC ROOF ASSEMBLY, TYPICAL	
	TAPERED INSULATION ON FLAT CONSTRUCTION W/ PITCH TO DRAIN
	CRICKET W/ PITCH TO DRAIN
	ROOF DETAIL
	RD
	RD
	RD/OD
	RAH
	EF
	VS
	PP
	GDS
	TRAFFIC PAD
	XX
	RH-1
	ROOF TOP PERIMETER BARBED WIRE AND BARBED RAZOR TAPE - SEE DETAIL 3/A508




ROOF CONSTRUCTION TYPES

(METAL DECK - SLOPED)	PREFINISHED 24 GA STEEL 25 mm DOUBLE-LOCK STANDING SEAM ROOF CLADDING @ 406 mm O.C. ON FASTENING SYSTEM ON SP SHEET 13 MM INSULATION OVERLAY BOARD, MECHANICALLY FASTENED 64mm 'Z' GIRTS PERPENDICULAR TO ROOF SLOPE WITH 64mm POLYISOCYANURATE BOARD INSULATION (RSI 2.64 MIN) 64mm 'Z' GIRTS PERPENDICULAR TO ROOF SLOPE 64 mm WITH 64 mm POLYISOCYANURATE BOARD INSULATION (RSI 2.64 MIN) VAPOUR RETARDER 13 mm ROOF SHEATHING, MECHANICALLY FASTENED 3.5 mm SHEET STEEL FASTENED W/ #12 SCREWS @ 400 MAX. O.C. TO 40 (NOM) X 0.91 GALVANIZED STEEL DECKING [SC2 SECURE CONSTRUCTION] STEEL STRUCTURE (REFER TO STRUCTURAL)
(R2)	SBS ROOF MEMBRANE SYSTEM 13 mm COMPOSITE COVER BOARD, ADHERED TAPERED FULLY ADHERED POLYISOCYANURATE INSULATION BOARDS 2 LAYERED TOTAL THICKNESS = 13 mm MIN. RSI 5.28 SELF ADHERED VAPOUR RETARDER 13mm DECK SHEATHING, ADHERED 65 mm CONCRETE TOPPING SLAB R/W 10M @ 300 mm OC E.W. MID DEPTH [SC2 SECURE CONSTRUCTION] 40 (NOM) X 0.91 GALVANIZED STEEL DECKING STRUCTURAL STEEL FRAMING (REFER TO STRUCTURAL)

ROOF PLAN NOTES:

- ALL ROOF PENETRATIONS FOR WIRING, CONDUIT AND REFRIGERATION LINES TO HAVE A WEATHER-PROOF GOOSENECK ROOF OPENING COVER, SUPPLIED AND INSTALLED BY THE CONTRACTOR, TYP.
- MAINTAIN MINIMUM 3048mm SEPARATION BETWEEN EXHAUSTS AND NEAREST FRESH AIR INTAKES, TYP.
- PROVIDE CRICKETS (SLOPE INSULATION) AT ALL ROOF TOP EQUIPMENT AND ROOF HATCH TO MAINTAIN POSITIVE SLOPE TO DRAINS, TYP.
- MECHANICAL ROOFTOP FANS, VENTS, ETC ARE SHOWN FOR REFERENCE ONLY. REFER TO MECHANICAL DRAWINGS FOR EXACT SIZE AND LOCATION.
- UNLESS OTHERWISE EXPLICITLY NOTED, ALL NEW EQUIPMENT, PRODUCTS, DEVICES AND MATERIAL SHALL BE SUPPLIED AND INSTALLED BY THE CONTRACTOR.
- ALL PLUMBING VENT STACKS MUST EXTEND A MINIMUM 305mm ABOVE THE FINISHED ROOF SURFACE AND BE FLASHED IN ACCORDANCE WITH MANUFACTURER'S SPECIFICATIONS.
- CONTRACTOR TO PROVIDE BLOCKING AS REQUIRED TO ENSURE CONTINUOUS FASCIA/COPING DIMENSIONS FOR EACH ROOF AREA, TO MAINTAIN CLEARANCE WITH THE HIGH POINT OF THE INSULATION AT ALL PARAPETS, TYP.
- ROOF DRAINS LOCATIONS ARE INDICATED DIAGRAMMATICALLY AND MUST BE COORDINATED IN THE FIELD TO INSTALL NEW DRAINS AT THE LOWEST POINT OF THE ROOF PITCH.
- TOP OF PARAPET WALLS MUST PITCH BACK TOWARD ROOF AT A 5% MINIMUM SLOPE.

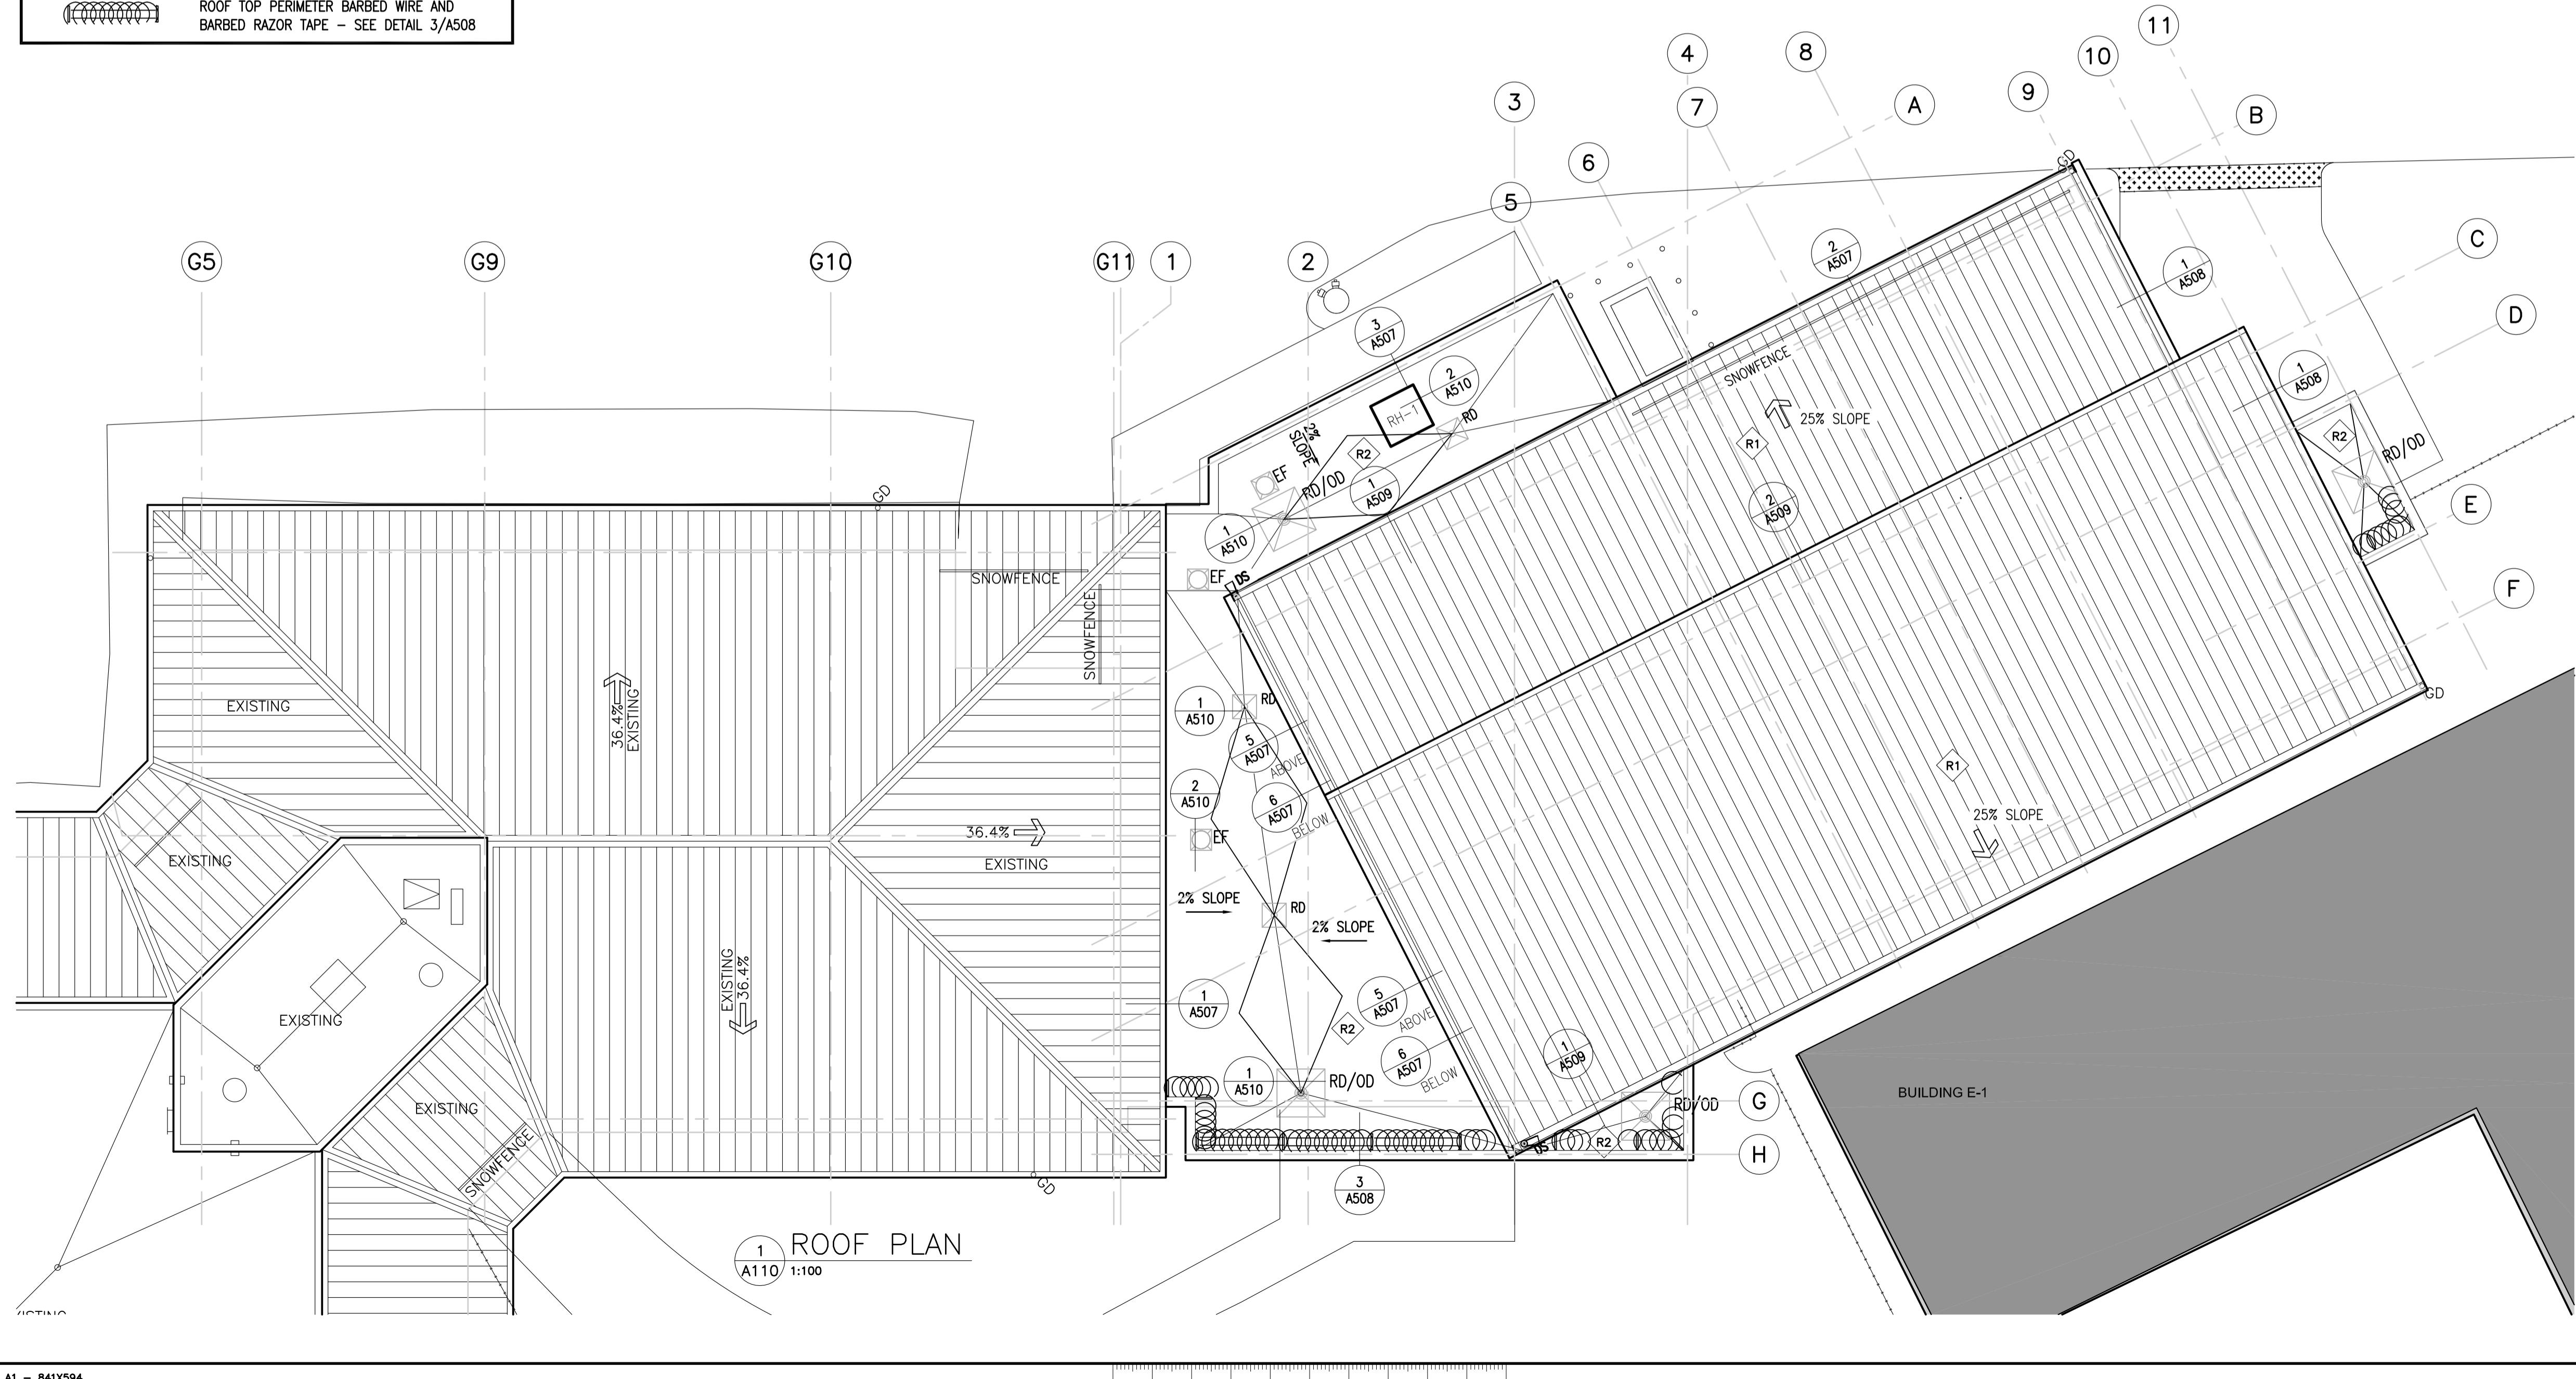

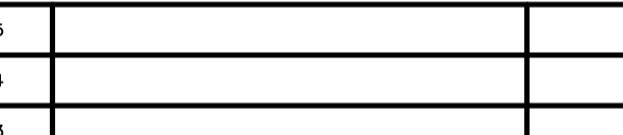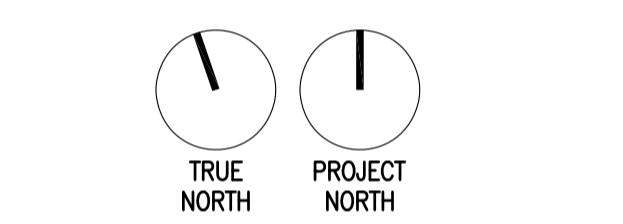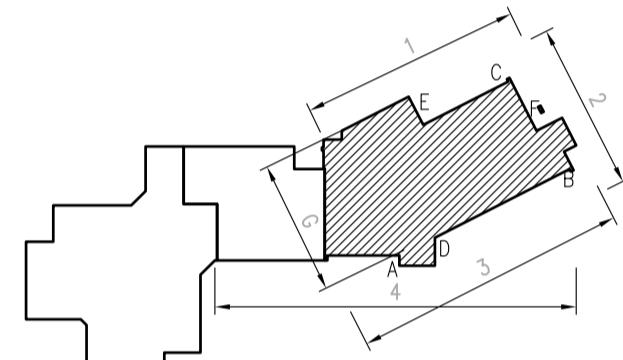

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AGASSIZ, BRITISH COLUMBIA
4732 CEMETARY ROAD PO BOX 1600
MOUNTAIN INSTITUTE

MOUNTAIN INSTITUTE HEALTH CARE EXPANSION

Consultant Signature Only

Designed by/Concept par
EDWIN BERZINS

Drawn by/Desiné par
BEN MONROE (2017-09-28)


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TONY TANG


Regional Manager, Architectural and Engineering Services
Gestionnaire régionale, Services d'architectural et de génie, TPSGC
PREETPAL PAUL

Drawing title/Titre du dessin

BUILDING ELEVATIONS

Project No./No. du projet	Sheet/Feuille	Revision no./ Révision no.
R.077724.001	A201	0
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 TRUE NORTH
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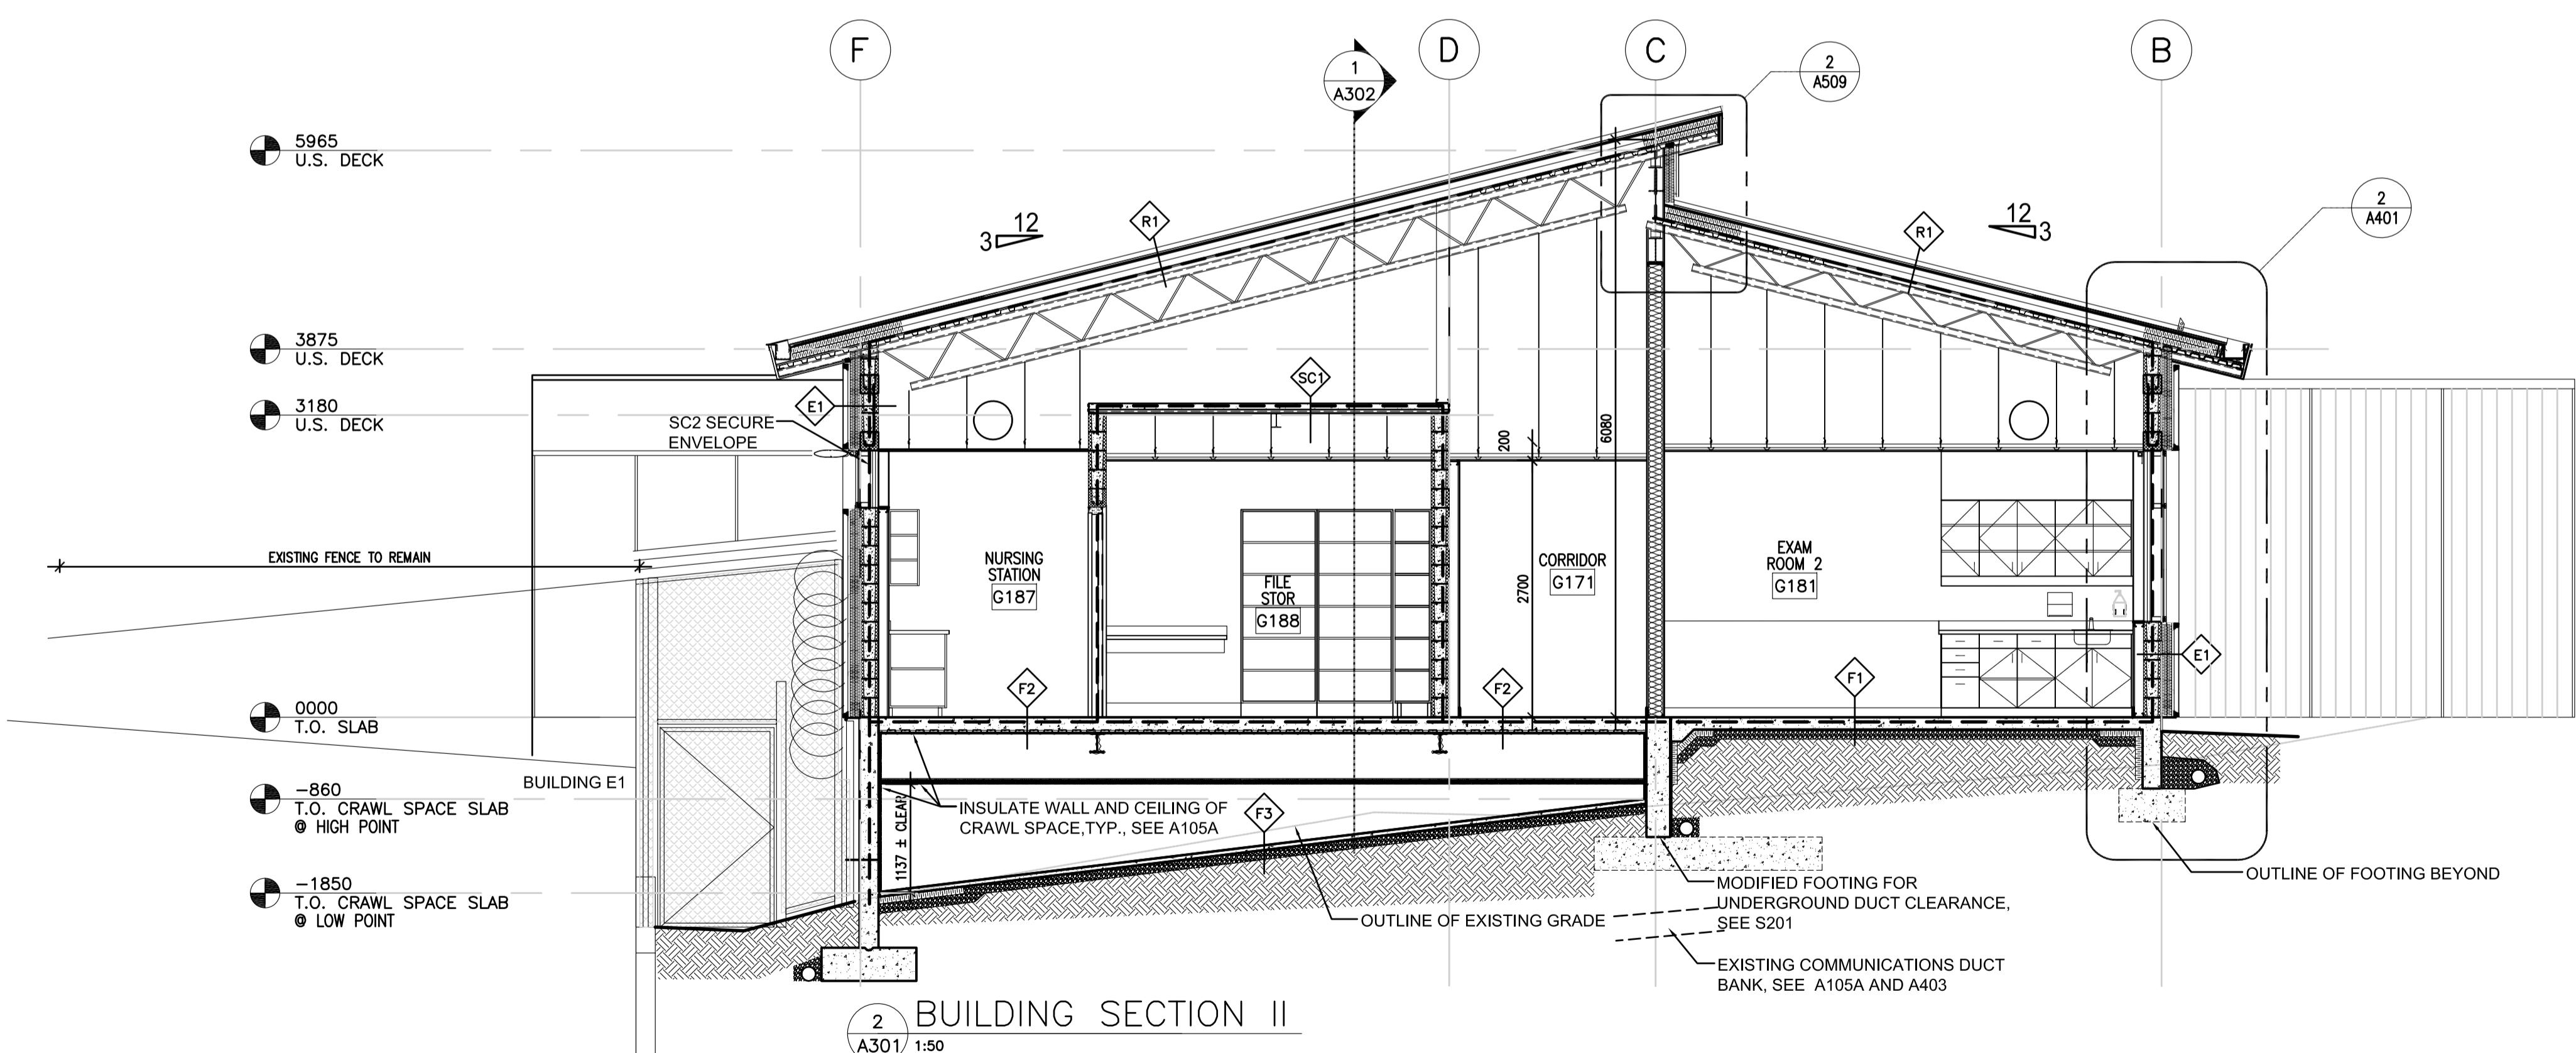
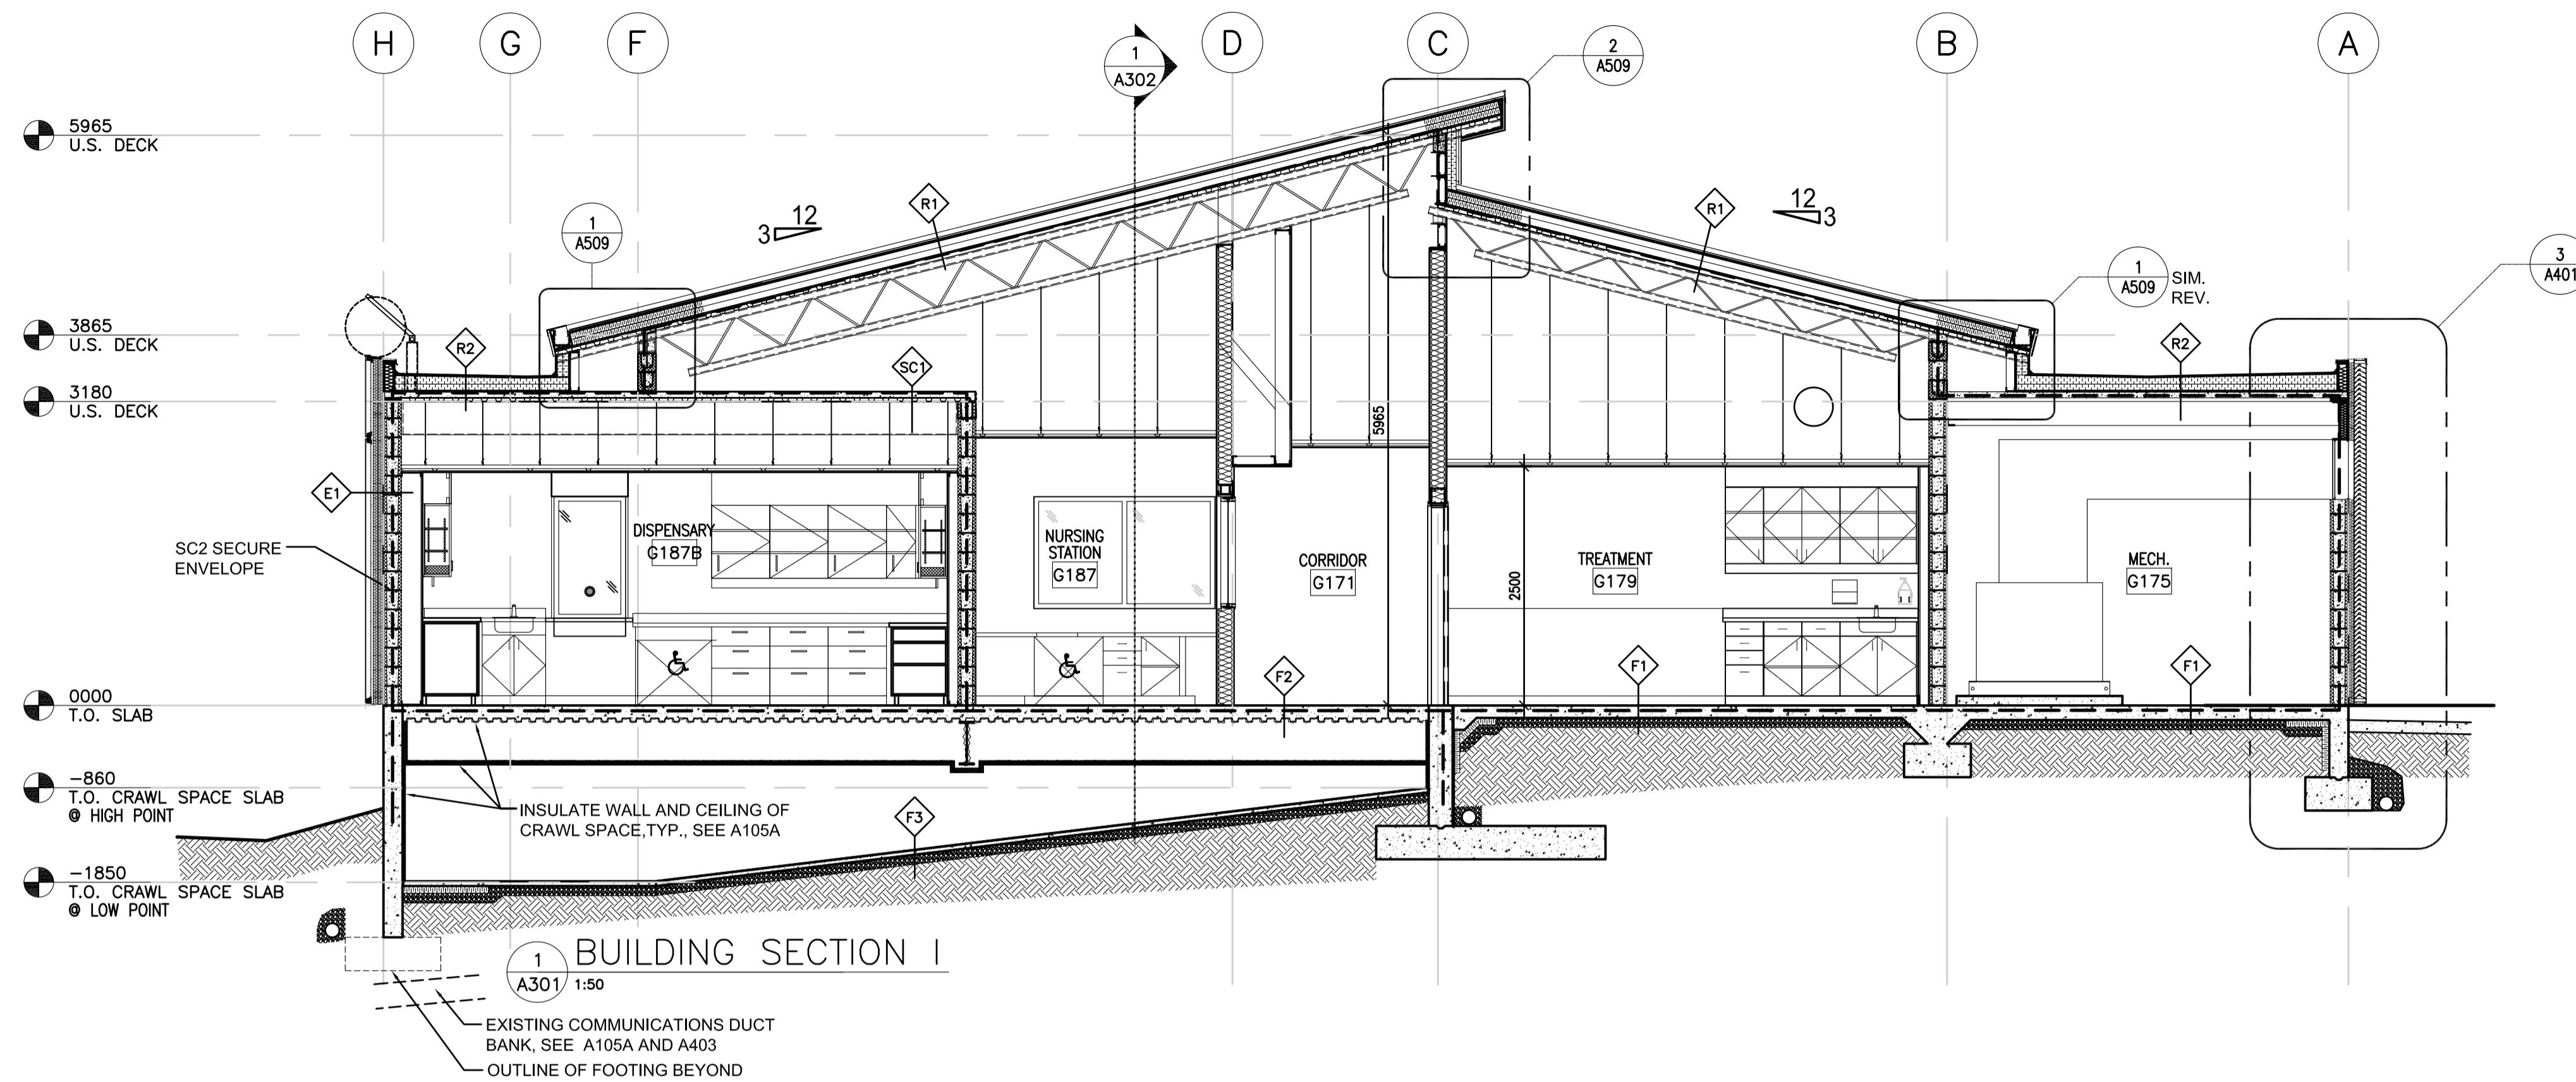
Project title/Titre du projet
AGASSIZ, BRITISH COLUMBIA
 4732 CEMETERY ROAD PO BOX 1600
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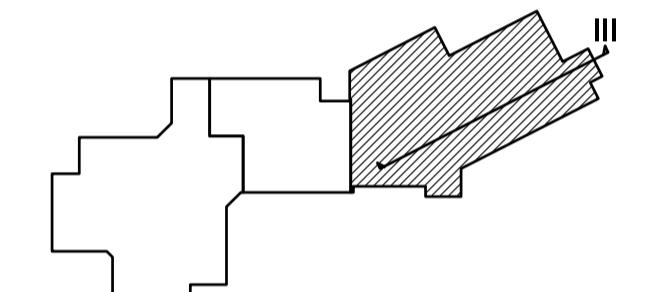
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 Designed by/Conçue par
EDWIN BERZINS
 Drawn by/Dessiné par
BEN MONROE (2017-09-28)
 PWGSC Project Manager/Administrateur de Projets TPSGC
TONY TANG
 Regional Manager, Architectural and Engineering Services
 Gestionnaire régionale, Services d'architecture et de génie, TPSGC
PREETPAL PAUL
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BUILDING SECTIONS

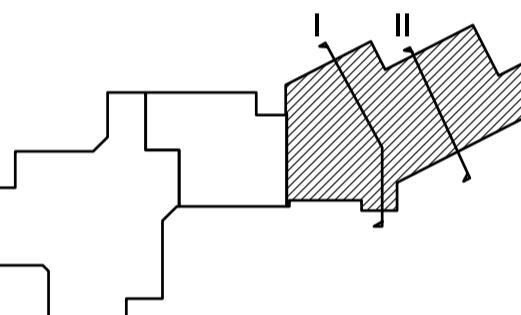Project No./No. du projet	Sheet/Feuille A301	Revision no./ La Révision no. 0
R.077724.001	OF 02	

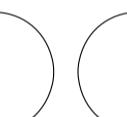



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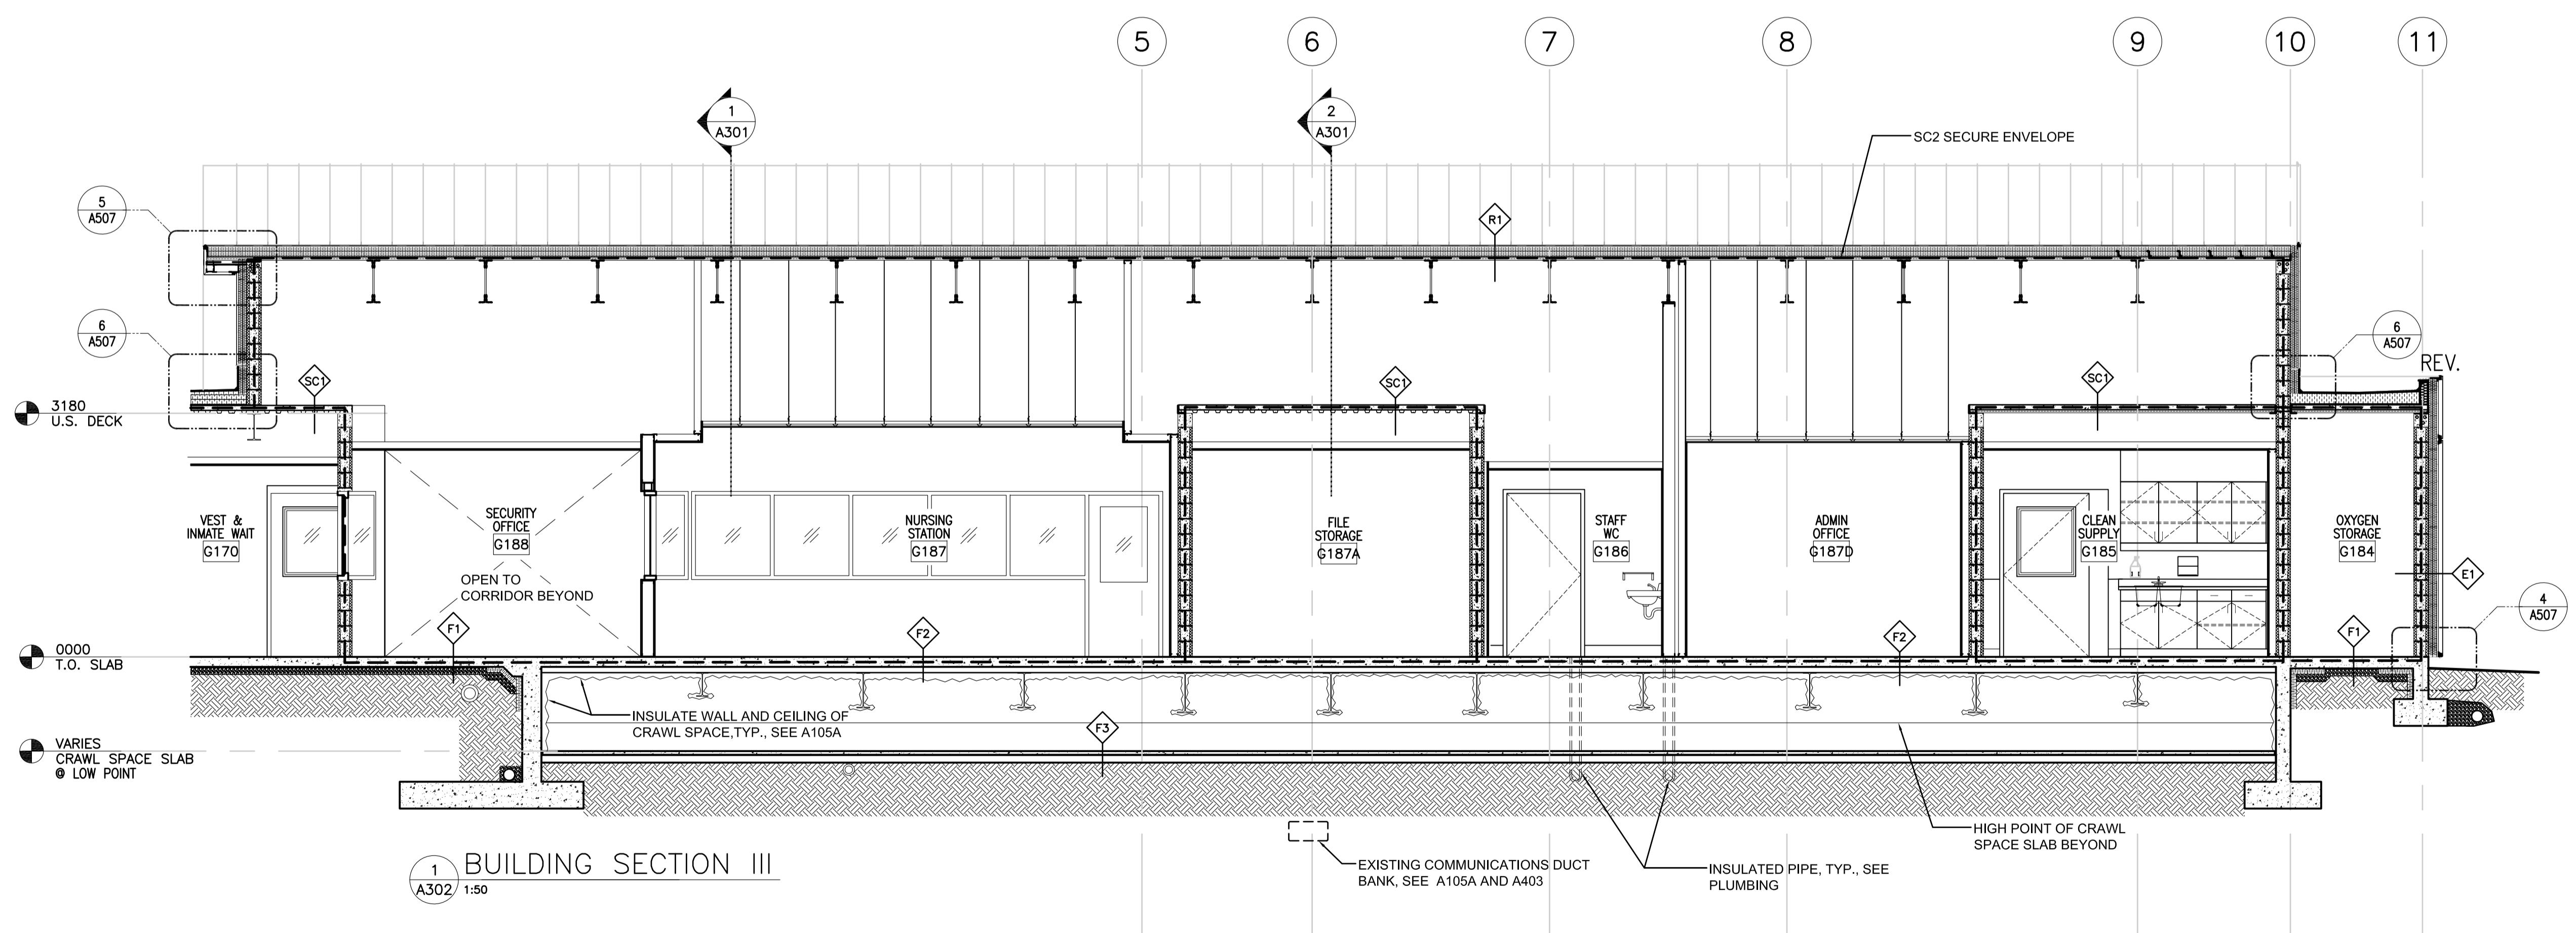
PWGS Project Manager/Administrateur de Projets TPSGC
TONY TANG

Regional Manager, Architectural and Engineering Services
 Gestionnaire régionale, Services d'architecture et de génie, TPSGC
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R.077724.001	A302	0





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by/Concept par
BERZINS


y/Dessine par
NROE (2017-09-28)

Project Manager/Administrateur de Projets TPSGC
ANG

Manager, Architectural and Engineering Services
ire régionale, Services d'architectural et de génie, TPSGC
PAL PAUL

SECTIONS 1



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WALL SECTION

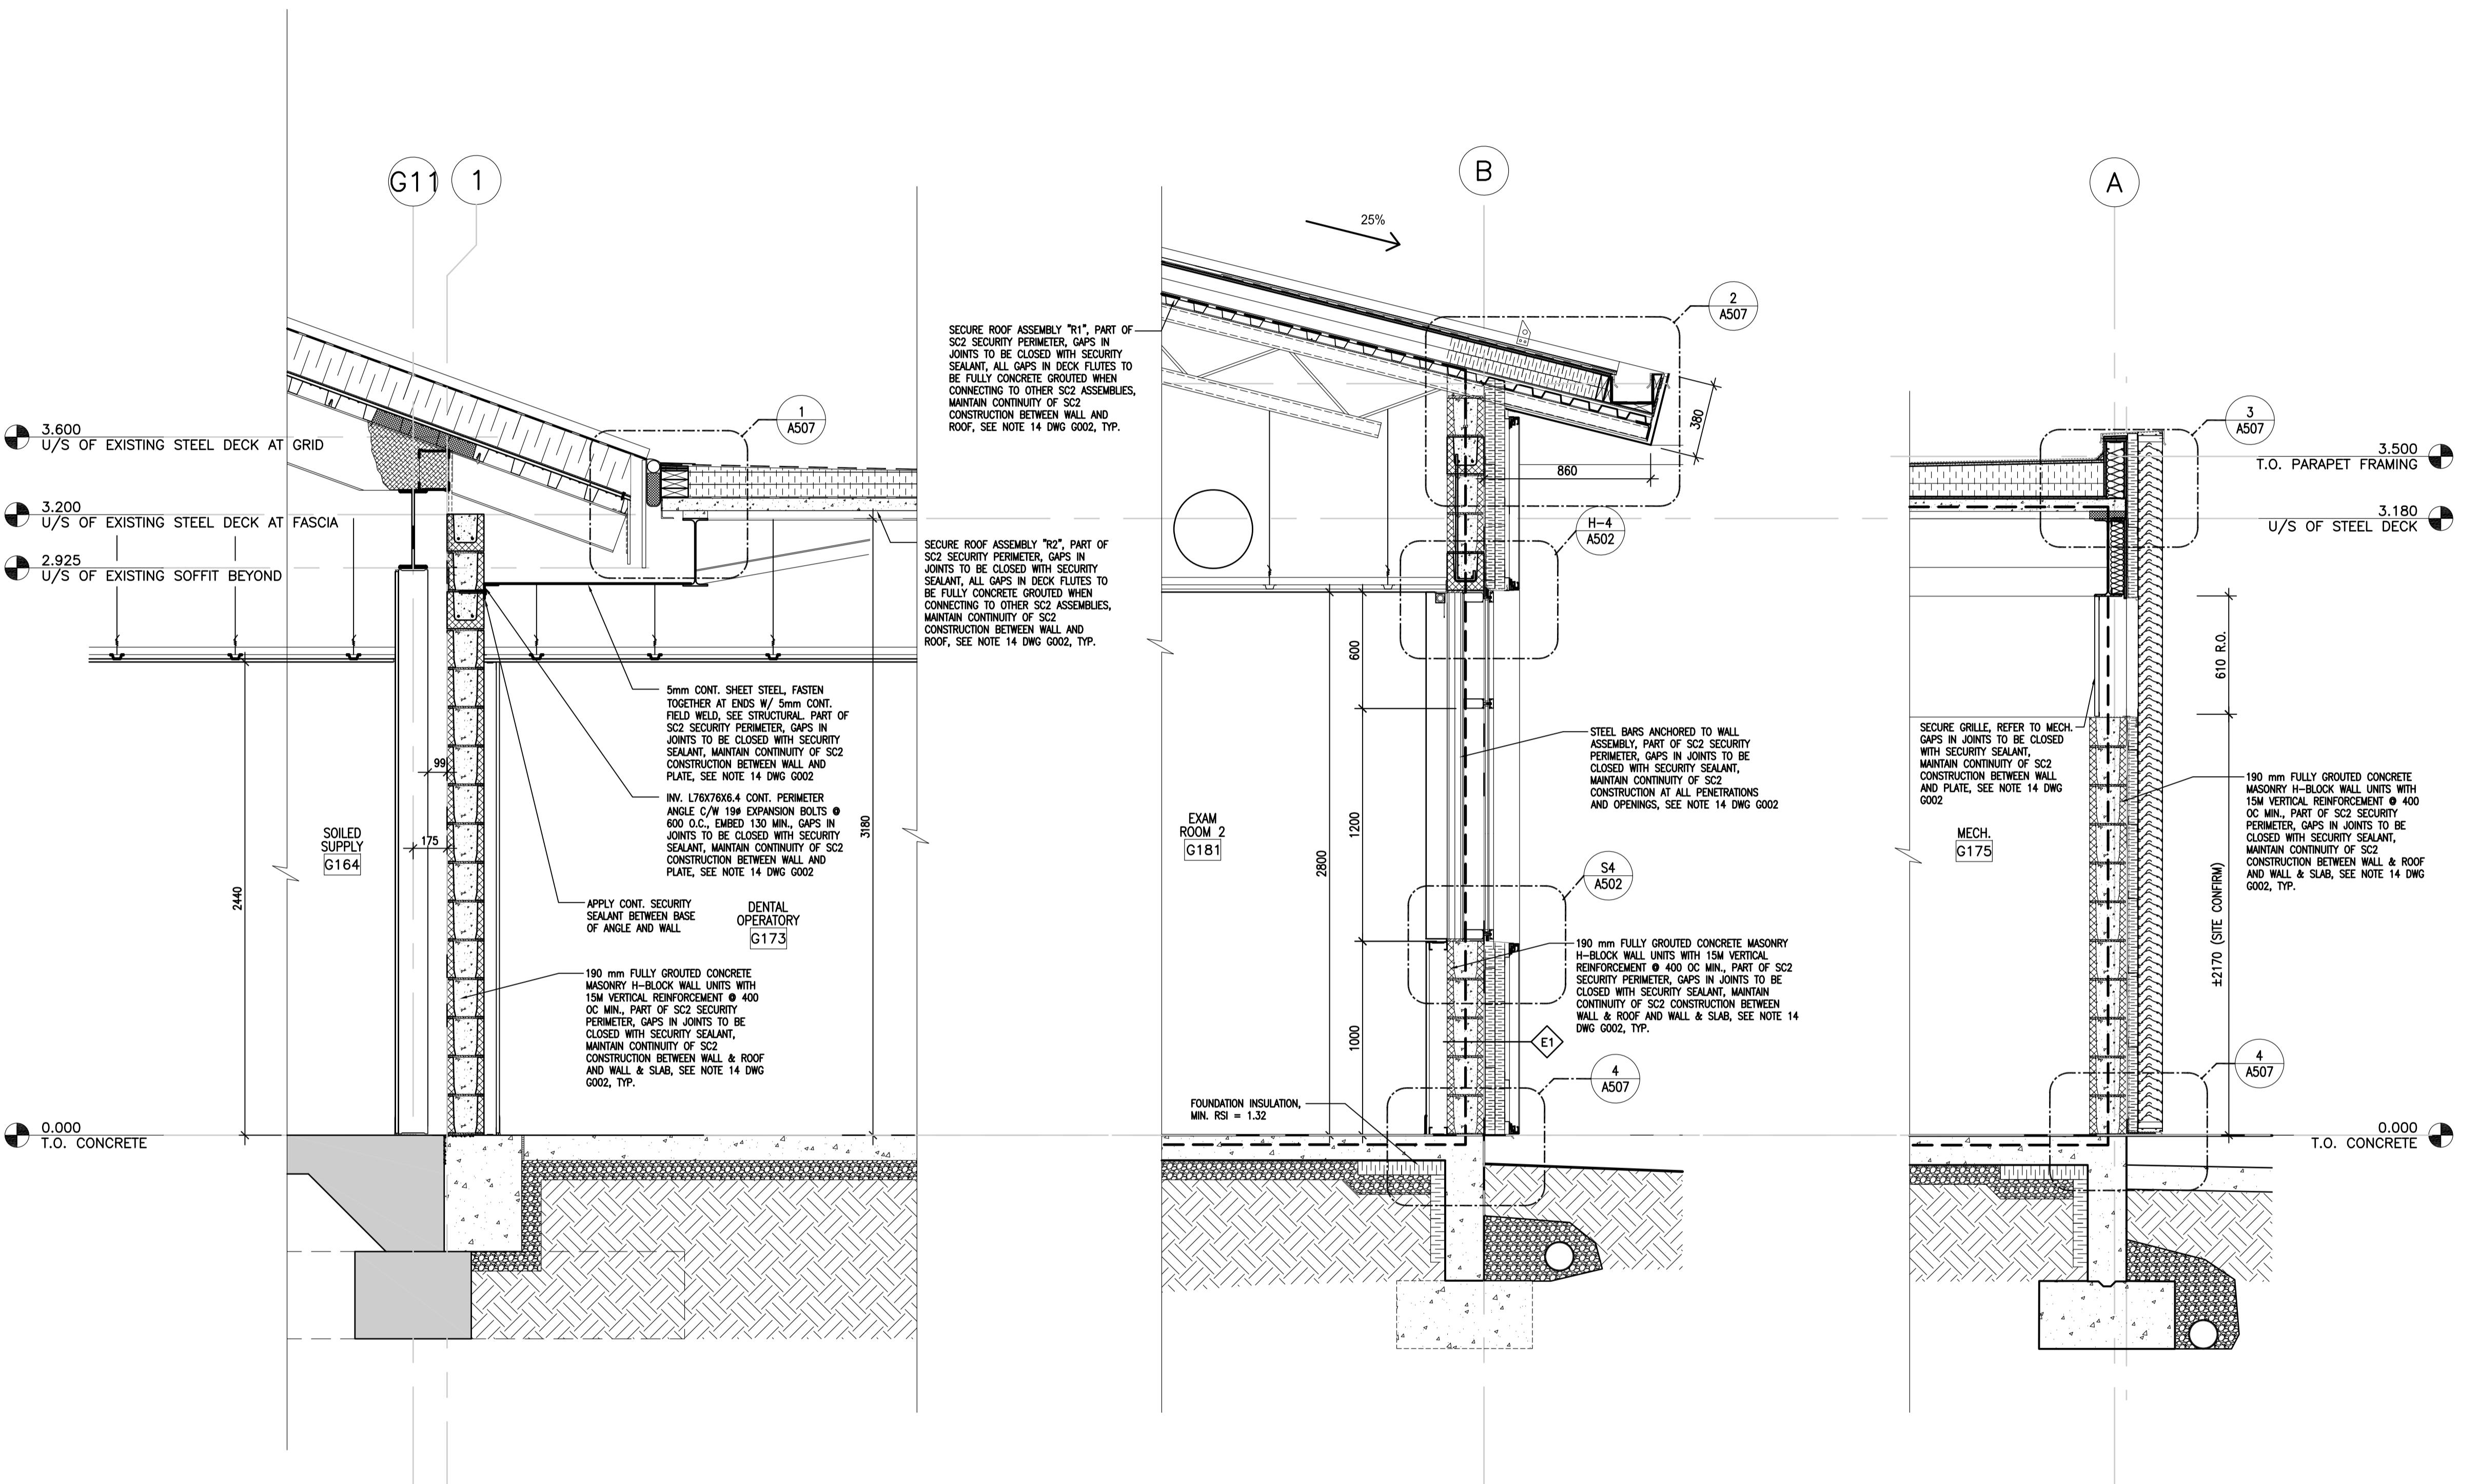WALL SECTION

WALL SECTION



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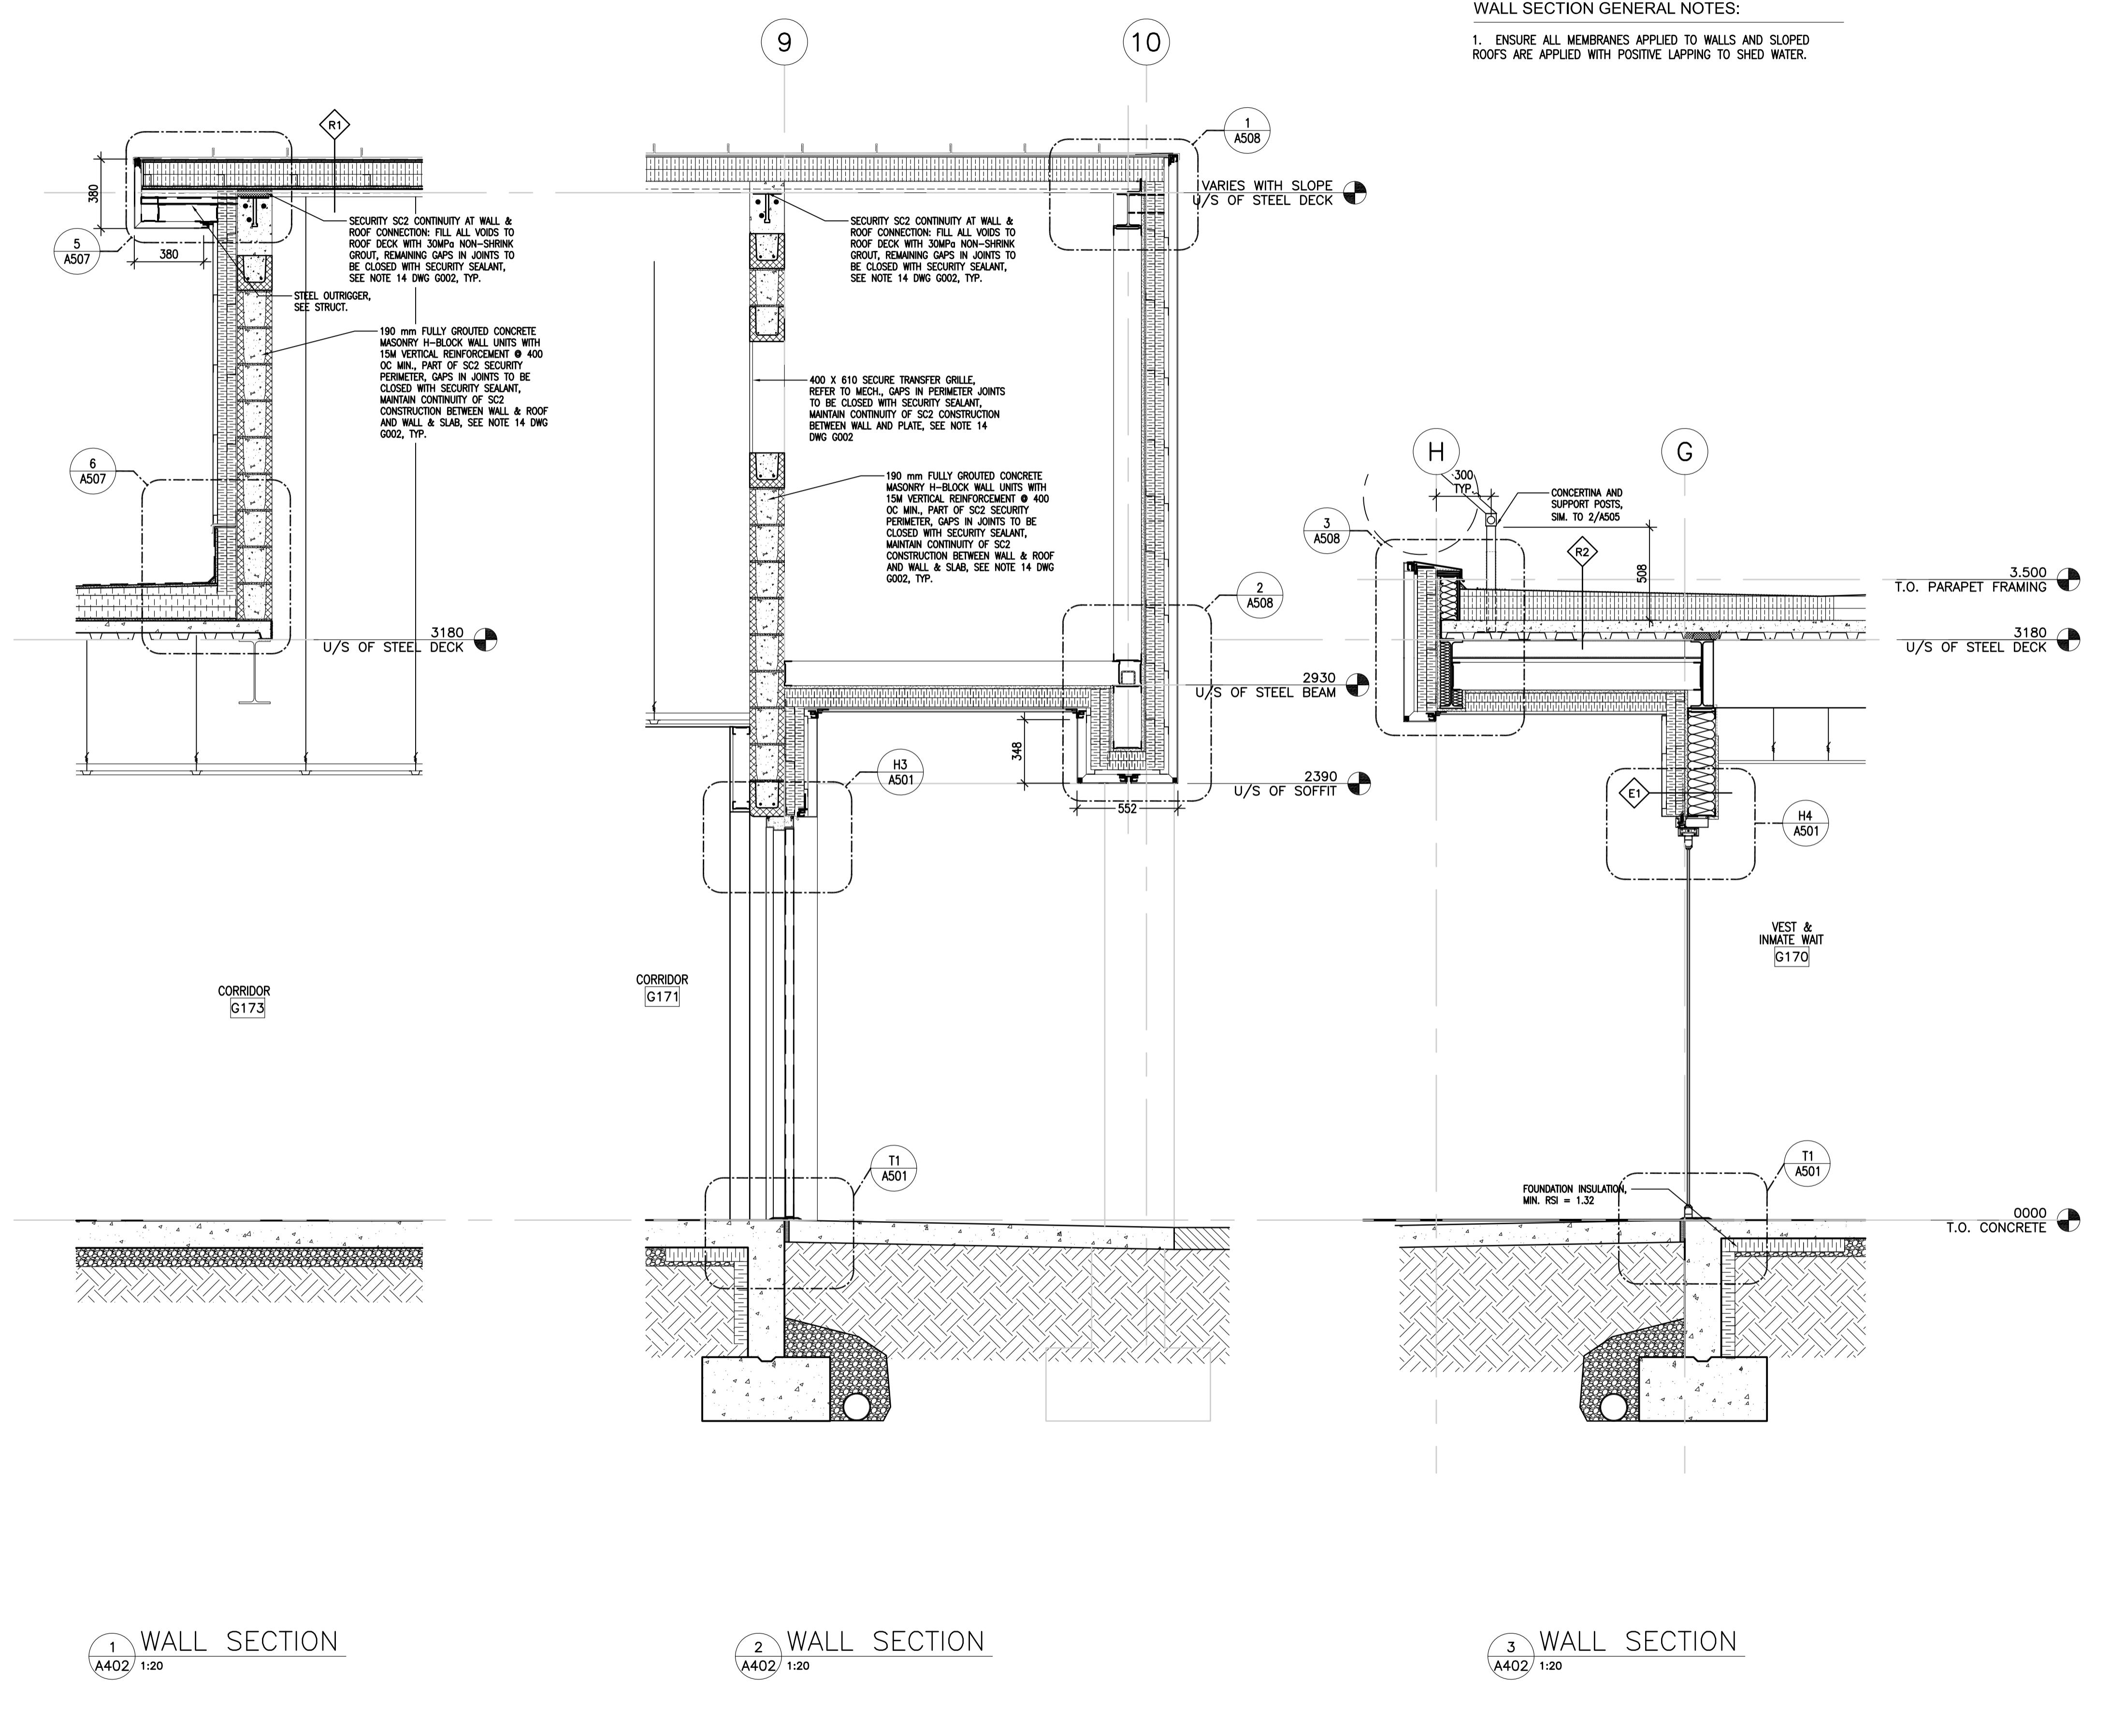
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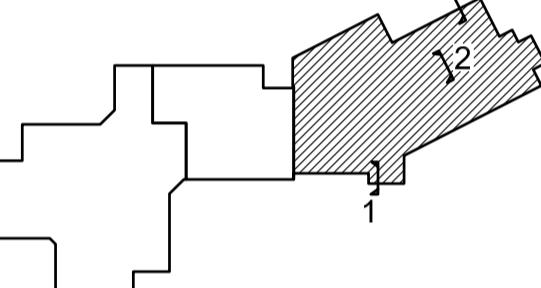
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EDWIN BERZINS
 Drawn by/Dessiné par
BEN MONROE (2017-09-28)
 PWGSC Project Manager/Administrateur de Projets TPSGC
TONY TANG
 Regional Manager, Architectural and Engineering Services
 Gestionnaire régionale, Services d'architectural et de génie, TPSGC
PREETPAL PAUL
 Drawing title/Titre du dessin

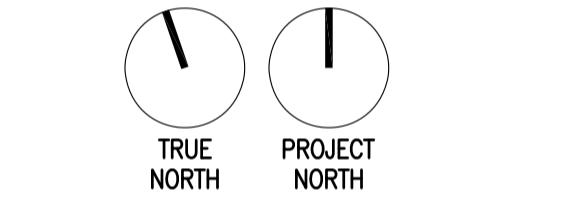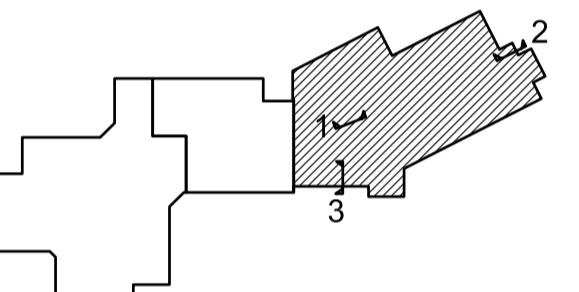WALL SECTIONS 2

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R.077724.001	A402	0
OF 03		





TRUE
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PROJECT
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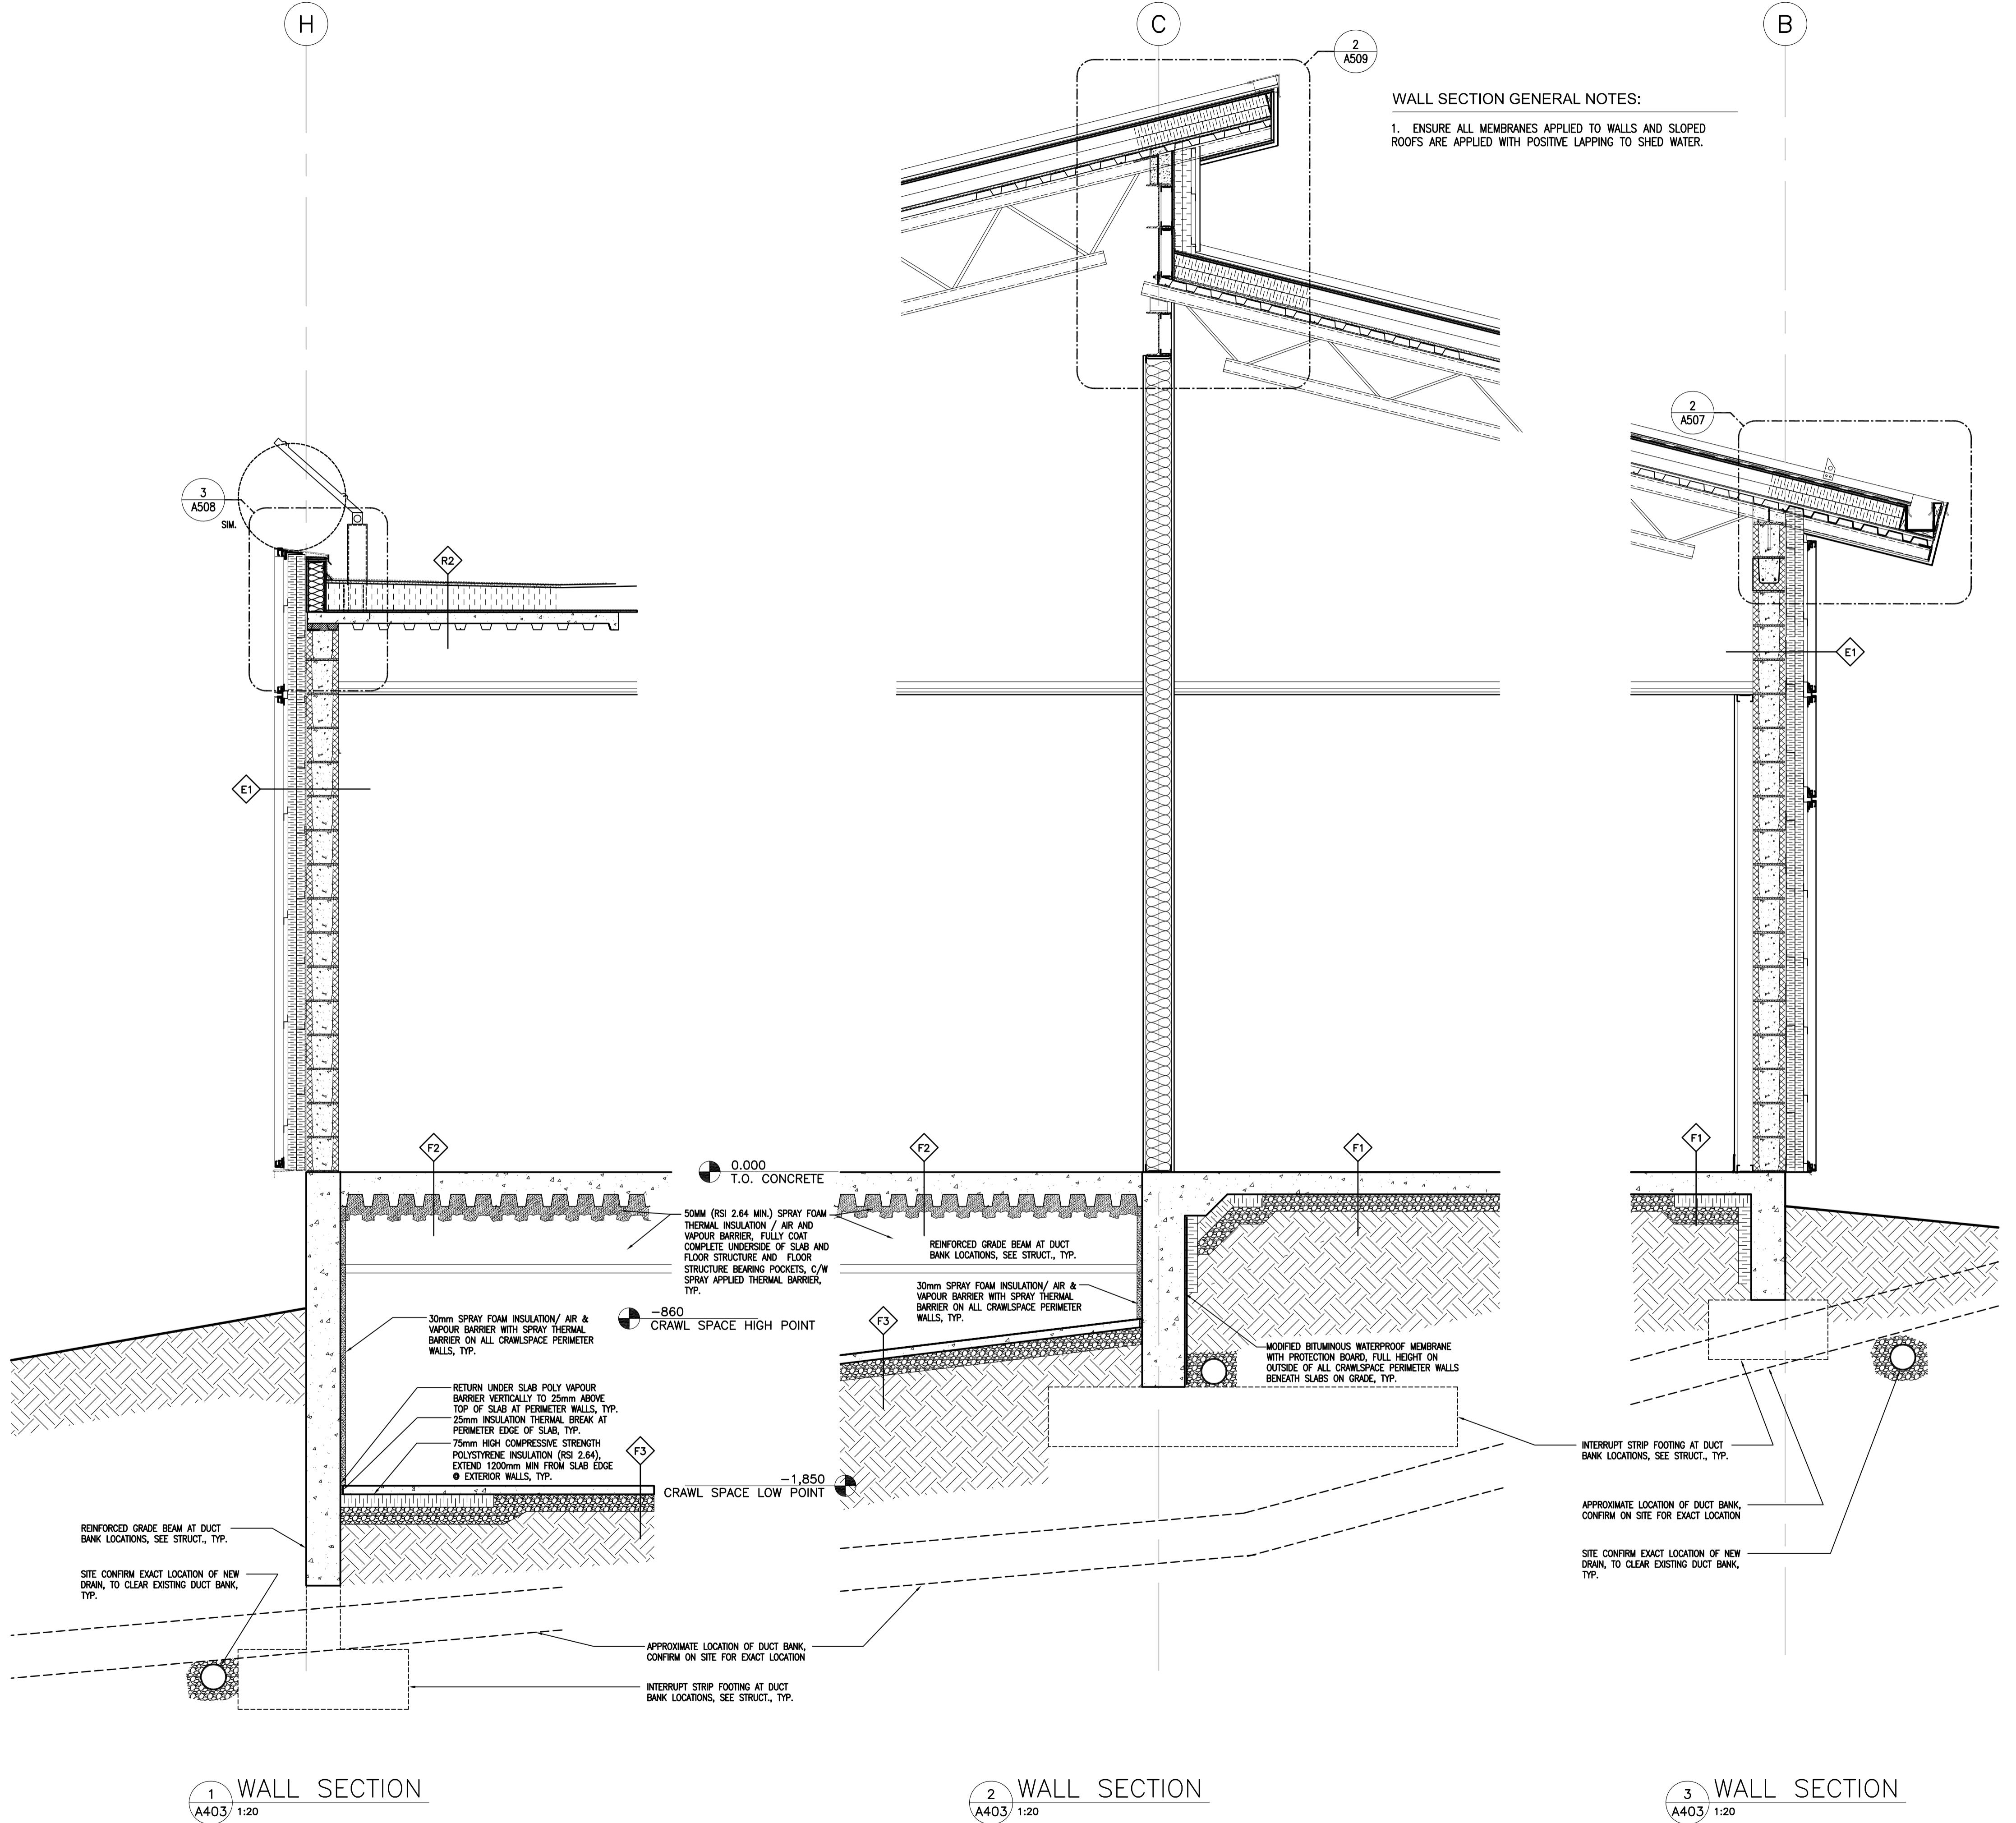
MOUNTAIN INSTITUTE HEALTH CARE EXPANSION

Consultant Signature Only
Designed by/Concept par
EDWIN BERZINS
Drawn by/Desiné par
BEN MONROE (2017-09-28)
PWGSC Project Manager/Administrateur de Projets TPSGC
TONY TANG
Regional Manager, Architectural and Engineering Services
Gestionnaire régionale, Services d'architecture et de génie, TPSGC
PREETPAL PAUL

Drawing title/Titre du dessin

WALL SECTIONS 3

Project No./No. du projet	Sheet/Feuille A403	Revision no./ La Révision no. 0
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DETENTION DOOR STYLE AND FRAME TYPES

01 A501 1 : 25

STYLE A - SEE A501B
STYLES F TO I - NOT USED
STYLE J - SEE A501B
HM-1 - SEE A501B

HM-2-DD1 FRAME HM-3-DD1 FRAME

DETENTION FRAME HEADER DETAILS

02 A501 1 : 5

H-2 DETENTION CMU PARTITION H-3 DETENTION EXTERIOR WALL H-7 DETENTION CONCRETE FOUNDATION WALL

DETENTION FRAME JAMB DETAILS

03 A501 1 : 5

J-2 DETENTION CMU PARTITION J-3 DETENTION EXTERIOR WALL

DETENTION DOOR THRESHOLD/SILL DETAILS

04 A501 1 : 5

T-1 DETENTION THERMALLY BROKEN, ALUMINUM S-7 DETENTION CONCRETE FOUNDATION WALL

DETENTION DOOR SPECIALTY DETAILS

05 A501 1 : 5

(1) 15M HOOK SECURITY REINFORCEMENT ANCHOR @ 400mm O.C. @ HEADER
(2) 15M HORIZONTAL STRUCTURAL REINFORCEMENT @ HEADER, EXTEND 400 mm MIN. BEYOND OPENING, SEE STRUCTURAL
NEW MASONRY BLOCK HEADER
(2) 15M STRUCTURAL VERTICAL REINFORCEMENT EACH SIDE, SEE STRUCTURAL
NEW MASONRY BLOCK JAMBS EACH SIDE
(1) 15M HORIZONTAL SECURITY REINFORCEMENT @ 600mm O.C., HOOK SHAPED REINFORCEMENT EMBEDDED 150 mm MIN. IN NEW GROUT IN EXISTING MASONRY BLOCK.
EXISTING MASONRY WALL TO REMAIN SHOWN SHADED.
(1) 15MX850 STRUCTURAL REINFORCEMENT DOWELLED AND EPOXY GROUTED 150 MM INTO EXISTING, EACH SIDE, SEE STRUCTURAL
ALIGN NEW MASONRY WITH EXISTING COURSING

CORRECTIONAL SERVICE OF CANADA

Project Title/Titre du projet: AGASSIZ, BRITISH COLUMBIA
4732 CEMETERY ROAD PO BOX 1600
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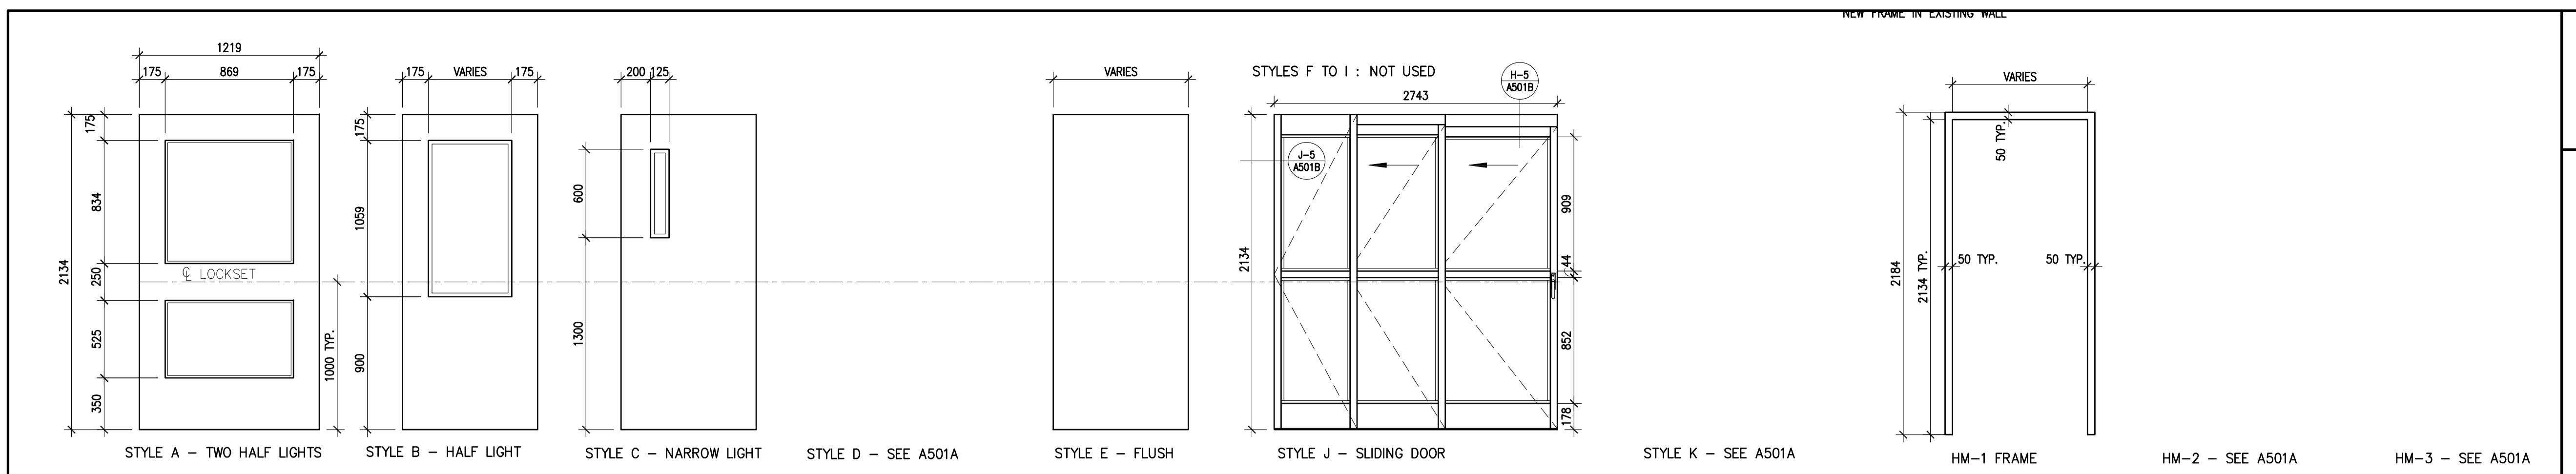
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Description/Description: ISSUED FOR TENDER
Date/Date: 17/09/01
Client/Client:

MOUNTAIN INSTITUTE HEALTH CARE EXPANSION

Consultant Signature Only
Designed by/Concept par: EDWIN BERZINS
Drawn by/Desiné par: BEN MONROE
PWGSC Project Manager/Administrateur de Projets TPSGC: TONY TANG
Regional Manager, Architectural and Engineering Services/Gestionnaire régionale, Services d'architecture et de génie, TPSGC: PREETPAL PAUL
Drawing title/Titre du dessin: DETENTION DOOR AND FRAME ELEVATIONS AND DETAILS





Project No./No. du projet: R.077724.001
Sheet/Feuille: A501A
Revision no./No. de Révision: 0
OF 13

0 4 3 2 1 0 ISSUED FOR TENDER 17/09/01
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Client/Client



STANDARD DOOR STYLE AND FRAME TYPES





01 A501B 1 : 25

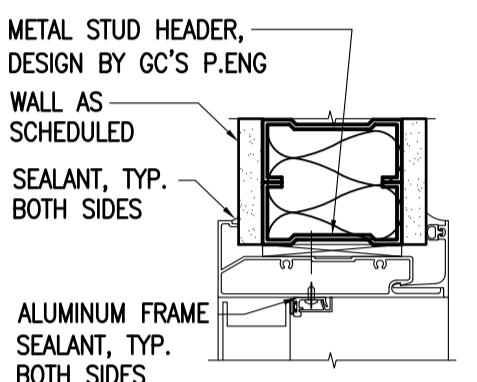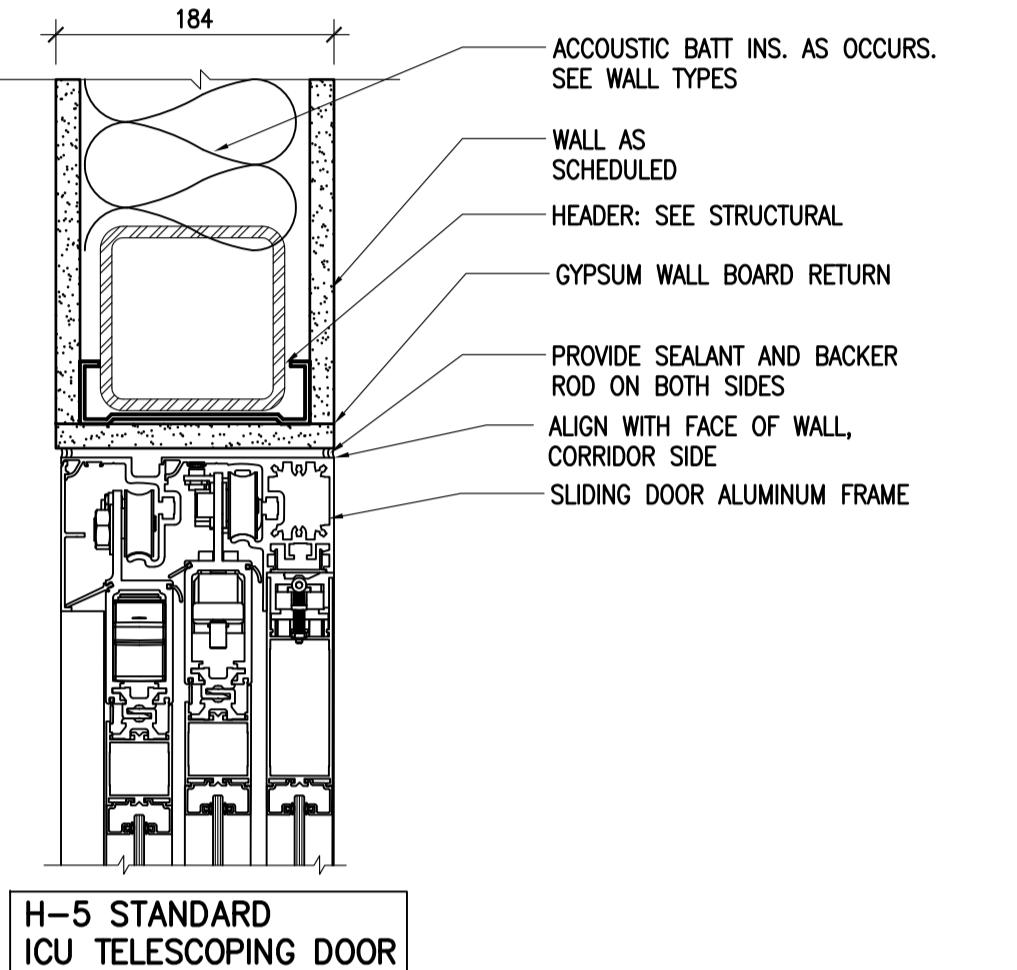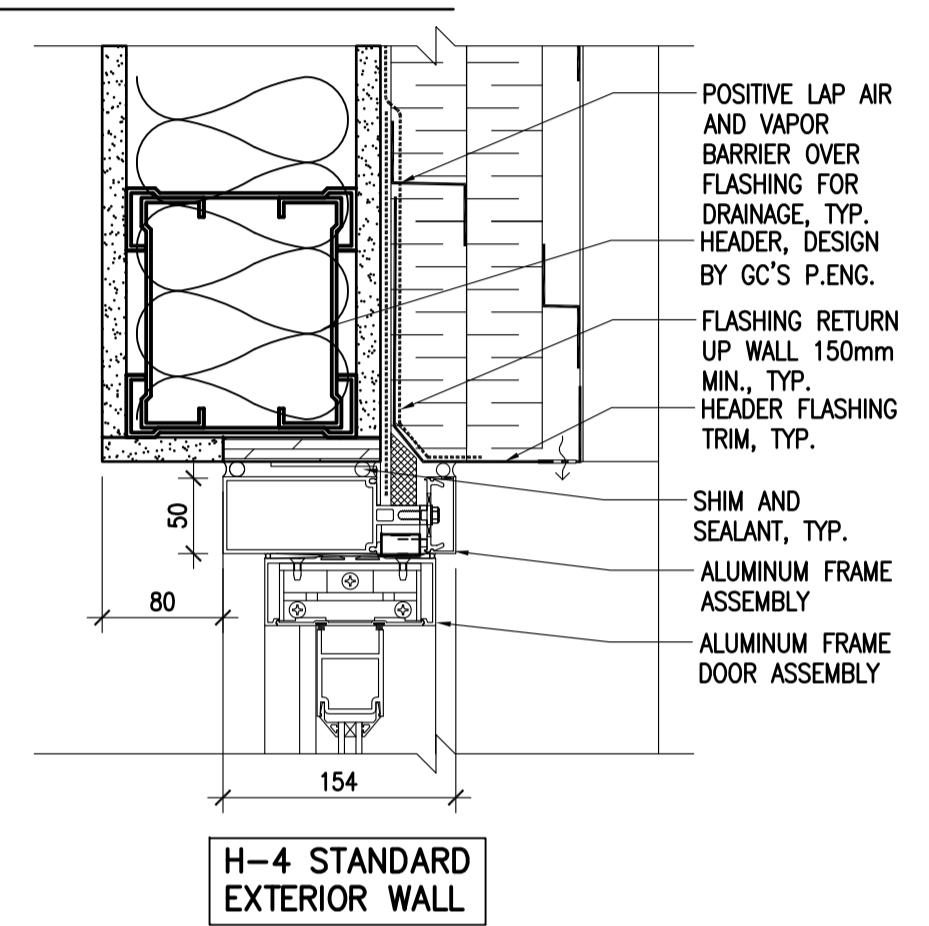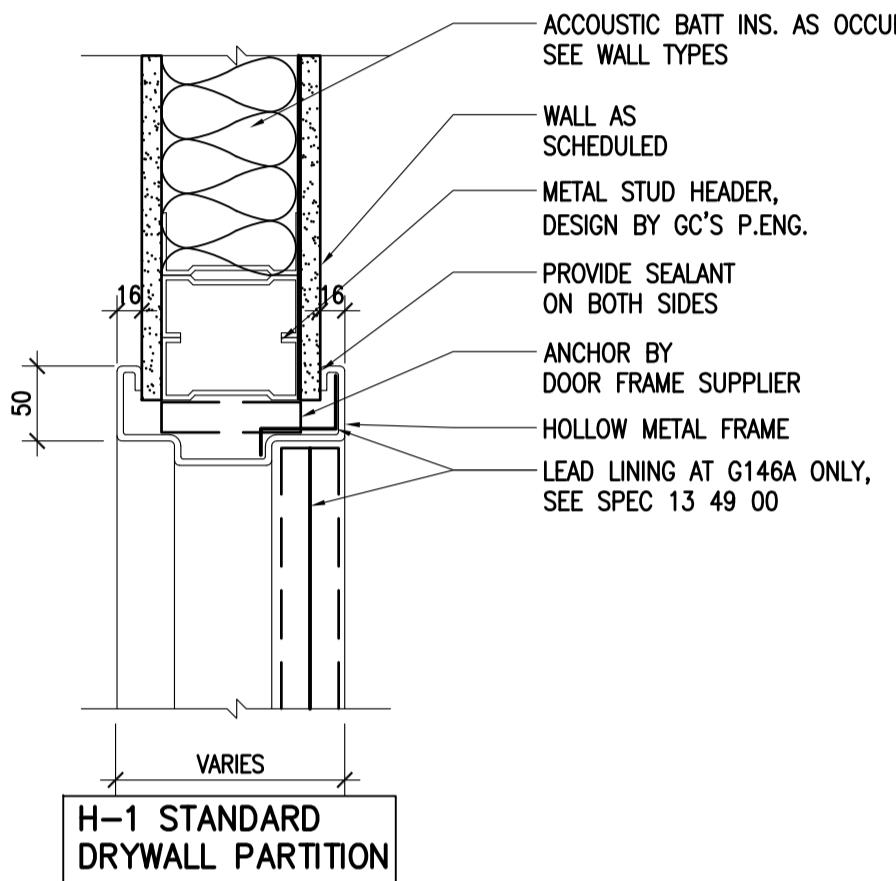

H-6 STANDARD
INTERIOR ALUMINUM FRAME



STANDARD HEADER DETAILS

02 A501B 1 : 5

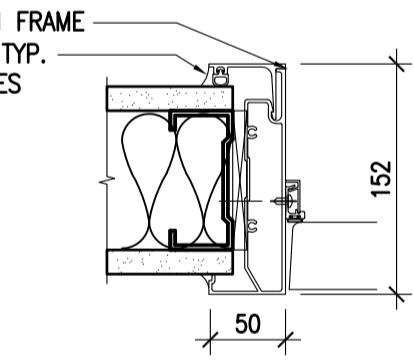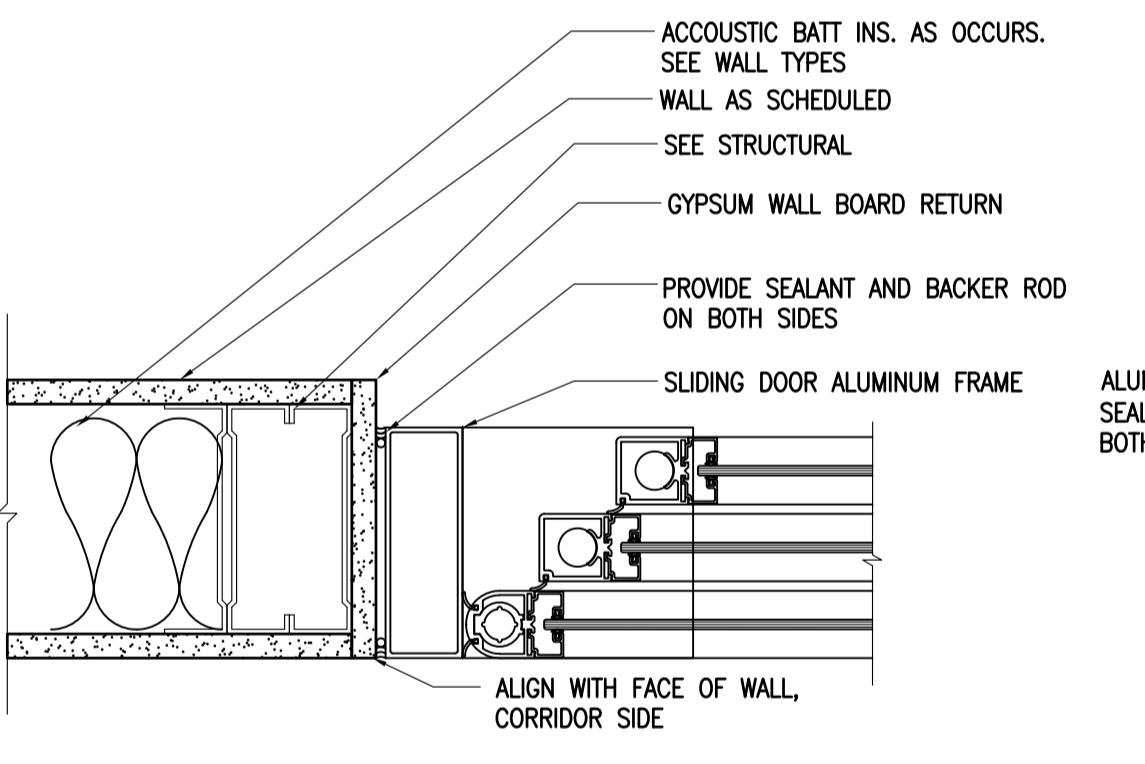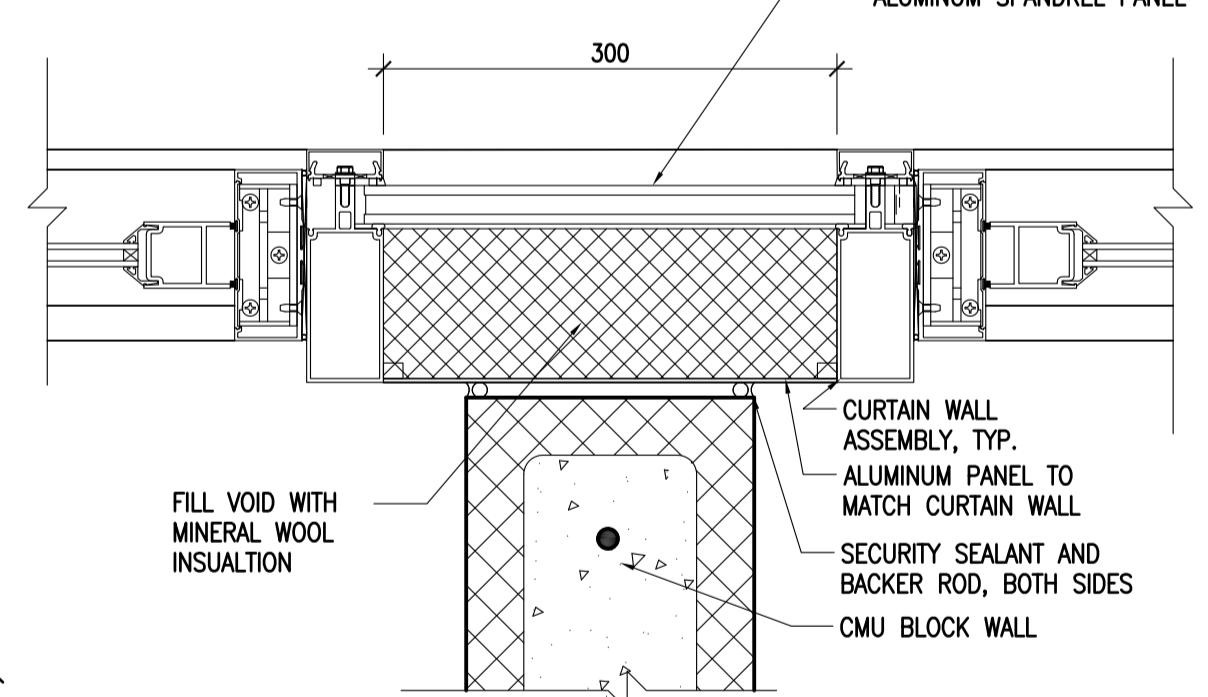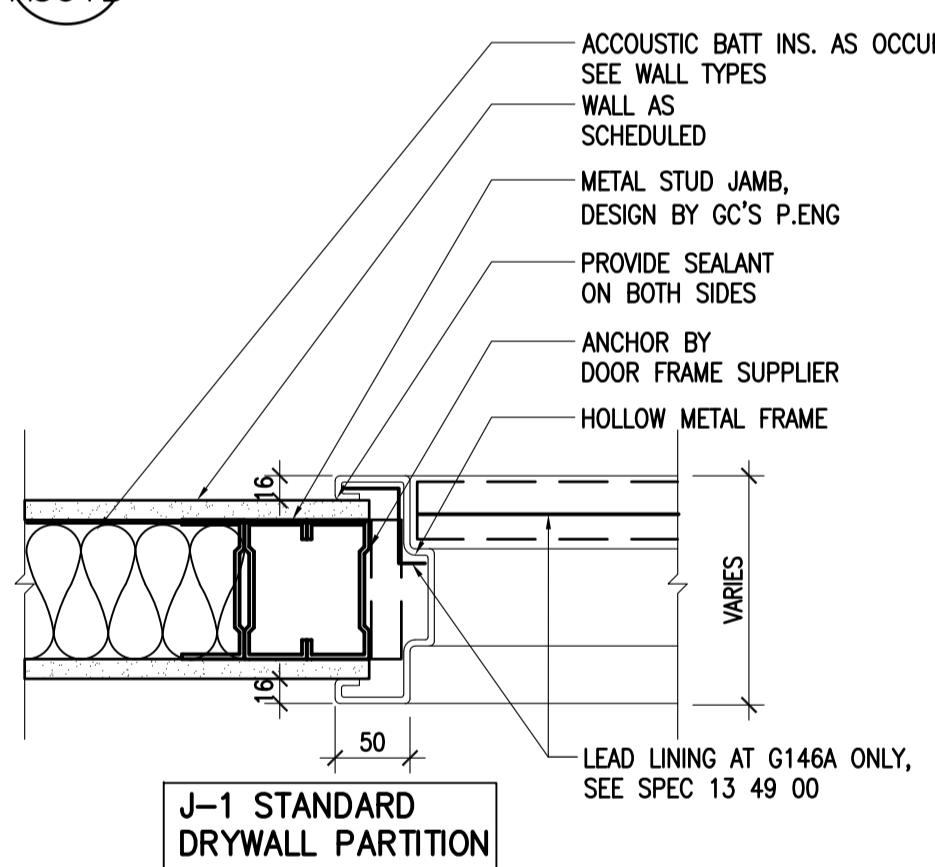

STANDARD JAMB DETAILS

03 A501B 1 : 5

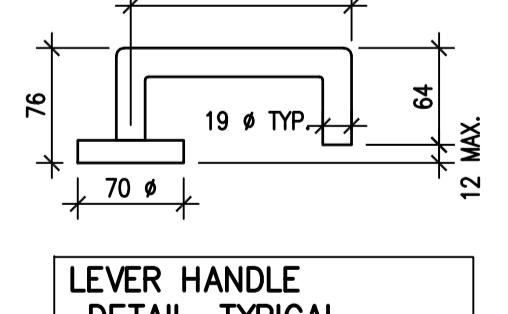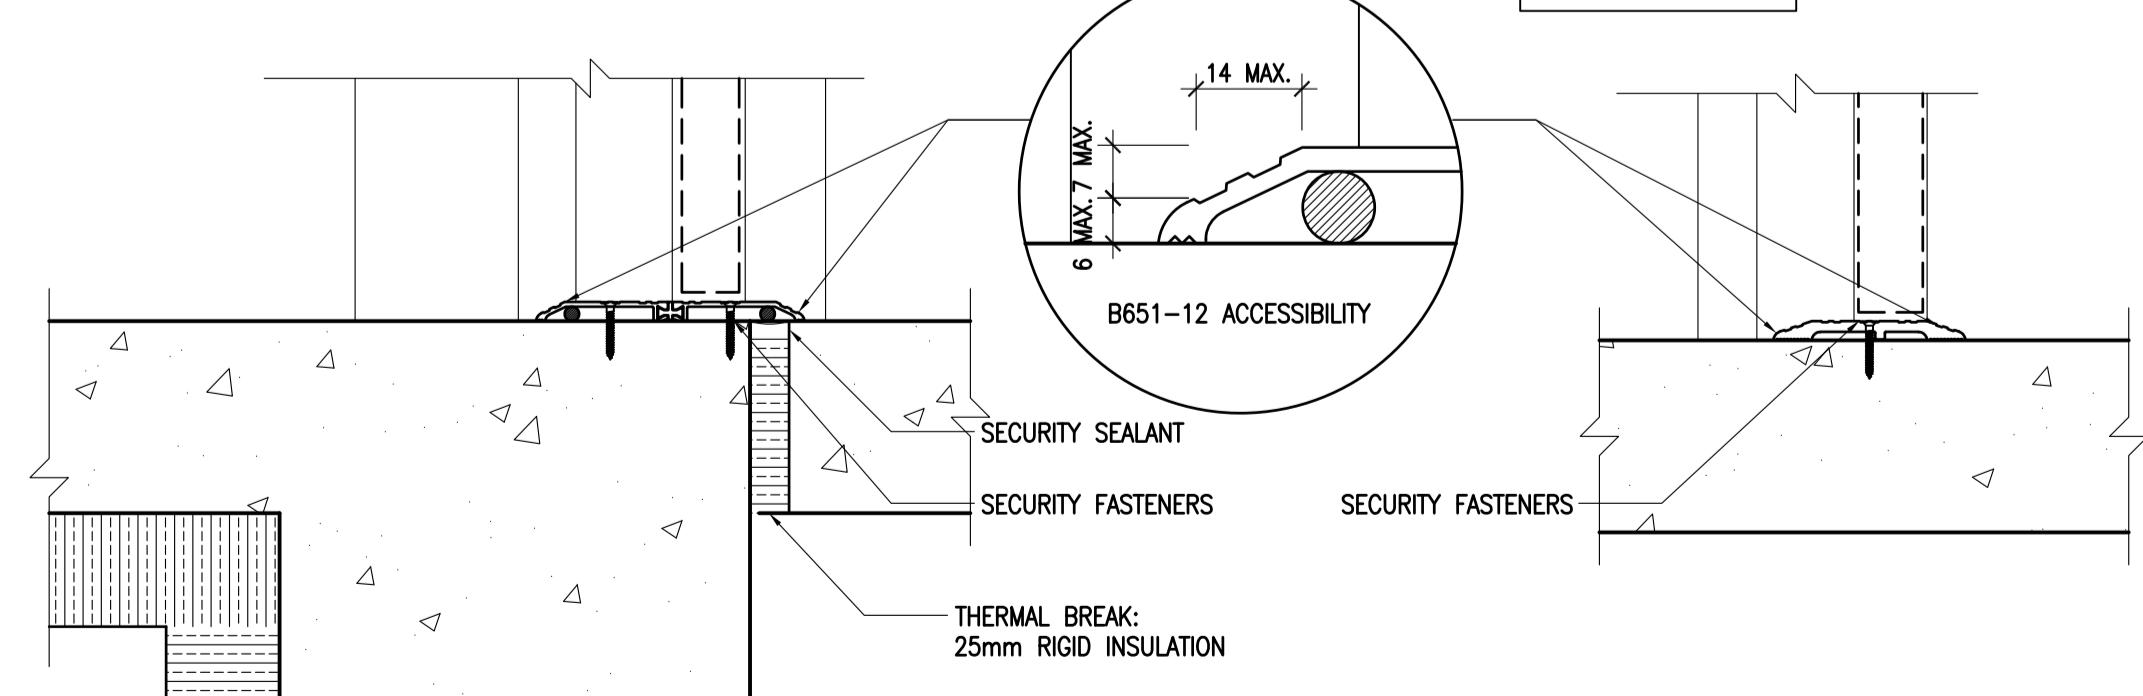

STANDARD THRESHOLD DETAILS

04 A501B 1 : 5

T-2 STANDARD
TYPICAL INTERIOR, ALUMINUM

DOOR HARDWARE DETAILS

05 A501B 1 : 5

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AGASSIZ, BRITISH COLUMBIA
4732 CEMETERY ROAD PO BOX 1600
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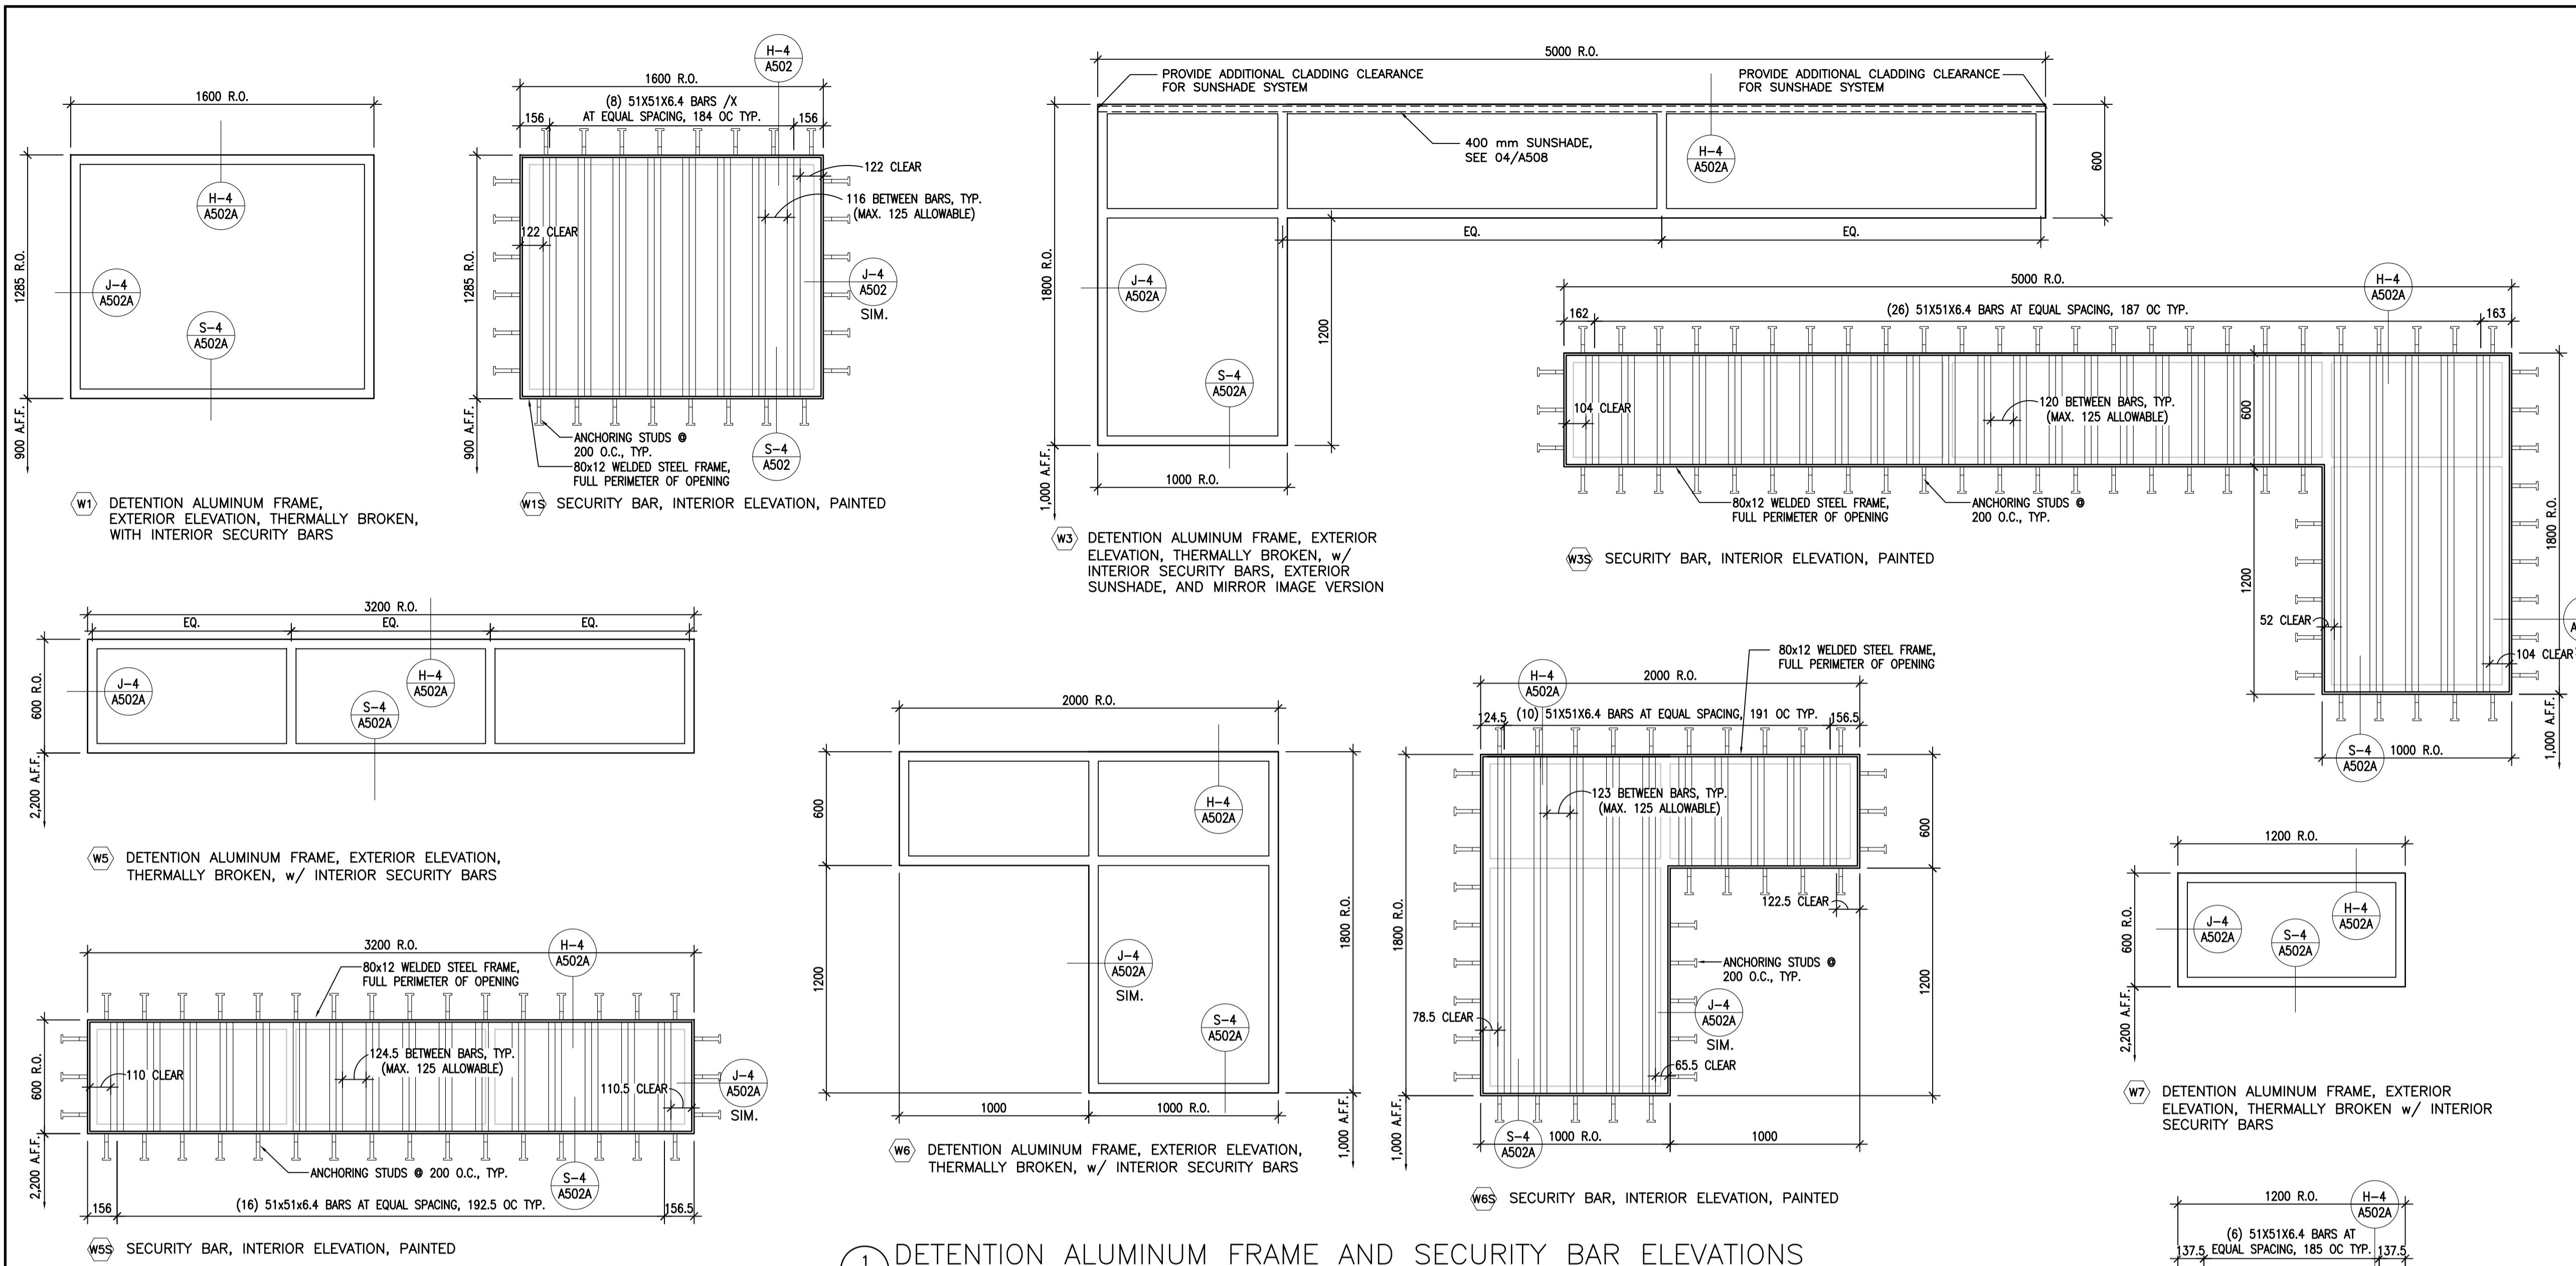
MOUNTAIN INSTITUTE HEALTH CARE EXPANSION

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Designed by/Concept par EDWIN BERZINS
Drawn by/Desiné par BEN MONROE
PWGS Project Manager/Administrateur de Projets TPSGC TONY TANG
Regional Manager, Architectural and Engineering Services Gestionnaire régionale, Services d'architectural et de génie, TPSGC PREETPAL PAUL

Drawing title/Titre du dessin



STANDARD DOOR AND FRAME ELEVATIONS AND DETAILS

Project No./No. du projet	Sheet/Feuille	Revision no./ La Révision no.
R.077724.001	A501B	0





DETENTION ALUMINUM FRAME AND SECURITY BAR ELEVATIONS

A502A 1 : 20

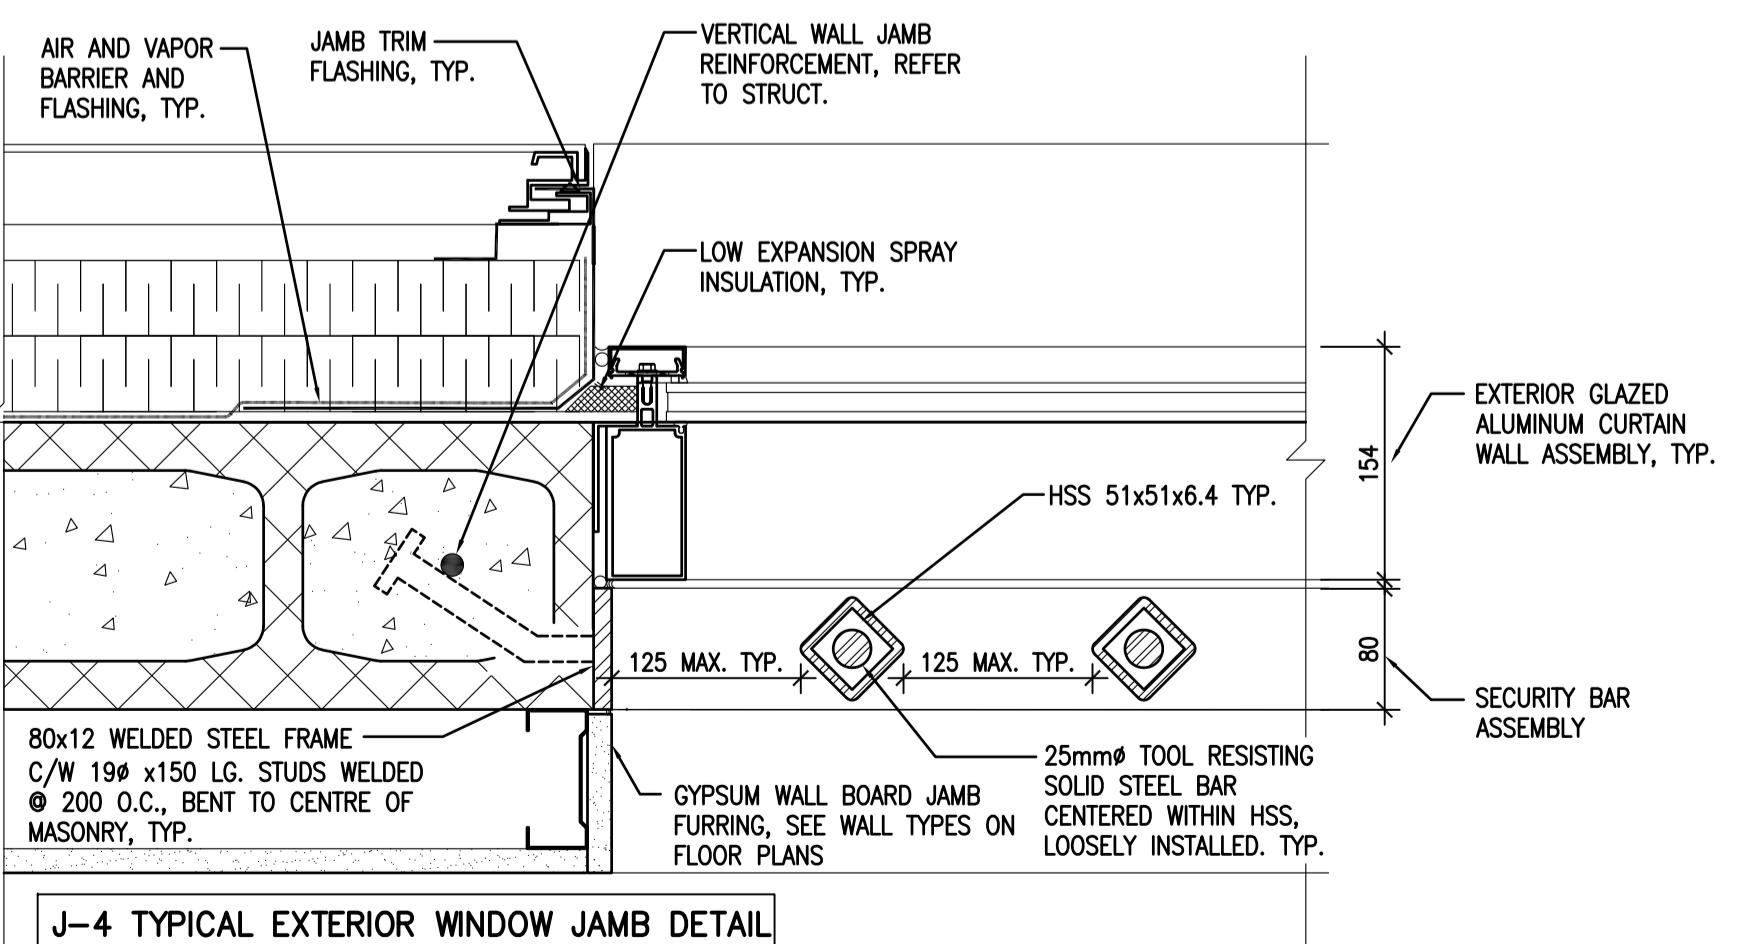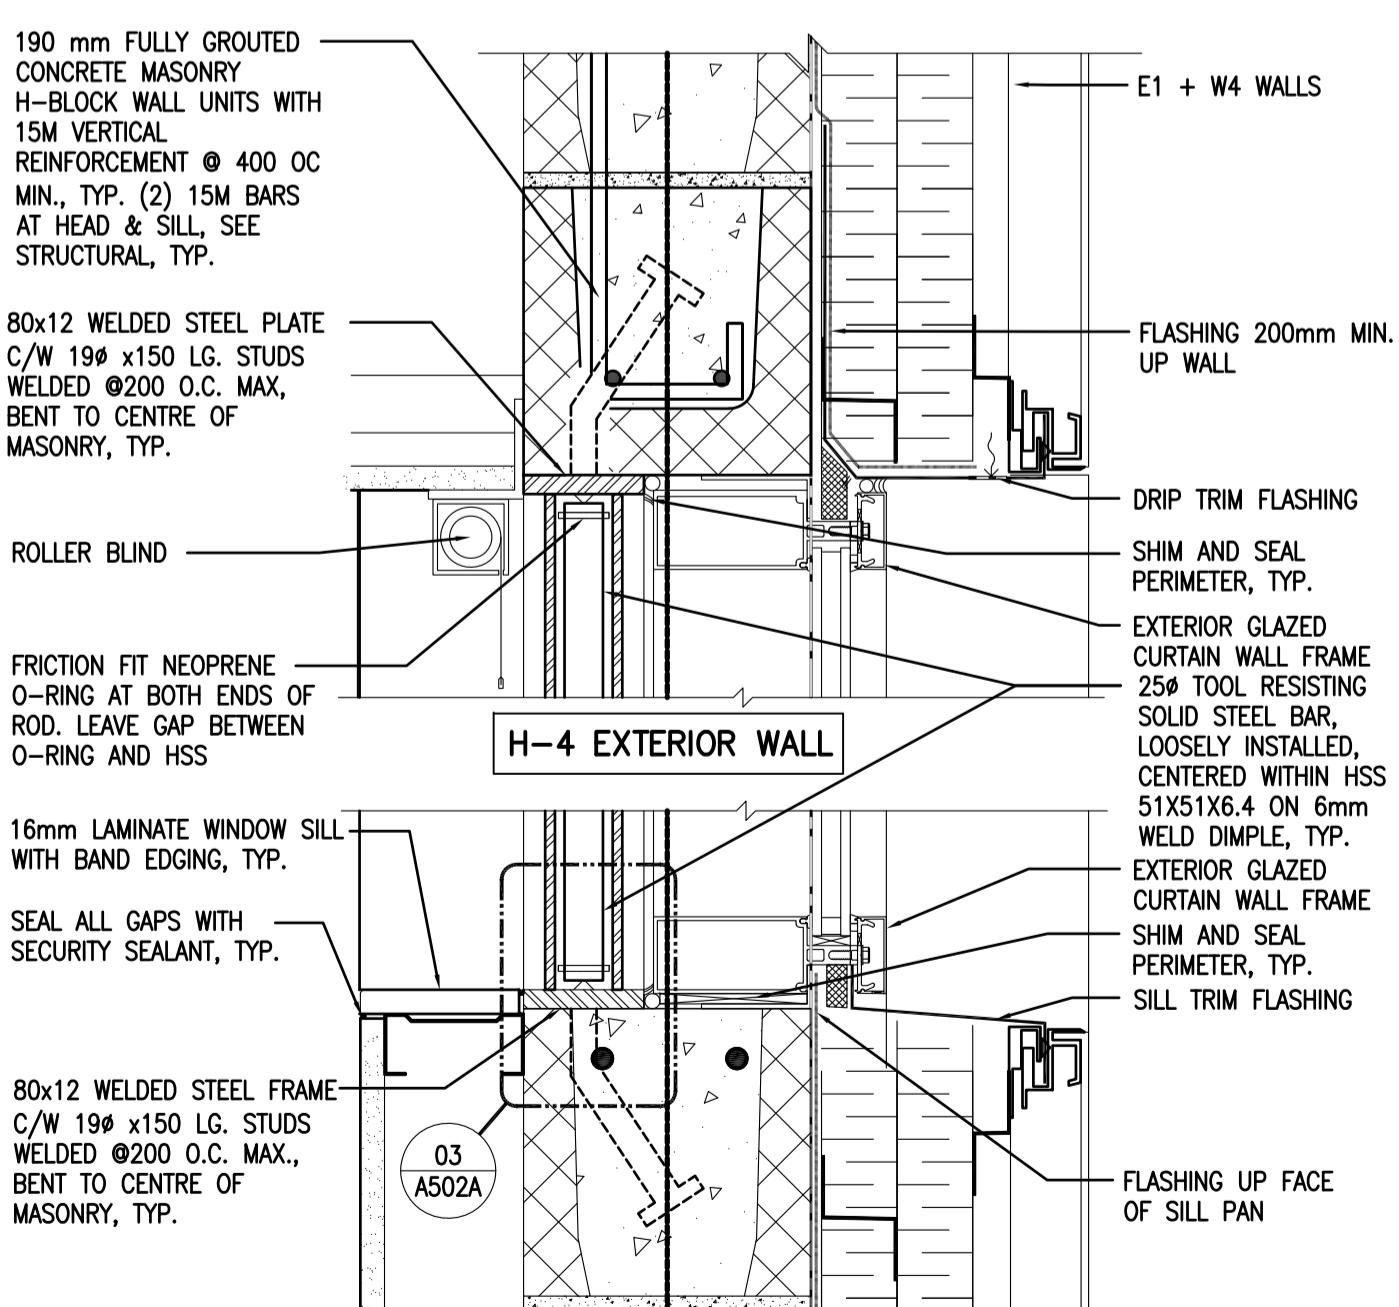

DIMENSION INDICATING R.O. ARE TO ROUGH OPENING.
PROVIDE SHIM SPACE AROUND FRAME PER MANUFACTURER

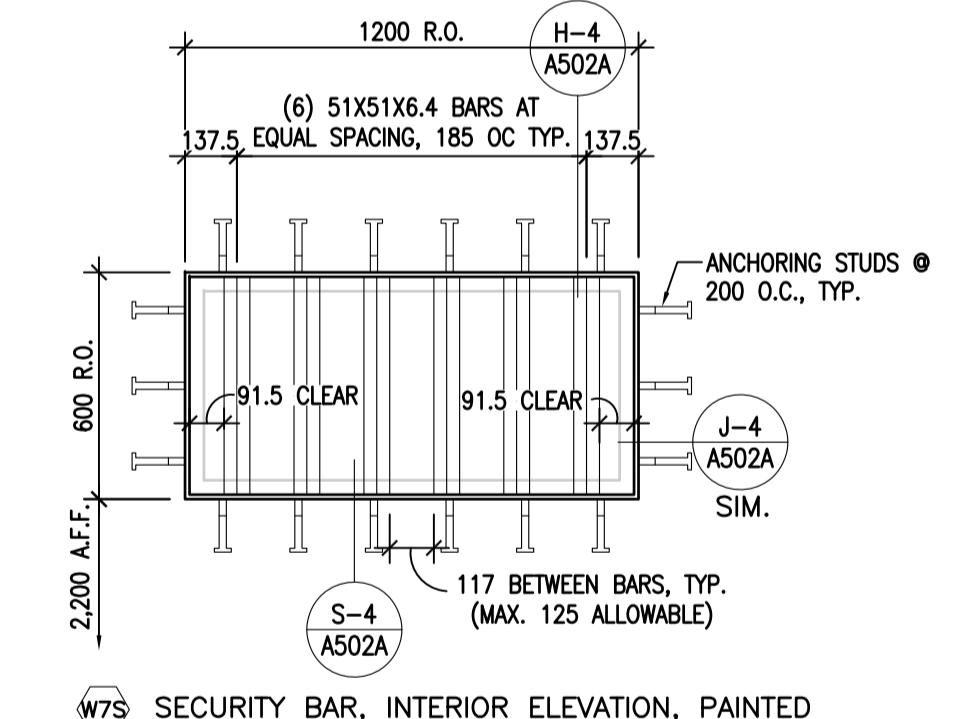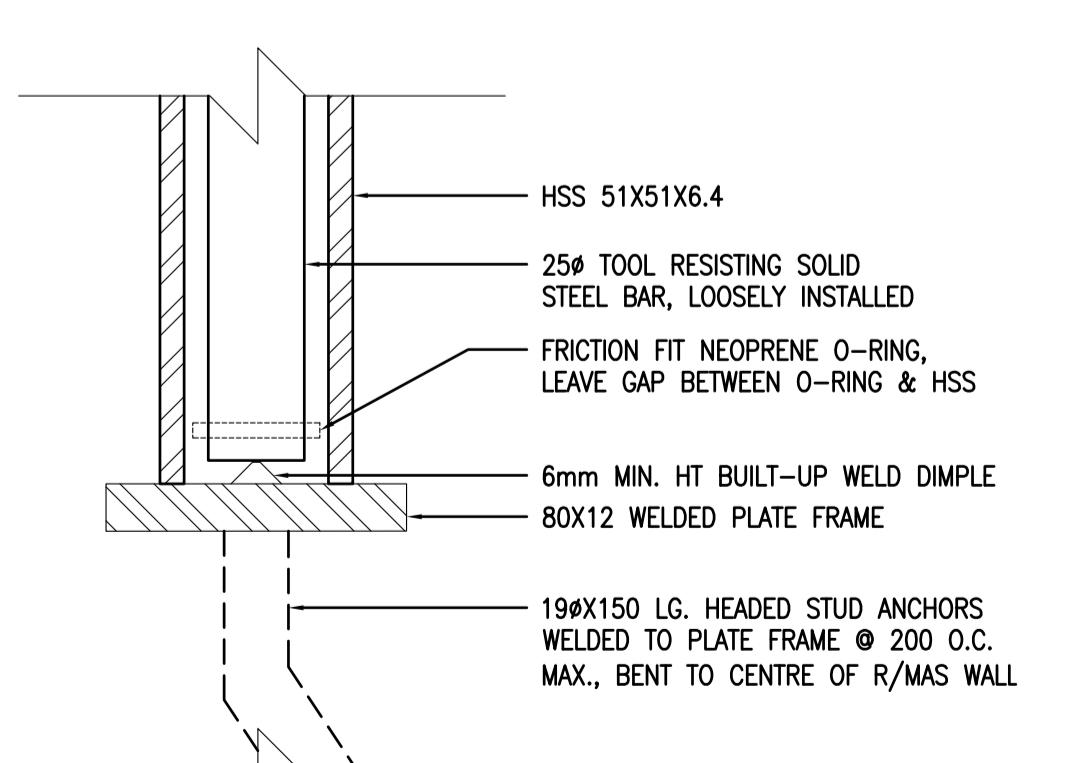

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Project title/Titre du projet AGASSIZ, BRITISH COLUMBIA 4732 CEMETARY ROAD PO BOX 1600 MOUNTAIN INSTITUTE

MOUNTAIN INSTITUTE HEALTH CARE EXPANSION

Consultant Signature Only

Designed by/Concept par EDWIN BERZINS

Drawn by/Dessiné par NORMANN BAUMANN (2017-09-28)

PWGS Project Manager/Administrateur de Projets TPSGC TONY TANG


Regional Manager, Architectural and Engineering Services Gestionnaire régionale, Services d'architecture et de génie, TPSGC PREETPAL PAUL

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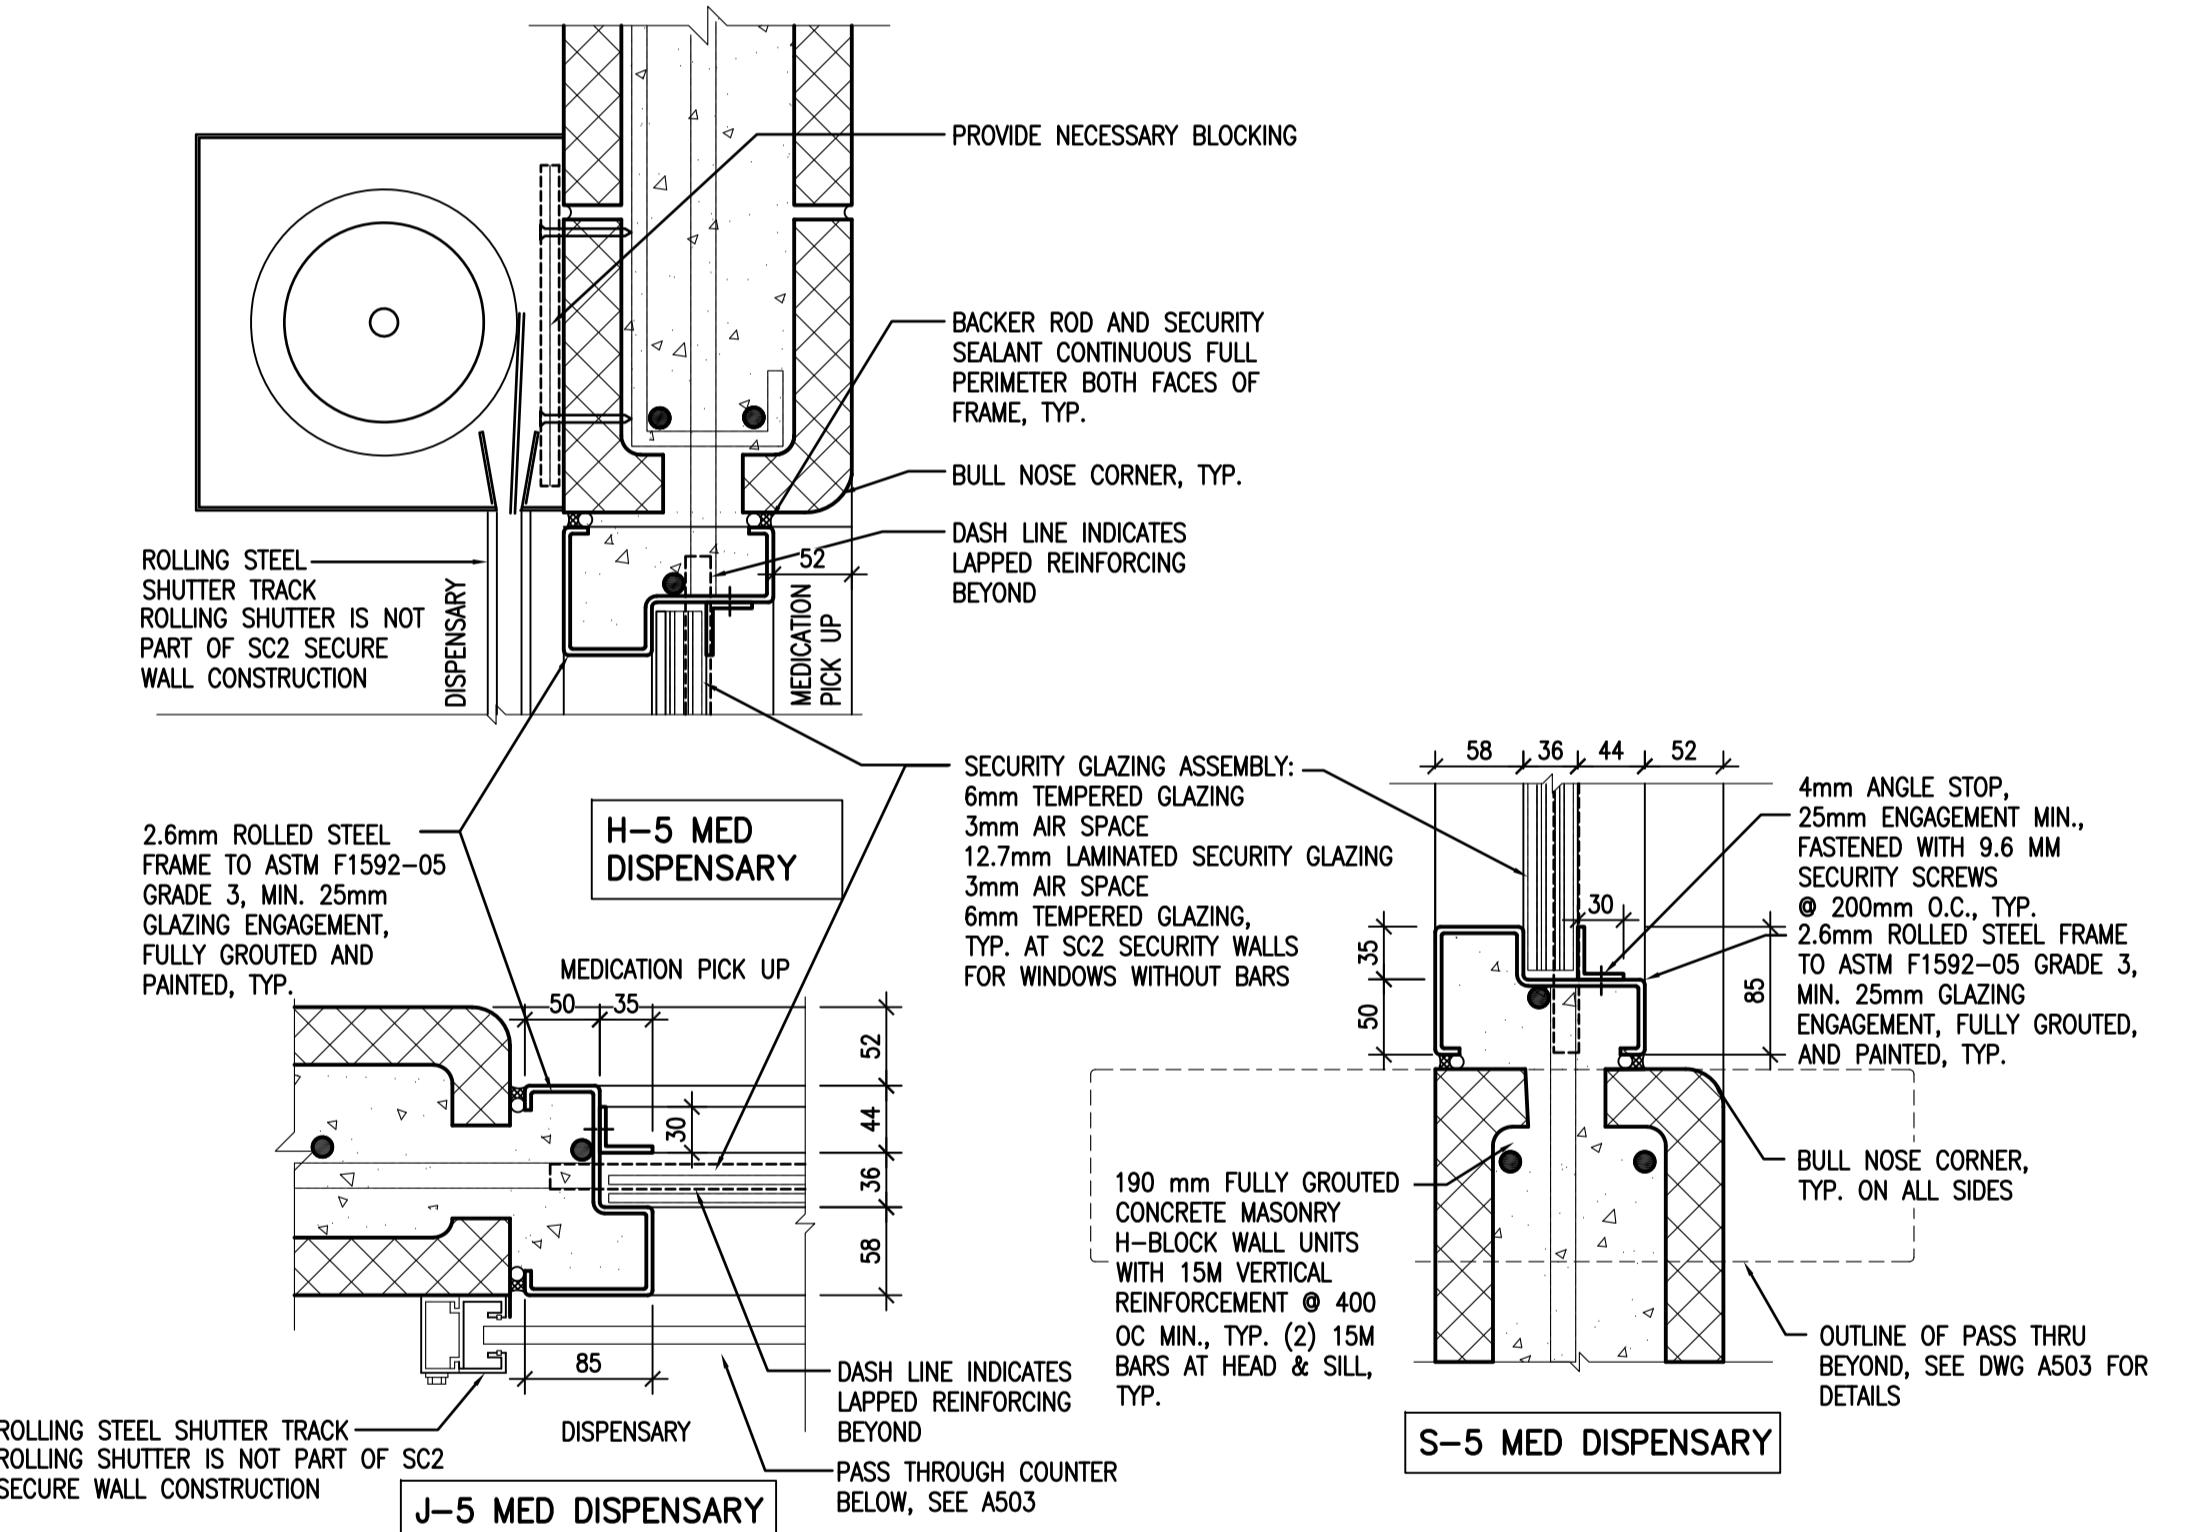
DETENTION WINDOW ELEVATIONS AND DETAILS 1

Project No./No. du projet	Sheet/Feuille	Revision no./No. de Révision
R.077724.001	A502A	0


OF 13

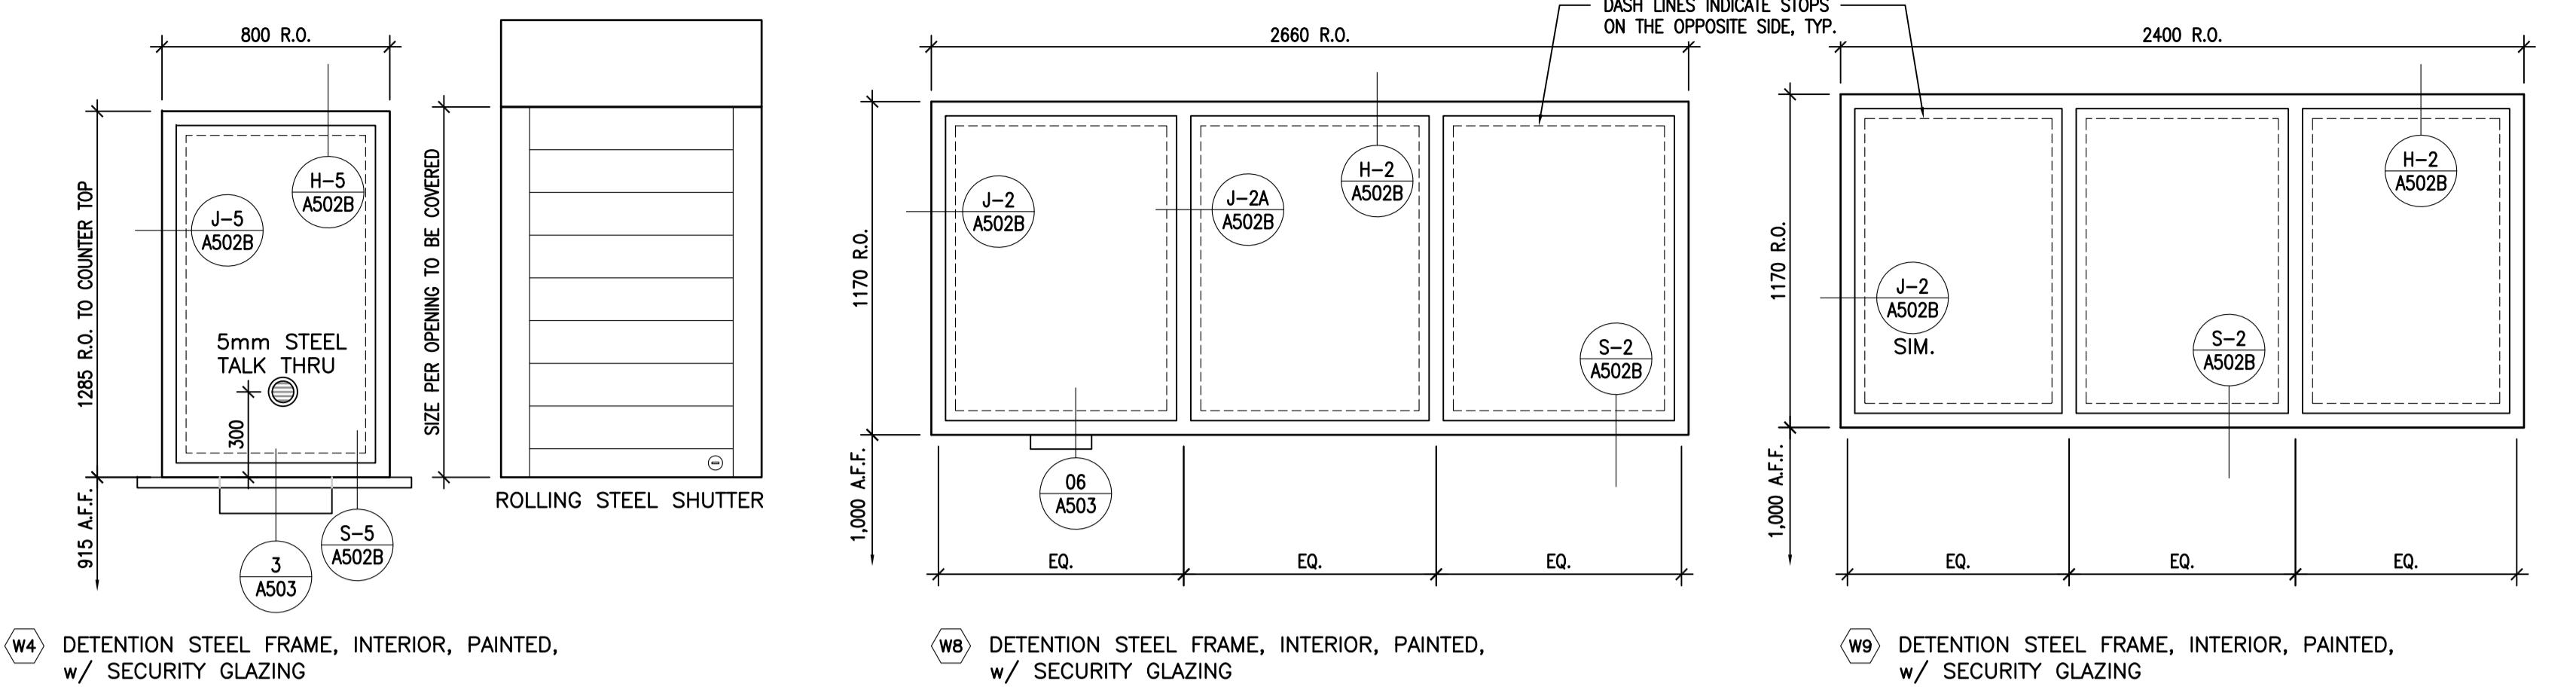

1 DETENTION STEEL FRAME ELEVATIONS
A502B 1 : 20



2 DETENTION STEEL FRAME DETAILS
A502B 1 : 5

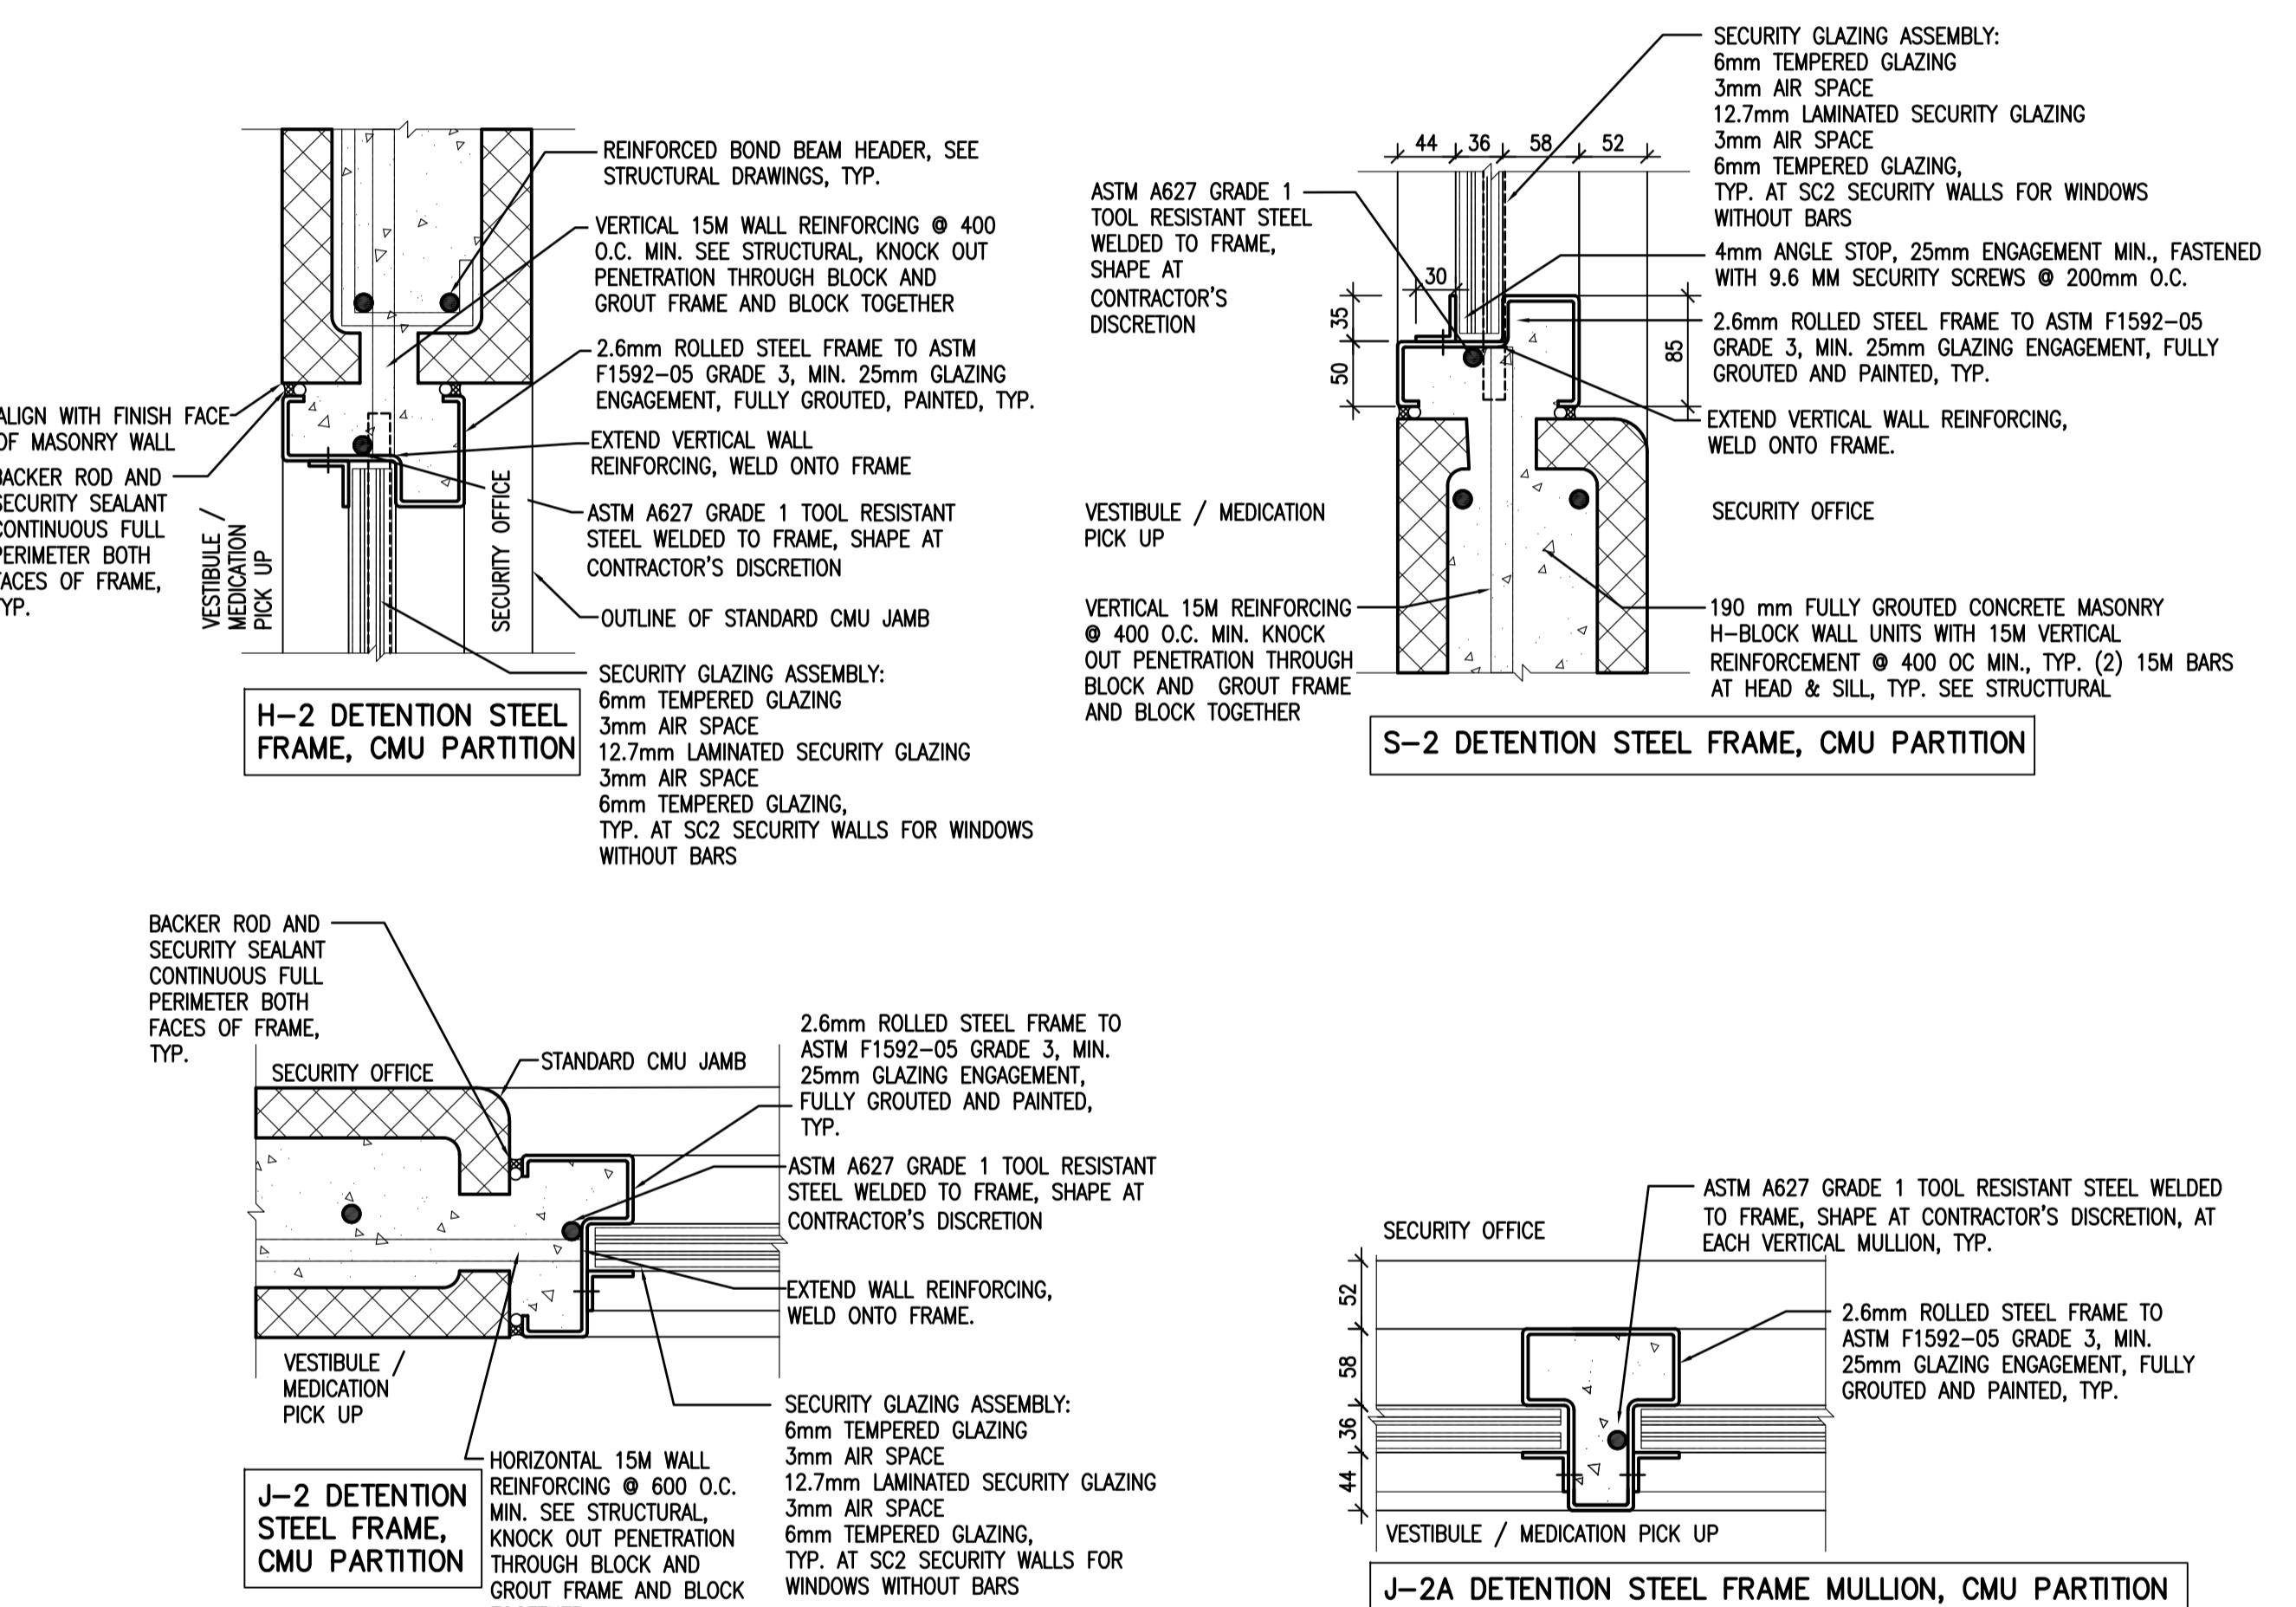

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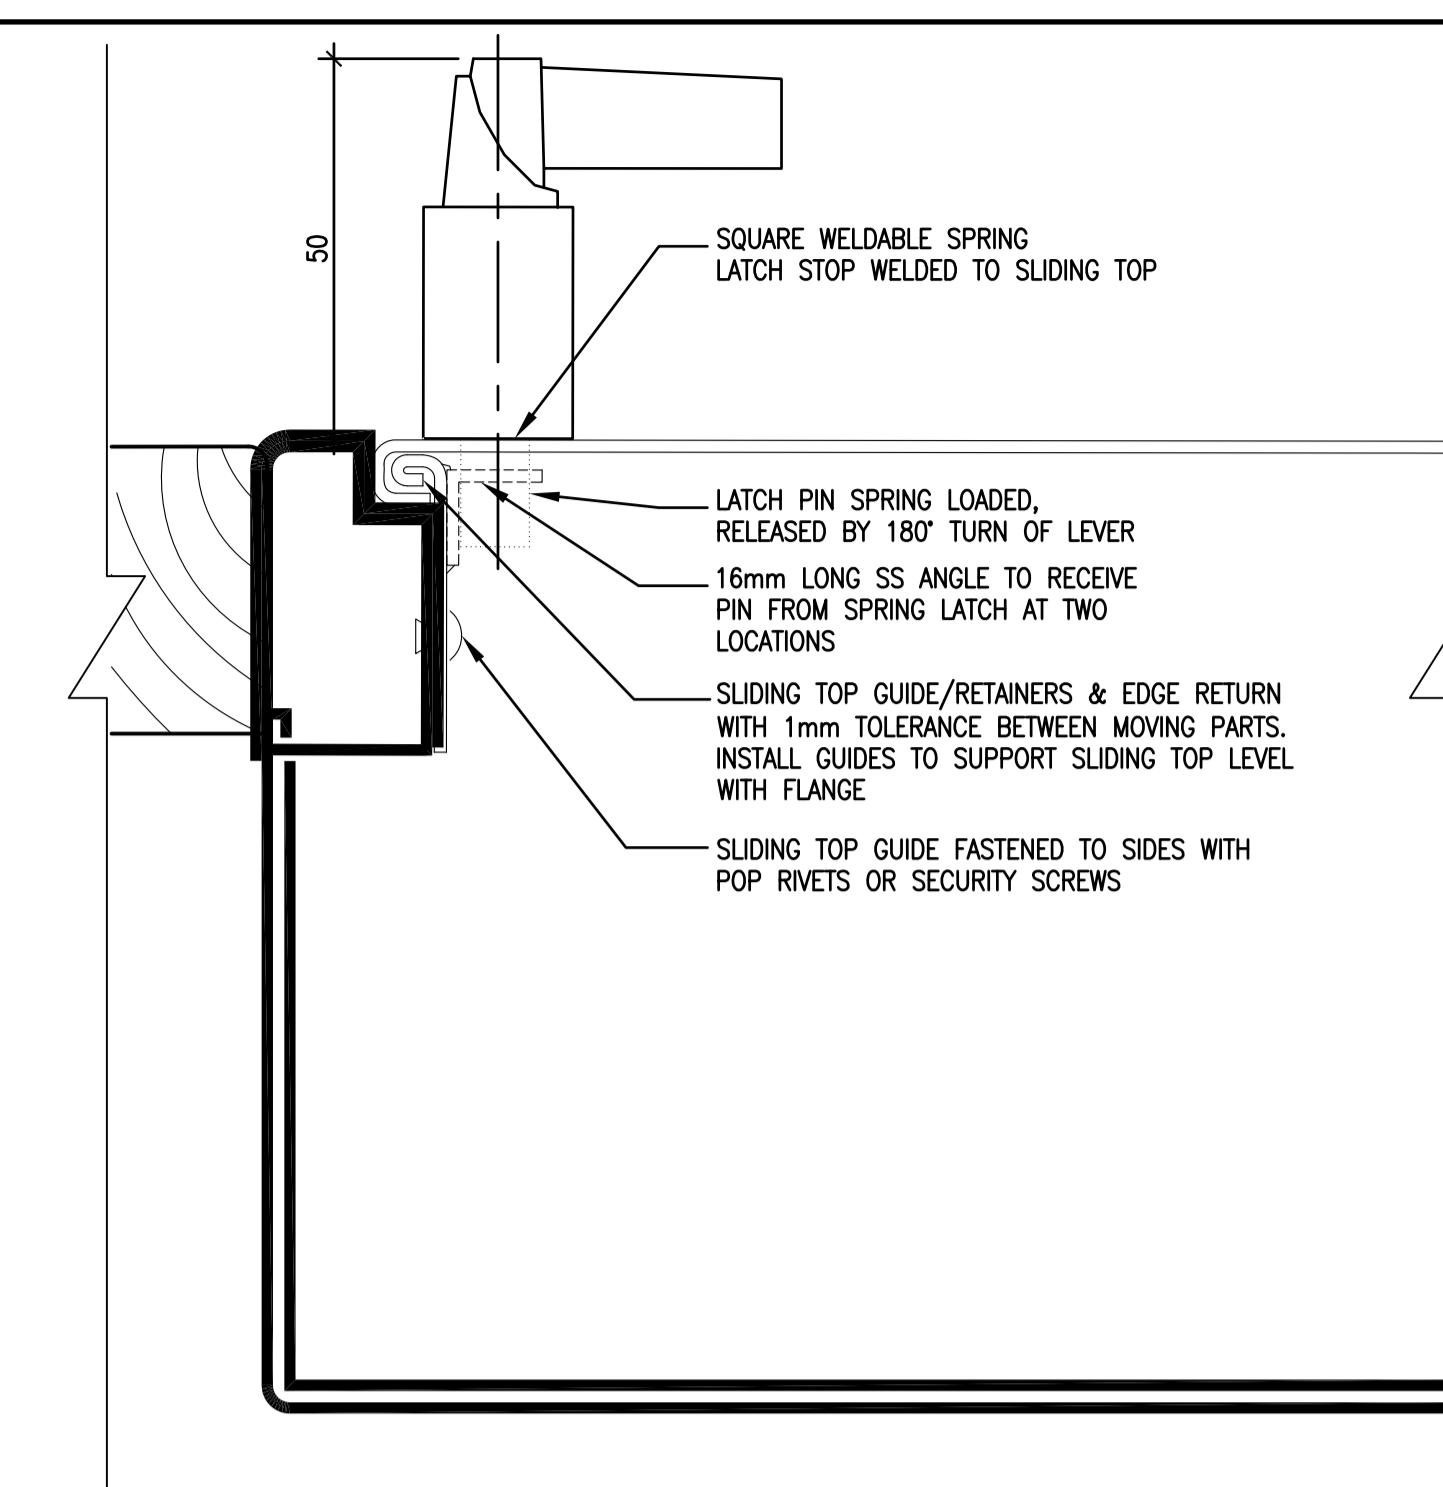
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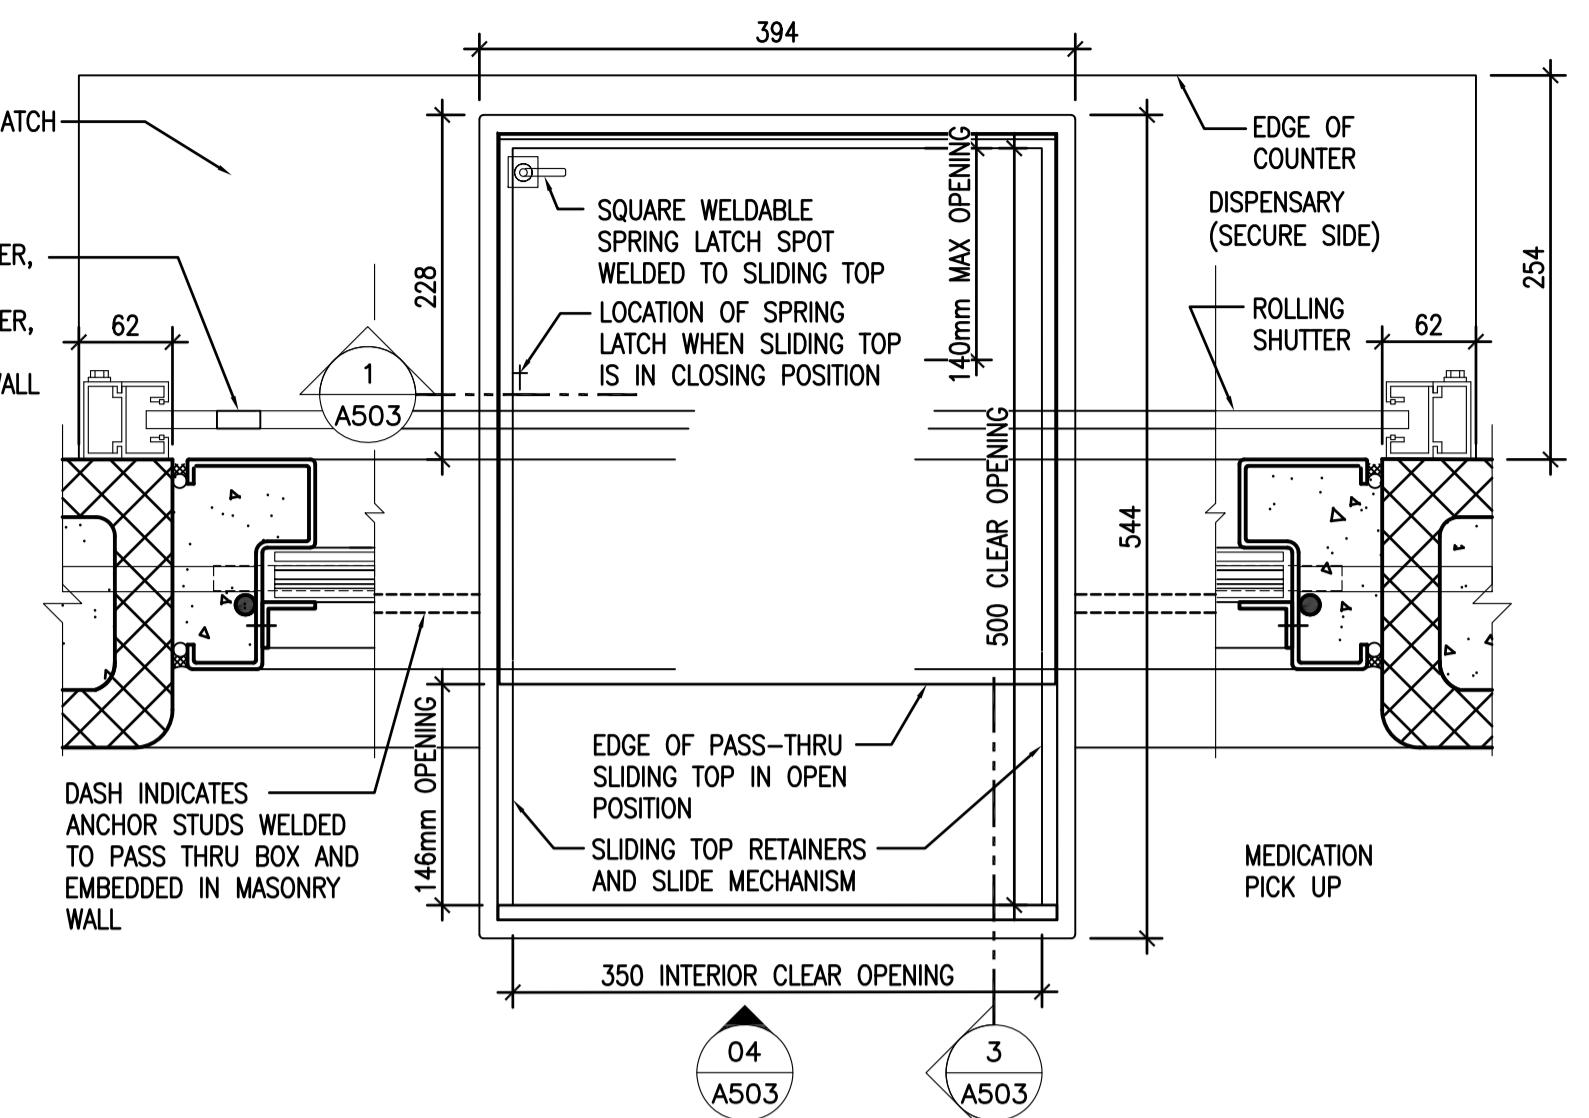
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Designed by/Conception par
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Drawn by/Dessiné par
NORMANN BAUMANN (2017-09-28)
PWGSC Project Manager/Administrateur de Projets TPSGC
TONY TANG
Regional Manager, Architectural and Engineering Services
Gestionnaire régionale, Services d'architecture et de génie, TPSGC
PREETPAL PAUL
Drawing title/Titre du dessin

DETENTION WINDOW ELEVATIONS AND DETAILS 2


Project No./No. du
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Revision no./
La Révision
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OF 13




1 PASS THRU SECTION
A503 1 : 1




2 PASS THRU PLAN
A503 1 : 5

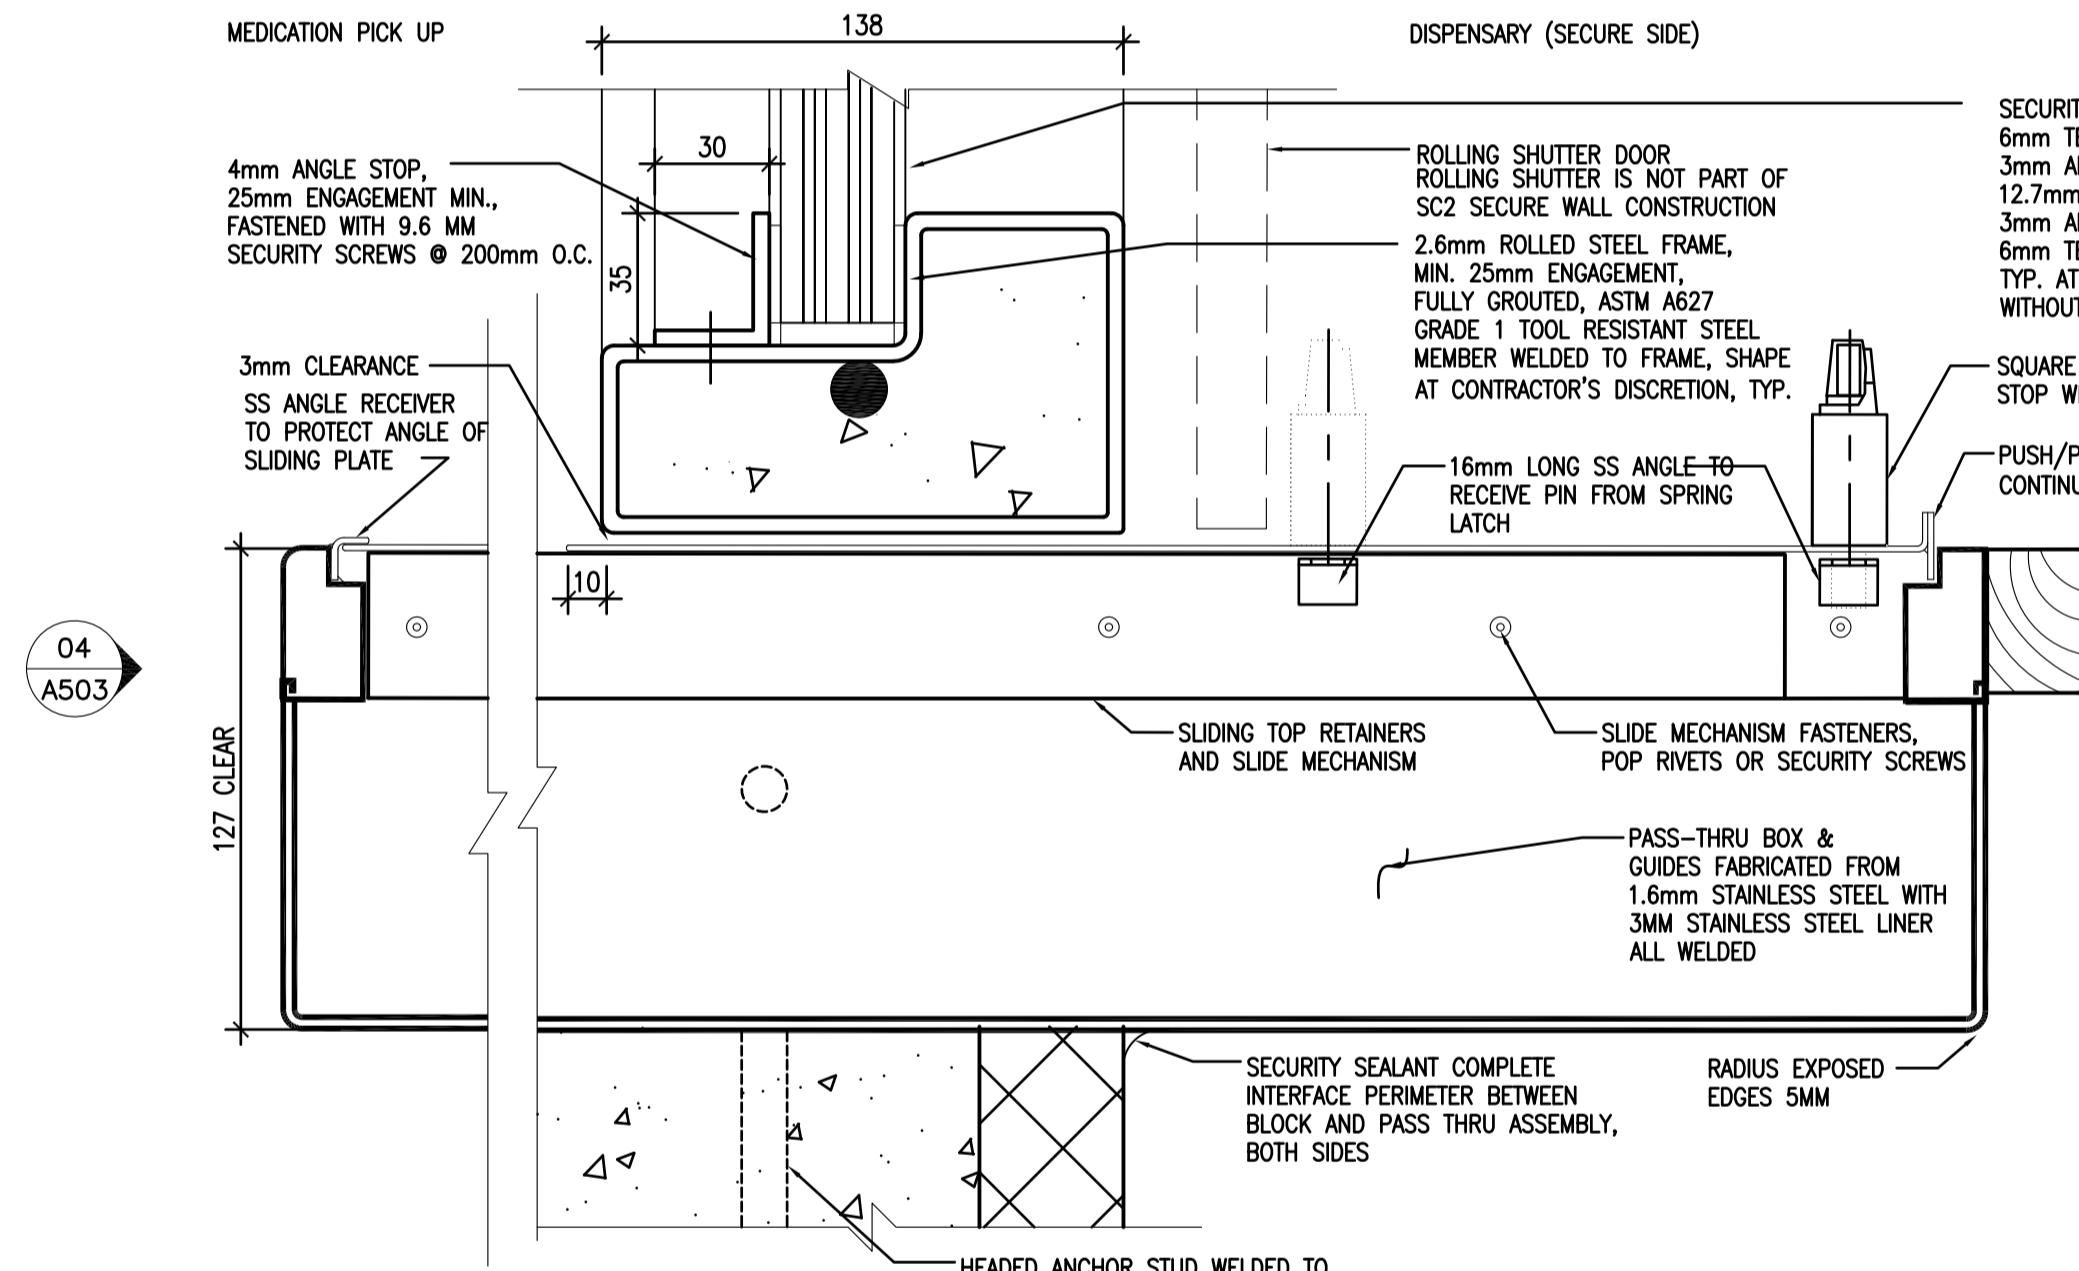


3 PASS THRU SECTION
A503 1 : 2

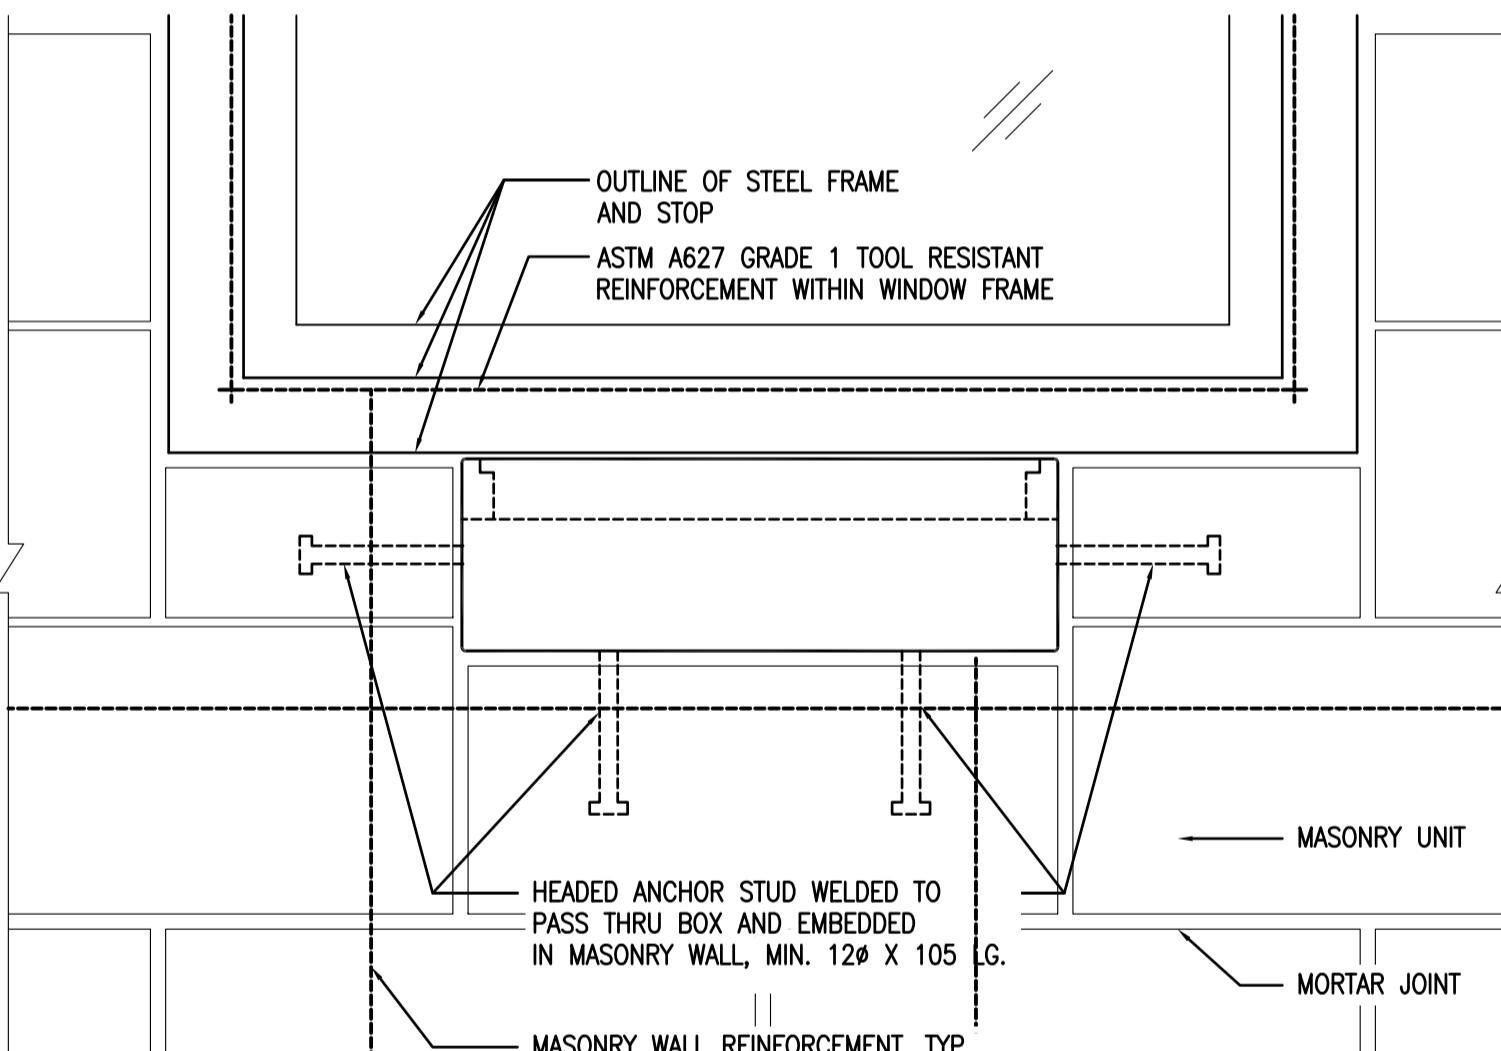


4 PASS THRU ELEVATION
A503 1 : 5

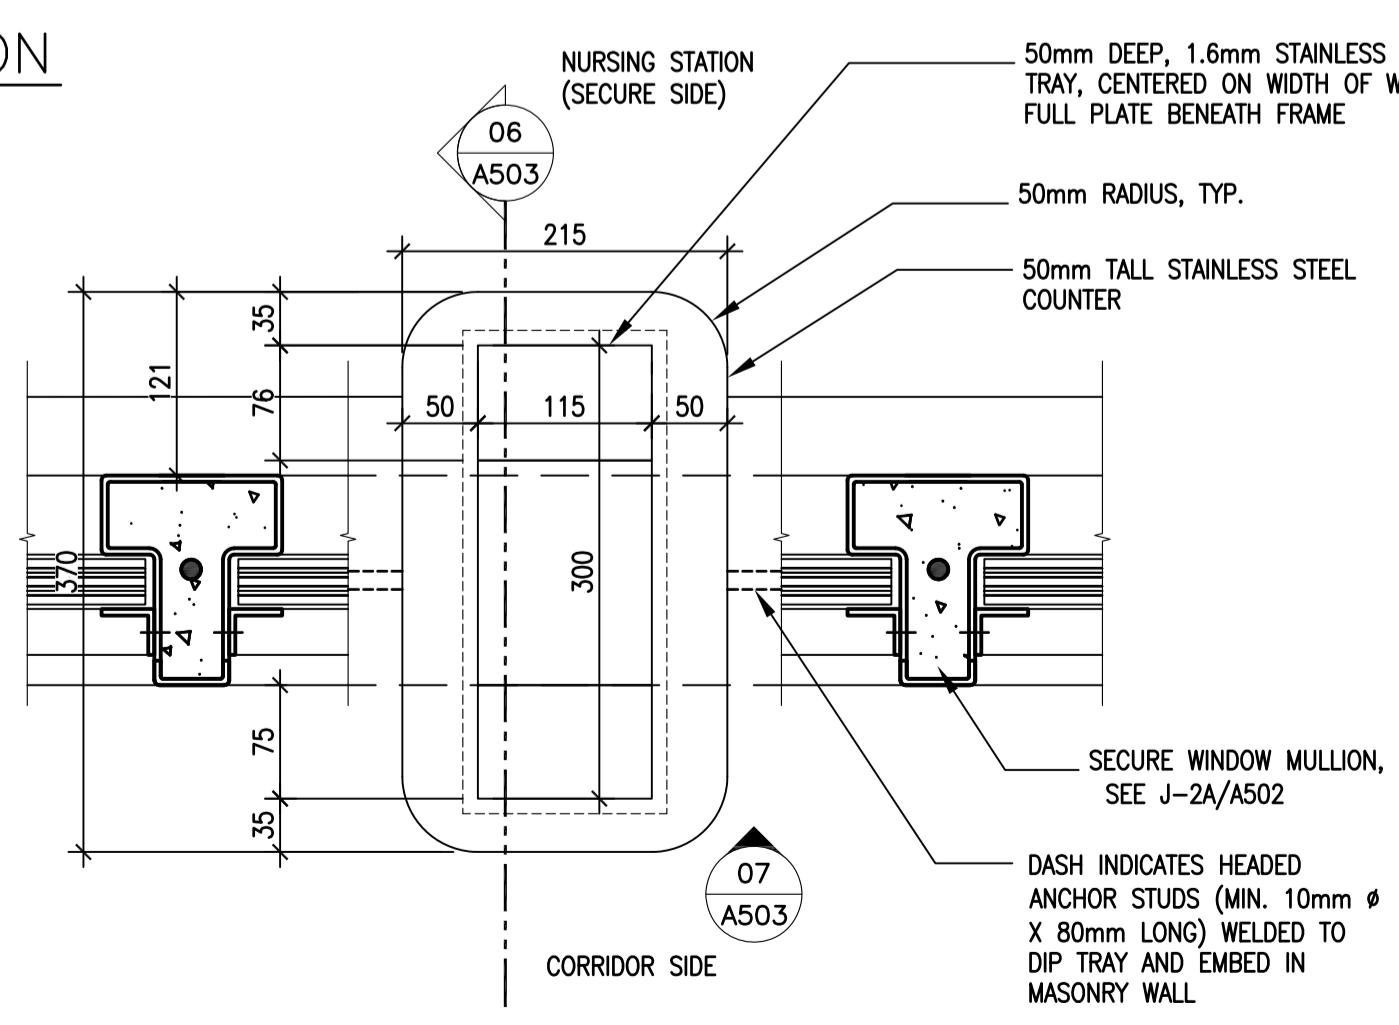

5 SECURE DIP TRAY PLAN
A503 1 : 5

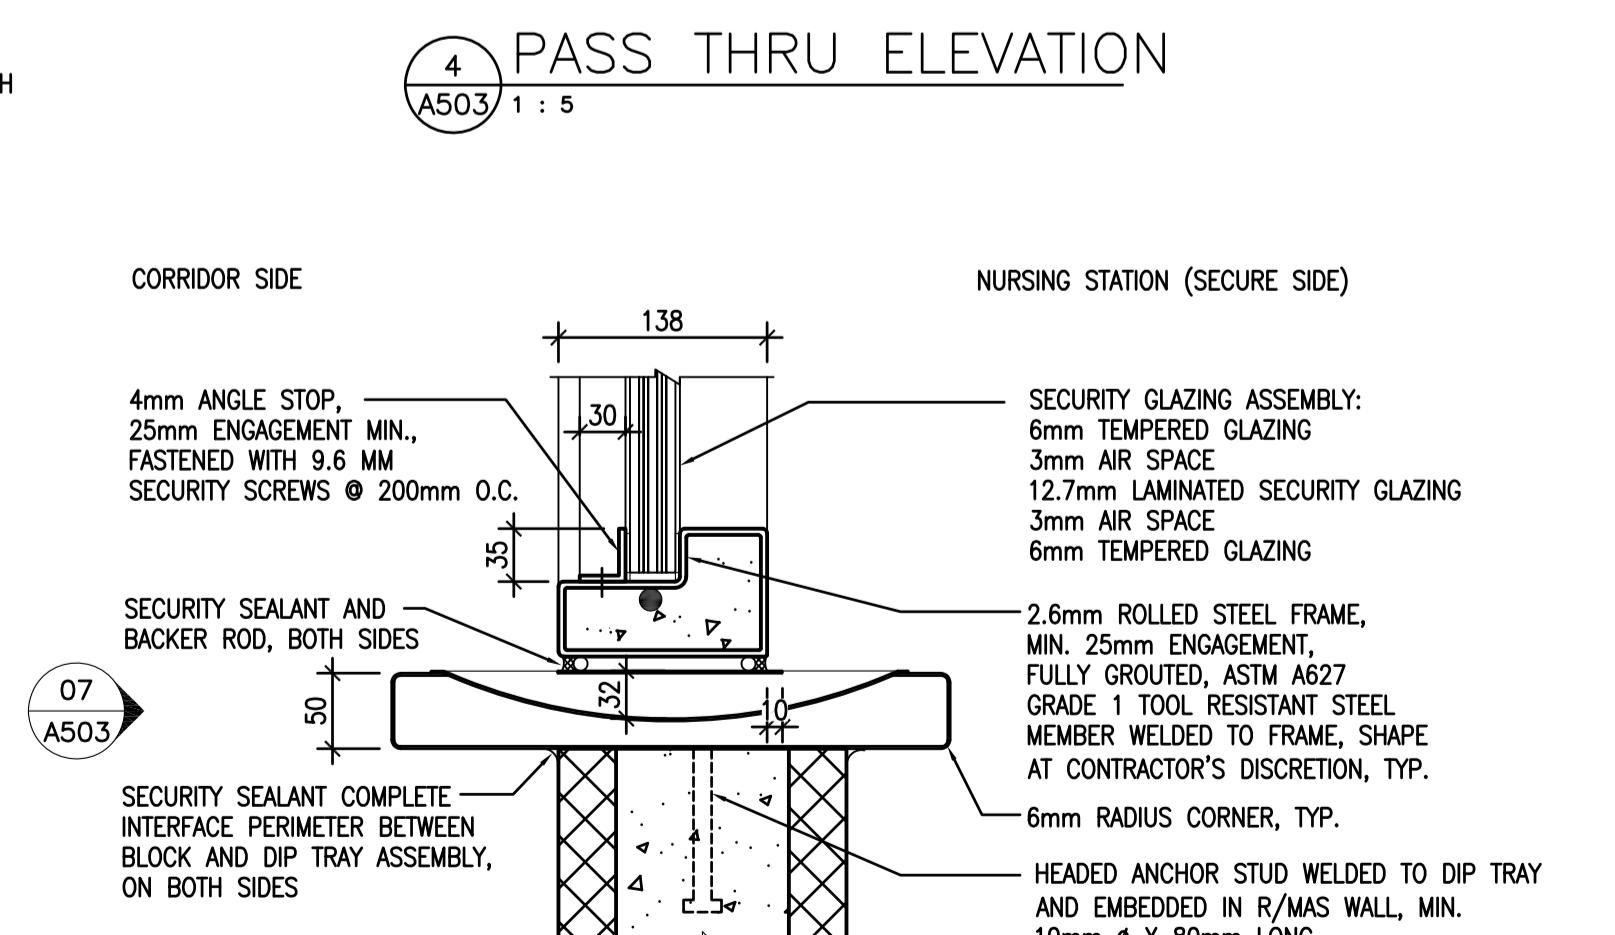

6 SECURE DIP TRAY SECTION
A503 1 : 5

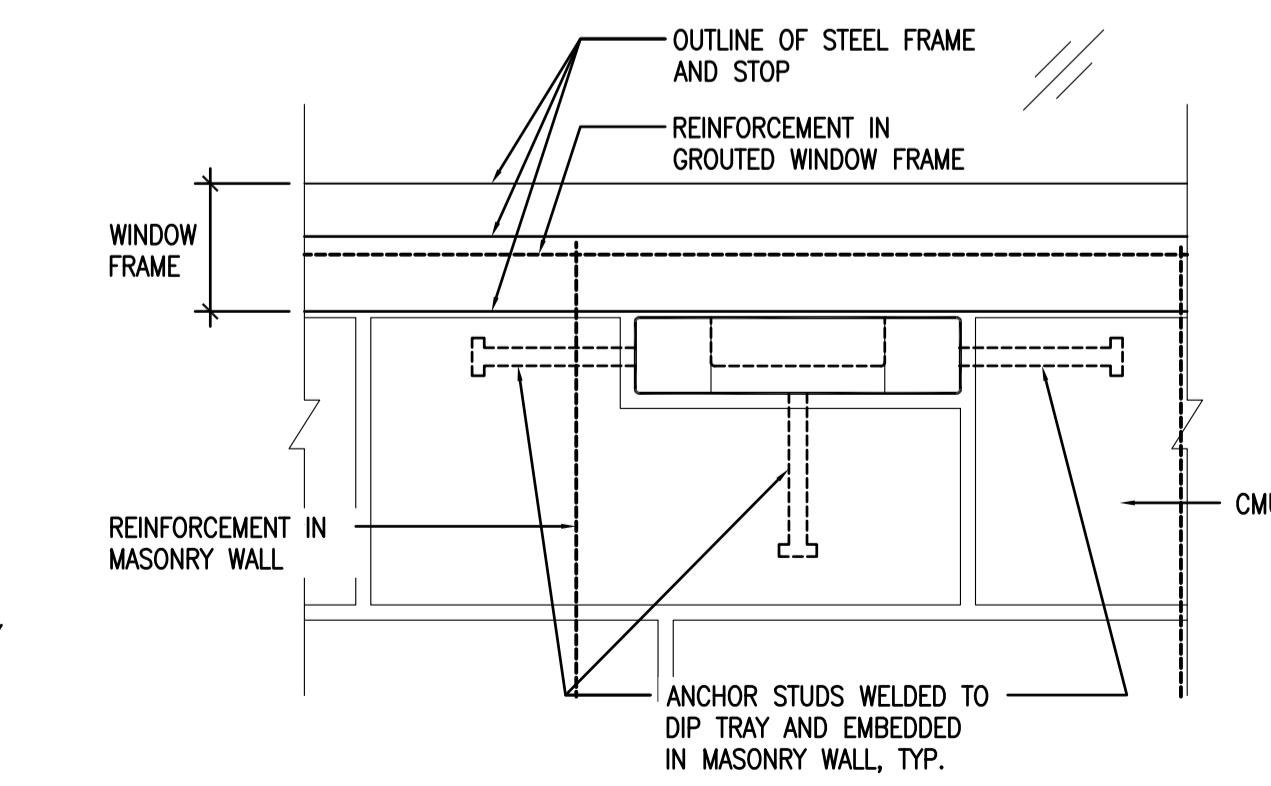

7 SECURE DIP TRAY ELEVATION
A503 1 : 5

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Project Title/Titre du projet
AGASSIZ, BRITISH COLUMBIA
4732 CEMETERY ROAD PO BOX 1600
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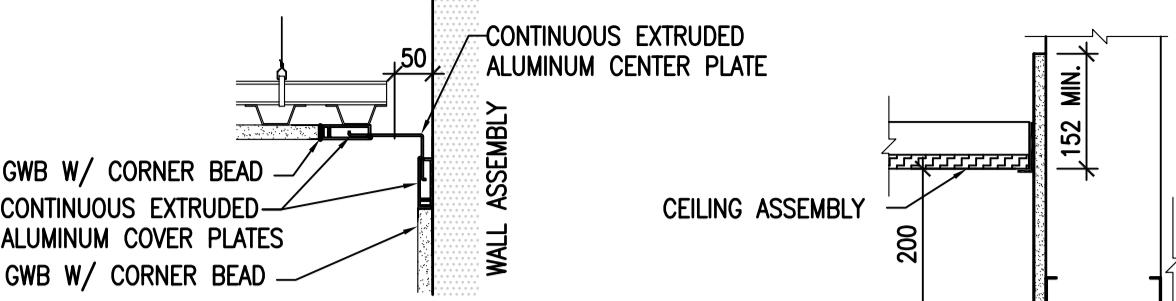
MOUNTAIN INSTITUTE HEALTH CARE EXPANSION

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Designed by/Concept par EDWIN BERZINS
Drawn by/Dessiné par NORMANN BAUMANN (2017-09-28)
PWGS Project Manager/Administrateur de Projets TPSGC TONY TANG
Regional Manager, Architectural and Engineering Services Gestionnaire régionale, Services d'architecture et de génie, TPSGC PREETPAL PAUL


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PASS THRU DETAILS


Project No./No. du projet	Sheet/Feuille A503	Revision no./ La Révision no. 0
R.077724.001		



1 SEISMIC JOINT
A504 1:10

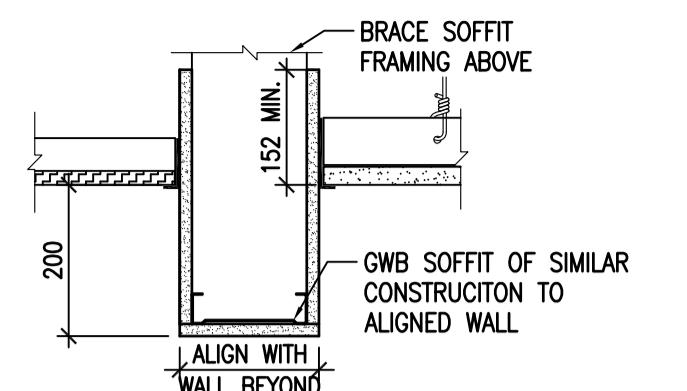


2 SOFFIT DETAIL 1
A504 1:10

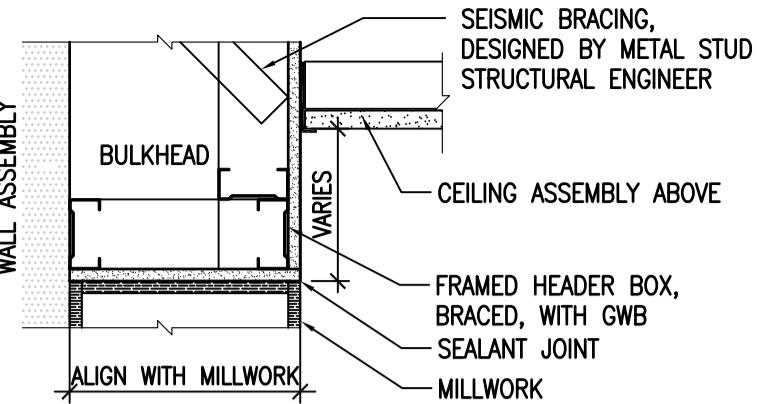


3 SOFFIT DETAIL 2
A504 1:10


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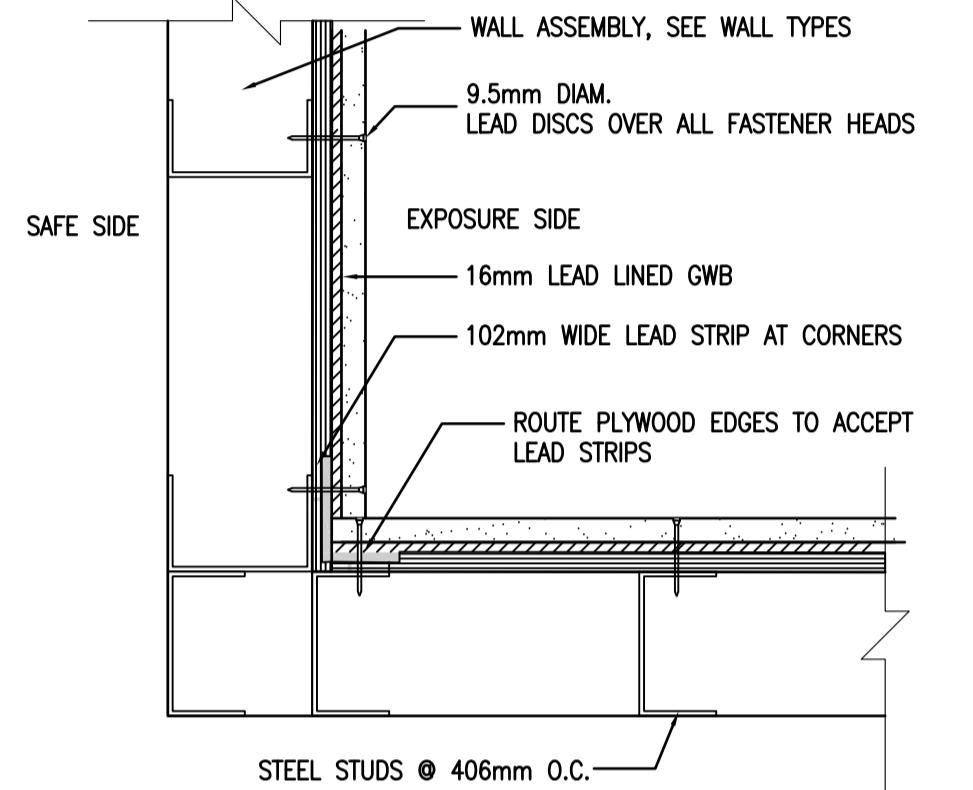
4 BULKHEAD DETAIL
A504 1:10

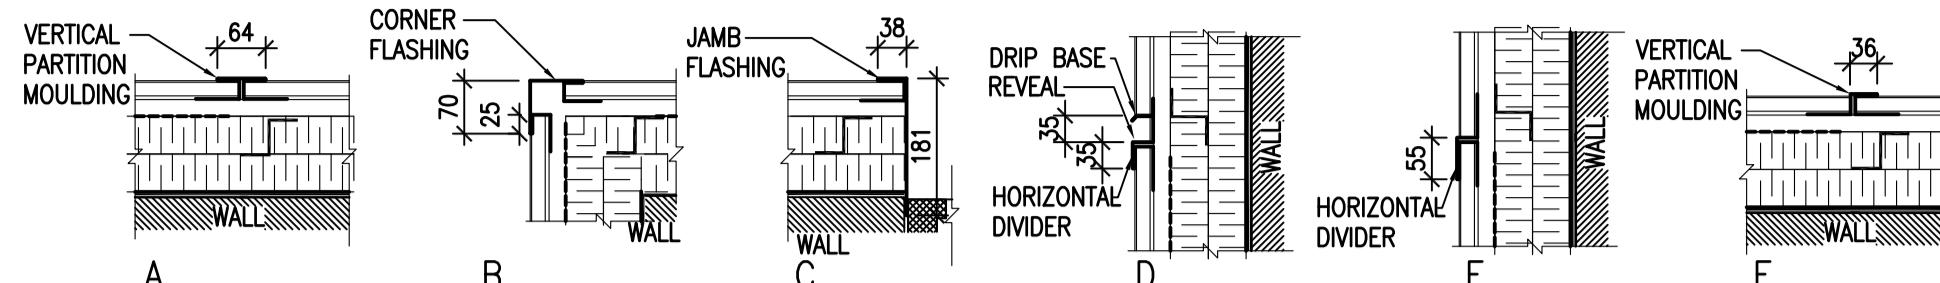

5 LEAD LINING DOOR JAMB
A504 1:5

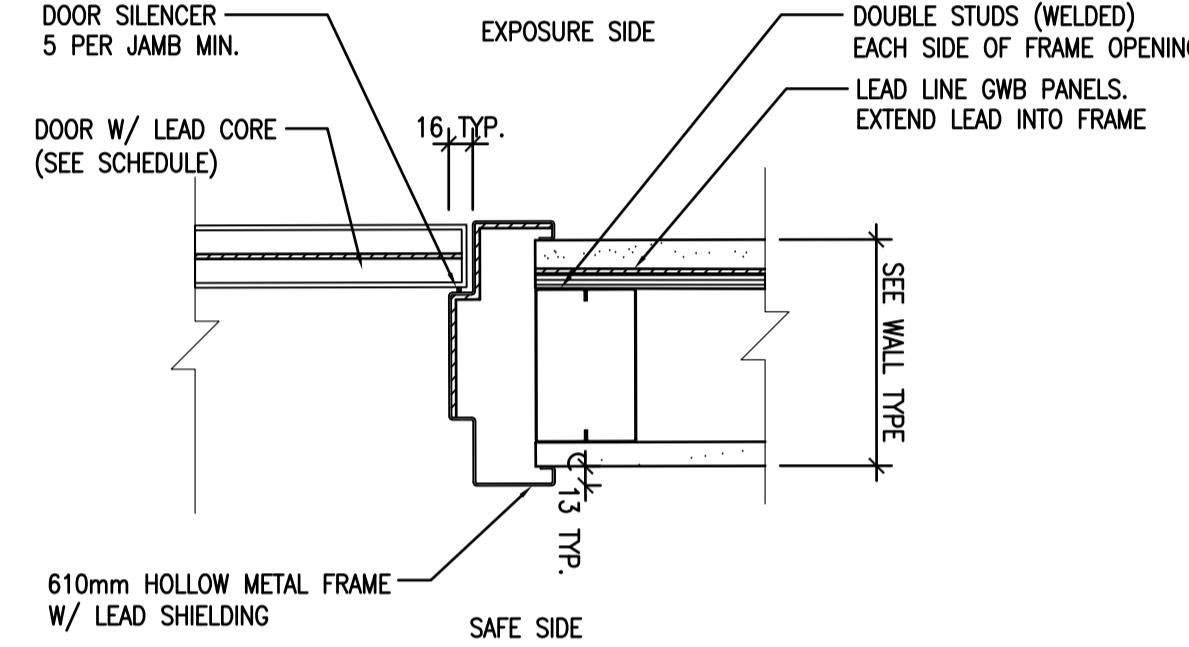


6 LEADED GLAZING WINDOW:
HEAD & SILL DETAIL
A504 1:5

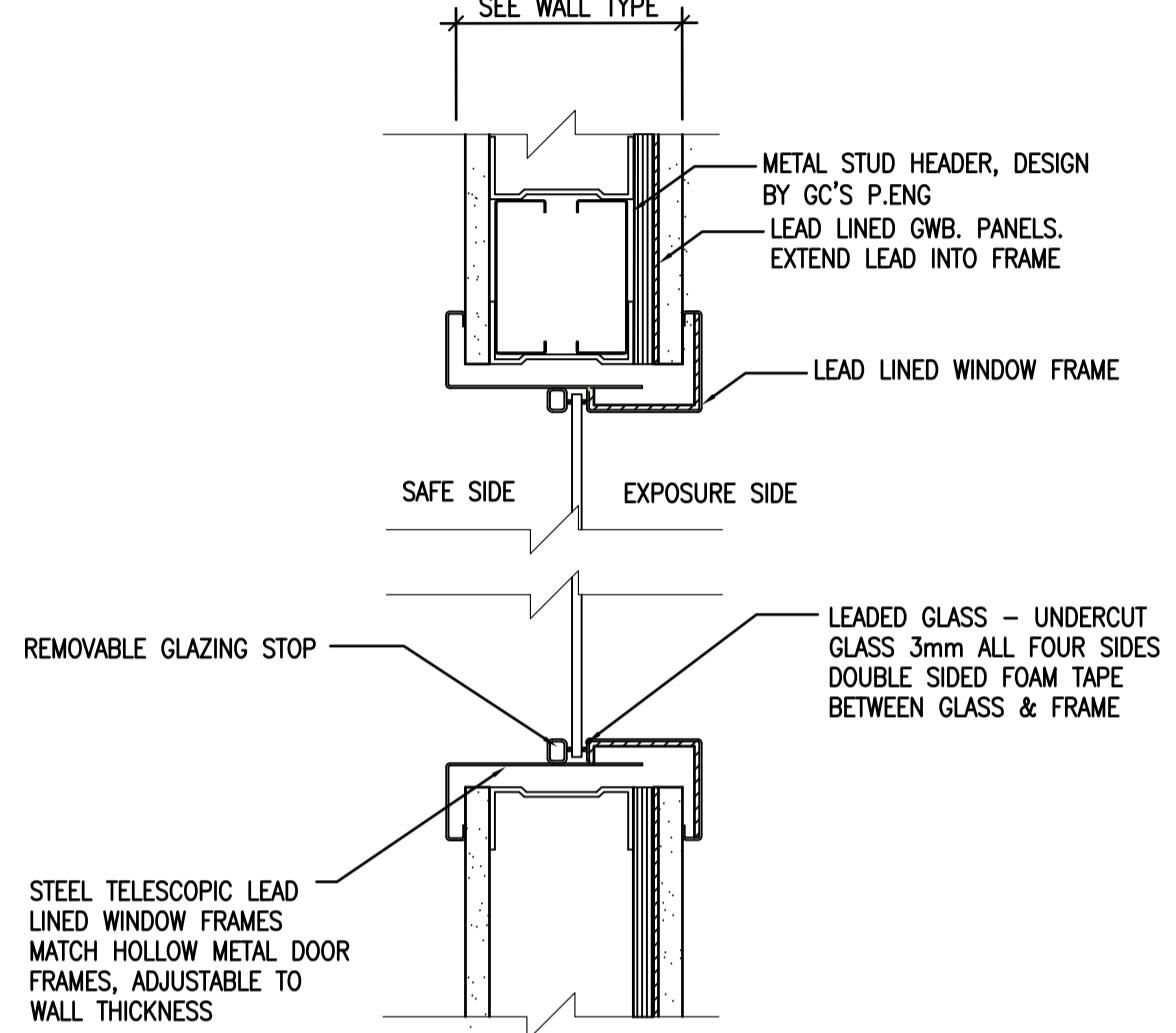


7 INSIDE CORNER LEAD DETAIL
A504 1:5


NOTE: LEAD BARRIER IS REQUIRED ON INDICATED WALLS TO A MINIMUM OF 2150mm AFF. ALL PENETRATIONS OF LEAD BARRIER BY FASTENERS OR OTHER ELEMENTS MUST BE PATCHED IN FRONT OR BEHIND WITH LEAD PATCH LARGER THAN THE PENETRATION. ADDITIONAL SHIELDING OF THE ROOF OR FLOOR IS NOT REQUIRED.

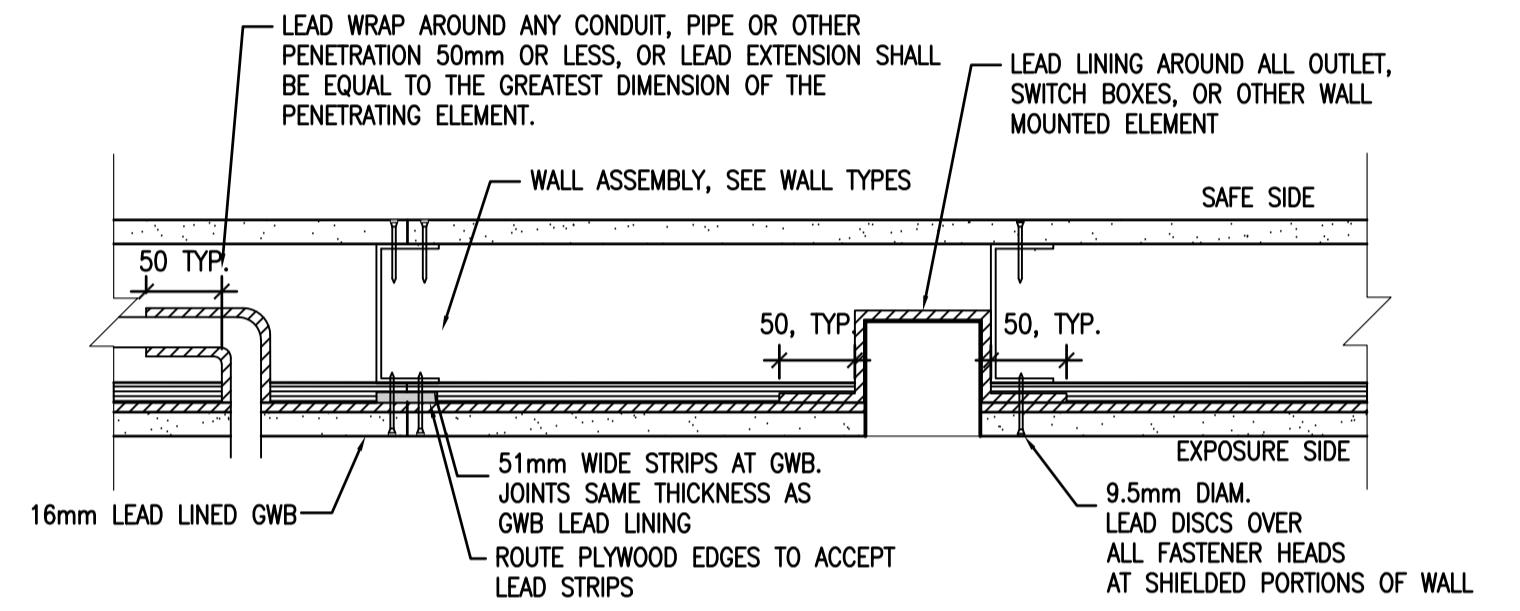


8 PLAN VIEW WALL LEAD DETAIL
A504 1:5

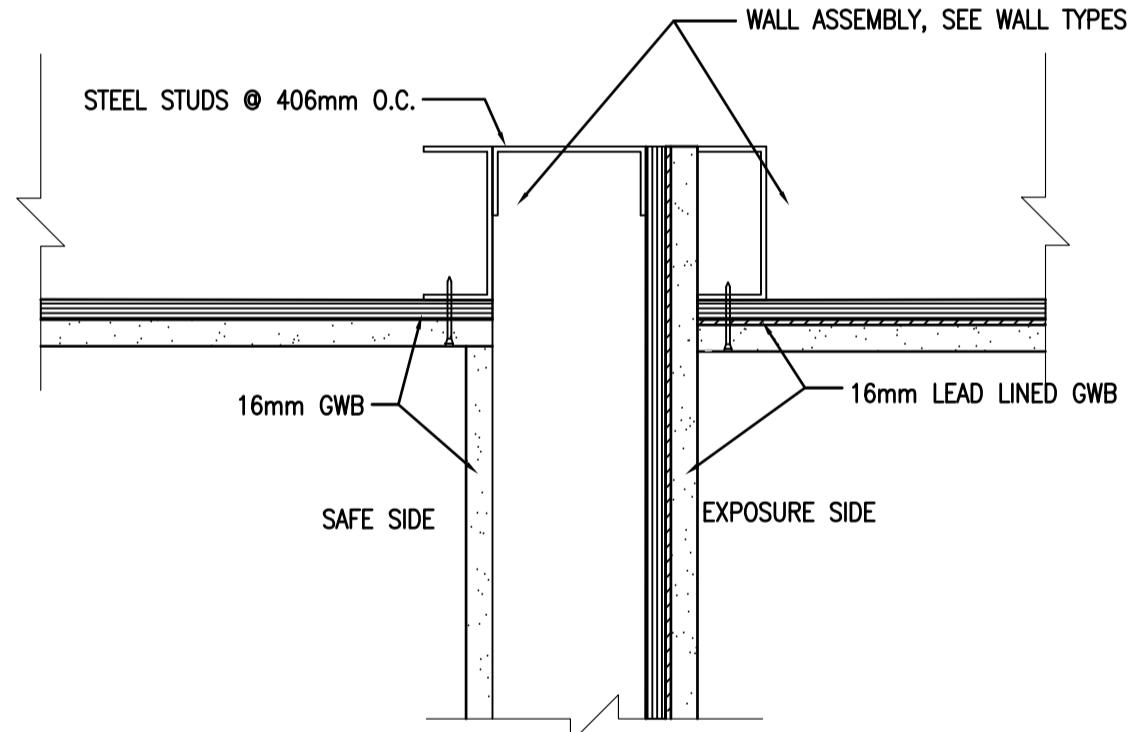


9 CORNER INTERSECTION LEAD DETAIL
A504 1:5

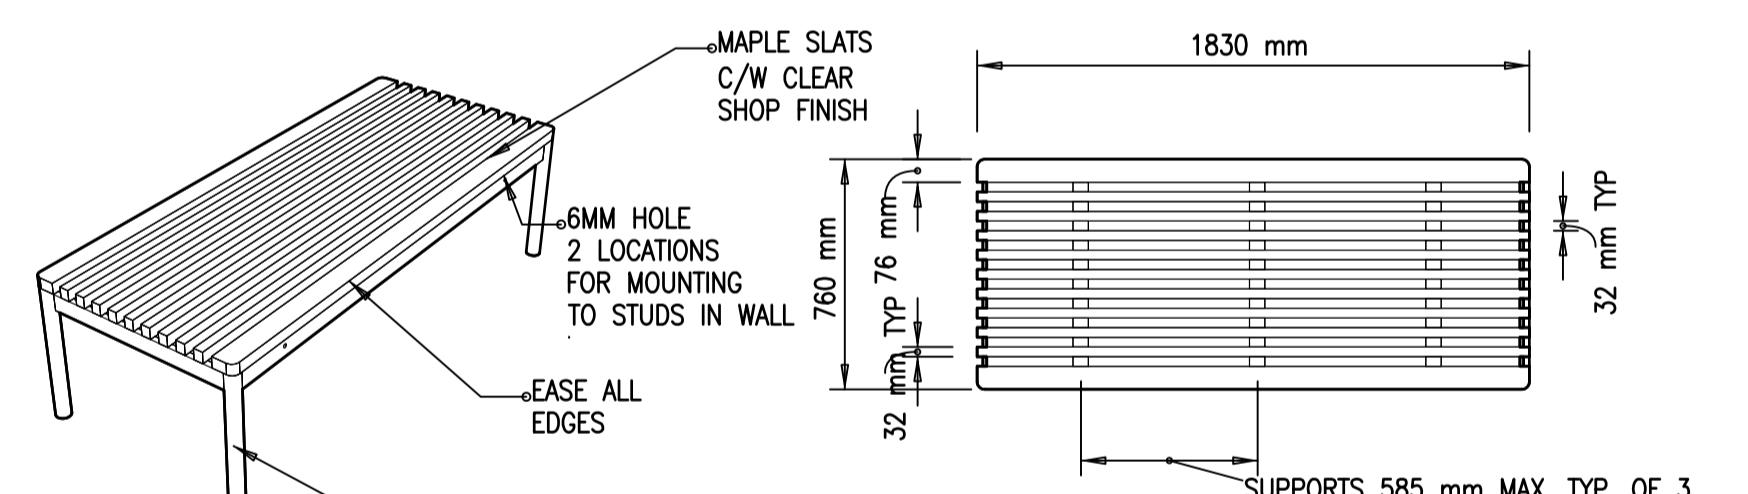

10 CHANGING BENCH DETAILS
A504 1:25

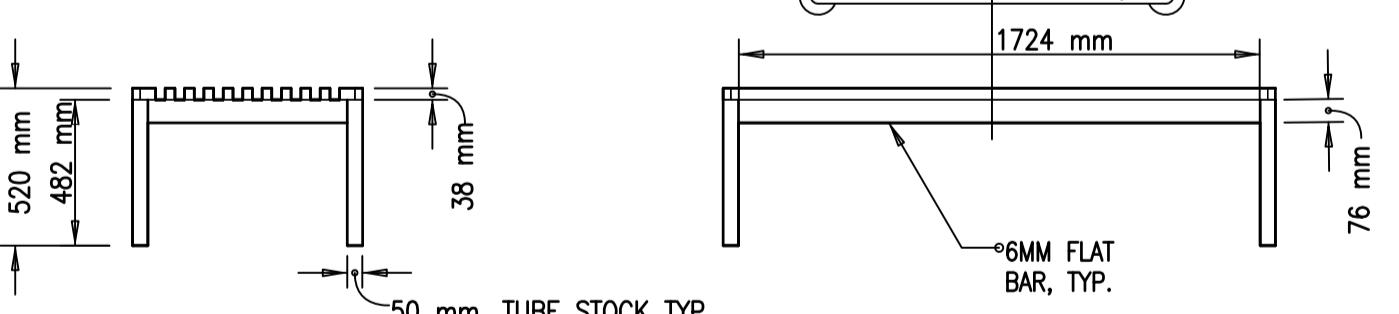

11 ENTRY BENCH DETAIL
A504 1:10

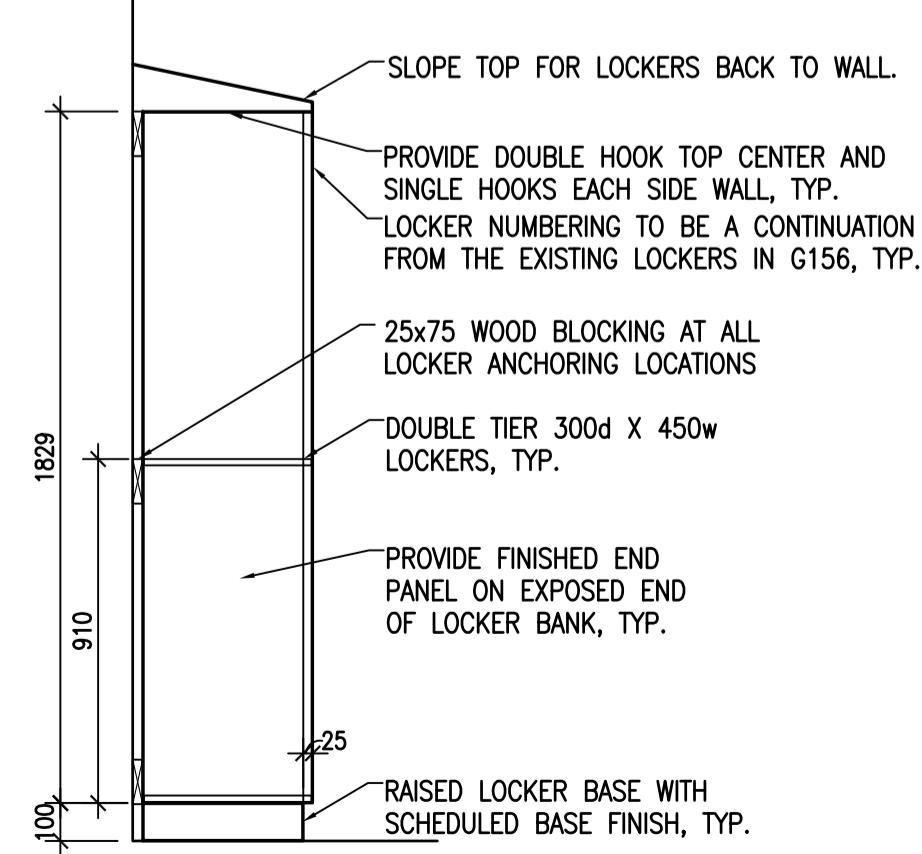

12 LOCKERS DETAIL
A504 1:20

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Project title/Titre du projet
AGASSIZ, BRITISH COLUMBIA
4732 CEMETERY ROAD PO BOX 1600
MOUNTAIN INSTITUTE


MOUNTAIN INSTITUTE HEALTH CARE EXPANSION

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Designed by/Concept par EDWIN BERZINS
Drawn by/Dessiné par NORMANN BAUMANN (2017-09-28)
PWGS Project Manager/Administrateur de Projets TPSGC TONY TANG
Regional Manager, Architectural and Engineering Services Gestionnaire régionale, Services d'architecture et de génie, TPSGC PREETPAL PAUL

Drawing title/Titre du dessin

MISCELLANEOUS DETAILS

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R.077724.001	A504	0

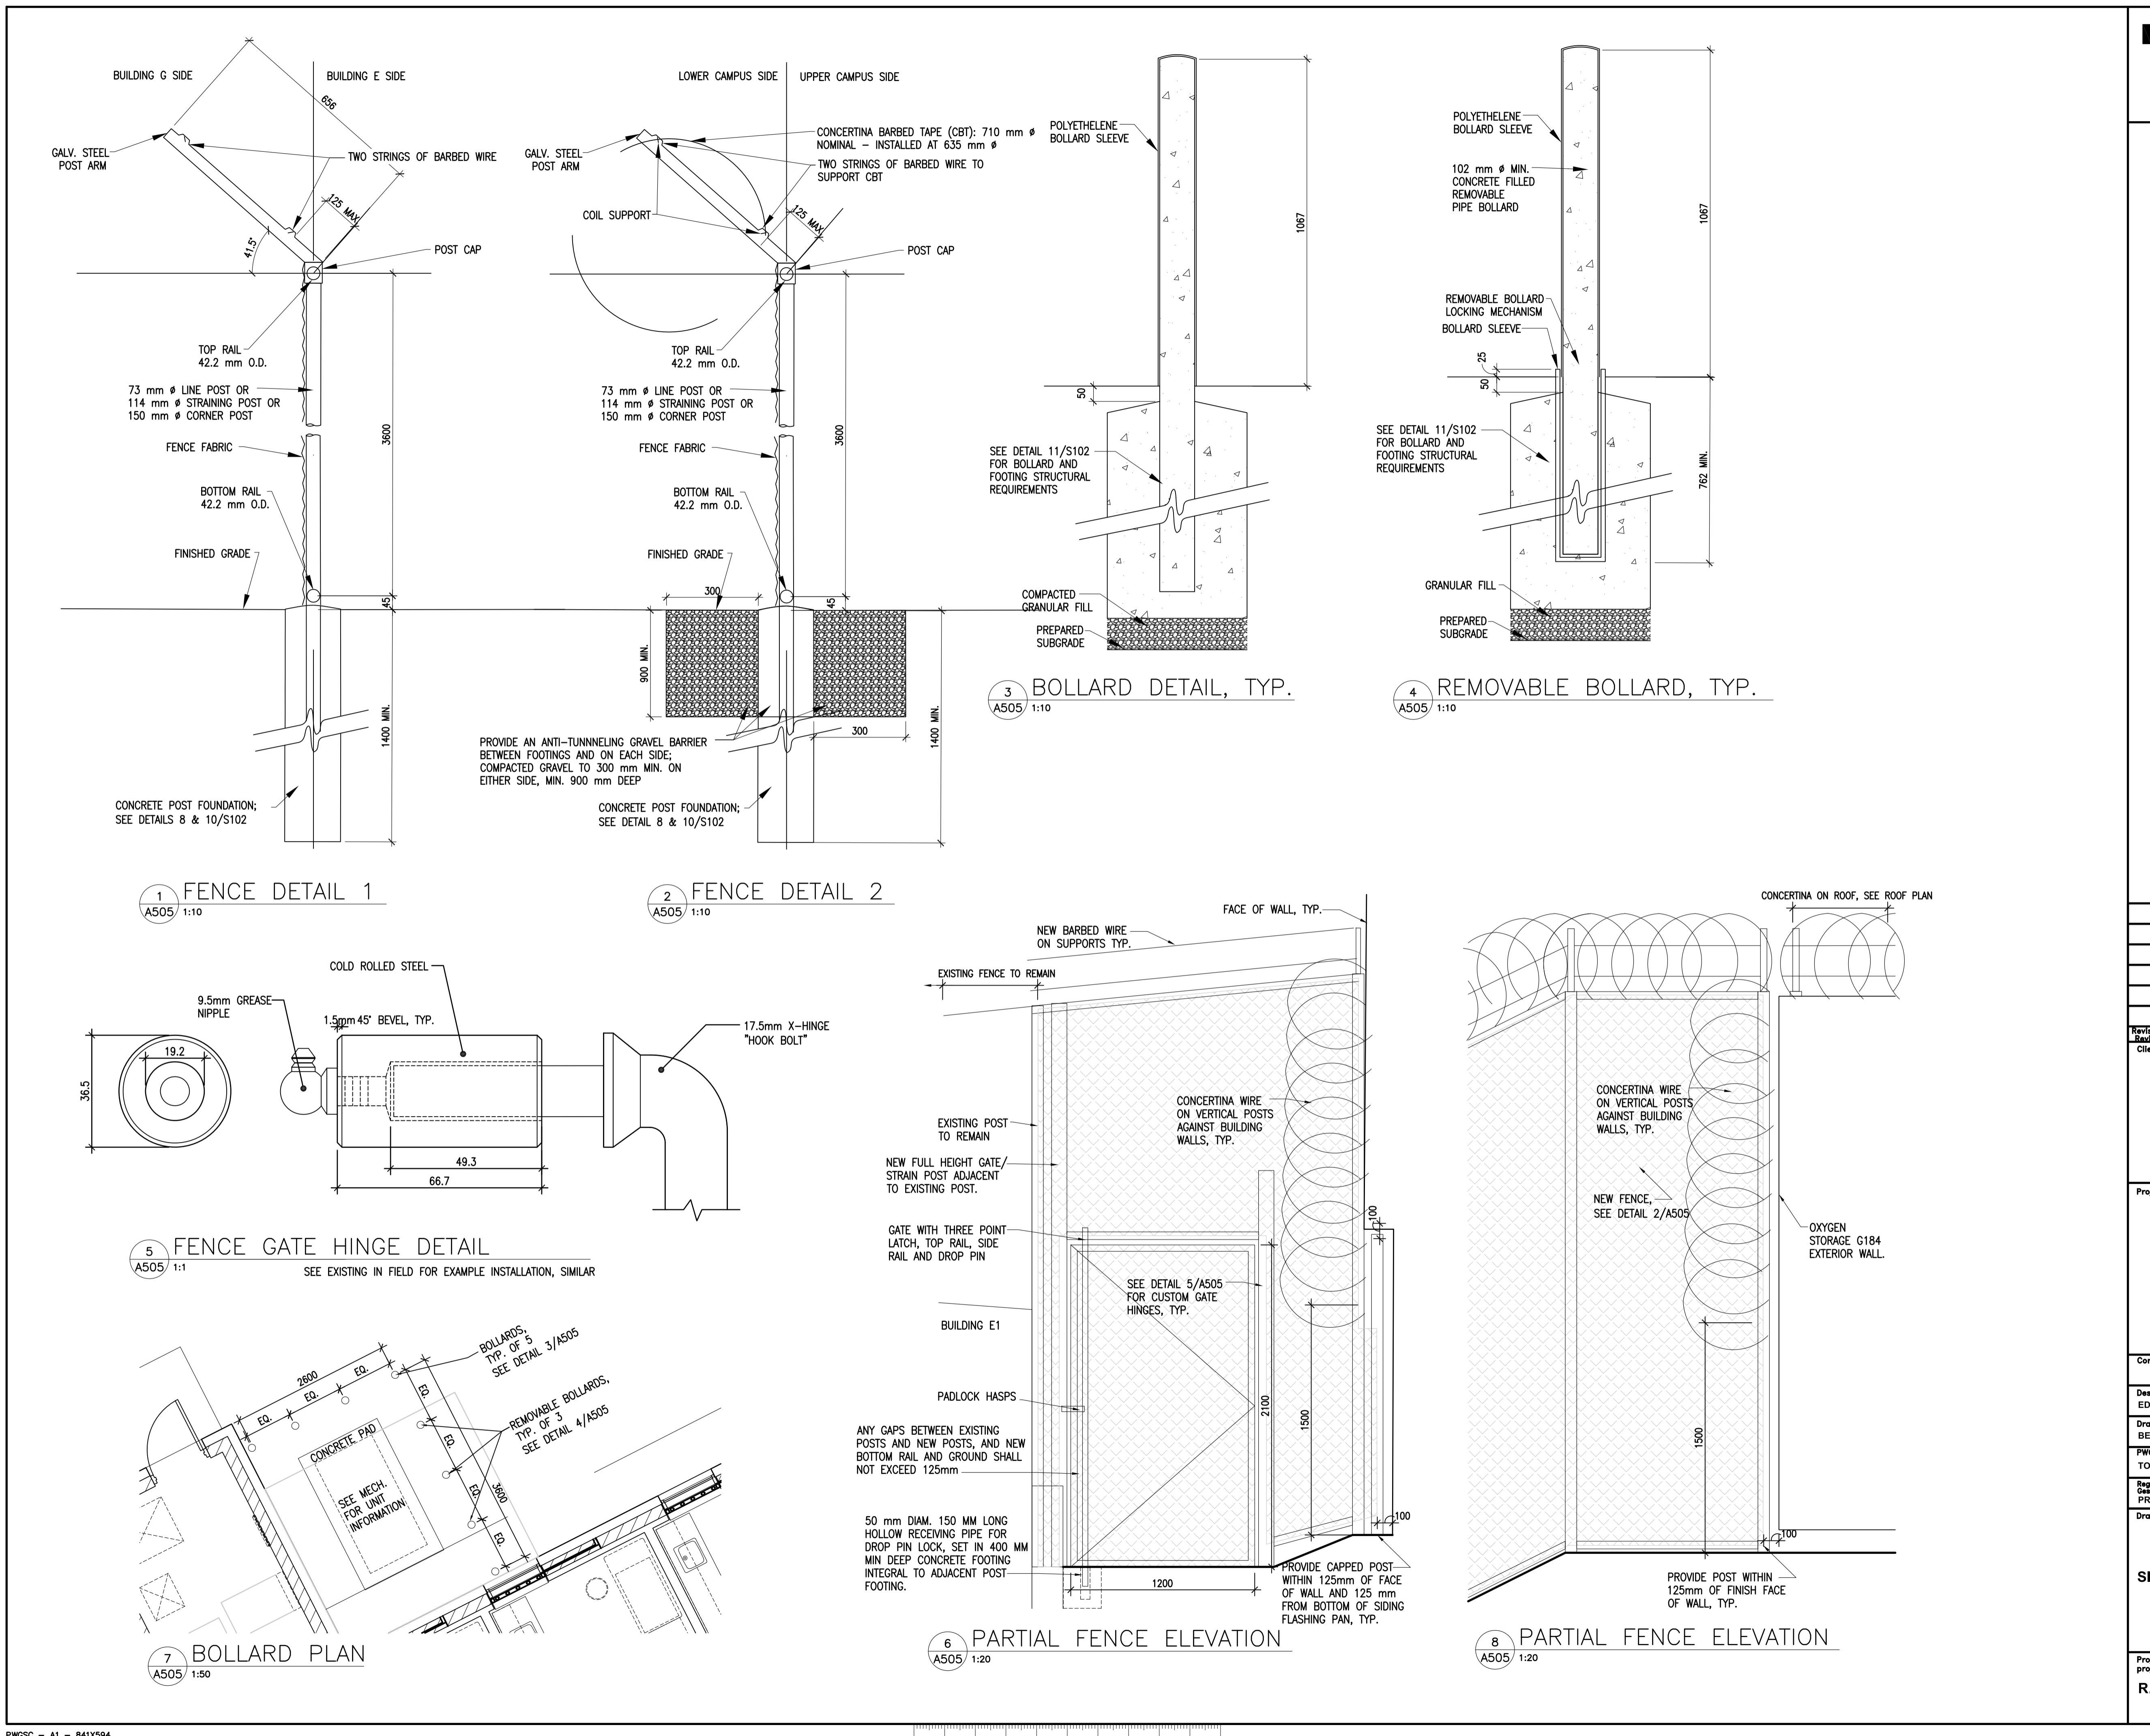

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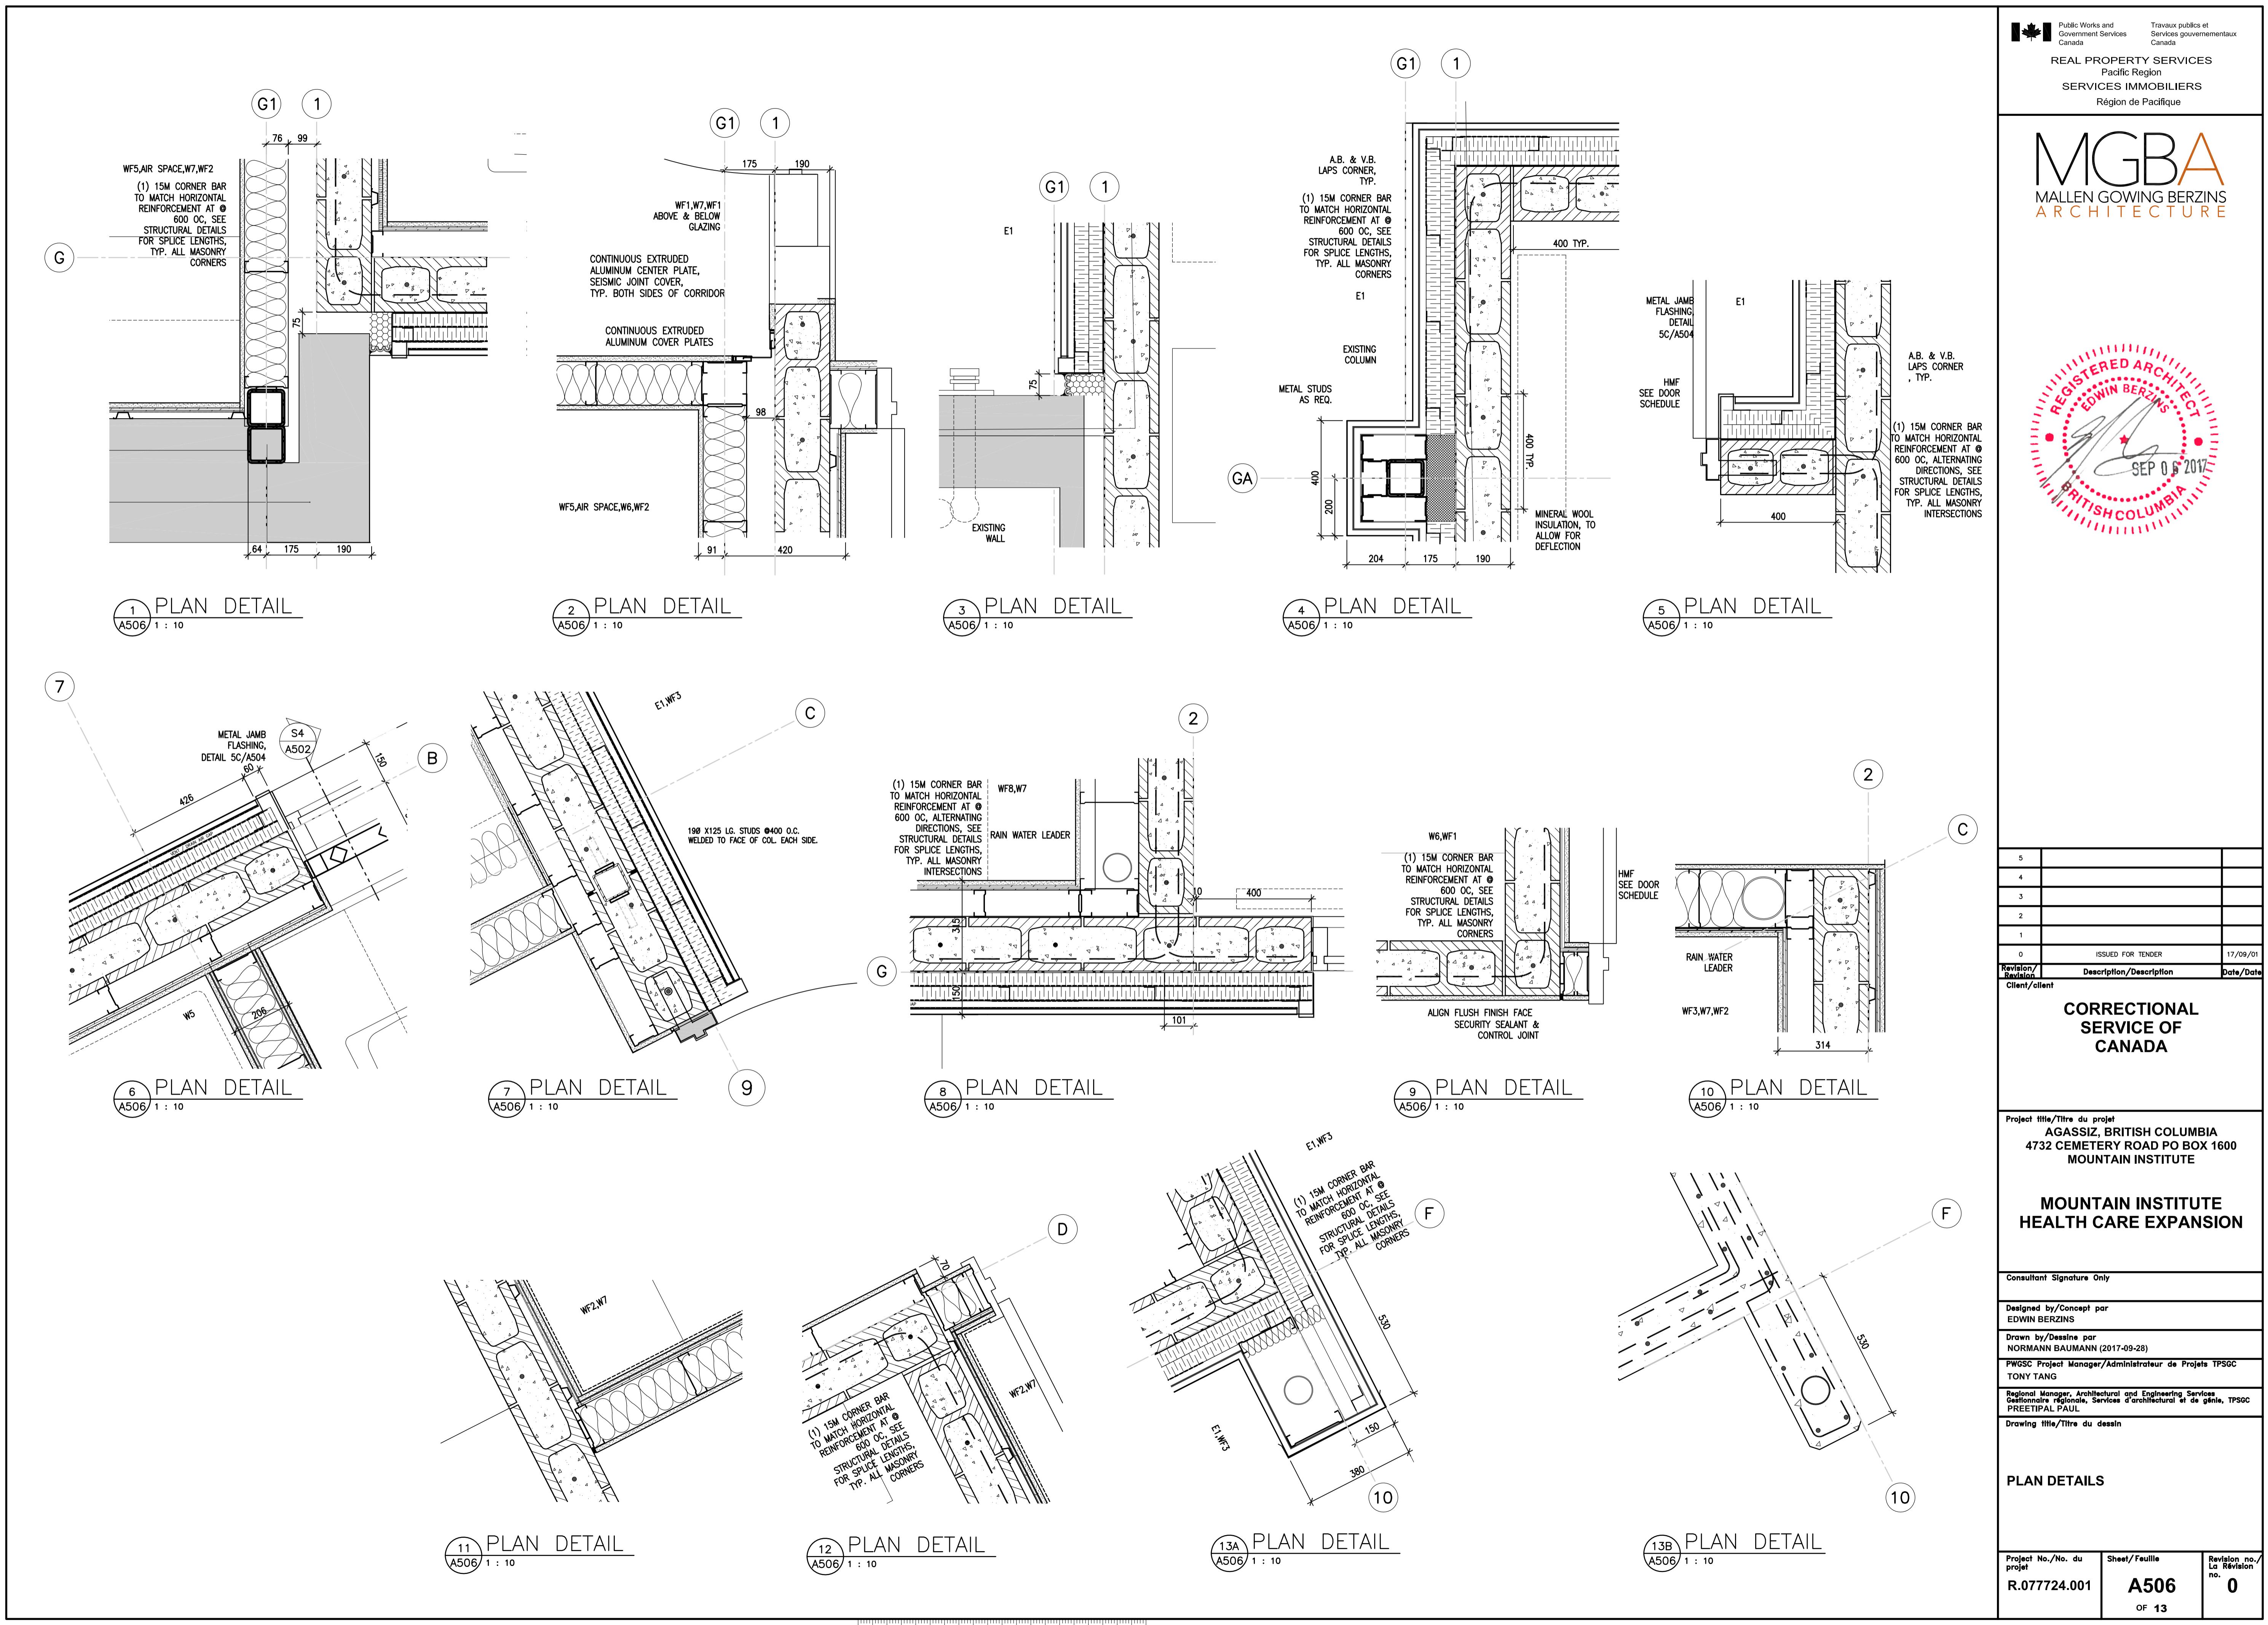
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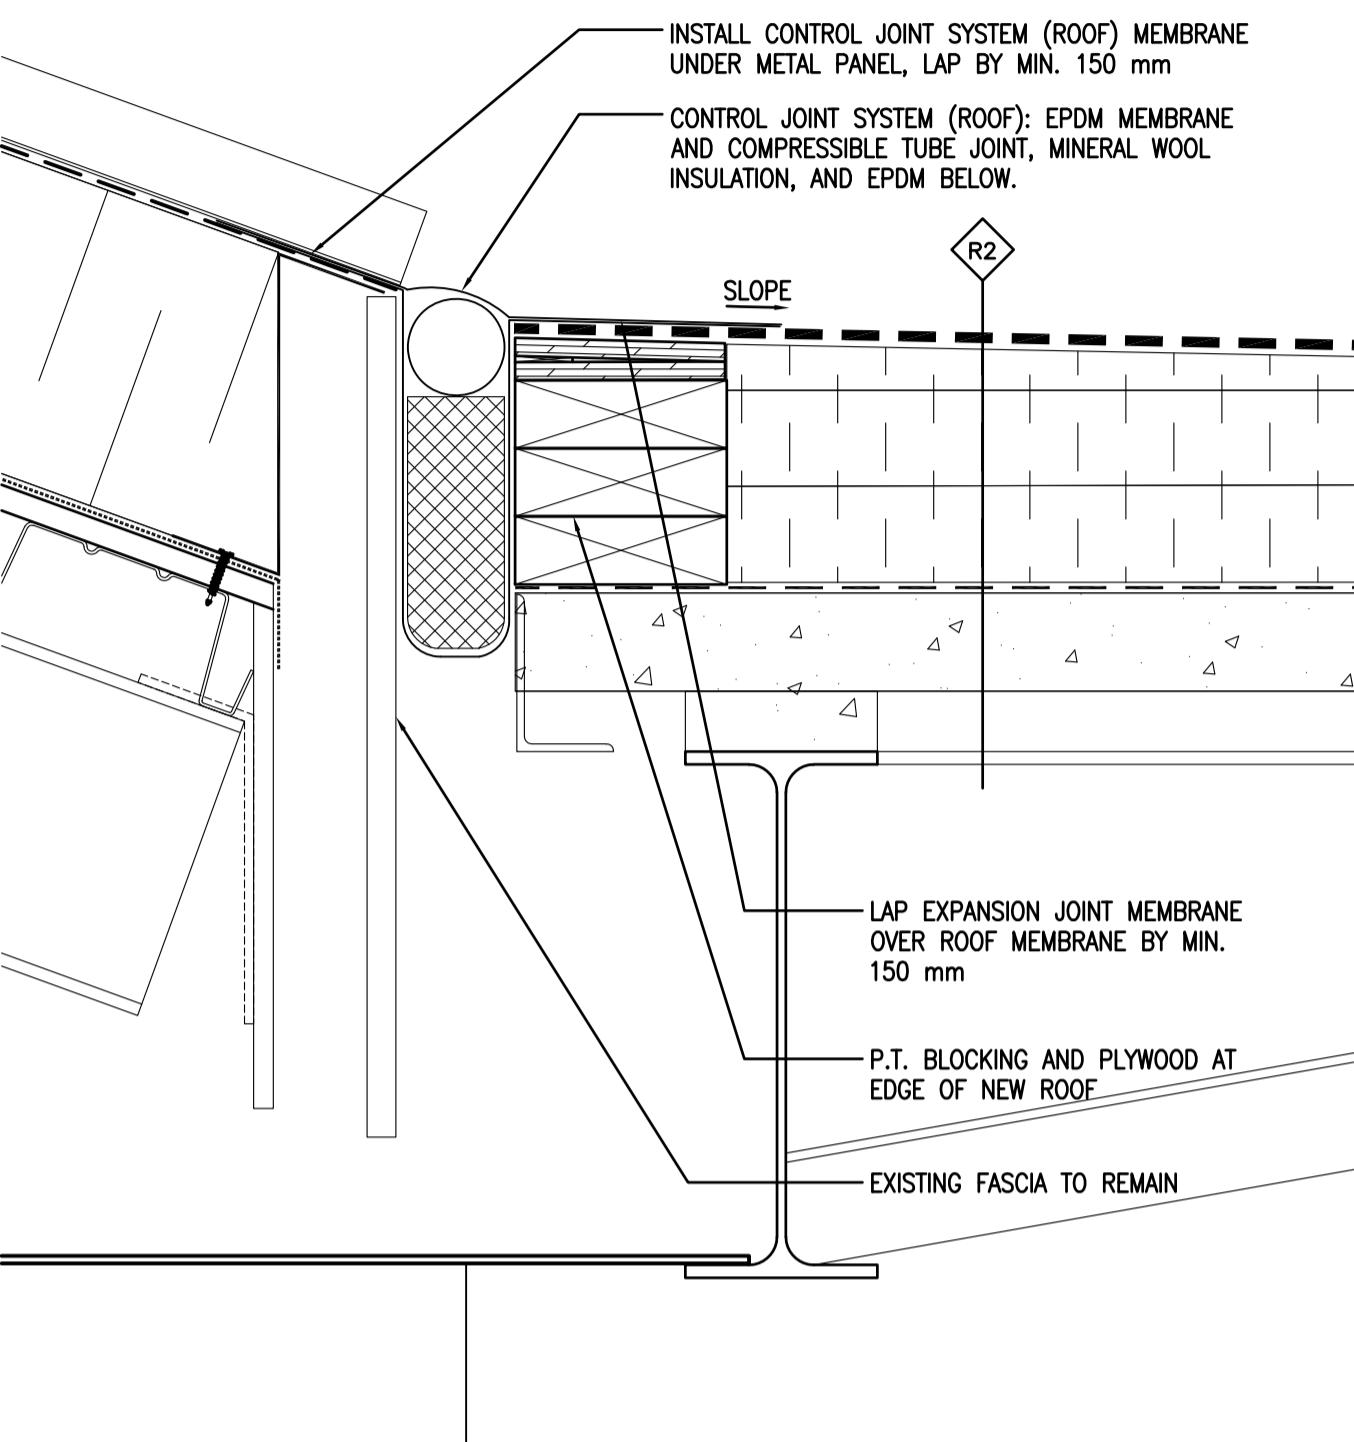
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projet R.077724.001

Sheet/Feuille A505


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Révision no. 0

OF 13







01 SECTION DETAIL @ ROOF
A507 1:5

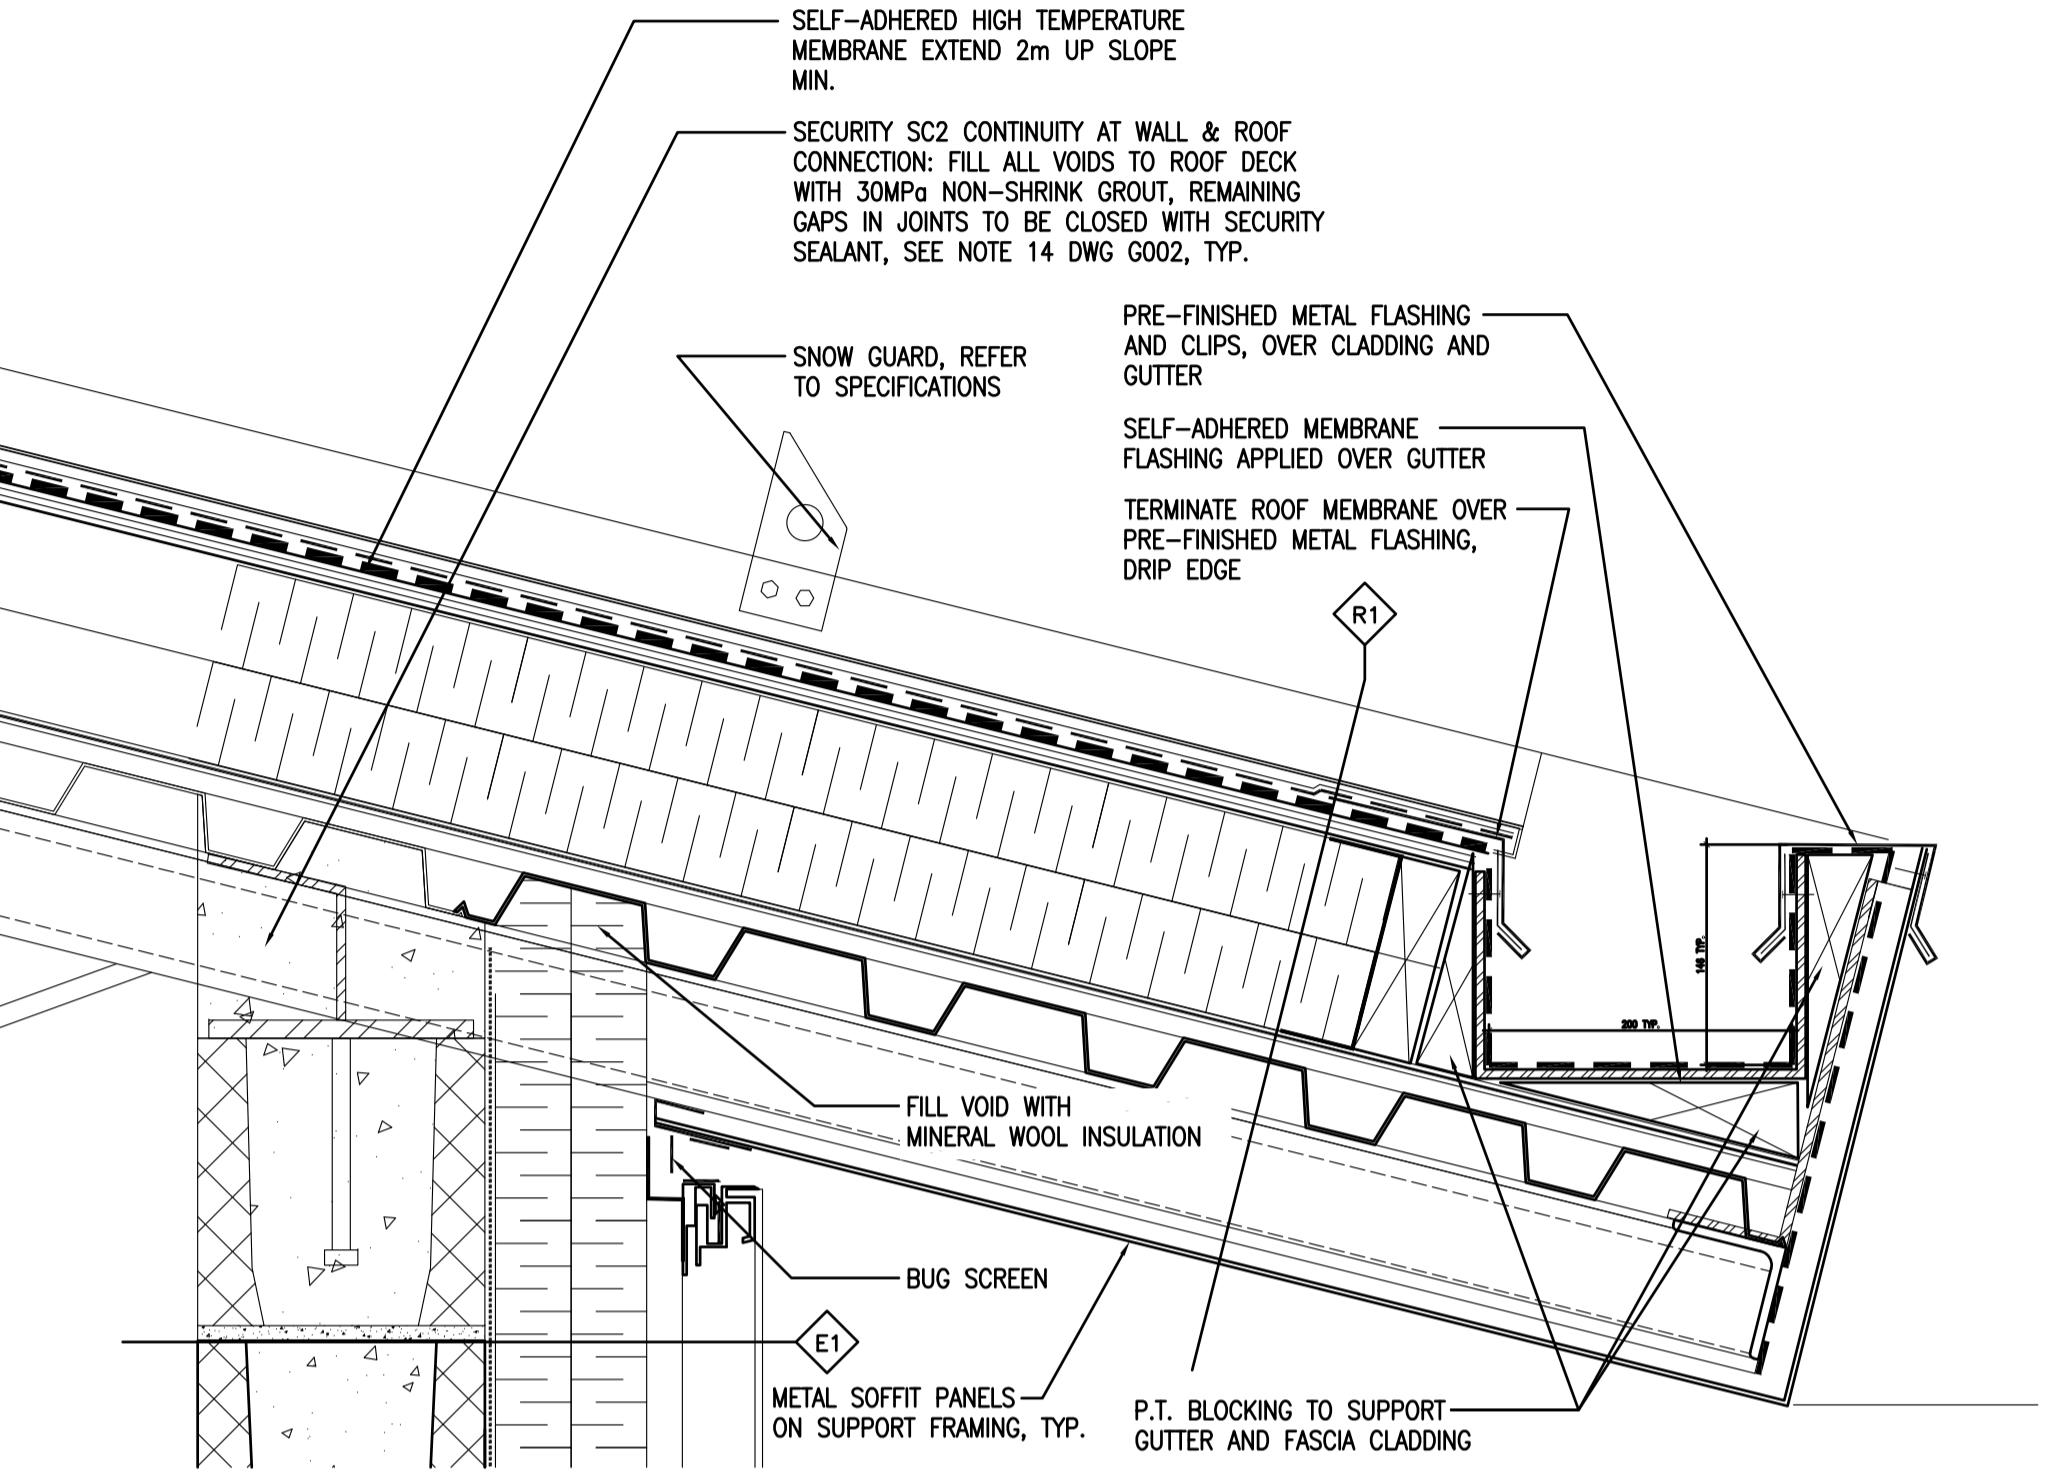


02 GUTTER DETAIL
A507 1:5

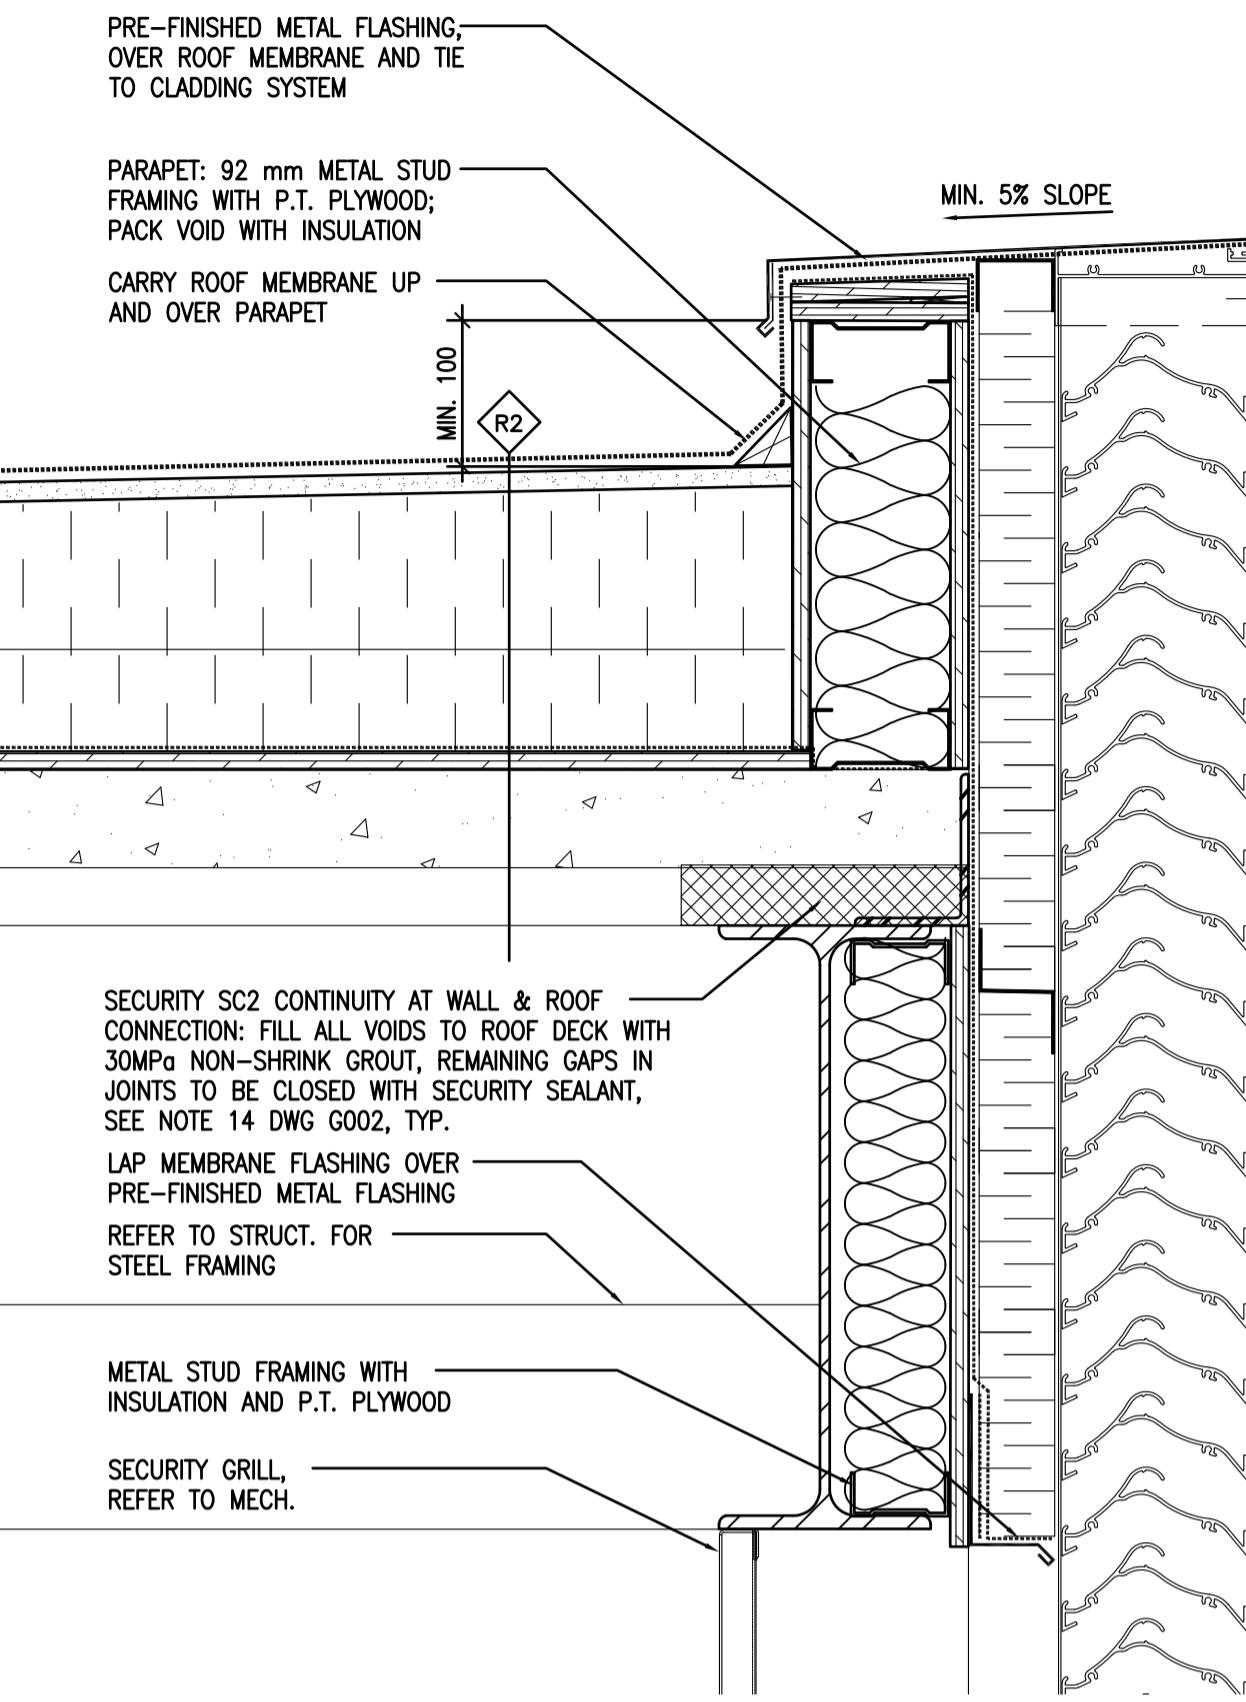


03 PARAPET DETAIL
A507 1:5

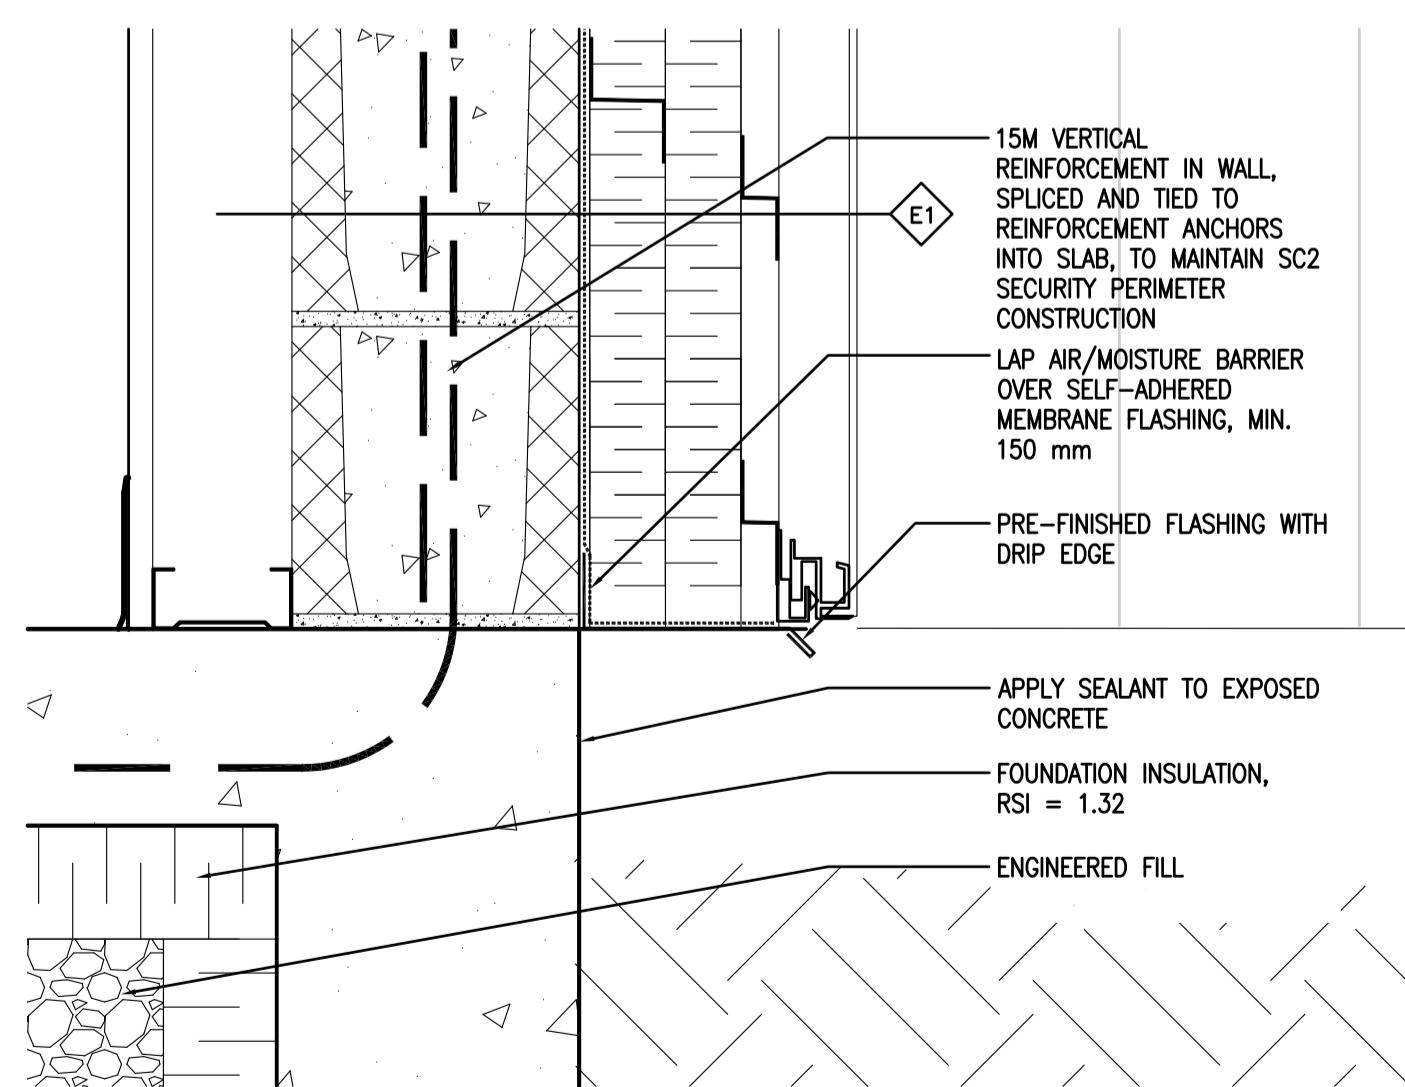

04 BASE OF WALL DETAIL
A507 1:5

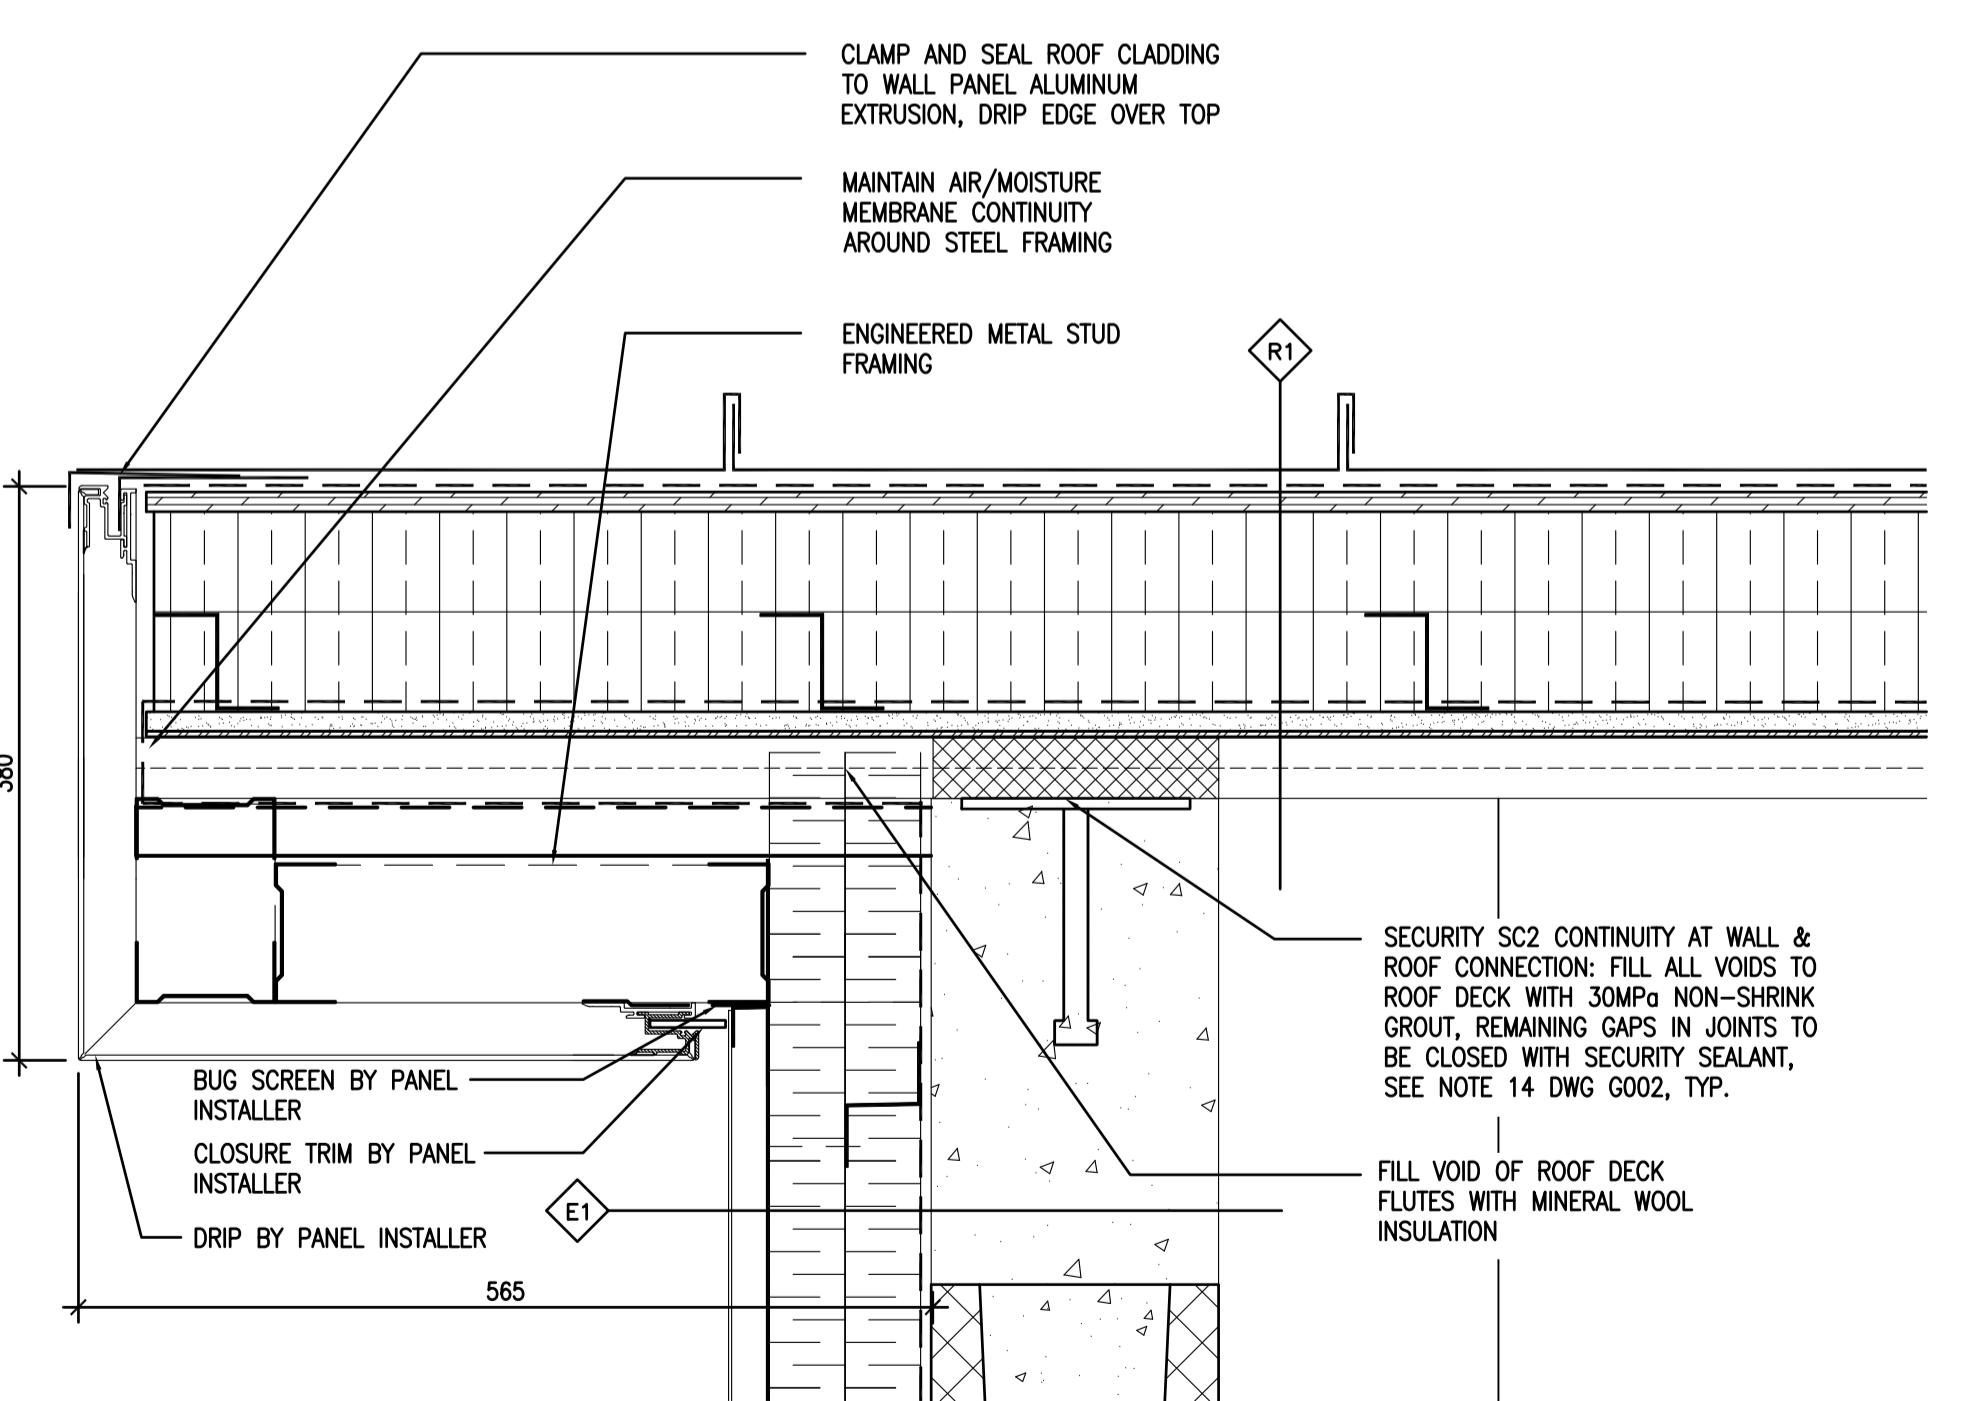

05 RAKE DETAIL 1
A507 1:5

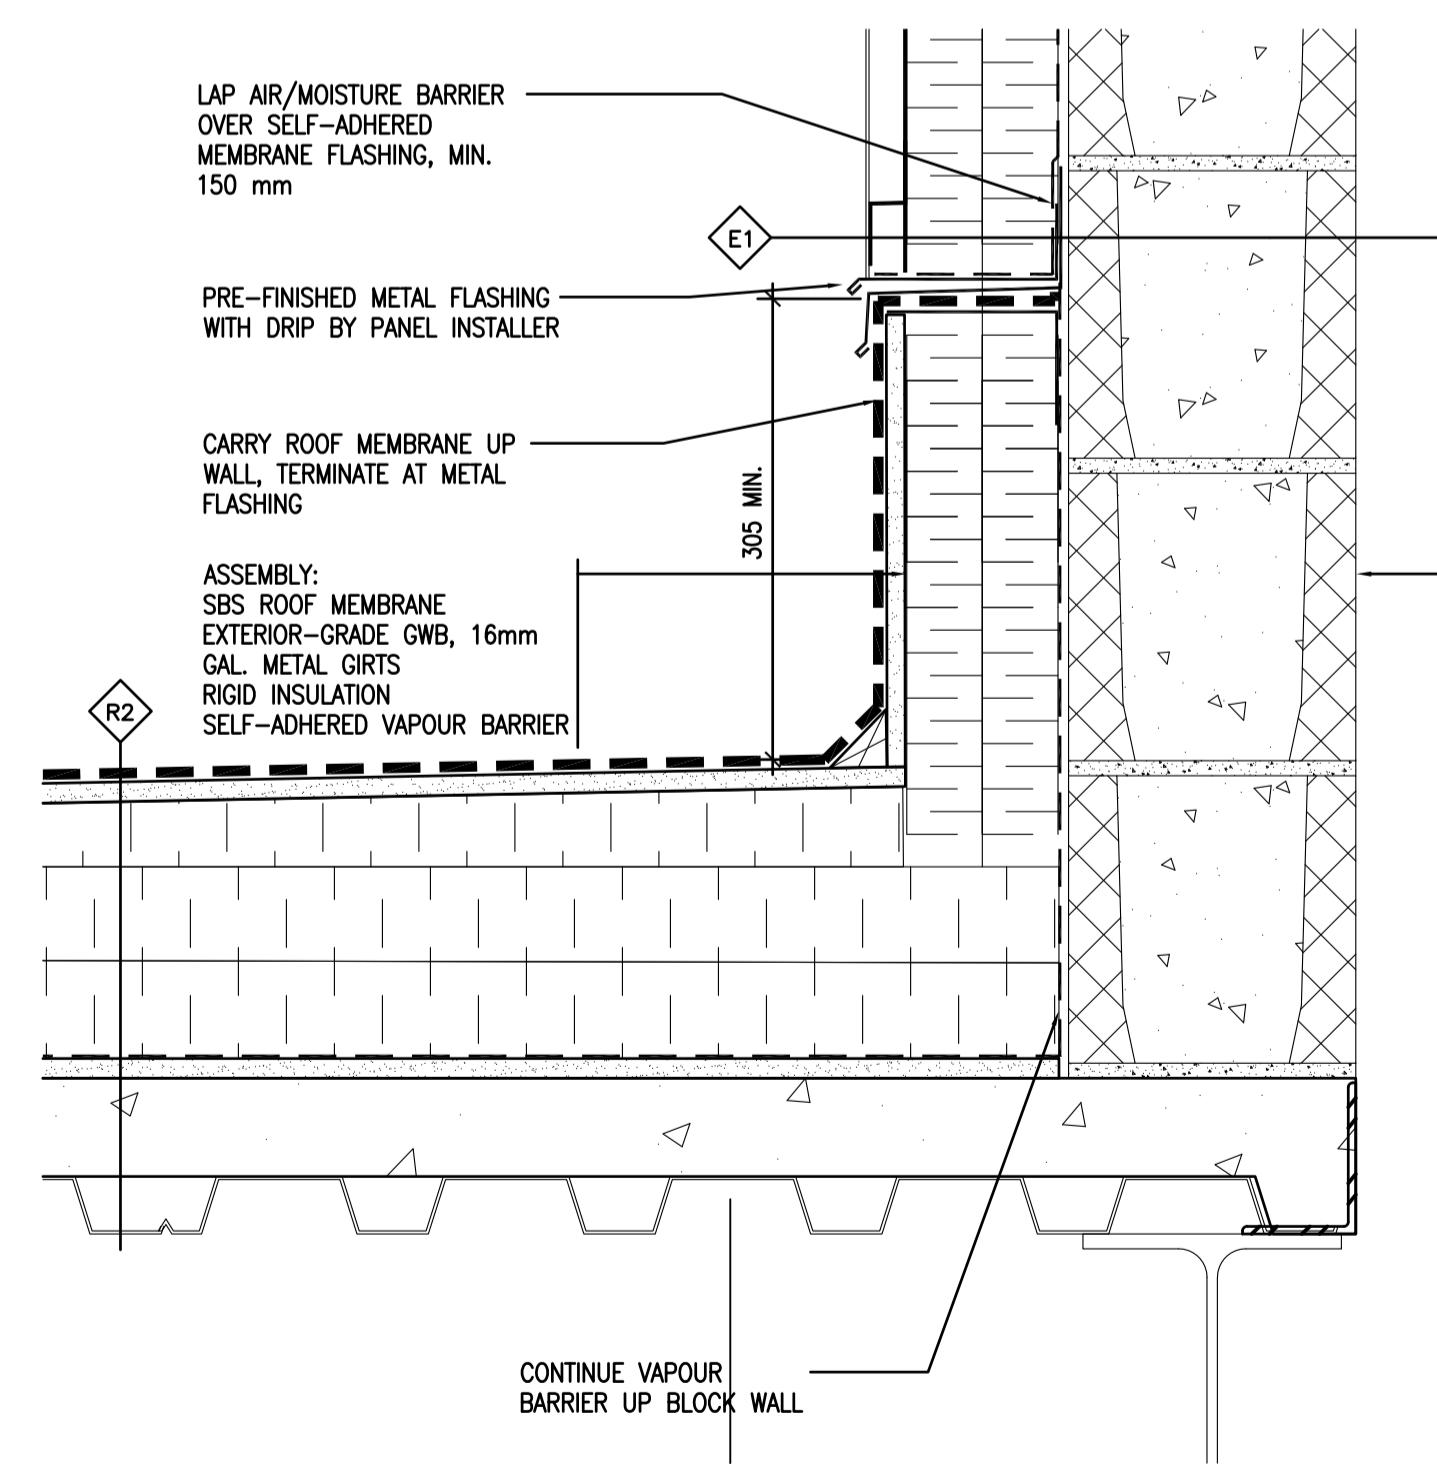

06 ROOF/WALL DETAIL
A507 1:5

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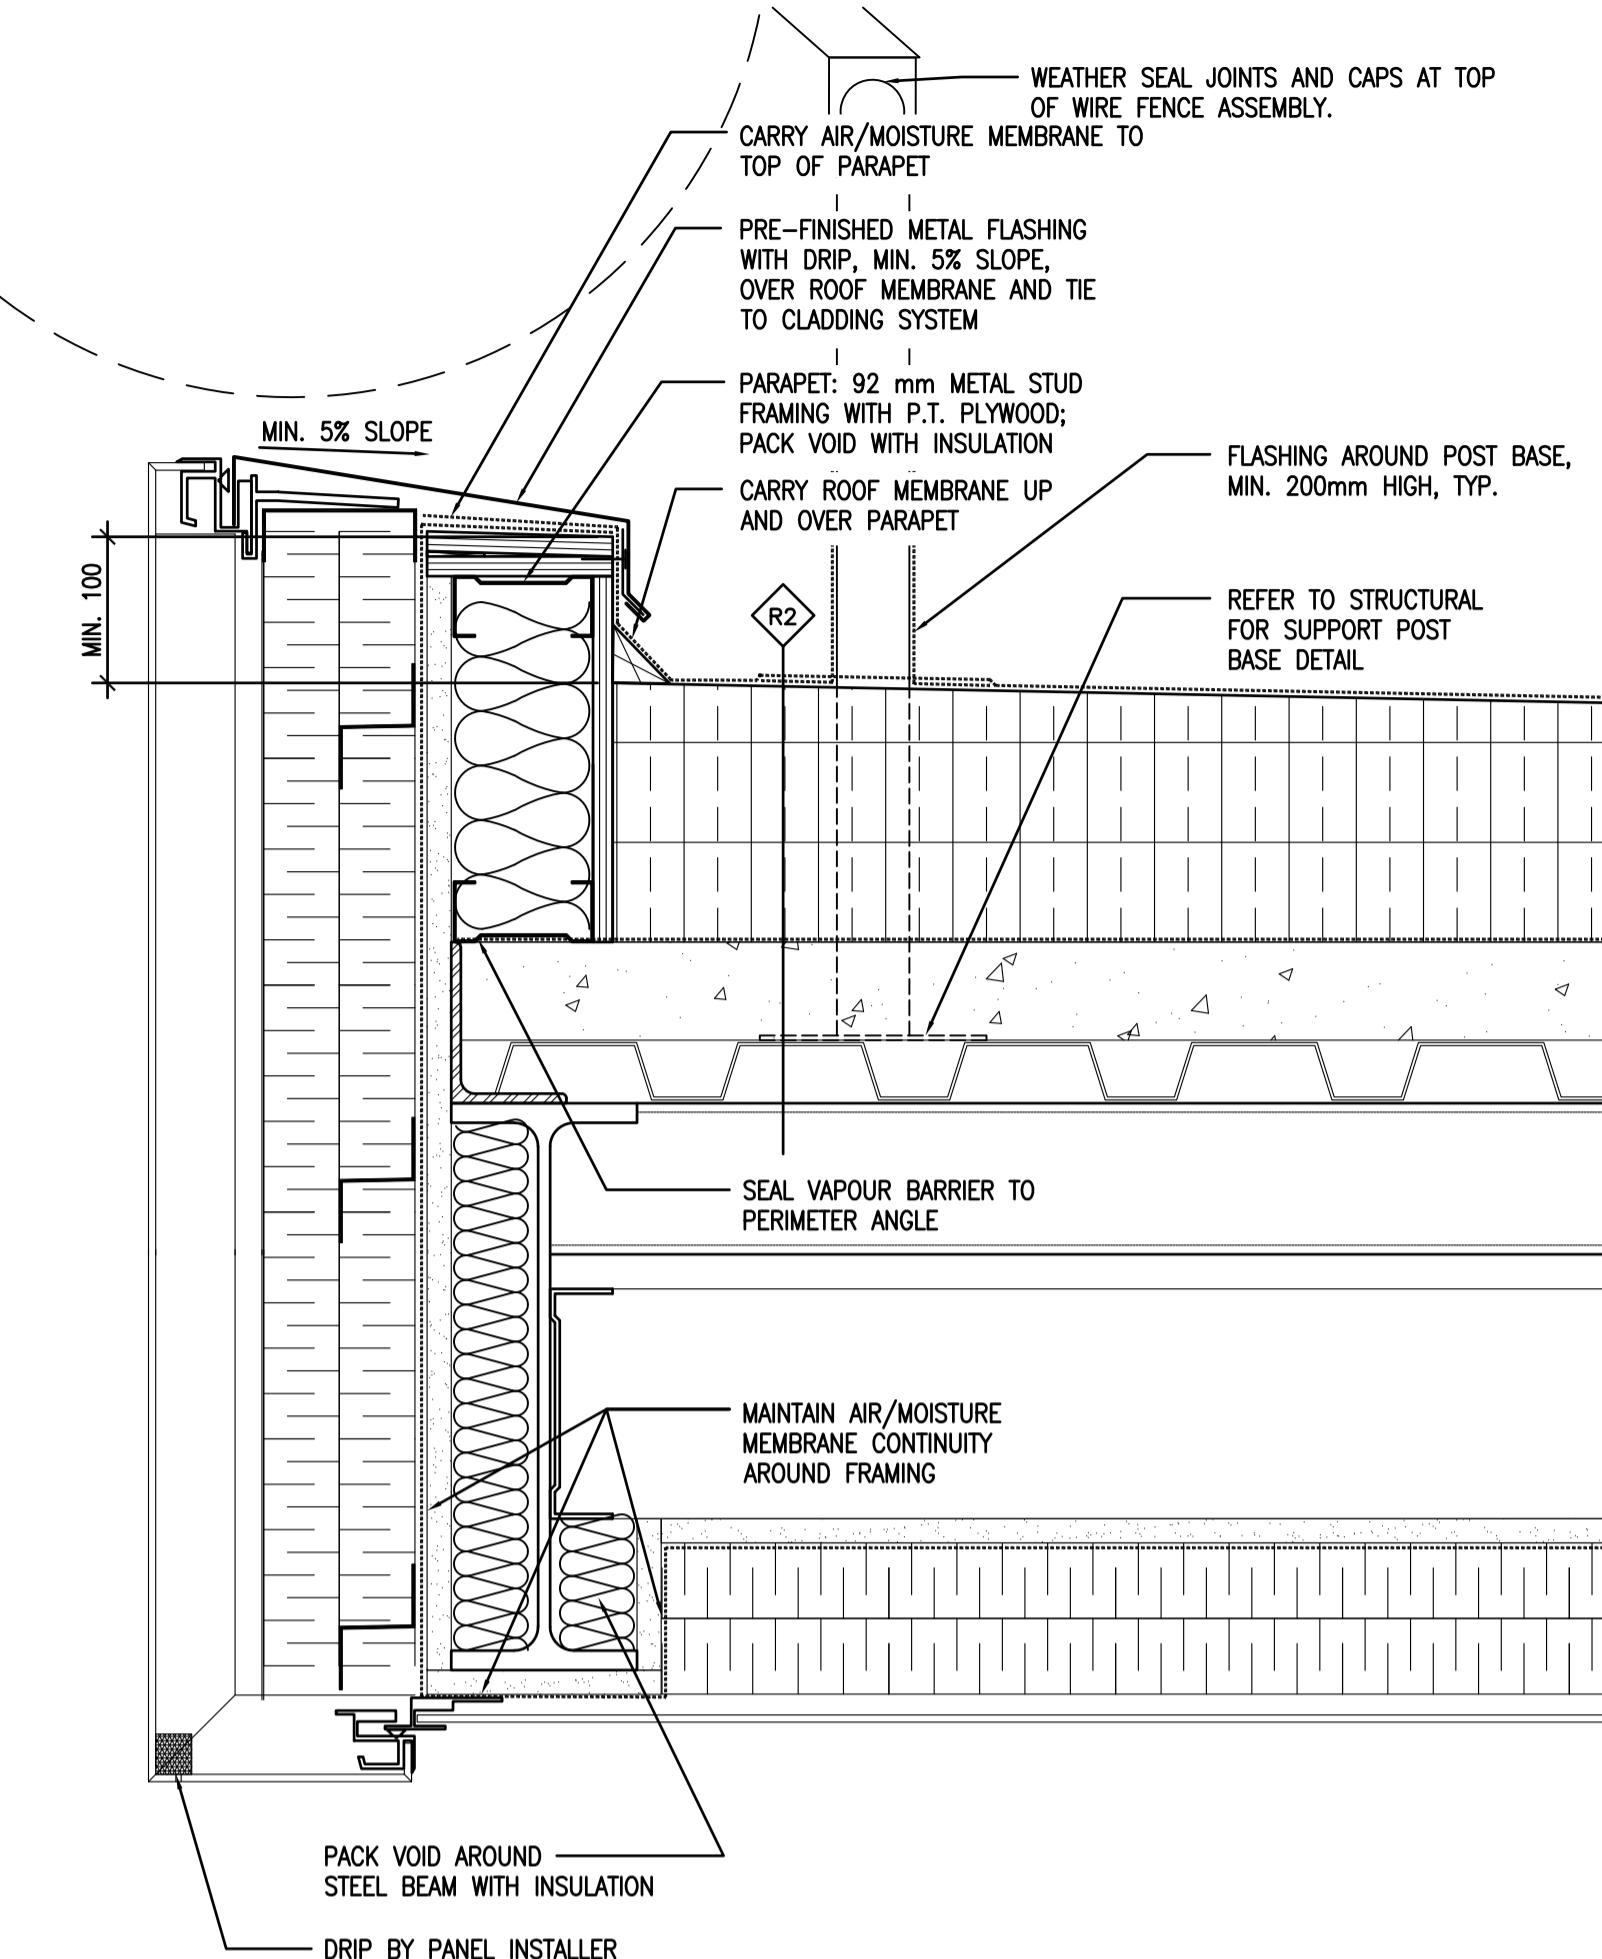
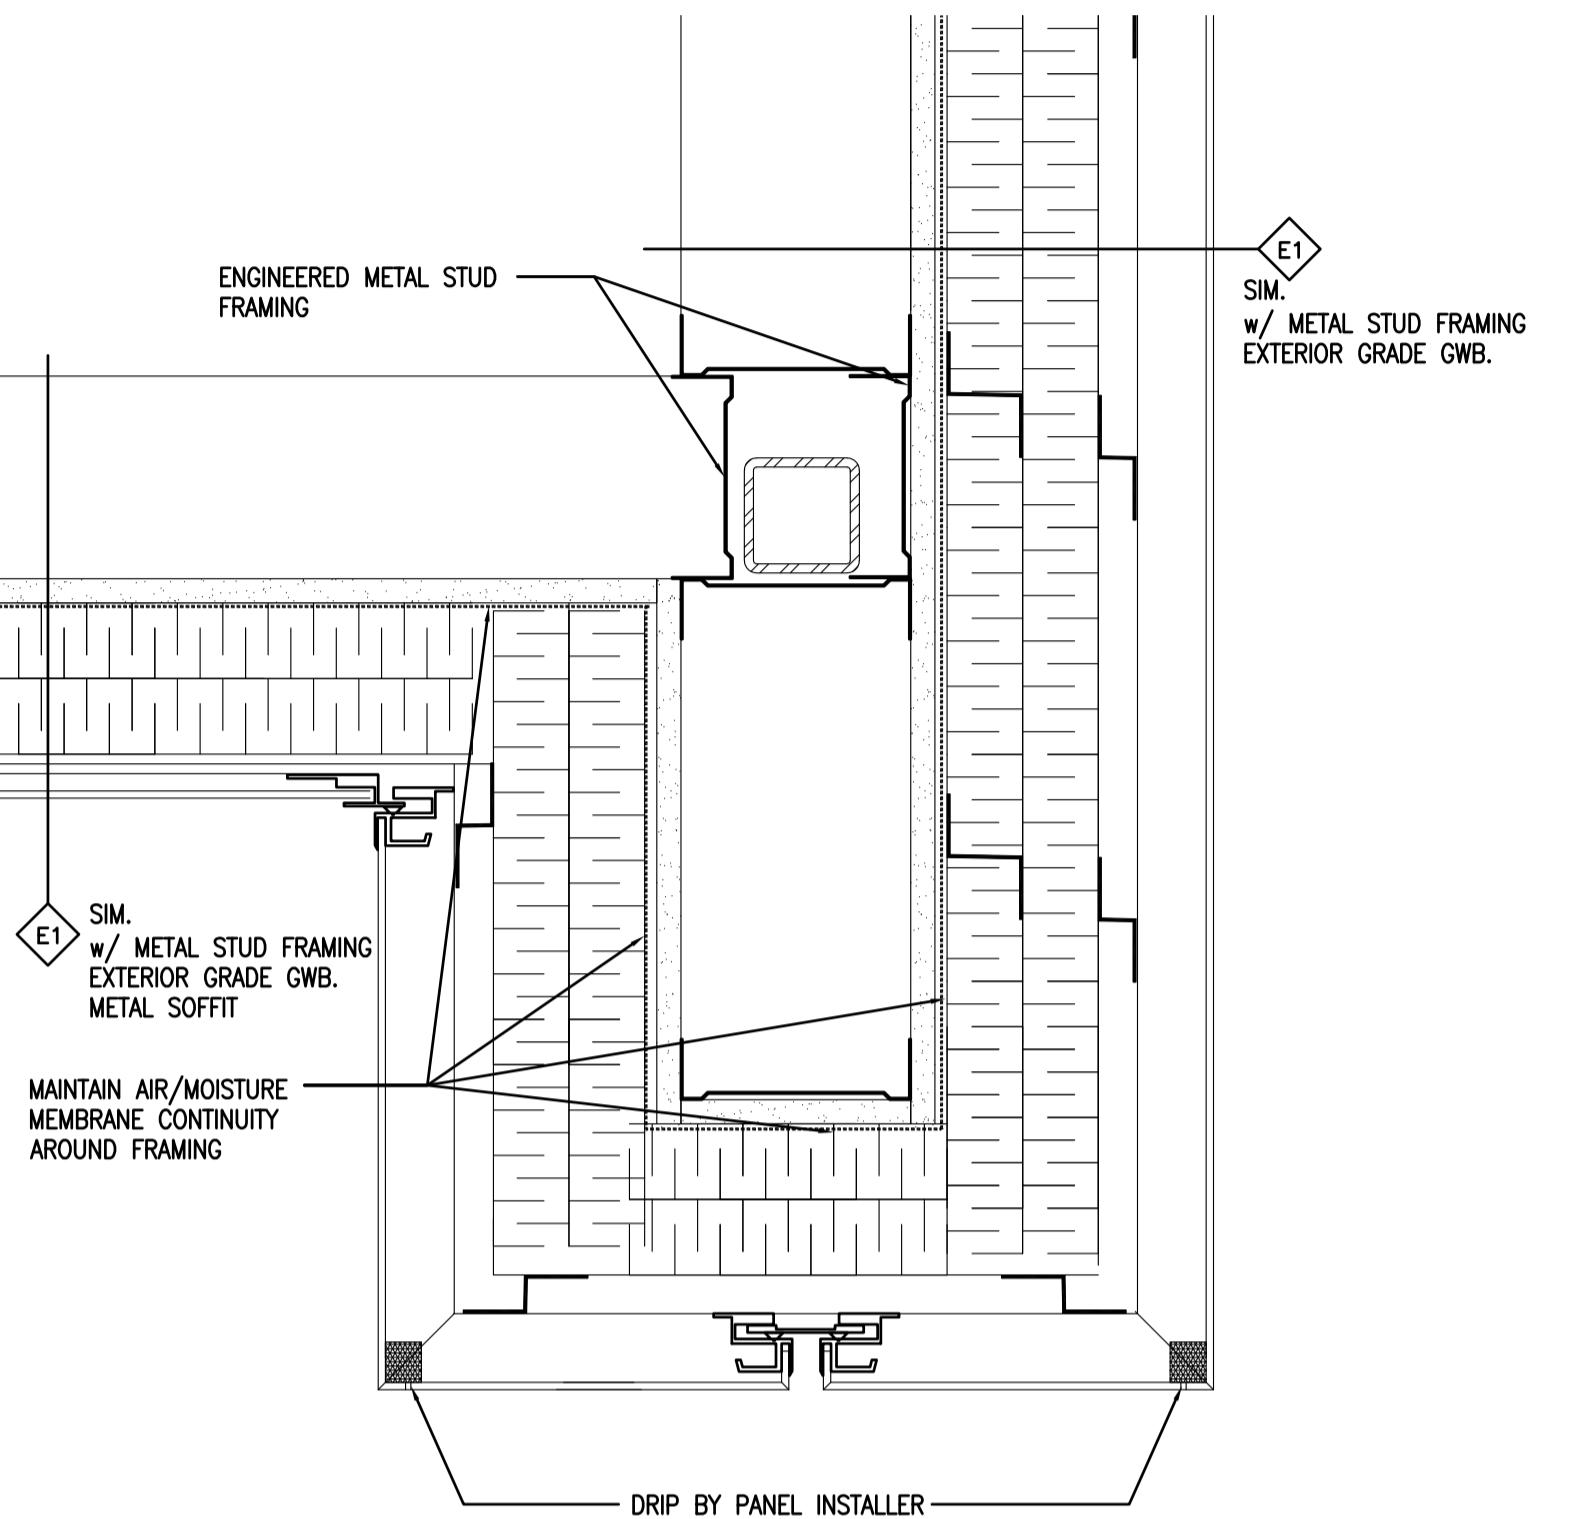
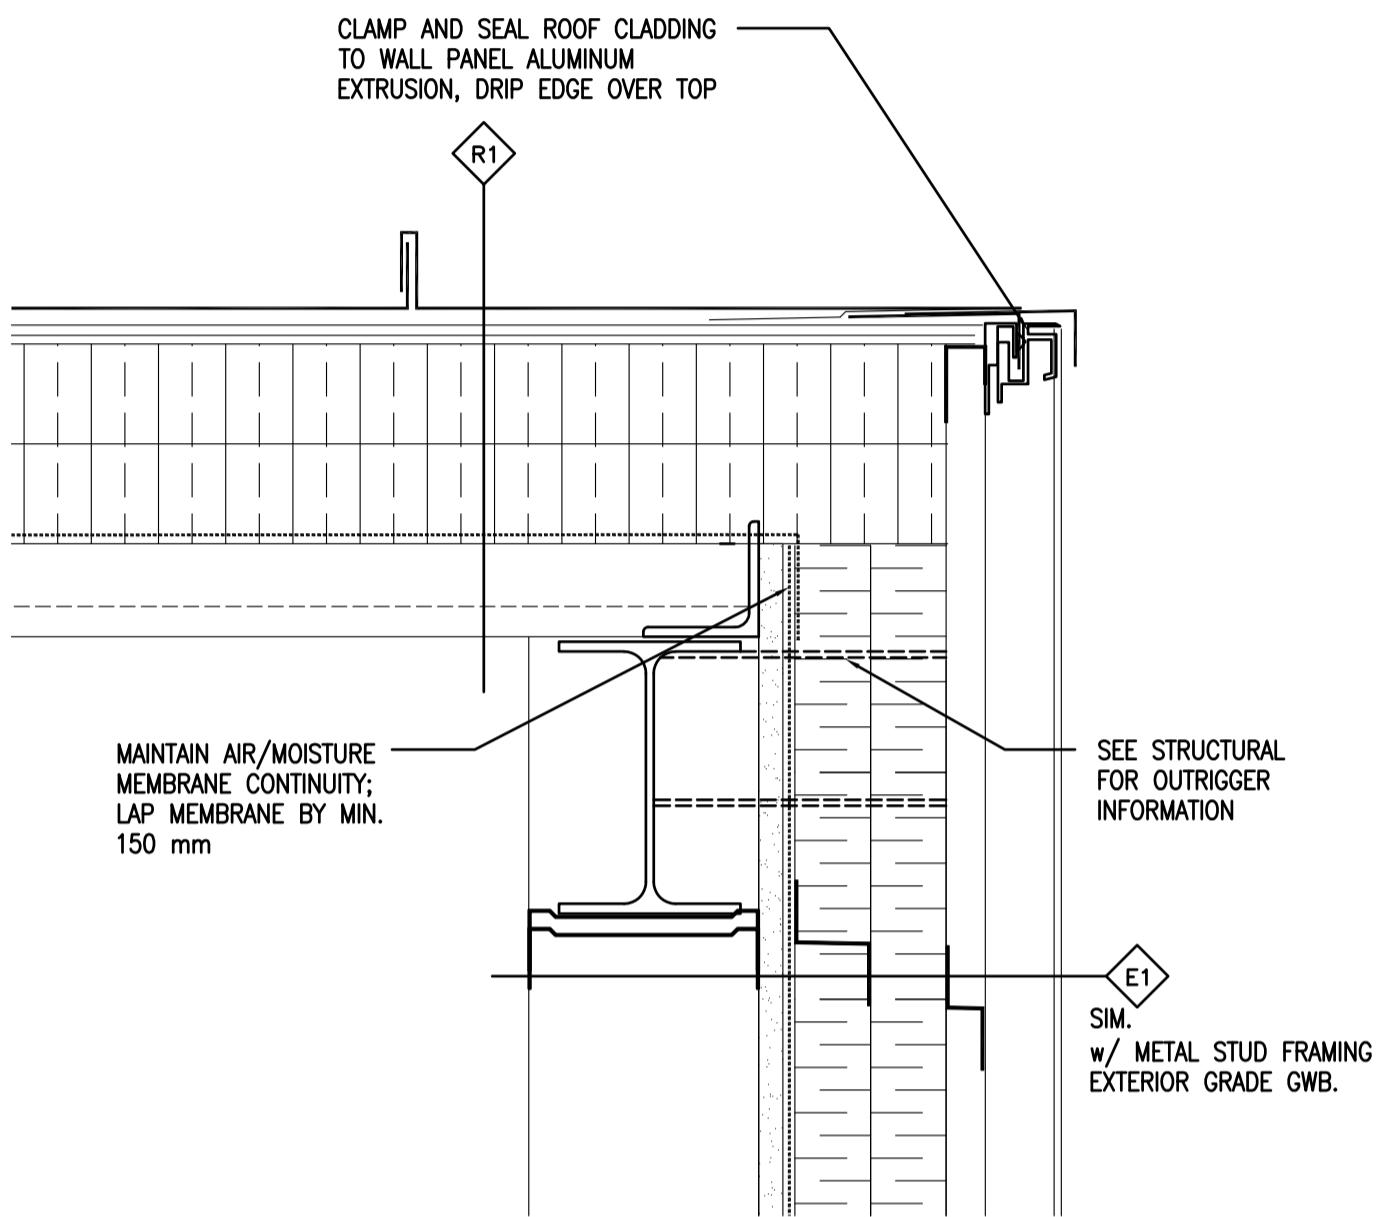
Project Title/Titre du projet
AGASSIZ, BRITISH COLUMBIA
4732 CEMETERY ROAD PO BOX 1600
MOUNTAIN INSTITUTE

MOUNTAIN INSTITUTE HEALTH CARE EXPANSION

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Designed by/Concept par
EDWIN BERZINS
Drawn by/Dessiné par
BEN MONROE / MING HSU
PWGSC Project Manager/Administrateur de Projets TPSGC
TONY TANG
Regional Manager, Architectural and Engineering Services
Gestionnaire régionale, Services d'architecture et de génie, TPSGC
PREETPAL PAUL
Drawing title/Titre du dessin

SECTION DETAILS 1


Project No./No. du projet	Sheet/Feuille	Revision no./ La Révision no.
R.077724.001	A507	0




01 RAKE DETAIL 2
A508 1:5

02 SOFFIT DETAIL
A508 1:5


03 CANOPY DETAIL
A508 1:5

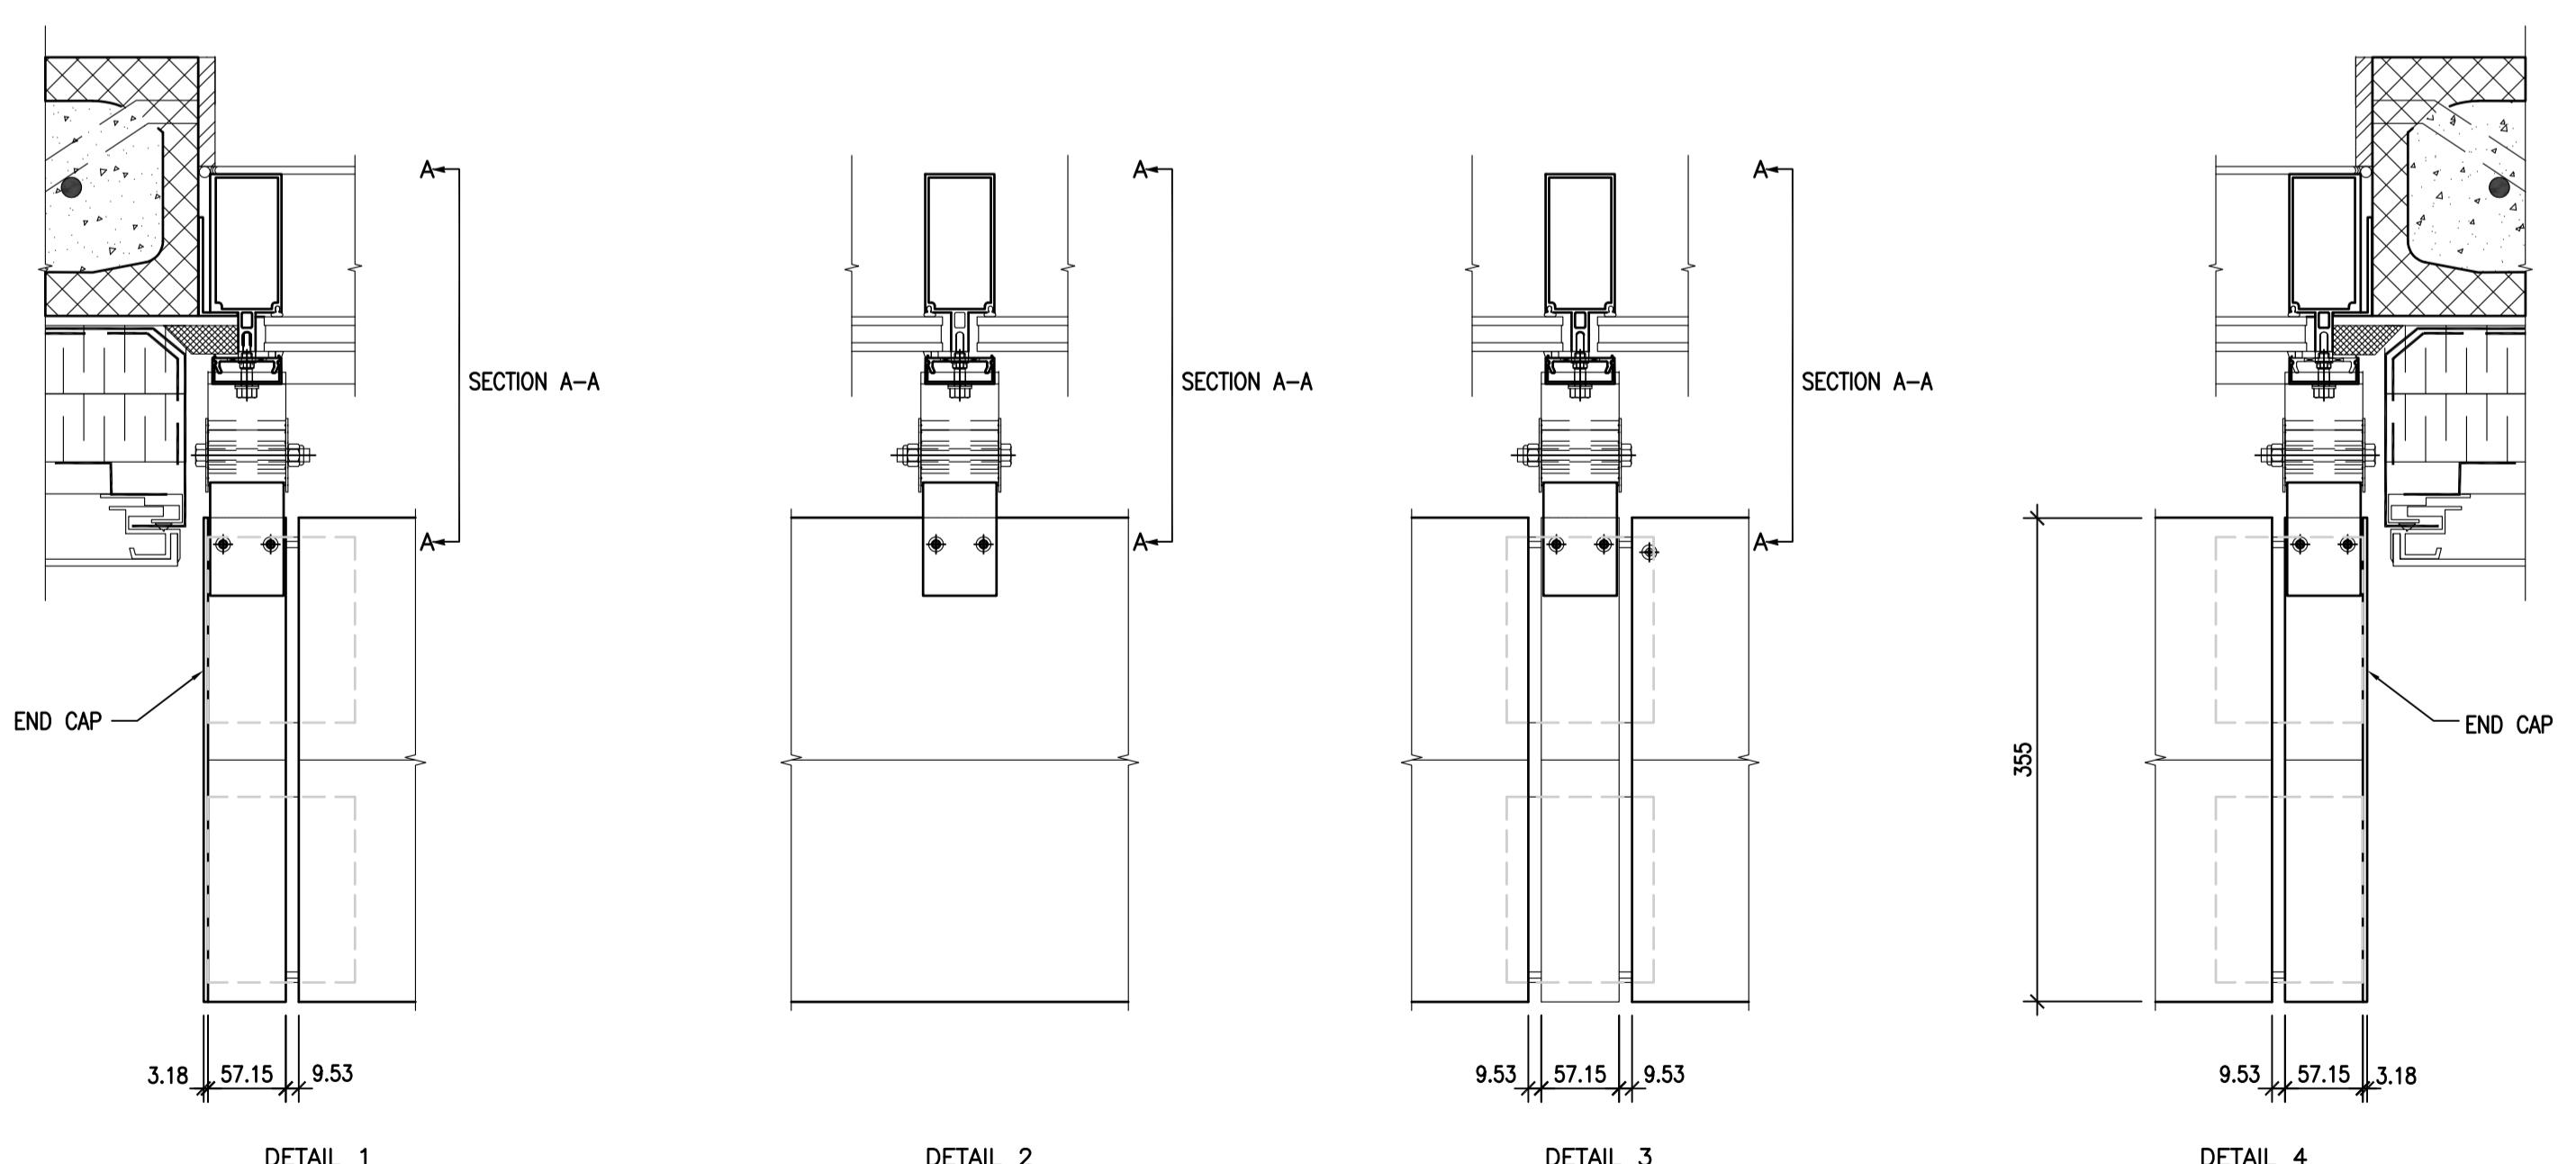

04 SUN SHADE DETAILS
A508 SCALE 1:5

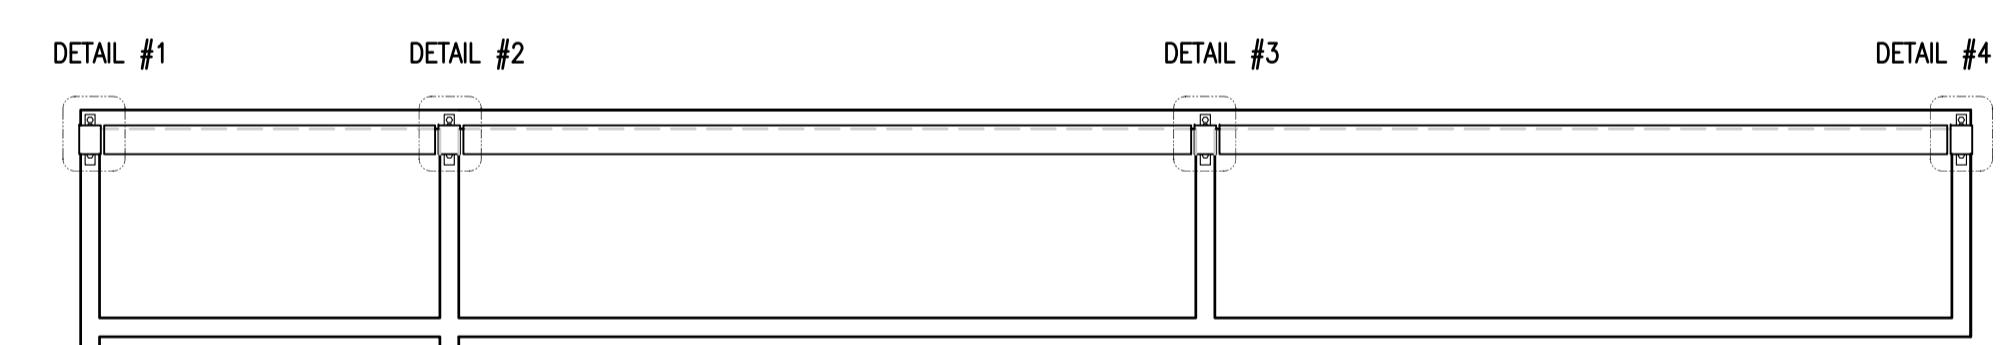

05 WINDOW W3 EXT. ELEVATION
A508 SCALE 1:20

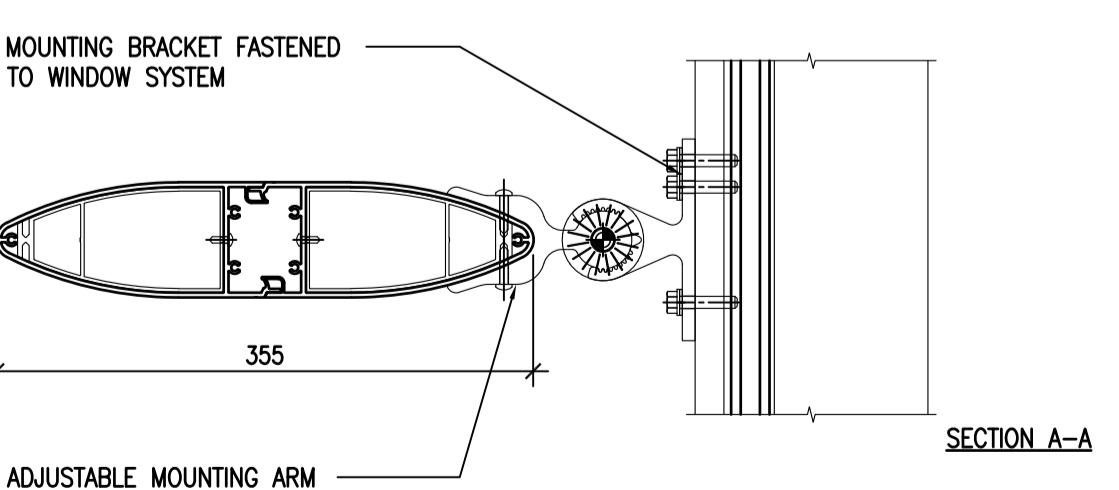

DETAIL 5
HORIZONTAL BLADE DETAIL

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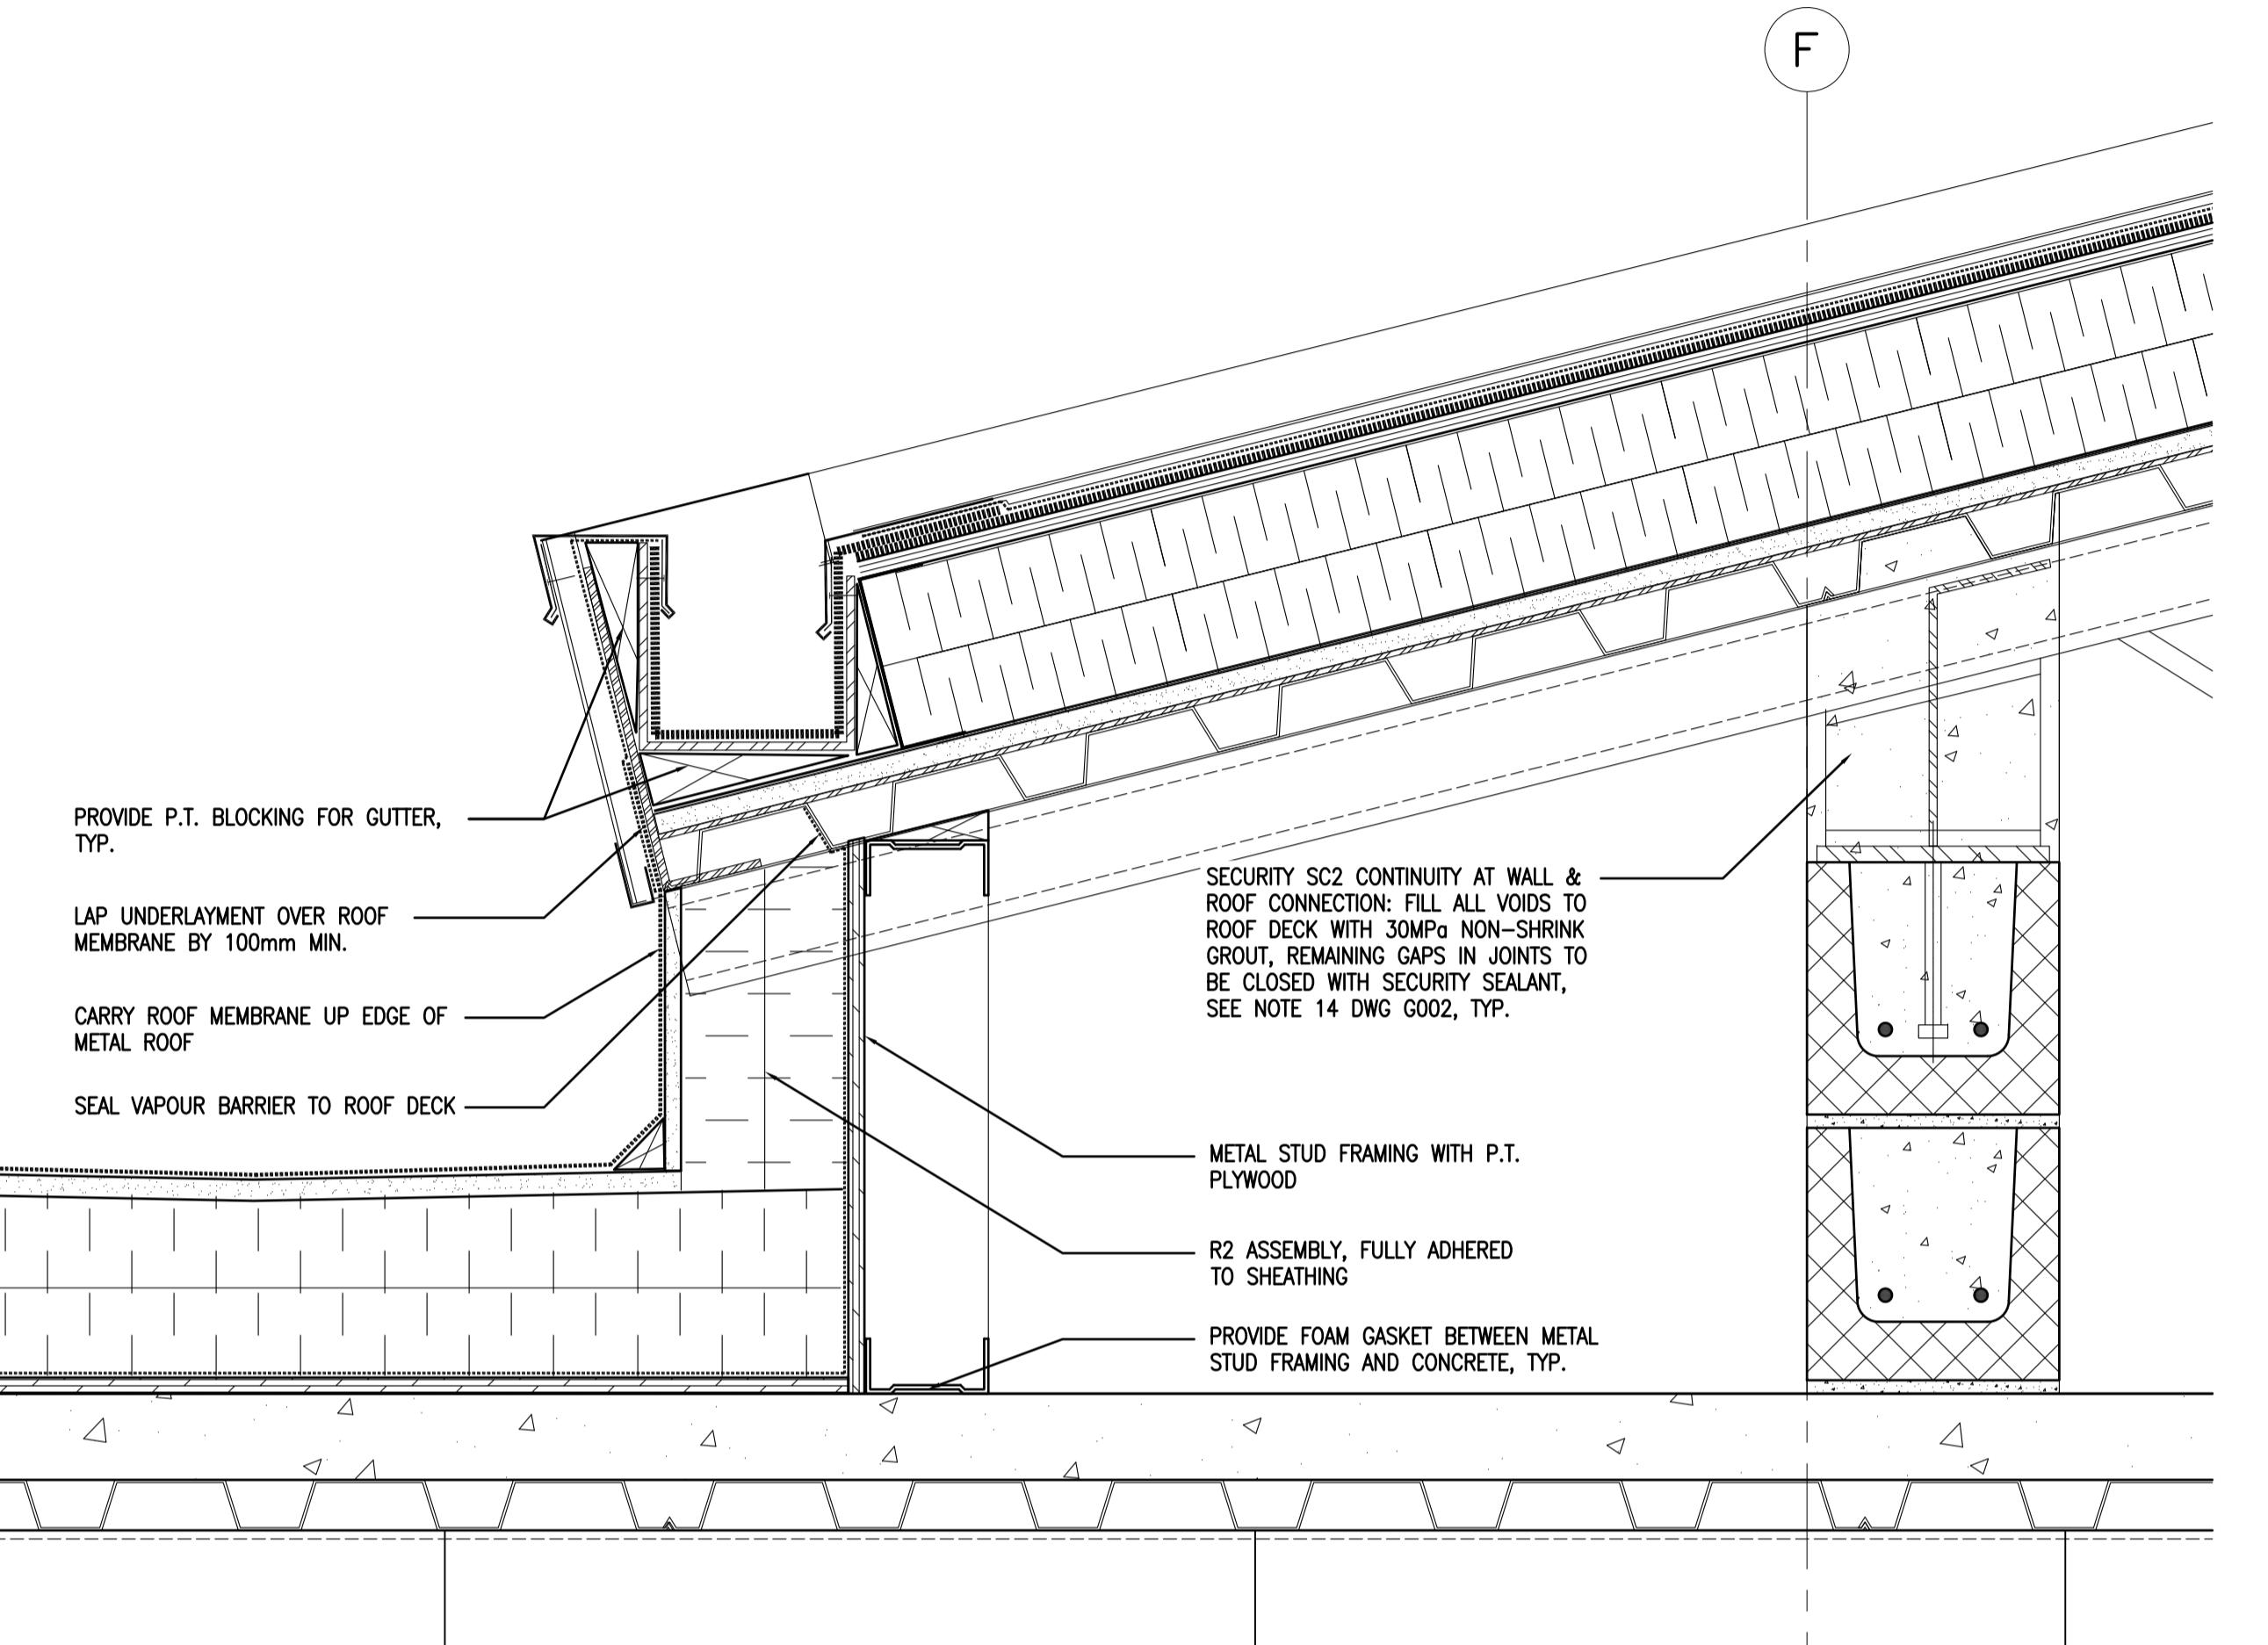
Project Title/Titre du projet
AGASSIZ, BRITISH COLUMBIA
4732 CEMETERY ROAD PO BOX 1600
MOUNTAIN INSTITUTE

MOUNTAIN INSTITUTE HEALTH CARE EXPANSION


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Designed by/Concept par
EDWIN BERZINS
Drawn by/Desiné par
BEN MONROE / MING HSU
PWGSC Project Manager/Administrateur de Projets TPSGC
TONY TANG
Regional Manager, Architectural and Engineering Services
Gestionnaire régionale, Services d'architectural et de génie, TPSGC
Preetpal Paul
Drawing title/Titre du dessin

SECTION DETAILS 2

Project No./No. du projet	Sheet/Feuille A508	Revision no./ La Révision no. 0
R.077724.001	OF 13	



01 ROOF DETAIL
A509 1:5

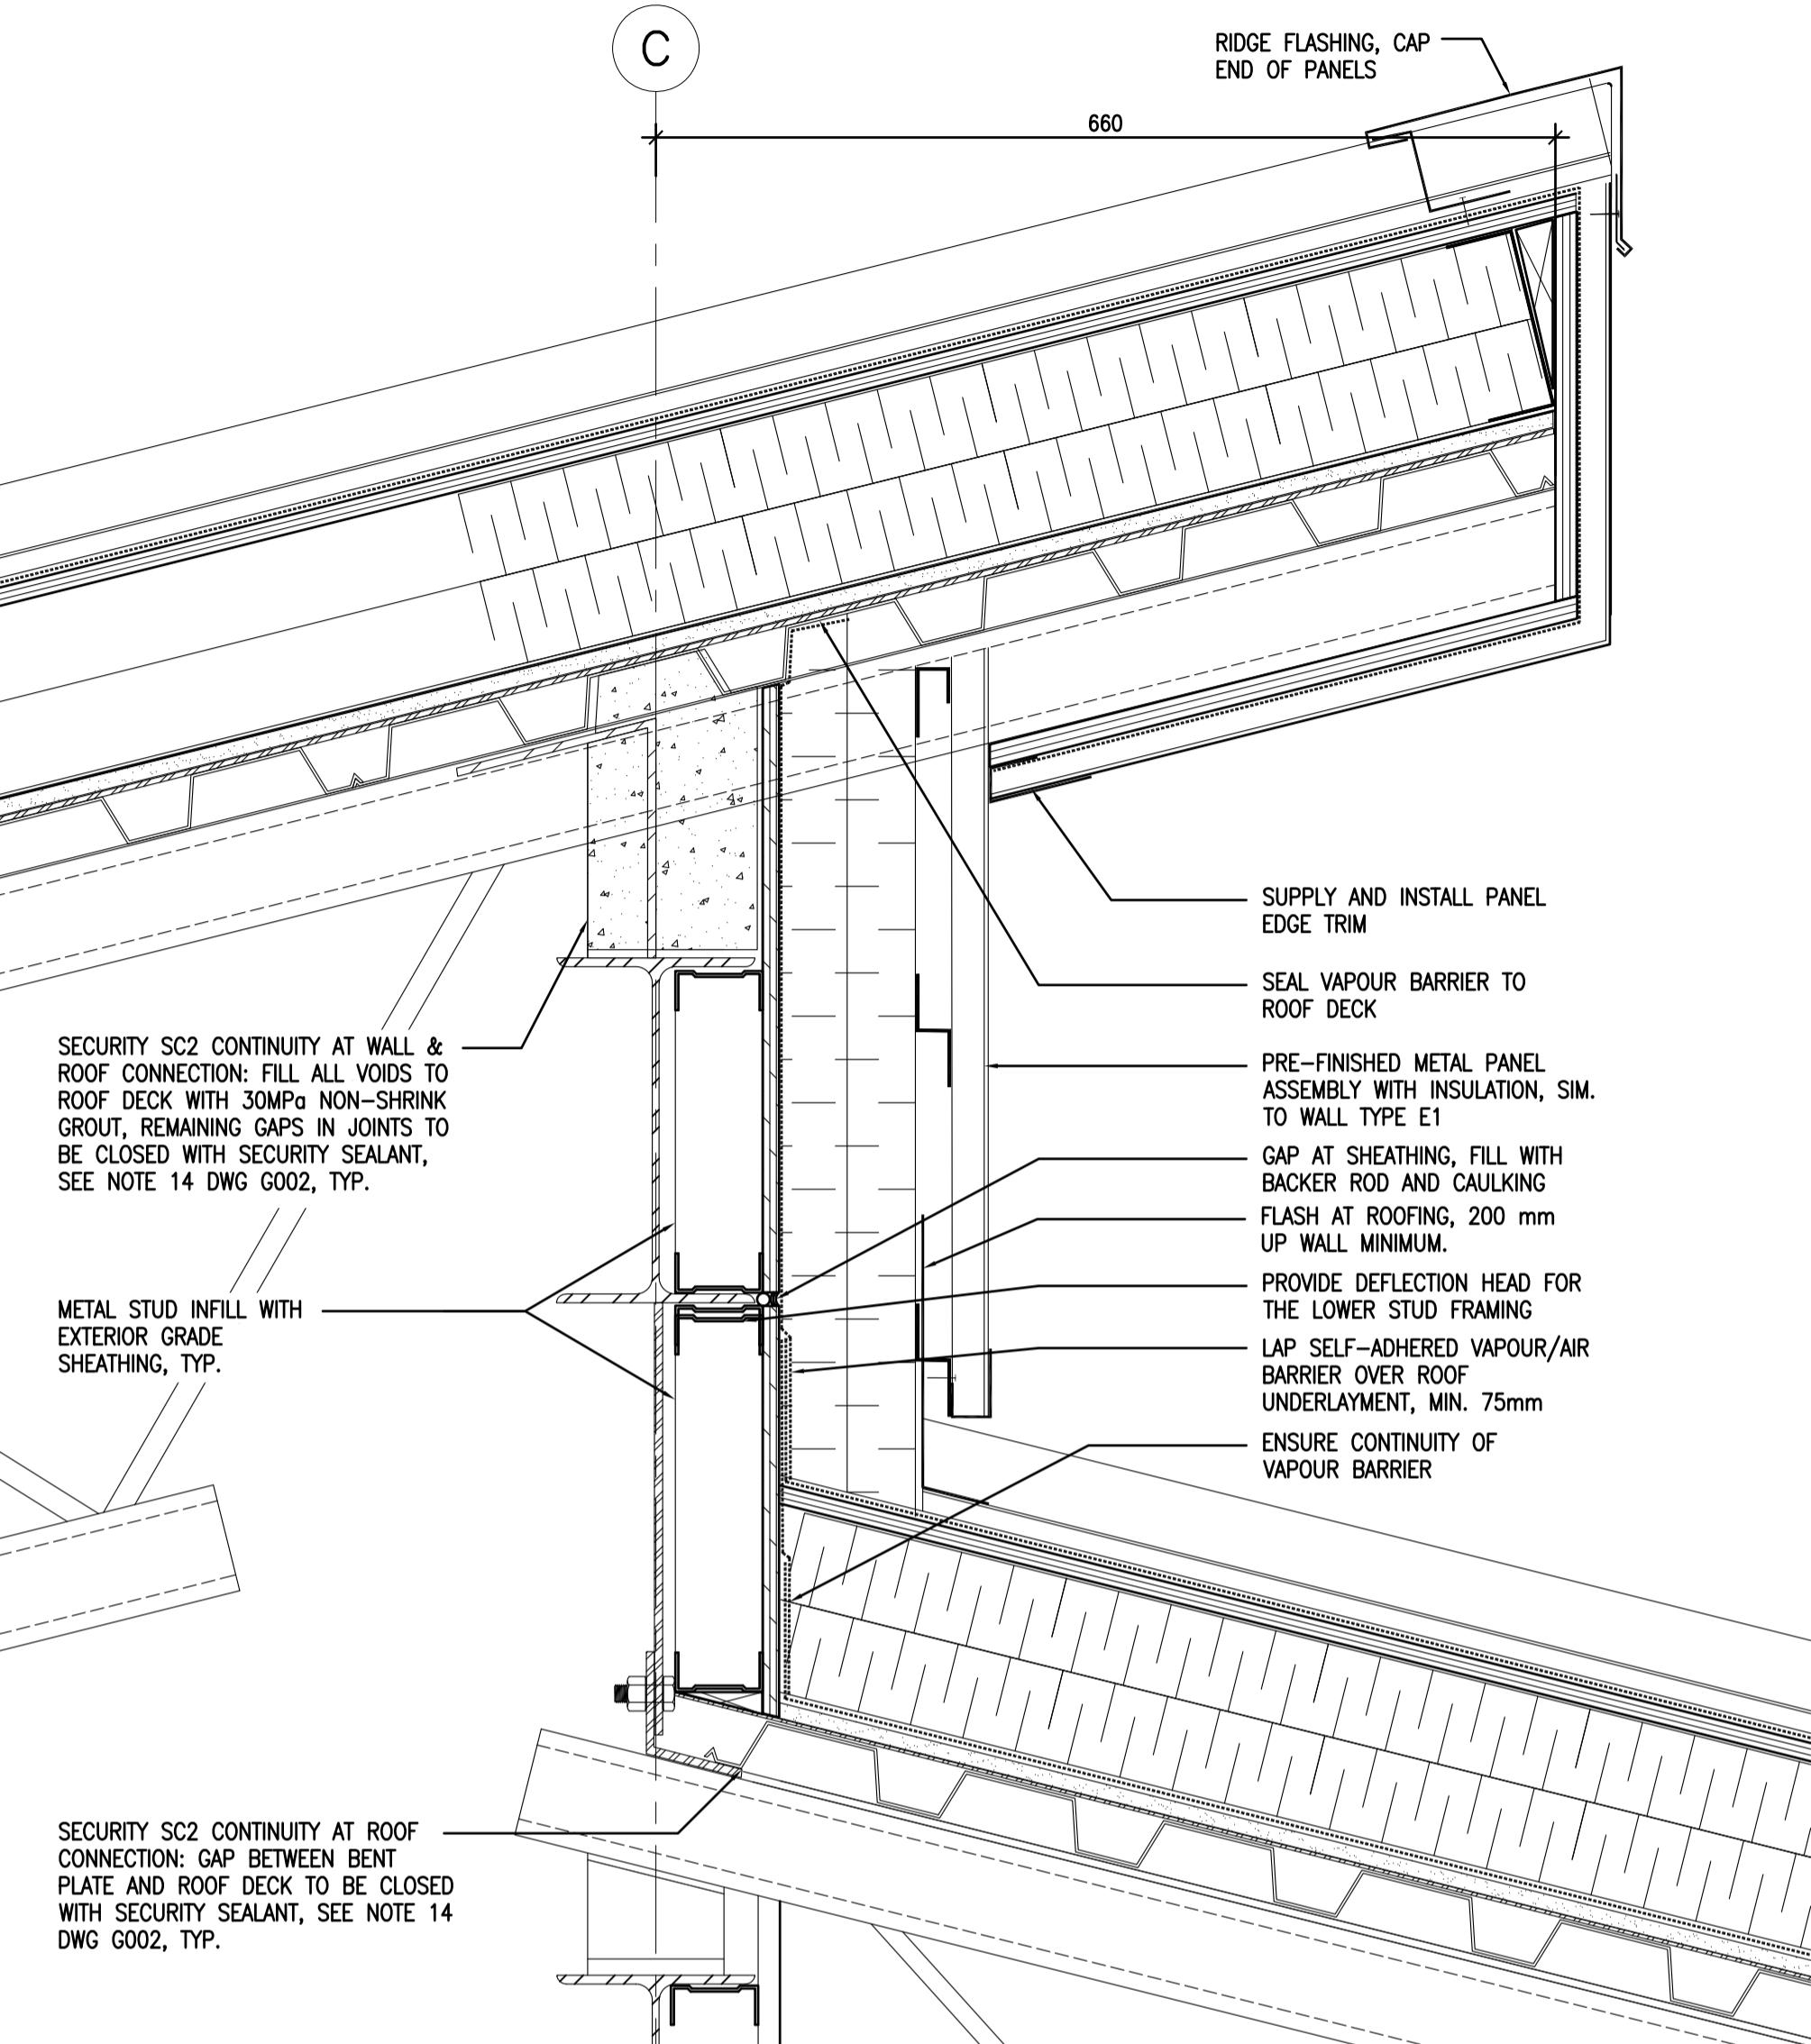

02 ROOF DETAIL
A509 1:5

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Revision/ Révision	Description/Description	Date/Date
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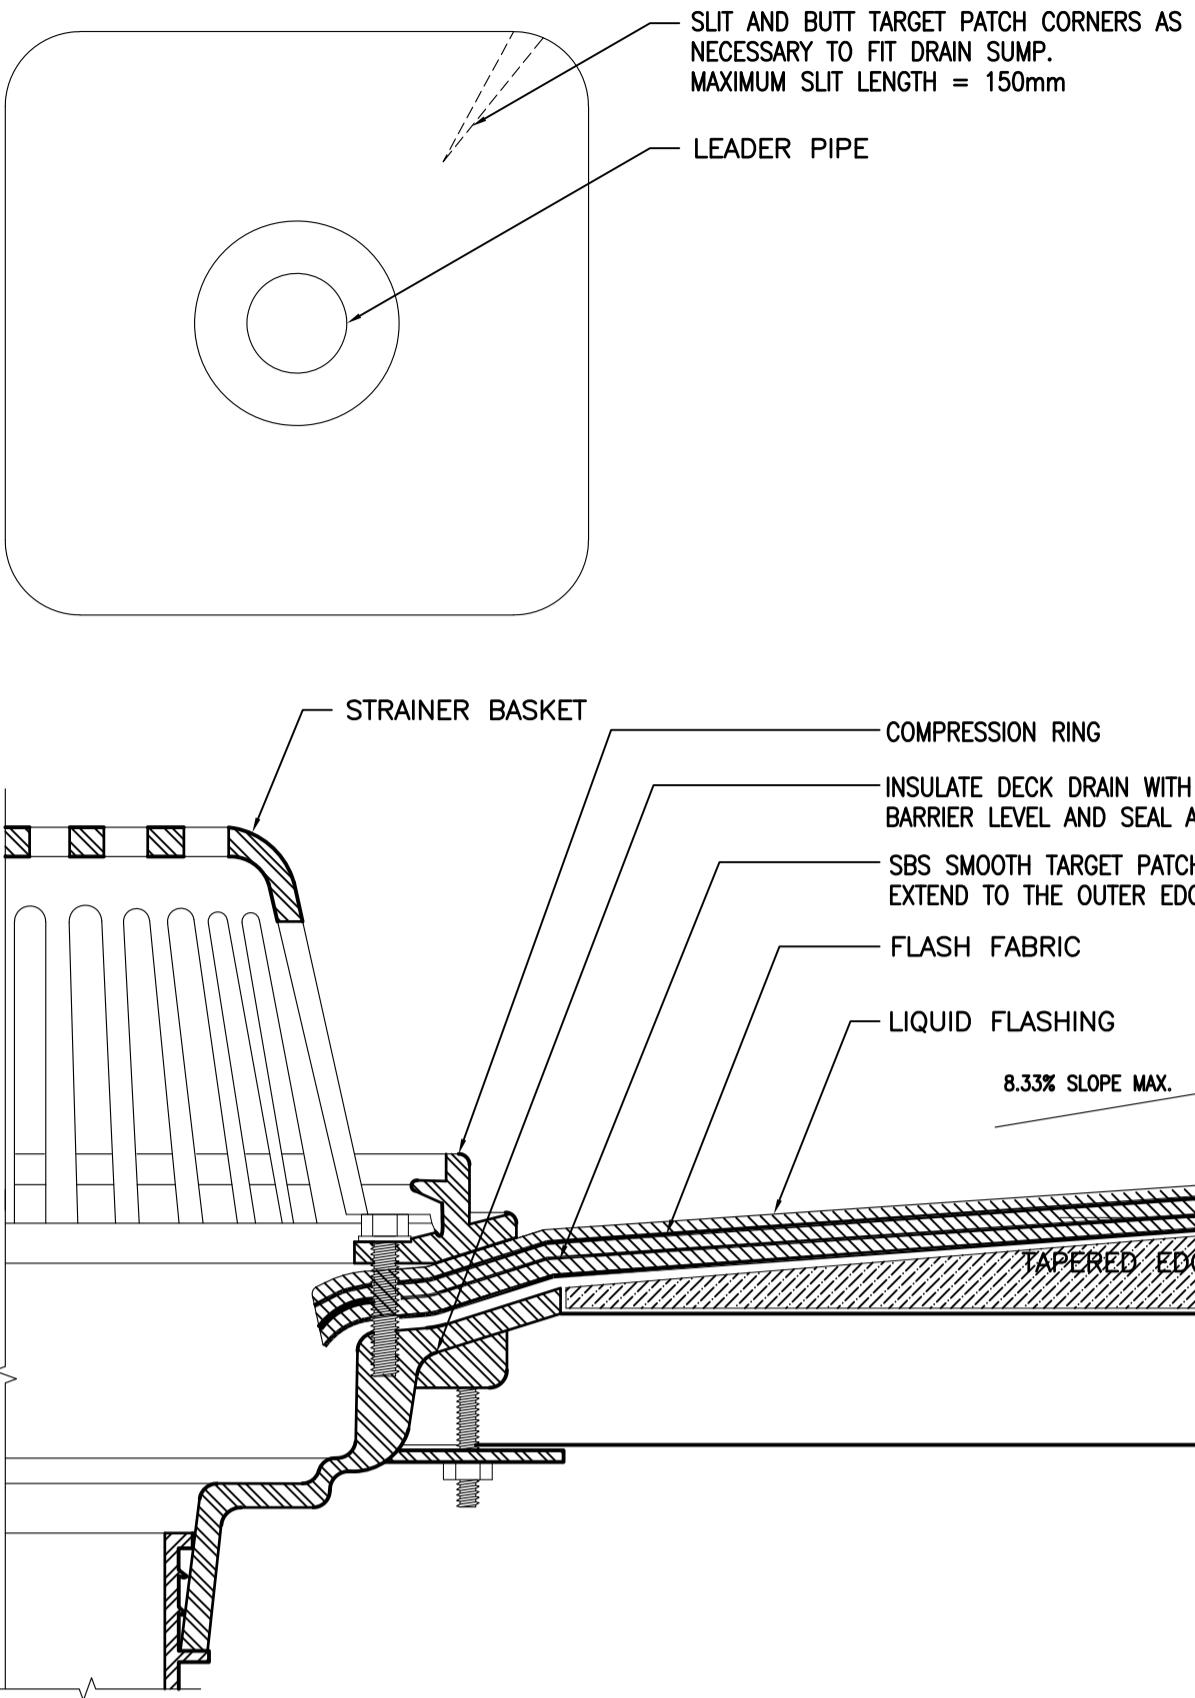
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Designed by/Concept par
EDWIN BERZINS
Drawn by/Desiné par
BEN MONROE / MING HSU
PWGSC Project Manager/Administrateur de Projets TPSGC
TONY TANG
Regional Manager, Architectural and Engineering Services
Gestionnaire régionale, Services d'architectural et de génie, TPSGC
PREETPAL PAUL
Drawing title/Titre du dessin

SECTION DETAILS 3

Project No./No. du projet	Sheet/Feuille	Revision no./ No. Révision
R.077724.001	A509	0







01 ROOF DETAIL – ROOF DRAIN
A510 NTS

NOTES:


1. WHEN DRAIN SUMP EXCEEDS 2.32% DRAIN INSERT IS RECOMMENDED.
2. THE HOLE IN THE TARGET PATCH SHOULD EXTEND A MINIMUM OF 25.4 MM BEYOND THE CLAMPING RING AND SHOULD NOT BE SMALLER THAN THE DIAMETER OF THE LEADER PIPE.
3. DRAIN SUMP MAXIMUM SLOPE = 8.33%.
4. ROOF PENETRATIONS TO BE DETAILED AS PER RCBC DETAILS.
5. ALL PENETRATIONS TO BE SEALED AT THE VAPOUR BARRIER LEVEL AND THE ROOFING LEVEL.
6. EXTEND WATERPROOFING UP SPUN ALUMINUM SLEEVE AT ALL PIPE PENETRATIONS THROUGH ROOFING.

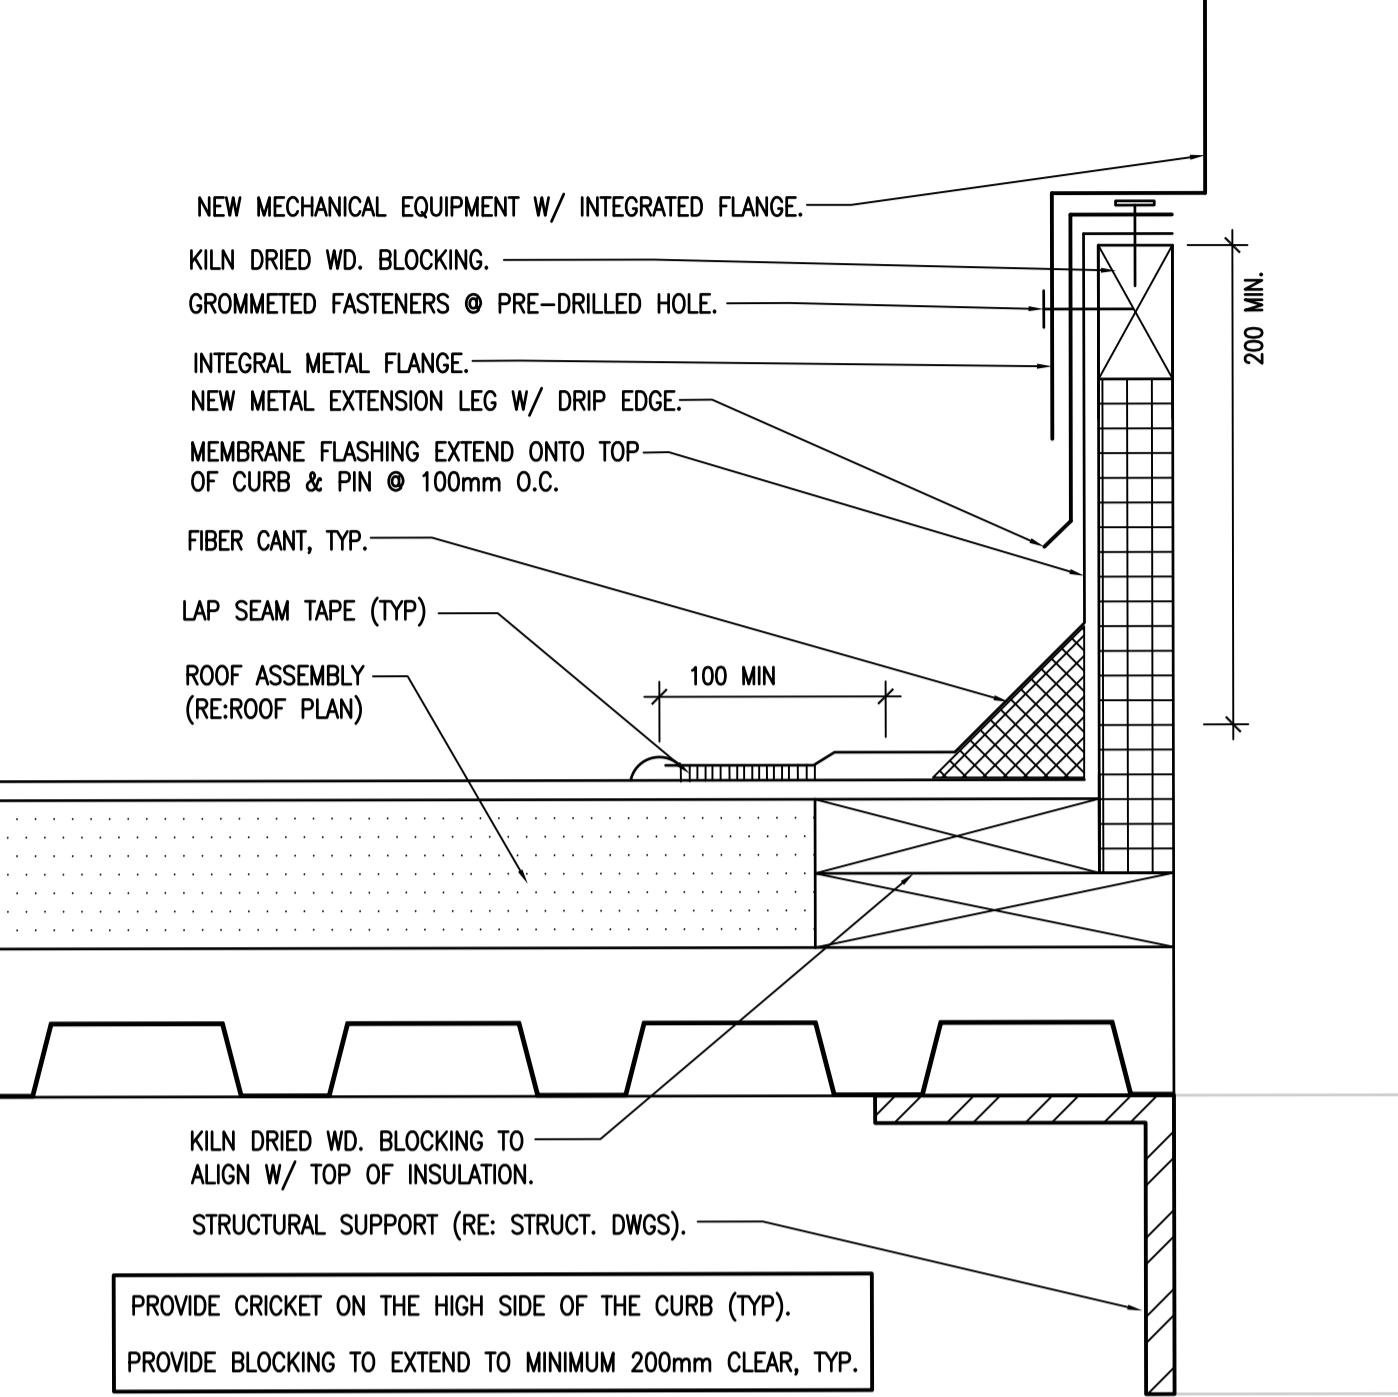

02 ROOF DETAIL – EQUIPMENT CURB
A510 NTS

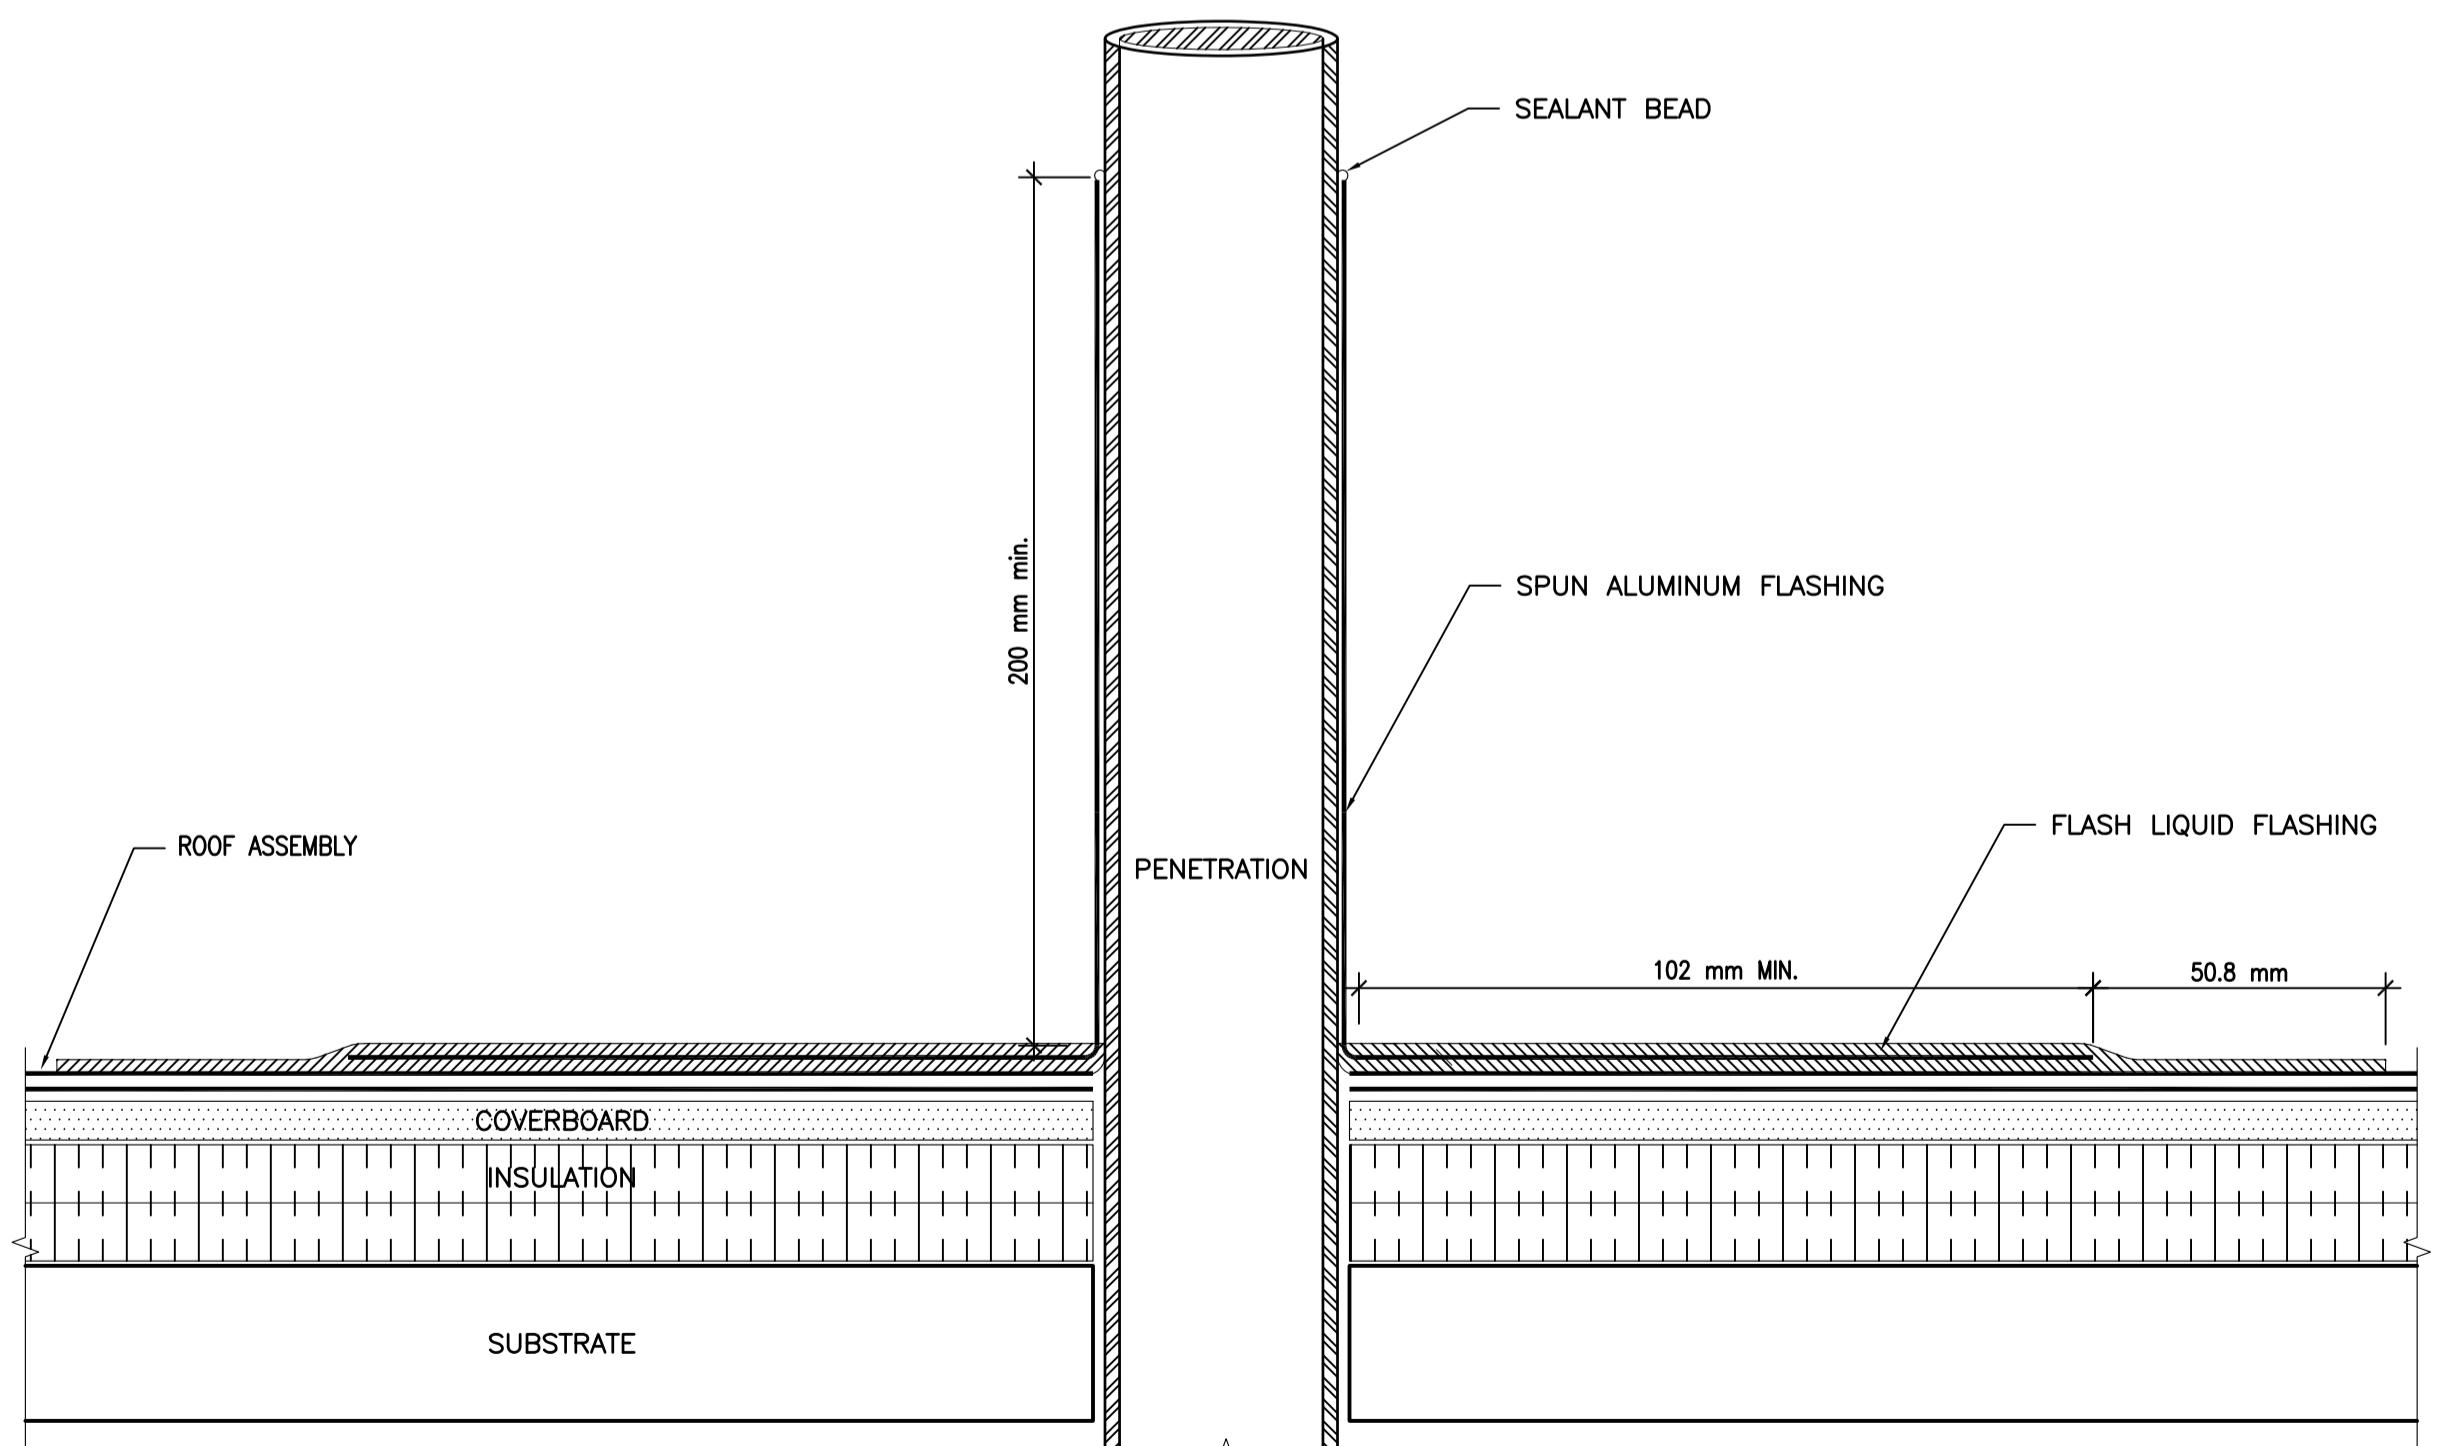

03 ROOF DETAIL – PIPE FLASHING
A510 NTS

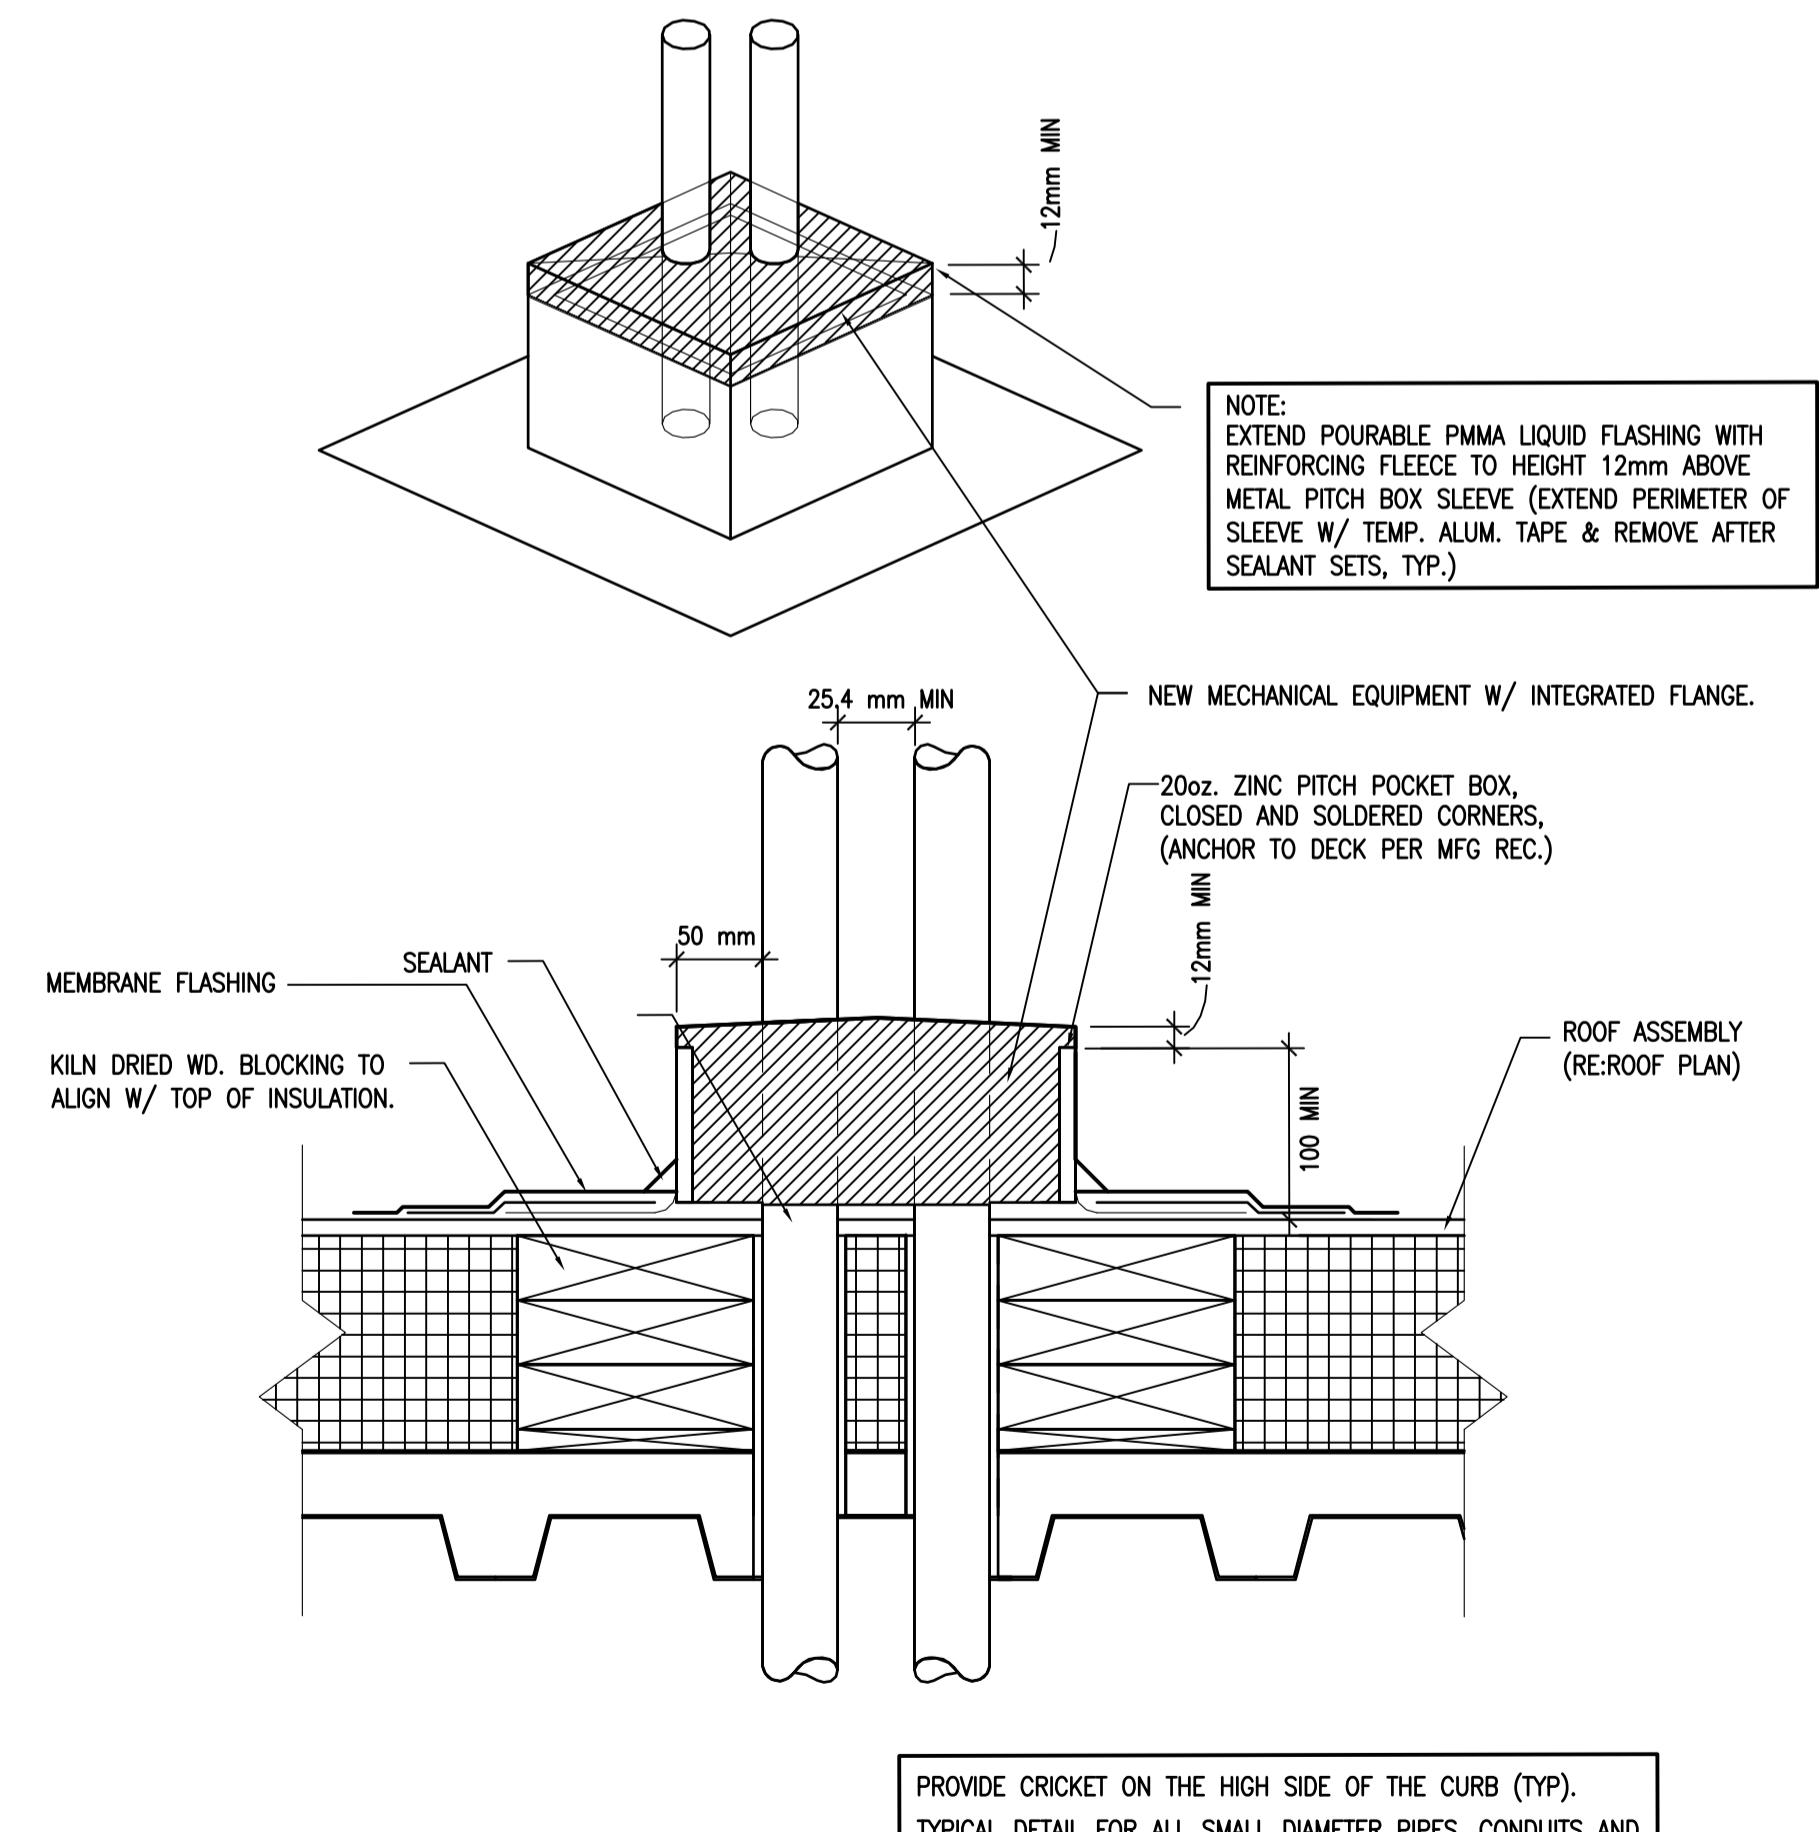

04 ROOF DETAIL – PITCH POCKET
A510 NTS

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AGASSIZ, BRITISH COLUMBIA
4732 CEMETERY ROAD PO BOX 1600
MOUNTAIN INSTITUTE

MOUNTAIN INSTITUTE HEALTH CARE EXPANSION

Consultant Signature Only
Designed by/Concept par
EDWIN BERZINS
Drawn by/Dessiné par
BEN MONROE
PWGSC Project Manager/Administrateur de Projets TPSGC
TONY TANG
Regional Manager, Architectural and Engineering Services
Gestionnaire régionale, Services d'architecture et de génie, TPSGC
PREETPAL PAUL
Drawing title/Titre du dessin

SECTION DETAILS 4 ROOF DETAILS

Project No./No. du projet	Sheet/Feuille A510	Revision no./ La Révision no. 0
R.077724.001		



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Révision | Description/Description Date/Date
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4732 CEMETARY ROAD PO BOX 1600
MOUNTAIN INSTITUTE

**MOUNTAIN INSTITUTE
HEALTH CARE EXPANSION**

Consultant Signature Only

Designed by/Concept par
EDWIN BERZINS

Drawn by/Desiné par
BEN MONROE (2017-09-28)

PWSSC Project Manager/Administrateur de Projets TPSGC
TONY TANG

Regional Manager, Architectural and Engineering Services
Gestionnaire régionale, Services d'architecture et de génie, TPSGC
PREETPAL PAUL

Drawing title/Titre du dessin

ROOM FINISH SCHEDULE

Project No./No. du projet R.077724.001	Sheet/Feuille A601	Revision no./ La Révision no. 0
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ROOM FINISH SCHEDULE

		FLOOR		BASE		NORTH WALL		EAST WALL		SOUTH WALL		WEST WALL		CEILING		NOTES	
ROOM NO.	LOCATION	MATERIAL	FINISH	MATERIAL	FINISH	MATERIAL	FINISH	MATERIAL	FINISH	MATERIAL	FINISH	MATERIAL	FINISH	MATERIAL	FINISH	SEE ELEVATION FOR FINISHES	
G140	SEARCH ROOM	MMA	F1	MMA	F1	WL-1	P1	WL-1	P1	WL-1	P1	WL-1	P1	EXISTING	P3		
G141	STAFF WC	MMA	F1	MMA	F1	WL-5	T1	WL-5	T1	WL-5	T1	WL-5	T1	EXISTING	P3		
G142	MEDICAL STORAGE	MMA	F1	MMA	F1	WL-1	P1	WL-1	P1	WL-1	P1	WL-1	P1	CL-2	P3		
G143	CHIEF HEALTH CARE	MMA	F1	MMA	F1	WL-1	P1	WL-1	P1	WL-1	P1	WL-1	P1	CL-1	-		
G144	MENTAL HEALTH NURSE	MMA	F1	MMA	F1	WL-1	P1	WL-1	P1	WL-1	P1	WL-1	P1	CL-1	-		
G146	MEDICAL X-RAY	MMA	F1	MMA	F1	WL-1*	P1	WL-1*	P1	WL-1*	P1	WL-1*	P1	CL-2	P3	WP-1 ALL WALLS TO 1015mm, LEAD LINED WALLS TO 2113mm A.F.F. MIN.	
G146A	IMAGING EQUIPMENT	MMA	F1	MMA	F1	WL-1*	P1	WL-1*	P1	WL-1*	P1	WL-1*	P1	CL-2	P3	WP-1 ALL WALLS TO 1015mm, LEAD LINED WALLS TO 2113mm A.F.F. MIN.	
G148	CORRIDOR	MMA	F1 / F2	MMA	F2	WL-1	P1	WL-1	P1	WL-1	P1	WL-1	P1	CL-1	-	SEE A107 FINISHES PLAN FOR PATTERN	
G150	SPRINKLER TREE	MMA	F1	MMA	F1	WL-1	P1 / WP-2	WL-1	P1	WL-1	P1	WL-1	P1	P1 / WP-2	EXISTING	P3	WP-2 TO 1015mm
G153	STAFF CHANGE	MMA	F1	MMA	F1	WL-1	P1	WL-1	P1	WL-1	P1	WL-1	P1	CL-2	P3	WP-1 ALL WALLS TO 1015mm	
G156	STAFF SHOWER	MMA	F1	MMA	F1	WL-1	P1	WL-1	P1	WL-1	P1	WL-1	P1	EXISTING	P3		
G157	MAINTENANCE CLOSET	MMA	F1	MMA	F1	WL-1	P1	WL-1	P1	WL-1	P1	WL-1	P1	EXISTING	P3		
G158	NURSE OPEN OFFICE	MMA	F1	MMA	F1	WL-1	P1	WL-1	P1	WL-1	P1	WL-1	P1	CL-1	-		
G158A	STAFF LOUNGE	MMA	F1	MMA	F1	WL-1	P1	WL-1	P1	WL-1	P1	WL-1	P1	CL-1	-		
G159	LONG TERM STORAGE	MMA	F1	MMA	F1	WL-1	P1	WL-1	P1	WL-1	P1	WL-1	P1	EXISTING	P3		
G160	COATS	MMA	F1	MMA	F1	WL-1	P1	WL-1	P1	WL-1	P1	WL-1	P1	EXISTING	P3		
G161	CORRIDOR	MMA	F1 / F2	MMA	F2	WL-1	P1	WL-1	P1	WL-1	P1	WL-1	P1	CL-1	-	SEE A107 FINISHES PLAN FOR PATTERN	
G162	CORRIDOR	MMA	F1 / F2	MMA	F2	WL-1	P1	WL-1	P1	WL-1	P1	WL-1	P1	CL-1	-	SEE A107 FINISHES PLAN FOR PATTERN	
G163	BIO. HAZ.	MMA	F1	MMA	F1	WL-1	P1	WL-1	P1	WL-1	P1	WL-1	P1	CL-2	P3	WP-1 ALL WALLS TO 1015mm	
G164	SOILED SUPPLY	MMA	F1	MMA	F1	WL-1	P1	WL-1	P1	WL-1	P1	WL-1	P1	CL-2	P3	WP-1 ALL WALLS TO 1015mm	
G165	STORAGE	MMA	F1	MMA	F1	WL-1	P1	WL-1	P1	WL-1	P1	WL-1	P1	CL-2	P3		
G170	VEST & INMATE WAIT	MMA	F2	MMA	F2	WL-3	P1	WL-3	P1	WL-3	P1	WL-3	P1	CL-2	P3		
G171	CORRIDOR	MMA	F1/F2	MMA	F1	WL-1	P1 / P2	WL-1	P1	WL-1	P1	WL-1	P1	CL-2	P3	SEE A107 FINISHES PLAN FOR PATTERN	
G172	DENTAL OPERATORY	MMA	F1	MMA	F2	WL-1	P1	WL-1	P1	WL-1	P1	WL-1	P1	CL-2	P3	WP-1 ALL WALLS TO 1015mm	
G172A	DENTAL PROCESSING	MMA	F1	MMA	F1	WL-1	P1	WL-1	P1	WL-1	P1	WL-1	P1	CL-2	P3	WP-1 ALL WALLS TO 1015mm	
G173	CORRIDOR	MMA	F1 / F2	MMA	F2	WL-1	P1 / P2	WL-1	P1	WL-1	P1 / P2	WL-1	P1	CL-2	P3	SEE A107 FINISHES PLAN FOR PATTERN	
G174	BOILER	CONCRETE	-	SEALANT	-	WL-3	P1	WL-3	P1	WL-3	P1	WL-3	P1	CL-5	-		
G175	MECH.	CONCRETE	-	SEALANT	-	WL-3	P1	WL-3	P1	WL-3	P1	WL-3	P1	CL-5	-		
G176	ELEC.	CONCRETE	-	SEALANT	-	WL-3	P1	WL-3	P1	WL-3	P1	WL-3	P1	CL-5	-		
G177	HWC	MMA	F1	MMA	F1	WL-5	T2	WL-5	T2	WL-5	T2	WL-5	T2	CL-2	P3		
G178	EXAM RM 1	MMA	F1	MMA	F1	WL-1	P1	WL-1	P1	WL-1	P1	WL-1	P1	CL-2	P3	WP-1 ALL WALLS TO 1015mm	
G179	TREATMENT	MMA	F1	MMA	F1	WL-1	P1	WL-1	P1	WL-1	P1	WL-1	P1	CL-2	P3	WP-1 ALL WALLS TO 1015mm	
G180	TREATMENT	MMA	F1	MMA	F1	WL-1	P1	WL-1	P1	WL-1	P1	WL-1	P1	CL-2	P3	WP-1 ALL WALLS TO 1015mm	
G181	EXAM RM 2	MMA	F1	MMA	F1	WL-1	P1	WL-1	P1	WL-1	P1	WL-1	P1	CL-2	P3	WP-1 ALL WALLS TO 1015mm	
G182	EXAM RM 3	MMA	F1	MMA	F1	WL-1	P1	WL-1	P1	WL-1	P1	WL-1	P1	CL-2	P3	WP-1 ALL WALLS TO 1015mm	
G183	SPECIALTY TREATMENT	MMA	F1	MMA	F1	WL-1	P1	WL-1	P1	WL-1	P1	WL-1	P1	CL-2	P3	WP-1 ALL WALLS TO 1015mm	
G184	OXYGEN STORAGE	CONCRETE	-	SEALANT	-	WL-3	P1	WL-3	P1	WL-3	P1	WL-3	P1	CL-2	P3		
G185	CLEAN SUPPLY	MMA	F1	MMA	F1	WL-1	P1	WL-1	P1	WL-1	P1	WL-1	P1	CL-2	P3	WP-1 ALL WALLS TO 1015mm	
G186	STAFF WC	MMA	F1	MMA	F1	WL-5	T1	WL-5	T1	WL-5	T1	WL-5	T1	CL-2	P3		
G187	NURSING STATION	MMA	F1	MMA	F1	WL-1	P1	WL-1	P3	WL-1	P1	WL-1	P1	CL-2 / CL-1	P3/-		
G187A	FILE STORAGE	MMA	F1	MMA	F1	WL-1	P1	WL-1	P1	WL-1	P1	WL-1	P1	CL-2	P3		
G187B	DISPENSARY	MMA	F1	MMA	F1	WL-1	P1	WL-1	P1	WL-1	P1	WL-1	P1	CL-2	P3	WP-1 ALL WALLS TO 1015mm	
G187C	CORRIDOR	MMA	F1	MMA	F1	WL-1	P1 / P3	WL-1	P1	WL-1	P1	WL-1	P1	CL-2	P3		
G187D	ADMIN. OFFICE	MMA	F1	MMA	F1	WL-1	P1										



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 4732 CEMETARY ROAD PO BOX 1600
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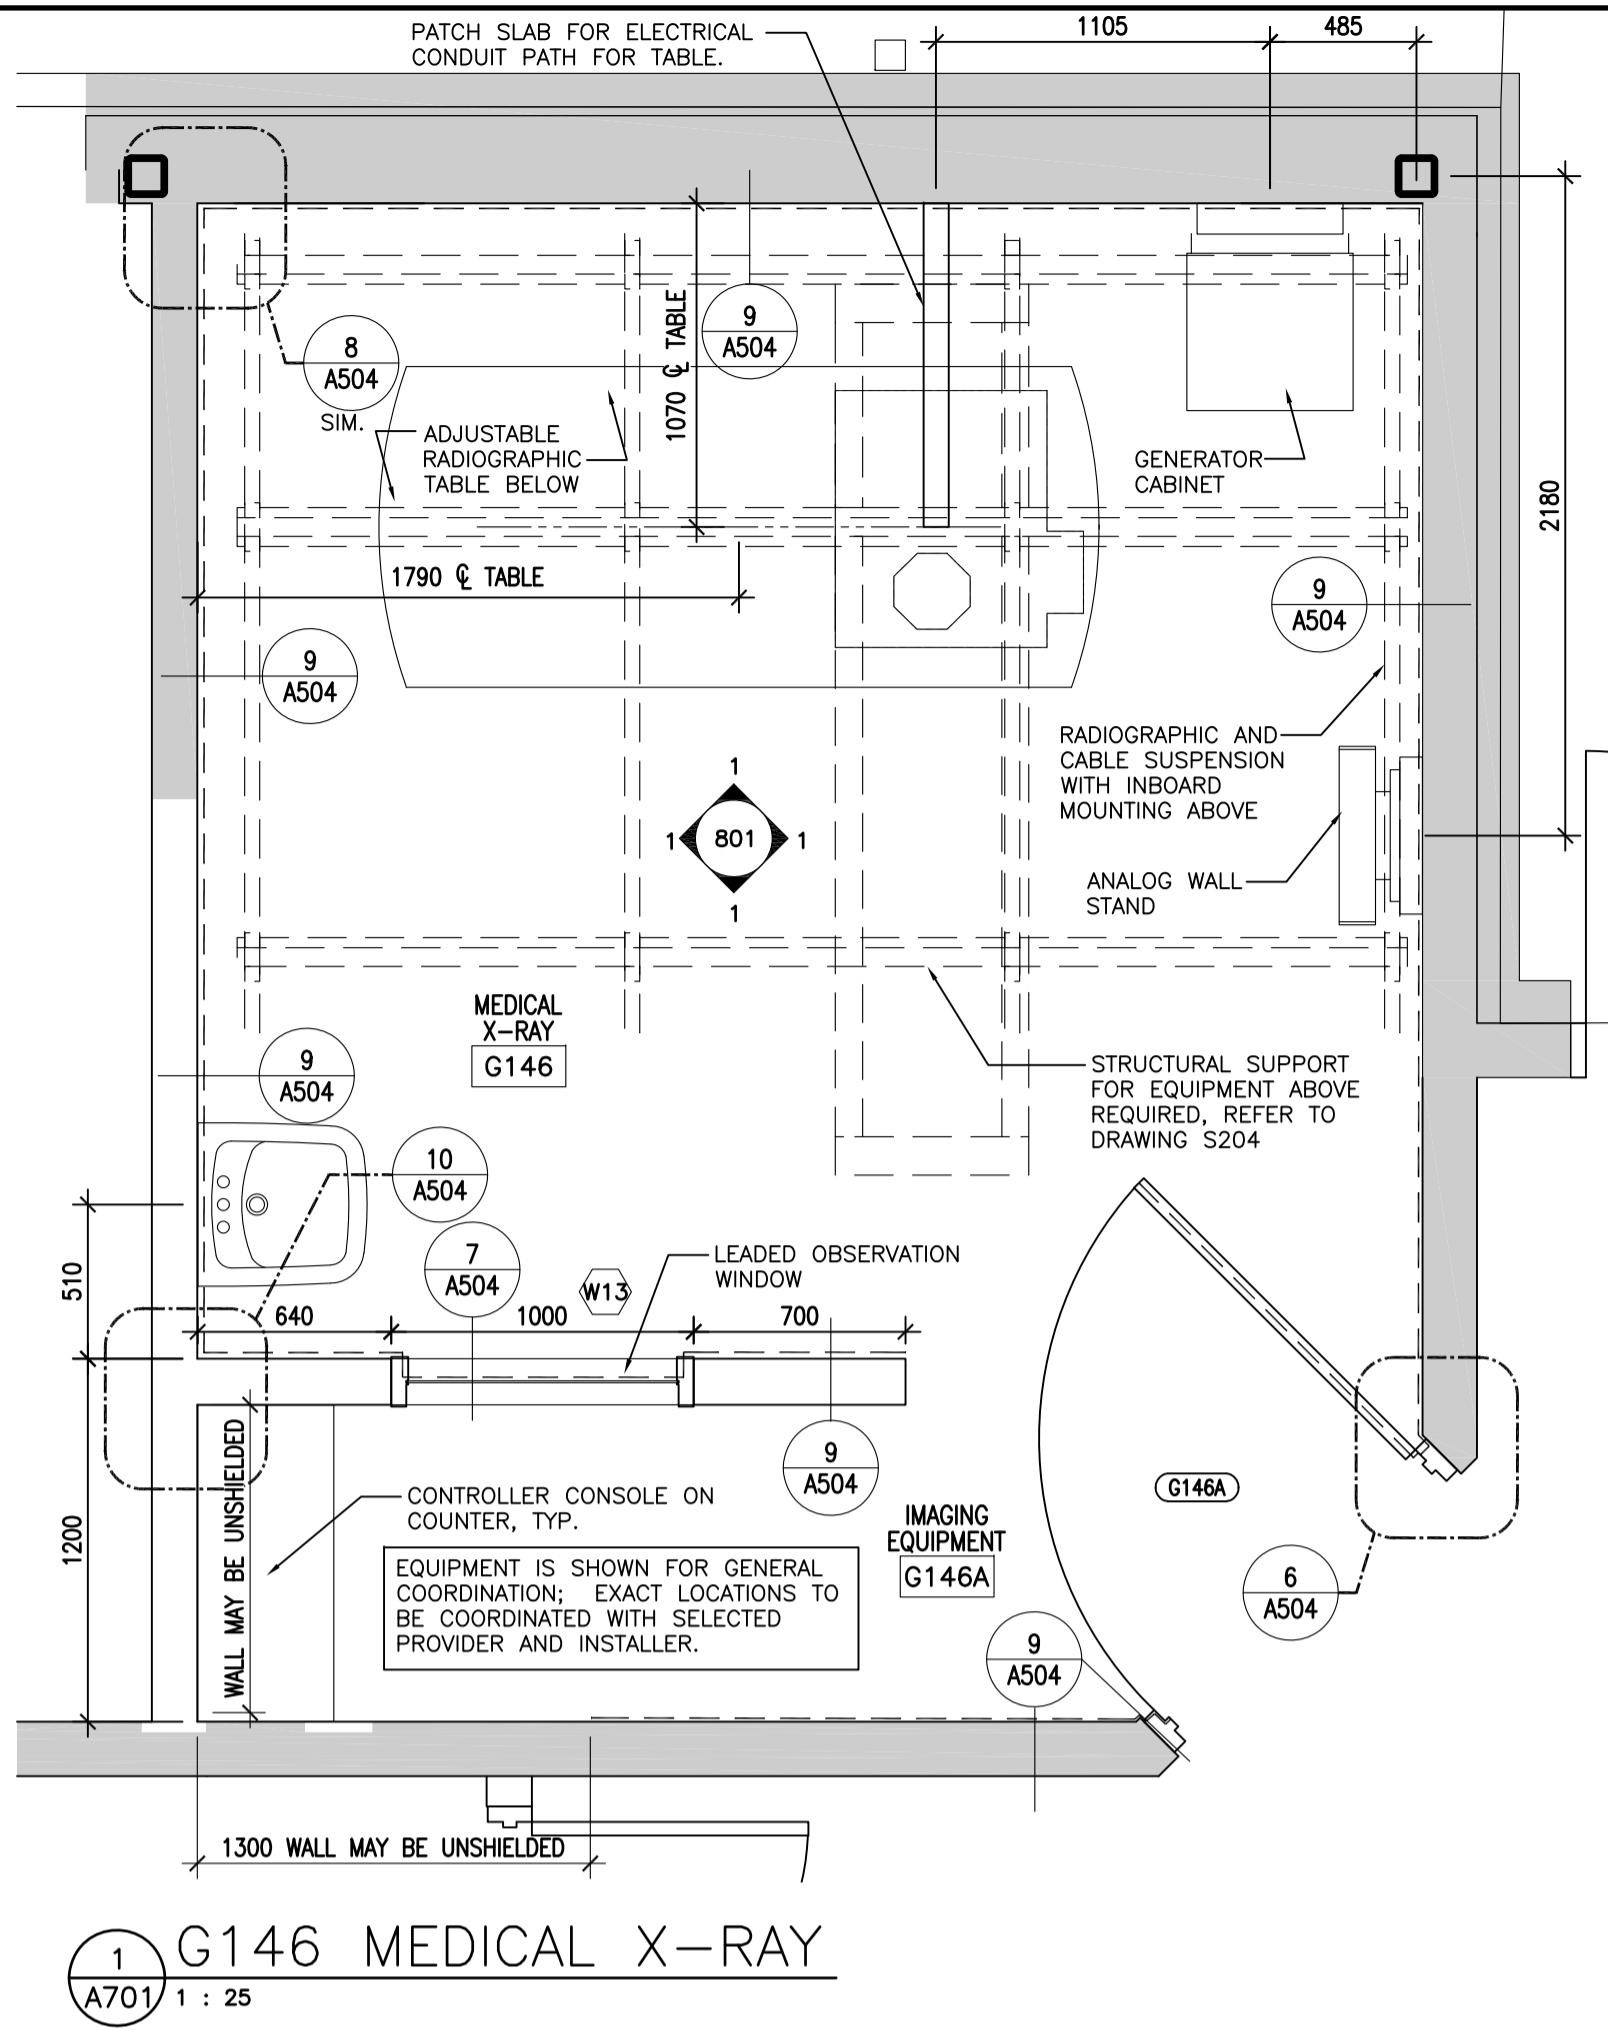
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Designed by/Concept par EDWIN BERZINS
Drawn by/Dessiné par BEN MONROE (2017-09-28)
PWGS Project Manager/Administrateur de Projets TPSGC TONY TANG
Regional Manager, Architectural and Engineering Services/Gestionnaire régionale, Services d'architectural et de génie, TPSGC PREETPAL PAUL

Drawing title/Titre du dessin
DOOR SCHEDULE
Project No./No. du projet R.077724.001 Sheet/Feuille A602 Revision no./No. de Révision 0


DOOR SCHEDULE

OPENING NO.	LOCATION	DOOR				FRAME						FIRE RATING	NOTES	HINGES	LOCKSET	LATCH SET	DOOR STOP	PUSH & PULLS	CLOSER	KICK PLATE	THRESHOLD / SWEEP	WEATHER STRIPPING	ACOUSTIC / SMOKE SEAL	DOOR CONTACTS / POSITION	SWITCH	ELECTRIC STRIKE - REMOTE	ELECTRIC STRIKE - CARD PROXIMITY	HARDWARE GROUP NO.	LOCK FUNCTION	NOTES
		WIDTH	HEIGHT	THICKNESS	STYLE	MATERIAL	FINISH	GLAZING	INSULATED	TYPE	MATERIAL			HEAD DETAIL	JAMB DETAIL	SILL/THRESHOLD DETAIL														
STANDARD DOORS AND FRAMES - SEE DRAWING A501B AND A502C AND SPECIFICATION SECTIONS 08 11 00, 08 42 43, 08 71 00 AND 13 49 00																														
G146A	IMAGING EQUIPMENT G146A	1219	2134	45	C	W/L	W	F	-	HM-1	HM/L	FP/P	H-1	J-1	-	-	LEAD LINED DOOR AND FRAME, SPECIFICATION 13 49 00	●	●	-	●	-	-	●	-	-	-	2	F05	120 DEGREES; LEAD LINED; AUTOMATIC DOOR BOTTOM, SPECIFICATION 13 49 00
G153	STAFF CHANGE G153	915	2134	45	E	W	W	-	-	HM-1	HM	FP/P	H-1	J-1	-	-	-	●	●	-	●	-	-	●	-	-	-	3	F19	OCCUPANCY INDICATOR
G158A	STAFF LOUNGE G158A	915	2134	45	B	W	W	A	-	HM-1	HM	FP/P	H-1	J-1	-	-	-	●	●	-	●	-	-	●	-	-	-	4	F05	-
G162B	CORRIDOR G162	915	2134	45	B	HM	FP/P	A	-	W13	HM	FP/P	H-1	J-1	-	-	-	●	●	-	●	-	-	●	-	-	-	6	F05	-
G163	BIO. HAZ. G163	915	2134	45	C	HM	FP/P	A	-	HM-1	HM	FP/P	H-1	J-1	-	-	-	●	●	-	●	-	-	●	-	-	-	7	F07	-
G164	SOILED SUPPLY G164	915	2134	45	C	HM	FP/P	A	-	HM-1	HM	FP/P	H-1	J-1	-	-	-	●	●	-	●	-	-	●	-	-	-	7	F07	-
G165	STORAGE G165	915	2134	45	C	HM	FP/P	A	-	HM-1	HM	FP/P	H-1	J-1	-	-	-	●	●	-	●	-	-	●	-	-	-	8	F07	-
G170A	VEST & WAIT G170A	1219	2134	45	A	AL	AL	C	-	W2	AL	AL	H-4	J-4	T-1	-	-	●	●	-	●	-	-	●	-	-	-	9	F30	90 DEGREES
G172	DENTAL OPERATORY G172	915	2134	45	B	W	W	A	-	HM-1	HM	FP/P	H-1	J-1	-	-	-	●	●	-	●	-	-	●	-	-	-	12	F05	-
G177	HWC G177	915	2134	45	E	W	W	-	-	HM-1	HM	FP/P	H-1	J-1	T-2	-	-	●	●	-	●	-	-	●	-	-	-	15	F01	OCCUPANCY INDICATOR, NO DEADBOLT
G178	EXAM RM 1 G178	1067	2134	45	B	W	W	A	-	HM-1	HM	FP/P	H-1	J-1	-	-	-	●	●	-	●	-	-	●	-	-	-	16	F05	-
G179	TREATMENT G179	1067	2134	45	B	W	W	A	-	HM-1	HM	FP/P	H-1	J-1	-	-	-	●	●	-	●	-	-	●	-	-	-	16	F05	-
G180	TREATMENT G180	1067	2134	45	B	W	W	A	-	HM-1	HM	FP/P	H-1	J-1	-	-	-	●	●	-	●	-	-	●	-	-	-	16	F05	-
G181	EXAM RM 2 G181	1067	2134	45	B	W	W	A	-	HM-1	HM	FP/P	H-1	J-1	-	-	-	●	●	-	●	-	-	●	-	-	-	16	F05	-
G182	EXAM RM 3 G182	1067	2134	45	B	W	W	A	-	HM-1	HM	FP/P	H-1	J-1	-	-	-	●	●	-	●	-	-	●	-	-	-	16	F05	-
G183	SPECIALTY TREAT. G183	1489 CLEAR	2134	45	J	AL	AL	A	-	-	-	-	H-5	J-5	-	-	TELESCOPING ICU DOOR, SPECIFICATION 08 42 43	-	●	-	-	-	-	-	-	-	-	17	-	TELESCOPING ICU DOOR, 1489 CLEAR OPENING, SPECIFICATION 08 42 43
G186	STAFF WC G186	915	2134	45	E	W	W	-	-	HM-1	HM	FP/P	H-1	J-1	T-2	-	-	●	●	-	●	-	-	●	-	-	-	13	F07	OCCUPANCY INDICATOR
G187	NURSING STATION G187	915	2134	45	B	AL	AL	A	-	W11	AL	AL	H-6	J-6	-	-	-	●	●	-	●	-	-	●	-	-	-	21	F05	-
G189	MED PICK UP G189	1219	2134	45	A	AL	AL	C	-	W2	AL	AL	H-4	J-4	T-1	-	-	●	●	-	●	-	-	●	-	-	-	24	F30	90 DEGREES
DETENTION DOORS AND FRAMES - SEE DRAWING A501A AND SPECIFICATION SECTIONS 08 11 10 AND 08 71 10																														
G001	CRAWL SPACE	1000	1000	50.8	K-DD1	IHM	FP/P	-	●	K-DD1	HM	FP/P	H-7	J-7	S-7	-	CAST FRAME WITHIN CONC. WALL	●	●	-	●	-	-	●	-	-	-	S6	DET	-
G140A	SEARCH ROOM G140	915	2134	50.8	D-DD1	HM	FP/P	B	-	HM-2-DD1	HM	FP/P	H-8	J-8	T-2	1.5h	-	●	●	-	●	●	●	●	-	-	-	S9	DET	-
G162A	CORRIDOR G162	1219	2134	50.8	B-DD1	HM	FP/P	D	-	HM-3-DD1	HM	FP/P	H-2	J-2	-	-	-	●	●	-	●	●	●	●						




1 G146 MEDICAL X-RAY

A701 1 : 2

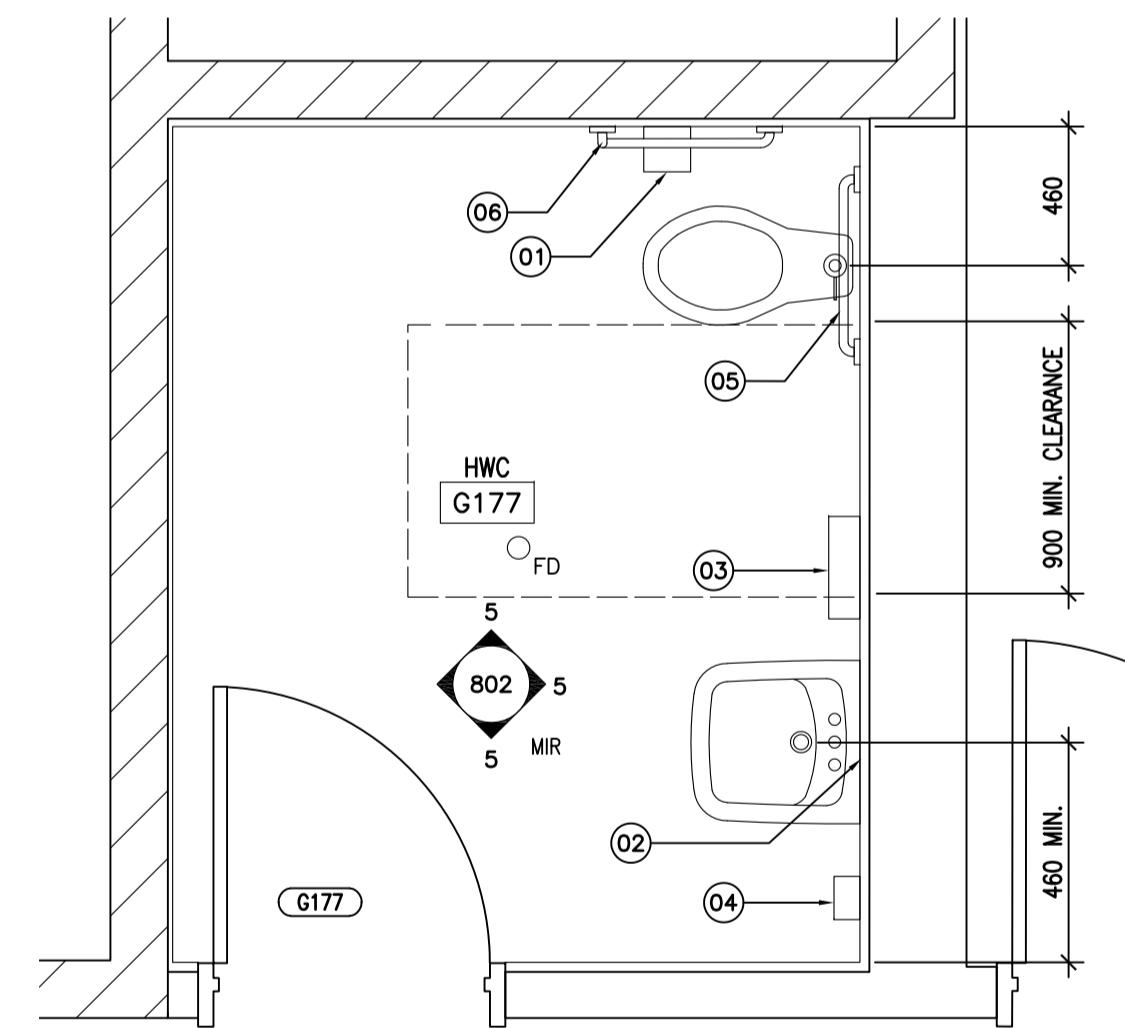


G177 ACCESSIBLE WC

A701 1

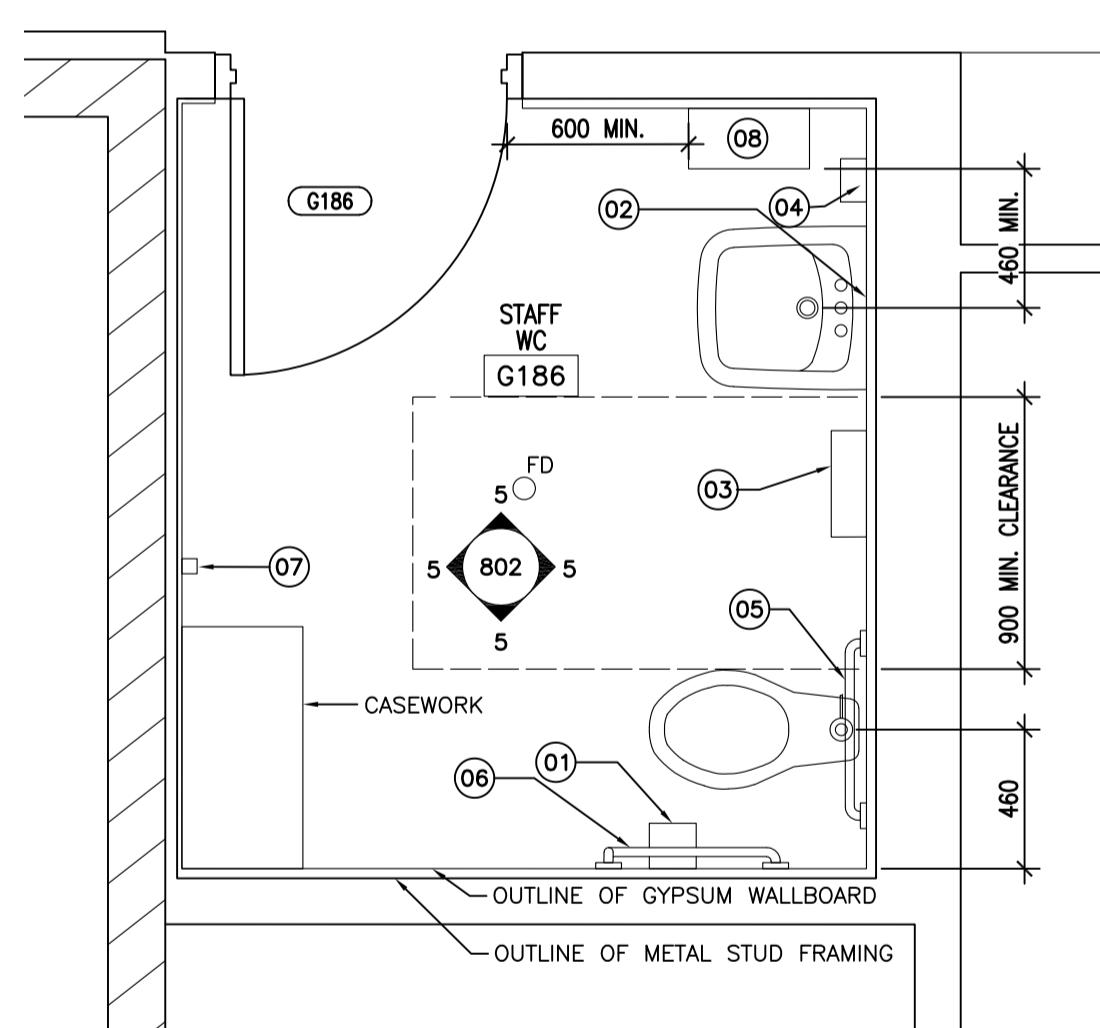


G186 STAFF WO

A701 1 :

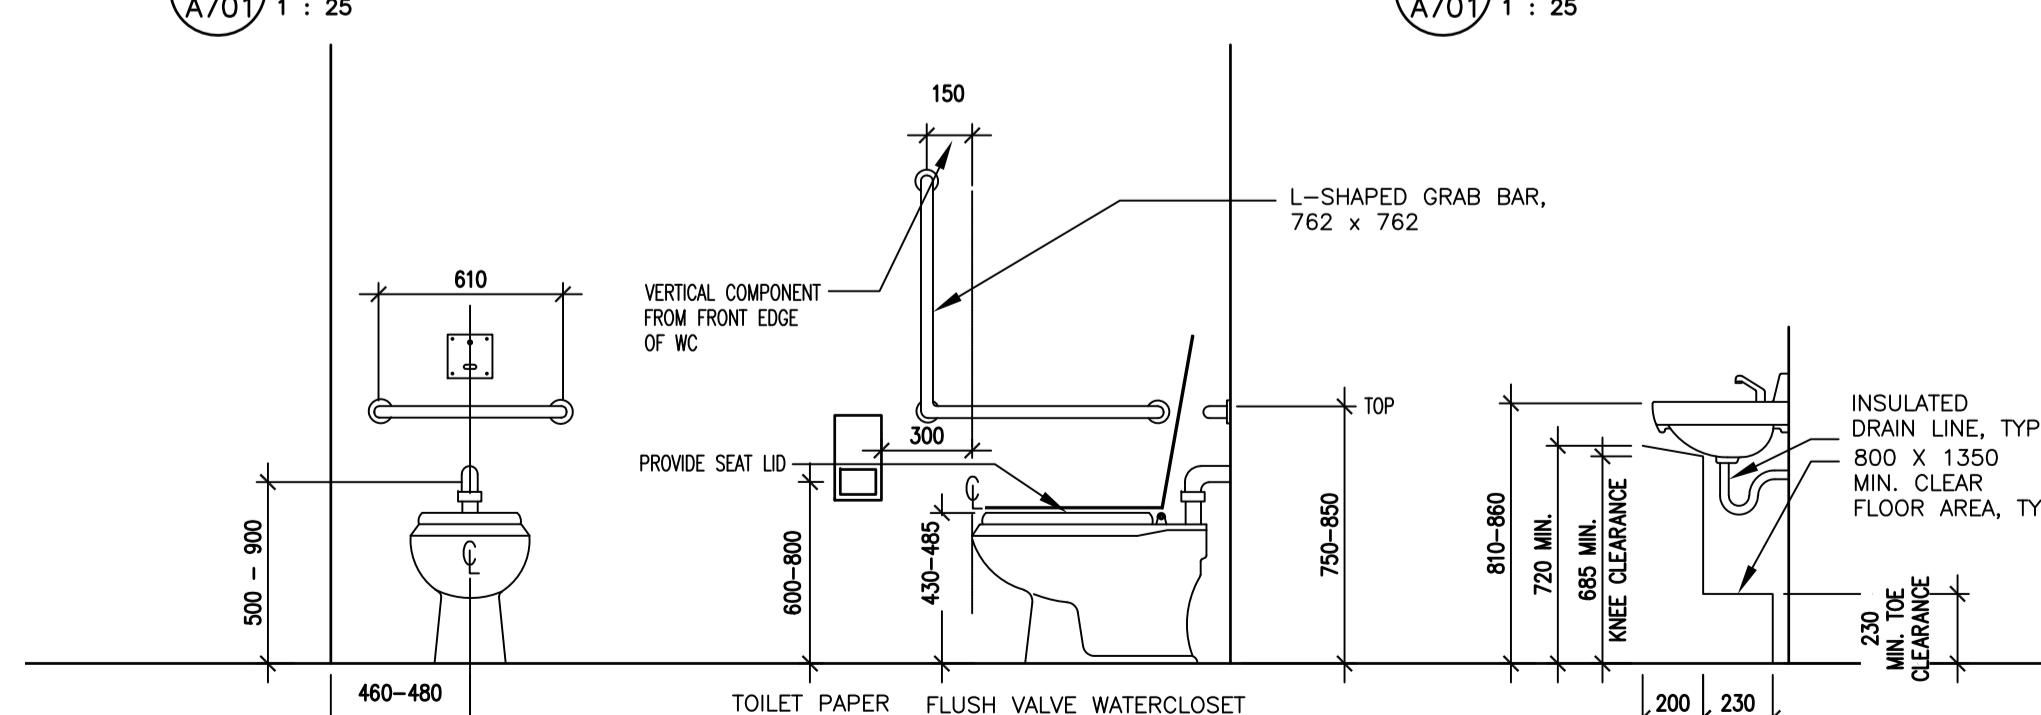

4 MOUNTING HEIGHTS

A701 1 : 25

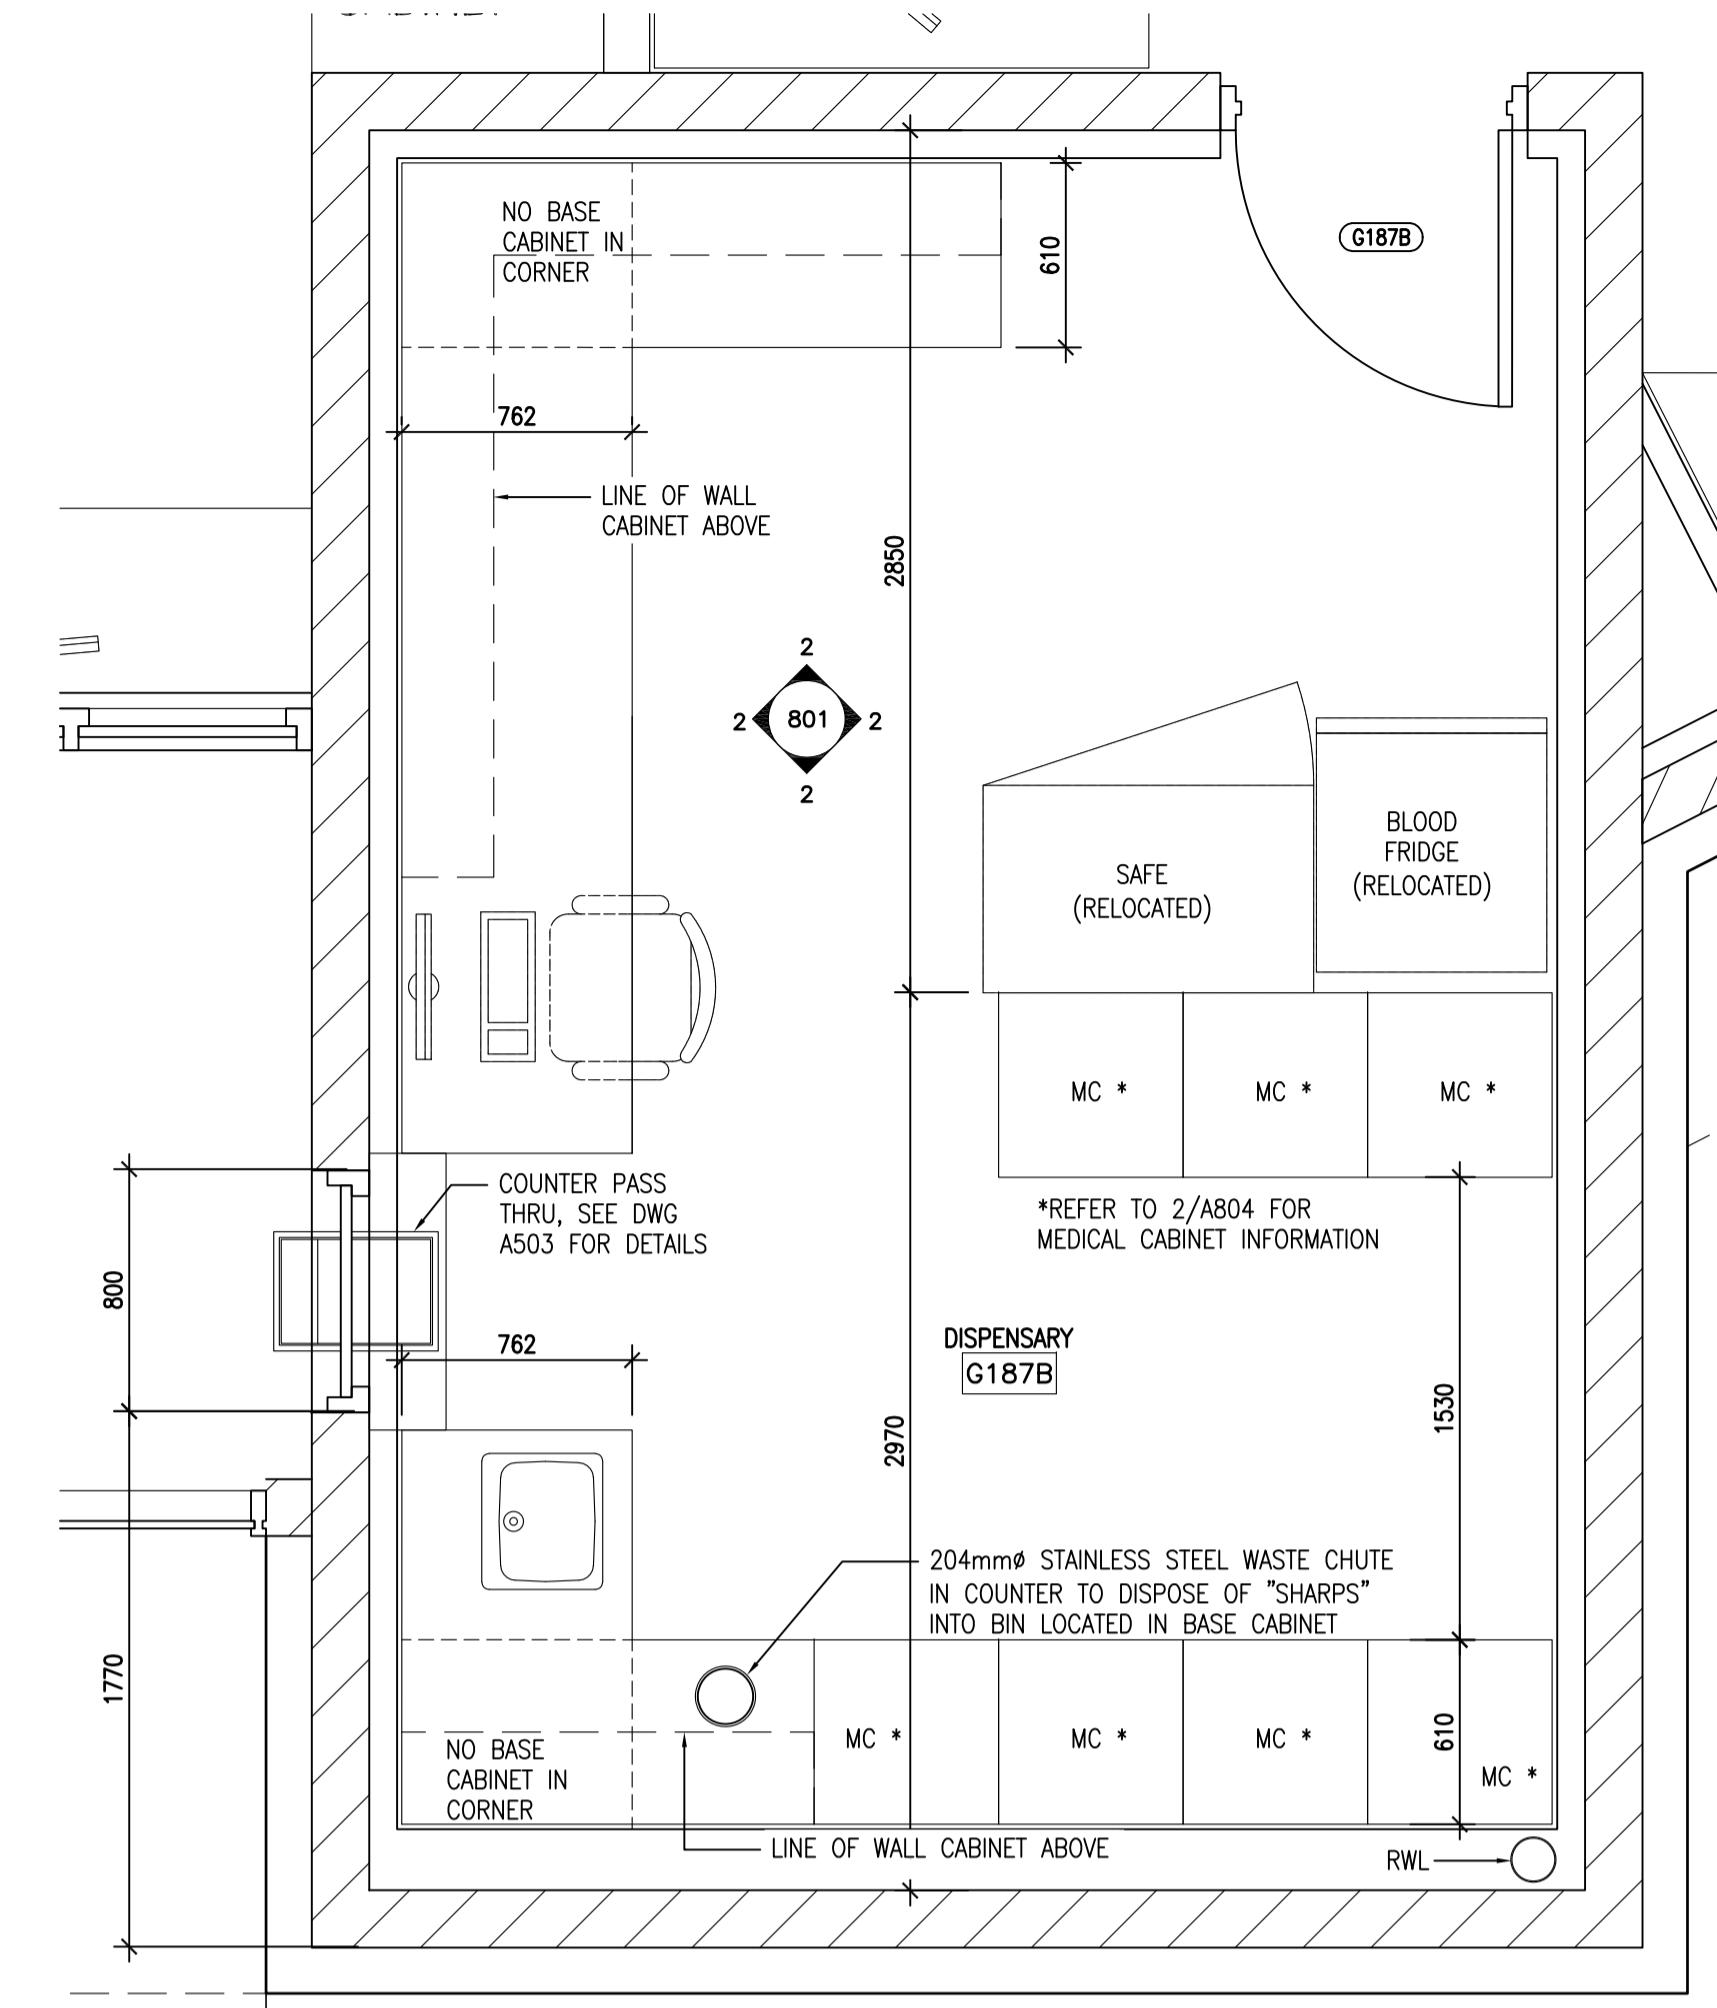

G187B DISPENSARY/MED. STOR.

A701 1 : 25



ACCESSORY SCHEDULE

CONTRACTOR TO SUPPLY AND INSTALL THE FOLLOWING
ACCESSORIES:

- ## WASHROOM FIXTURE NOTES:

 1. REFERENCE MOUNTING HEIGHT / CLEARANCES DIAGRAM FOR ALL ACCESSORIES AND FIXTURES.
 2. PROVIDE BLOCKING FOR ALL ACCESSORIES / FIXTURES AS REQUIRED.
 3. DO NOT RECESS ACCESSORIES IN FIRE RATED ASSEMBLIES.
 4. CONTRACTOR TO ENSURE FLUSH MECHANISM IS LOCATED ON ACCESSIBLE SIDE OF TANK (SIDE OPPOSITE WALL)
 5. CONTRACTOR TO PROVIDE & INSTALL UNIVERSAL - MALE / FEMALE / HC SIGNAGE. MOUNT ON WALL NEXT TO DOOR. SEE MOUNTING HEIGHT DIAGRAM.
 6. REFERENCE DETAILED DWGS / SCHEDULES FOR ALL MILLWORK REQUIREMENTS & FINISHES
 7. WHERE TWO HEIGHTS ARE NOTED, THESE ARE THE MINIMUM AND MAXIMUM THRESHOLDS OF WHRFR THFSF MAY BE MOUNTED.

LEGEND

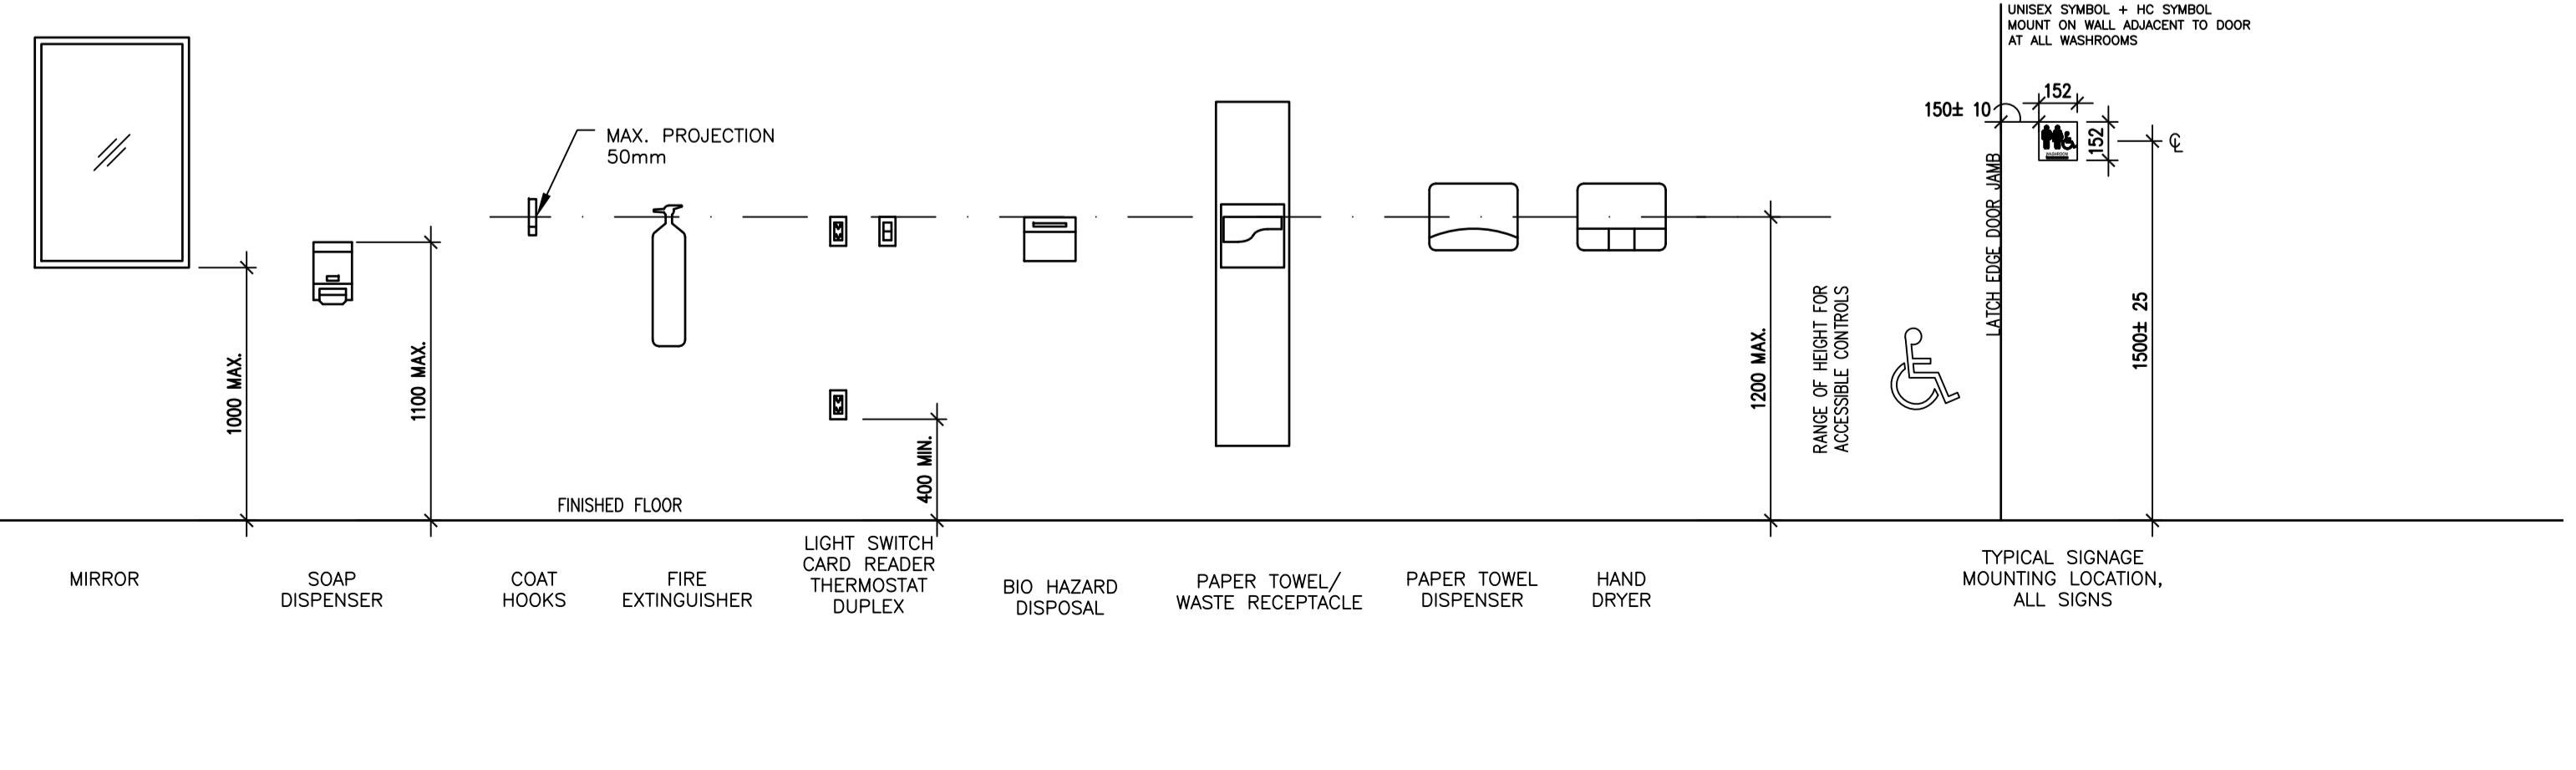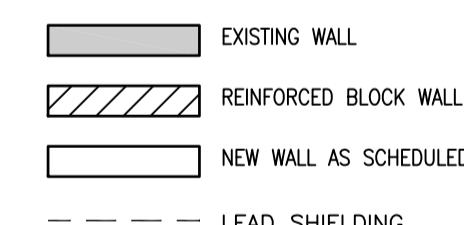




**Public Works and
Government Services
Canada**

**Travaux publics et
Services gouvernementaux
Canada**

**REAL PROPERTY SERVICES
Pacific Region**

**SERVICES IMMOBILIERS
Région de Pacifique**

MGBA
MALLEN GOWING BERZINS
ARCHITECTURE

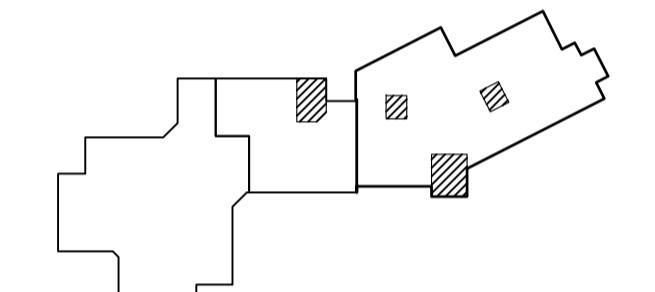

TRUE
NORTH

PROJECT
NORTH

CORRECTIONAL SERVICE OF CANADA

Project title/Titre du projet
AGASSIZ, BRITISH COLUMBIA
4732 CEMETERY ROAD PO BOX 1600
MOUNTAIN INSTITUTE

MOUNTAIN INSTITUTE HEALTH CARE EXPANSION

Consultant Signature Only

Designed by/Concept par
EDWIN BERZINS


Drawn by/Dessine par
MING HSU

PWGSC Project Manager/Administrateur de Projets TPSGC
TONY TANG


**Regional Manager, Architectural and Engineering Services
Gestionnaire régionale, Services d'architectural et de génie, TPSGC**
PREETIPAL PAUL

LARGE SCALE PLANS


Project No./No. du projet	Sheet/Feuille	Revision no. La Révision no.
R.077724.001	A701	0

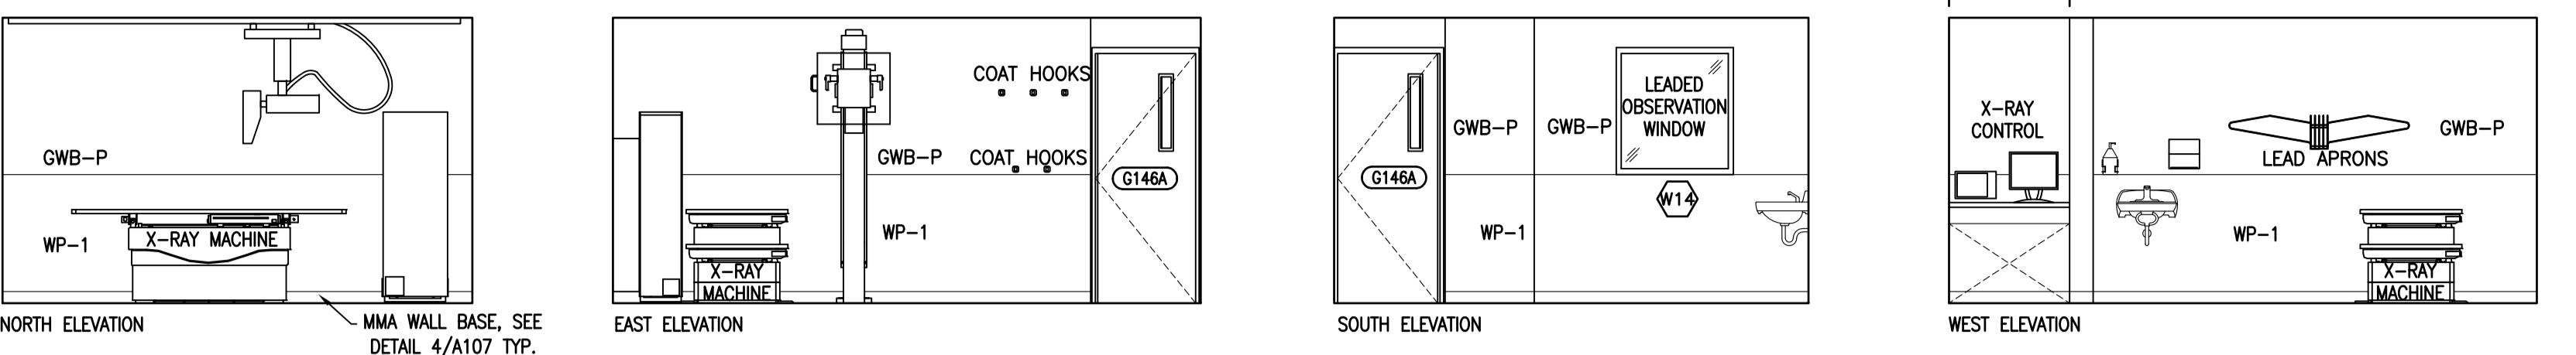

1 G146 MEDICAL X-RAY
A801 1:50

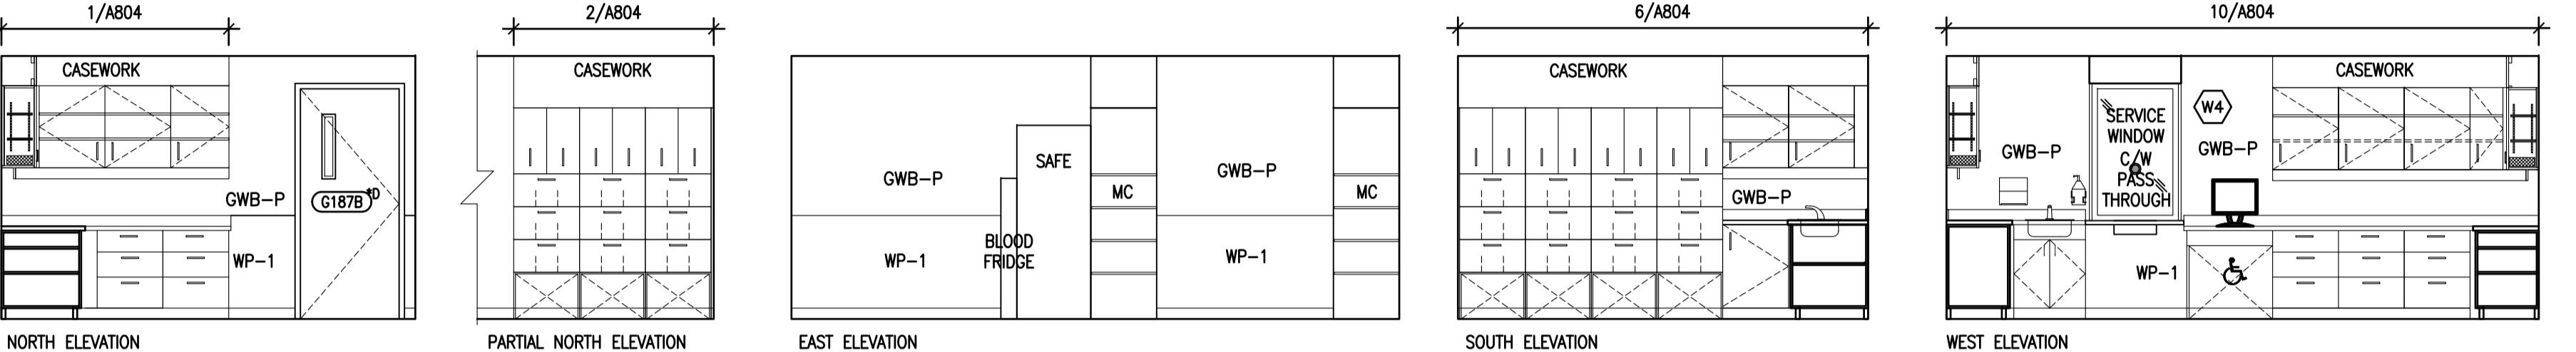

2 G187B DISPENSARY
A801 1:50

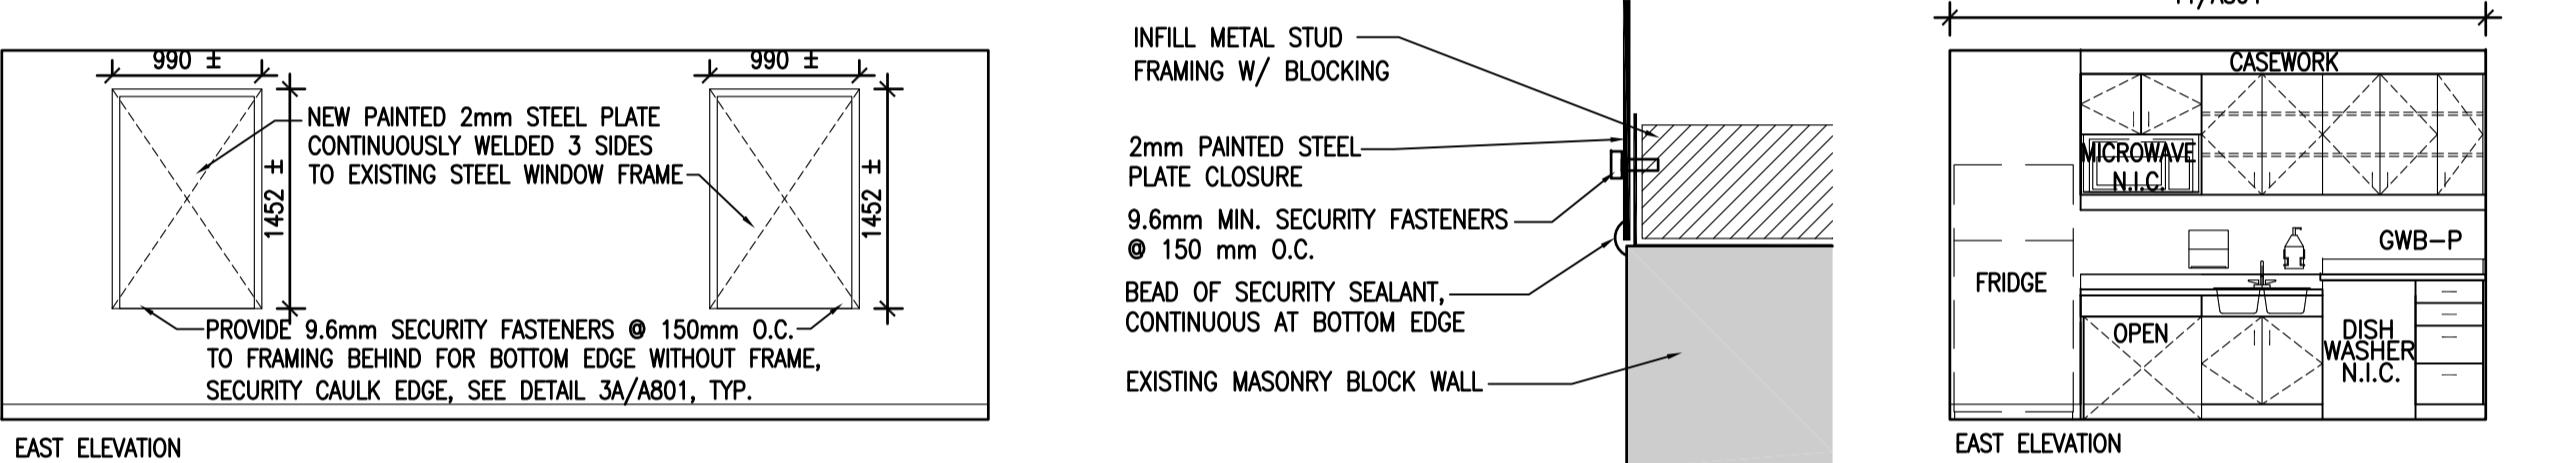


3 G140 SEARCH ROOM
A801 1:50

3A EDGE DETAIL
A801 1:2


4 G158A STAFF LOUNGE
A801 1:50

5 G163 BIO. HAZARD
A801 1:50


6 G164 SOILED SUPPLY
A801 1:50

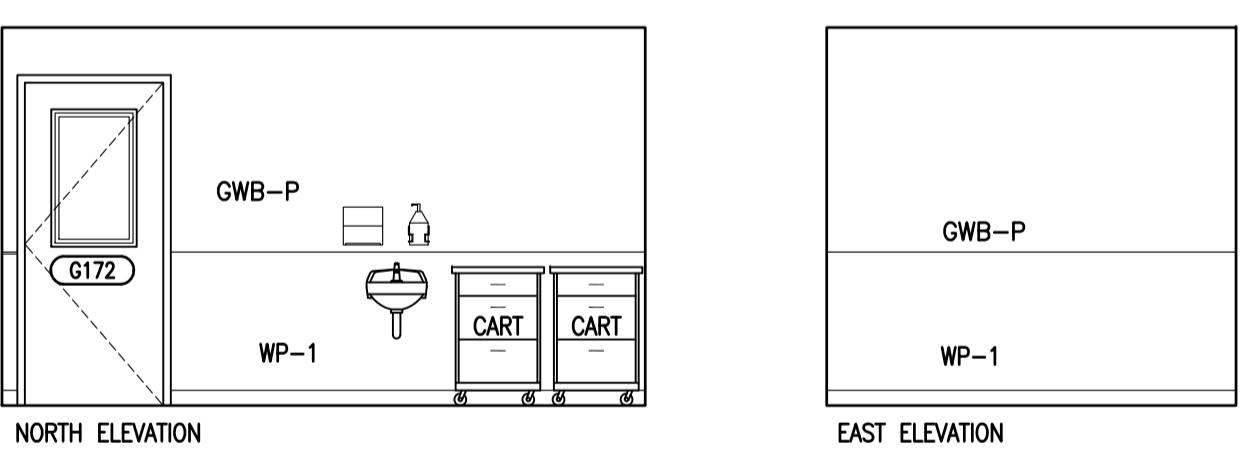

7 G172 DENTAL OPERATORY
A801 1:50

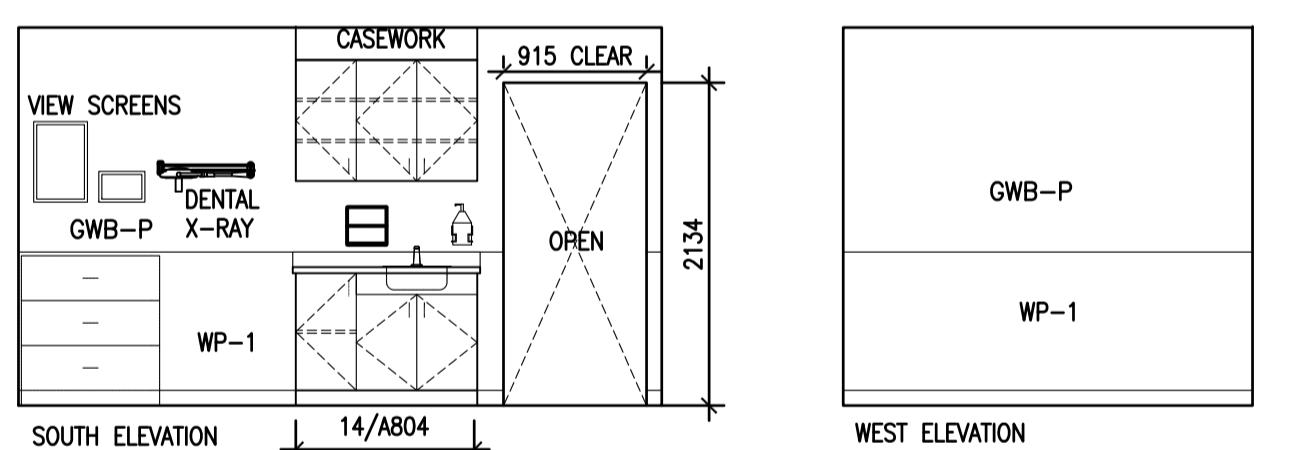

8 G172A DENTAL PROCESSING
A801 1:50

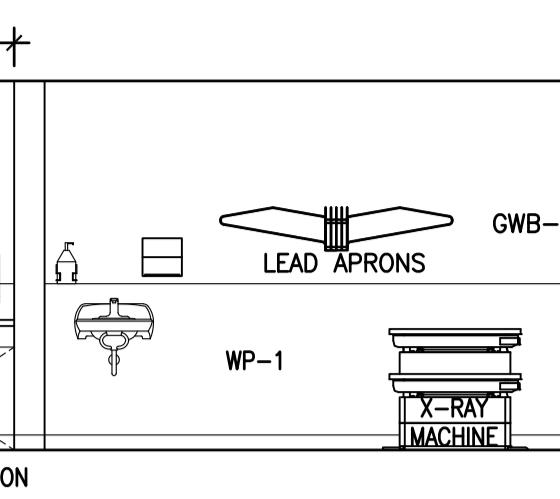

9 G153 STAFF CHANGE
A801 1:50

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0	ISSUED FOR TENDER Description/Description Client/Client

CORRECTIONAL SERVICE OF CANADA

Project Title/Titre du projet
AGASSIZ, BRITISH COLUMBIA
4732 CEMETERY ROAD PO BOX 1600
MOUNTAIN INSTITUTE


MOUNTAIN INSTITUTE HEALTH CARE EXPANSION

Consultant Signature Only
Designed by/Concept par EDWIN BERZINS
Drawn by/Desiné par BEN MONROE /MING HSU (2017-09-28)
PWGS Project Manager/Administrateur de Projets TPSGC TONY TANG
Regional Manager, Architectural and Engineering Services Gestionnaire régionale, Services d'architecture et de génie, TPSGC PREETPAL PAUL


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INTERIOR ELEVATIONS 1


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R.077724.001	OF 6	

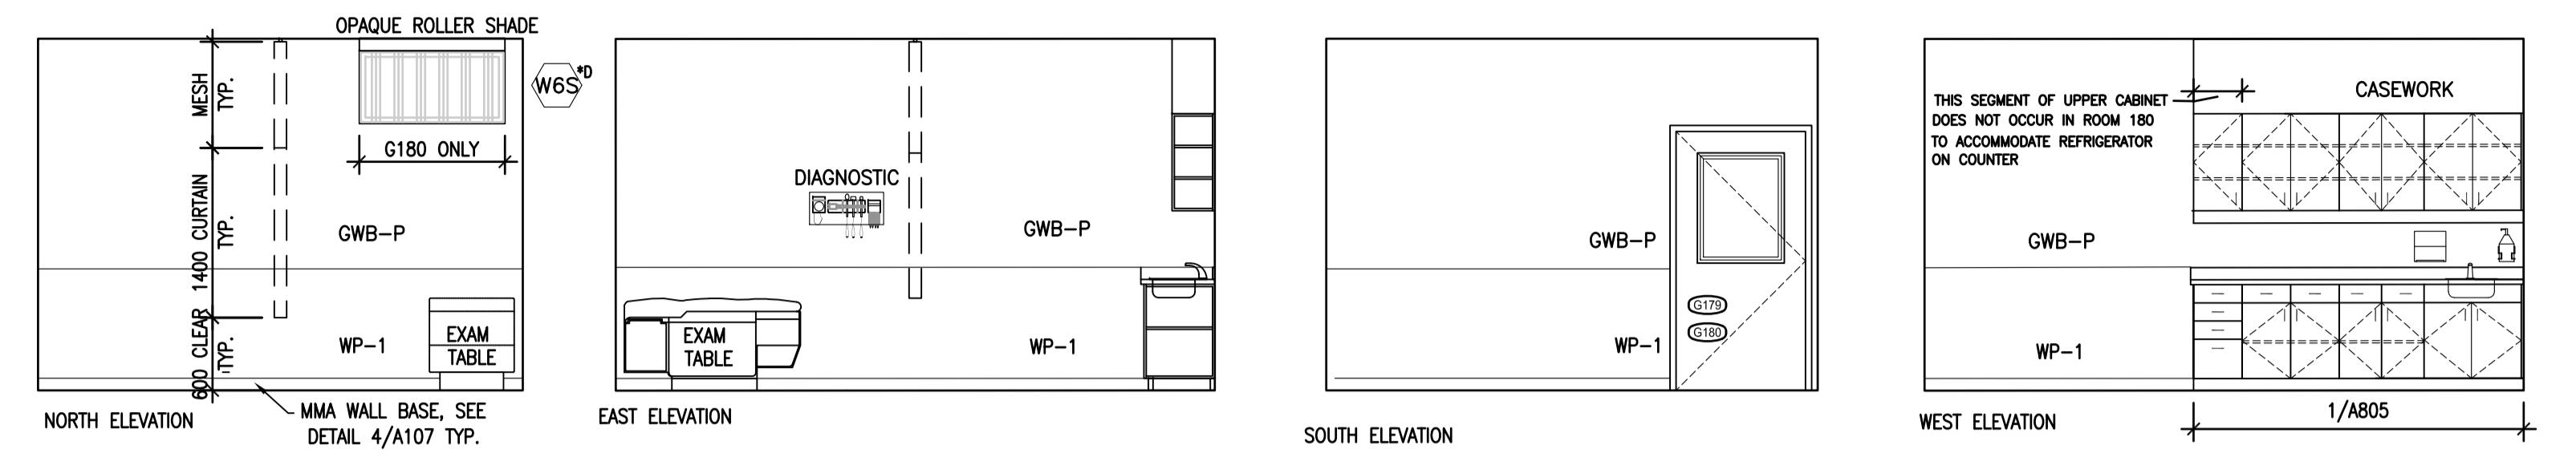


1 G179/G180 TREATMENT

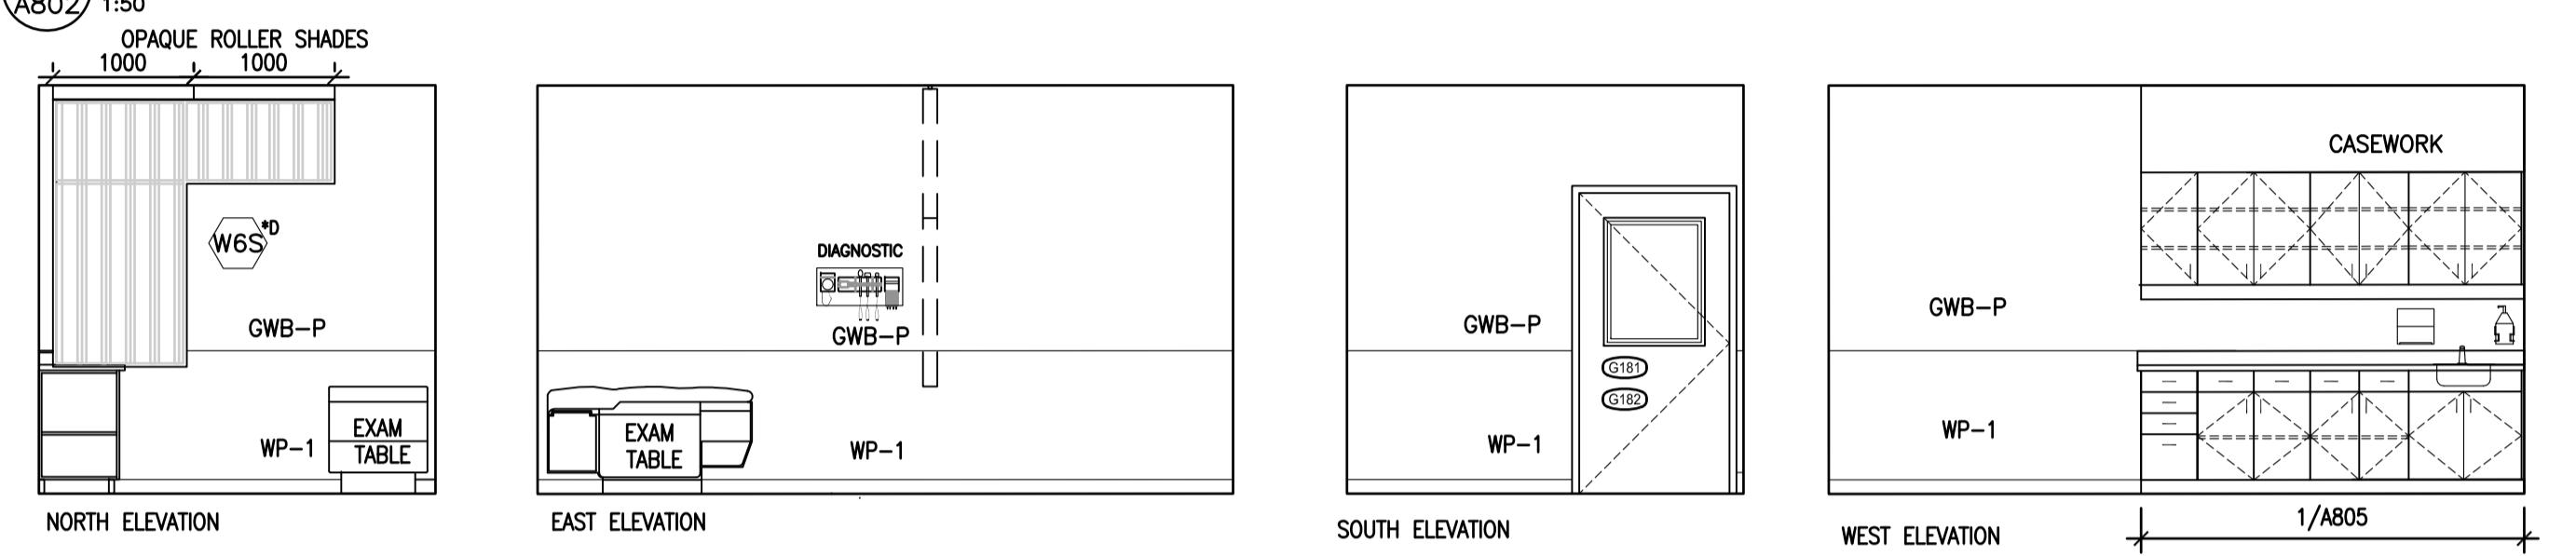


2 G181/182 EXAM ROOM 2/3

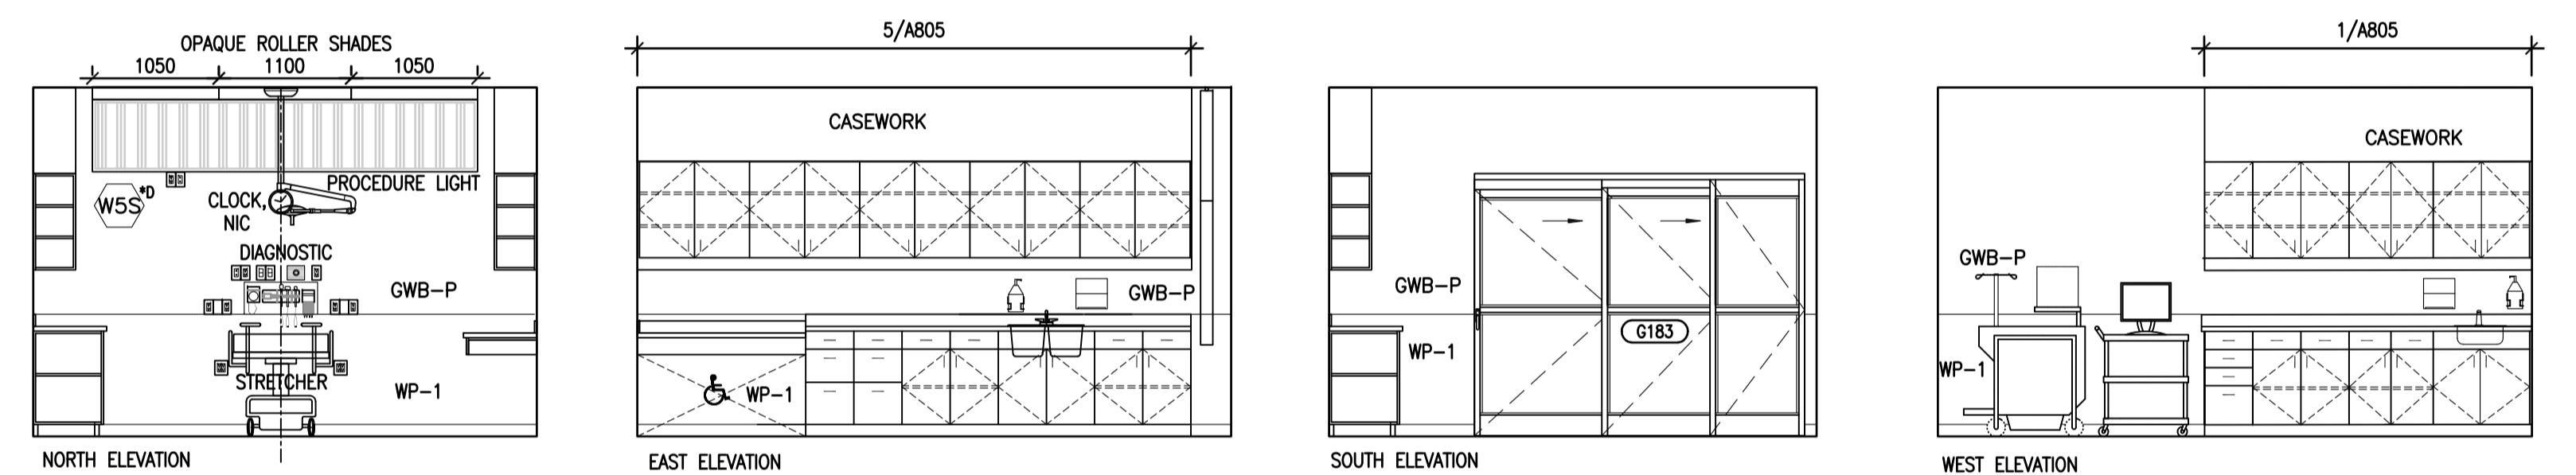

3 G183 SPECIALTY TREATMENT ROOM

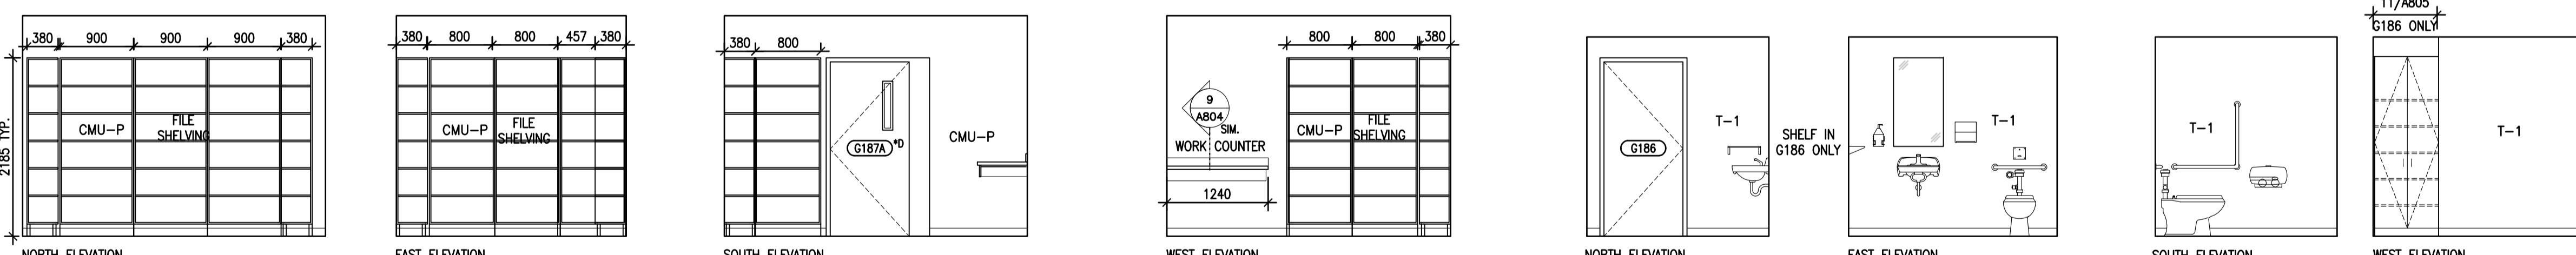

4 G187A FILE STORAGE

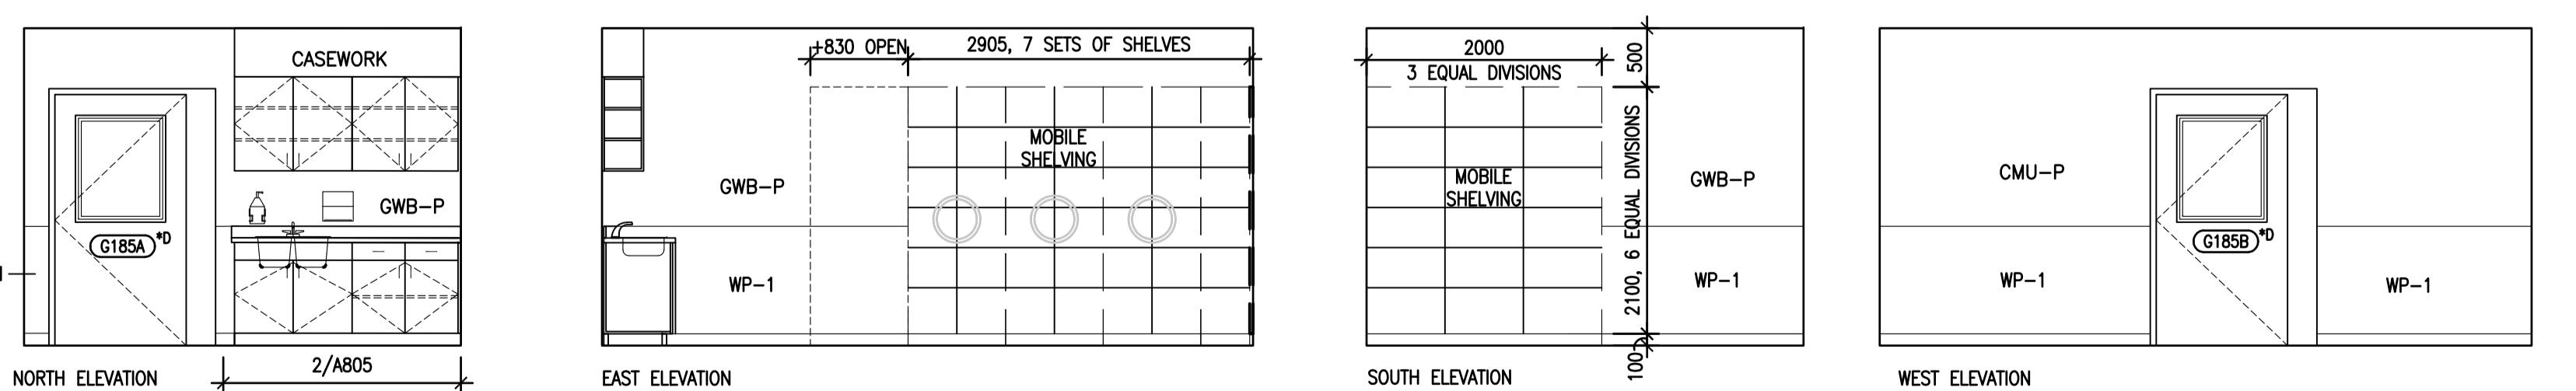

5 G186 STAFF WASHROOM / G177 SIMILAR

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Revision/ Revision	Description/Description	Date/Date

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Project Title/Titre du projet
AGASSIZ, BRITISH COLUMBIA
4732 CEMETERY ROAD PO BOX 1600
MOUNTAIN INSTITUTE


MOUNTAIN INSTITUTE HEALTH CARE EXPANSION

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Designed by/Concept par EDWIN BERZINS
Drawn by/Dessiné par MING HSU
PWGS Project Manager/Administrateur de Projets TPSGC TONY TANG
Regional Manager, Architectural and Engineering Services Gestionnaire régionale, Services d'architecture et de génie, TPSGC PREETPAL PAUL


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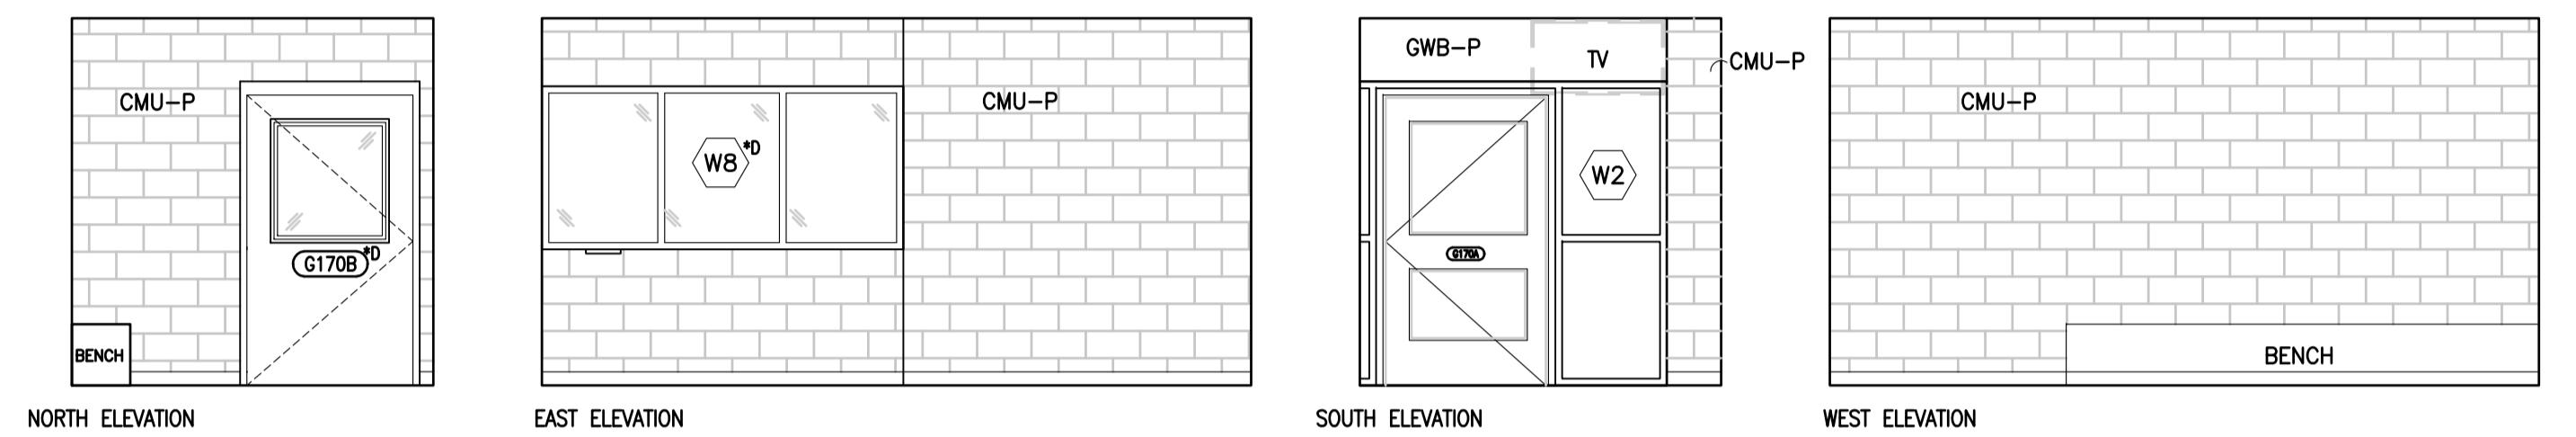
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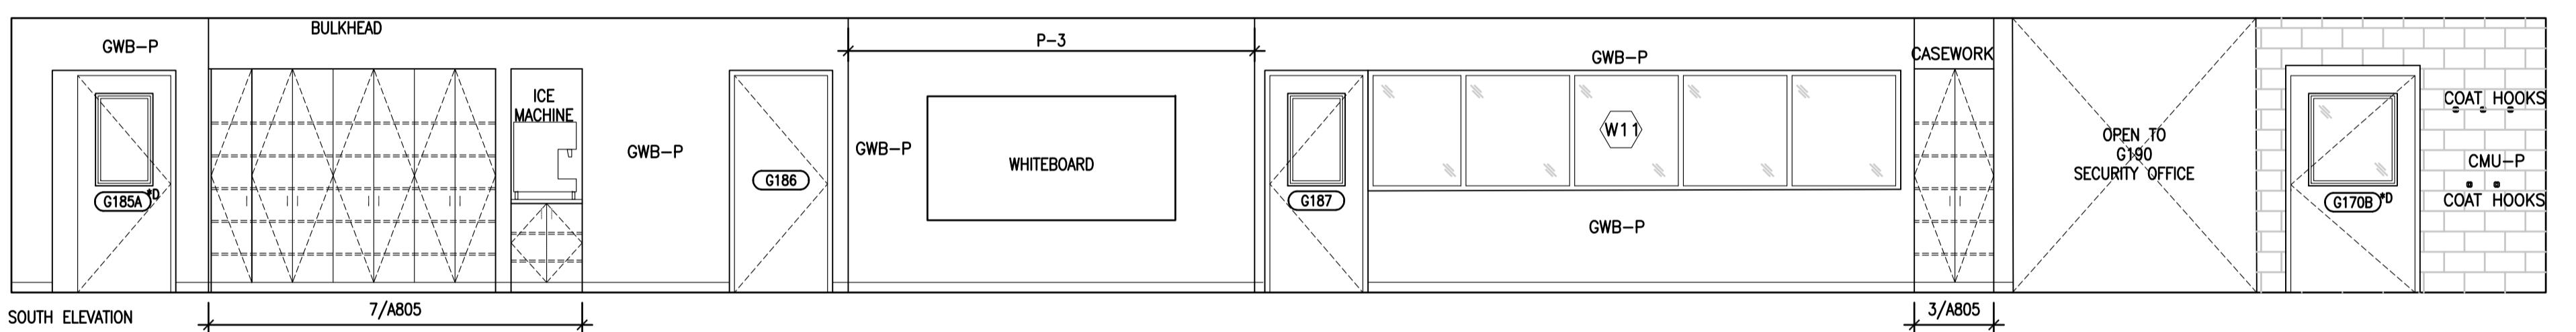
01 G178 EXAM ROOM 1
A803 1:50




02 G190 SECURITY OFFICE
A803 1:50

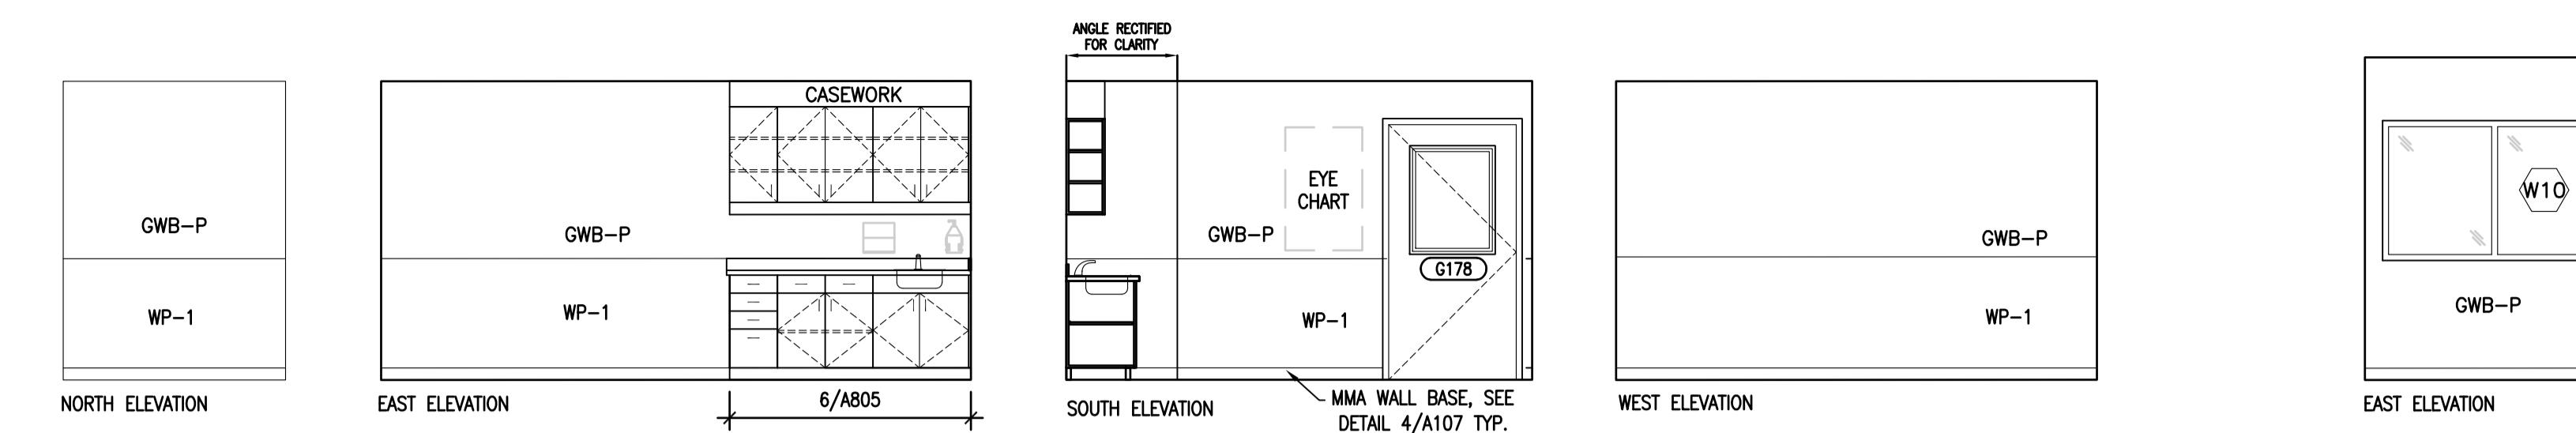


03 G170 VEST & INMATE WAIT
A803 1:50

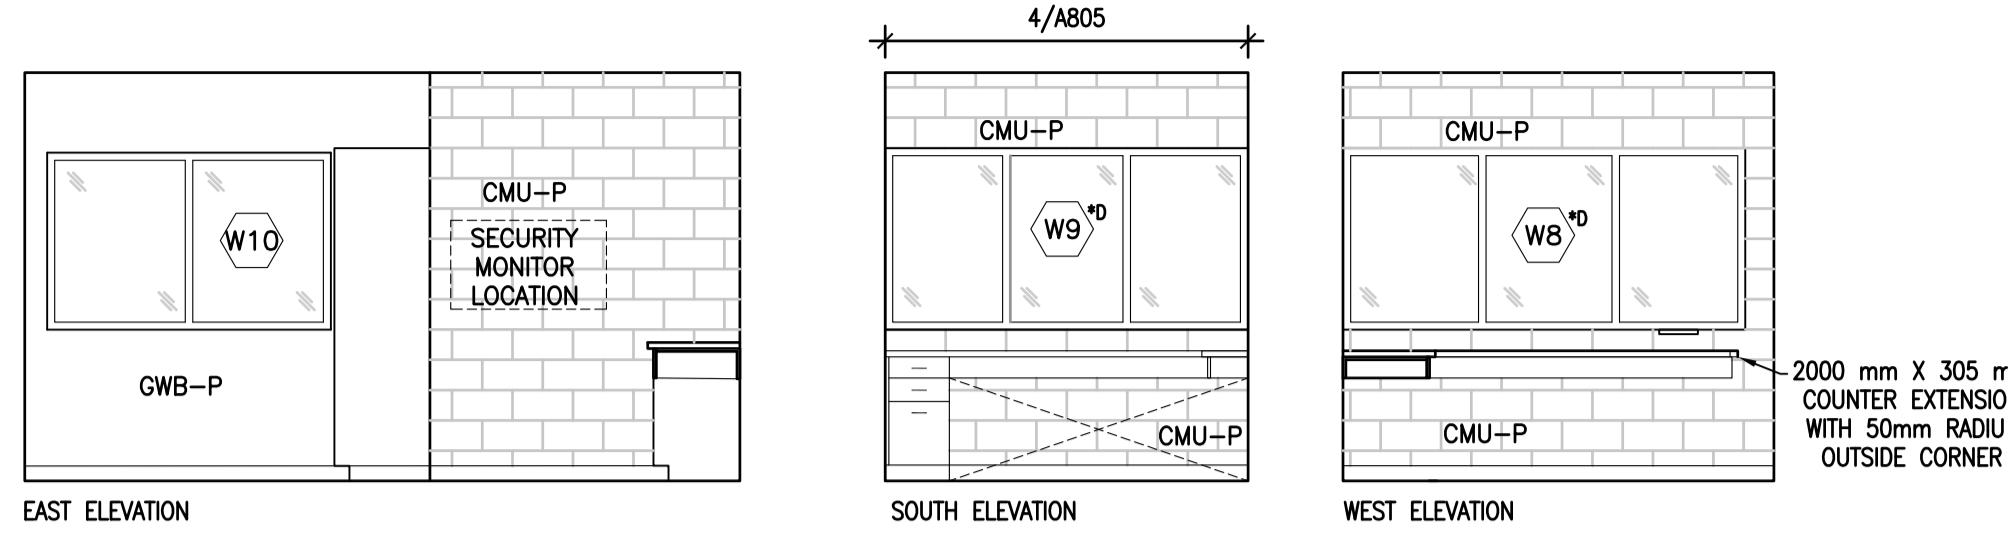

04 G171 CORRIDOR
A803 1:50

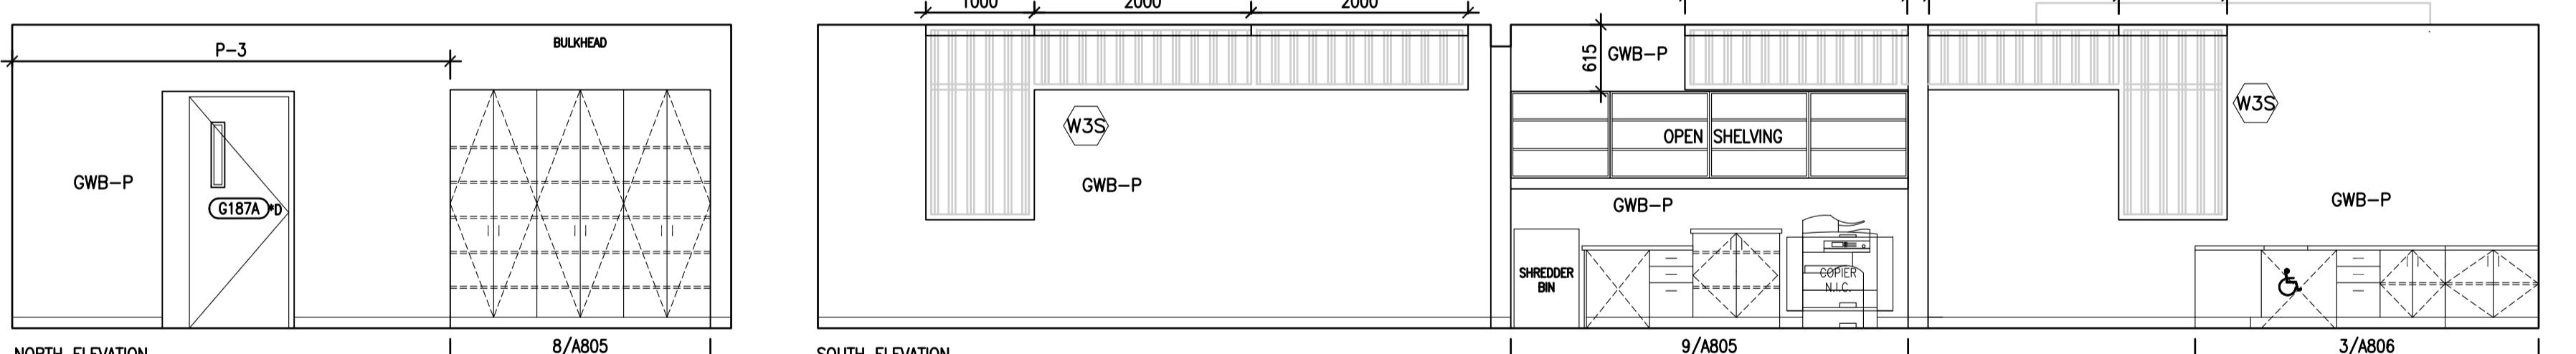

05 G194 CORRIDOR
A803 1:50

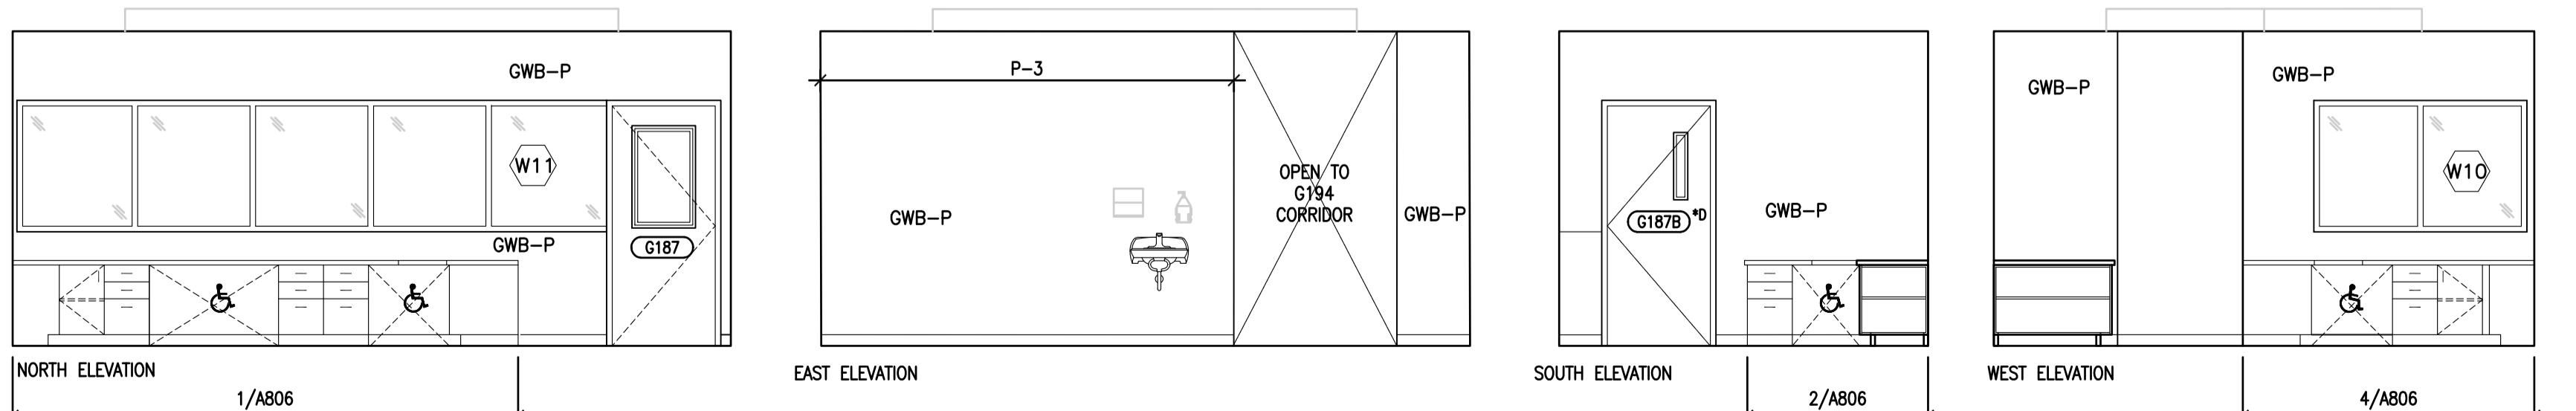

06 G187 NURSING STATION
A803 1:50

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Révision

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CORRECTIONAL
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AGASSIZ, BRITISH COLUMBIA
4732 CEMETERY ROAD PO BOX 1600
MOUNTAIN INSTITUTE

MOUNTAIN INSTITUTE HEALTH CARE EXPANSION

Consultant Signature Only

Designed by/Conçue par
EDWIN BERZINS

Drawn by/Dessinée par
NORMANN BAUMANN (2017-09-28)

PWSSC Project Manager/Administrateur de Projets TPSGC
TONY TANG

Regional Manager, Architectural and Engineering Services
Gestionnaire régionale, Services d'architecture et de génie, TPSGC
PREETPAL PAUL


Drawing title/Titre du dessin

INTERIOR ELEVATIONS 3

Project No./No. du
projet
R.077724.001

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La Révision
no.
A803

OF 6

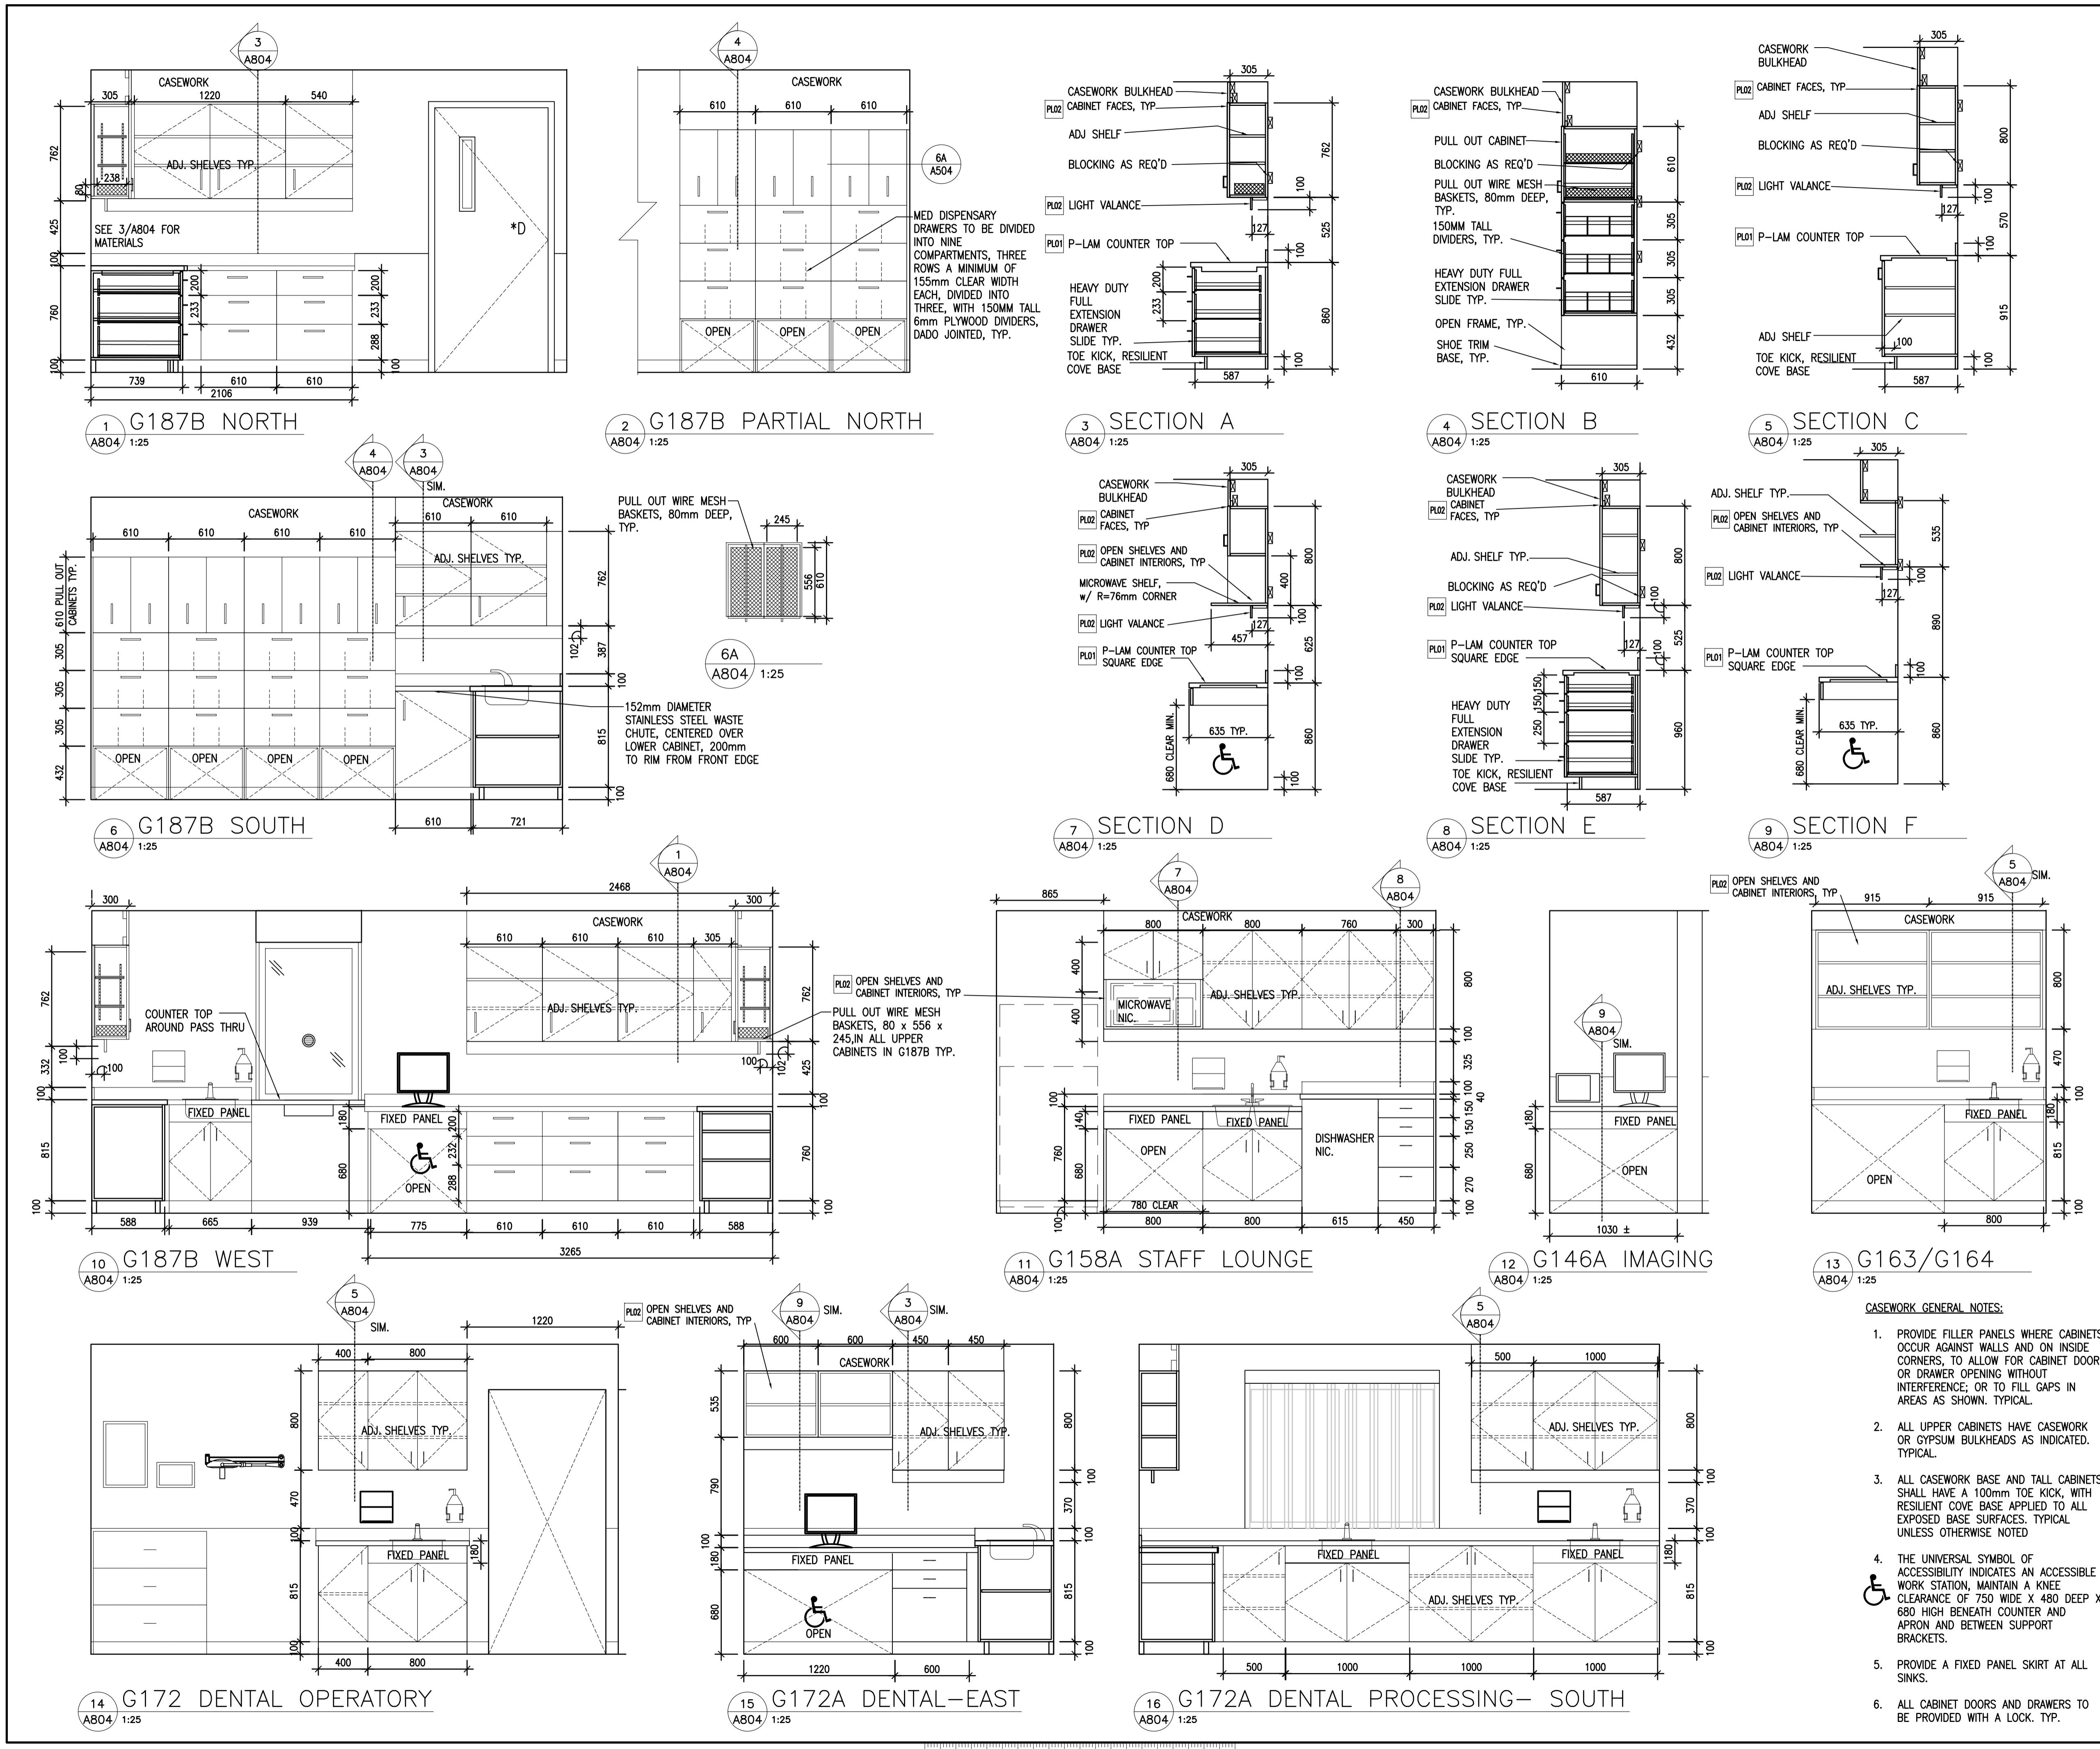

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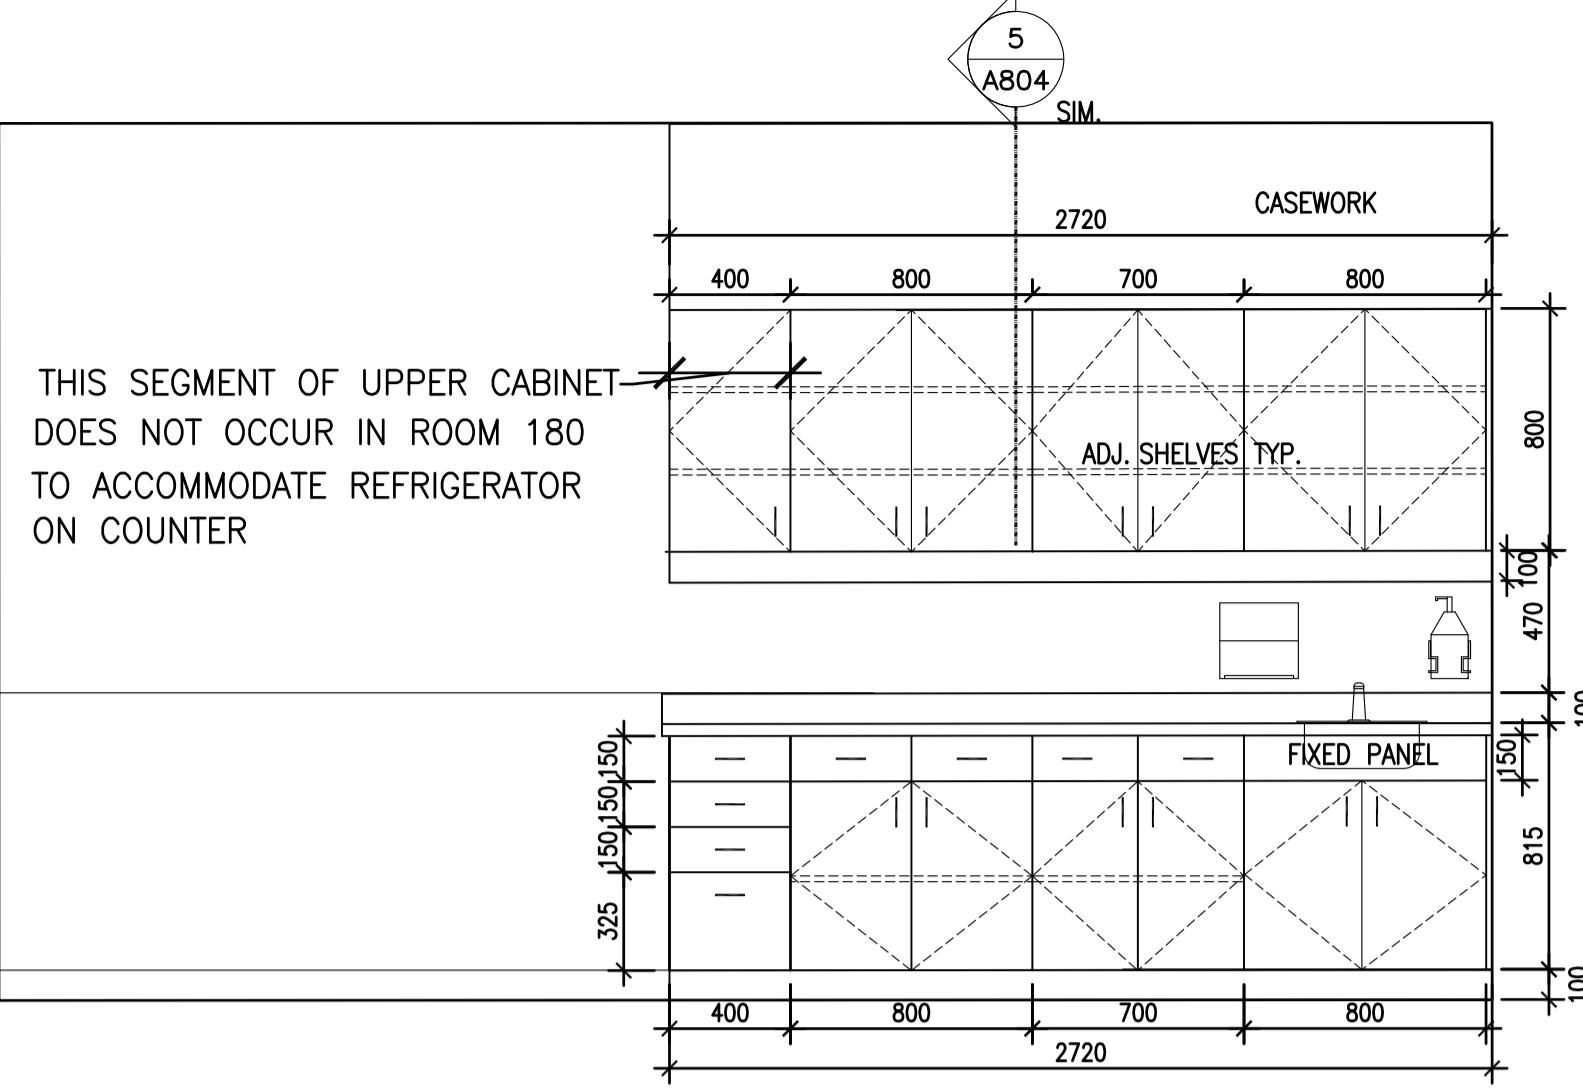
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4732 CEMETERY ROAD PO BOX 1600
MOUNTAIN INSTITUTE

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HEALTH CARE EXPANSION**


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Designed by/Concept par
EDWIN BERZINS
Drawn by/Desain par
NORMANN BAUMANN (2017-09-28)
PWGSC Project Manager/Administrateur de Projets TPSGC
TONY TANG
Regional Manager, Architectural and Engineering Services
Gestionnaire régionale, Services d'architecture et de génie, TPSGC
PREETPAL PAUL

Drawing title/Titre du dessin
CASEWORK DETAILS 1


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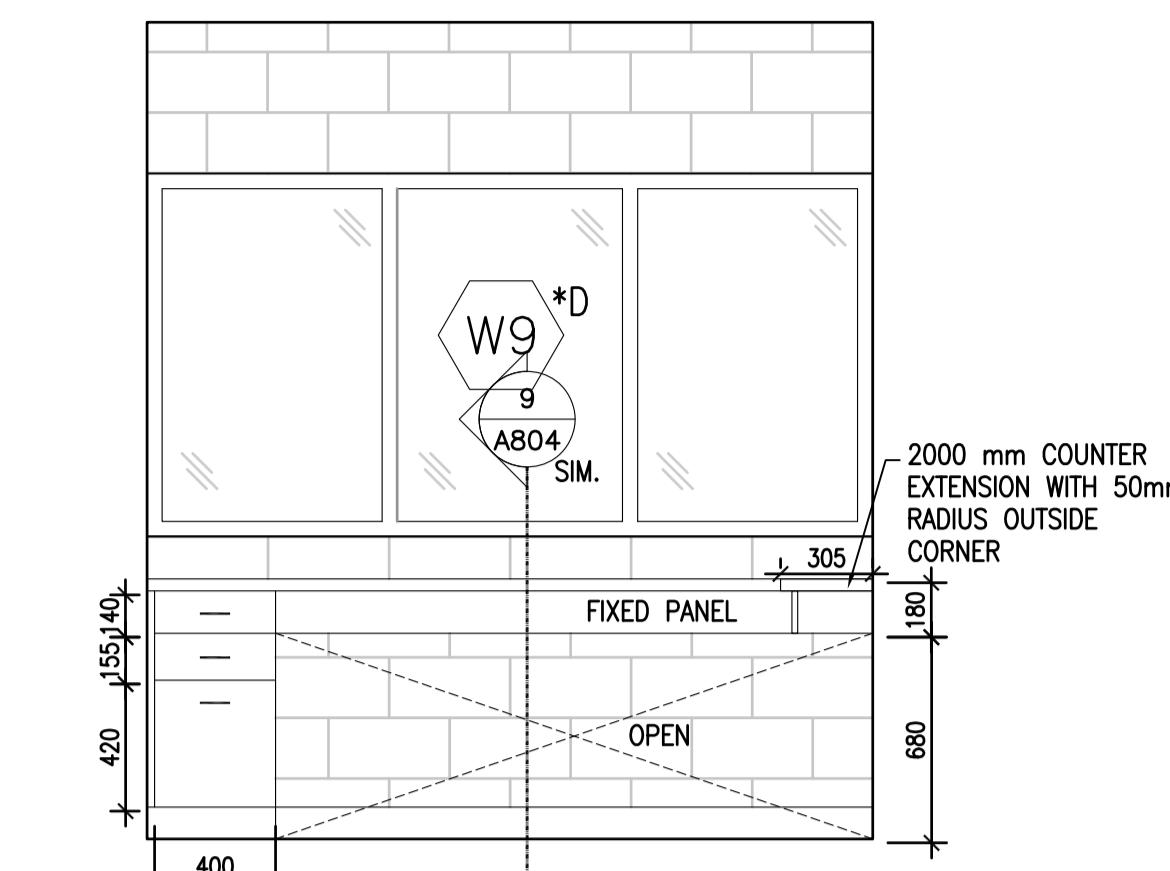
1 G179, G180, G181 G182, G183 WEST, TYP.
A805 1:25




2 G185 CLEAN SUPPLY, NORTH
A805 1:25

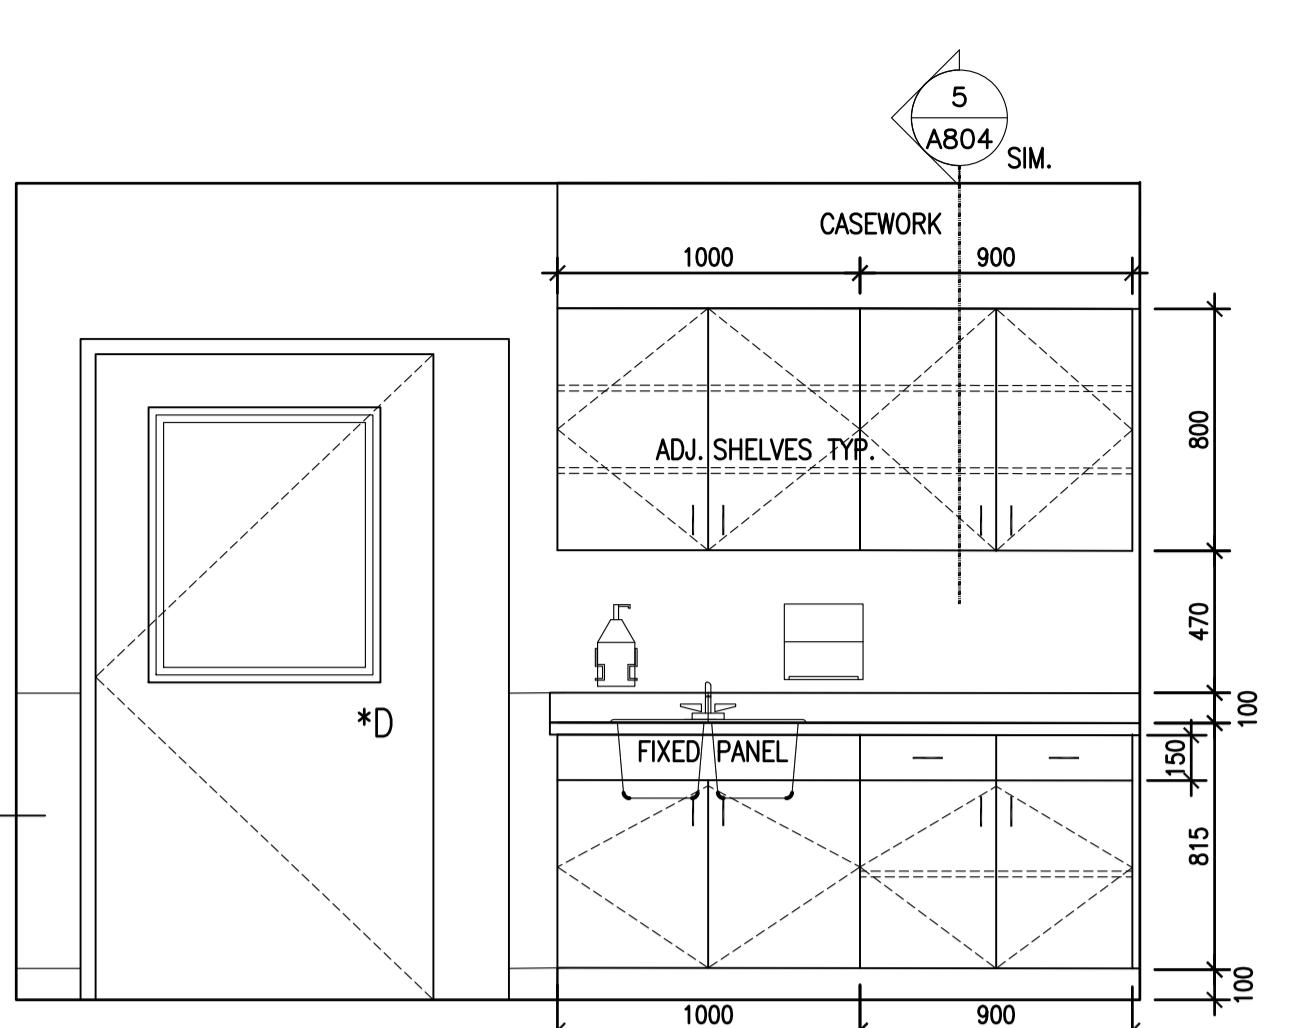


3 G188 SEC. SOUTH I
A805 1:25

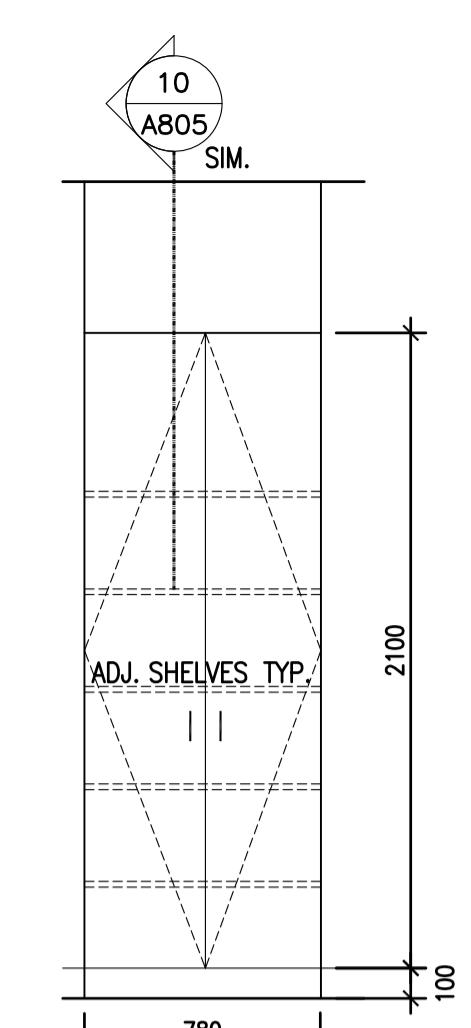


4 G188 SEC. SOUTH II
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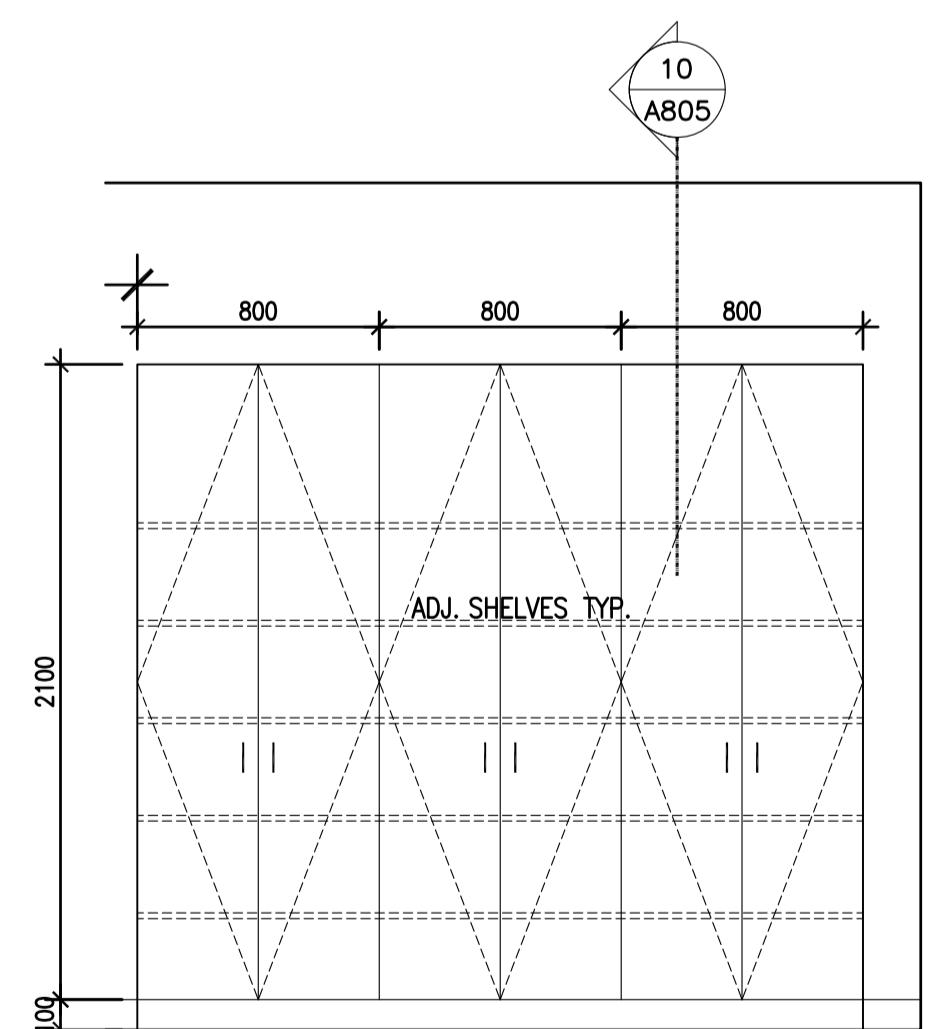
5 G183 SPECIALTY TREATMENT EAST
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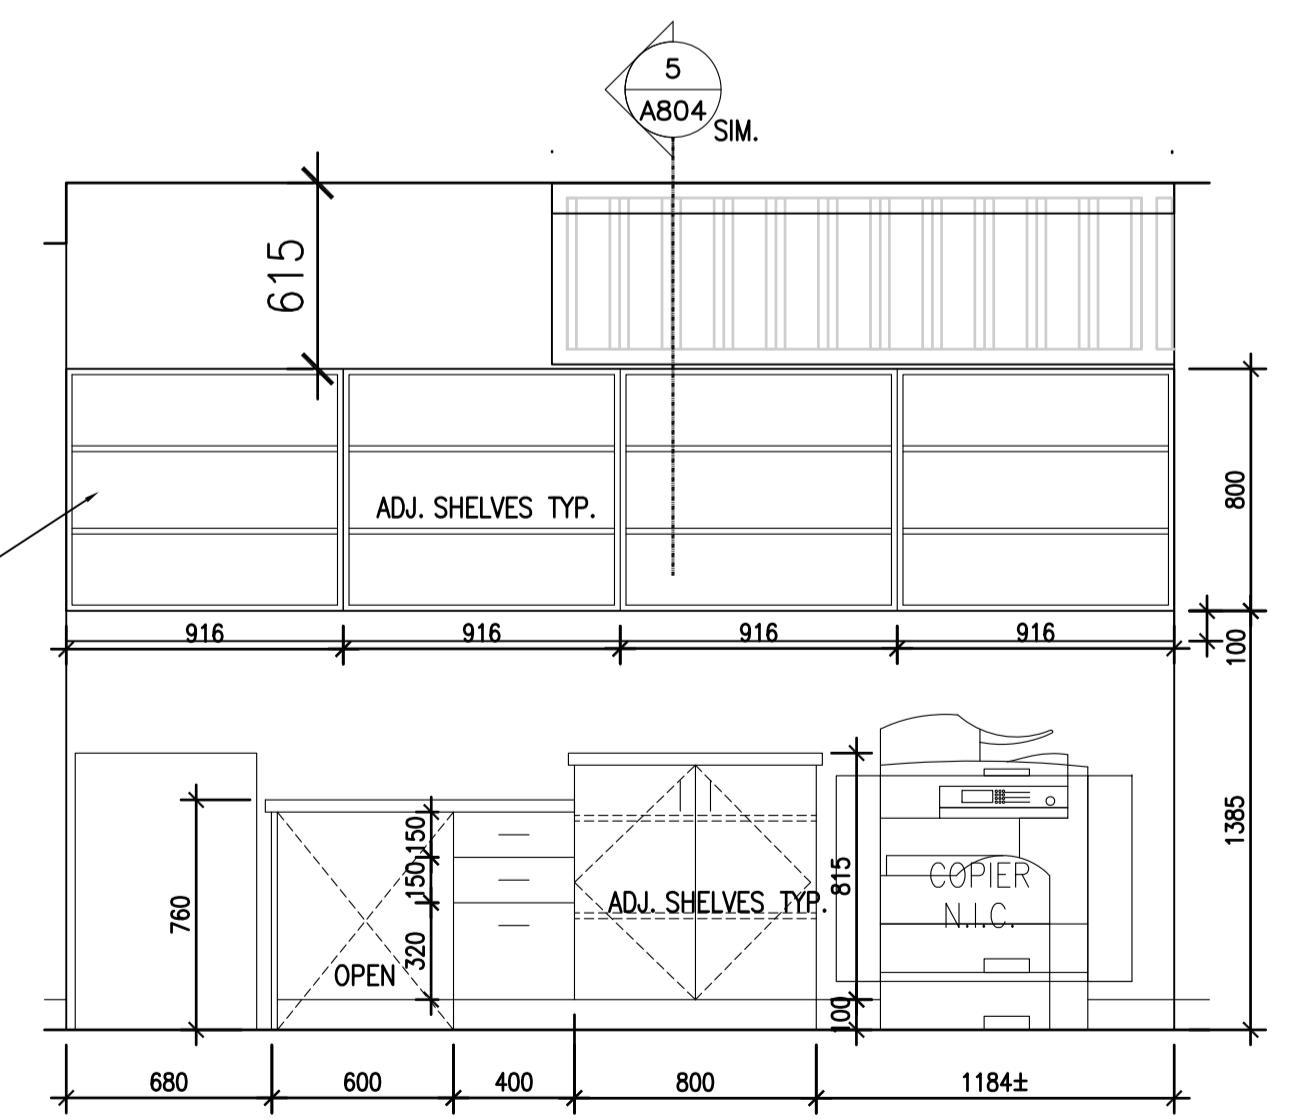
6 G178 EXAM ROOM 1
A805 1:25

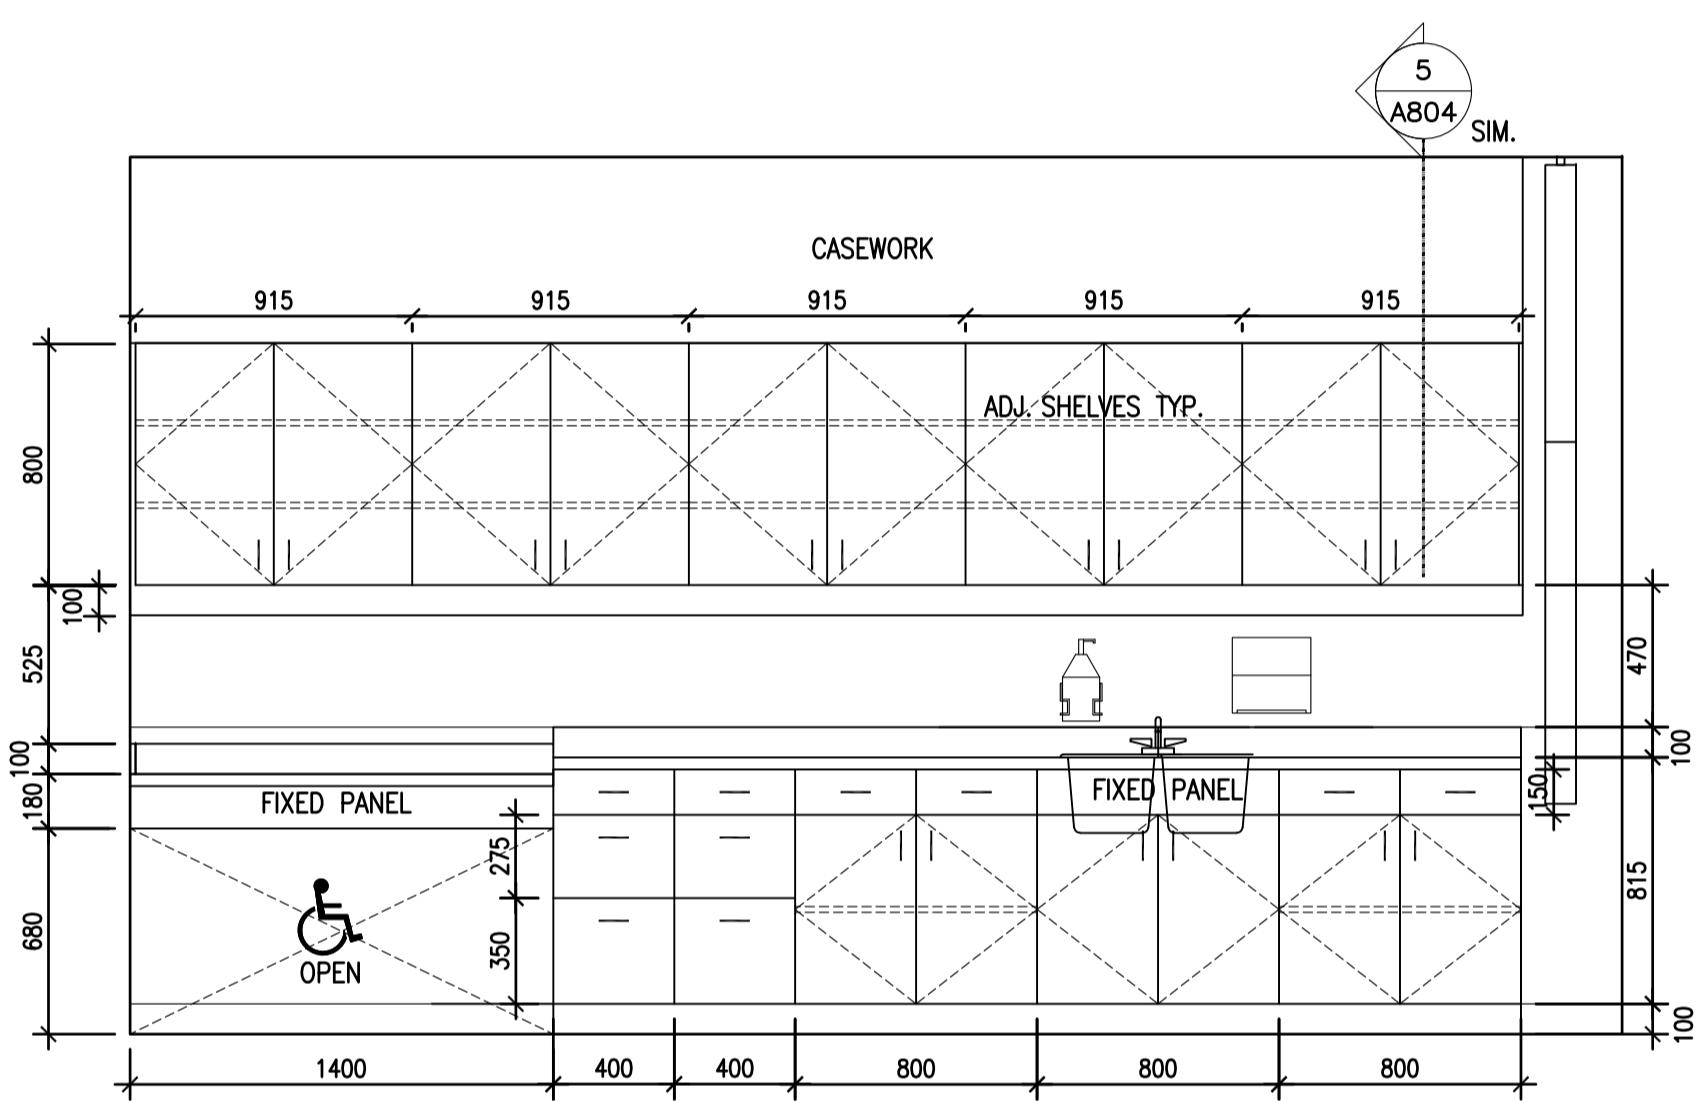


7 G171 CORRIDOR, PART. SOUTH
A805 1:25

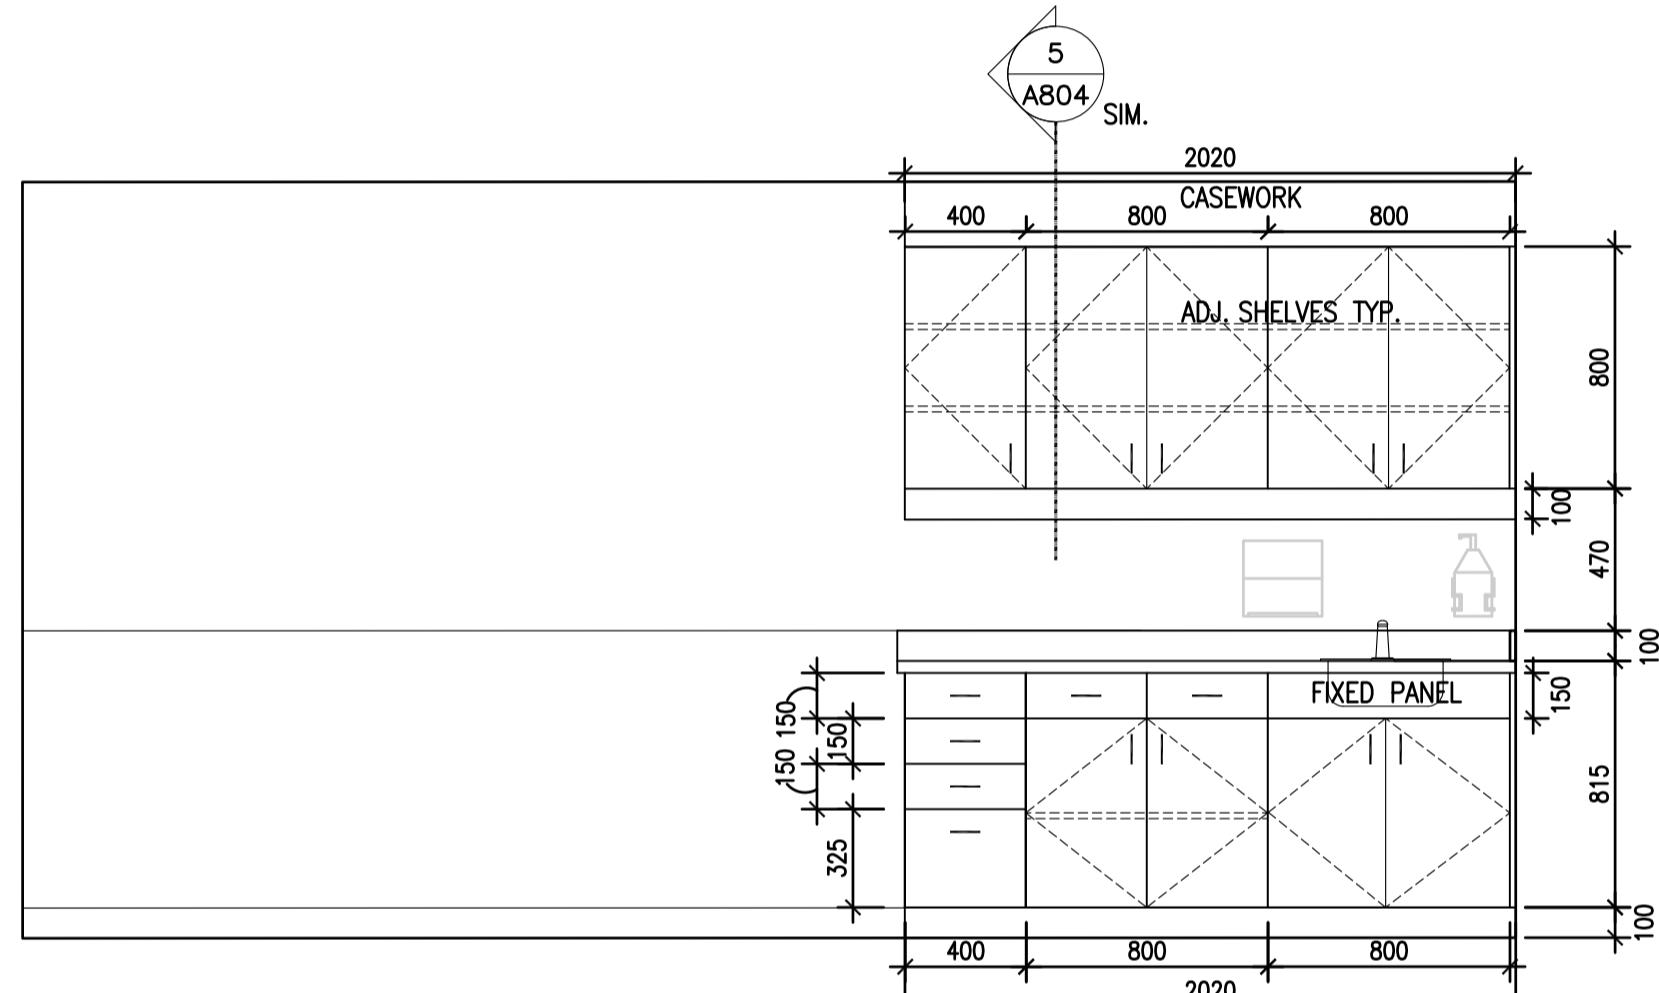


8 G187C CORRIDOR NORTH
A805 1:25

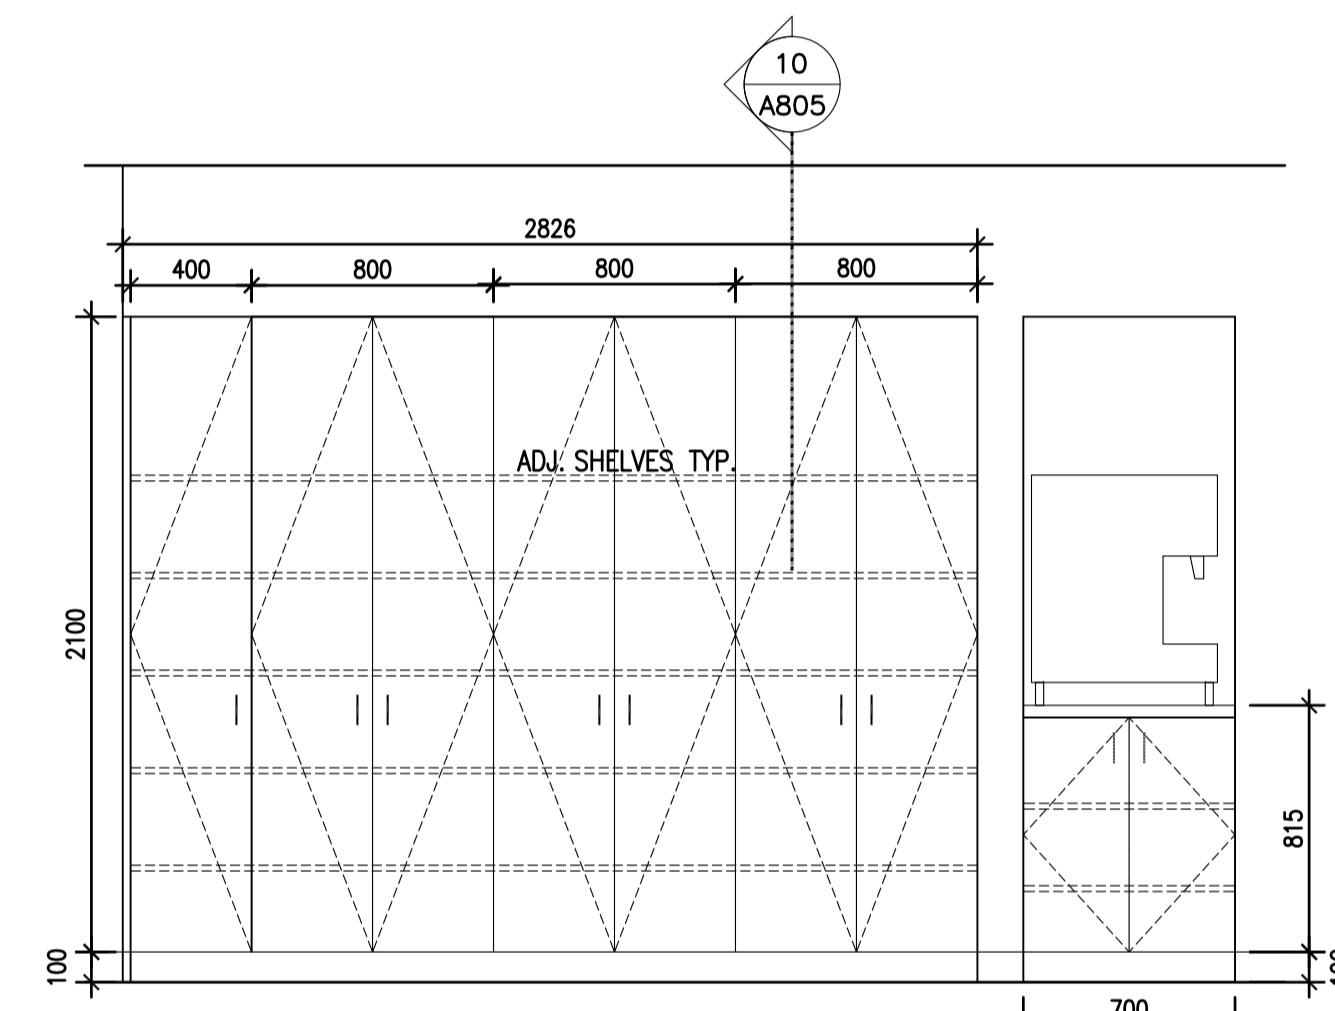

9 G187C CORRIDOR SOUTH
A805 1:25

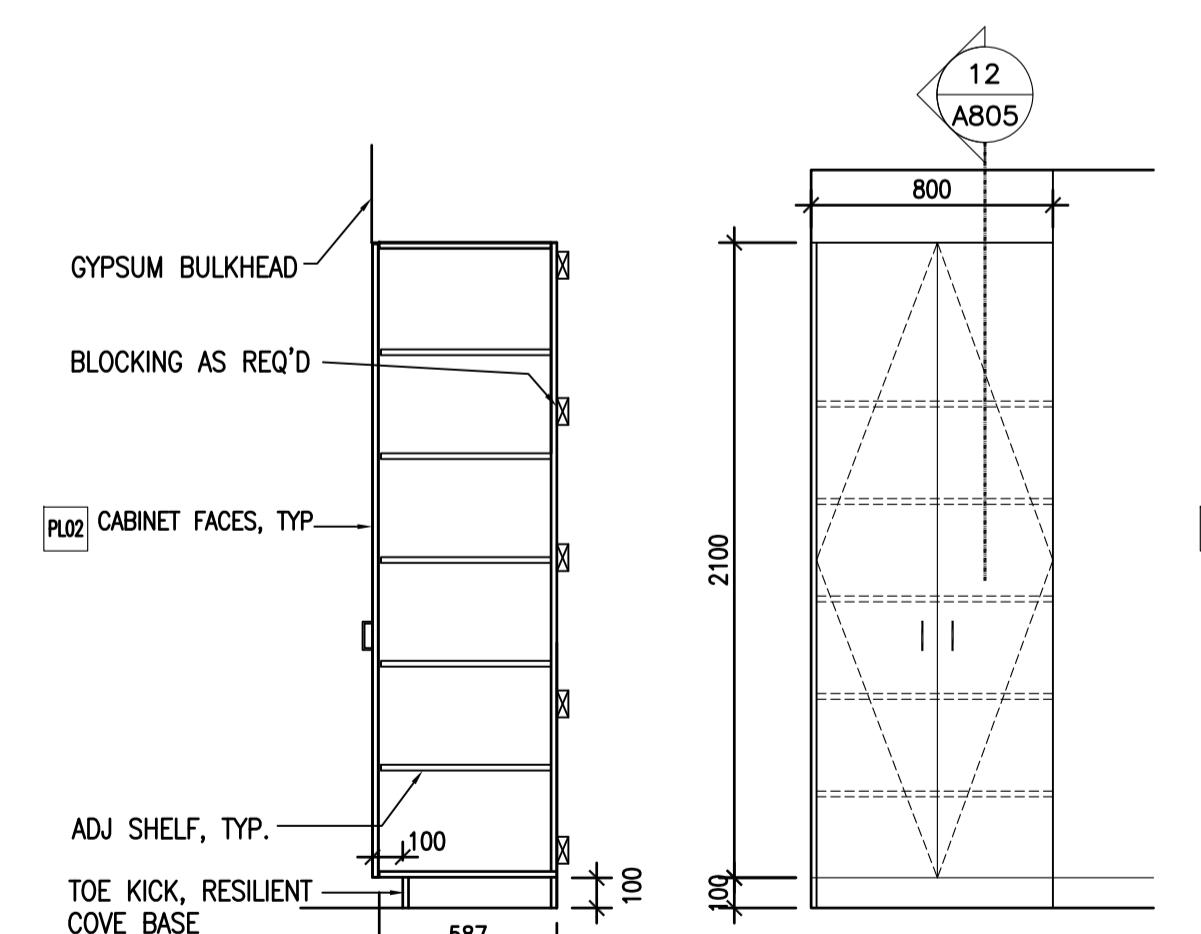

10 SECTION G
A805 1:25

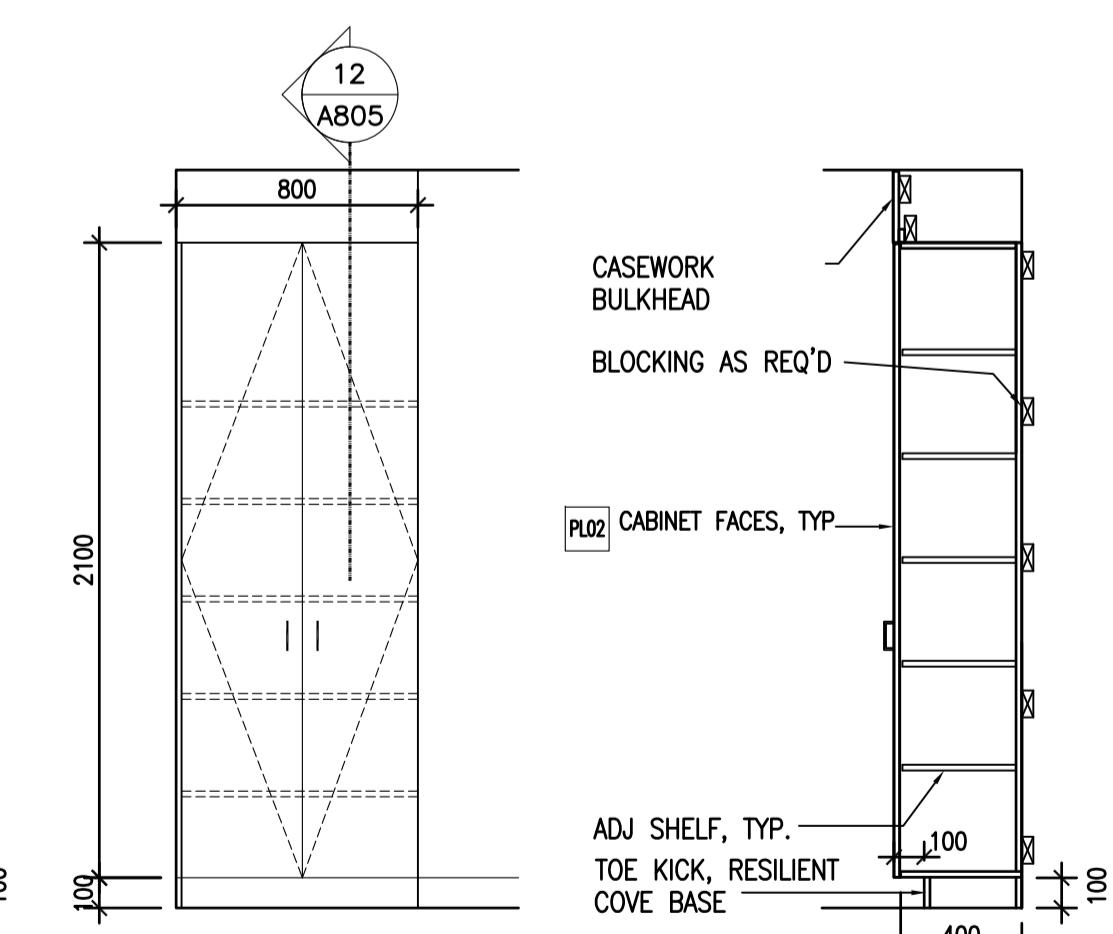

11 SECTION K
A805 1:25

- CASEWORK GENERAL NOTES:**
1. PROVIDE FILLER PANELS WHERE CABINETS OCCUR AGAINST WALLS AND ON INSIDE CORNERS, TO ALLOW FOR CABINET DOOR OR DRAWER OPENING WITHOUT INTERFERENCE, OR TO FILL GAPS IN AREAS AS SHOWN. TYPICAL.
 2. ALL UPPER CABINETS HAVE CASEWORK OR GYPSUM BULKHEADS AS INDICATED, TYPICAL.
 3. ALL CASEWORK BASE AND TALL CABINETS SHALL HAVE A 100mm TOE KICK, WITH RESILIENT COVE BASE APPLIED TO ALL EXPOSED BASE SURFACES, TYPICAL UNLESS OTHERWISE NOTED.
 4. THE UNIVERSAL SYMBOL OF ACCESSIBILITY INDICATES AN ACCESSIBLE WORK STATION, MAINTAIN A KNEE CLEARANCE OF 750 WIDE X 480 DEEP X 680 HIGH BEHIND COUNTER AND APRON AND BETWEEN SUPPORT BRACKETS.
 5. PROVIDE A FIXED PANEL SKIRT AT ALL SINKS.
 6. ALL CABINET DOORS AND DRAWERS TO BE PROVIDED WITH A LOCK. TYP.

Project title/Titre du projet
AGASSIZ, BRITISH COLUMBIA
4732 CEMETERY ROAD PO BOX 1600
MOUNTAIN INSTITUTE

MOUNTAIN INSTITUTE HEALTH CARE EXPANSION

Consultant Signature Only
EDWIN BERZINS
Designed by/Conception par
Drawn by/Dessiné par
NORMANN BAUMANN (2017-09-28)
PWGSC Project Manager/Administrateur de Projets TPSGC
TONY TANG
Regional Manager, Architectural and Engineering Services
Gestionnaire régionale, Services d'architecture et de génie, TPSGC
PREETPAL PAUL

Drawing title/Titre du dessin
CASEWORK DETAILS 2

Project No./No. du
projet
R.077724.001
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Revision no./
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0
OF 6



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<i>revision/</i> <i>revision</i>	Description/Description	Date/Date

CORRECTIONAL SERVICE OF CANADA

Project title/Titre du projet
AGASSIZ, BRITISH COLUMBIA
4732 CEMETERY ROAD PO BOX 1600
MOUNTAIN INSTITUTE

MOUNTAIN INSTITUTE HEALTH CARE EXPANSION

CASEWORK GENERAL NOTES:

1. PROVIDE FILLER PANELS WHERE CABINETS OCCUR AGAINST WALLS AND ON INSIDE CORNERS, TO ALLOW FOR CABINET DOOR OR DRAWER OPENING WITHOUT INTERFERENCE; OR TO FILL GAPS IN AREAS AS SHOWN. TYPICAL.
2. ALL UPPER CABINETS HAVE CASEWORK OR GYPSUM BULKHEADS AS INDICATED. TYPICAL.
3. ALL CASEWORK BASE AND TALL CABINETS SHALL HAVE A 100mm TOE KICK, WITH RESILIENT COVE BASE APPLIED TO ALL EXPOSED BASE SURFACES. TYPICAL UNLESS OTHERWISE NOTED
4. THE UNIVERSAL SYMBOL OF ACCESSIBILITY INDICATES AN ACCESSIBLE WORK STATION, MAINTAIN A KNEE CLEARANCE OF 750 WIDE X 480 DEEP X 680 HIGH BEHIND COUNTER AND APRON AND BETWEEN SUPPORT BRACKETS.

5. PROVIDE A FIXED PANEL SKIRT AT ALL SINKS.
6. ALL CABINET DOORS AND DRAWERS TO BE PROVIDED WITH A LOCK. TYP.


ON DRAWER OPENING WIDTH INTERFERENCE; OR TO FILL GAPS IN AREAS AS SHOWN. TYPICAL.	Consultant Signature Only
2. ALL UPPER CABINETS HAVE CASEWORK OR GYPSUM BULKHEADS AS INDICATED. TYPICAL.	Designed by/Concept par EDWIN BERZINS
3. ALL CASEWORK BASE AND TALL CABINETS SHALL HAVE A 100mm TOE KICK, WITH RESILIENT COVE BASE APPLIED TO ALL EXPOSED BASE SURFACES. TYPICAL UNLESS OTHERWISE NOTED.	Drawn by/Dessine par NORMANN BAUMANN (2017-09-28)
	PWGSC Project Manager/Administrateur de Projets TPSGC TONY TANG




- 4. THE UNIVERSAL SYMBOL OF
ACCESSIBILITY INDICATES AN ACCESSIBLE
WORK STATION, MAINTAIN A KNEE
CLEARANCE OF 750 WIDE X 480 DEEP X
680 HIGH BENEATH COUNTER AND
APRON AND BETWEEN SUPPORT
BRACKETS.**
- 5. PROVIDE A FIXED PANEL SKIRT AT ALL
SINKS.**
- 6. ALL CABINET DOORS AND DRAWERS TO
BE PROVIDED WITH A LOCK, TYP.**

CASEWORK DETAILS 3


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R.077724.001	A806 OF 6	0

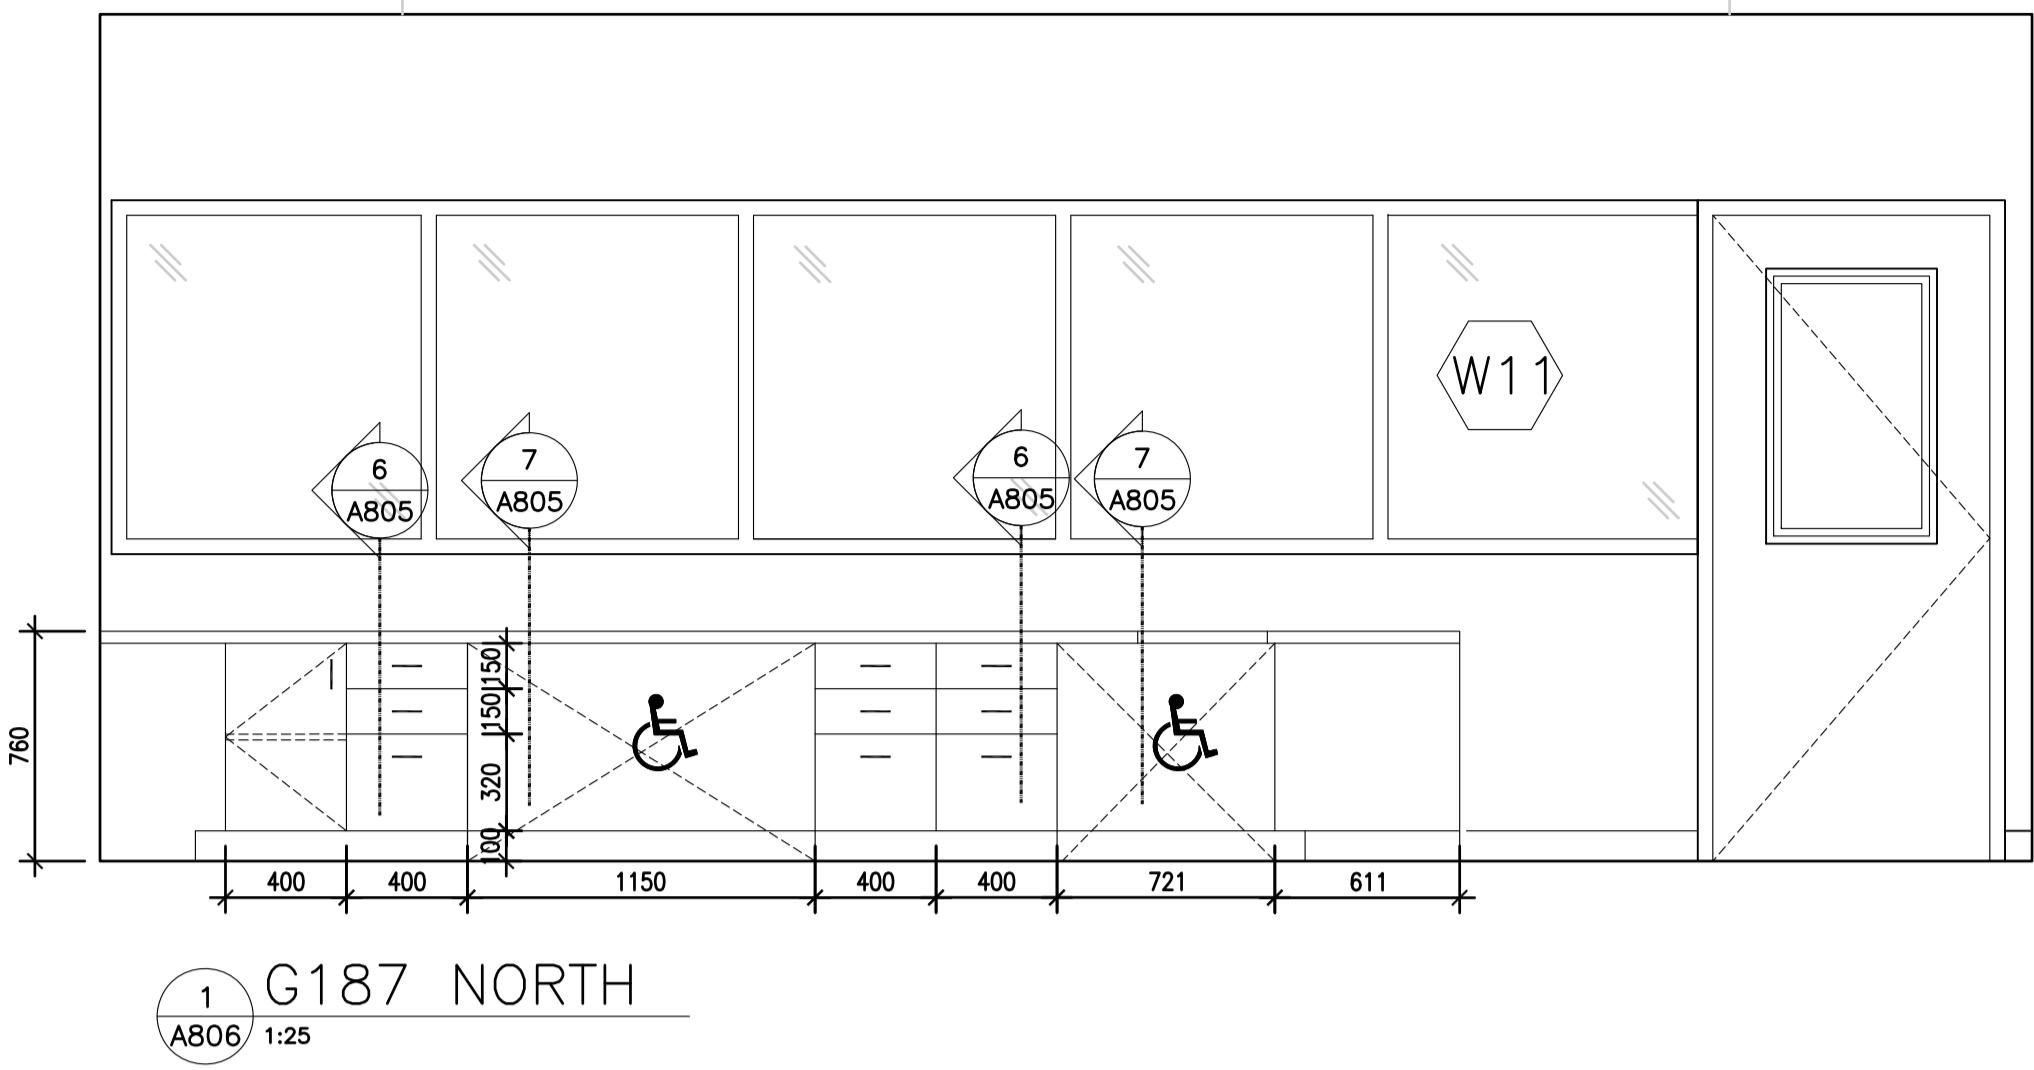


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A806 1:25

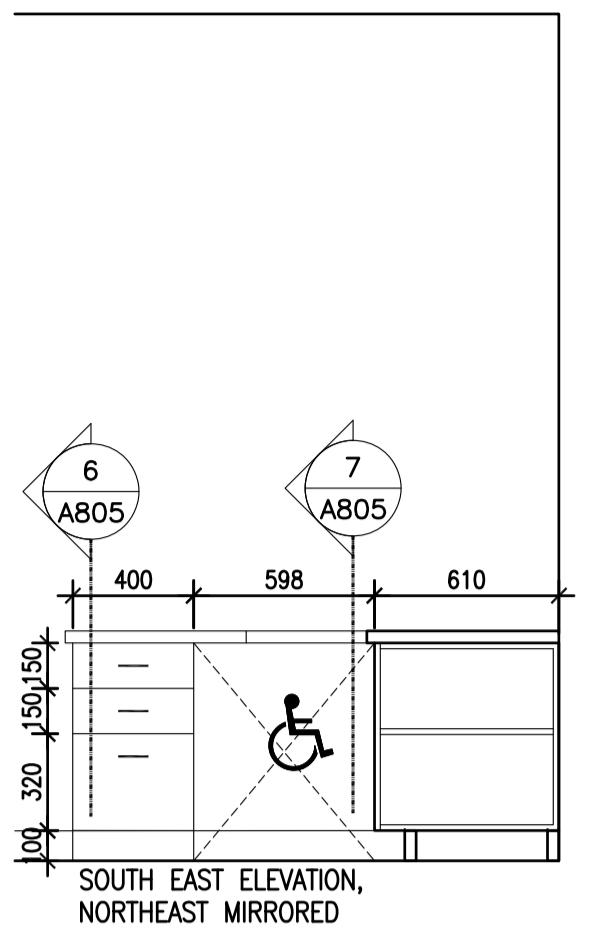


2 G187 PART. EAST
A806 1:25

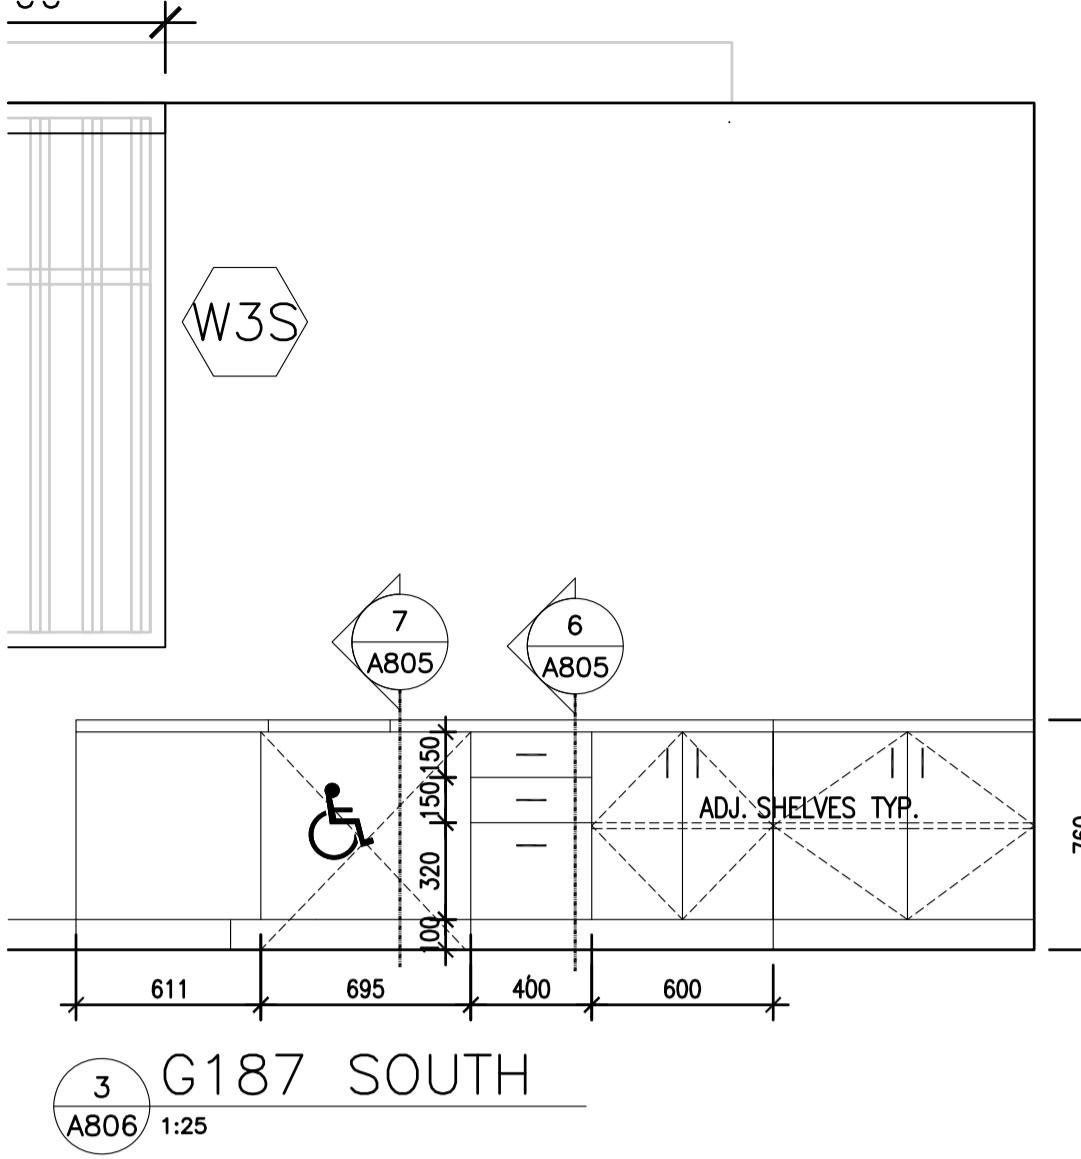


G187 SOUTH

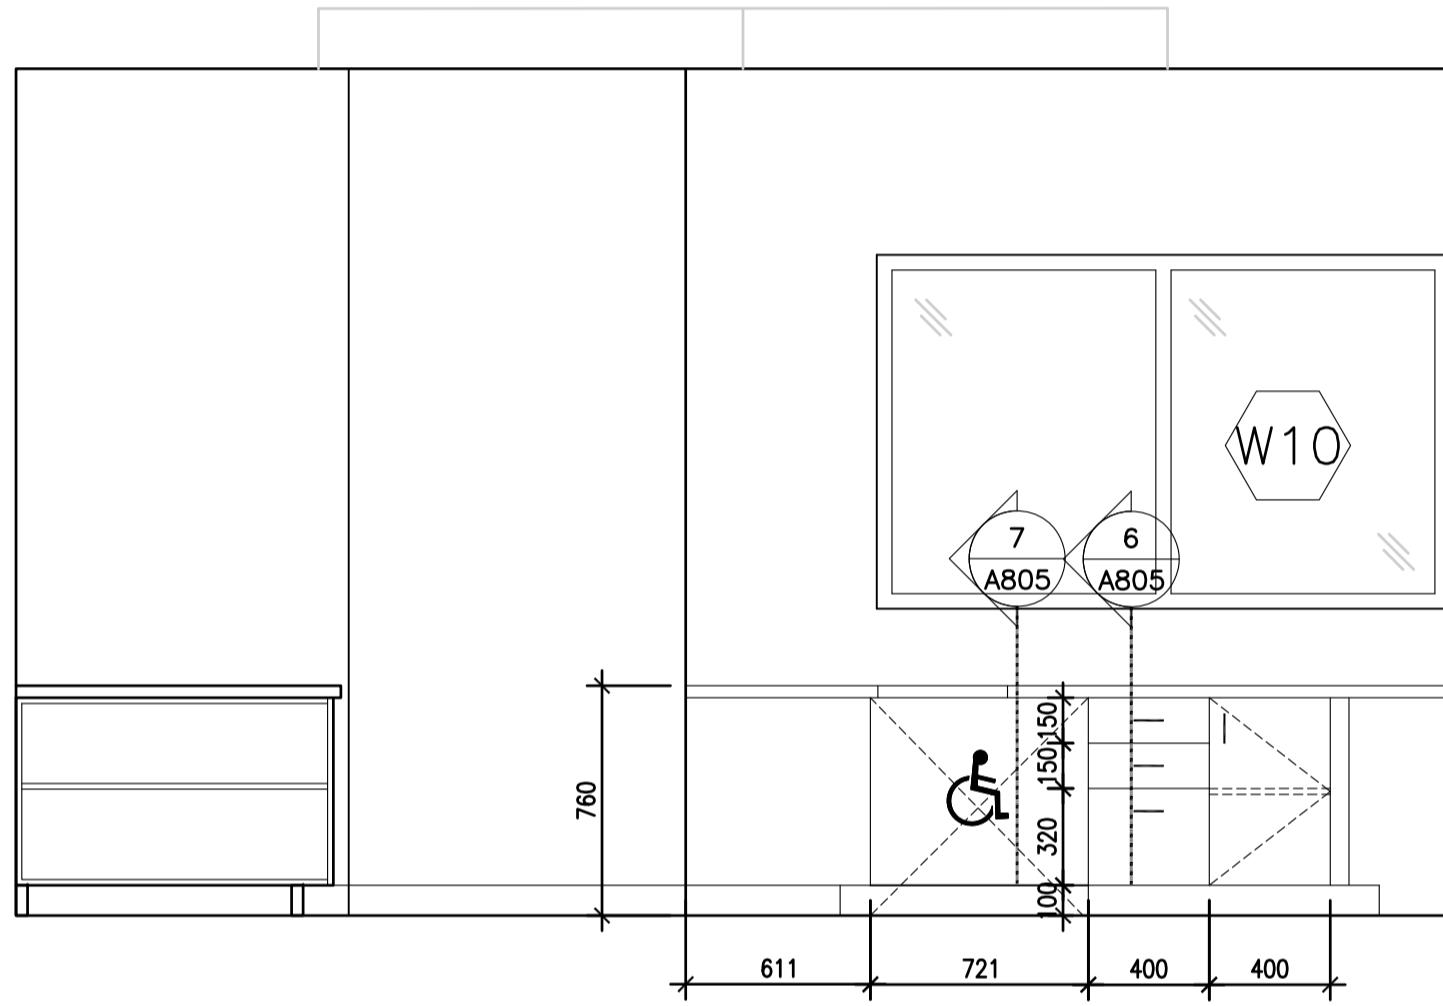

G187 WEST
A806 1:25

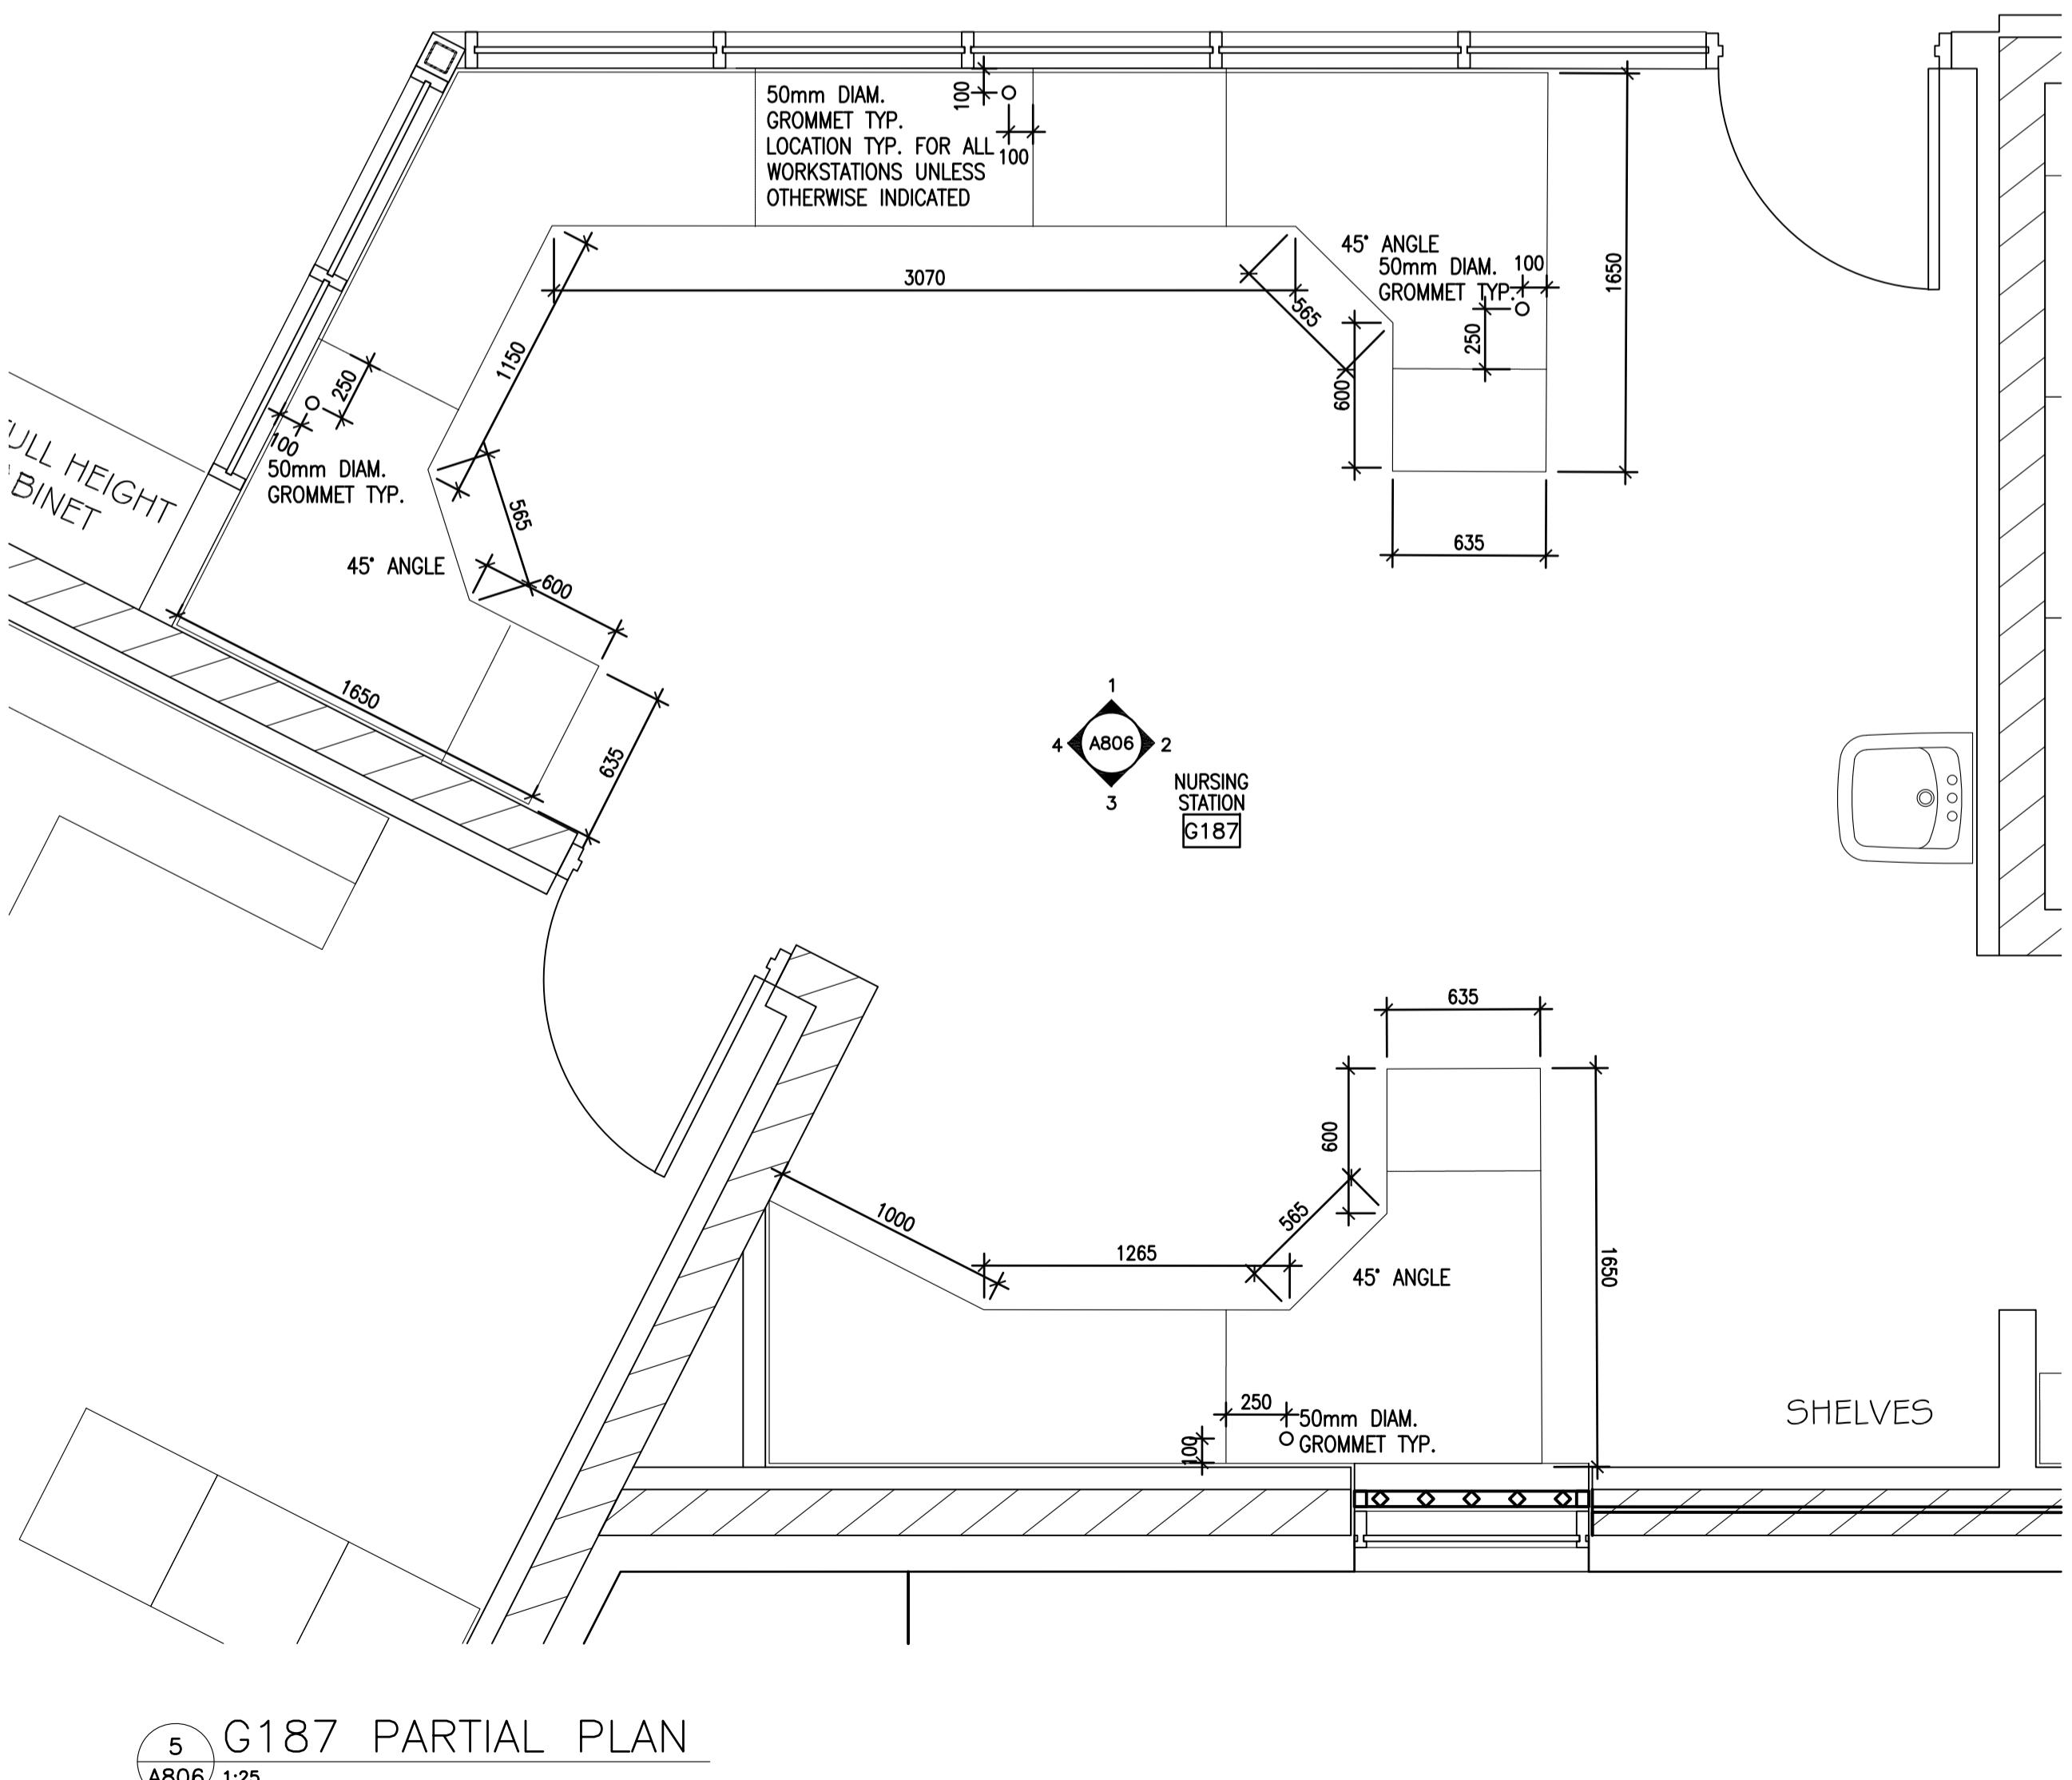

5 G187 PARTIAL PLAN
A806 1:25

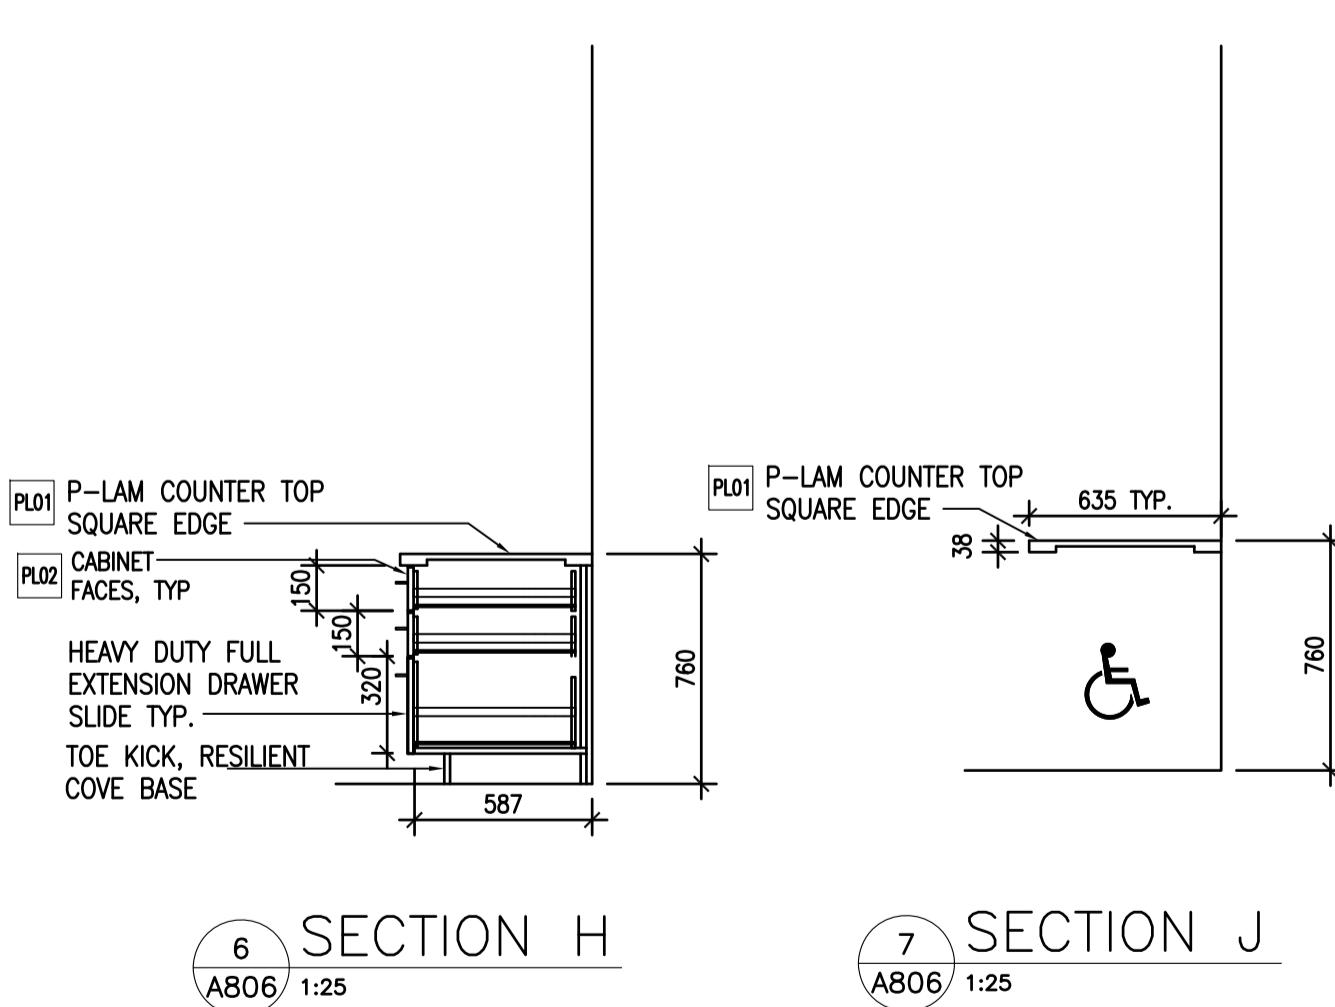



SECTION H
6
A806 1:25





**NOTE: CONTRACTOR IS RESPONSIBLE FOR THE
RELOCATION AND INSTALLATION OF THE EXISTING
FURNITURE AS INDICATED.**

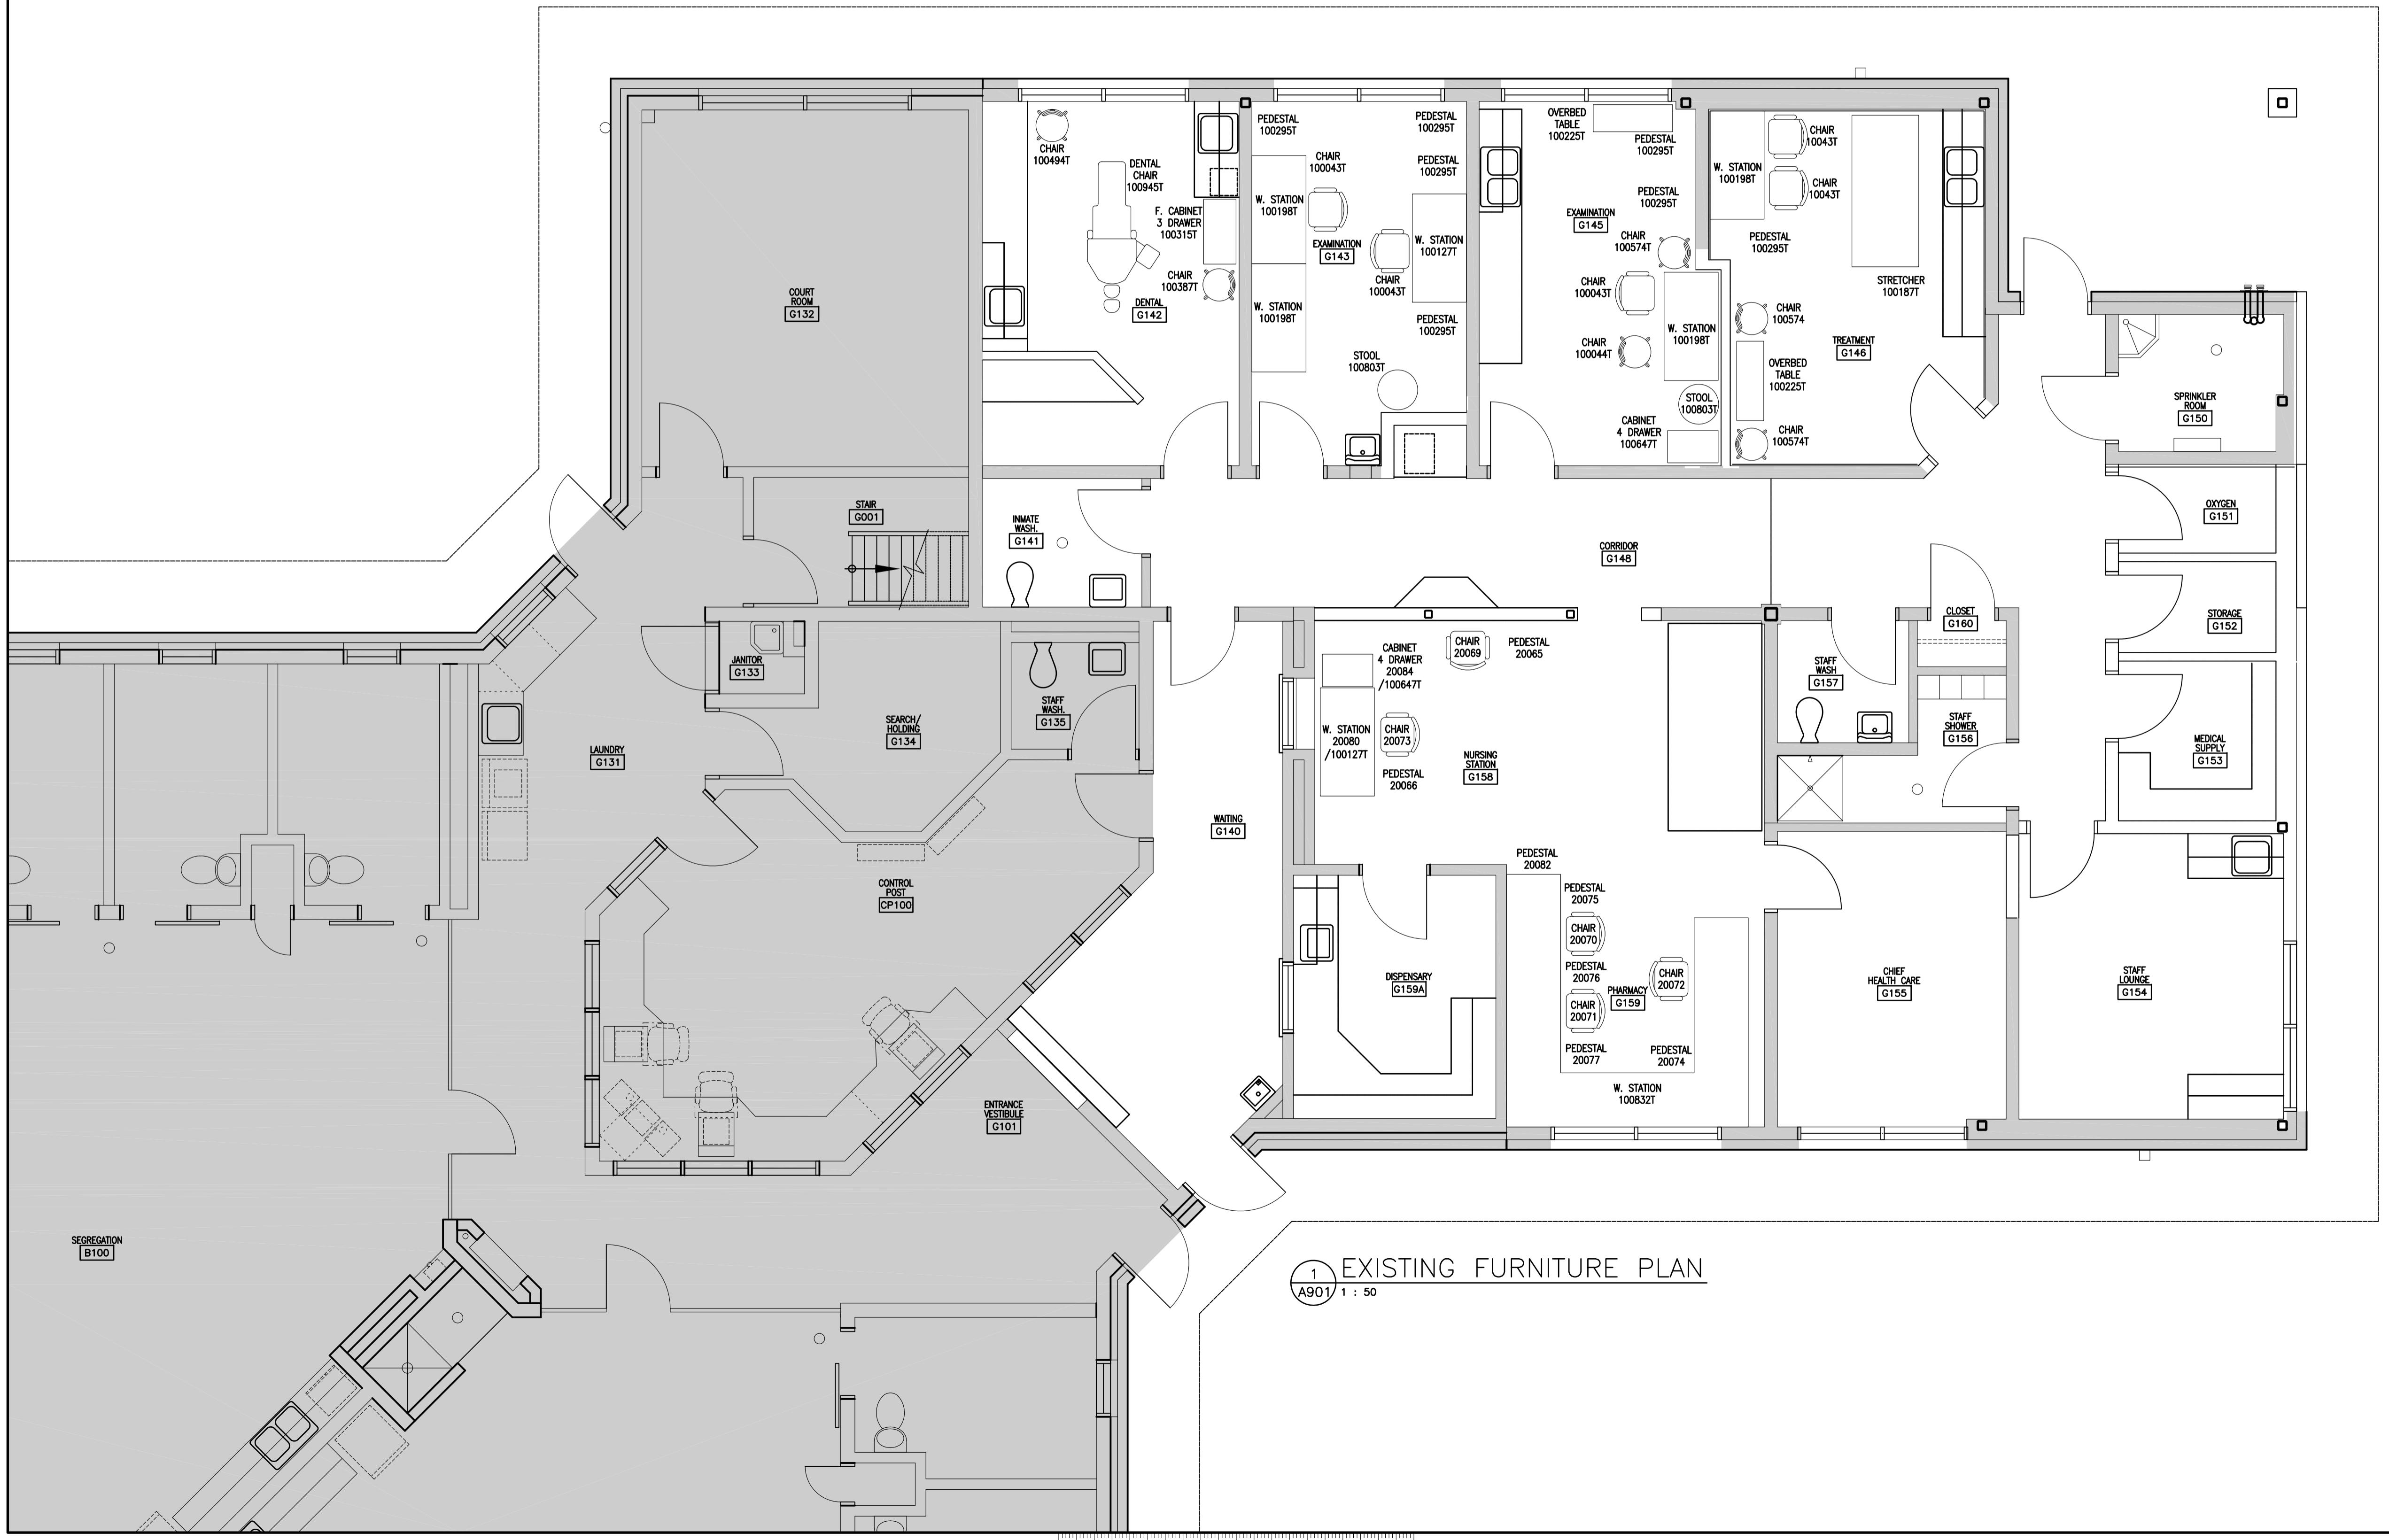

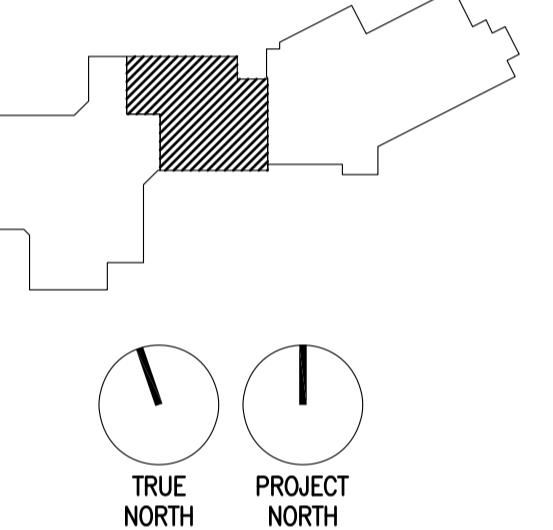

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CORRECTIONAL SERVICE OF CANADA

Project Title/Titre du projet
AGASSIZ, BRITISH COLUMBIA
4732 CEMETERY ROAD PO BOX 1600
MOUNTAIN INSTITUTE

MOUNTAIN INSTITUTE HEALTH CARE EXPANSION


Consultant Signature Only
Designed by/Concept par
EDWIN BERZINS
Drawn by/Dessin par
MING HSU
PWGSC Project Manager/Administrateur de Projets TPSGC
TONY TANG
Regional Manager, Architectural and Engineering Services
Gestionnaire régionale, Services d'architectural et de génie, TPSGC
PREETPAL PAUL

Drawing title/Titre du dessin

PHASE 2 FURNITURE PLAN


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R.077724.001	A903	0
OF 6		

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RELOCATION AND INSTALLATION OF THE EXISTING
FURNITURE INDICATED.

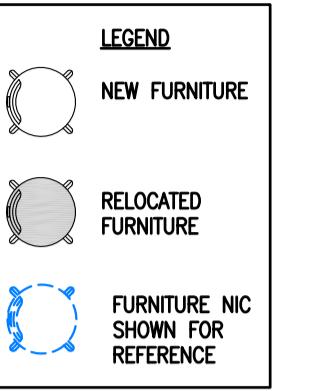



FURNITURE NOTES:

- CONTRACTOR TO PROVIDE ANY FINE-TUNING AND ADJUSTMENTS TO THE FURNITURE LAYOUT AND BUILDING SYSTEMS THAT ARE IDENTIFIED DURING THE MOVE-IN AND FOR FIVE (5) WORKING DAYS FOLLOWING THE COMPLETION OF MOVE-IN.
- SEE ELECTRICAL FOR ADDITIONAL NOTES.
- PROVIDE BACKING FOR ALL CORR BOARDS, WHITE BOARDS.
- PROVIDE BLOCKING FOR ALL CEILING / WALL MOUNTED EQUIPMENT / ACCESSORIES & CABINETS.
- ALL SHELVING UNITS / MILLWORK OVER 4'-0" (1200mm) IN HEIGHT SHALL BE SEISMICALLY BRACED TO WALLS.

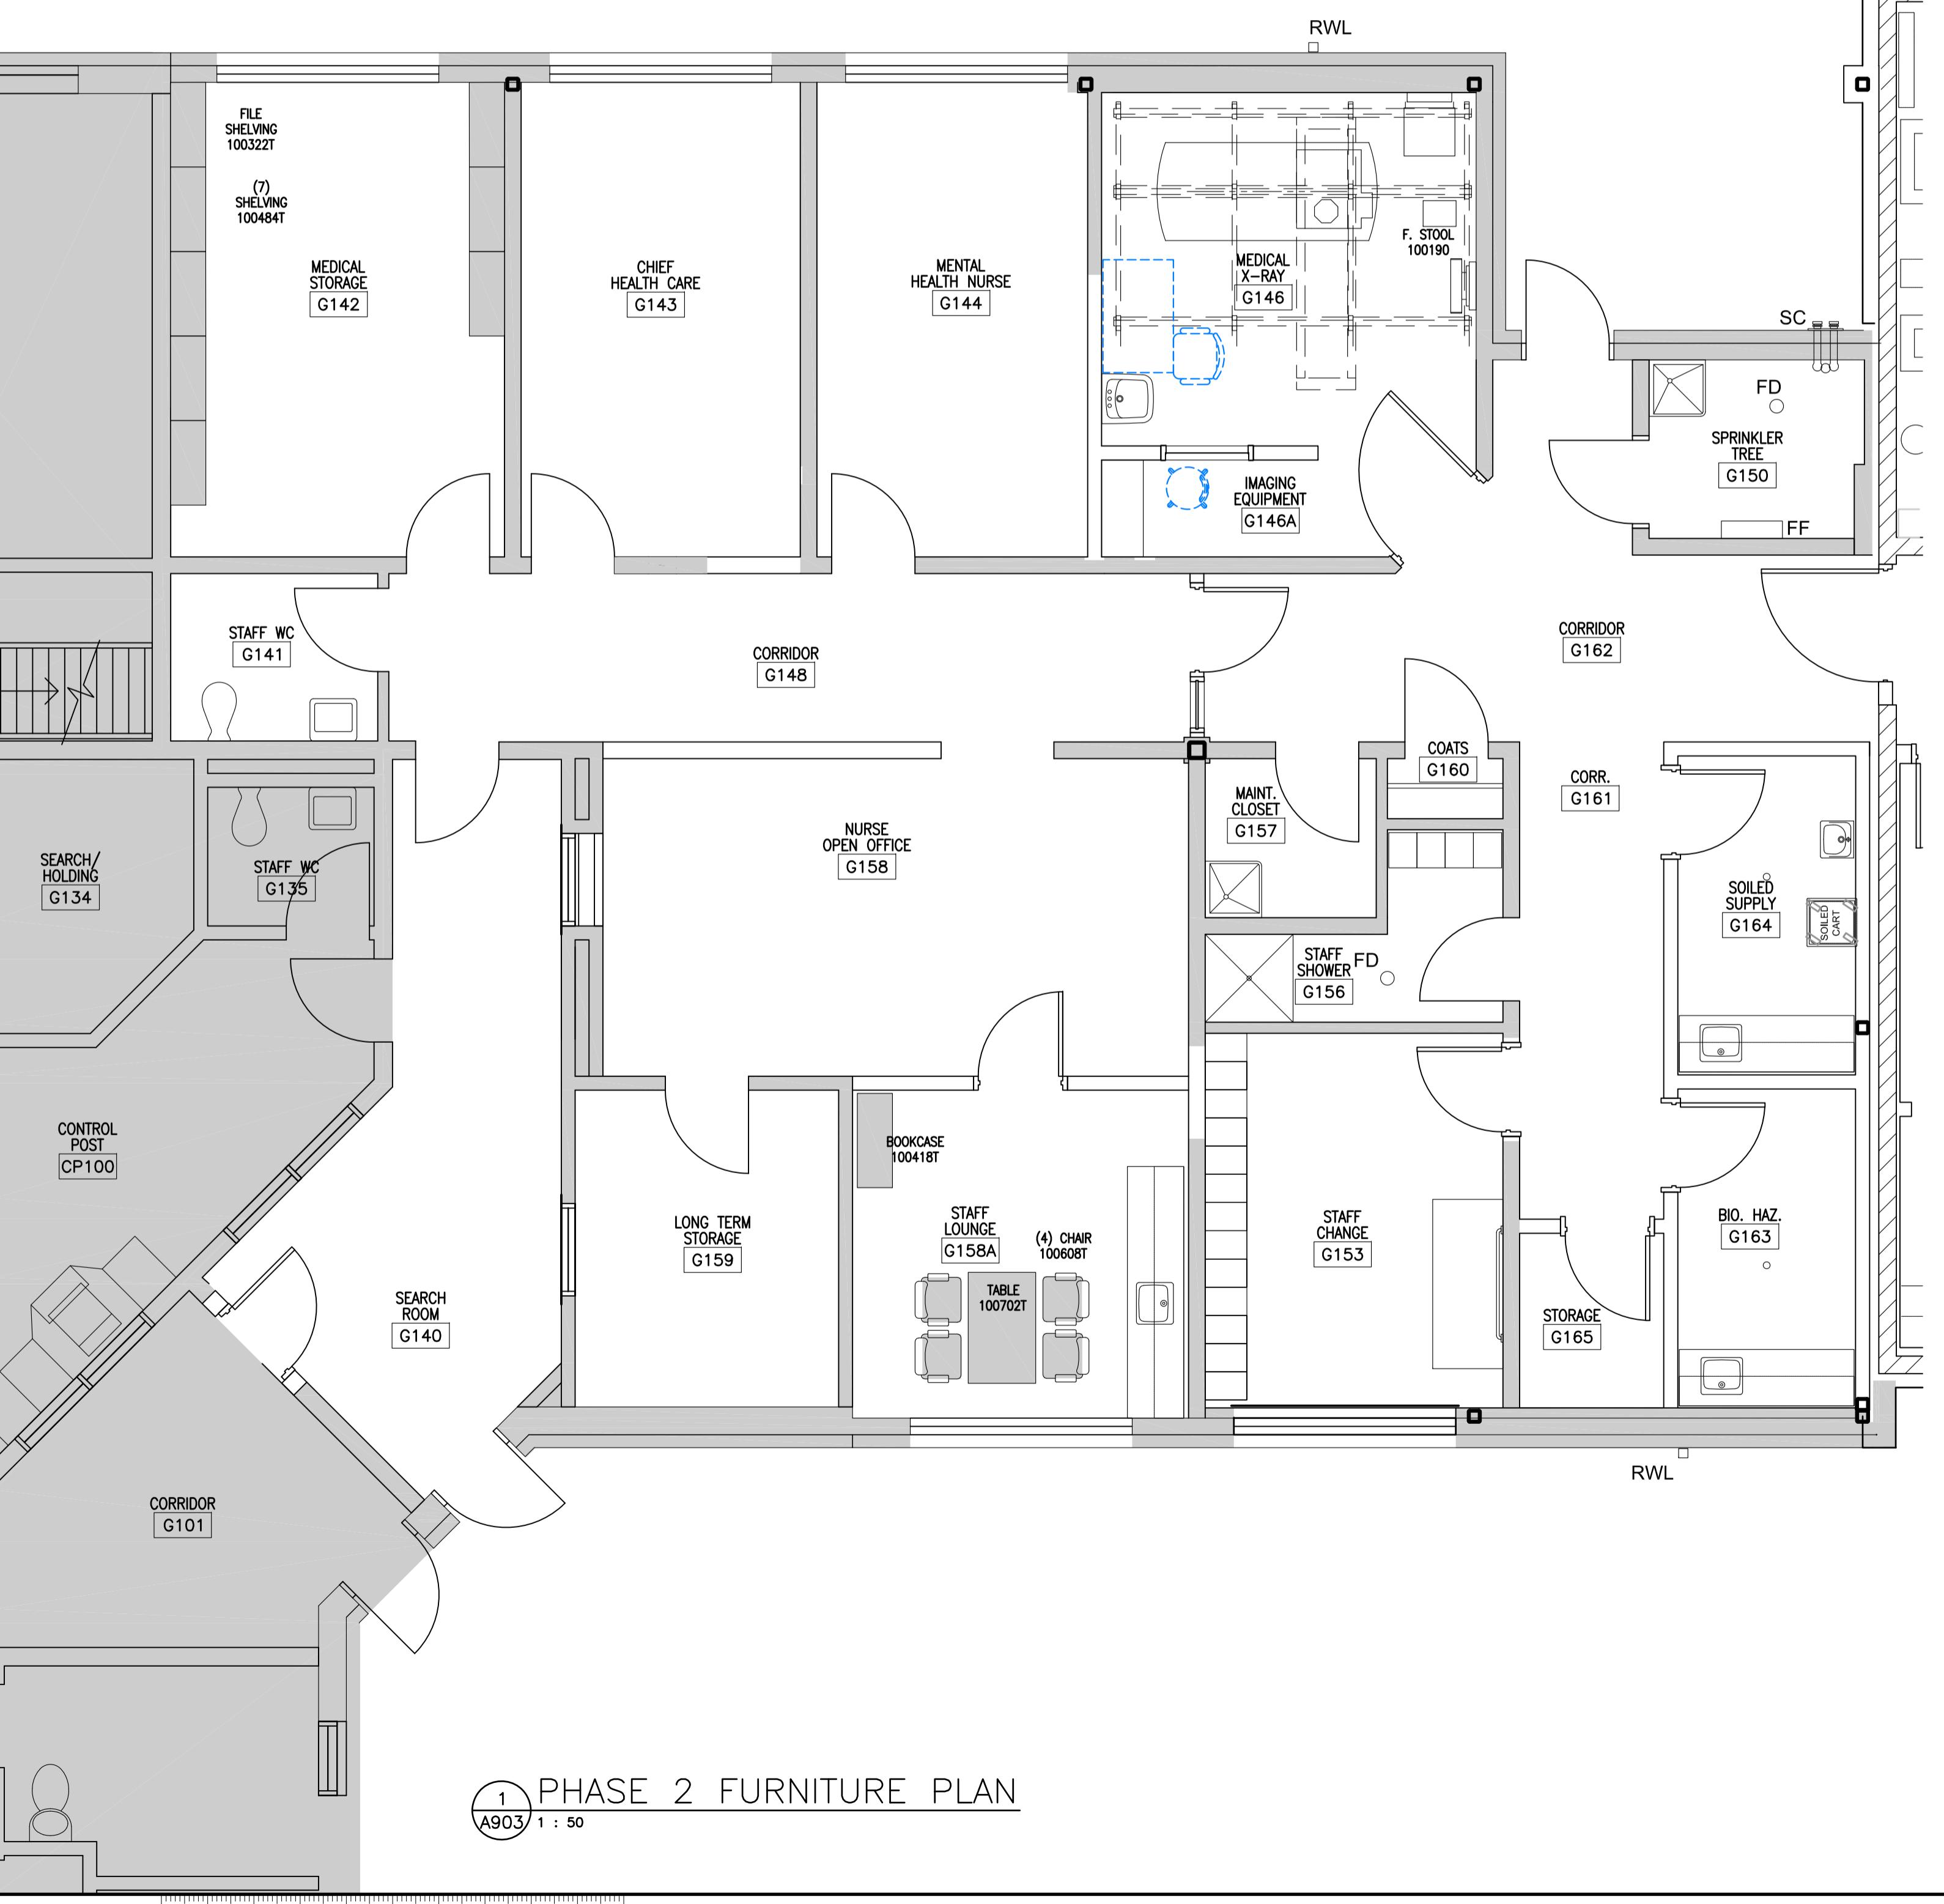



NOTE: CONTRACTOR IS RESPONSIBLE FOR THE
RELOCATION AND INSTALLATION OF THE EXISTING
FURNITURE INDICATED.

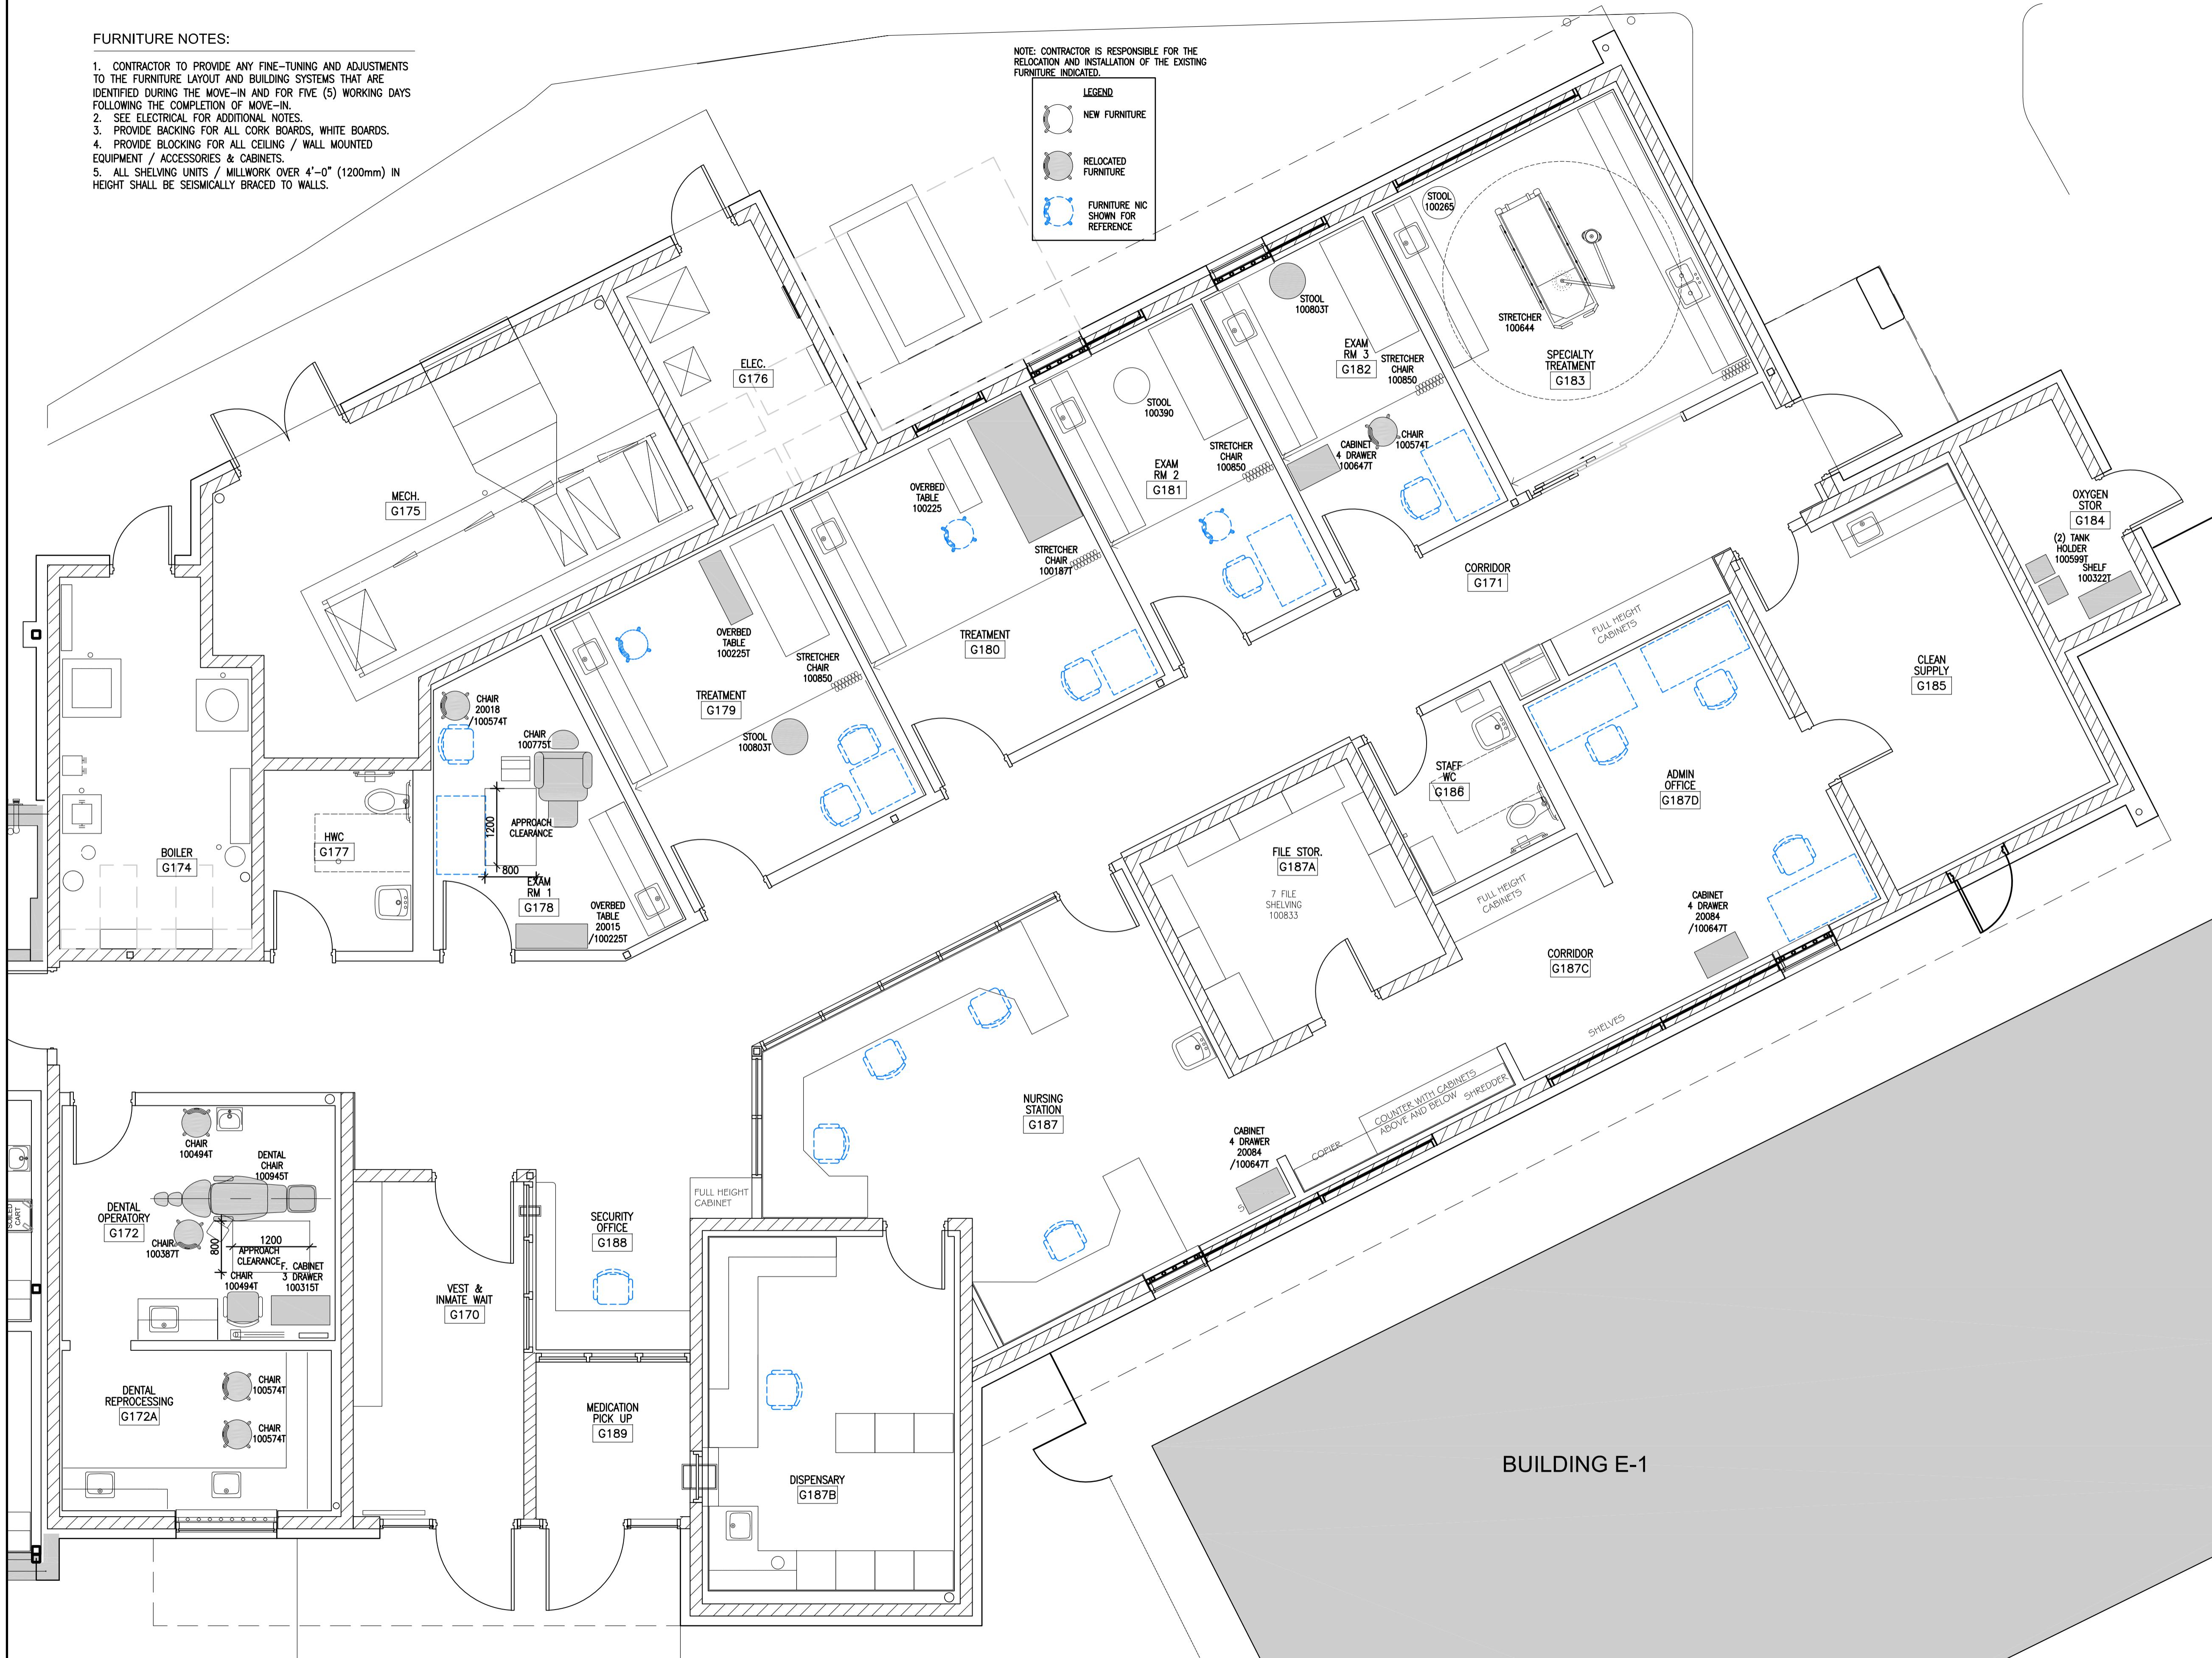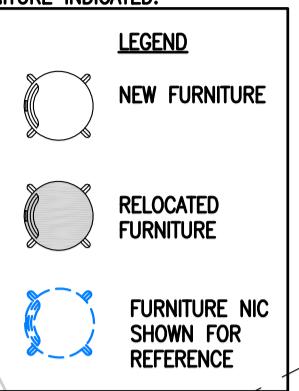

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	Revision/Revision Description/Description Date/Date
	Client/Client

CORRECTIONAL SERVICE OF CANADA

Project title/Titre du projet AGASSIZ, BRITISH COLUMBIA
4732 CEMETERY ROAD PO BOX 1600
MOUNTAIN INSTITUTE

MOUNTAIN INSTITUTE HEALTH CARE EXPANSION


Consultant Signature Only
Designed by/Concept par EDWIN BERZINS
Drawn by/Dessiné par MING HSU
PWGSC Project Manager/Administrateur de Projets TPSGC
TONY TANG
Regional Manager, Architectural and Engineering Services
Gestionnaire régionale, Services d'architectural et de génie, TPSGC
PREETPAL PAUL
Drawing title/Titre du dessin

PHASE 1 FURNITURE PLAN

Project No./No. du projet	Sheet/Feuille	Revision no./ Révision no.
R.077724.001	A902	0



NOTE: CONTRACTOR IS RESPONSIBLE FOR THE
 RELOCATION AND INSTALLATION OF THE EXISTING
 EQUIPMENT AS INDICATED AND FOR THE
 ACQUISITION AND INSTALLATION OF THE NEW
 EQUIPMENT. SEE SPECIFICATION 12-50-00

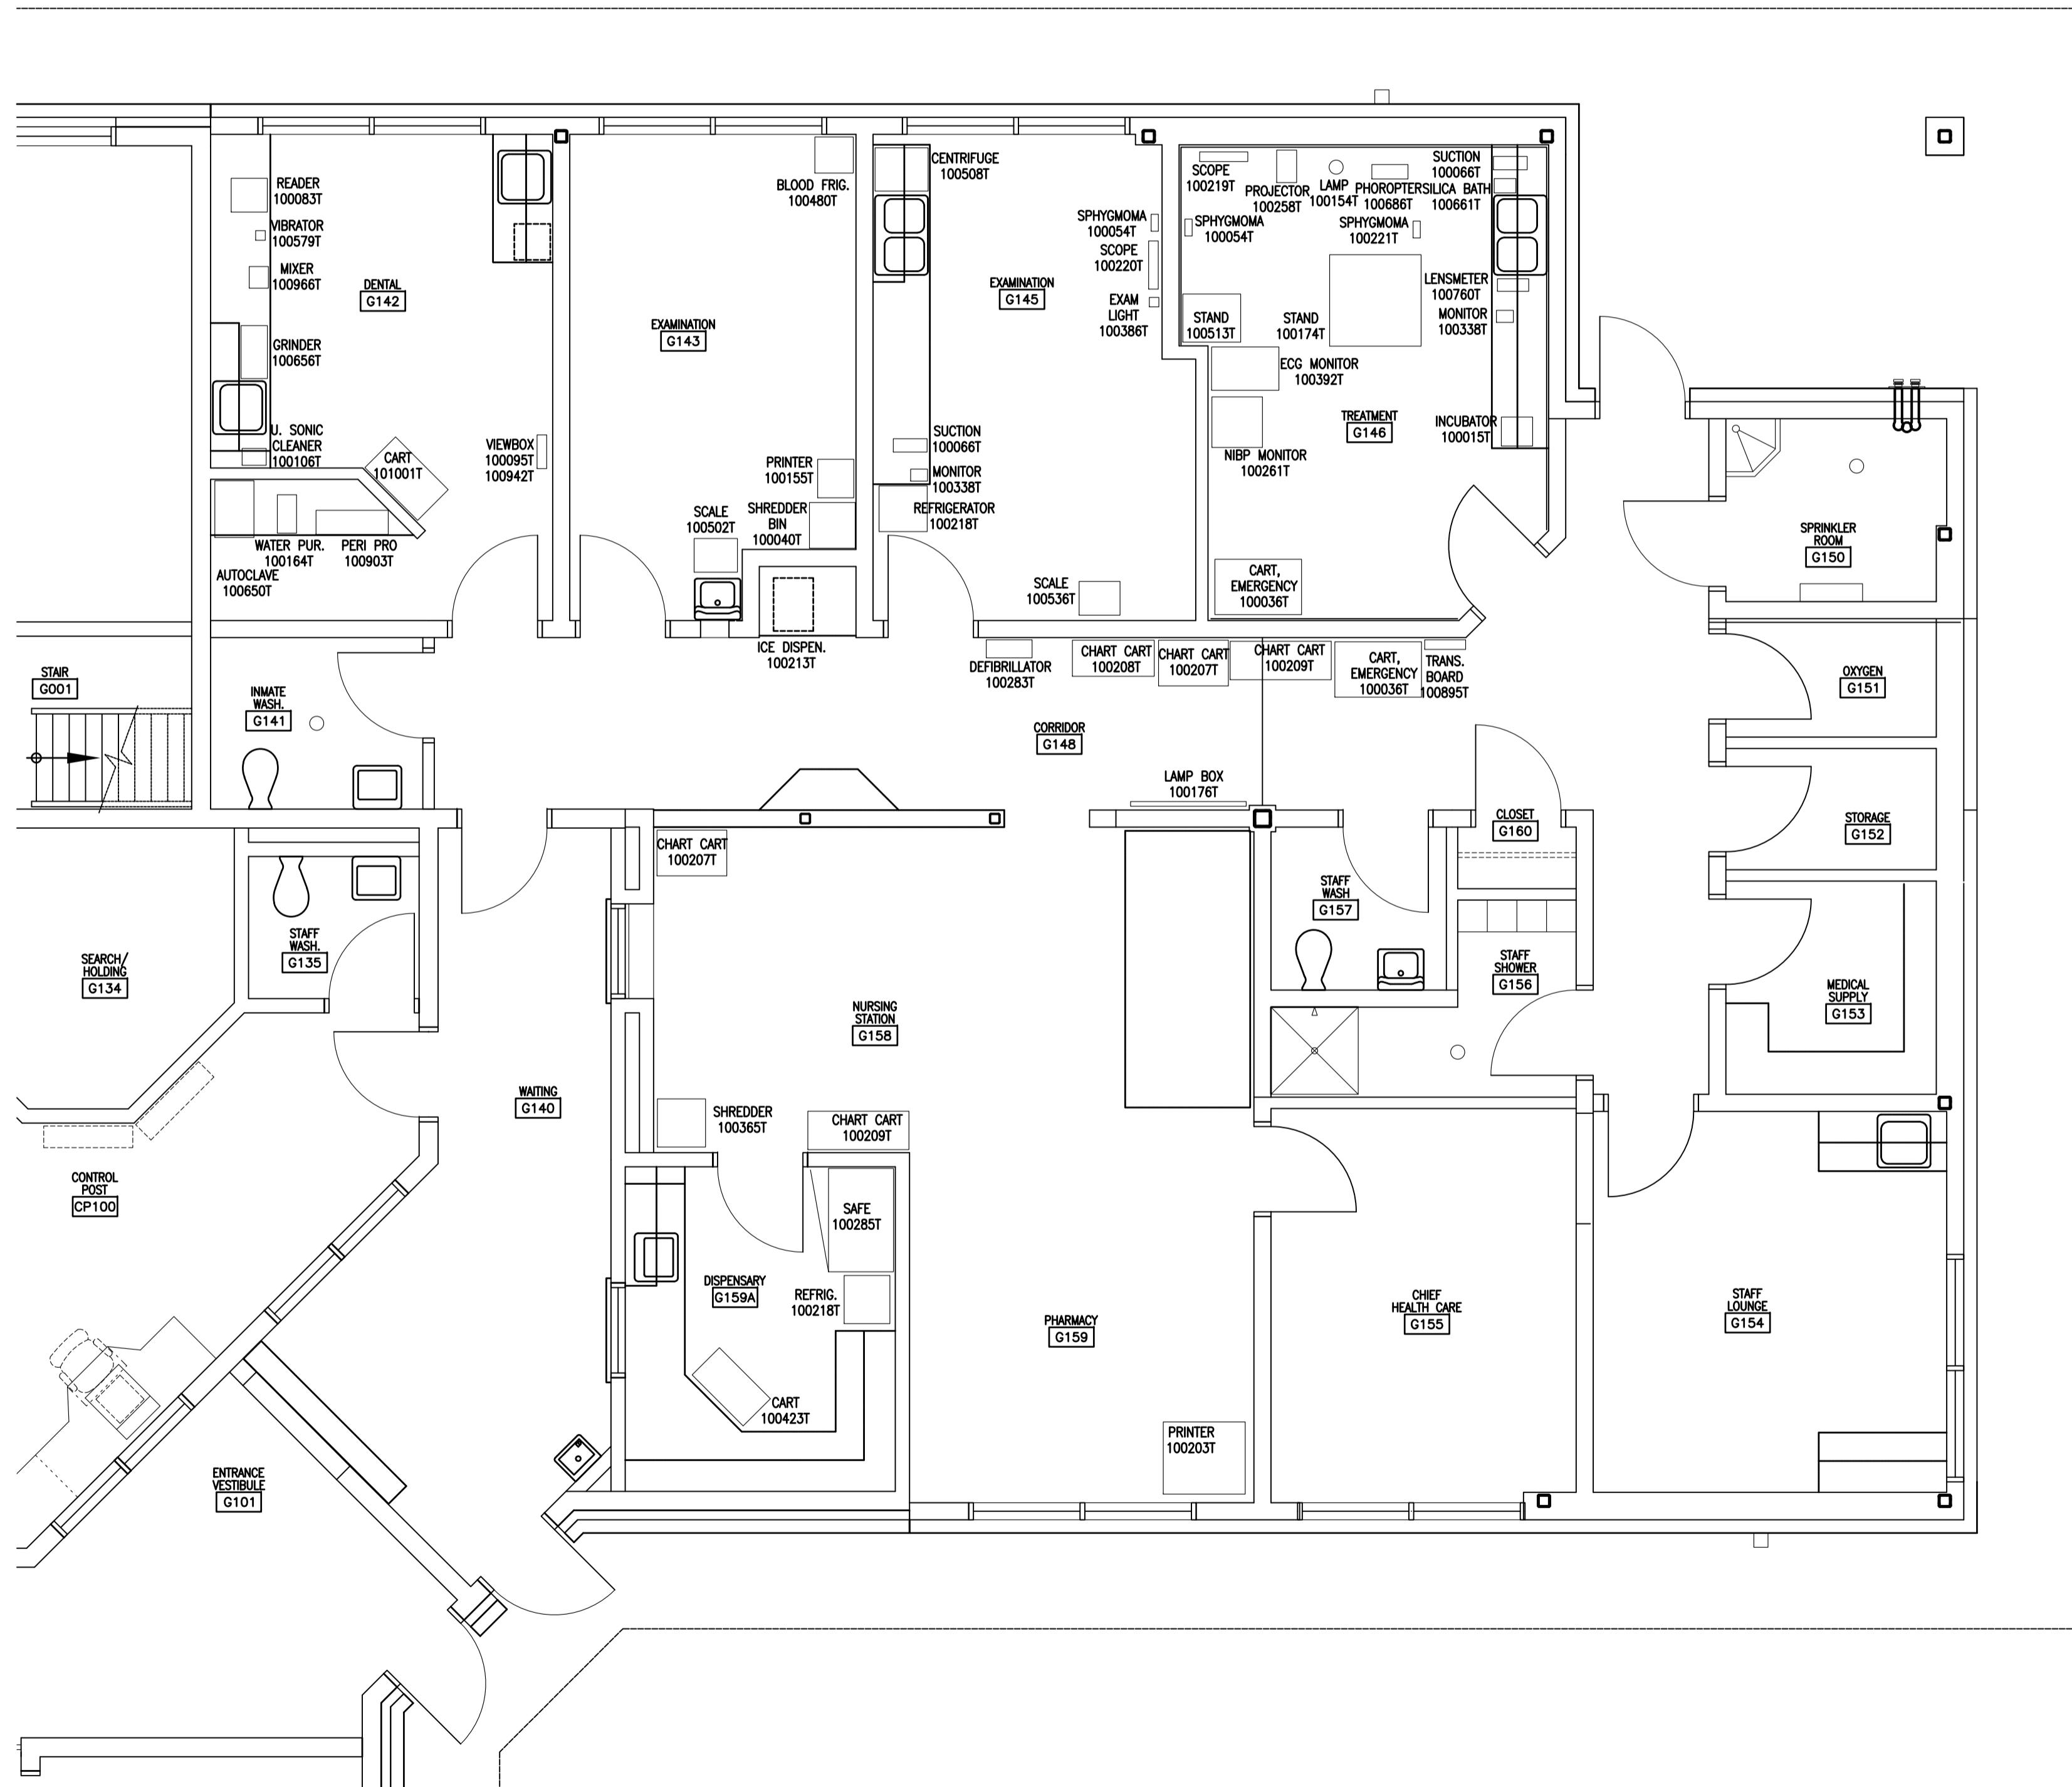

1 EXISTING EQUIPMENT PLAN
A904 1 : 50

CORRECTIONAL SERVICE OF CANADA

Project Title/Titre du projet
AGASSIZ, BRITISH COLUMBIA
4732 CEMETERY ROAD PO BOX 1600
MOUNTAIN INSTITUTE

**MOUNTAIN INSTITUTE
HEALTH CARE EXPANSION**

Consultant Signature Only
Designed by/Concept par
EDWIN BERZINS
Drawn by/Desiné par
BEN MONROE / MING HSU
PWGSC Project Manager/Administrateur de Projets TPSGC
TONY TANG
Regional Manager, Architectural and Engineering Services
Gestionnaire régionale, Services d'architectural et de génie, TPSGC
PREETPAL PAUL
Drawing title/Titre du dessin

EXISTING EQUIPMENT PLAN

Project No./No. du projet R.077724.001	Sheet/Feuille A904	Revision no./ La Révision no. 0
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The diagram consists of two main parts. On the left, there is a stepped boundary represented by a series of vertical lines connected by horizontal segments, forming a staircase-like pattern. On the right, there is a polygon with a diagonal hatching pattern. The polygon is bounded by several lines: a vertical line on the far right, a line sloping down to the right, a horizontal line connecting the end of the slope to the end of the staircase, a vertical line connecting the start of the slope to the start of the staircase, and a horizontal line connecting the start of the staircase to the left edge of the diagram.

CORRECTIONAL SERVICE OF CANADA

title/Titre du projet
AGASSIZ, BRITISH COLUMBIA
732 CEMETERY ROAD PO BOX 1600
MOUNTAIN INSTITUTE

MOUNTAIN INSTITUTE HEALTH CARE EXPANSION

ant Signature Only

d by/Concept par
BERZINS

bby/Dessine par
ONROE \ MING HSU

Project Manager/Administrateur de Projets TPSGC
TANG


Manager, Architectural and Engineering Services
L'Administrateur des services architecturaux et d'ingénierie, TPSGC

BUILDING E-1

SE 1 EQUIPMENT PLAN

No./No. du	Sheet/Feuille	Revision no. La Révision no.
7724.001	A905	0

1 PHASE 1 EQUIPMENT PLAN
A905 1 : 50

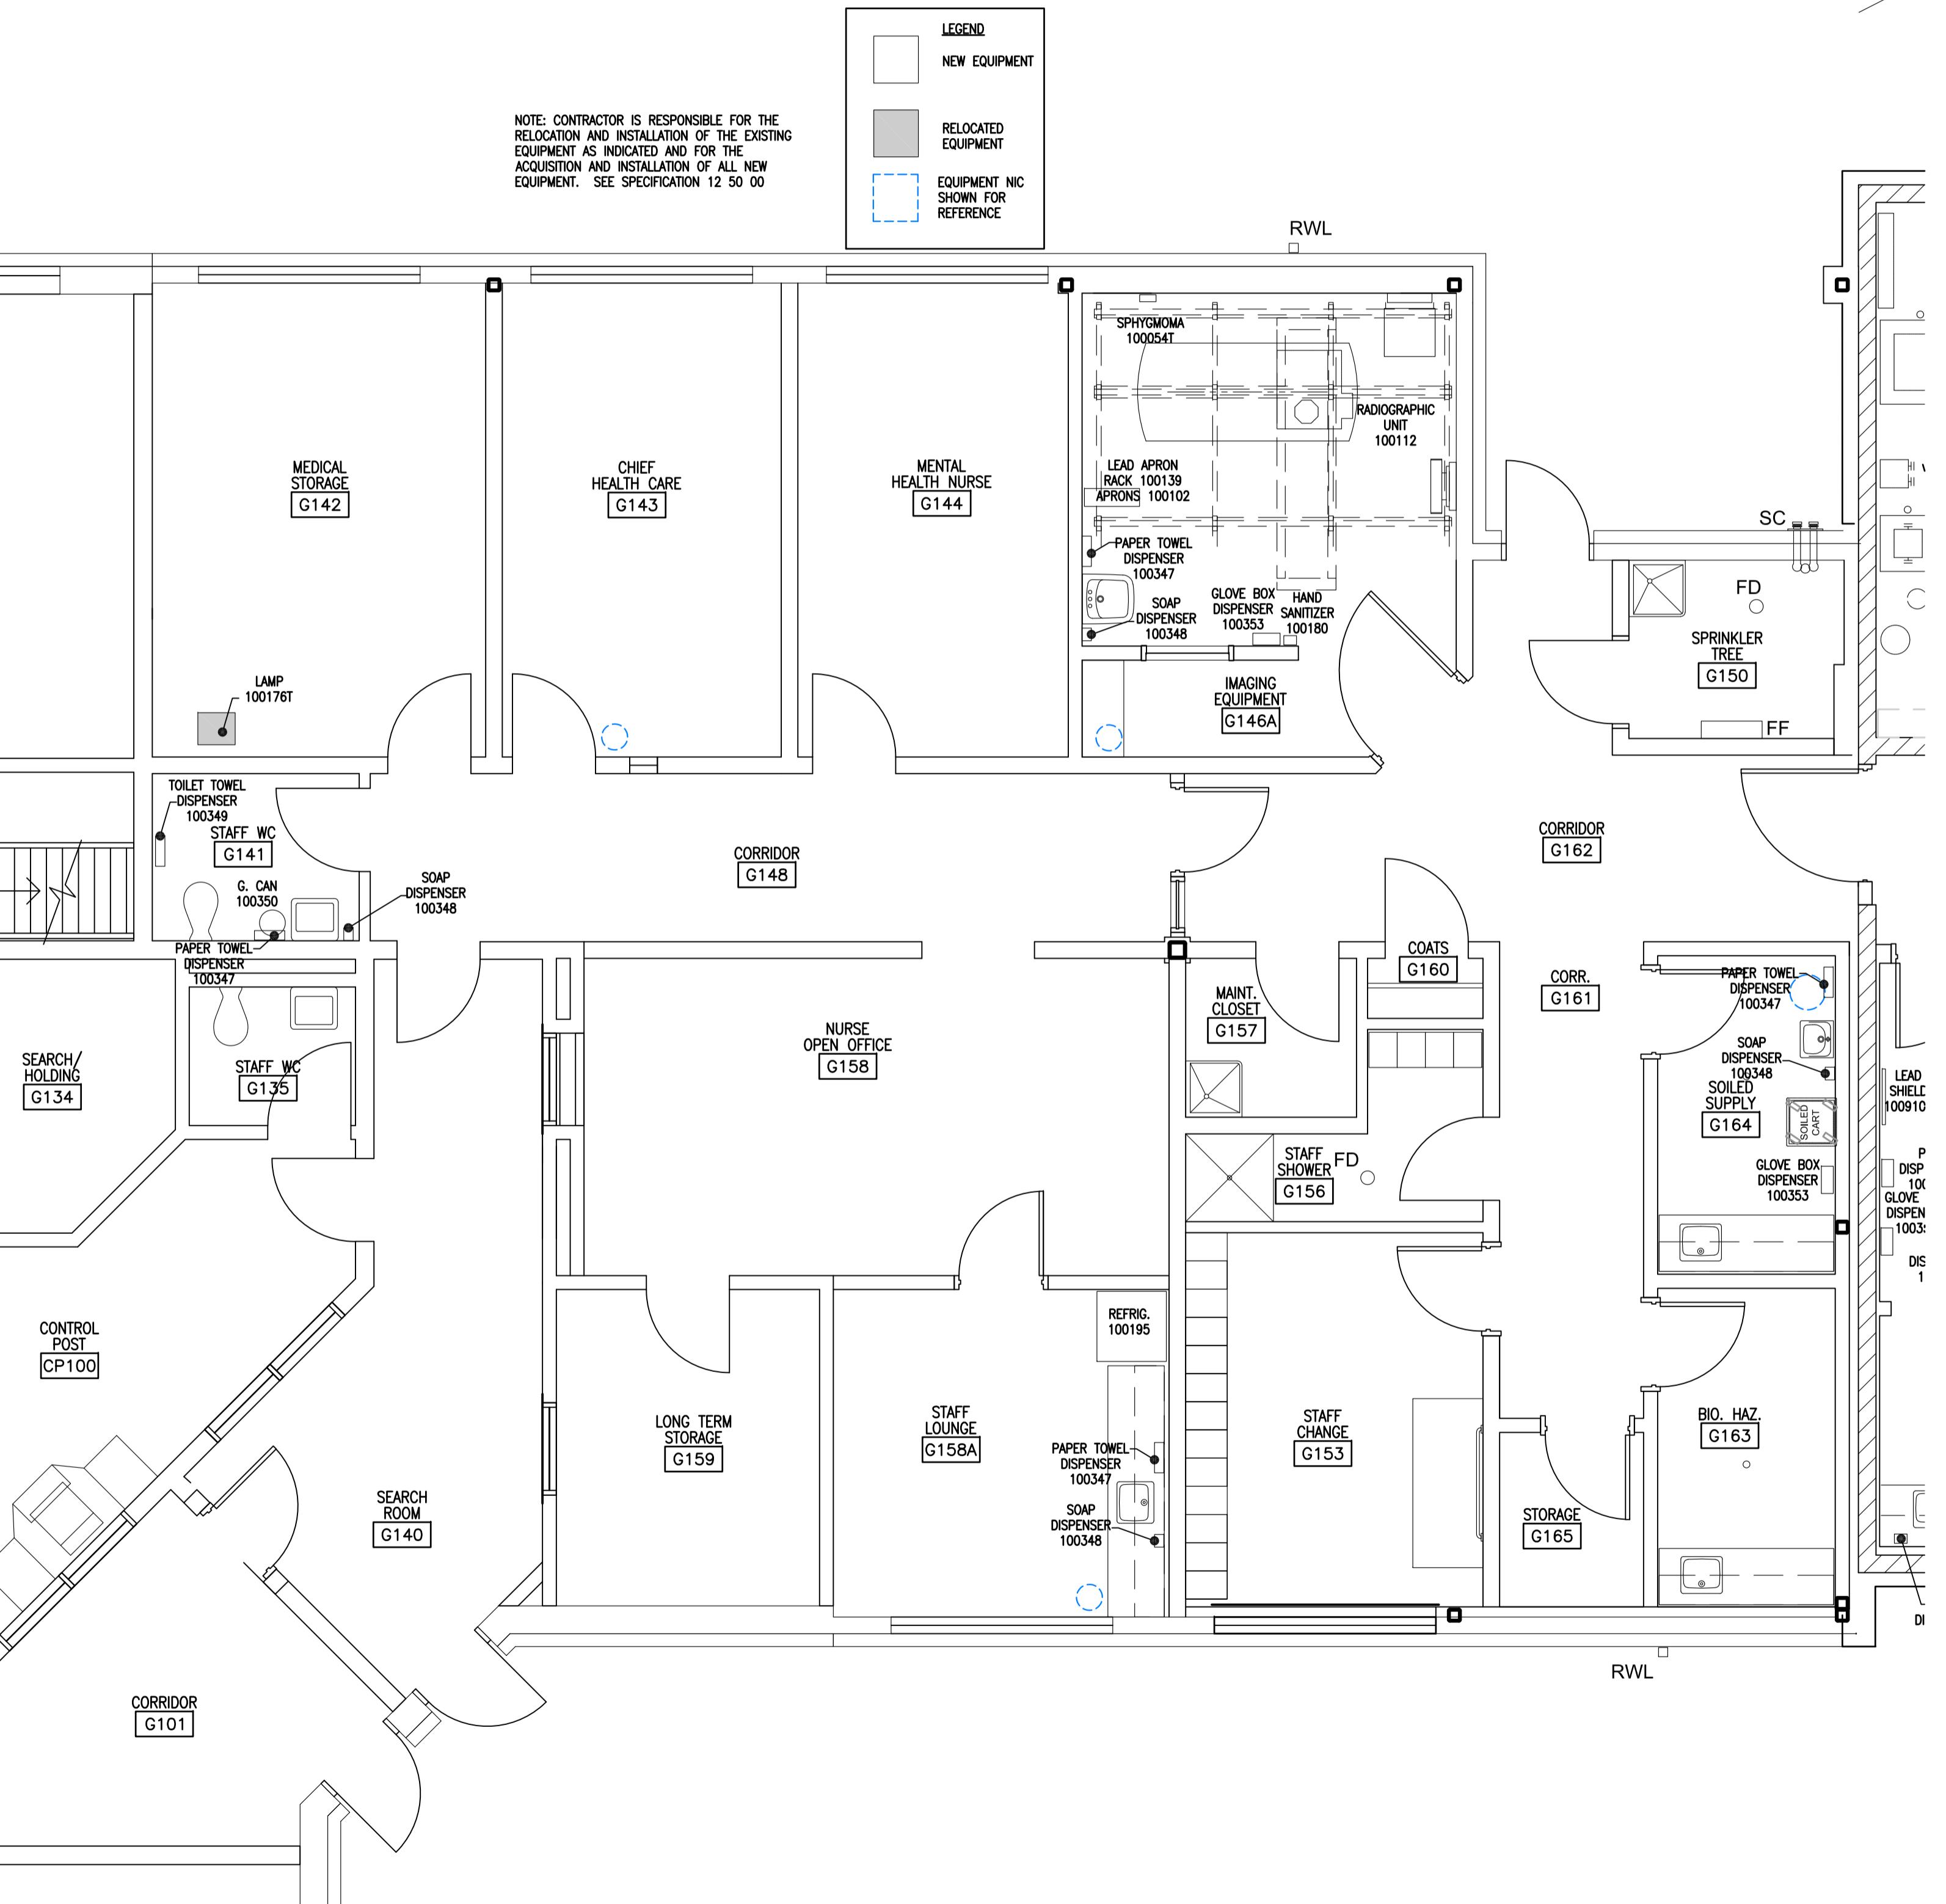

1
A906 1 : 50
PHASE 2 EQUIPMENT PLAN

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0	ISSUED FOR TENDER 17/09/01
Revision/Revision	Description/Description Date/Date
Client/Client	

CORRECTIONAL SERVICE OF CANADA

Project Title/Titre du projet
AGASSIZ, BRITISH COLUMBIA
4732 CEMETERY ROAD PO BOX 1600
MOUNTAIN INSTITUTE

MOUNTAIN INSTITUTE HEALTH CARE EXPANSION

Consultant Signature Only
Designed by/Conception par EDWIN BERZINS
Drawn by/Dessiné par BEN MONROE / MING HSU
PWGS Project Manager/Administrateur de Projets TPSGC TONY TANG
Regional Manager, Architectural and Engineering Services Gestionnaire régionale, Services d'architectural et de génie, TPSGC PREETPAL PAUL

Drawing title/Titre du dessin

PHASE 2 EQUIPMENT PLAN

Project No./No. du projet	Sheet/Feuille	Revision no./ La Révision no.
R.077724.001	A906	0