



EQUIPMENT SCHEDULE		
SYMBOL	DESCRIPTION	NOTES
	PARKING PEDESTAL REFER TO DETAIL	
	JUNCTION BOX	
	LUMINAIRE OF TYPE 'S' NEW SPOT LIGHT ON 4m POLE	
	LUMINAIRE OF TYPE 'S' NEW SPOT LIGHT ON 1m POLE	
	POLE/POST MOUNT LUMINAIRE OF TYPE 'T' EATON, GAN-AF-01-LED-U-SL3-BK	
	POLE/POST MOUNT LUMINAIRE OF TYPE 'T' EATON, GAN-AF-02-LED-U-SL3-BK	

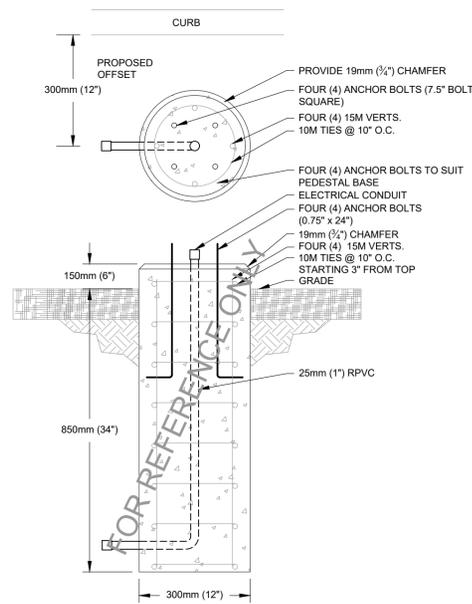


PARKING POST BASE DETAIL
SCALE: NTS

- PEDESTAL BASE NOTES:**
1. CONCRETE TO BE 20MPA 4-8% AIR, 19mm (3/4") MAX. AGGREGATE
 2. PROVIDE 19mm (3/4") CHAMFER ON ALL EXPOSED CONCRETE EDGES
 3. COORDINATE FINAL OFFSET FROM BACK OF CURB WITH LANDSCAPE AND CIVIL DRAWINGS.

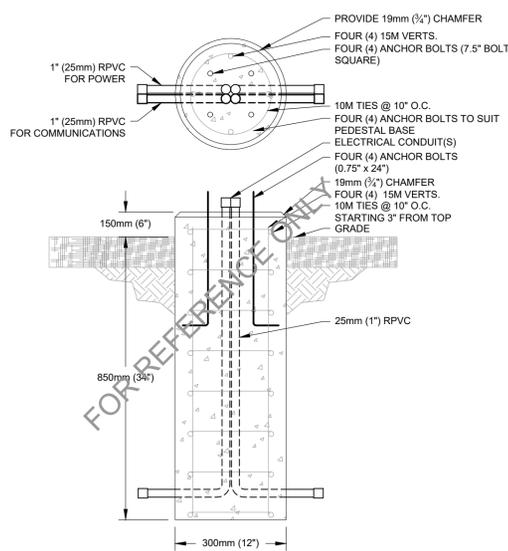


SMALL LUMINAIRE BASE DETAIL
SCALE: NTS

- SMALL LUMINAIRE BASE NOTES:**
1. CONCRETE TO BE 20MPA 4-8% AIR, 19mm (3/4") MAX. AGGREGATE
 2. PROVIDE 19mm (3/4") CHAMFER ON ALL EXPOSED CONCRETE EDGES
 3. CONDUITS ARE TO BE GROUPED AS TIGHT AS POSSIBLE WHILE STILL ALLOWING SPACE FOR COUPLINGS TO BE INSTALLED ON EACH CONDUIT. CONDUITS ARE TO BE CENTERED AT TOP OF BASE.

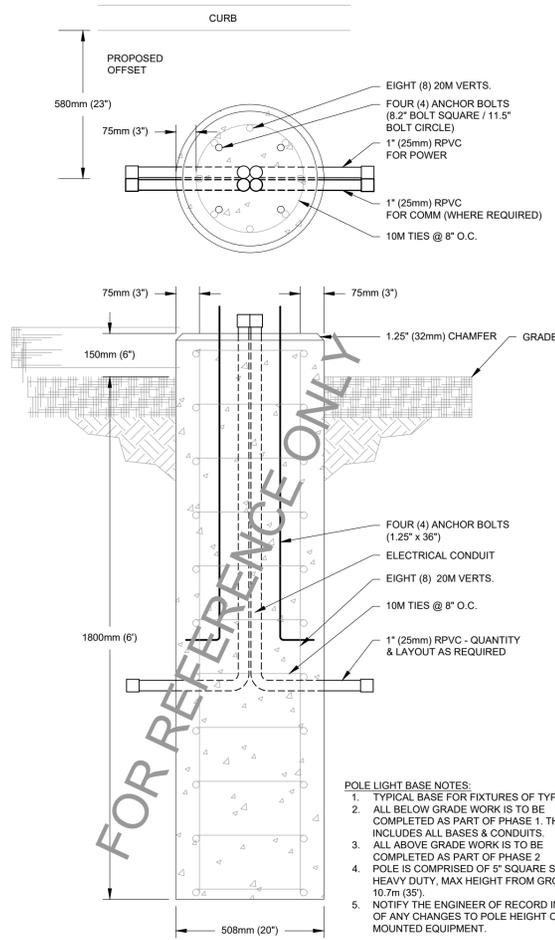

POLE LUMINAIRE CONCRETE BASE
SCALE: NTS

- POLE LIGHT BASE NOTES:**
1. TYPICAL BASE FOR FIXTURES OF TYPE 'T' & 'S'
 2. ALL BELOW GRADE WORK IS TO BE COMPLETED AS PART OF PHASE 1. THIS INCLUDES ALL BASES & CONDUITS.
 3. ALL ABOVE GRADE WORK IS TO BE COMPLETED AS PART OF PHASE 2.
 4. POLE IS COMPRISED OF 5" SQUARE STRAIGHT HEAVY DUTY, MAX HEIGHT FROM GROUND 10.7m (35').
 5. NOTIFY THE ENGINEER OF RECORD IN CASE OF ANY CHANGES TO POLE HEIGHT OR MOUNTED EQUIPMENT.

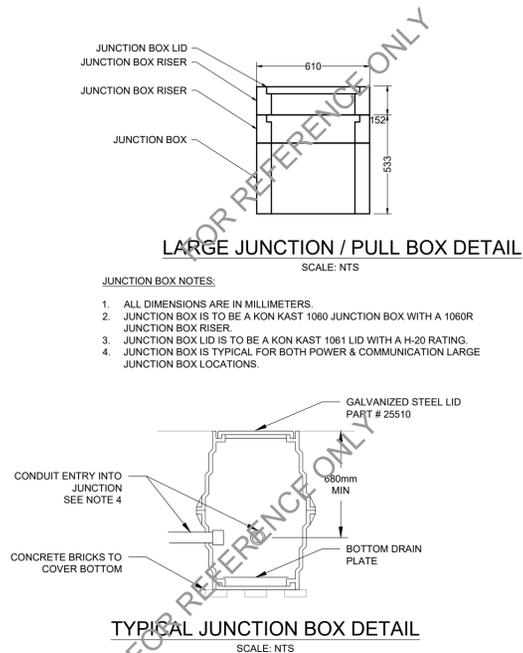

LARGE JUNCTION / PULL BOX DETAIL
SCALE: NTS

- JUNCTION BOX NOTES:**
1. ALL DIMENSIONS ARE IN MILLIMETERS.
 2. JUNCTION BOX IS TO BE A KON KAST 1060 JUNCTION BOX WITH A 1060R JUNCTION BOX RISER.
 3. JUNCTION BOX LID IS TO BE A KON KAST 1061 LID WITH A H-20 RATING.
 4. JUNCTION BOX IS TYPICAL FOR BOTH POWER & COMMUNICATION LARGE JUNCTION BOX LOCATIONS.

- JUNCTION BOX NOTES:**
1. TWO RECTANGULAR JUNCTION BOXES INSTALLED WITH ONE INVERTED UNDER THE OTHER.
 2. PROVIDE BONDING FOR STEEL LID.
 3. TYPICAL JUNCTION BOX IS TO BE WEST COAST ENGINEERING 25100 OR APPROVED EQUAL.
 4. CONDUIT IS TO BE RUN AT A DEPTH OF 900mm AND HAVE A GENTLE RISE UP FOR ENTRY INTO JUNCTION BOX.
 5. SMALL TYPE JUNCTION BOX IS TO BE WEST COAST ENGINEERING 25202 WITH STEEL LID (25410) OR APPROVED EQUAL.

PHASE 3 - SCOPE OF WORK	
•	ALL WORK SHOWN IN 'FAINTLINE' OR AS 'FOR REFERENCE' WERE COMPLETED DURING A PREVIOUS PHASE OF THE PROJECT.
•	ALL WORK SHOWN IN DARKLINE IS TO BE COMPLETED DURING THIS PHASE OF THE PROJECT.
•	SOME ITEMS INDICATED IN DARKLINE HAVE BEEN PARTIALLY COMPLETED DURING PREVIOUS PHASES AND IS TO BE EXTENDED / MODIFIED AS REQUIRED / INDICATED TO FORM A COMPLETE SYSTEM.
•	ALL UNDERGROUND WORKS WERE COMPLETED AS PART OF PHASES 1 & 2.
•	REMOVE PROTECTIVE JUNCTION BOXES, INSTALLED AS PART OF PHASE 2, FROM PEDESTAL & LUMINAIRE BASES.
•	SUPPLY AND INSTALL ALL NECESSARY MOUNTING BRACKETS, POLES, SUPPORTS, BREAKERS, WIRING, AND ANCILLARY DEVICES RELATED TO FIXTURES OF TYPE 'S' & 'S1'.
•	SUPPLY AND INSTALL ALL NECESSARY MOUNTING BRACKETS, SUPPORTS, BREAKERS, WIRING AND ANCILLARY DEVICES RELATED TO PARKING PEDESTALS.
•	SUPPLY AND INSTALL ALL LIGHT POLE MOUNTED RECEPTACLES.
•	SUPPLY AND INSTALL ALL NECESSARY MOUNTING BRACKETS, BACKBOXES, SUPPORTS, BREAKERS, WIRING AND ANCILLARY DEVICES RELATED TO POLE MOUNTED RECEPTACLES.
•	SUPPLY AND INSTALL PARKING KIOSK (PANEL P) AS PER KIOSK DETAILS.
•	SUPPLY AND INSTALL NECESSARY MOUNTING BRACKETS, SUPPORTS, AND ANCILLARY DEVICES FOR PARKING PANEL KIOSK.
•	PHASE 1 & 2 SHOP DRAWINGS WILL BE PROVIDED IN AN APPENDIX OF THE SPECIFICATIONS FOR REFERENCE.
•	REFER TO ATTACHED MP&P DRAWINGS FOR LIGHTING REQUIREMENTS.
•	COMPLETELY REMOVE EXISTING OVERHEAD SERVICE FOR WASHROOM BUILDING AS PER DRAWING E-32. COORDINATE SERVICE REMOVAL WITH FORTIS.
•	THERE WILL BE A MANDATORY SITE VISIT AS PART OF THE TENDERING PROCESS TO CONFIRM EXACT SCOPE OF WORK WITH ALL PROSPECTIVE BIDDERS.

Public Works and Government Services Canada / Travaux publics et Services gouvernementaux Canada

Client: Parks Canada Agency / L'Agence Parcs Canada

Western and Northern Region / Ouest et Nord du Canada

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PERMIT NUMBER: P 6383

REVISIONS	DESCRIPTION	DATE
01	ISSUED FOR TENDER - PHASE 3	16/11/17

A	A detail number	A
B	B source drawing no.	B
C	C detail on drawing no.	C

project title / titre du projet: **BANFF ADMINISTRATION BUILDING PARKING LOT REHABILITATION PHASE 3**


BANFF TOWN CENTER BANFF NATIONAL PARK, BANFF AB

drawing title / titre du dessin: **ELECTRICAL SCHEDULES & DETAILS**

designed by / conçu par: TI	drawn by / dessiné par: EL/TI	approved by / approuvé par: LL
PWSC Project Manager / Administrateur de Projets TPSGC: MATTHEW WHALEN		scale / échelle: AS NOTED
project no. / projet no.: MCSL 2531-13503	date / date: 16 DECEMBER 2017	sheet / feuille: E-30


DRAWING LIST		
NO.	TITLE	SCALE
E-30	ELECTRICAL SCHEDULES & DETAILS	AS NOTED
E-31	ELECTRICAL SCHEDULES & DETAILS	AS NOTED
E-32	POWER SITE PLAN	1:500
E-33	COMMUNICATIONS SITE PLAN	1:500
E-34	PARKING LOT POWER & LIGHTING PLAN	1:150
E-35	SINGLE LINE, KIOSK & PANEL ELEVATION	AS NOTED

PERMIT NUMBER: P 6383

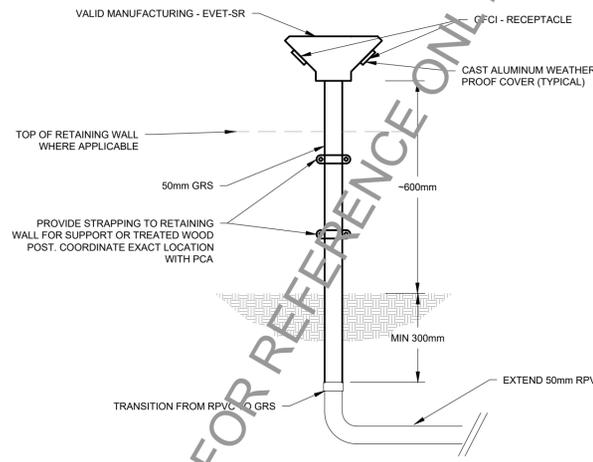


DETAIL 1 - RECEPTACLE PARKING LOT - POST MOUNTING DETAIL
SCALE: NTS
(REFER TO SHEET E-32 + E-34 FOR INDICATED LOCATION)

RECEPTACLE PARKING LOT POST NOTES:
1. CONDUIT AND RECEPTACLE ENCLOSURE ARE TO BE PAINTED BLACK (POWDER COATED) TO MATCH PARKING PEDESTAL AND LIGHT POST

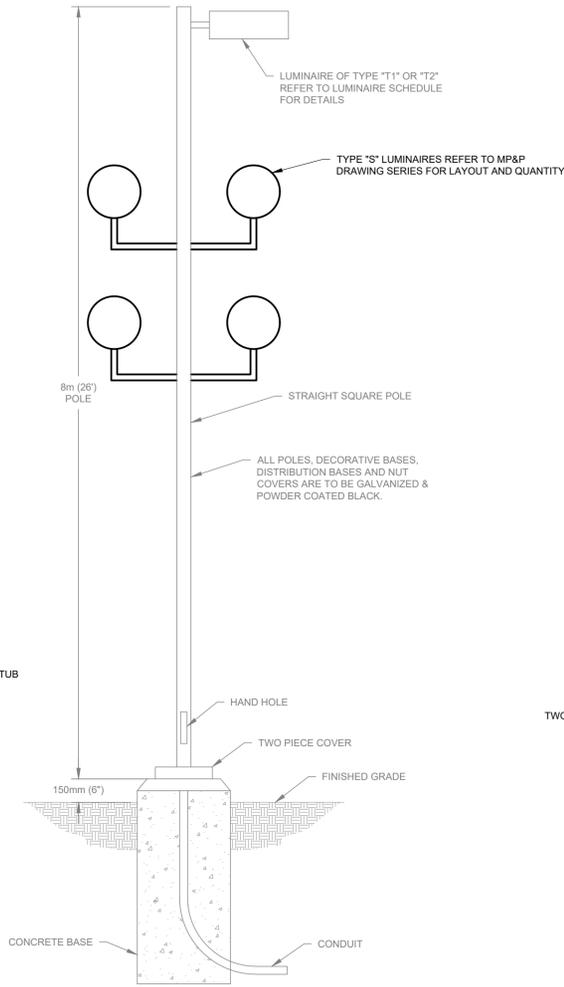


DETAIL 2 - POLE LUMINAIRE FIXTURE TYPE "S + T" MOUNTING DETAIL
SCALE: NTS

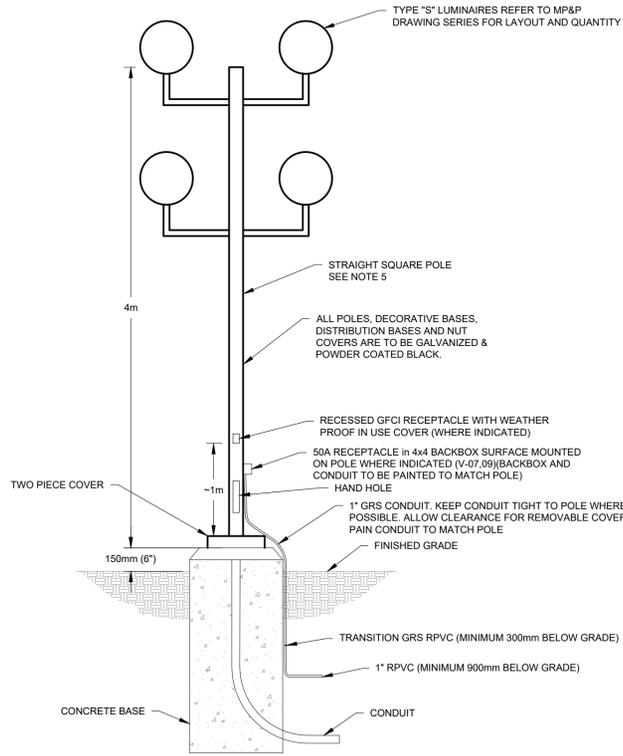


DETAIL 3 - POLE LUMINAIRE FIXTURE TYPE "S" MOUNTING DETAIL
SCALE: NTS

EXTERIOR LIGHT FIXTURE NOTES:
1. ALL BELOW GRADE WORK WAS COMPLETED AS PART OF PHASE 1 & 2. THIS INCLUDES ALL BASES & CONDUITS.
2. ALL ABOVE GRADE WORK IS TO BE COMPLETED AS PART OF PHASE 3. WIRING AND CONTROLS ARE PART OF PHASE 3.
3. POLE IS FOR REFERENCE PURPOSES. COORDINATE WITH SHEET E-32 FOR TYPE LIGHT LOCATION.
4. POLE AT LOCATION INDICATED HAS TO BE HINGED TO ALLOW FOR EASE OF REMOVAL. HINGED PART IS TO BE COORDINATED WITH HAND HOLE AND RECEPTACLE LOCATION. ALLOW FOR EXTRA WIRE LENGTH TO ALLOW FOR HINGING ACTION.
5. REFER TO PHASE 2 SHOP DRAWINGS FOR POLE INFORMATION ON POLES PROVIDED AS PART OF PHASE 2. PROVIDE ALL NECESSARY POLES TO COMPLETE PHASE 3.

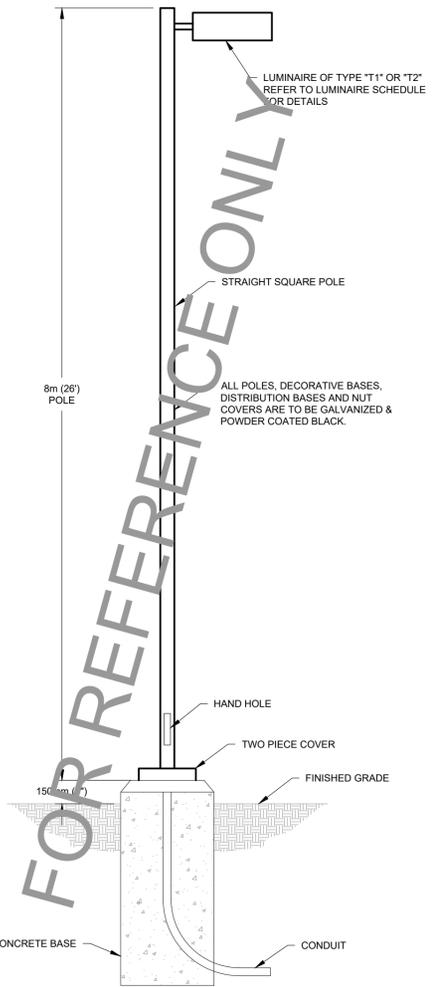


DETAIL 4 - POLE LUMINAIRE FIXTURE TYPE "T1" OR "T2" MOUNTING DETAIL
SCALE: NTS

EXTERIOR LIGHT FIXTURE NOTES:
1. ALL BELOW GRADE WORK WAS COMPLETED AS PART OF PHASE 1. THIS INCLUDES ALL BASES & CONDUITS.
2. ALL ABOVE GRADE WORK WAS COMPLETED AS PART OF PHASE 2. WIRING WAS PART OF PHASE 2.

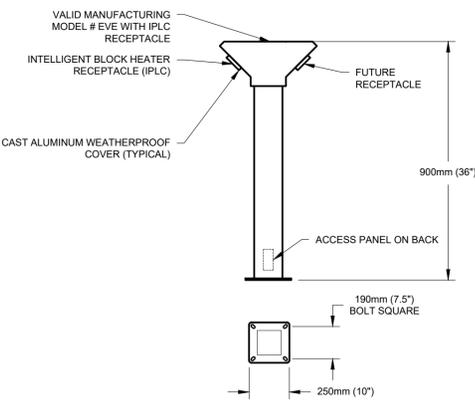


DETAIL 5 - PARKING PEDESTAL DETAIL
SCALE: NTS

PARKING POST NOTES:
1. ALL BELOW GRADE WORK WAS COMPLETED AS PART OF PHASE 1 & 2. THIS INCLUDES ALL BASES & CONDUITS.
2. ALL ABOVE GRADE WORK IS TO BE COMPLETED AS PART OF PHASE 3. WIRING AND CONTROLS ARE PART OF PHASE 3.
3. CONDUIT AND RECEPTACLE ENCLOSURE ARE TO BE PAINTED BLACK (POWDER COATED) TO MATCH PARKING PEDESTAL AND LIGHT POST.
4. PROVIDE LUGS IN BASE OF PEDESTAL SUITABLE FOR 3 WIRES (#6 MINIMUM). RUN #12 WIRE FOR LUGS UP TO MINI BREAKER AT TOP OF PEDESTAL FOR RECEPTACLES.

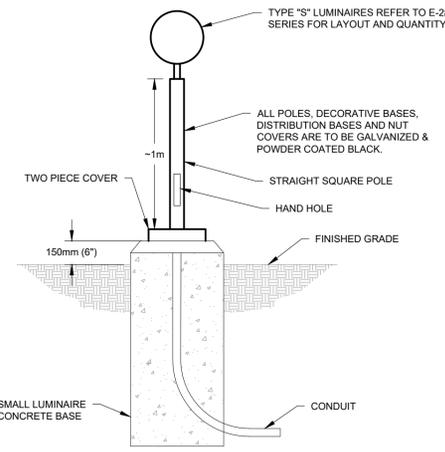


DETAIL 8 - POLE LUMINAIRE FIXTURE TYPE "S1" MOUNTING DETAIL
SCALE: NTS

EXTERIOR LIGHT FIXTURE NOTES:
1. ALL BELOW GRADE WORK WAS COMPLETED AS PART OF PHASE 1 & 2. THIS INCLUDES ALL BASES & CONDUITS.
2. ALL ABOVE GRADE WORK IS TO BE COMPLETED AS PART OF PHASE 3. WIRING AND CONTROLS ARE PART OF PHASE 3.
3. POLE IS FOR REFERENCE PURPOSES. COORDINATE WITH SHEET E-32 FOR TYPE LIGHT LOCATION.

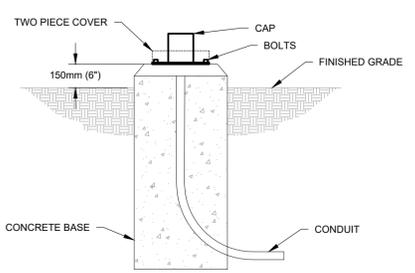

DETAIL 6 - REMOVABLE POLE LUMINAIRE FIXTURE WITH TYPE "S" REMOVED MOUNTING DETAIL
SCALE: NTS

EXTERIOR LIGHT FIXTURE NOTES:
1. ALL BELOW GRADE WORK WAS COMPLETED AS PART OF PHASE 1 & 2. THIS INCLUDES ALL BASES & CONDUITS.
2. ALL ABOVE GRADE WORK IS TO BE COMPLETED AS PART OF PHASE 3. WIRING AND CONTROLS ARE PART OF PHASE 3.
3. CAP IS TO BE SUITABLE TO PROTECT WIRES WHEN TYPE "S" POLE IS REMOVED. CAP IS TO BE GALVANIZED & POWDER COATED BLACK PAINTED.
4. CAP IS TO BE COORDINATED WITH HINGING POLE TO SUIT.
5. PROVIDE LOCKING MECHANISM FOR CAP TO BE PREVENT UNAUTHORIZED ACCESS.

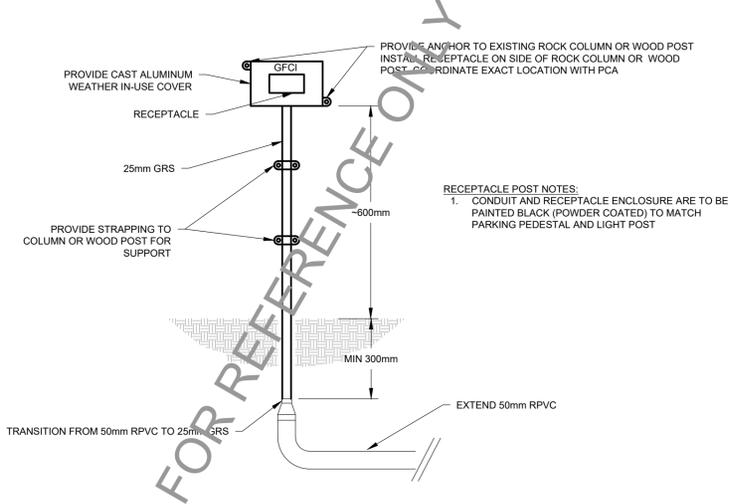

DETAIL 7 - RECEPTACLE POST MOUNTING DETAIL
SCALE: NTS
(SEE SHEET E-32)

REVISIONS	DESCRIPTION	DATE
01	ISSUED FOR TENDER - PHASE 3	16/11/17

A	A detail number	A
B	B source drawing no.	B
C	C detail on drawing no.	C

project title / titre du projet: **BANFF ADMINISTRATION BUILDING PARKING LOT REHABILITATION PHASE 3**
BANFF TOWN CENTER BANFF NATIONAL PARK, BANFF AB

drawing title / titre du dessin: **ELECTRICAL SCHEDULES & DETAILS**

designed by / conçu par: TI	drawn by / dessiné par: EL/TI	approved by / approuvé par: LL
PWGSC Project Manager / Administrateur de Projets TPSGC: MATTHEW WHALEN		scale / échelle: AS NOTED
project no. / projet no.: MCSL 2531-13503	date / date: 16 DECEMBER 2017	sheet / feuille: E-31



EQUIPMENT SCHEDULE		
SYMBOL	DESCRIPTION	NOTES
■	PARKING PEDESTAL REFER TO DETAIL	
JB	JUNCTION BOX	
Ⓢ	LUMINAIRE OF TYPE 'S' NEW SPOT LIGHT ON 4m POLE	
Ⓢ	LUMINAIRE OF TYPE 'S' NEW SPOT LIGHT ON 1m POLE	
Ⓢ	POLE/POST MOUNT LUMINAIRE OF TYPE 'T' EATON, GAN-AF-01-LED-U-SL3-BK	
Ⓢ	POLE/POST MOUNT LUMINAIRE OF TYPE 'T' EATON, GAN-AF-02-LED-U-SL3-BK	

PANEL SCHEDULE		
PANEL	RATING	CONDUCTOR
PANEL P	400A	4c #600 MCM
PANEL X	100A	3c #4 (600V)
PANEL Y	100A	2x 4c #10
PANEL Z	200A	3c #4 (600V)
WASHROOM	100A	2c #6 (600V)

POWER SITE PLAN
SCALE: 1:500

- NOTES:**
- REFER TO SHEET E-34 FOR PARKING LOT POWER & LIGHTING PLAN.
 - 25mm POWER CONDUIT FOR LIGHTING OF TYPE 'S' LOOPS FROM FIXTURE TO FIXTURE.
 - ALL CONDUIT PENETRATIONS INTO BUILDING ARE TO BE IN COMPLIANCE WITH CEC 22.1 12-018 & GOOD PRACTICE TO DEAL WITH EXISTING BUILDING CONDITIONS.
 - EXACT LOCATIONS & MOUNTING METHODS OF ALL RECEPTACLES & PANELS TO BE CONFIRMED ON SITE WITH PCA (OWNER).
 - REMOVABLE POLE
 - COMM CABLE IS TO HAVE A RJ45 CONNECTOR AT THE BASE OF THE POLE FOR TYPE "S" LIGHT FIXTURE CONTROLLER PROVIDE WEATHER PROOF / WATER PROOF CONNECTOR FOR DISCONNECT / CONNECT.
 - THE POWER CABLE IS TO BE ABLE TO BE DISCONNECTED AT THE BASE OF THE POLE AND BE SECURED UNDERNEATH THE WEATHER PROOF CAP SEE SHEET E-31. PROVIDE WEATHER PROOF / WATER PROOF CONNECTOR FOR DISCONNECT / CONNECT.
 - POLE IS TO HINGE DOWN FOR REMOVAL OF POLE ASSEMBLY. HINGE IS TO BE LOCKABLE IN BOTH UPRIGHT AND LOWERED POSITIONS.
 - MINIMUM BOND IS #12.
 - ALL CONDUIT EXITING OR ENTERING GROUND SURFACE ARE TO BE PROTECTED.
 - ALL CONDUITS AND WIRING SHOWN IN FAINT LINE ARE EXISTING BASED ON PHASE II CONTRACT.
 - PROVIDE ALL RECEPTACLES ON LIGHTING POLES AS SHOWN.

PERMIT NUMBER: P 6383

REVISIONS	DESCRIPTION	DATE
01	ISSUED FOR TENDER - PHASE 3	16/11/17

A	A detail number	A
B	B source drawing no.	B/C
C	C detail on drawing no.	


project title / titre du projet
BANFF ADMINISTRATION BUILDING PARKING LOT REHABILITATION PHASE 3
BANFF TOWN CENTER
BANFF NATIONAL PARK, BANFF AB

drawing title / titre du dessin
POWER SITE PLAN

designed by / conçu par	TI	
drawn by / dessiné par	EL/TI	
approved by / approuvé par	LL	
PWOSC Project Manager / Administrateur de Projets TPSOC	MATTHEW WHALEN	
scale / échelle	1:500	sheet / feuille
project no. / projet no.	MCSL 2531-13503	E-32
date	16 DECEMBER 2017	

PERMIT NUMBER: P 6383

EQUIPMENT SCHEDULE		
SYMBOL	DESCRIPTION	NOTES
■	PARKING PEDESTAL REFER TO DETAIL	
JB	JUNCTION BOX	
Ⓢ	LUMINAIRE OF TYPE 'S' NEW SPOT LIGHT ON 4m POLE	
Ⓢ	LUMINAIRE OF TYPE 'S' NEW SPOT LIGHT ON 1m POLE	
Ⓢ-T1	POLE/POST MOUNT LUMINAIRE OF TYPE 'T' EATON, GAN-AF-01-LED-U-SL3-BK	
Ⓢ-T2	POLE/POST MOUNT LUMINAIRE OF TYPE 'T' EATON, GAN-AF-02-LED-U-SL3-BK	

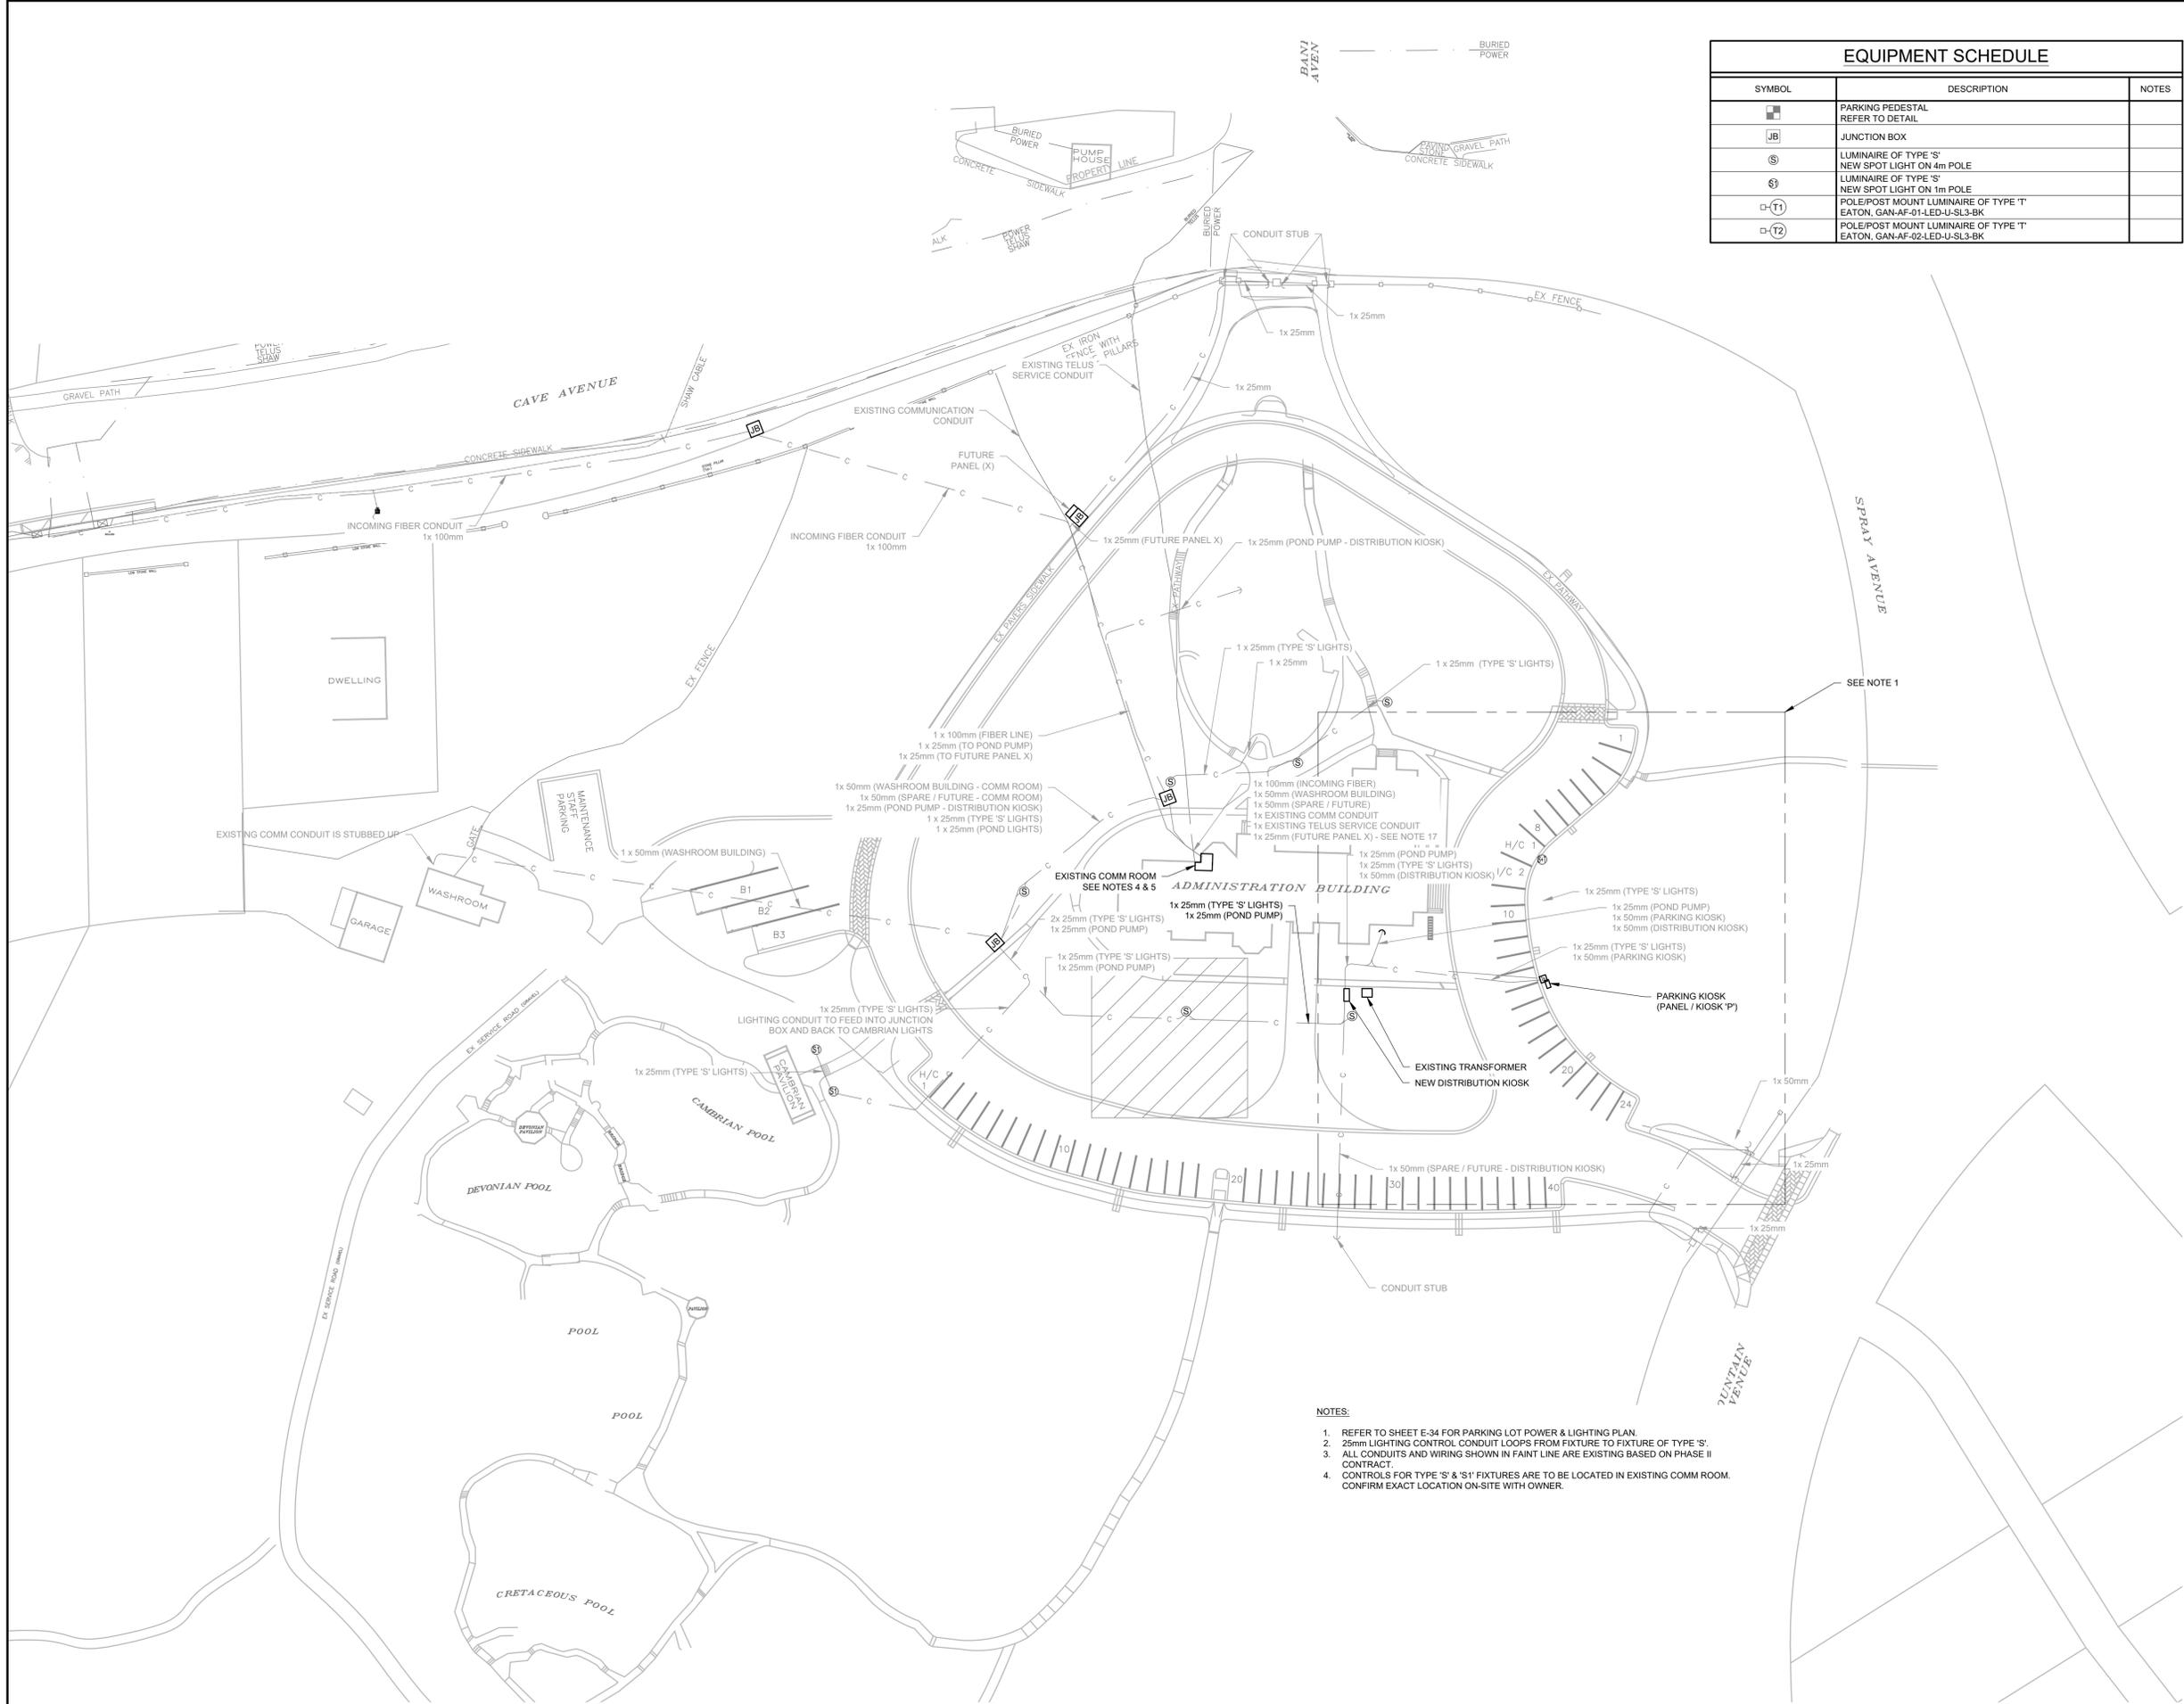

- NOTES:**
- REFER TO SHEET E-34 FOR PARKING LOT POWER & LIGHTING PLAN.
 - 25mm LIGHTING CONTROL CONDUIT LOOPS FROM FIXTURE TO FIXTURE OF TYPE 'S'.
 - ALL CONDUITS AND WIRING SHOWN IN FAINT LINE ARE EXISTING BASED ON PHASE II CONTRACT.
 - CONTROLS FOR TYPE 'S' & 'S1' FIXTURES ARE TO BE LOCATED IN EXISTING COMM ROOM. CONFIRM EXACT LOCATION ON-SITE WITH OWNER.

REVISIONS	DESCRIPTION	DATE
01	ISSUED FOR TENDER - PHASE 3	16/11/17

A	A detail number	A
B	B source drawing no.	B
C	C detail on drawing no.	C

project title / titre du projet
**BANFF ADMINISTRATION BUILDING
 PARKING LOT REHABILITATION
 PHASE 3**
 BANFF TOWN CENTER
 BANFF NATIONAL PARK, BANFF AB

drawing title / titre du dessin
**COMMUNICATIONS SITE
 PLAN**

designed by / conçu par: TI
 drawn by / dessiné par: EL/TI
 approved by / approuvé par: LL
 PWGSC Project Manager / Administrateur de Projets TPSGC: MATTHEW WHALEN

scale / échelle: 1:500
 project no. / projet no.: MCSL 2531-13503
 date / date: 16 DECEMBER 2017
 sheet / feuille: E-33

COMMUNICATIONS SITE PLAN
 SCALE: 1:500


PERMIT NUMBER: P 6383

EQUIPMENT SCHEDULE		
SYMBOL	DESCRIPTION	NOTES
■	PARKING PEDESTAL REFER TO DETAIL	
JB	JUNCTION BOX	
S	LUMINAIRE OF TYPE 'S' NEW SPOT LIGHT ON 4m POLE	
S	LUMINAIRE OF TYPE 'S' NEW SPOT LIGHT ON 1m POLE	
T1	POLE/POST MOUNT LUMINAIRE OF TYPE 'T' EATON, GAN-AF-01-LED-U-SL3-BK	
T2	POLE/POST MOUNT LUMINAIRE OF TYPE 'T' EATON, GAN-AF-02-LED-U-SL3-BK	

PEDESTAL SCHEDULE		
PED#	CONDUCTOR	REMARKS
PED-01	3c #6	
PED-02	3c #6	
PED-03	3c #6	
PED-04	3c #8	
PED-05	3c #8	
PED-06	3c #8	
PED-07	3c #8	
PED-08	3c #8	
PED-09	3c #8	
PED-10	3c #8	
PED-11	3c #8	
PED-12	3c #6	

• ALL WIRE SIZES SHOWN ARE RW90 CU
• ALL WIRE SIZES SHOWN ARE BASED ON FUTURE EV CHARGER REQUIREMENTS.

- NOTES:
1. COMBINED POLE FOR FIXTURES 'S' + 'T'. REFER TO SHEET E-31 FOR DETAIL.
 2. EXACT PEDESTAL LOCATION TO BE APPROVED BY PCA.
 3. ALL CONDUITS AND WIRING SHOWN IN FAINT LINE ARE EXISTING BASED ON PHASE II CONTRACT.
 4. INDICATED POLE IS EXISTING WITH TYPE 'T' FIXTURE INSTALLED. FIXTURES OF TYPE 'S' ARE TO BE PROVIDED AND MOUNTED TO POLE. REFER TO DETAIL 2 ON SHEET E-31.

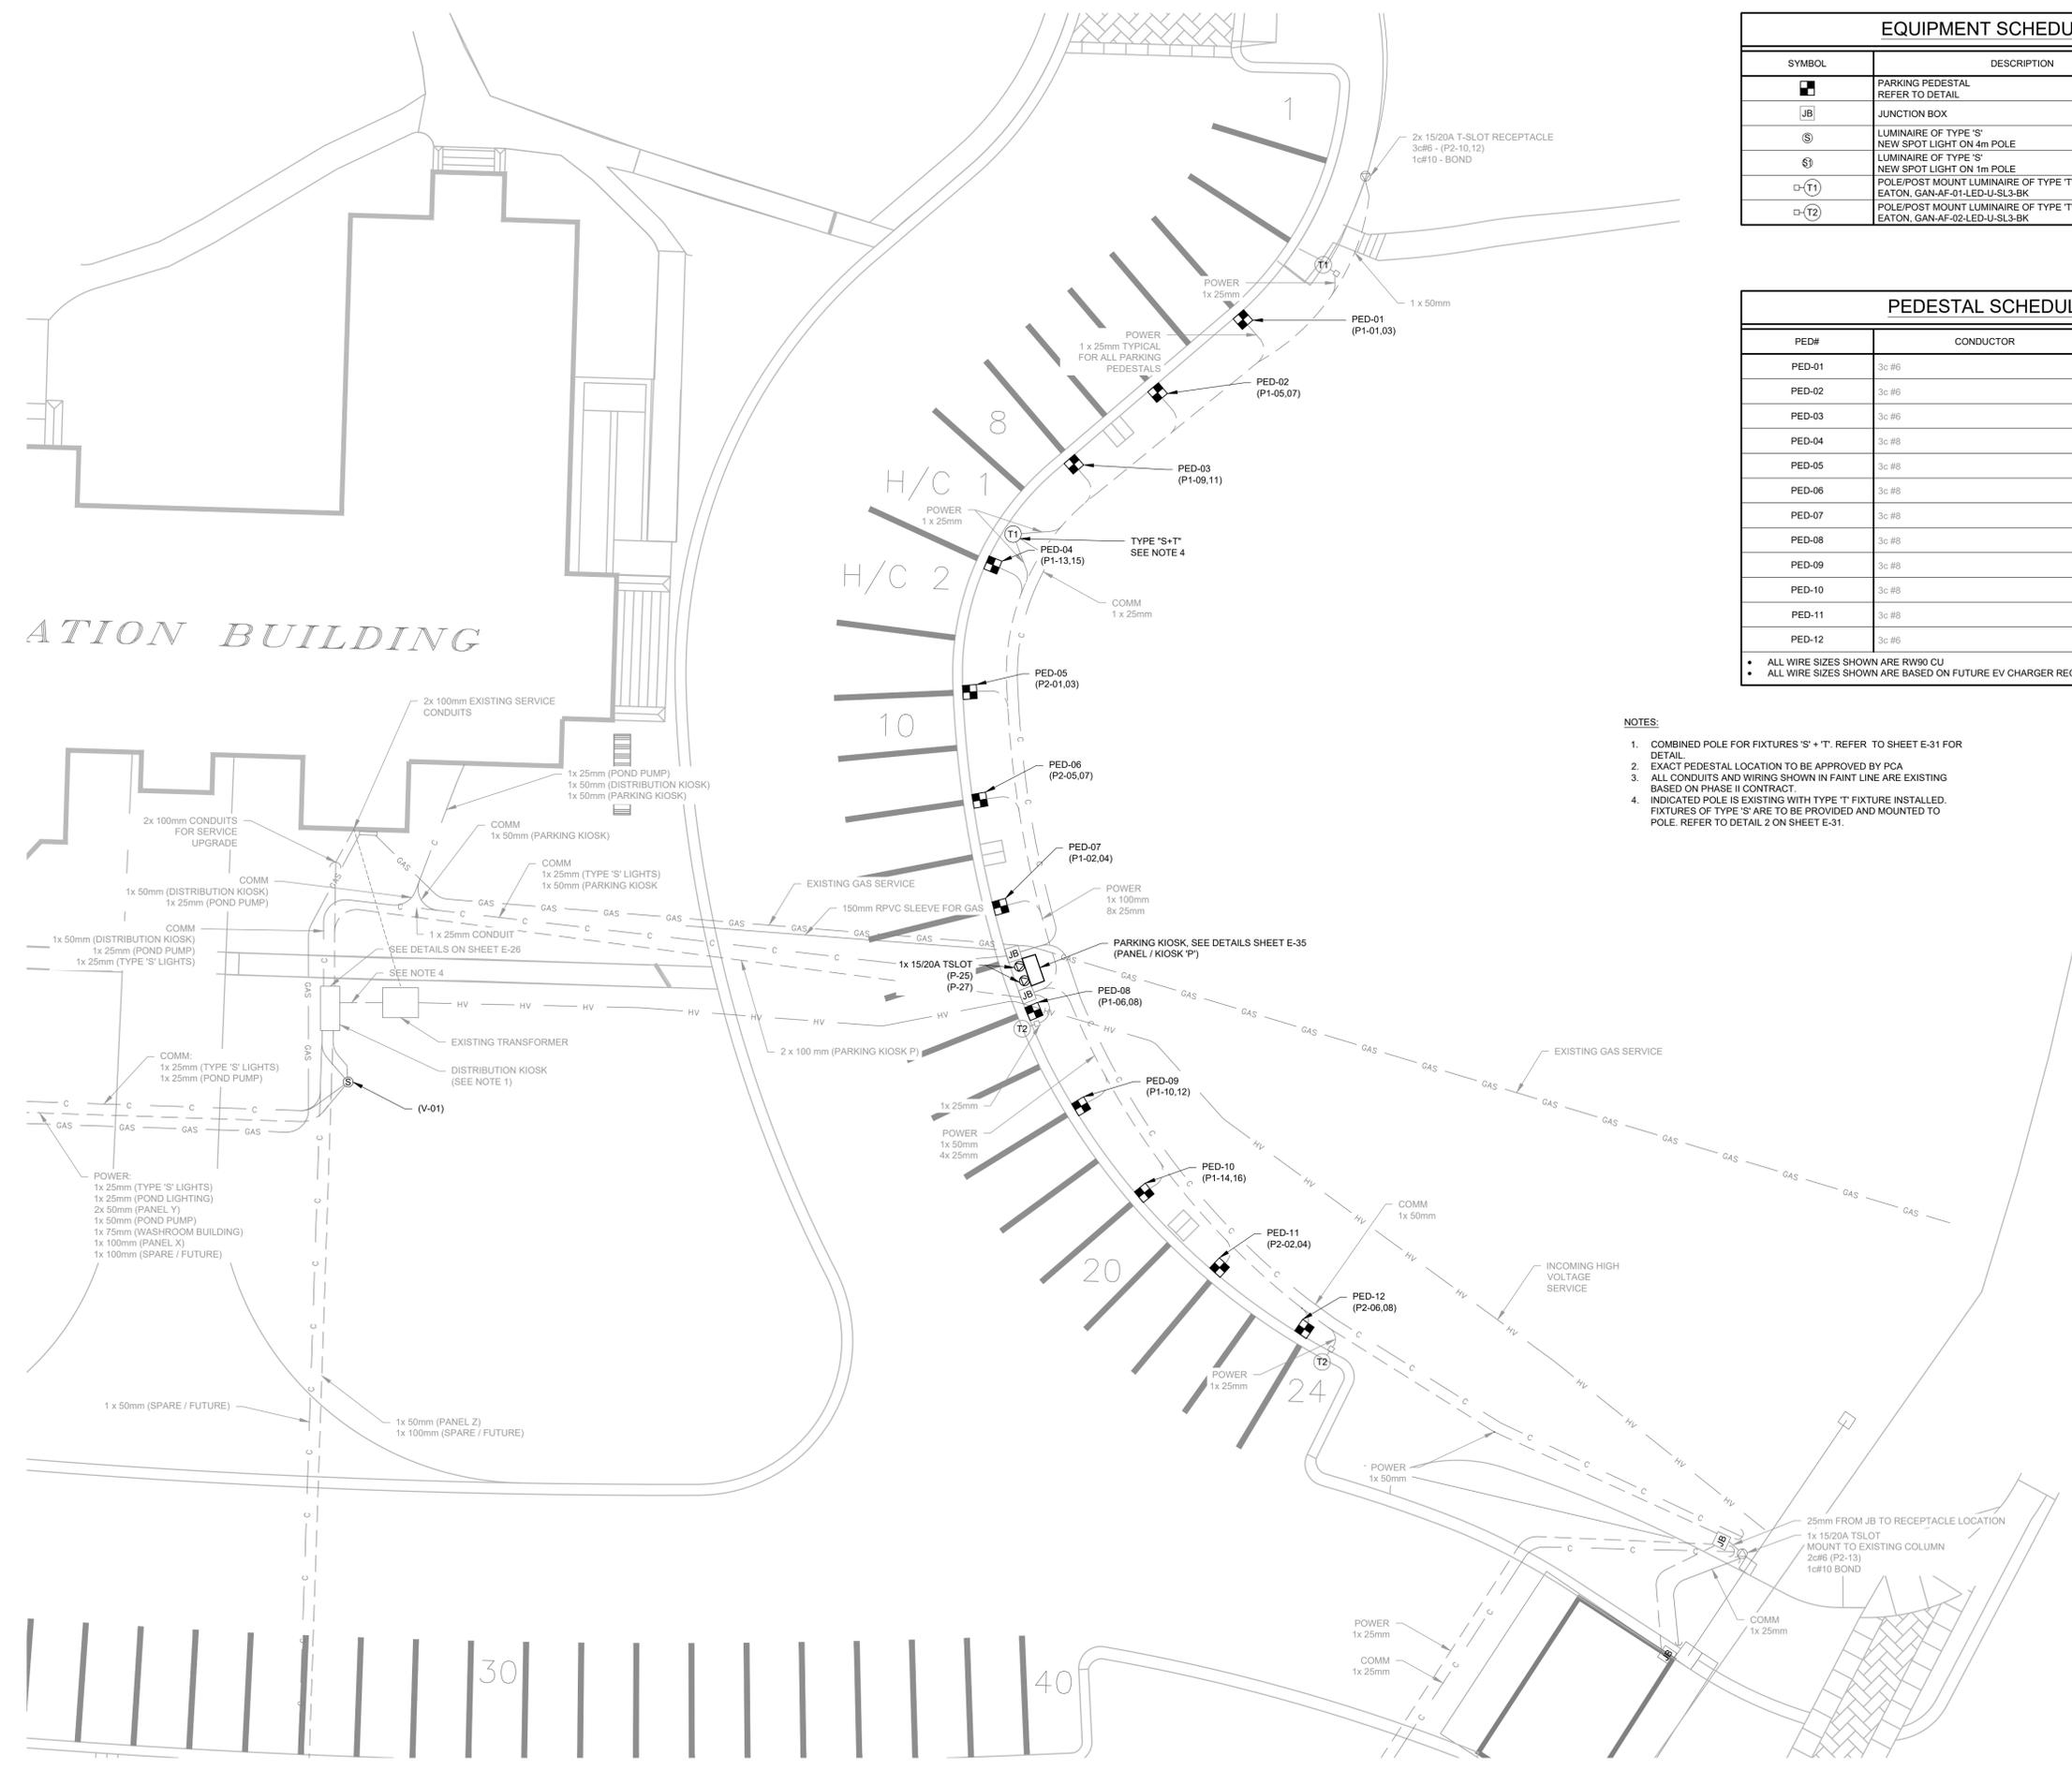

PARKING LOT POWER & LIGHTING PLAN
SCALE: 1:150

REVISIONS	DESCRIPTION	DATE
01	ISSUED FOR TENDER - PHASE 3	16/11/17

A	A detail number	A
B	B source drawing no.	B
C	C detail on drawing no.	C

project title / titre du projet: **BANFF ADMINISTRATION BUILDING PARKING LOT REHABILITATION PHASE 3**
BANFF TOWN CENTER
BANFF NATIONAL PARK, BANFF AB


drawing title / titre du dessin: **PARKING LOT POWER & LIGHTING PLAN**

designed by / conçu par: TI
drawn by / dessiné par: EL/TI
approved by / approuvé par: LL

PWOSC Project Manager / Administrateur de Projets TPSOC: **MATTHEW WHALEN**


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project no. / projet no.: MCSL 2531-13503
sheet / feuille: **E-34**
date / date: 16 DECEMBER 2017

PERMIT NUMBER: P 6383

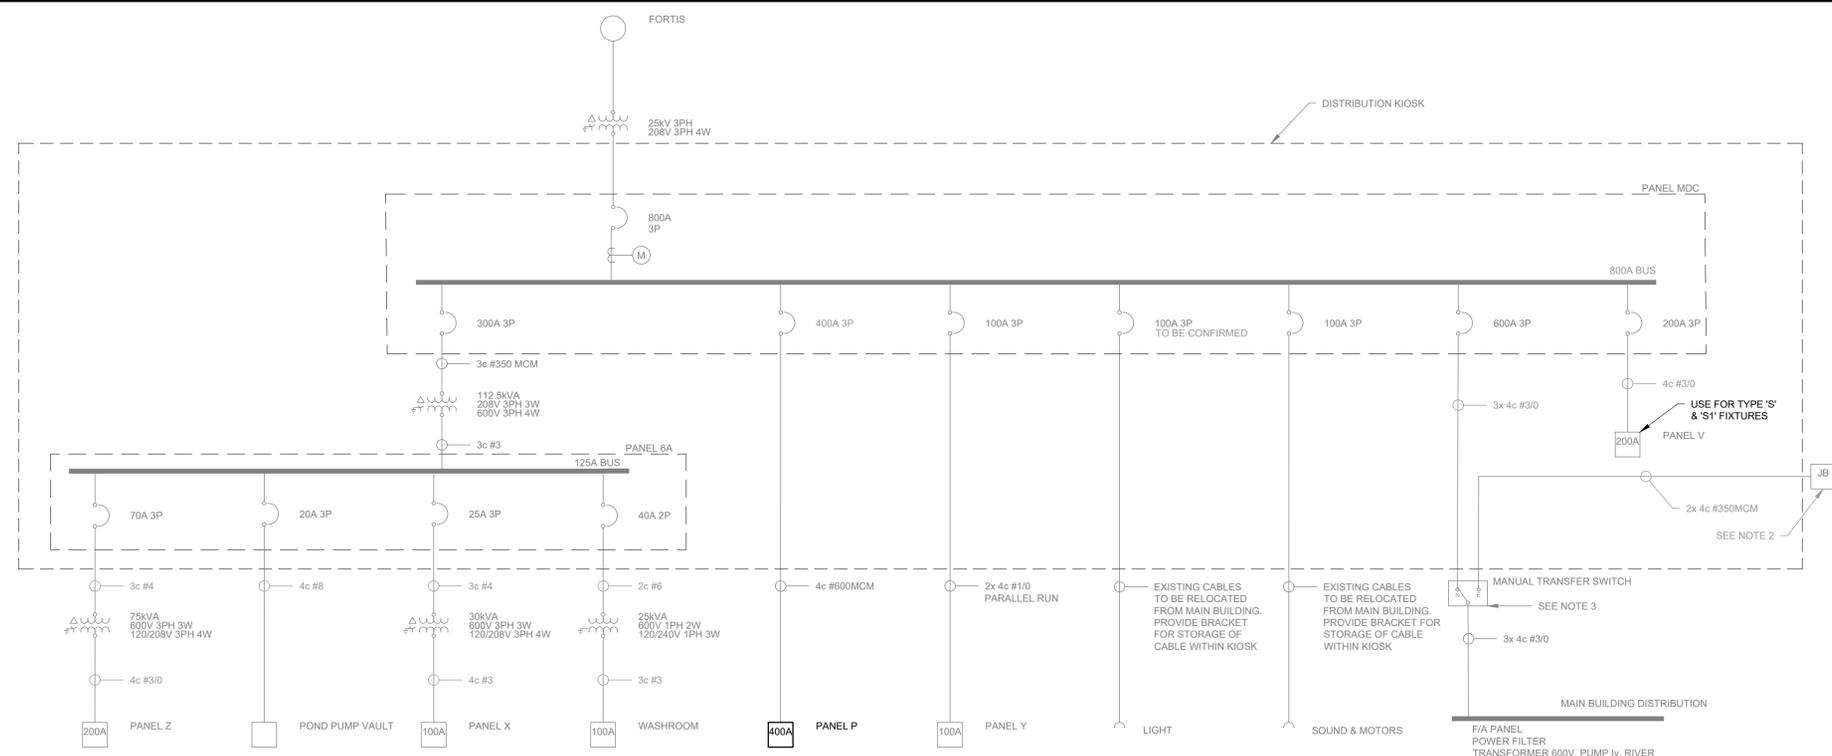


SYMBOL	DESCRIPTION	NOTES
	BREAKER	
	FUSE	
	DISCONNECT SWITCH	
	FUSED CUTOFF (SERVICE AUTHORITY)	
	CURRENT TRANSFORMER (WITH METER) - LETTER DENOTES TYPE	
	TRANSFORMER	
	TRANSFORMER (A-Y)	
	TRANSFER SWITCH	
	MOTOR / EQUIPMENT	
	PANEL - MAIN BREAKER AS INDICATED	
	GENERATOR	
	GROUND	
	CONDUCTOR/FEEDER INFORMATION	


SINGLE LINE DIAGRAM
SCALE: NOT TO SCALE

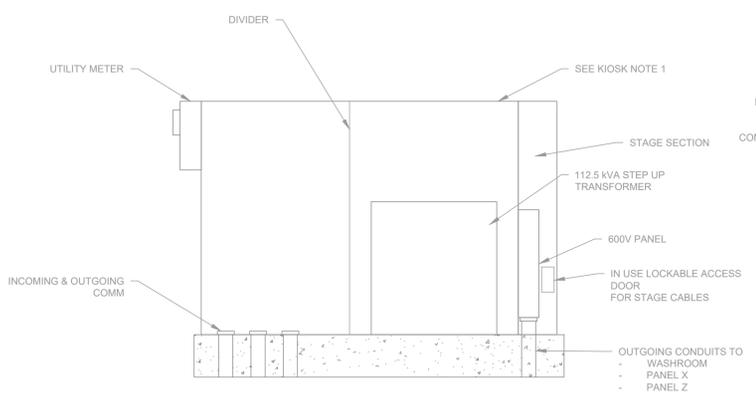

ELECTRICAL SERVICE KIOSK ELEVATION DETAIL - WEST SIDE
SCALE: 1:25

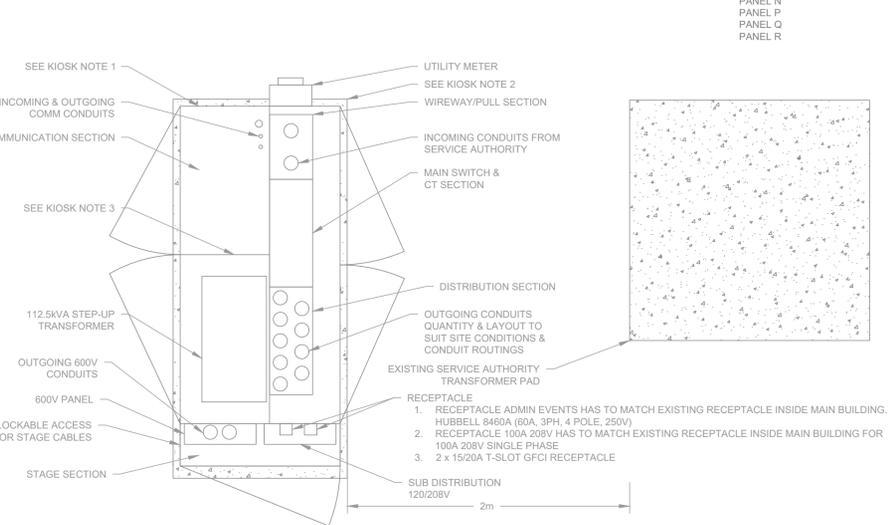

ELECTRICAL SERVICE KIOSK LAYOUT DETAIL
SCALE: 1:25

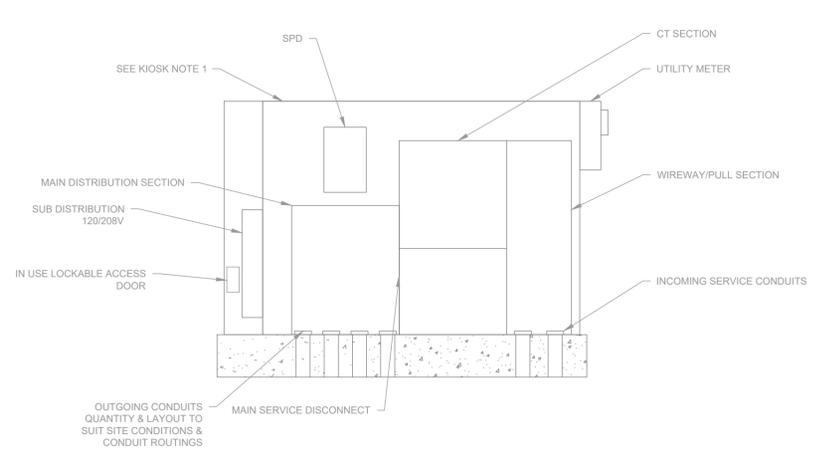

ELECTRICAL SERVICE KIOSK ELEVATION DETAIL - EAST SIDE
SCALE: 1:25

- SERVICE KIOSK NOTES:
- EXACT KIOSK SIZE AND LAYOUT IS TO SUIT SITE CONDITIONS. PROVIDE DETAILED DIMENSIONED LAYOUT DRAWINGS OF KIOSK PRIOR TO ORDERING EQUIPMENT.
 - KIOSK PAD IS TO BE 50mm LARGER IN ALL DIRECTIONS THAN KIOSK. EXACT PAD REQUIREMENTS ARE TO BE CONFIRMED WITH KIOSK MANUFACTURER.
 - PROVIDE BARRIER BETWEEN COMMUNICATION SECTION AND STAGE SECTION.
 - KIOSK IS TO BE COMPLETED AS PART OF PHASE 2. ALL CONDUITS ENTERING KIOSK CURRENTLY TERMINATE 1-3m AWAY FROM KIOSK BASE.
 - CONTRACTOR RESPONSIBLE FOR FINAL LAYOUT & CONFIGURATION. KIOSK IS TO BE SIZED TO ALLOW FOR ALL EQUIPMENT SHOWN AND ANY ANCILLARY EQUIPMENT REQUIRED.
 - EXACT LOCATION TO BE APPROVED BY PCA
 - PROVIDE NEW GROUNDING GRID AS PER CEC


NOTE	DESCRIPTION	BKR	CIRCUIT	BKR	DESCRIPTION	NOTE
--	PANEL 6A	-300 01	02	400		--
--		-300 03	04	400		--
--		-300 05	06	400		--
--		-100 07	08	100		--
--	PANEL Y	-100 09	10	100	LIGHT CORDS	--
--		-100 11	12	100		--
--		-600 13	14	100		--
--	MAIN BUILDING	-600 15	16	100	SOUND CORDS	--
--		-600 17	18	100		--
--		-100 19	20	--		--
--	PANEL V	-100 21	22	--		--
--		-100 23	24	--		--

- GENERAL NOTES
- ALL PANELS TO HAVE LAMACOID LABELS
 - BREAKER PANELS TO BE EATON OR SQUARE D

NOTE	DESCRIPTION	BKR	CIRCUIT	BKR	DESCRIPTION	NOTE
--	PED-01	50 01	02	50	PED-07	--
--		50 03	04	50		--
--	PED-02	50 07	08	50	PED-08	--
--		50 09	10	50		--
--	PED-03	50 11	12	50	PED-09	--
--		50 13	14	50		--
--	PED-04	50 15	16	50	PED-10	--
--		50 17	18	--		--

- PANEL P NOTES:
- EXACT KIOSK SIZES AND LAYOUT IS TO SUIT SITE CONDITIONS. PROVIDE DETAILED DIMENSIONED LAYOUT DRAWINGS OF KIOSKS PRIOR TO ORDERING EQUIPMENT.
 - KIOSK PADS ARE TO BE 50mm LARGER IN ALL DIRECTIONS THAN KIOSKS. EXACT PAD REQUIREMENTS ARE TO BE CONFIRMED WITH KIOSK MANUFACTURER(S).
 - CONTRACTOR RESPONSIBLE FOR FINAL LAYOUT & CONFIGURATION. KIOSKS ARE TO BE SIZED TO ALLOW FOR ALL EQUIPMENT SHOWN AND ANY ANCILLARY EQUIPMENT REQUIRED.
 - EXACT LOCATIONS TO BE APPROVED BY PCA
 - FINISH TO BE BLACK POWDER COATED
 - ALL KIOSKS AND PANELS ARE TO HAVE THE SAME MASTER KEY.
 - PRICING IS TO INDICATE ANY ASSUMPTIONS MADE REGARDING PANELS AND ENCLOSURES
 - ALL PANELS ARE TO BE MADE AS SMALL AS POSSIBLE. CONTRACTOR TO SUBMIT SHOP DRAWINGS BEFORE ORDERING. PANEL AND KIOSK QUALITY STANDARD HAS TO BE EQUAL TO VALID PADMOUNT ENCLOSURES PREMIUM DESIGN OR APPROVED EQUAL
 - ALL PANELS TO HAVE LAMACOID LABELS. LABELS ARE TO HAVE 38mm TALL LETTERING ON MINIMUM 50mm LAMACOID.
 - BREAKER PANELS ARE TO BE EATON OR SQUARE D WITH BOLT ON BREAKERS

NOTE	DESCRIPTION	BKR	CIRCUIT	BKR	DESCRIPTION	NOTE
--	PED-05	50 01	02	50	PED-11	--
--		50 03	04	50		--
--	PED-06	50 05	06	50	PED-12	--
--		50 07	08	50		--
--	RECEPTACLE IN PANEL	20 09	10	20	RECEPTACLE AT POST	--
--	RECEPTACLE IN PANEL	20 11	12	20		--
--	ENTRY GATE RECEPTACLE	20 13	14	--		--
--		15	16	--		--
--		17	18	--		--

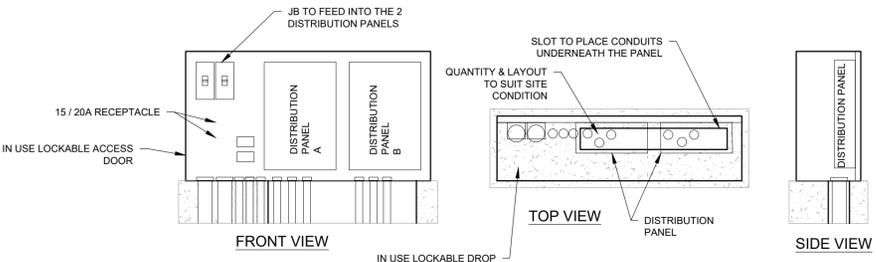

PANEL P DETAILS AND ELEVATION
SCALE: 1:25

REVISIONS	DESCRIPTION	DATE
01	ISSUED FOR TENDER - PHASE 3	16/11/17

A	A detail number	A
B	B source drawing no.	B
C	C detail on drawing no.	C

PROJECT TITLE: BANFF ADMINISTRATION BUILDING PARKING LOT REHABILITATION PHASE 3
BANFF TOWN CENTER BANFF NATIONAL PARK, BANFF AB

designed by	TI	conçu par
drawn by	EL/TI	dessiné par
approved by	LL	approuvé par
PWOSC Project Manager	MATTHEW WHALEN	Administrateur de Projets TPSOC
scale	1:150	sheet
echelle	1:150	feuille
project no.	MCSL 2531-13503	project no.
date	16 DECEMBER 2017	date

E-35