



 Parks Canada / Parcs Canada

# Lake Louise Campground – Tent Side Shower Building Renovation

Stantec Project Number: 113678159

**131 Fairview Dr,  
Improvement District  
No. 9,  
Lake Louise, Alberta  
T0L**

## PROJECT TEAM:

### OWNER/ PROJECT MANAGER:

Parks Canada / Government of Canada  
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### ARCHITECTURAL DRAWING LIST

A001	GENERAL NOTES AND SYMBOLS
A100	CONSTRUCTION PLANS
A200	FINISH & EQUIPMENT PLAN
A400	ELEVATIONS
A700	TYPICAL DETAILS

### MECHANICAL DRAWING LIST

M001	MECHANICAL LEGEND, SCHEDULES, DETAILS AND DRAWING LIST
M100	MECHANICAL PLANS
M200	MECHANICAL SPECIFICATIONS



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3	ISSUED FOR TENDER	DG	SS	2017.12.15
2	ISSUED FOR 80% REVIEW	DG	SS	2017.12.06
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File Name: N/A	DG	SS	GV	
	Dwn.	Dsgn.	Chkd.	YYYY.MM.DD

Permit/Seal

Client/Project  
Parks Canada / Government of Canada

Lake Louise Campground – Tent Side Shower Building Renovation

131 Fairview Dr, Improvement District No. 9,  
Lake Louise, Alberta  
T0L

Title  
COVER

Project No.  
113678159

Scale

Revision  
3

Drawing No.

**A000**

# ABBREVIATIONS

ACT	ACOUSTICAL TILE	SIM	SIMILAR
ALUM	ALUMINUM	SPEC	SPECIFICATION
A.F.F.	ABOVE FLOOR FINISH	SS	STAINLESS STEEL
APPROX	APPROXIMATE	STD	STANDARD
ARCH	ARCHITECTURAL	STOR	STORAGE
B.F.	BARRIER FREE	STRUCT	STRUCTURAL
BLKG	BLOCKING	SUSP	SUSPENDED
BLDG	BUILDING	TEL	TELEPHONE
B/O	BOTTOM OF	T/O	TOP OF
BTWN	BETWEEN	TYP	TYPICAL
CLG	CEILING	UIS	UNDERSIDE
COL	COLUMN	UNO	UNLESS NOTED OTHERWISE
COMP	COMPUTER	VB	VAPOUR BARRIER
CW	COMPLETE WITH	VENT.	VENTILATED
CJ	CONTROL JOINT	WR	WASHROOM
CONC	CONCRETE	WB	WHITE BOARD
CB	CONCRETE BLOCK	WC	WATER CLOSET
CL	CENTER LINE		
C/C	CENTER TO CENTER		
DISP	DISPENSER		
DTL	DETAIL		
DN	DOWN		
DF	DRINKING FOUNTAIN		
DWG	DRAWING		
ELEC	ELECTRICAL		
ELEV	ELEVATION		
EQ	EQUIPMENT		
EX	EXISTING		
EXIST	EXISTING		
EXP JT	EXPANSION JOINT		
EXT	EXTERIOR		
FON	FOUNDATION		
FD	FLOOR DRAIN		
FFE	FINISHED FLOOR ELEVATION		
FLUOR	FLUORESCENT		
FRR	FIRE RESISTANT RATING		
FTG	FOOTING		
FURR	FURRING		
GC	GENERAL CONTRACTOR		
GALV	GALVANIZED		
GL	GLASS, GLAZING		
GWB	GYPSUM WALL BOARD		
HT	HEIGHT		
HM	HOLLOW METAL		
HOR	HORIZONTAL		
HB	HOSE BIB		
HP	HIGH POINT		
HSS	HOLLOW STEEL SECTION		
INFO	INFORMATION		
INSUL	INSULATION		
LAV	LAVATORY		
LP	LOWPOINT		
MANUF	MANUFACTURER		
MO	MASONRY OPENING		
MAT	MATERIAL		
MAX	MAXIMUM		
MECH	MECHANICAL		
MET	METAL		
MIN	MINIMUM		
MISC	MISCELLANEOUS		
NIC	NOT IN CONTRACT		
NTS	NOT TO SCALE		
OC	ONCENTRE		
PERIM	PERIMETER		
PLYWD	PLYWOOD		
PREFAB	PREFABRICATED		
PREFIN	PREFINISHED		
RD	ROOF DRAIN		
RM	ROOM		
RO	ROUGH OPENING		
RTU	ROOF TOP UNIT		
RWL	RAIN WATER LEADER		

# GENERAL NOTES

- CONTRACTOR TO CONFIRM ALL DIMENSIONS ON SITE AND IMMEDIATELY REPORT ANY DISCREPANCIES TO THE DESIGN TEAM PRIOR TO PROCEEDING
- CONTRACTOR TO MAINTAIN CONTINUITY OF FIRE SEPARATIONS AND FIRE RESISTANCE RATINGS. THIS INCLUDES ALL NEW PENETRATIONS IN WALL, FLOOR, AND CEILING ASSEMBLIES, AND SEALING OF ALL PENETRATIONS REMAINING WHERE SERVICES HAVE BEEN REMOVED.
- EXISTING DUCTWORK AND SHAFT SPACES (BOTH CONFORMING AND NON-CONFORMING), NOTED AS OUT OF SCOPE ARE TO REMAIN AS-IS.
- PROVIDE ALL FRAMING & BLOCKING AS REQUIRED TO ENSURE PROPER SECUREMENT OF ALL MATERIALS, EQUIPMENT, ACCESSORIES, ETC.
- CONTRACTOR TO COORDINATE LOCATIONS OF ALL MECHANICAL & ELECTRICAL EQUIPMENT PRIOR TO ROUGH IN & INSTALLATION.
- MAINTAIN SAFE ACCESS TO ALL REQUIRED EXITS AT ALL TIMES.
- ALL ANIMAL ATTRACTANTS (GASOLINE, FOOD, PERSONAL TRASH) MUST BE STORED INSIDE IN A SAFE LOCATION INSIDE.
- CONSTRUCTION DEBRIS MUST BE STORED IN APPROPRIATE GARAGE BIN AND REMOVED REGULARLY.

# PROJECT SPECIFIC NOTES

- ALL WORK IN NEW CONSTRUCTION AREAS TO CONFORM TO 2015 NATIONAL BUILDING CODE.
- ALL NEW FRAMING TO BE COMPLETED IN HOUSE. GC TO ENSURE STRUCTURAL ADEQUACY OF OWNER CONSTRUCTED WALLS AND CEILINGS, PRIOR COMMENCEMENT OF WORK.
- ALL ELECTRICAL WORK TO BE COMPLETED IN HOUSE BY OWNER. GC TO COORDINATE INSTALLATION OF FIXTURES AND EQUIPMENT WITH OWNER/ PROJECT MANAGER.
- GC TO COORDINATE WITH OWNER/ PROJECT MANAGER FOR INSTALLATION OF OWNER INSTALLED PLUMBING FIXTURES.
- DEMOLITION OF EXISTING FIXTURES AND EQUIPMENT COMPLETED BY OWNER.
- DEMOLITION OF EXISTING INTERIOR GYPSUM BOARD AND PARTITIONS COMPLETED BY OWNER.
- DEMOLITION OF EXISTING INTERIOR GYPSUM BOARD CEILINGS COMPLETED BY OWNER.
- GC TO COMPLETE DEMOLITION REQUIRED FOR INSTALLATION OF NEW FIXTURES, EQUIPMENT AND HVAC SYSTEMS.

# ARCHITECTURAL SYMBOLS LEGEND

**DETAIL NUMBER**  
 1 SIM A802  
 SHEET ON WHICH DETAIL IS SHOWN

**ELEVATION NUMBER**  
 A1 A101  
 SHEET ON WHICH ELEVATION IS SHOWN

**ELEVATION NUMBER**  
 1 A600 2 3  
 SHEET ON WHICH ELEVATION IS SHOWN

**BUILDING SECTIONS**  
 1 SIM A909  
 SHEET ON WHICH SECTION IS SHOWN

**WALL SECTIONS**  
 1 SIM A909  
 SHEET ON WHICH SECTION IS SHOWN

**FLOOR**  
 FLOOR OR ROOF LEVEL NAME  
 0'-0" VERTICAL ELEVATION

**CEILING TYPE**  
 ACT-1  
 10' - 0" A.F.F.  
 CEILING HEIGHT

**DOOR OPENING NUMBER**  
 1000A  
 DENOTES FIRE RATED PLYWOOD BLOCKING.

**DEMOLITION SHEET NOTE**  
 1

**GENERAL SHEET NOTE**  
 1

**NORTH ARROW**  
 N

**DRAWING REVISION**  
 1

**ROOM TAG**  
 ROOM NAME  
 101  
 150 SF

**AREA TAG**  
 AREA NAME  
 150 SF

**WINDOW TAG**  
 1

**PARTITION TYPE**  
 A01

**CASEWORK TAG**  
 1

**GLAZING TYPE**  
 1G1

**DEMOLITION KEYNOTE**  
 1

**KEYNOTE**  
 1

**FURNITURE & EQUIPMENT TAG**  
 Legend Key

**WALL/FLOOR FINISH TRANSITION**  
 Merchandising Key

**MERCHANDISING TAG**  
 Merchandising Key

**WALL FINISH TAG**  
 Merchandising Key

**FLOOR FINISH TAG**  
 XXX



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### Consultant

### Notes

4	ISSUED FOR TENDER	DG	SS	2017.12.15
3	ISSUED FOR 80% REVIEW	DG	SS	2017.12.06
2	ISSUED TO COST CONSULTANT	DG	SS	2017.12.05
1	ISSUED FOR 50% REVIEW	DG	SS	2017.11.17
Issued				By Appd YYYY.MM.DD

PACKAGE A	By	Appd	YYYY.MM.DD
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File Name: N/A	Author Dwn.	Designer Dsgn.	Checker Chkd.	10/19/17
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### Permit/Seal

### Client/Project Logo



Parks Canada / Government of Canada

Lake Louise Campground – Tent Side Shower Building Renovation

131 Fairview Dr, Improvement District No. 9,  
 Lake Louise, Alberta

Title  
 GENERAL NOTES AND SYMBOLS

Project No. 113678159	Scale 1 : 1
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Revision 4	Drawing No. A001
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4	ISSUED FOR TENDER	DG	SS	2017.12.15
3	ISSUED FOR 80% REVIEW	DG	SS	2017.12.06
2	ISSUED TO COST CONSULTANT	DG	SS	2017.12.05
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File Name: N/A	Author Dwn.	Designer Dgn.	Checker Chkd.
			10/19/17
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Lake Louise Campground – Tent Side Shower Building Renovation

131 Fairview Dr, Improvement District No. 9,  
Lake Louise, Alberta

Title  
**CONSTRUCTION PLANS**

Project No.  
113678159

Revision  
4

Scale  
As indicated

Drawing No.  
**A100**



**SHEET NOTES - PARTITION**


- A. ALL WALL AND CEILING FRAMING TO BE COMPLETED IN HOUSE. GC TO CONFIRM LOCATION AND STRUCTURAL ADEQUACY OF OWNER CONSTRUCTED FRAMING. ADVISE PROJECT MANAGER OF DISCREPANCIES WITH THE DIMENSIONED PLANS OR CONFLICTS WITH OTHER PARTS OF THE WORK. ADJUST LOCATIONS AS REQUIRED BASED ON REVIEW.
- B. FURR OUT AS REQUIRED ALL COLUMNS, EXTERIOR WALLS, BUILDING CORE WALLS, ETC., FOR INSTALLATION OF POWER, COMMUNICATION, AND SECURITY WIRING, CONDUITS, AND DEVICE BOXES.
- C. DOOR AND WINDOW SIZES ARE NOMINAL. CONTRACTOR TO CONSULT SUPPLIER FOR EXACT SIZES AND ROUGH OPENINGS.
- D. PROVIDE ALL FRAMING / BLOCKING AS REQUIRED TO ENSURE PROPER SECUREMENT OF ALL MATERIALS, EQUIPMENT, ACCESSORIES, ETC.
- E. FURR IN ALL EXPOSED MECH. AND ELECT. DUCTS AND PIPING.

**KEY NOTES- PARTITION PLAN**

- INSTALL 89MM X 12.7 (3.5" X 0.5") NEW SOLID WOOD WINDOW TRIM. CONSTRUCTED WITH FLAT PROFILE AND MITERED CUTS.
- TIE NEW VAPOUR BARRIER INTO EXISTING.
- PREPARE EXISTING DOOR AND FRAME TO RECEIVE NEW FINISHES.
- PREPARE LOCATION OF NEW WALL HUNG TOILET LOCATION. REFER TO MECHANICAL DRAWINGS.
- ALIGN NEW SHOWER BASE WITH EXISTING SHOWER DRAINS. NOTIFY CONSULTANT IMMEDIATELY IF CONFLICTS ARE FOUND BETWEEN THE NEW SHOWER BASE AND EXISTING DRAIN.
- RELOCATE EXISTING SHOWER DRAIN TO ACCOMMODATE NEW LAYOUT. REFER TO MECHANICAL DRAWINGS. SITE VERIFY AND COORDINATE WITH MANUFACTURER INSTALLATION GUIDE.
- CAP OFF EXISTING FLOOR DRAIN. REFER TO MECHANICAL. PATCH AND REPAIR SLAB TO RECEIVE NEW FINISHES.
- FOR INSTALLATION OF NEW MILLWORK & MIRROR, PROVIDE FULL HEIGHT 19mm PLYWOOD BLOCKING BETWEEN STUDS.
- INSTALL NEW JANITOR MOP SINK C/W SPLASH GUARD. REFER TO MECHANICAL.
- AT NEW FURNACE LOCATION CONSTRUCT STEEL SUPPORT FRAME TO SUPPORT NEW FURNACE. MINIMUM OF 250MM A.F.F. CONSTRUCT TO SUIT FURNACE MANUFACTURER'S SUPPORT AND ACCESS REQUIREMENTS. CONTRACTOR TO PROVIDE SHOP DRAWINGS TO CONSULTANTS FOR REVIEW. SEE FURNACE SPECIFICATIONS.
- CONSTRUCT NEW SHOWER BASE CAP. REFER TO DETAILS ON SHEET A700.

**LEGEND: PARTITION / CONSTRUCTION**

<p><b>VARIES</b></p> <p><b>INTERIOR PARTITION &amp; EXTERIOR WALL: EX</b></p> <p>EXISTING BASE BUILDING WALLS TO REMAIN</p>	<p><b>P2- INTERIOR MOISTURE RESISTANT FURRING: SLAB TO US OF FINISHED CEILING</b></p> <p>-13mm (1/2") CEMENT TILE BACKER BOARD (ONE SIDE) -38mm x 89mm (2"x4") DIMENSIONAL LUMBER @ 410mm (16") O.C. <b>NOTE ALL FRAMING TO BE COMPLETED BY OWNER.</b></p>
<p><b>P1- INTERIOR MOISTURE RESISTANT PARTITION: SLAB TO US OF FINISHED CEILING</b></p> <p>-13mm CEMENT TILE BACKER BOARD -38mm x 89mm (2"x4") DIMENSIONAL LUMBER @ 410mm (16") O.C. -13mm TILE BACKER CEMENT BOARD <b>NOTE ALL FRAMING TO BE COMPLETED BY OWNER.</b></p>	<p><b>INTERIOR PARTITION: P4 SLAB TO US SLAB</b></p> <p>-13mm (1/2") CEMENT TILE BACKER BOARD ADHERED TO EXISTING WALLS</p>
<p><b>W1- EXTERIOR WALL FURRING: SLAB TO US OF FINISHED CEILING</b></p> <p>-38mm x 89mm (2"x4") DIMENSIONAL LUMBER @ 410mm (16") O.C. INFILL STUD CAVITY WITH R-14 SEMI RIDGED MINERAL WOOL INSULATION. -6 ml POLYETHYLENE VAPOUR BARRIER -13mm TILE BACKER CEMENT BOARD <b>NOTE ALL FRAMING TO BE COMPLETED BY OWNER.</b></p>	<p><b>SYMBOLS</b></p> <p> DENOTES LOCATION OF 19mm (3/4") PLYWOOD BLOCKING BETWEEN STUDS</p>

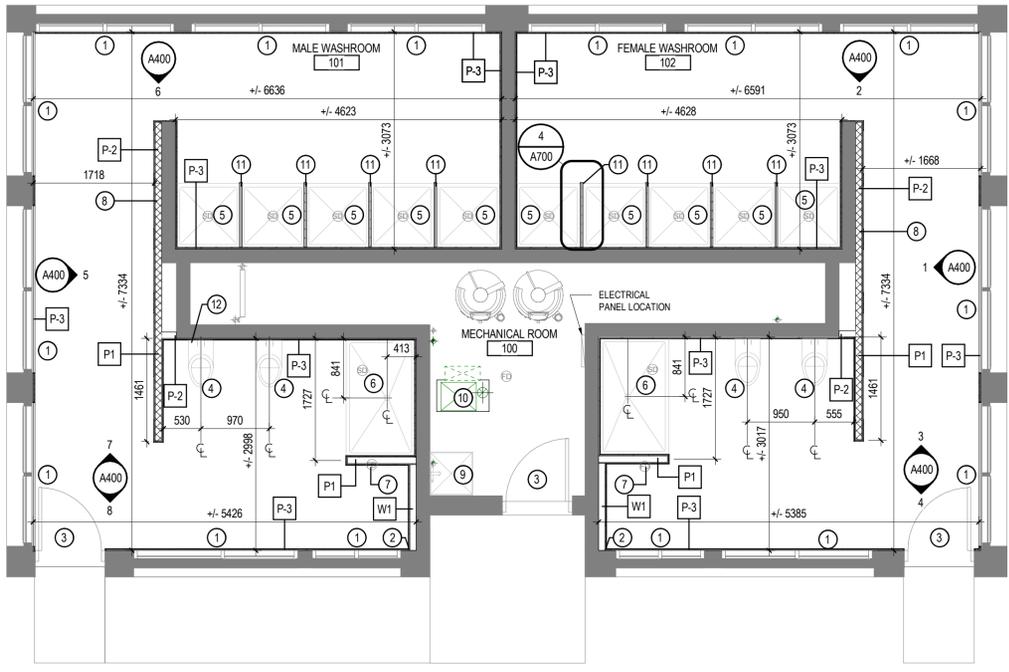

**1 PARTITION PLAN**  
A100 1:50

**SHEET NOTES - REFLECTED CEILING PLAN**


- A. THIS DRAWING IS FOR THE LOCATION AND DIMENSIONS OF A PORTION OF FIXTURES, OUTLETS, GRILLES, DIFFUSERS AND OTHER EQUIPMENT AND DEVICES. IT IS NOT INTENDED TO INDICATE THE COMPLETE SCOPE OF MECHANICAL AND ELECTRICAL WORK. REPORT ANY DISCREPANCIES BETWEEN THIS DRAWING AND ENGINEERS' DRAWINGS TO THE CONSULTANT IMMEDIATELY.
- B. ADVISE CONSULTANT IMMEDIATELY UPON DISCOVERY OF INTERFERENCE WITH STRUCTURAL MEMBERS, DUCTS, PIPES OR OTHER BUILDING SERVICES THAT WILL AFFECT LAYOUT AS INDICATED ON DRAWINGS. ADJUST LOCATIONS AS REQUIRED AS AGREED TO BY CONSULTANT.
- C. PAINT EXPOSED SURFACES OF PAINTABLE ACCESS PANELS, GRILLES AND LINEAR DIFFUSERS TO MATCH THE CEILING COLOUR.
- D. PRIOR TO GWB INSTALLATION, PAINT ALL FRAMING VISIBLE THROUGH RETURN AIR SLOTS OR CEILING OPENINGS BLACK.
- E. PAINT ALL CEILING COVES, REVEALS AND RECESSES TO MATCH CEILING COLOUR UNLESS OTHERWISE NOTED.
- F. ALL MECHANICAL AND ELECTRICAL ELEMENTS NOT SHOWN (INCLUDING, SENSORS, STROBE LIGHTS ETC.) ARE TO BE COORDINATED TO ALIGN AND BE CENTERED WITH OTHER CEILING ELEMENTS AS SHOWN.
- G. PROVIDE ALL FRAMING / BLOCKING AS REQUIRED TO ENSURE PROPER SECUREMENT OF ALL MATERIALS, EQUIPMENT, ACCESSORIES, ETC.
- H. ALL NEW CEILING FRAMING TO BE COMPLETED IN HOUSE BY OWNER. GC TO SUPPLY AND INSTALL NEW GWB/ TILE BACKER BOARD.
- I. ALL NEW FRAMING TO BE COMPLETED IN HOUSE. GC TO ENSURE STRUCTURAL ADEQUACY OF OWNER CONSTRUCTED CEILINGS, PRIOR COMMENCEMENT OF WORK.

**CEILING LEGEND**


	GWB-EX EXISTING GYPSUM BOARD CEILING TO REMAIN.
	GWB-1 NEW 16mm GYPSUM BOARD CEILING INSTALLED ONTO EXISTING FRAMING
	T-3 TILE BACKER BOARD CEILING FINISHED W/ CERAMIC TILE REFER TO FINISH PLAN
	NEW SURFACE MOUNTED 305mm x 1200mm LUMINAIRE LOCATION
	NEW RECESSED POT LUMINAIRE LOCATION
	NEW RECESSED 305mm x 305mm DIFFUSER GRILLE REFER TO MECHANICAL DRAWINGS LOCATION
	NEW RECESSED 610x610 ACCESS PANEL LOCATION
	NEW RECESSED RETURN AIR GRILLE LOCATION. REFER TO MECHANICAL
	NEW RECESSED SUPPLY AIR DIFFUSER LOCATION. REFER TO MECHANICAL

**KEYED NOTES - RCP**


- NEW GYPSUM 16mm BOARD CEILING TO BE FINISHED W/ PT-01
- INSTALL NEW INSULATED RECESSED 610MM X 610MM ACCESS PANEL. FRAMED IN OPENING COMPLETED BY OWNER. COORDINATE ROUGH OPENING DIMENSIONS
- INSTALL STARTER EDGE STRIP (BY SCHLUTER OR EQUAL) AT TRANSITION BETWEEN TILE AND GWB CEILING
- INSTALL NEW TILE BACKER BOARD WHERE TILE IS TO BE INSTALLED ON CEILING. FINISH WITH T-3
- PRIOR TO INSTALLATION OF GYPSUM BOARD/ TILE BACKER INSTALL 6 MIL POLYETHYLENE VAPOUR BARRIER. TIE INTO EXISTING VAPOUR BARRIER ON EXTERIOR WALLS.
- AFTER INSTALLATION OF GYPSUM BOARD/ TILE BACKER INFILL ATTIC SPACE WITH MINERAL WOOL BATT INSULATION TO AN EFFECTIVE RSI VALUE OF 7.04 (R-40).
- ALL LUMINAIRES AND LIGHTING EQUIPMENT TO BE SUPPLIED AND INSTALL BY OWNER.
- ENSURE AIR CIRCULATION BETWEEN EXISTING SOFFET AND NEW ATTIC CAVITY. REMOVE EXISTING CEILING INSULATION AT SOFFET LOCATIONS AND INSTALL NEW INSULATION STOPS BETWEEN NEW CEILING TRUSSES.
- CEILING TILE START POINT. BEGIN TILE PATTERN WITH A FULL TILE.
- PROVIDE 19mm PLYWOOD BLOCKING TO SUPPORT CEILING SUPPORTED WASHROOM PARTITION PANEL.
- PATCH AND REPAIR EXISTING GWB CEILING TO RECEIVE NEW FINISHES. REPAIR UNUSED OPENINGS FROM REMOVED HVAC SYSTEM. PAINT WITH PT-01 FINISH.
- REMOVE POLY VAPOUR BARRIER AND INSULATION FROM EXISTING VAULTED CEILING. ENSURE ADEQUATE AIR CIRCULATION FROM SOFFETS INTO NEW ATTIC SPACE.

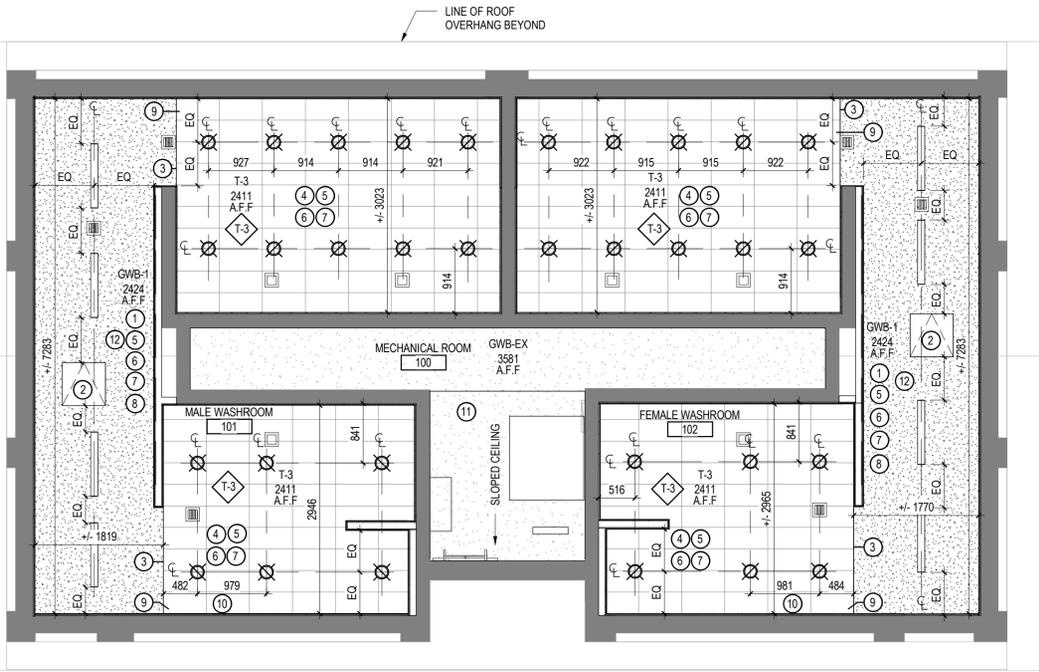

**2 REFLECTED CEILING PLAN**  
A100 1:50

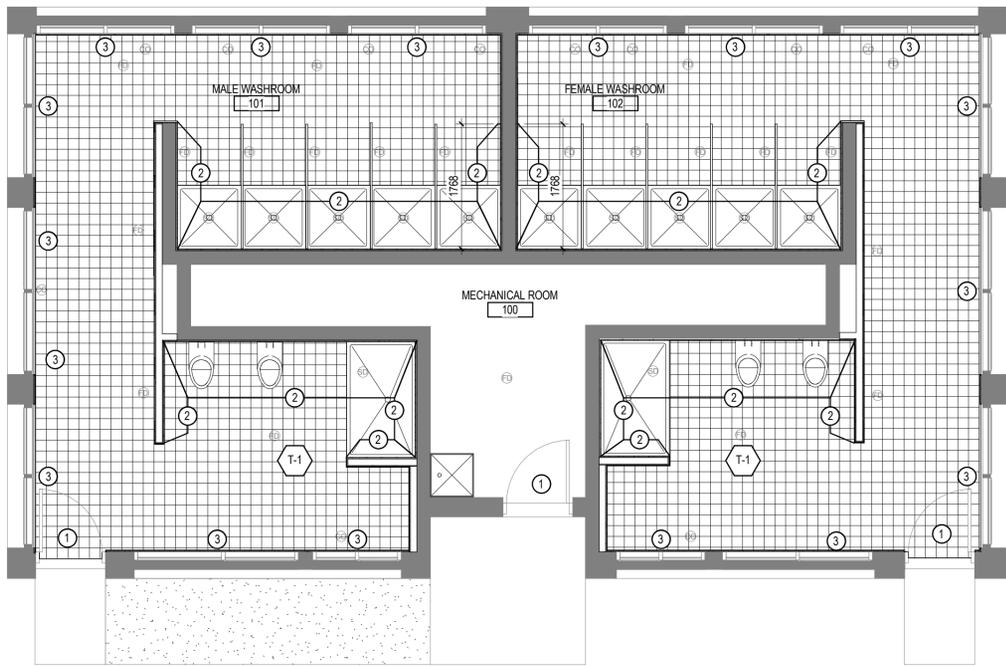

**1 FINISH PLAN**  
A200 1:50

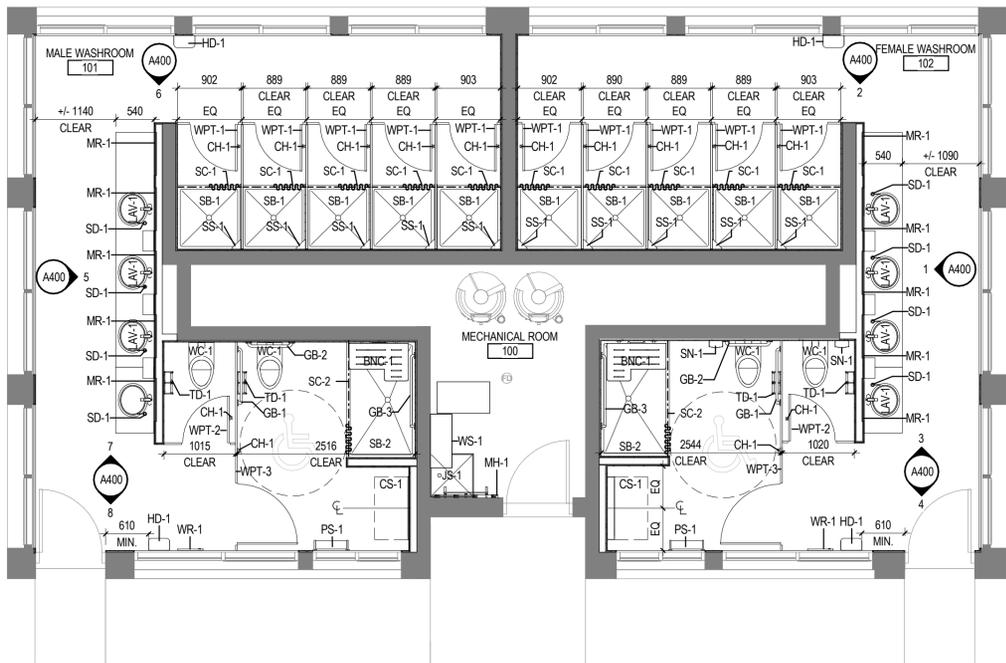

**2 EQUIPMENT PLAN**  
A200 1:50

### SHEET NOTES - WALL FINISHES

- A. REMOVE ALL SURFACE APPLIED ACCESSORIES, COVER PLATES, AND OTHER DEVICES PRIOR TO PREPARING WALLS FOR NEW FINISHES. RE-INSTALL AFTER FINISHING IS COMPLETE.
- B. PAINT EXPOSED SURFACES OF PAINTABLE GRILLES AND DIFFUSERS TO MATCH THE ADJACENT WALL OR CEILING COLOUR UNLESS OTHERWISE NOTED.
- C. ALL MATERIALS ARE TO BE PRIMED AND PAINTED UNLESS NOTED OTHERWISE. PROVIDE COLOR COORDINATED SEALANT BETWEEN DISSIMILAR MATERIALS

### SHEET NOTES - FLOOR FINISHES

- A. ALL FLOORING CHANGES AND TRANSITION STRIPS TO OCCUR UNDER CENTERLINE OF DOORS UNLESS OTHERWISE NOTED.
- B. FEATHER AND/OR LEVEL CONCRETE FLOORS WITH CONCRETE TOPPING AS REQUIRED TO BRING ADJACENT MATERIALS FLUSH AND TO FACILITATE OTHER INSTALLATION. SLOPE TO BE 3.1mm MAXIMUM PER 305mm.
- C. ALL MATERIALS ARE TO BE PRIMED AND PAINTED UNLESS NOTED OTHERWISE. PROVIDE COLOR COORDINATED SEALANT BETWEEN DISSIMILAR MATERIALS
- D. PATCH ALL DAMAGED FLOOR AREAS WITH SUITABLE LATEX CONCRETE FILLER DEPENDING ON EXTENT OF DAMAGE. FILL AND LEVEL FLOOR SLAB TO THE TOLERANCES SPECIFIED. APPLY SEALER TO THE CONCRETE SLAB WHERE AFFECTED
- E. MAINTAIN ACCESS AND FUNCTION OF ALL EXISTING FLOOR DRAINS AND CLEAN OUTS.
- F. ADJUST ALL EXISTING FLOOR DRAINS AND CLEAN OUTS TO BE FLUSH WITH NEW FLOOR FINISH.
- G. NEW FLOOR FINISH TO TERMINATE AT NEW SHOWER BASINS.
- H. NEW FLOOR FINISH TO SLOPE TO EXISTING FLOOR DRAINS. UNO.

FINISH SCHEDULE-ROOM DATA						
NUMBER	NAME	AREA	FLOOR FINISH	WALL FINISH	CEILING FINISH	COMMENTS
100	MECHANICAL ROOM	13.14 m <sup>2</sup>	EX	EX	EX	
101	MALE WASHROOM	36.93 m <sup>2</sup>	T-1	T-2/T-3	T-3/GWB	
102	FEMALE WASHROOM	36.73 m <sup>2</sup>	T-1	T-2/T-3	T-3/GWB	

### KEYED NOTES - FINISHES

- 1 PAINT BOTH SIDES OF DOOR AND FRAME WITH PT-02 EXTERIOR GRADE PAINT.
- 2 FINISH WALLS WITH FULL HEIGHT T-2
- 3 FINISH NEW WINDOW CASING WITH PT-02

### FINISH LEGEND

	T-1	152mm x 152mm QUARRY TILE MANUFACTURER: DAL TILE SERIES: QUARRY TILE COLOUR/FINISH: ARID GRAY-0042 (2) GROUT: FLEXITILE- PEWTER GRAY-688 588
	T-2	203mm x 1219mm WALL TILE MANUFACTURER: DAL TILE SERIES: SEASON WOOD COLOUR/FINISH: WEATHERED ORCHARD GRAY- SW01 GROUT TO BE FLEXITILE- BONE-612 512
	T-3	305mm x 610mm WALL & CEILING TILE MANUFACTURER: DAL TILE SERIES: NEXT EG1 COLOUR/FINISH: FIELD TILE FARRINGTON- J100- POLISHED WALL GROUT TO BE FLEXITILE- BONE-612 512 CEILING GROUT TO BE FLEXITILE- SNOW WHITE-651 651
	SSC-1	SOLID SURFACE CORIAN MANUFACTURER: DUPONT SERIES: TERRA COLLECTION COLOUR/FINISH: PLATINUM
	PT-01	CEILING PAINT MANUFACTURER: SHERWIN WILLIAMS COLOUR/FINISH: EXTRA WHITE SW7006
	PT-02	DOOR & TRIM PAINT MANUFACTURER: SHERWIN WILLIAMS COLOUR/FINISH: GAUNTLET GRAY

WASHROOM FIXTURES									
Type Mark	Count	Description	Manufacturer	Model	Contractor Installed	Contractor Supplied	Owner Installed	Owner Supplied	Comments
BNC-1	2	REVERSIBLE SOLID PHENOLIC FOLDING SHOWER SEAT	BOBRICK	B-5181	•	•			CENTER MOUNTED TO INSIDE FACE OF WASHROOM PARTITION DOORS U.N.O
CH-1	14	SURFACE MOUNTED HAT & COAT HOOK	BOBRICK	B-682	•	•			
CS-1	2	KB200-00 SURFACE MOUNTED BABY CHANGING STATION	BOBRICK	KB200-00	•	•			
GB-1	2	STAINLESS STEEL 762X762MM (30"X 30") 90 DEGREE GRAB BAR	BOBRICK	B-5889.99	•	•			32mm (1-1/4") Diameter
GB-2	2	STAINLESS STEEL 610mm (24") GRAB BARS	BOBRICK	B-6806.99x24"	•	•			
GB-3	2	STAINLESS STEEL 762X1000MM (30"X 39") 90 DEGREE GRAB BAR	BOBRICK	B-5889.99	•	•			32mm (1-1/4") Diameter
HD-1	4	AUTOMATIC SENSOR HAND DRYER	N/A	N/A			•	•	COORDINATE INSTALLATION WITH PROJECT MANAGER
JS-1	1	MOP SINK					•	•	COORDINATE INSTALLATION WITH PROJECT MANAGER
LAV-1	8	UNDERMOUNT LAVATORY					•	•	COORDINATE INSTALLATION WITH PROJECT MANAGER
MH-1	1	BOBRICK B-224 UTILITY SHELF WITH RAG HOOKS AND BROOM HOLDERS	BOBRICK	B-224	•	•			
MR-1	10	6.35mm (1/4") SILVERED FLOAT GLASS			•	•			
PS-1	2	STAINLESS STEEL SHELF, SURFACE MOUNTED	BOBRICK	B-683	•	•			
SB-1	10	STANDARD SHOWER BASE PRECAST TERRAZZO			•	•			914 x 914 x 152 mm (36" x 36" x 6")- REFER TO MECHANICAL DRAWINGS
SB-2	2	WHEEL CHAIR ACCESSIBLE SHOWER BASE PRECAST TERRAZZO			•	•			914 x 1500 x 152 mm (36" x 60" x 6")- REFER TO MECHANICAL DRAWINGS
SC-1	10	BREAK AWAY SHOWER CURTAIN ROD AND HOOKS	BOBRICK	B-6047x915	•	•			
SC-2	2	BREAK AWAY BARRIER FREE SHOWER ROD AND HOOKS	BOBRICK	B-6047x1830	•	•			
SD-1	8	BREAK AWAY BARRIER FREE SHOWER CURTAIN			•	•			
SD-1	8	LAVATORY MOUNTED SOAP DISPENSER	BOBRICK	B-822	•	•			
SN-1	2	CONTURA SERIES SURFACE MOUNTED SANITARY NAPKIN DISPOSAL	BOBRICK	B-270	•	•			
SS-1	10	SMALL STAINLESS STEEL SHOWER CORNER CADDY	DELTA FAUCET COMPANY	47000-ST	•	•			
TD-1	4	SURFACE MOUNTED DOUBLE TOILET TISSUE DISPENSER	BOBRICK	B-2760	•			•	COORDINATE WITH PROJECT MANAGER
WC-1	4	WALL HUNG ELONGATED WATER CLOSET					•	•	COORDINATE INSTALLATION WITH PROJECT MANAGER
WPT-1	10	CLASS B FIRE-RESISTANT SOLID PLASTIC PARTITIONS, SCREENS AND DOORS	HADRIAN	HEADRAIL BRACED-FINISH 239 GRAY	•	•			CONSTRUCTED WITH GAP FREE PRIVACY HARDWARE OPTION. DOOR HARDWARE BY SUPPLIER.
WPT-2	2	CLASS B FIRE-RESISTANT SOLID PLASTIC PARTITIONS, SCREENS AND DOORS	HADRIAN	HEADRAIL BRACED-FINISH 239 GRAY	•	•			CONSTRUCTED WITH GAP FREE PRIVACY HARDWARE OPTION. DOOR HARDWARE BY SUPPLIER.
WPT-3	2	CLASS B FIRE-RESISTANT SOLID PLASTIC PARTITIONS, SCREENS AND DOORS	HADRIAN	HEADRAIL BRACED-FINISH 239 GRAY	•	•			CONSTRUCTED WITH GAP FREE PRIVACY HARDWARE OPTION. DOOR HARDWARE BY SUPPLIER. ENSURE B.F COMPLIANT
WR-1	2	TRIMLINESERIES™ RECESSED WASTE RECEPTACLE WITH DISPOSAL DOOR	BOBRICK	B-35633	•	•			
WS-1	1	305mm x 762mm WALL MOUNTED WIRE SHELF			•	•			



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4	ISSUED FOR TENDER	DG	SS	2017.12.15
3	ISSUED FOR 80% REVIEW	DG	SS	2017.12.06
2	ISSUED TO COST CONSULTANT	DG	SS	2017.12.05
1	ISSUED FOR 50% REVIEW	DG	SS	2017.11.17

Issued By Appd YYYY.MM.DD

PACKAGE A By Appd YYYY.MM.DD

File Name: N/A Author Dwnr. Designer Dsgn. Checker Chkd. 10/19/17  
YYYY.MM.DD

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Lake Louise Campground – Tent Side Shower Building Renovation

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T0L

Title  
FINISH & EQUIPMENT PLAN

Project No. 113678159 Scale As indicated

Revision 4 Drawing No. A200

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Lake Louise Campground – Tent Side Shower Building Renovation

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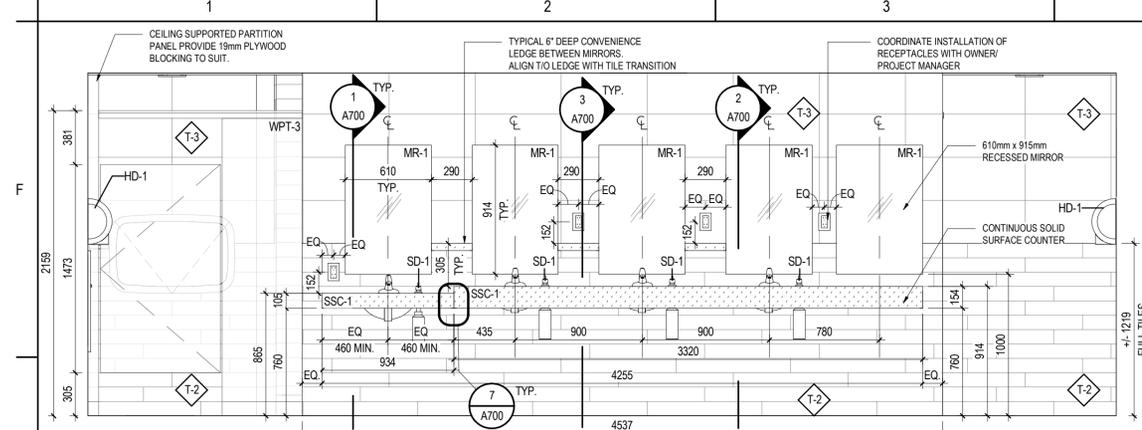
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ELEVATIONS

Project No.  
113678159

Revision  
4


Scale  
As indicated

Drawing No.  
A400




**1 FEMALE WASHROOM- INTERIOR ELEVATION- WASH BASIN**  
A400 1:25

REFER TO TYPICAL MOUNTING HEIGHT DETAIL ON SHEET A700 FOR MOUNTING HEIGHTS OF ALL FIXTURES.

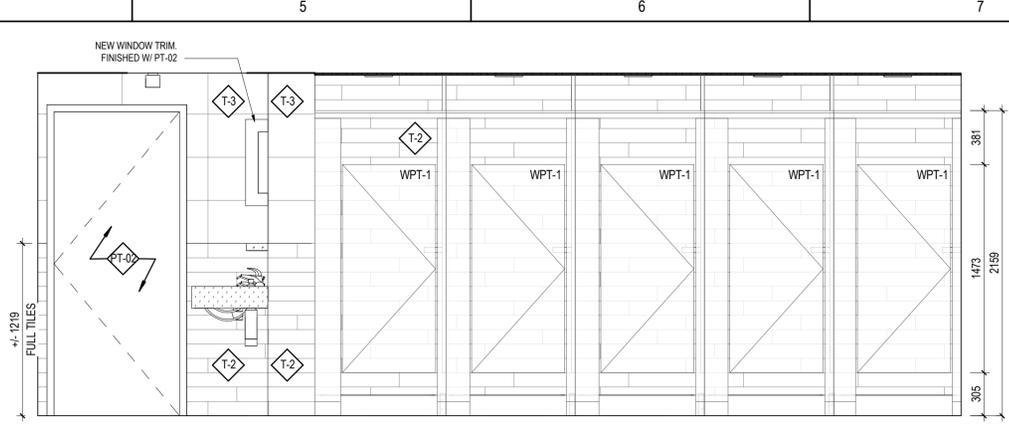


**2 FEMALE WASHROOM- ELEVATION- SHOWERS**  
A400 1:25

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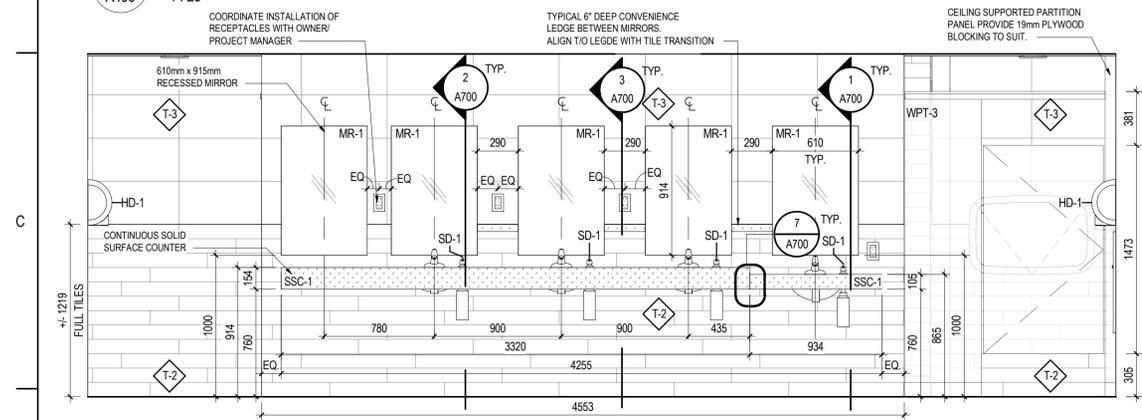
**3 FEMALE WASHROOM- INTERIOR ELEVATION- WATER CLOSETS**  
A400 1:25

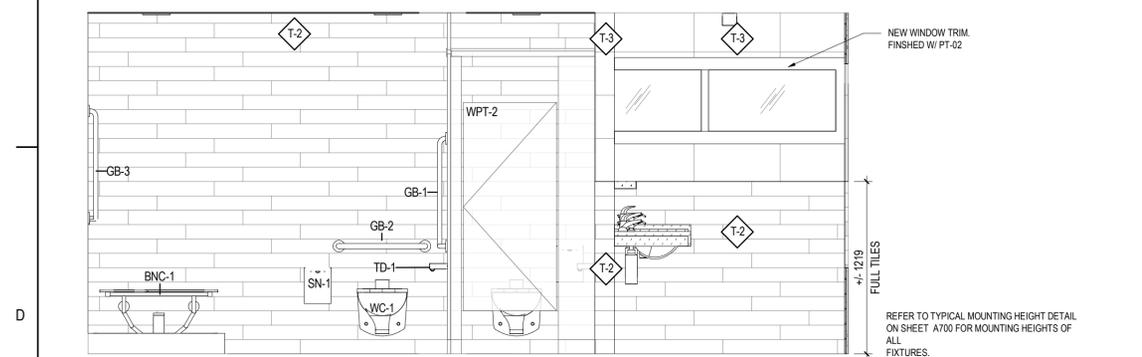REFER TO TYPICAL MOUNTING HEIGHT DETAIL ON SHEET A700 FOR MOUNTING HEIGHTS OF ALL FIXTURES.




**4 FEMALE WASHROOM- ENTRY**  
A400 1:25

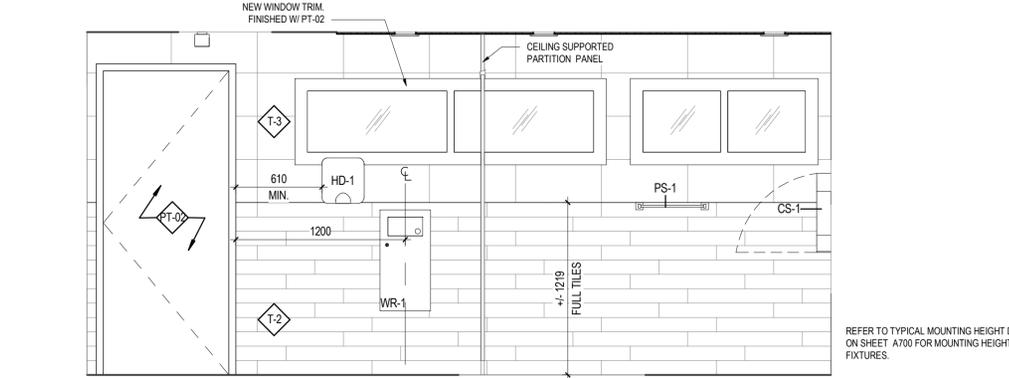REFER TO TYPICAL MOUNTING HEIGHT DETAIL ON SHEET A700 FOR MOUNTING HEIGHTS OF ALL FIXTURES.




**5 MALE WASHROOM- INTERIOR ELEVATION- WASH BASIN**  
A400 1:25

REFER TO TYPICAL MOUNTING HEIGHT DETAIL ON SHEET A700 FOR MOUNTING HEIGHTS OF ALL FIXTURES.

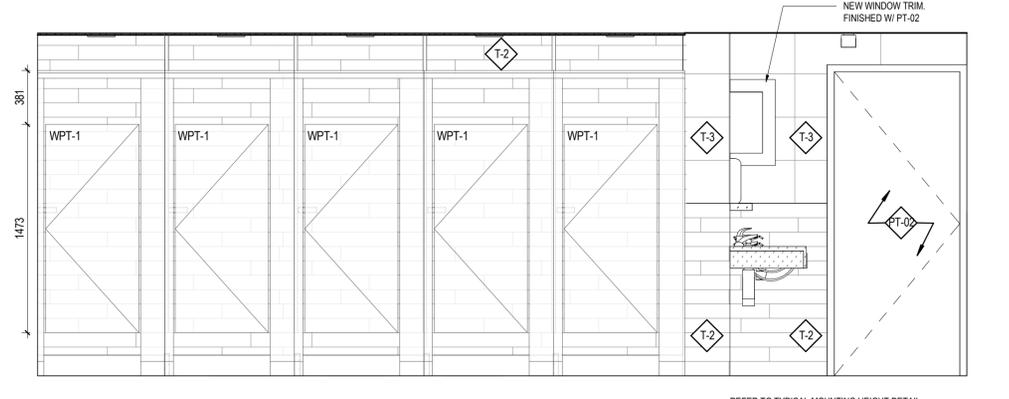


**6 MALE WASHROOM- ELEVATION- SHOWERS**  
A400 1:25

REFER TO TYPICAL MOUNTING HEIGHT DETAIL ON SHEET A700 FOR MOUNTING HEIGHTS OF ALL FIXTURES.

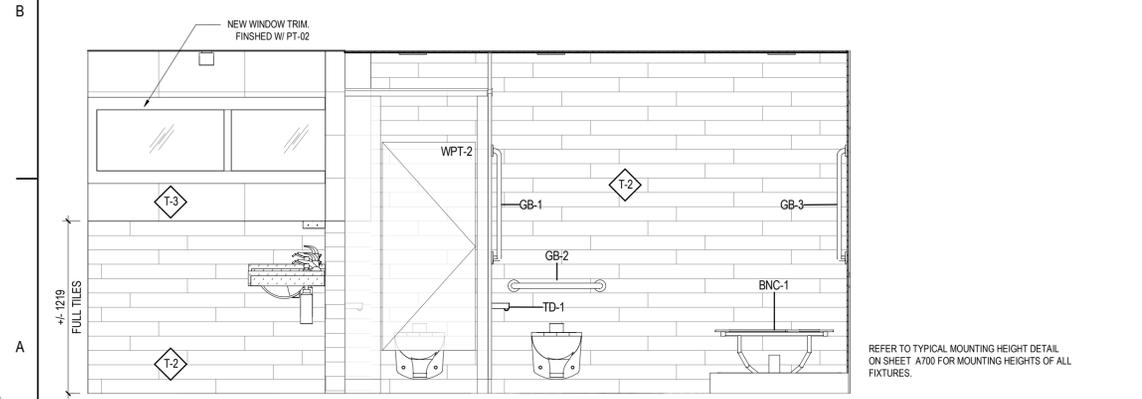

**7 MALE WASHROOM- INTERIOR ELEVATION- WATER CLOSETS**  
A400 1:25

REFER TO TYPICAL MOUNTING HEIGHT DETAIL ON SHEET A700 FOR MOUNTING HEIGHTS OF ALL FIXTURES.

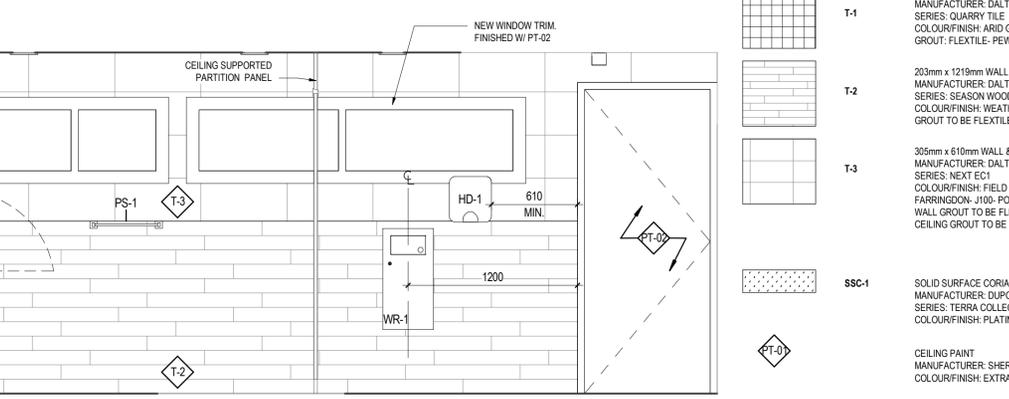


**8 MALE WASHROOM- ENTRY**  
A400 1:25


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**FINISH LEGEND**


- T-1** 152mm x 152mm QUARRY TILE  
MANUFACTURER: DAL TILE  
SERIES: QUARRY TILE  
COLOUR/FINISH: ARID GRAY- 0042 (2)  
GROUT: FLEXTILE- PEWTER GRAY-688 588
- T-2** 203mm x 1219mm WALL TILE  
MANUFACTURER: DAL TILE  
SERIES: SEASON WOOD  
COLOUR/FINISH: WEATHERED ORCHARD GRAY- SW01  
GROUT TO BE FLEXTILE- BONE-612 512
- T-3** 305mm x 610mm WALL & CEILING TILE  
MANUFACTURER: DAL TILE  
SERIES: NEXT EC1  
COLOUR/FINISH: FIELD TILE  
FARRINGTON- J100- POLISHED  
WALL GROUT TO BE FLEXTILE- BONE-612 512  
CEILING GROUT TO BE FLEXTILE- SNOW WHITE-651 551
- SSC-1** SOLID SURFACE CORIAN  
MANUFACTURER: DUPONT  
SERIES: TERRA COLLECTION  
COLOUR/FINISH: PLATINUM
- PT-02** CEILING PAINT  
MANUFACTURER: SHERWIN WILLIAMS  
COLOUR/FINISH: EXTRA WHITE SW7006
- PT-02** DOOR & TRIM PAINT  
MANUFACTURER: SHERWIN WILLIAMS  
COLOUR/FINISH: GAUNTLET GRAY

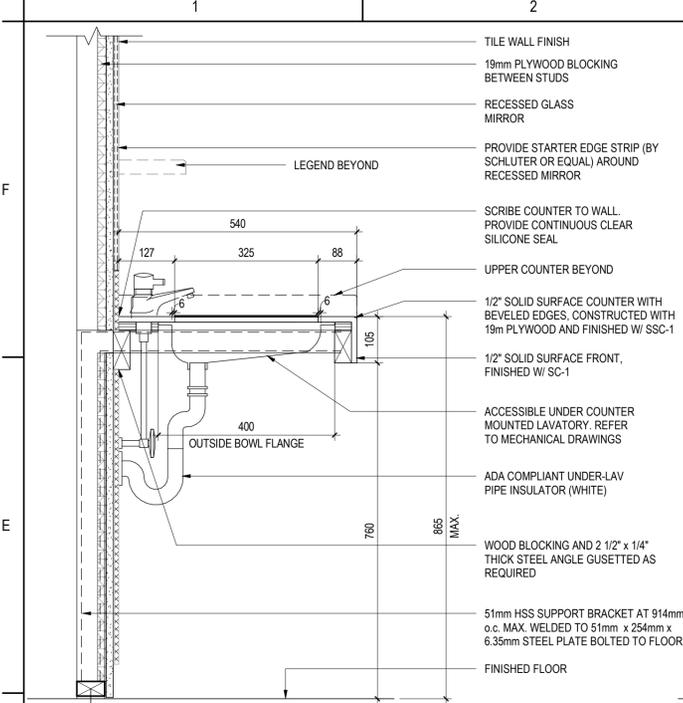


**1 MILLWORK SECTION- B.F. COUNTER**  
A700 1:8

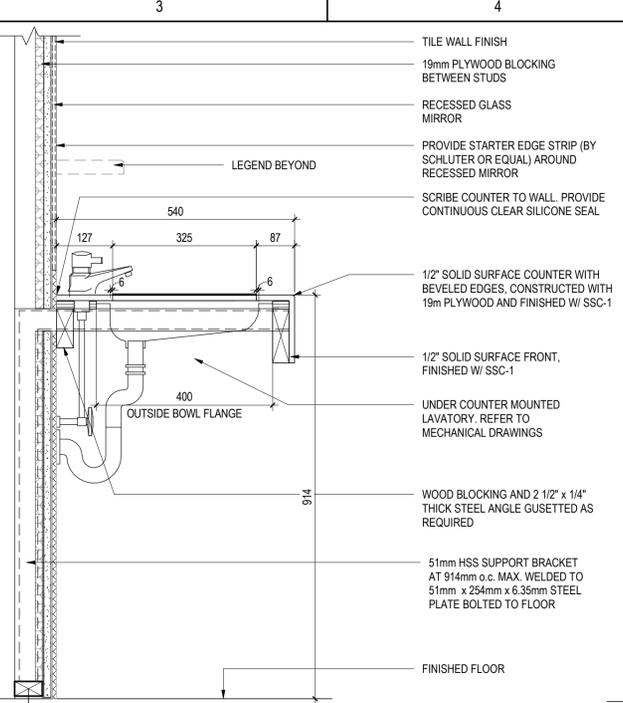


**2 MILLWORK SECTION- TYPICAL COUNTER**  
A700 1:8

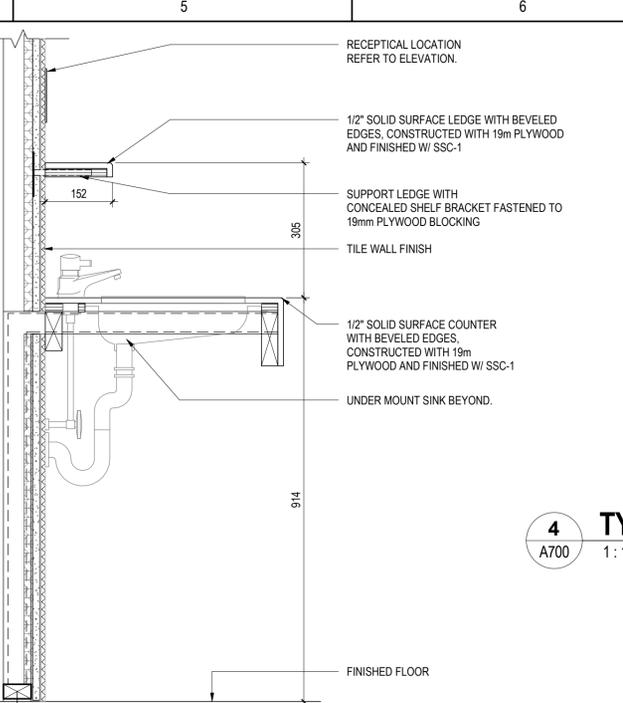


**3 MILLWORK SECTION- WASHROOM LEDGE**  
A700 1:8

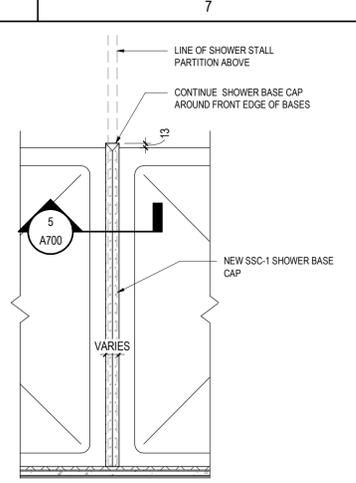


**4 TYP. PLAN DETAIL- SHOWER CAP**  
A700 1:10

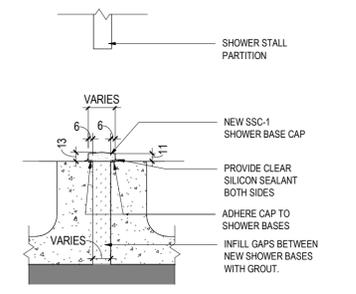

**5 TYP. SECTION DETAIL- SHOWER CAP**  
A700 1:5

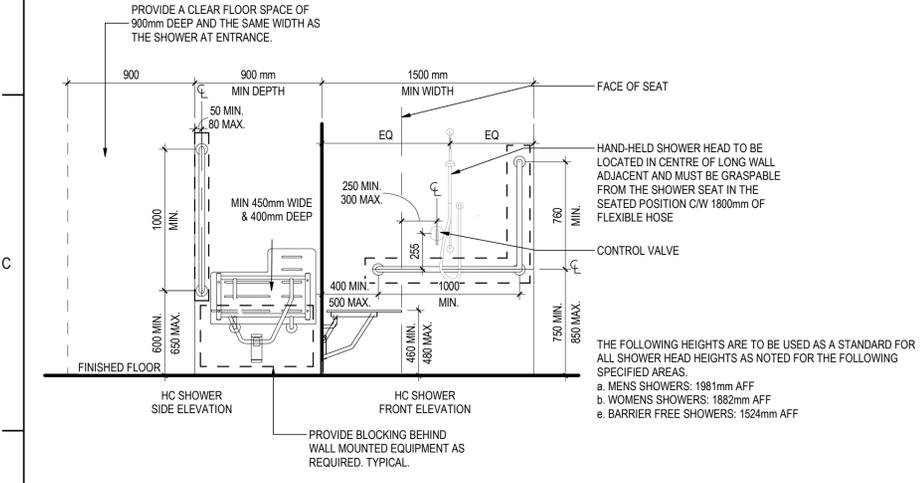

**7 MILLWORK DETAIL- COUNTER DETAIL**  
A700 1:4

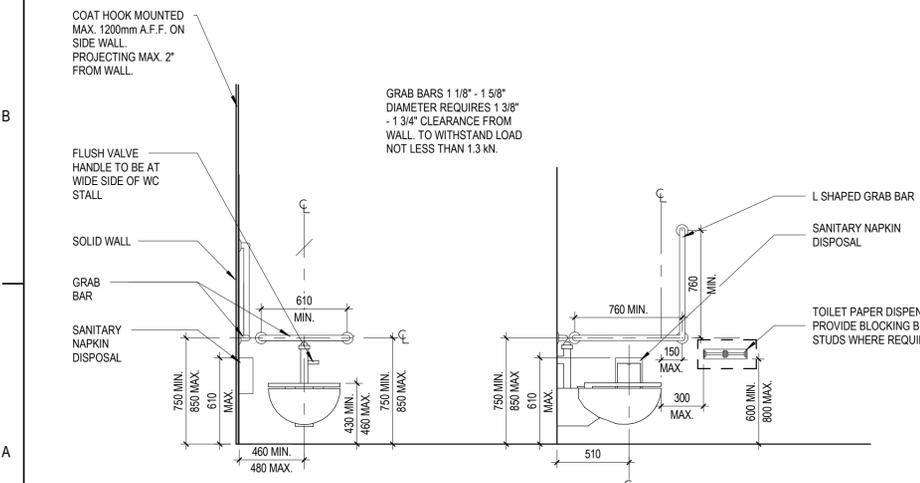

**6 TYPICAL WASHROOM FIXTURE MOUNTING HEIGHTS**  
A700 1:25



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File Name: N/A	Author Dwn.	Designer Dsgn.	Checker Chkd.
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Title  
TYPICAL DETAILS

Project No. 113678159	Scale As indicated
Revision 4	Drawing No. A700





