


Public Works and Government Services Canada

PENTICTON AIRPORT EXTERNAL WATER SUPPLY CONNECTION

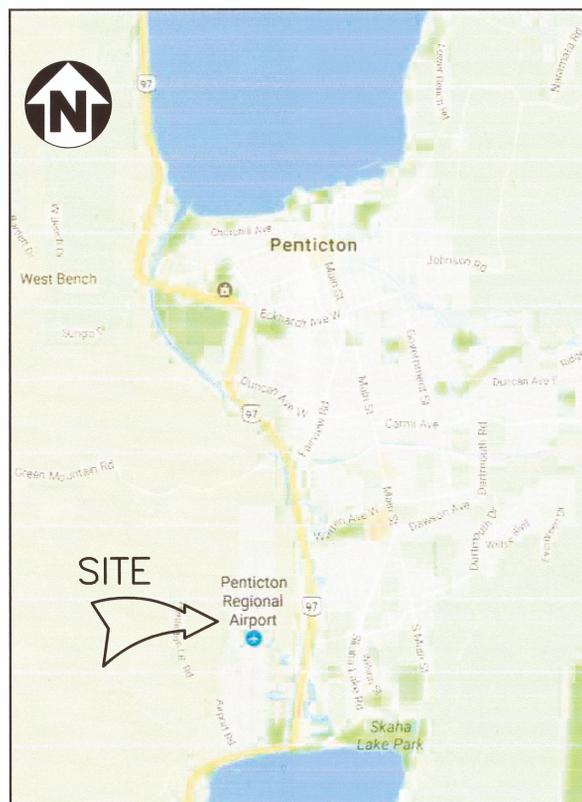

LOCATION PLAN
N.T.S.



KEY PLAN
N.T.S.

DRAWING No: TITLE:

- C-001 INDEX
- C-002 PLAN - PROFILE AND TIE-IN DETAILS
- C-003 PRESSURE REDUCING VALVE CHAMBER - DETAILS AND GENERAL NOTES
- C-004 LESSEE - LOCATION PLAN
- C-005 LESSEE LOCATION PLAN - WATER METER LOCATIONS
- C-006 LESSEE LOCATION PLAN - WATER METER LOCATIONS
- C-007 LESSEE LOCATION PLAN - WATER METER LOCATIONS
- C-008 DEMOLITION PLAN

Revision/Revisão	Description/Description	Date/Date
4	Issued for Tender	31/03/2017
3	Issued for 100% Review	02/28/2017
2	Issued for 95% Review	08/19/2016
1	ISSUED FOR 66% REVIEW	03/12/2016

Client/client
PUBLIC WORKS AND AND GOVERNMENT SERVICES CANADA
 219-800 Burrard Street
 Vancouver, BC, V6Z 0B9

Project title/Titre du projet
PENTICTON AIRPORT
 PENTICTON, BC

EXTERNAL WATER SUPPLY CONNECTION

Consultant Signature Only
 CONSULTANT_SIGNATURE_ONLY
 Designed by/Concept par
 B. MARSHALL


Drawn by/Dessiné par
 T. Gernshied - 2016/03/31

PWSSC Project Manager/Administrateur de Projets TPSSC
 JIMMY WONG


Regional Manager, Architectural and Engineering Services
 Gestionnaire régional, Services d'architecture et de génie, TPSSC
 PREETIPAL PAUL

Drawing title/Titre du dessin
INDEX

Project No./No. du projet R.073300.101	Sheet/Feuille C-001 OF 8	Revision no./La Révision no. 4
---	---------------------------------------	--

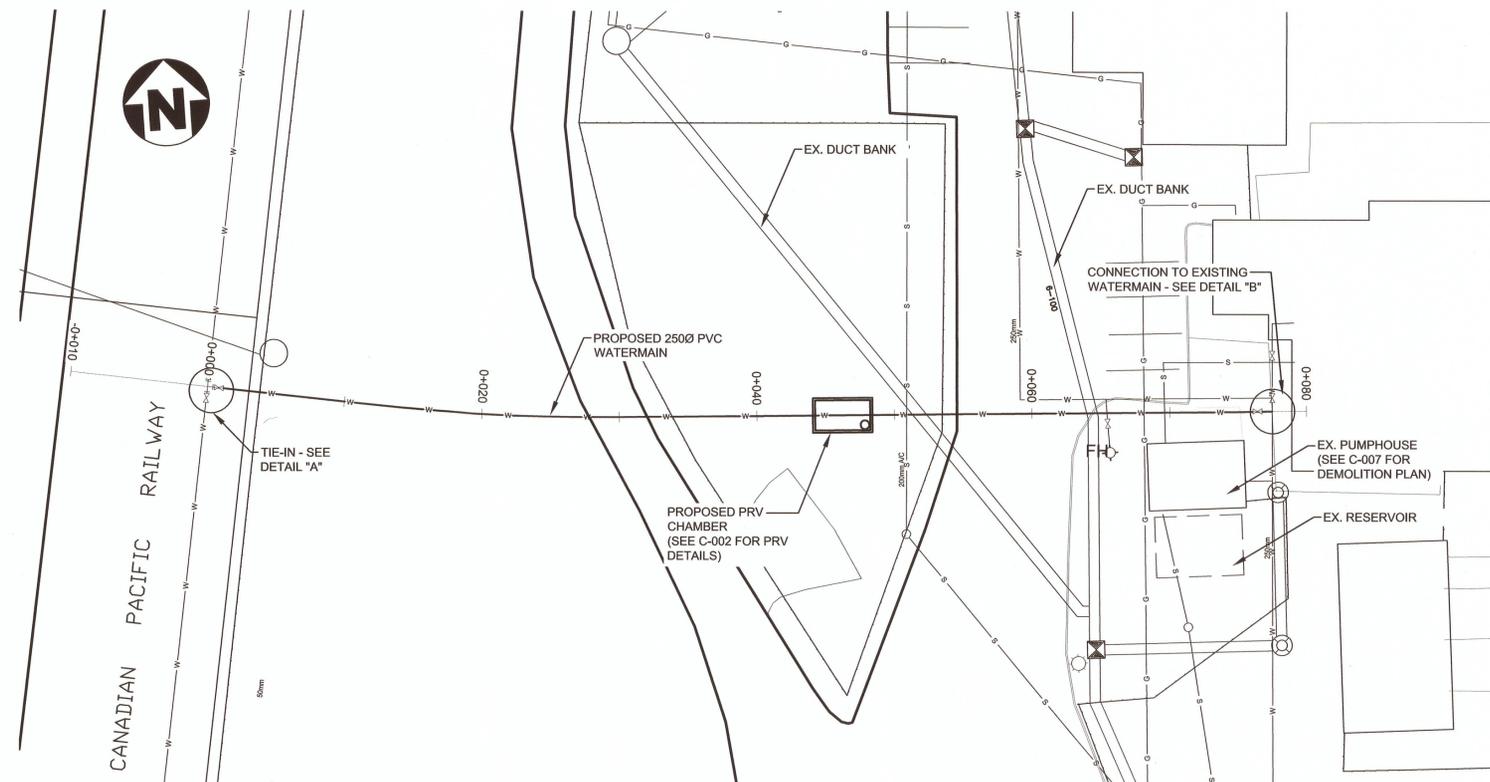


SITE PLAN
1:250

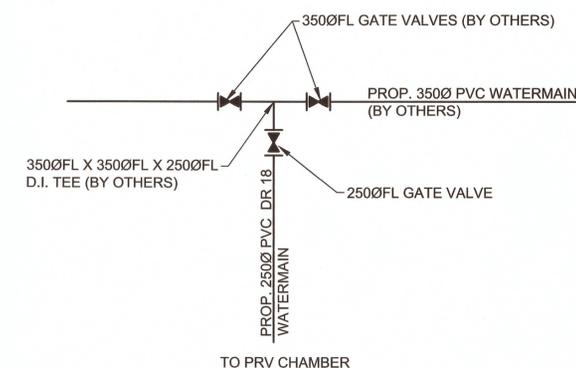



DETAIL "A"

STA. 2+385 WATERMAIN EXTENSION TO LOT 116 SCHEMATIC LAYOUT
N.T.S.

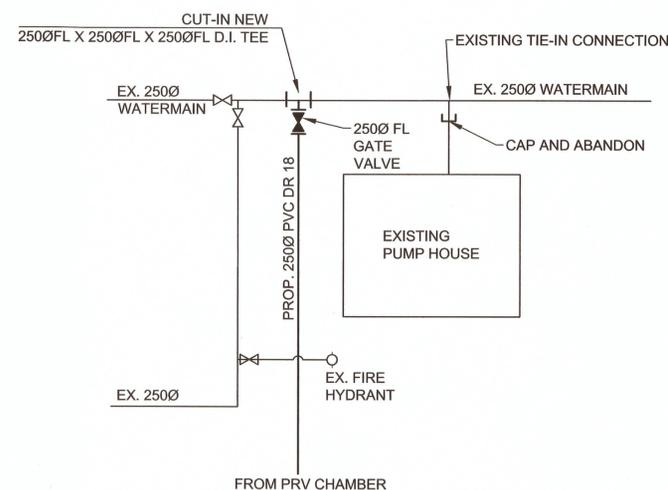


DETAIL "B"

N.T.S.

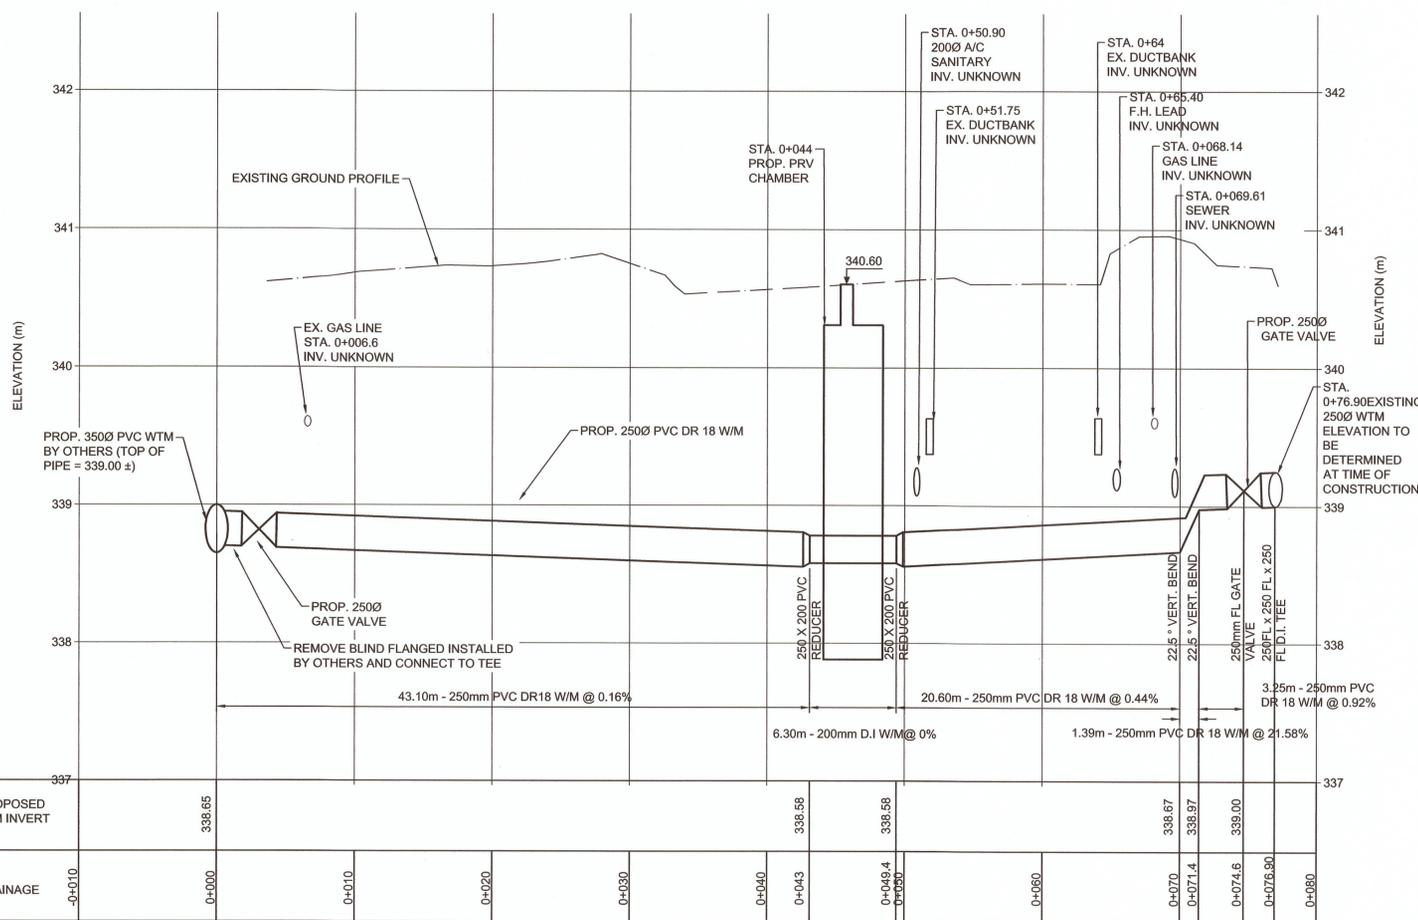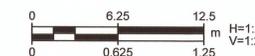

PLAN/PROFILE

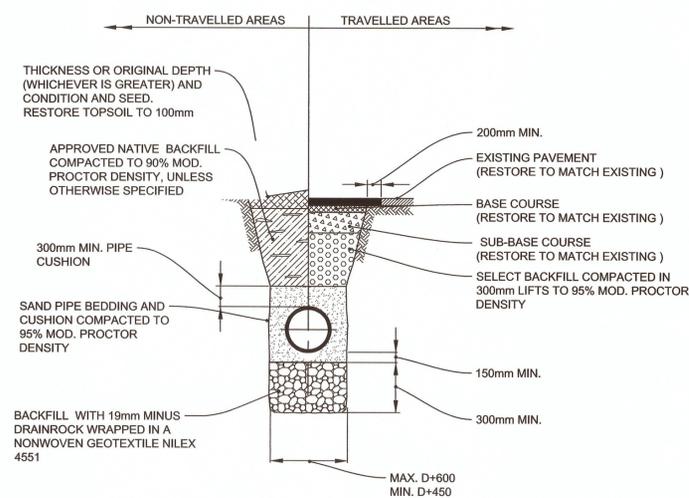

TYPICAL TRENCH DETAIL

N.T.S.

Revision/	Description/Description	Date/Date
4	ISSUED FOR TENDER	03/01/2017
3	ISSUED FOR 100% REVIEW	02/28/2017
2	ISSUED FOR 99% REVIEW	08/19/2016
1	ISSUED FOR 90% REVIEW	03/01/2016

Client/Client
PUBLIC WORKS AND GOVERNMENT SERVICES CANADA
219-800 Burrard Street
Vancouver, BC, V6Z 0B9

Project Title/Titre du projet
**PENTICTON AIRPORT
PENTICTON, BC**

EXTERNAL WATER SUPPLY CONNECTION

Consultant Signature Only
CONSULTANT_SIGNATURE_ONLY

Designed by/Concept par
B. Marshall


Drawn by/Dessiné par
T.Germsheld - 2016/03/31

PWOSC Project Manager/Administrateur de Projets TPSGC
JIMMY WONG


Regional Manager, Architectural and Engineering Services
Gestionnaire régionale, Services d'architecture et de génie, TPSGC
PREEETIPAL PAUL

Drawing Title/Titre du dessin
PLAN AND PROFILE AND TIE-IN DETAILS

Project No./No. du projet	Sheet/Feuille	Revision no./La Revision no.
R.073300.101	C-002 OF 8	4

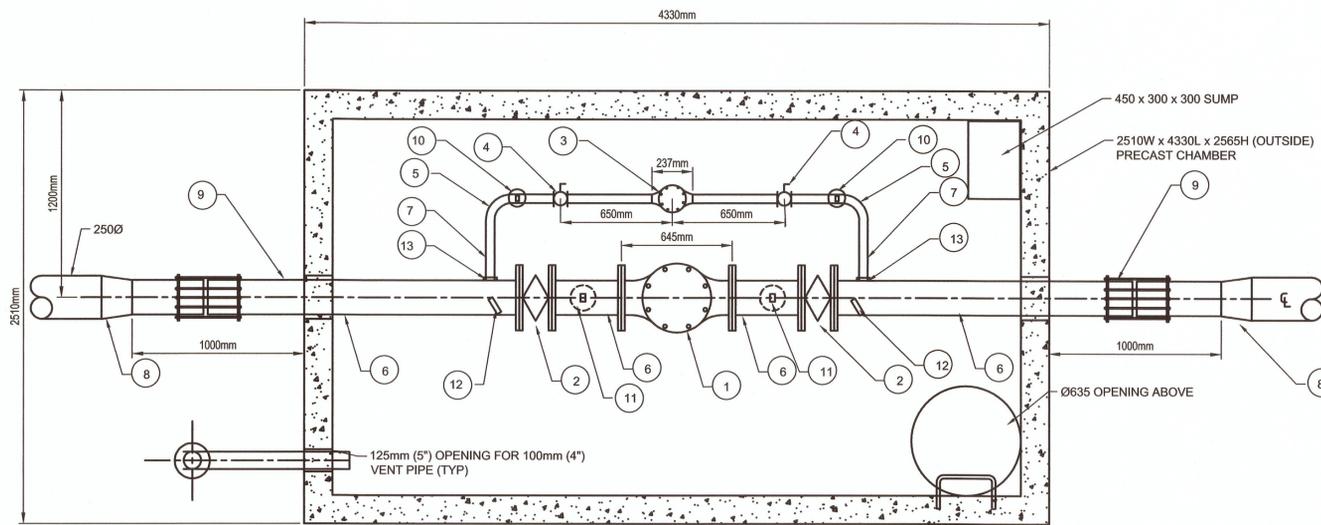

PLAN VIEW 1:20

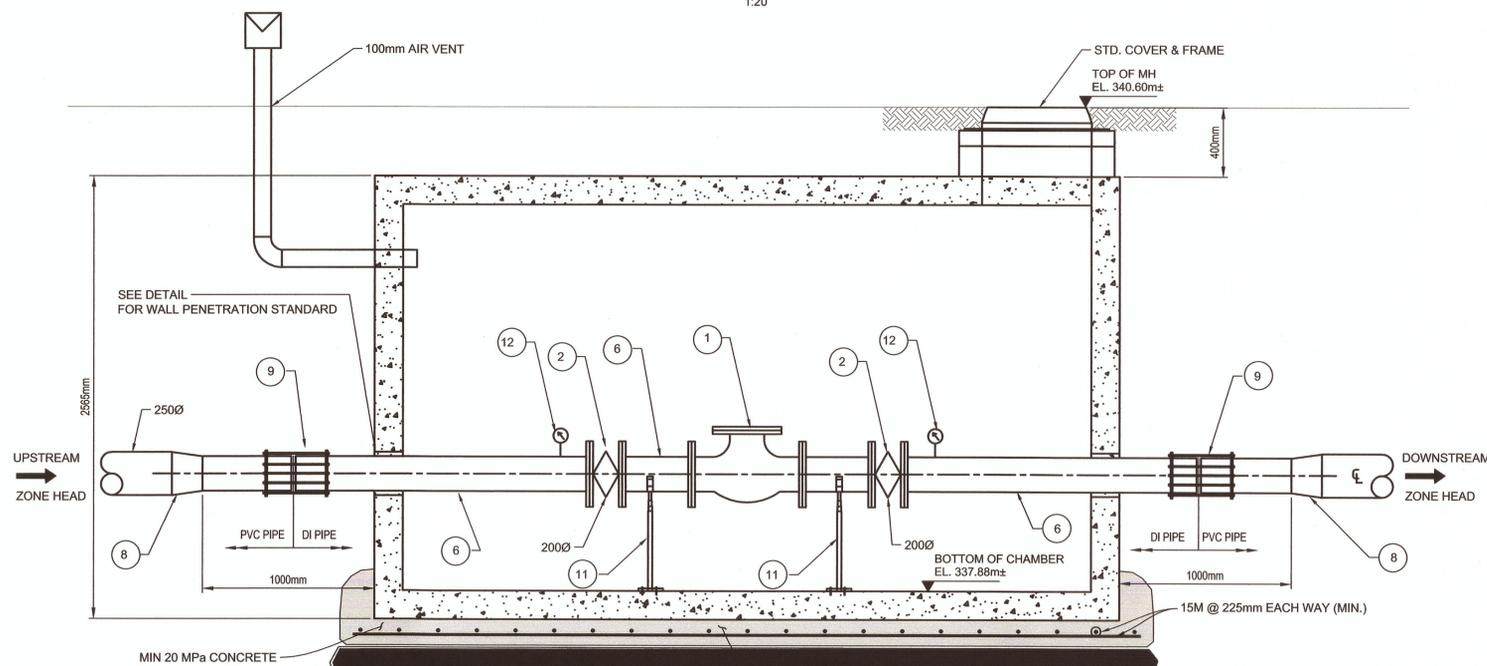


SECTION VIEW 1:20

300mm THICK SAND & CLEAR CRUSHED GRAVEL (19mm MINUS) WRAPPED IN A NONWOVEN GEOTEXTILE NILEX 4551

BASE TO BE PRE-CAST OR CAST-IN-PLACE AT CONTRACTOR'S OPTION

ITEM #	DESCRIPTION
1	200mm PRESSURE REDUCING VALVE
2	200mm FLANGED GATE VALVE
3	50mm PRESSURE REDUCING VALVE
4	50mm THREADED BALL VALVE
5	50mm SCHEDULE 40 G.I. 90 DEGREE BEND
6	200mm D.I. SPOOL PIECE
7	50mm SCHEDULE 40 G.I. SPOOL PIECE
8	250 to 200 mm PVC REDUCER
9	200mm PVC to D.I. COUPLING
10	1" PIPE SUPPORT AND SADDLE
11	2" PIPE SUPPORT AND SADDLE
12	100mm (4") PRESSURE GAUGE
13	50mm THREADED BOSS

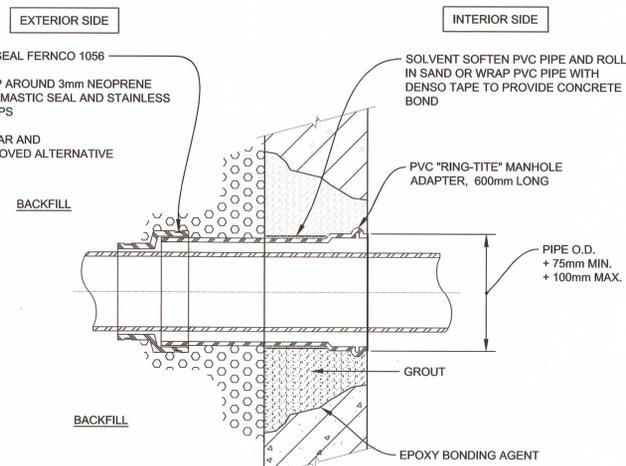

WALL PENETRATION DETAIL (TYP.) N.T.S.

GENERAL NOTES:

- ALL UNITS ARE IN METERS UNLESS NOTED OTHERWISE (U.N.O.).
- ALL MATERIALS AND CONSTRUCTION WORKS TO BE AS PER THE MOST RECENT:
 - THE CITY OF PENTICTON SUBDIVISION AND DEVELOPMENT BYLAW 2004-81 - SCHEDULE "G" - DESIGN CRITERIA, UNLESS SPECIFIED OTHERWISE.
 - THE NATIONAL MASTERS SPECIFICATIONS (NMS);
 - ALL RELEVANT CONTRACT DOCUMENTS AND ALL SPECIFICATIONS INCLUDED IN TENDER PACKAGE
- THE CONTRACTOR MUST RETAIN COPIES OF THE ABOVE DOCUMENTS ON-SITE AND SHALL ENSURE THAT ALL SUB-CONTRACTORS ARE FAMILIAR WITH RELEVANT SECTIONS OF THE ABOVE DOCUMENTS.
- THE CONTRACTOR IS SOLELY RESPONSIBLE FOR THE MEANS OF CONSTRUCTION, SPECIFICALLY COORDINATING THE VARIOUS SCOPES OF WORK. ALSO, THE CONTRACTOR MUST ENSURE THAT THERE IS NO DISRUPTION OF SERVICES. HOWEVER IF SUCH DISRUPTION IS NECESSARY, THE CONTRACTOR SHALL NOTIFY THE DEPARTMENTAL REPRESENTATIVE A MINIMUM OF 72 HOURS PRIOR TO STARTING SUCH WORK, AND THE CONTRACTOR SHALL OBTAIN APPROVALS FOR DISRUPTION FROM THE DEPARTMENTAL REPRESENTATIVE AND ANY AND ALL RELATED PARTIES.
- THE CONTRACTOR IS TO NOTIFY THE DEPARTMENTAL REPRESENTATIVE OF ANY DISCREPANCIES FOUND WITHIN THESE DRAWINGS OR THE CONTRACT DOCUMENTS A MINIMUM OF 72 HOURS BEFORE STARTING CONSTRUCTION.
- THE CONTRACTOR MUST REPAIR OR REPLACE ALL EXISTING SIGNS, SERVICES, ROADS, CURBS, UTILITY INFRASTRUCTURE, VEGETATION, DRIVEWAYS AND THEIR LETDOWNS, THAT BECOME DAMAGED DUE TO CONSTRUCTION AND THIS WORK SHALL BE INCLUDED IN THE CONTRACT PRICE
- INFORMATION CONCERNING THE EXISTING UTILITIES SHOWN ON THESE DRAWINGS MUST BE TAKEN AS APPROXIMATE ONLY. IT IS THE CONTRACTOR'S RESPONSIBILITY TO DETERMINE THE EXACT LOCATION OF ALL EXISTING UTILITIES. AS SOON AS THE CONTRACT IS AWARDED, AND AT LEAST 5 DAYS PRIOR TO BEGINNING ANY CONSTRUCTION ACTIVITIES, CONTRACTOR TO VERIFY EXISTING UTILITY LOCATIONS AND TO ENSURE ALL RELATED PARTIES ARE INFORMED OF THE PROPOSED WORKS AHEAD OF TIME.

WATERMAIN NOTES:

- ALL WORK AND MATERIALS SHALL BE IN ACCORDANCE WITH THE CITY OF PENTICTON'S SPECIFICATIONS AND STANDARDS DRAWINGS, SUPPLEMENTAL UPDATES AND STANDARD DETAIL DRAWINGS AND THE NATIONAL MASTERS SPECIFICATIONS (NMS), UNLESS SPECIFIED OTHERWISE.
- ALL NEW WATERMAIN SHALL BE PVC AWWA C900 DR18 235 PSI. CONNECTION TO FITTINGS AND VALVES WILL BE MADE BY JOINT RESTRAINING IN ACCORDANCE WITH SPECIFICATIONS.
- ALL FITTINGS SHALL BE PVC AWWA C900 AND CSA B137.3. SUITABLE FOR PRESSURE RATING OF 235 PSI
- WATERMAIN SHALL BE INSTALLED WITH 1.5m MINIMUM COVER.
- 200MM PIPE INSIDE PRV CHAMBER TO BE DUCTILE IRON CLASS 350 AS PER AWWA C151
- ALL EXISTING UNDERGROUND UTILITIES (INCLUDING STORM, SANITARY, WATERMAIN, GAS MAINS, ELECTRICAL, TELEPHONE, FIBER OPTIC CONDUITS, STREETLIGHTING, ETC.) CROSSING ALONG THE COMPLETE PROPOSED WATERMAIN ALIGNMENT, INCLUDING TIE-IN LOCATIONS, SHALL BE LOCATED, EXPOSED AND DEPTHS TO BE RECORDED.
- ANY CHANGES TO THE DESIGN MUST BE APPROVED IN WRITING BY THE DEPARTMENTAL REPRESENTATIVE.
- PROTECTION OF THE WATERMAIN MINISTRY OF HEALTH REQUIREMENTS:
 - HORIZONTAL SEPARATION
WHEN 3.0M HORIZONTAL SEPARATION BETWEEN WATERMAIN AND SEWERS IS UNATTAINABLE ALL WATERMAIN JOINTS ARE TO BE WRAPPED
 - VERTICAL SEPARATION
WHEN THE WATERMAIN IS CLOSER THAN 0.5M TO A SEWER BUT ABOVE THE SEWER THE WATERMAIN MUST BE LAID IN SUCH A MANNER THAT CROSSING IS MADE MIDWAY BETWEEN JOINTS ON A FULL LENGTH OF WATERMAIN. IF THIS IS NOT ATTAINABLE THE JOINTS ARE TO BE WRAPPED
WHEN THE WATERMAIN IS BENEATH THE SEWER THERE SHALL BE A MINIMUM 300MM SEPARATION. THE CROSSING SHALL BE MIDWAY ON A FULL LENGTH OF THE WATERMAIN PIPE. THE WATERMAIN JOINTS ARE TO BE SHRINK WRAPPED OR TAPE WRAPPED SHRINK WRAP OR TAPE WRAP THE FOLLOWING STANDARDS WILL APPLY TO WATERMAIN PROTECTION:
 - ANSI/AWWA C214 (FACTORY APPLIED)
 - ANSI/AWWA C209 (FIELD APPLIED)
 - ANSI/AWWA C217-90 (PETROLATUM TAPE)
- ALL MATERIALS USED ARE TO HAVE ZERO HEALTH HAZARD.
- ALL PRESSURE TESTING, CHLORINATION AND FLUSHING TO BE PERFORMED TO MINISTRY OF HEALTH AND AWWA STANDARDS. ALL TESTING IS TO BE WITNESSED BY THE DEPARTMENTAL REPRESENTATIVE.
- PIPES MAY BE DEFLECTED AT JOINT TO MAXIMUM OF 1/2 MANUFACTURER'S RECOMMENDATION ALLOWANCE.

PRESSURE REDUCING VALVE:

- ALL INSIDE WETTED SURFACES TO BE SANDBLASTED AND COALTAR EPOXY COATED. OUTSIDE SURFACES TO BE SANDBLASTED AND EPOXY COATED.
- ALL FITTINGS AND VALVES TO BE RATED AT 235 PSI MINIMUM
- CHAMBER TO BE H2O HIGHWAY RATED.
- INSIDE DIMENSIONS: 4000mm L x 2180mm W x 2010MM H
- EXTERIOR SURFACE COATED WITH TWO (2) COATS OF STATIC ASPHALT PROTECTIVE COATING TYPE #1
- FLOOR TO CENTERLINE OF PIPE: 800mm
- UPSTREAM ZONE HEAD = 150 psi
- DOWNSTREAM ZONE HEAD: 70 psi

Revision/Description	Description/Description	Date/Date
4	ISSUED FOR TENDER	03/12/07
3	ISSUED FOR 100% REVIEW	02/28/07
02	ISSUED FOR 90% REVIEW	08/10/06
01	ISSUED FOR 80% REVIEW	03/12/06

PUBLIC WORKS AND GOVERNMENT SERVICES CANADA
219-800 Burrard Street
Vancouver, BC, V6Z 0B9

Project title/Titre du projet
PENTICTON AIRPORT PENTICTON, BC

EXTERNAL WATER SUPPLY CONNECTION

Consultant Signature Only
CONSULTANT_SIGNATURE_ONLY

Designed by/Conçue par
B. MARSHALL

Drawn by/Dessiné par
T. GERMSHEID


PWOSC Project Manager/Administrateur de Projets TPSC
JIMMY WONG

Regional Manager, Architectural and Engineering Services
Gestionnaire régionale, Services d'architecture et de génie, TPSC
PRESTIPAL PAUL

Drawing title/Titre du dessin
PRESSURE REDUCING VALVE CHAMBER

DETAILS AND GENERAL NOTES

Project No./No. du projet	Sheet/Feuille	Revision no./Loi Révision
R.073300.101	C-003 OF 8	4

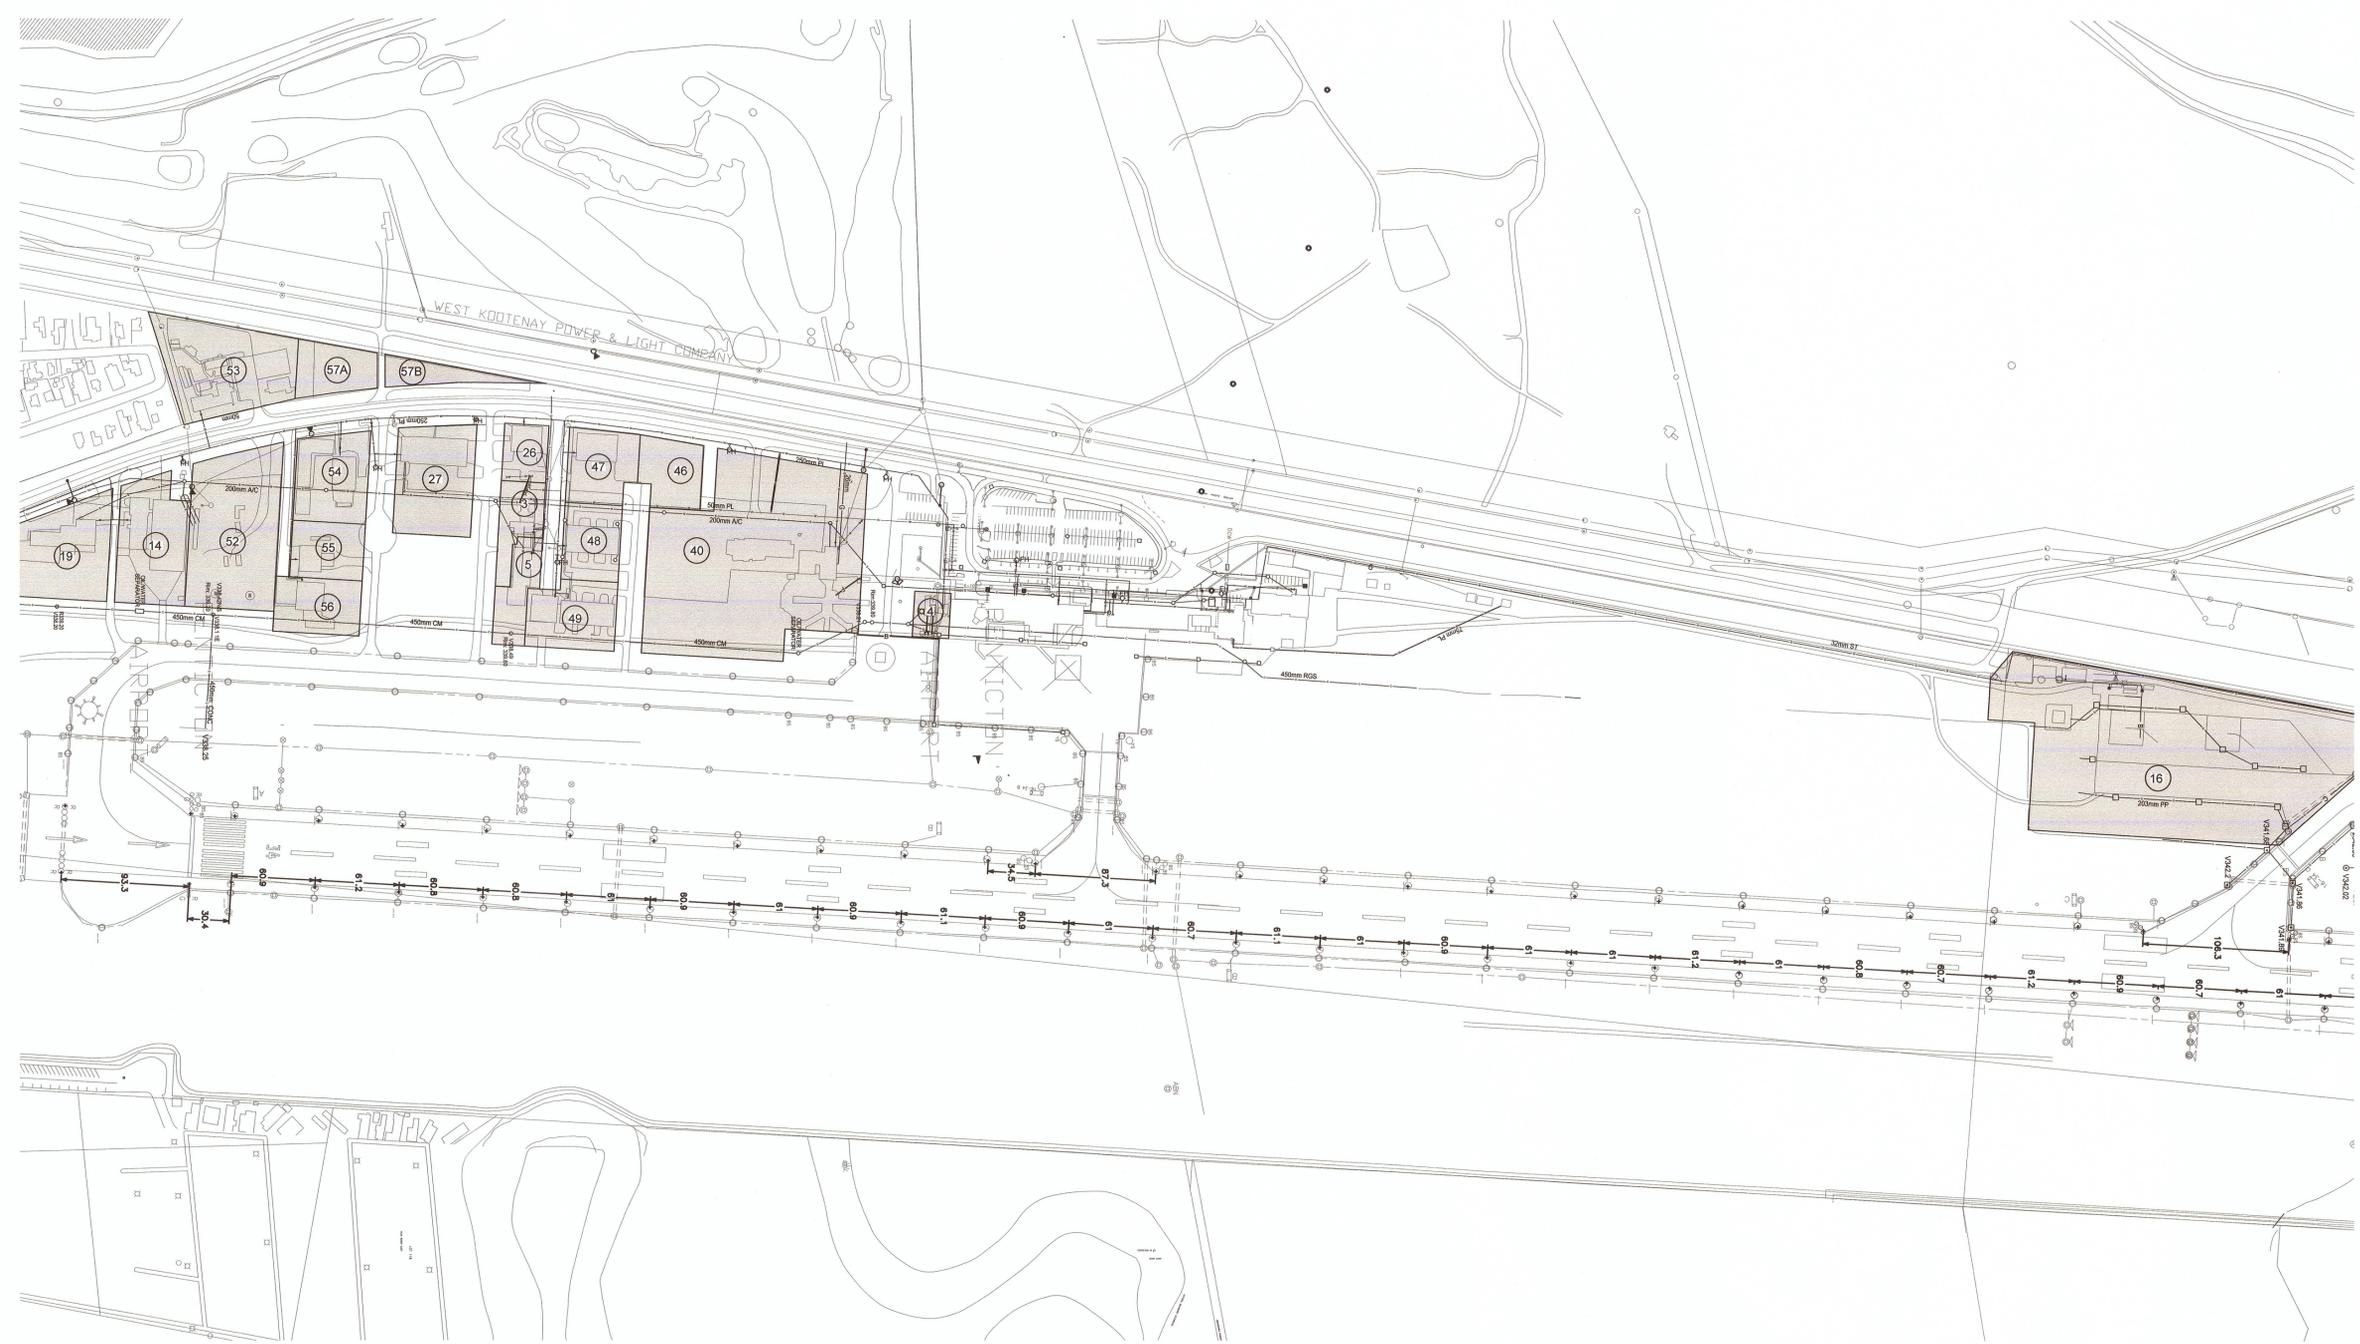

LOT#	LESSEE
3	PENTICTON FLYING CLUB
4	SPENCER AVIATION LTD.
5	TRACI STEVENSON
14	KITTYHAWK A/C SERVICES
16	BC MINISTRY OF FORESTS
19	SOUTHERN SKIES AVIATION
26	RODNEY ALLEN KRANTZ
27	B & N AIRCRAFT LEASING
40	CANADIAN HELICOPTERS
46	PETERS BROS. CONST. LTD.
47	PETERS BROS. CONST. LTD.
48	PIETER KOSTER
49	SUN LEASING LTD.
52	PROVINCE OF BC FORESTRY
53	PROVINCE OF BC FORESTRY
54	DEMEL AIRCRAFT
55	BOBTAIL RANCH
56	ECLIPSE HELICOPTERS
57	KITTYHAWK A/C SERVICES

LEGEND

—	ACTIVE WATER LINE
—	IRRIGATION LINE
—	ABANDONED WATER LINE
—	FLUSH POINT LINE
—	SANITARY SEWER
—	FORCE MAIN
—	GAS LINE
—	SEWER

Revision/Modification	Description/Description	Date/Date
3	ISSUED FOR TENDER	31/03/2017
2	ISSUED FOR 100% REVIEW	22/28/2017
1	Issued for 99% Review	08/19/2016

PUBLIC WORKS AND GOVERNMENT SERVICES CANADA
 219-800 Burrard Street
 Vancouver, BC, V6Z 0B9

Project Title/Titre du projet
PENTICTON AIRPORT
 PENTICTON, BC

EXTERNAL WATER SUPPLY CONNECTION



Consultant Signature Only
 CONSULTANT_SIGNATURE_ONLY

Designed by/Conçopt par
 B. MARSHALL

Drawn by/Dessine par
 M. Kramer 2016-02-26


PWGSC Project Manager/Administrateur de Projets TPSSC
 JIMMY WONG

Regional Manager, Architectural and Engineering Services
 Gestionnaire régionale, Services d'architectural et de génie, TPSSC
 PREETI PAUL


Drawing Title/Titre du dessin
LESSEE
LOCATION PLAN

Project No./No. du projet R.073300.101	Sheet/Fauille C-004 OF 8	Revision no./La Révision 3
--	---------------------------------------	--------------------------------------




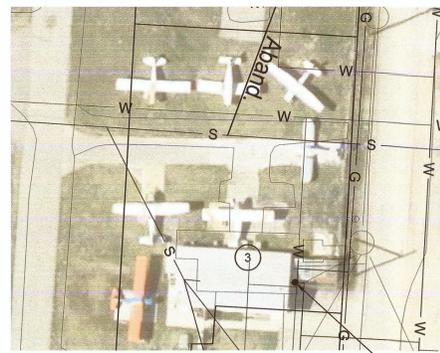

LOT #3 PENTICTON FLYING CLUB
 PROPOSED METER LOCATION

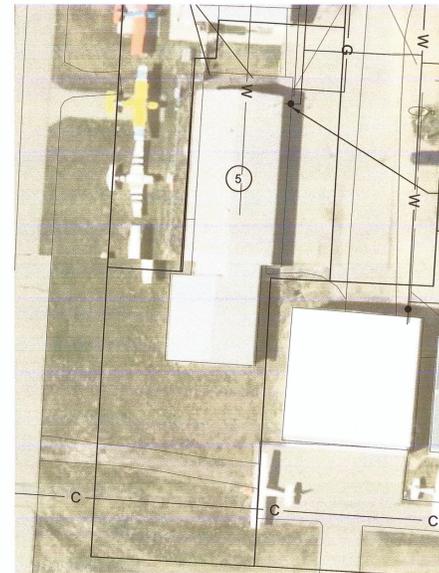


LOT #5 TRACI STEVENSON
 PROPOSED METER LOCATION

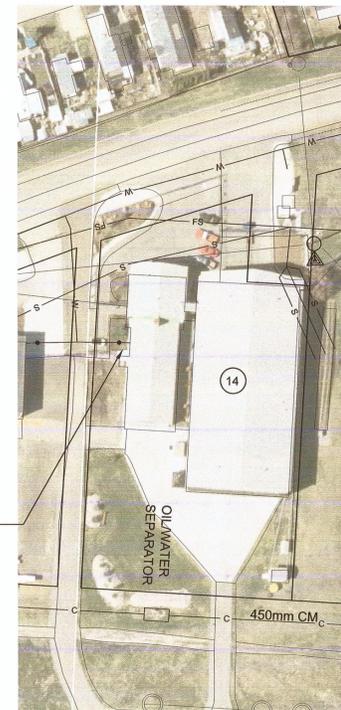

LOT #14 KITTYPHAWK A/C SERVICES
 PROPOSED METER LOCATION



LOT #19 SOUTHERN SKIES AVIATION
 PROPOSED METER LOCATION

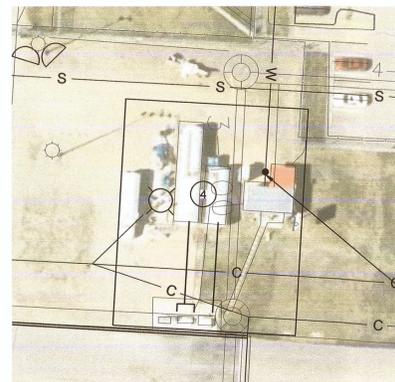


LOT #4 SPENCER AVIATION LTD.
 PROPOSED METER LOCATION

- GENERAL NOTES:**
1. CONTRACTOR TO LOCATE AND CONFIRM SIZE OF WATER SERVICE CONNECTION
 2. FINAL METER LOCATION TO BE CONFIRMED WITH A DEPARTMENTAL REPRESENTATIVE
 3. CONTRACTOR TO ADVISE BUILDING'S TENANT WITH 48 HRS. ANTICIPATION
 4. CONTRACTOR TO INSTALL FROST PROOF WATER METER BOX
 5. WATER BOX TO BE INSTALLED AWAY FROM VEHICULAR TRAFFIC



LOT #16 BC MINISTRY OF FORESTS
 PROPOSED METER LOCATION

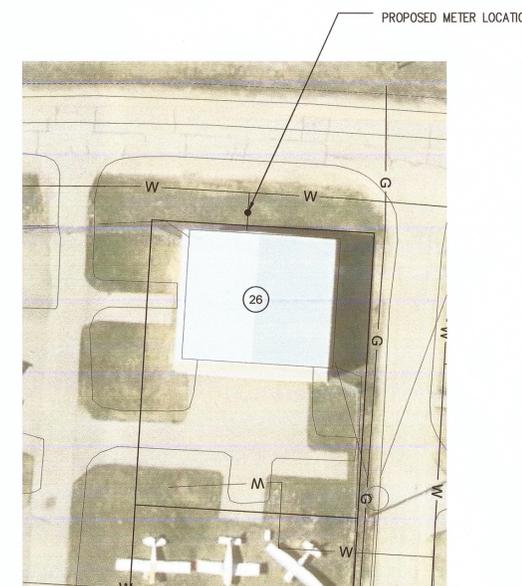

LOT #26 RODNEY ALLEN KRANTZ
 PROPOSED METER LOCATION

LEGEND

— W —	— W —	ACTIVE WATER LINE
— W —	— W —	IRRIGATION LINE
— W —	— W —	ABANDONED WATER LINE
— W —	— W —	FLUSH POINT LINE
— S —	— S —	SANITARY SEWER
— FS —	— FS —	FORCE MAIN
— G —	— G —	GAS LINE

Revision/	Description/Description	Date/Date
3	ISSUED FOR TENDER	31/03/2017
2	ISSUED FOR 100% REVIEW	02/28/2017
1	Issued for 99% Review	08/19/2016

Client/Client
PUBLIC WORKS AND GOVERNMENT SERVICES CANADA
 219-800 Burrard Street
 Vancouver, BC, V6Z 0B9

Project title/Titre du projet
**PENTICTON AIRPORT
 PENTICTON, BC**

EXTERNAL WATER SUPPLY CONNECTION




Consultant Signature Only
 CONSULTANT SIGNATURE ONLY
 Designed by/Concept par
 B. MARSHALL
 Drawn by/Designé par
 M. Kramer 2016-02-26
 PWGSC Project Manager/Administrateur de Projets TPSGC
 JIMMY WONG

Regional Manager, Architectural and Engineering Services
 Gestionnaire régionale, Services d'architecture et de génie, TPSGC
 PREEPTAL PAUL

Drawing title/Titre du dessin
**LESSEE
 LOCATION PLAN
 WATER METER LOCATIONS
 SCALE 1:500**

Project No./No. du projet R.073300.101	Sheet/Feuille C-005 OF 8	Revision no./La Révision no. 3
---	---------------------------------------	--



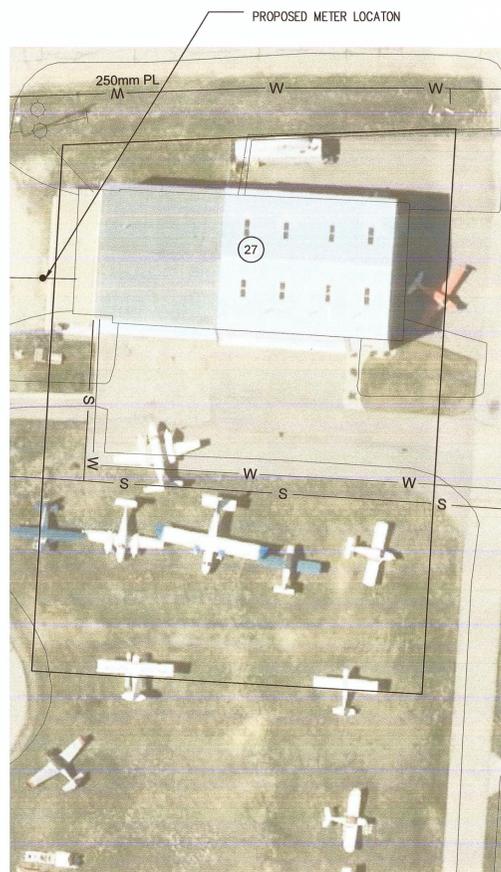


LOT #27 B & N AIRCRAFT LEASING




LOT# 40 CANADIAN HELICOPTERS




LOT #52 PROVINCE OF BC FORESTRY

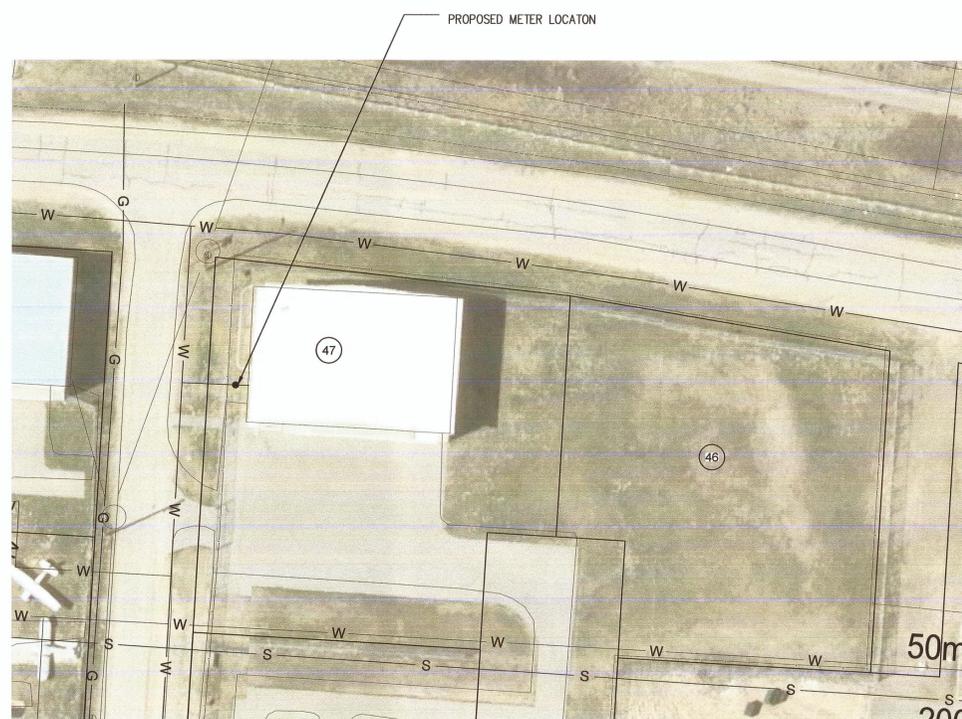

LOTS #46 & #47 PETERS BROS.CONST. LTD.

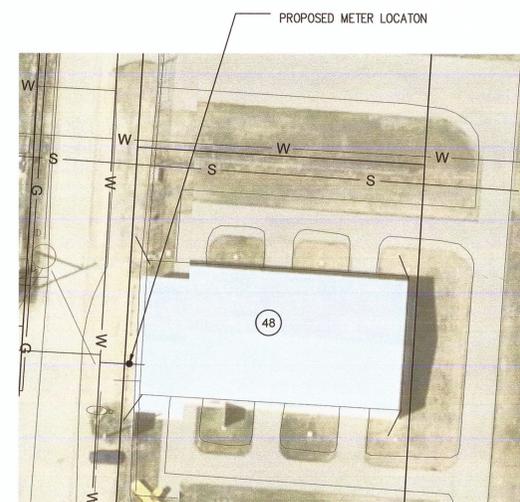

LOT# 48 PIETER KOSTER

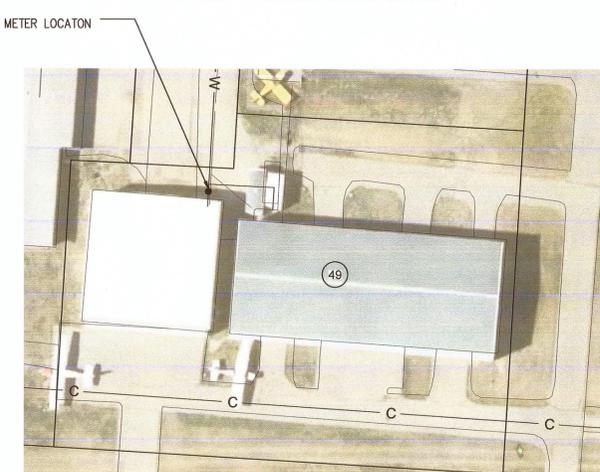

LOT #49 SUN LEASING LTD.

LEGEND

— W —	— W —	ACTIVE WATER LINE
— W —	— W —	IRRIGATION LINE
— W —	— W —	ABANDONED WATER LINE
— W —	— W —	FLUSH POINT LINE
— S —	— S —	SANITARY SEWER
— FS —	— FS —	FORCE MAIN
— G —	— G —	GAS LINE

SEE C-004 FOR GENERAL NOTES:

Revision/	Description/Description	Date/Date
3	ISSUED FOR TENDER	31/03/2017
2	ISSUED FOR 100% REVIEW	02/28/2017
1	Issued for 90% Review	06/19/2016

Client/Client
PUBLIC WORKS AND GOVERNMENT SERVICES CANADA
 219-800 Burrard Street
 Vancouver, BC, V6Z 0B9

Project title/Titre du projet
**PENTICTON AIRPORT
 PENTICTON, BC**

EXTERNAL WATER SUPPLY CONNECTION




Consultant Signature Only
 CONSULTANT_SIGNATURE_ONLY
 Designed by/Concept par
 B. MARSHALL
 Drawn by/Dessiné par
 M.Kramer 2016-02-26
 PWGSC Project Manager/Administrateur de Projets TPSGC
 JIMMY WONG
 Regional Manager, Architectural and Engineering Services
 Gestionnaire régionale, Services d'architecture et de génie, TPSGC
 PREETIPAL PAUL
 Drawing title/Titre du dessin


**LESSEE
 LOCATION PLAN
 WATER METER LOCATIONS
 SCALE 1:500**

Project No./No. du projet R.073300.101	Sheet/Feuille C-006 OF 8	Revision no./La Révision 3
--	---------------------------------------	--------------------------------------




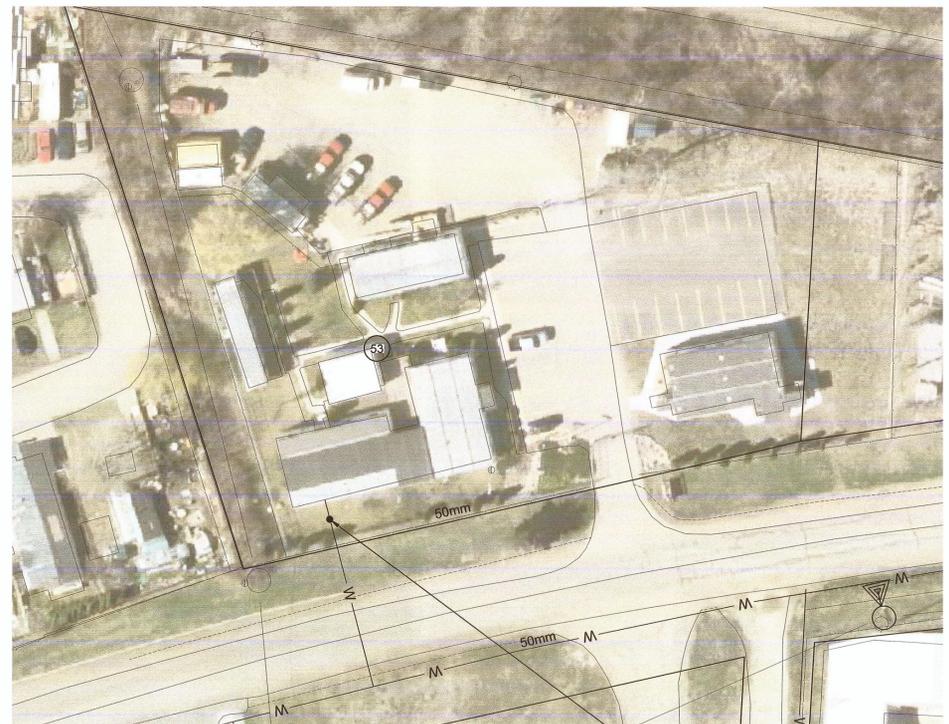

LOT #53 PROVINCE OF BC FORESTRY

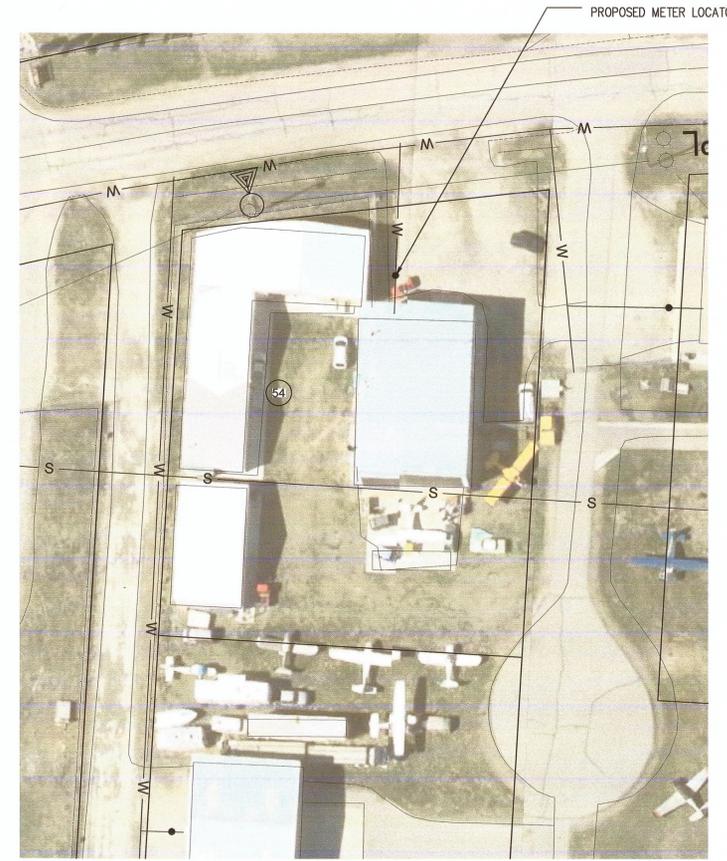

LOT #54 DEMEL AIRCRAFT

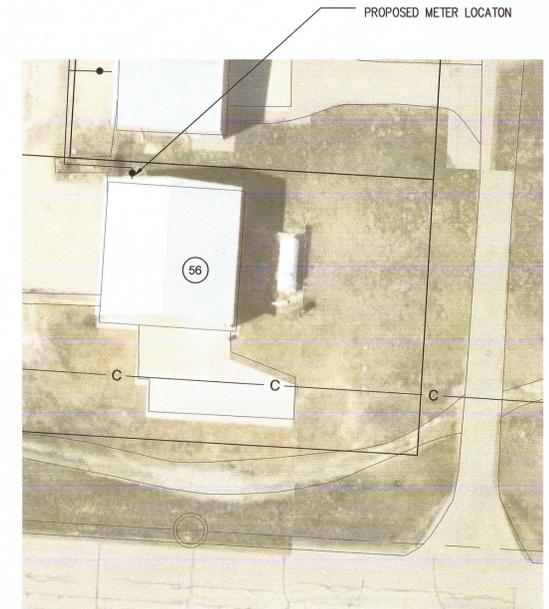

LOT #56 ECLIPSE HELICOPTERS



LOT #55 BOBTAIL RANCH



LOTS #57A & #57B KITTYHAWK A/C SERVICES

LEGEND

— W —	— W —	ACTIVE WATER LINE
— W —	— W —	IRRIGATION LINE
— W —	— W —	ABANDONED WATER LINE
— W —	— W —	FLUSH POINT LINE
— S —	— S —	SANITARY SEWER
— FS —	— FS —	FORCE MAIN
— G —	— G —	GAS LINE

SEE C-004 FOR GENERAL NOTES:

Revision/	Description/Description	Date/Date
3	ISSUED FOR TENDER	31/03/2017
2	ISSUED FOR 100% REVIEW	22/28/2017
1	Issued for 90% REVIEW	08/19/2016

PUBLIC WORKS AND GOVERNMENT SERVICES CANADA
 219-800 Burrard Street
 Vancouver, BC, V6Z 0B9

Project title/Titre du projet
PENTICTON AIRPORT
 PENTICTON, BC

EXTERNAL WATER SUPPLY CONNECTION

Consultant Signature Only
 CONSULTANT_SIGNATURE_ONLY

Designed by/Concept par
 B. Marshall

Drawn by/Dessiné par
 M.Kramer 2016-02-26


PWGSC Project Manager/Administrateur de Projets TPSGC
 JIMMY WONG

Regional Manager, Architectural and Engineering Services
 Gestionnaire régionale, Services d'architectural et de génie, TPSGC
 PREETIPAL PAUL

Drawing title/Titre du dessin
LESSEE
LOCATION PLAN
WATER METER LOCATIONS
SCALE 1:500

Project No./No. du projet R.073300.101	Sheet/Fauille C-007 OF 8	Revision no./La Révision no. 3
--	---------------------------------------	--



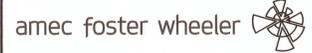

GENERAL NOTES

PUMPHOUSE

1. ALL EQUIPMENT, PIPING, SURFACE MOUNTED FIXTURES AND CONDUITS TO BE REMOVED.
2. EXISTING LIGHTING AND HEATERS TO REMAIN AND PROTECTED DURING DEMOLITION.
3. EXISTING ELECTRICAL SERVICE AND LIGHTING PANEL TO REMAIN. ALL ELECTRICAL WIRING AND PANELS NEEDED TO MAINTAIN POWER AND HEATING, LIGHTING TO REMAIN.
4. COORDINATE WITH DEPARTMENTAL REPRESENTATIVE FOR DISPOSAL OR STORAGE OF THE EQUIPMENT.


RESERVOIR

1. RESERVOIR WILL BE DEWATERED AND DRIED BEFORE DECOMMISSION.
2. REMOVE ALL EXISTING EQUIPMENT, ELECTRICAL AND CONTROL.
3. REMOVE HATCH AND SEAL THE VOID WITH A STEEL PLATE.

REMOVE PIPING AND WELL PUMP HANGING IN RESERVOIR BELOW. REMOVE/CUT PIPE PENETRATION FLUSH WITH FLOOR. FILL VOID WITH 20MPA CONCRETE. (TYP. 2 PLACES)

DRAIN AND REMOVE PRESSURE TANKS

MINOR WALL PENETRATIONS TO BE FILLED WITH INSULATION AND INTERIOR FINISH TO MATCH EXISTING. EXTERIOR TO BE FINISHED WITH WATERPROOF CAULKING.

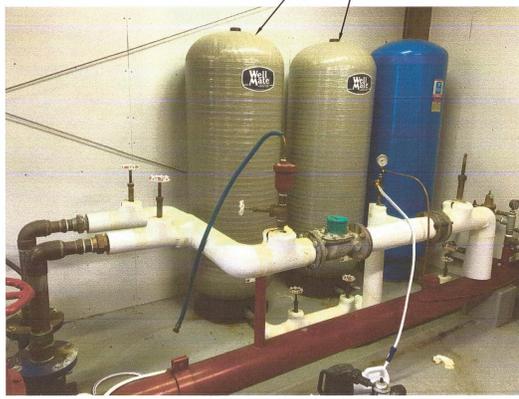


REMOVE ALL SURFACE MOUNTED FIXTURES, CONDUITS AND CABINETS. REPAIR AND MAKE GOOD WALL SURFACE AS REQUIRED.

REMOVE EXHAUST PIPING AND MUFFLER ABOVE THIMBLE AND EXHAUST PIPING THROUGH ROOF TO BE REMOVED. REPAIR CEILING, ROOF JOISTS AND ROOF AS REQUIRED. ROOF REPAIR TO BE WATER TIGHT.



PIPE THROUGH WALL TO BE REMOVED. WALL OPENING TO BE FILLED WITH INSULATION AND INTERIOR REPAIR TO MATCH EXISTING. PROVIDE PAINTED WOOD COVERING ON OUTSIDE OPENING AND SEAL AS REQUIRED TO MAKE WATER TIGHT. (TYP. AT 2 LOCATIONS)

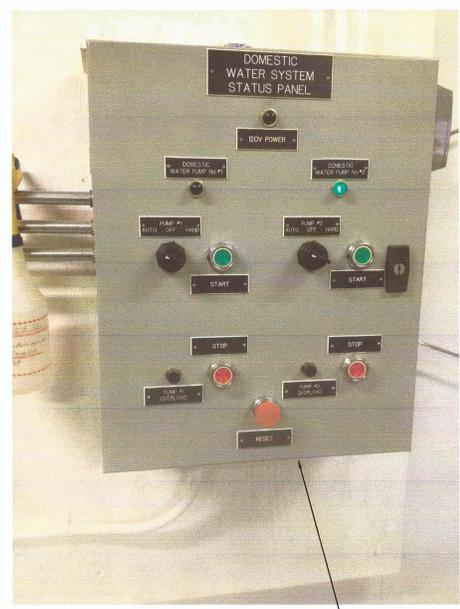

PANEL AND ASSOCIATED WIRING/ CONDUITS TO BE REMOVED. REPAIR ALL WALL PENETRATIONS AND ANCHOR HOLES AS REQUIRED.



REMOVE EXISTING PLATE AND PROVIDE NEW PLATE c/w ANCHORS

CHIP OUT HOUSEKEEPING PADS BELOW DIESEL ENGINE AND MAKE SMOOTH AND FLUSH WITH EXISTING FLOOR.

Revision/ Révision	Description/ Description	Date/ Date
3	ISSUED FOR TENDER	31/03/2017
2	ISSUED FOR 100% REVIEW	02/08/2017
1	ISSUED FOR 90% REVIEW	08/19/2016

PUBLIC WORKS AND GOVERNMENT SERVICES CANADA
219-800 Burrard Street
Vancouver, BC, V6Z 0B9

Project title/ Titre du projet
**PENTICTON AIRPORT
PENTICTON, BC**

EXTERNAL WATER SUPPLY CONNECTION



Consultant Signature Only
CONSULTANT SIGNATURE ONLY

Designed by/ Concept par
B. Marshall

Drawn by/ Dessiné par
T. Gernsheld - 2016/03/31

PWGC Project Manager/ Administrateur de Projets TPSC
JIMMY WONG

Regional Manager, Architectural and Engineering Services
Gestionnaire régionale, Services d'architectural et de génie, TPSC
PAUL PREETIPAL

Drawing title/ Titre du dessin
DEMOLITION PLAN

Project No./No. du projet	Sheet/Feuille	Revision no./La Révision no.
R.073300.101	C-008 OF 8	3

