

Revision/Revisions	Description/Description	Date/Date
0	ISSUED FOR TENDER	2017/11/30
Client/client		

**PARKS CANADA**

Project title/Titre du projet  
23433 Mavis Avenue  
Fort Langley, British Columbia

**FORT LANGLEY  
NATIONAL HISTORIC PARK  
KITCHEN UPGRADE**

Consultant Signature Only

Designed by/Concept par  
M.K.

Drawn by/Dessiné par  
W.E.

PWGC Project Manager/Administrateur de Projets TPSGC  
TOM DUNPHY

Regional Manager, Architectural and Engineering Services  
Gestionnaire régionale, Services d'architecture et de génie, TPSGC  
PREETIPAL PAUL

Drawing title/Titre du dessin

**KITCHEN AND WASHROOMS  
ELECTRICAL AND  
LIGHTING PLANS**


Project No./No. du projet  
R.081108.001

Sheet/Feuille  
**E-02**  
OF 4


Revision no./  
La Révision  
no.

**DEMOLITION NOTES:**


- DEMOLITION WORK TO BE CARRIED OUT BY QUALIFIED ELECTRICAL CONTRACTOR
- ALL EXISTING ELECTRICAL OUTLETS TO BE REMOVED.
- ALL EXISTING LIGHTING FIXTURES, EXIT SIGNS AND LIGHTING CONTROLS TO BE REMOVED.
- ALL WIRING TO BE REMOVED BACK TO TERMINATION PANEL.
- EXISTING 100A PANEL, MAIN FEEDER AND BRANC WIRING TO BE REMOVED. FEEDER TERMINATES IN MAIN DISTRIBUTION CENTRE. SEE LOCATION ON DRAWING E1.
- ALL REMOVED EQUIPMENT TO BE DISPOSED IN ACCORDANCE WITH LOCAL BYLAWS.
- RELOCATE EXISTING SECURITY DEVICES TO SUIT NEW SPACE LAYOUT.
- EXISTING LIGHTING FIXTURES (FLUORESCENT STRIPS) AND CONTROLS IN BOTH WASHROOMS TO BE REMOVED. RETAIN CIRCUITS TO CONNECT NEW LIGHTING FIXTURES.
- EXISTING HAND DRYERS TO BE REMOVED. RETAIN CIRCUITS TO CONNECT NEW ELECTRIC HAND DRYERS.
- RELOCATE SECURITY CONTROL PANEL AND EXISTING DEVICES AS SHOWN ON REVISED ELECTRICAL PLAN.
- REMOVE TWO WALL MOUNTED, EXTERIOR LIGHTING FIXTURES TYPE 'X'. REROUTE EXISTING FEEDERS TO NEW PANEL 'K'. REUSE FEEDER TO SUPPLY NEW LIGHTING FIXTURES TYPE 'C'.

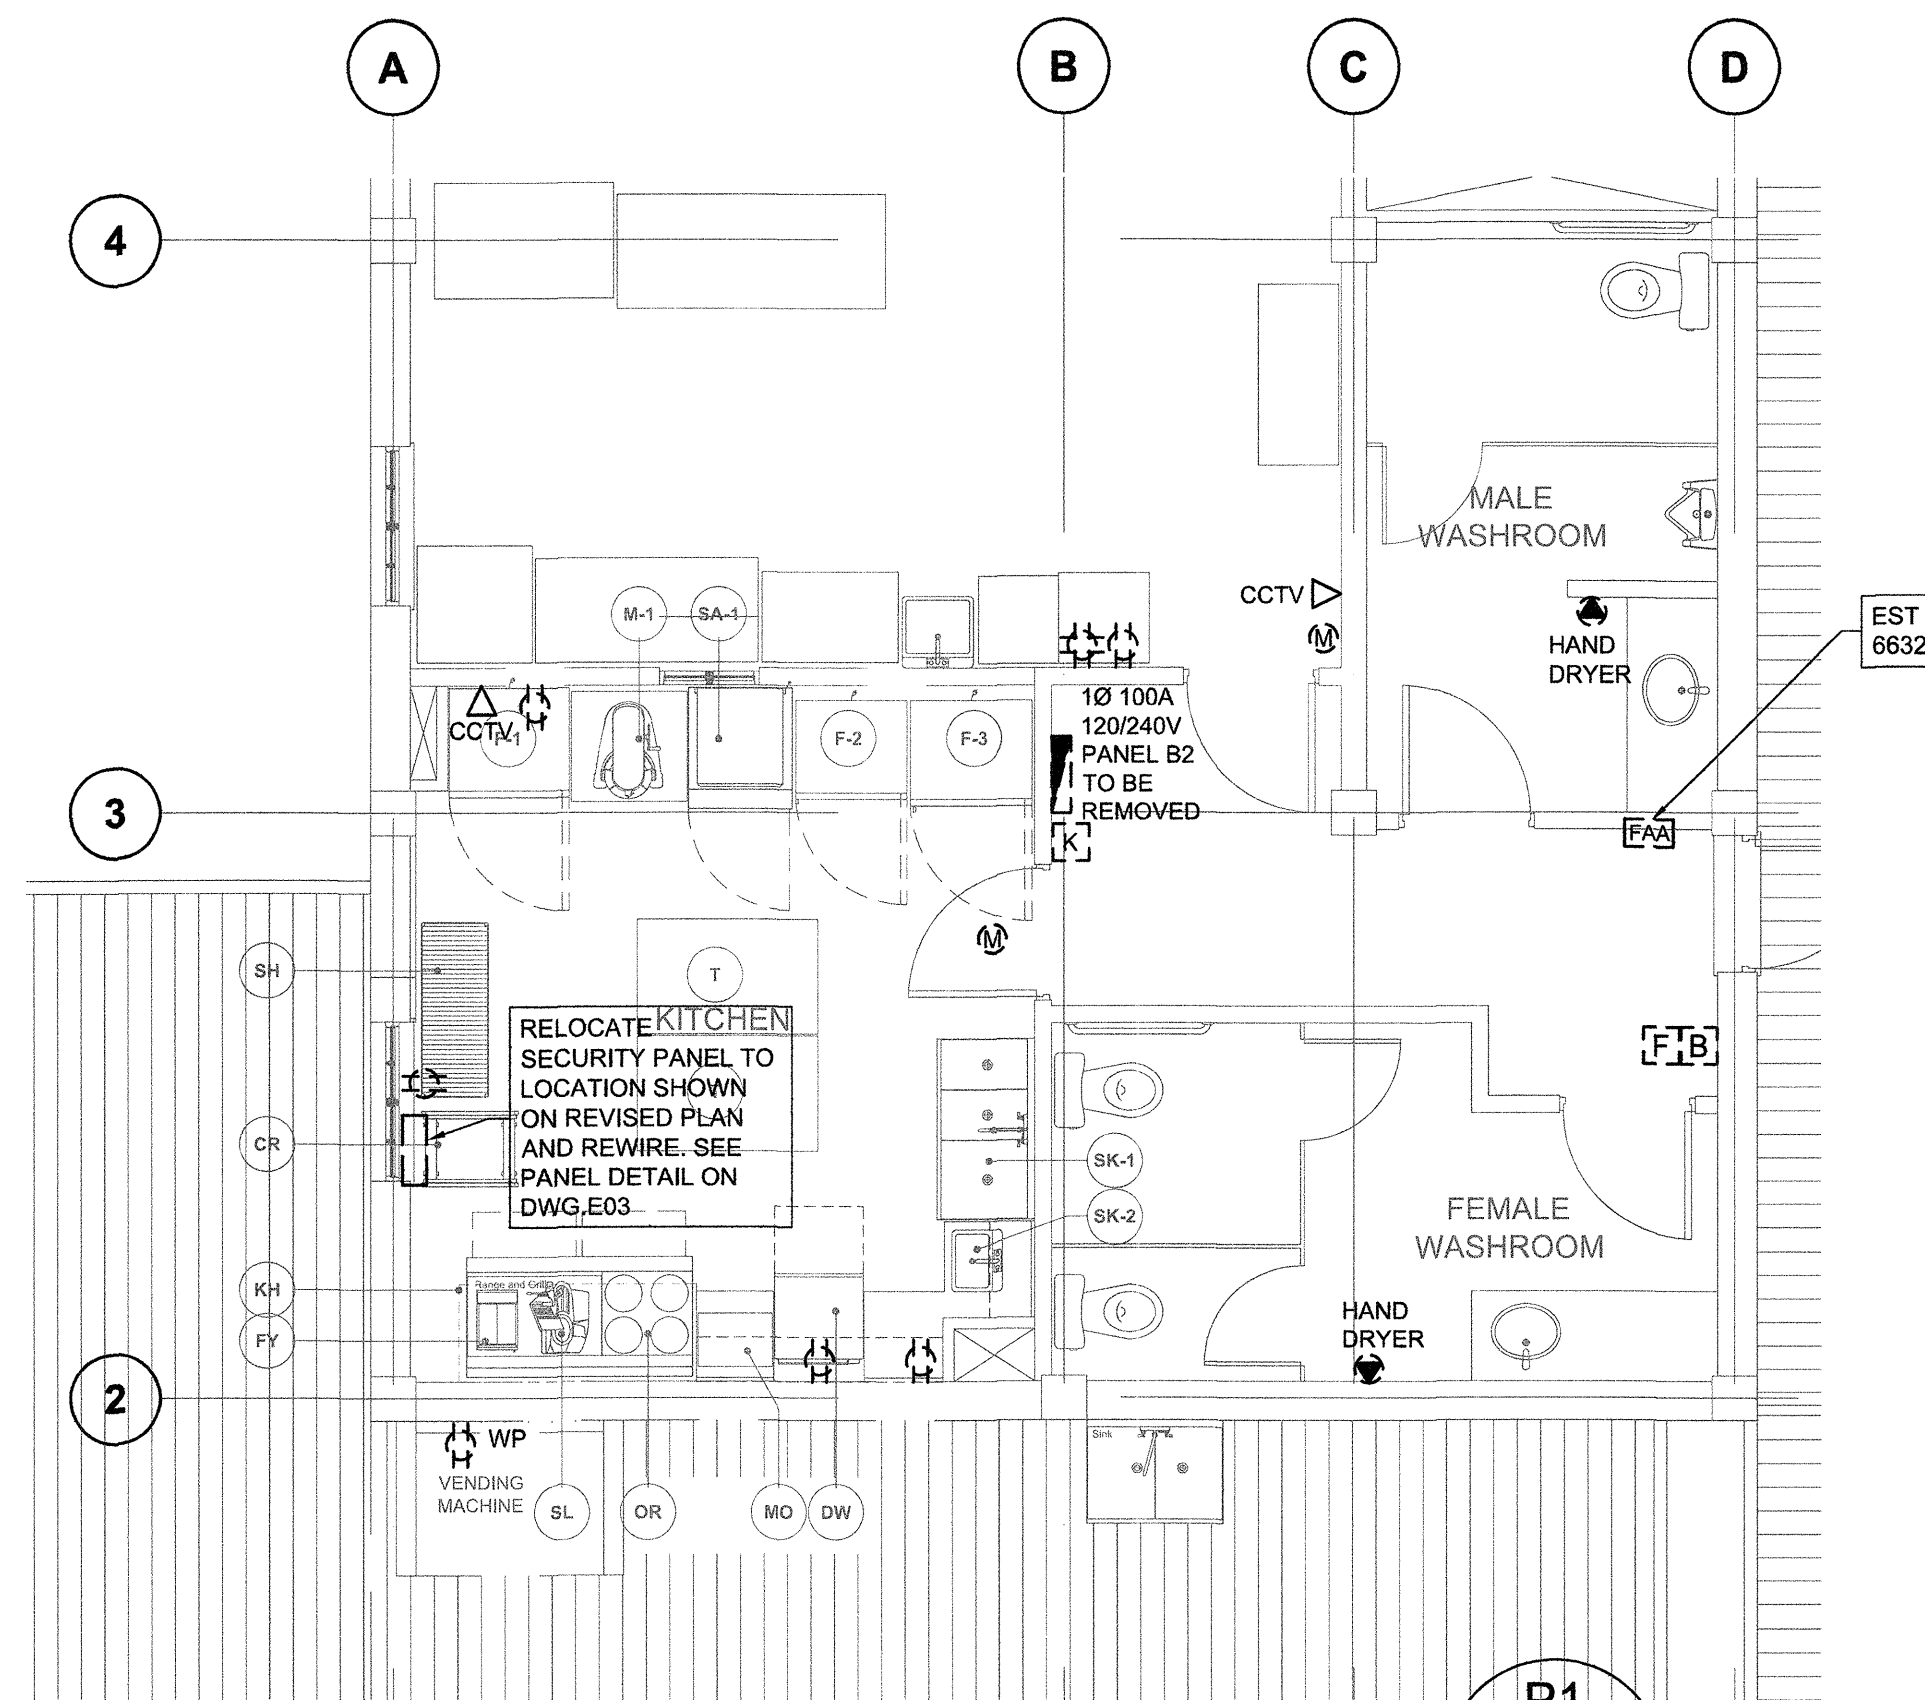


**ELECTRICAL DEMOLITION PLAN**  
SCALE: 1:50

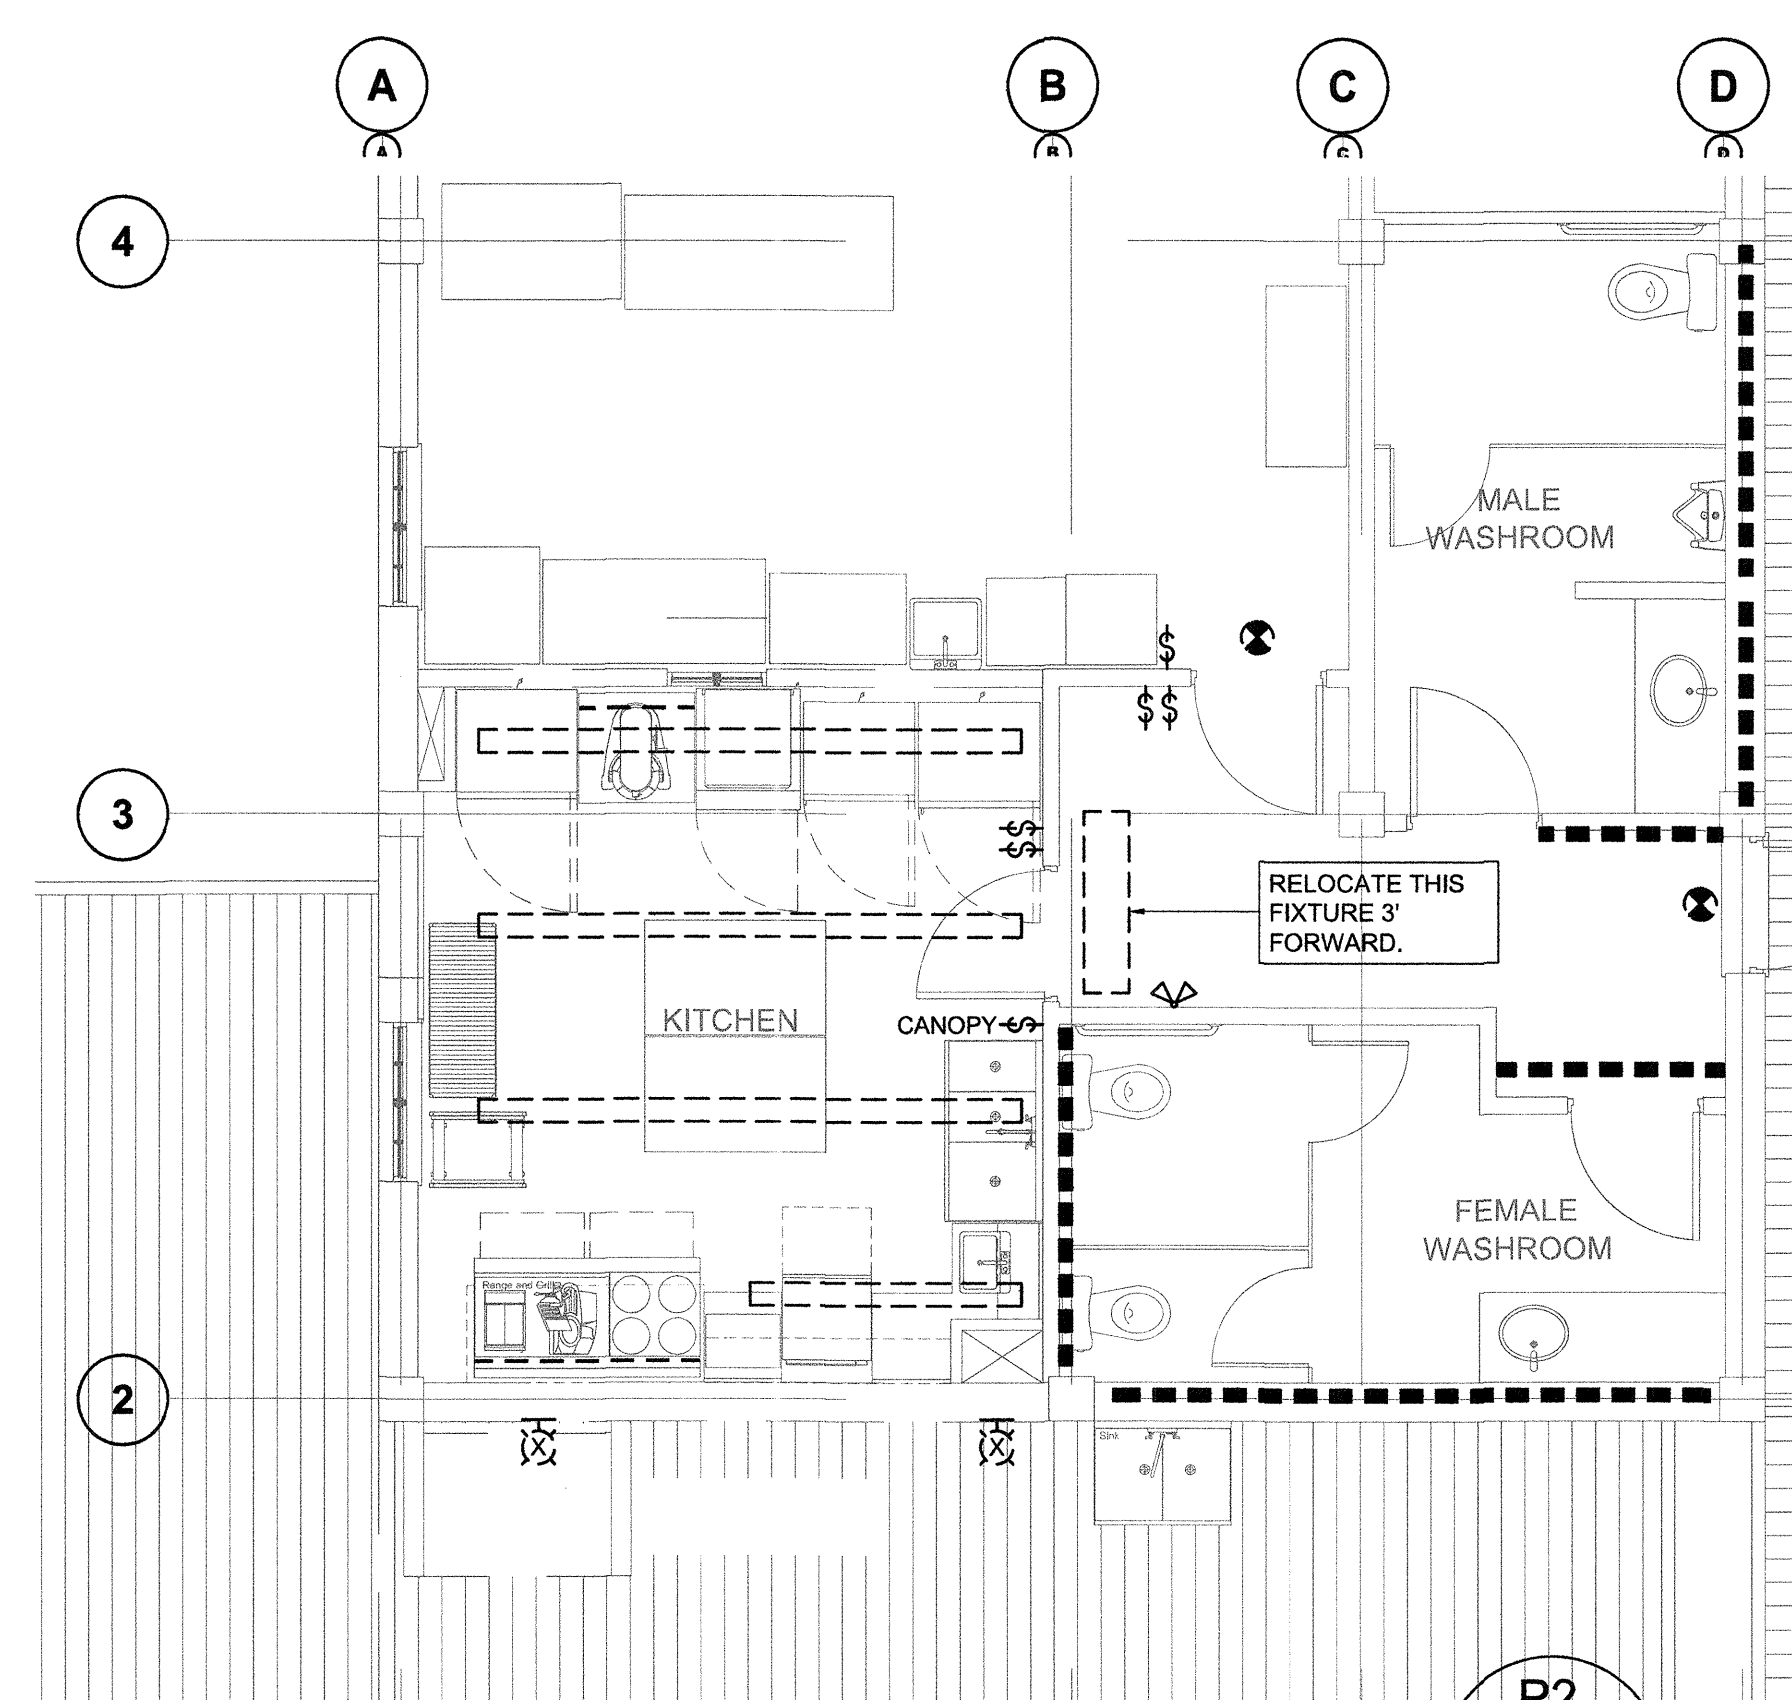

**LIGHTING DEMOLITION PLAN**  
SCALE: 1:50

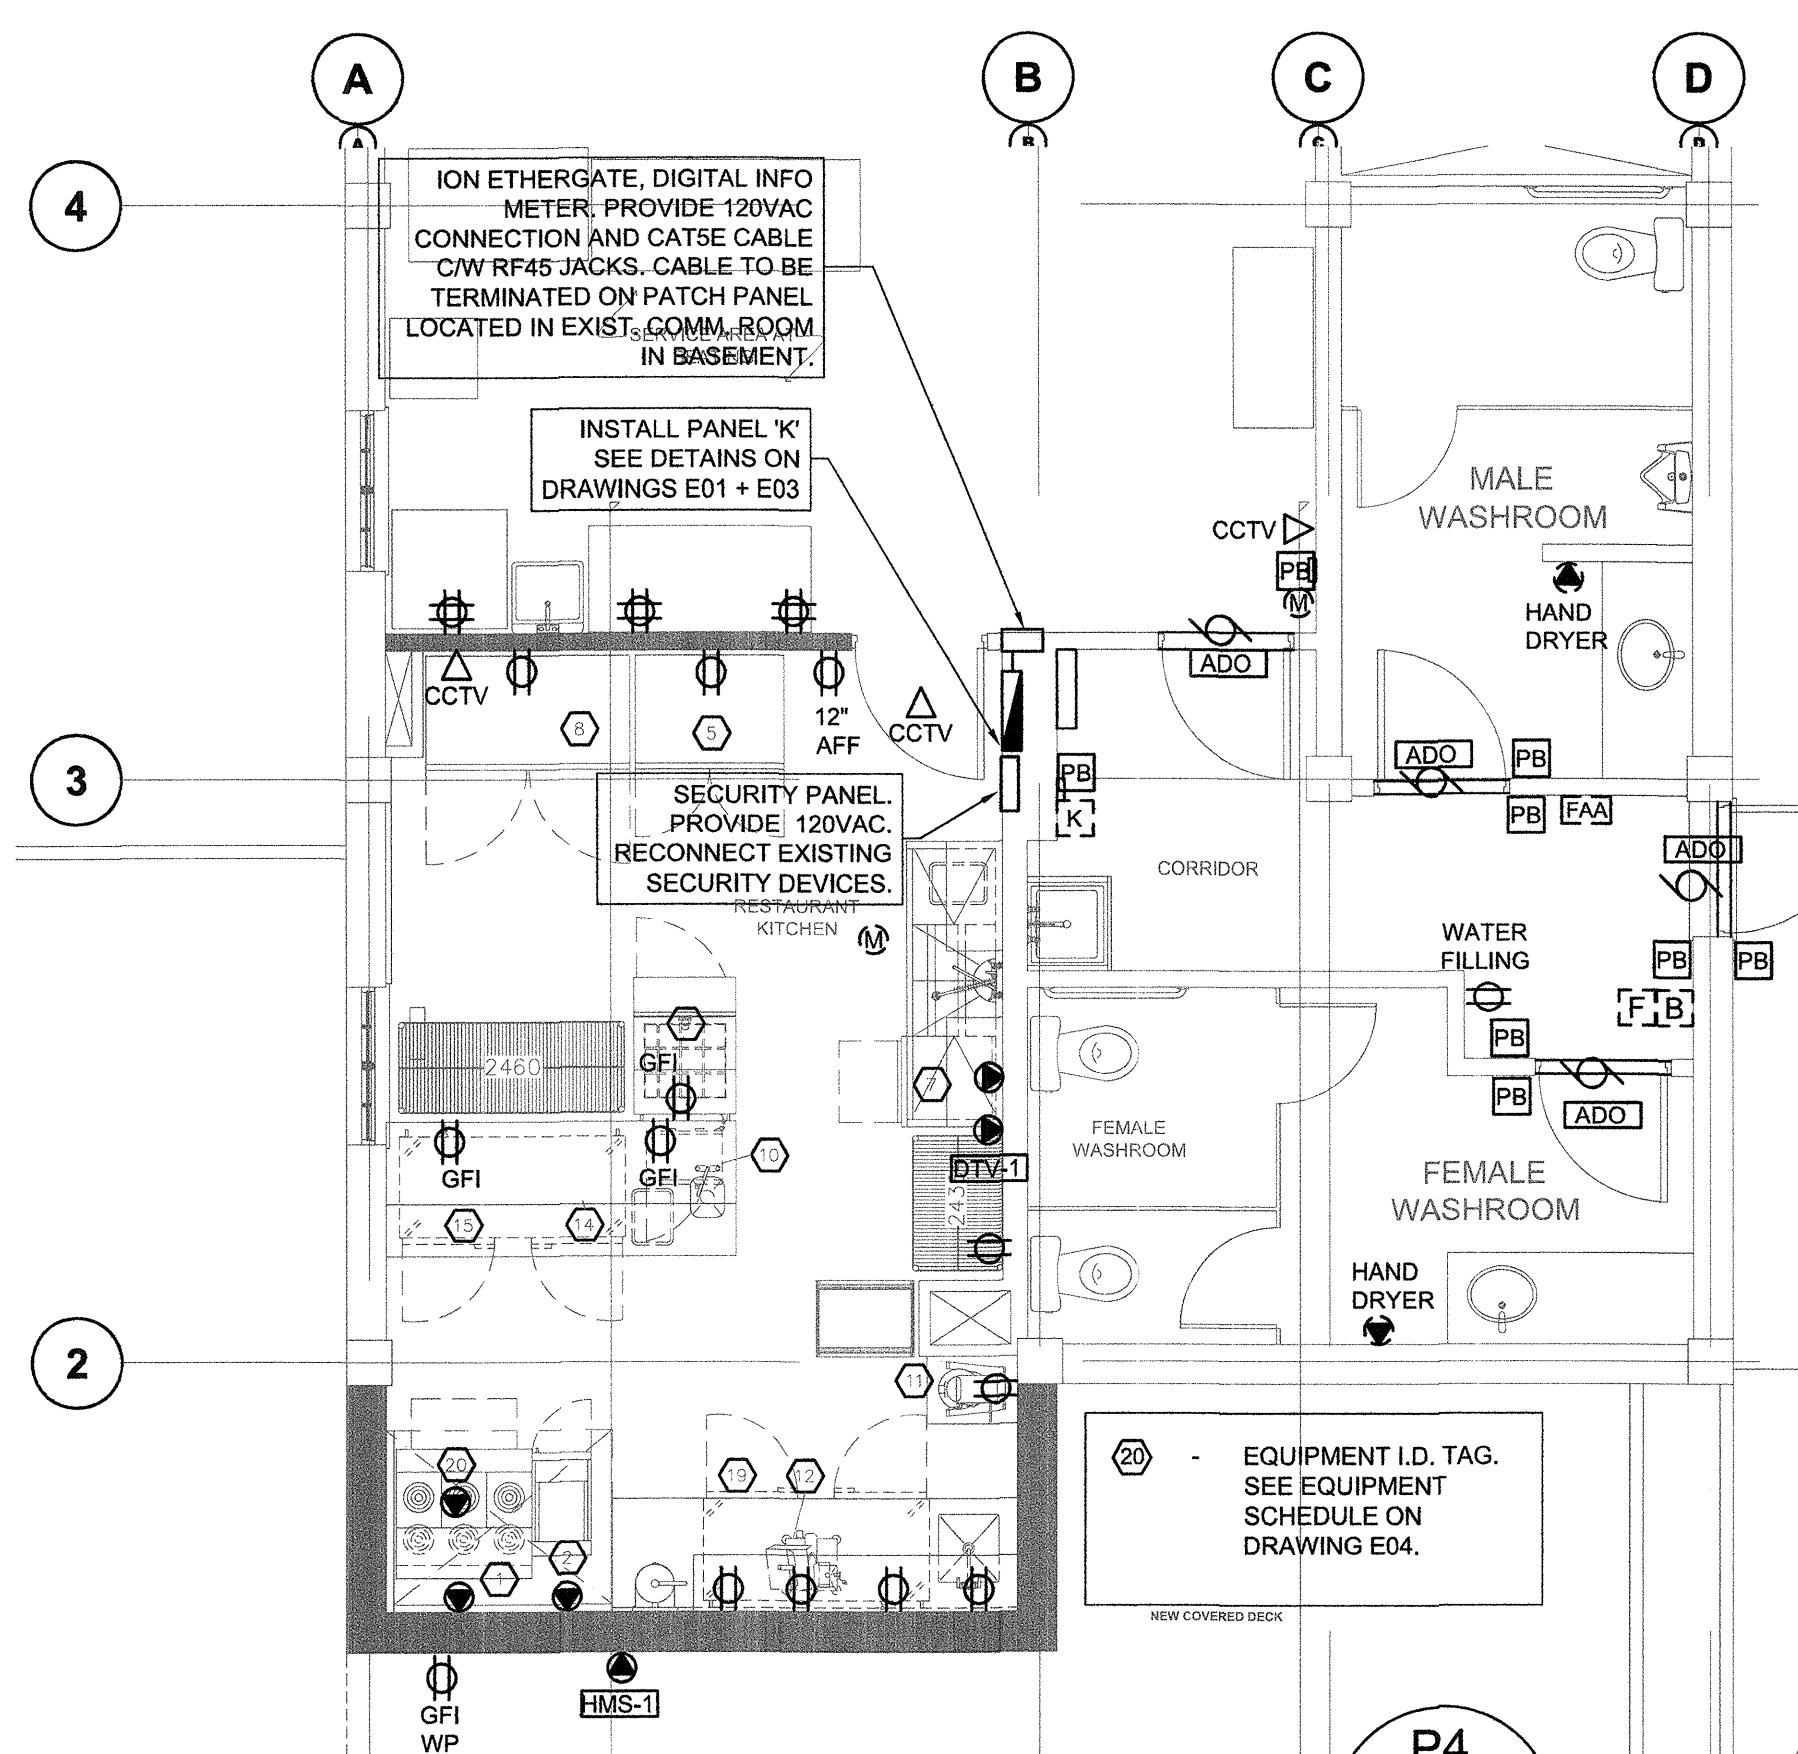

**REVISED ELECTRICAL PLAN**  
SCALE: 1:50

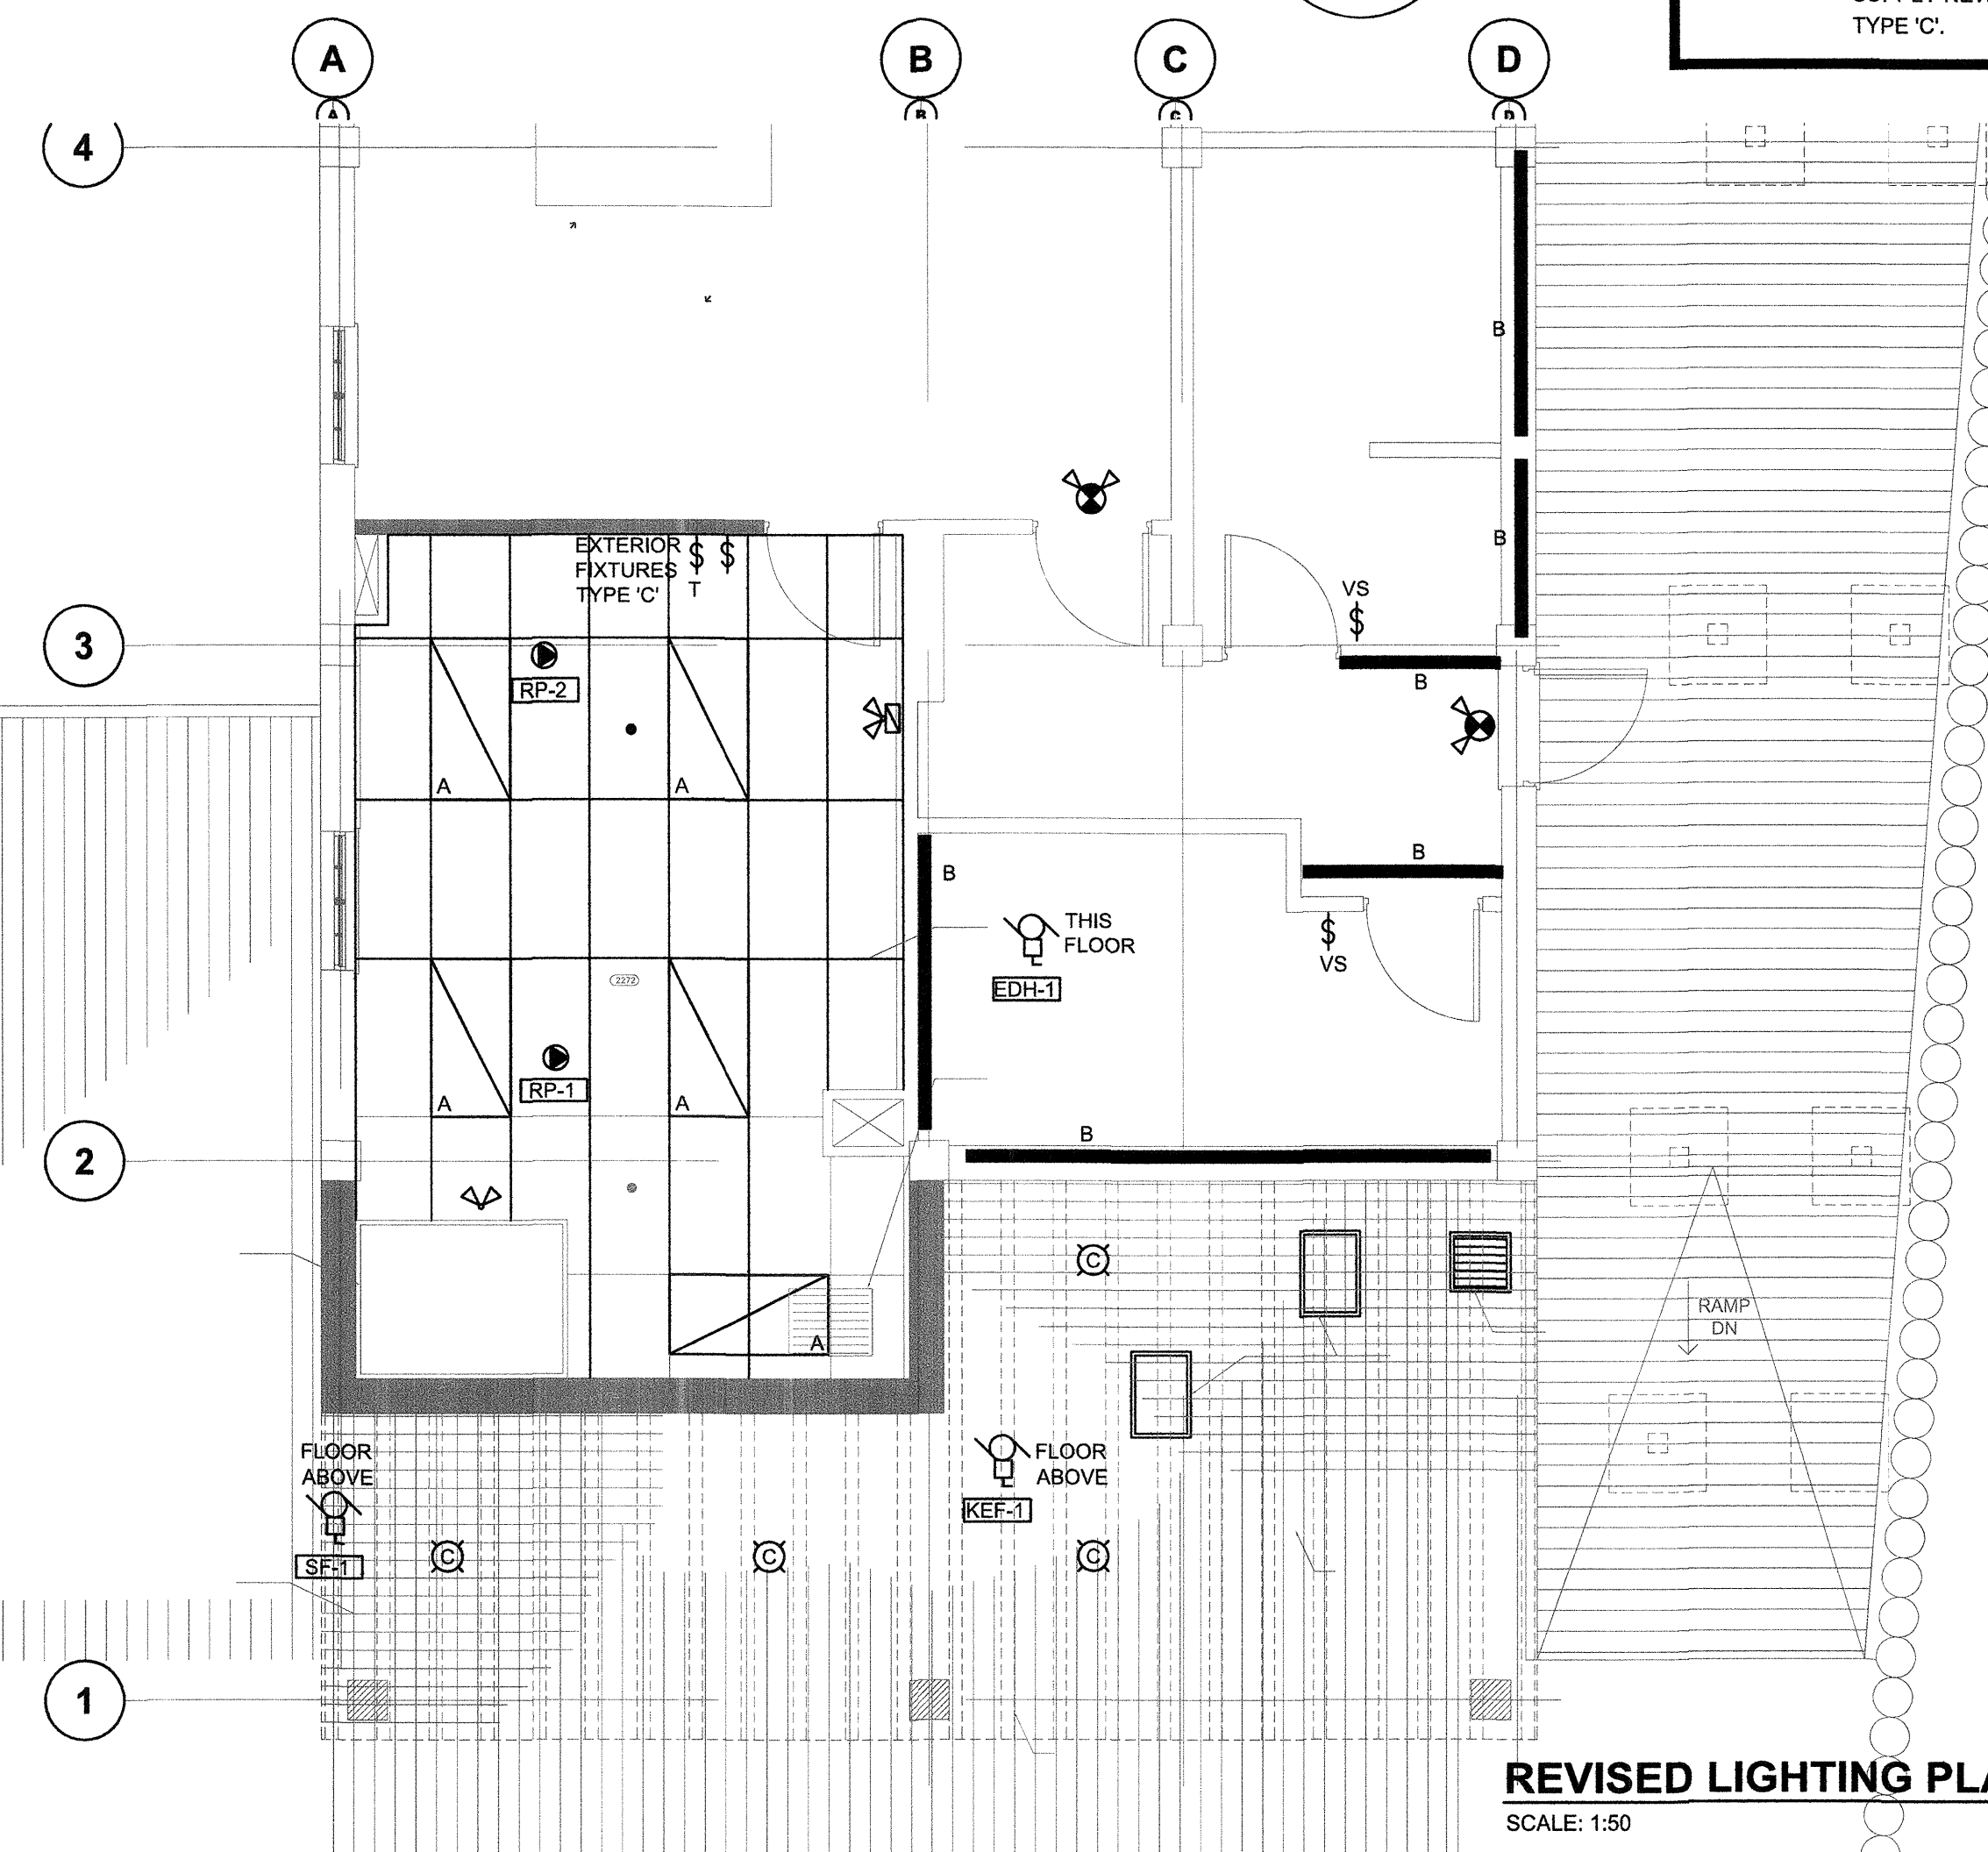

**REVISED LIGHTING PLAN**  
SCALE: 1:50

PROFESSIONAL  
ENGINEER  
J. R. FERNANDEZ  
# 33531  
NOV 29 2017