


kadesigns
(902) 454-9889 kadesigns@eastlink.ca
3873 Memorial Drive, Halifax, N.S. B3K 5A4

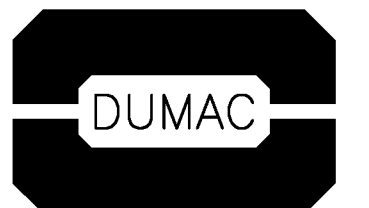

DUMAC ENERGY LTD.
CONSULTING ENGINEERS
752 BEDFORD HIGHWAY
HALIFAX, N.S.
Tel: (902) 457-1300
Fax: (902) 457-1777
Email: DUMAC@DUMACNS.CA




1.	ISSUED FOR TENDER	01.26.2018
revisions		date
project		proj

CCG WP2.0 FIT-UP
MARITIME HEADQUARTERS
BEDFORD INSTITUTE OF OCEANOGRAPHY
DARTMOUTH
NOVA SCOTIA

drawing dessin

CCG FIT-UP
LEVELS 400 & 500
FLOOR PLANS -
LIGHTING


designed	KADesigns	conçu
date	OCT.02.2017	
drawn		dessiné
date		
approved		approuvé
date		
Tender	IAN SCELES	Soumission
PWGSC Project Manager	Administrateur de projets TPSGC	
project number		no. du projet
	R.082156.001	
drawing no.		no. du dessin
	E.05	

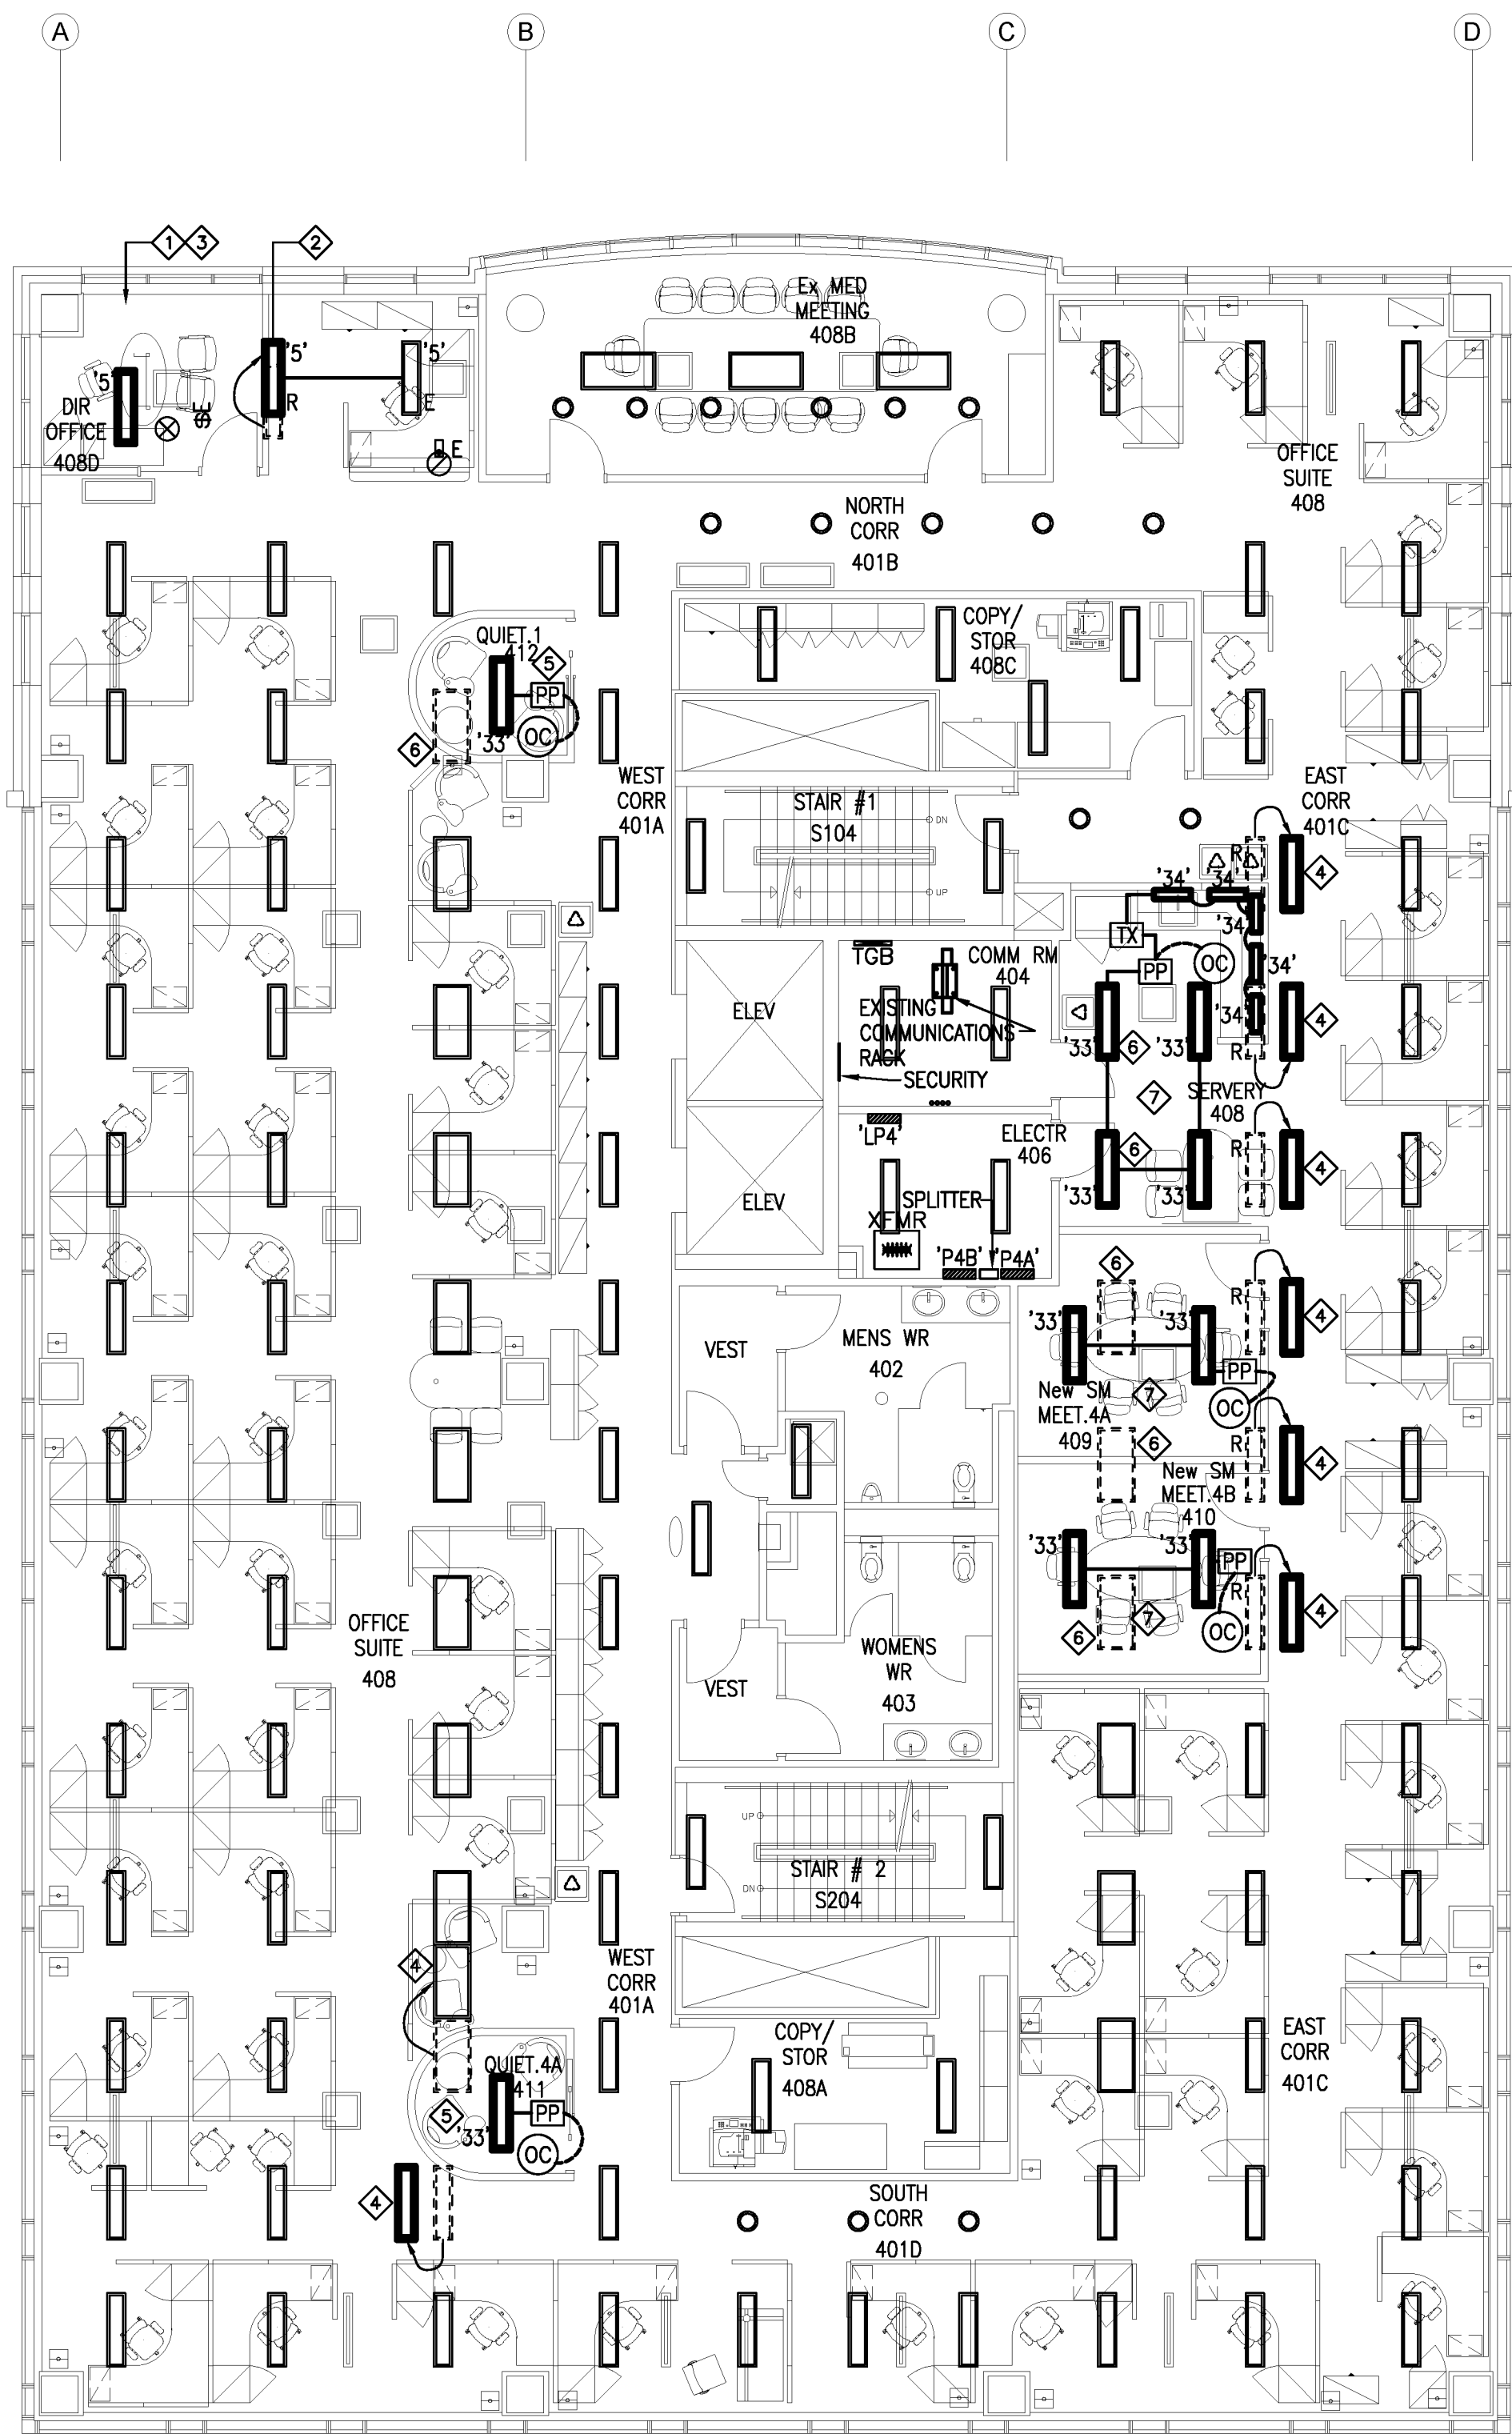

1
E.05
LEVEL 400 FLOOR PLAN - LIGHTING
SCALE : 1:100

LEVEL 400 LIGHTING NOTES:

- DISCONNECT AND REMOVE TRACK LIGHT AND ALL ASSOCIATED WIRING AND CONTROLS. MAINTAIN CIRCUIT CONTINUITY TO ALL DEVICES TO REMAIN.
- RELOCATE EXISTING LIGHTING FIXTURE IN-LINE WITH ADJACENT FIXTURE AND RE-WIRE TO ADJACENT LIGHTING FIXTURE AS INDICATED. RELOCATE INPUT/OUTPUT MODULE TO LIGHTING FIXTURE IN NEW OFFICE 408D.
- EXISTING OFFICE LIGHTING CONTROLS TO BE RELOCATED TO SUIT NEW CONSTRUCTION. RE-INSTALL AND REWIRE TO CONTROL LIGHTING WITHIN OFFICE ONLY.
- RELOCATE EXISTING LIGHTING FIXTURE TO SUIT NEW CONSTRUCTION. EXTEND WIRING AS REQUIRED.
- INSTALL NEW LIGHTING FIXTURE, OCCUPANCY SENSOR AND POWER PACK AS INDICATED. WIRE TO NEAREST AVAILABLE 347V PORTION OF EXISTING LIGHTING CIRCUIT. INSTALL OCCUPANCY SENSOR IN CORNER OF ROOM AND MASK OFF SENSOR SO THAT IT DOES NOT PICK UP MOTION OUTSIDE OF ROOM.
- DISCONNECT AND REMOVE EXISTING LIGHTING FIXTURE. MAINTAIN CIRCUIT CONTINUITY TO ALL REMAINING DEVICES.
- DISCONNECT AND REMOVE EXISTING LIGHTING FIXTURE. MAINTAIN CIRCUIT CONTINUITY AND CONTROLS TO REMAINING LIGHTING TO REMAIN.
- INSTALL NEW LIGHTING, OCCUPANCY SENSOR AND POWER PACK IN ROOM AS INDICATED. WIRE FIXTURE TO NEAREST AVAILABLE 347V NON SWITCHED PORTION OF EXISTING UNLOADED LIGHTING CIRCUIT.
- RE-USE EXISTING LIGHTING FIXTURES WHERE POSSIBLE OR TURN OVER TO OWNER.

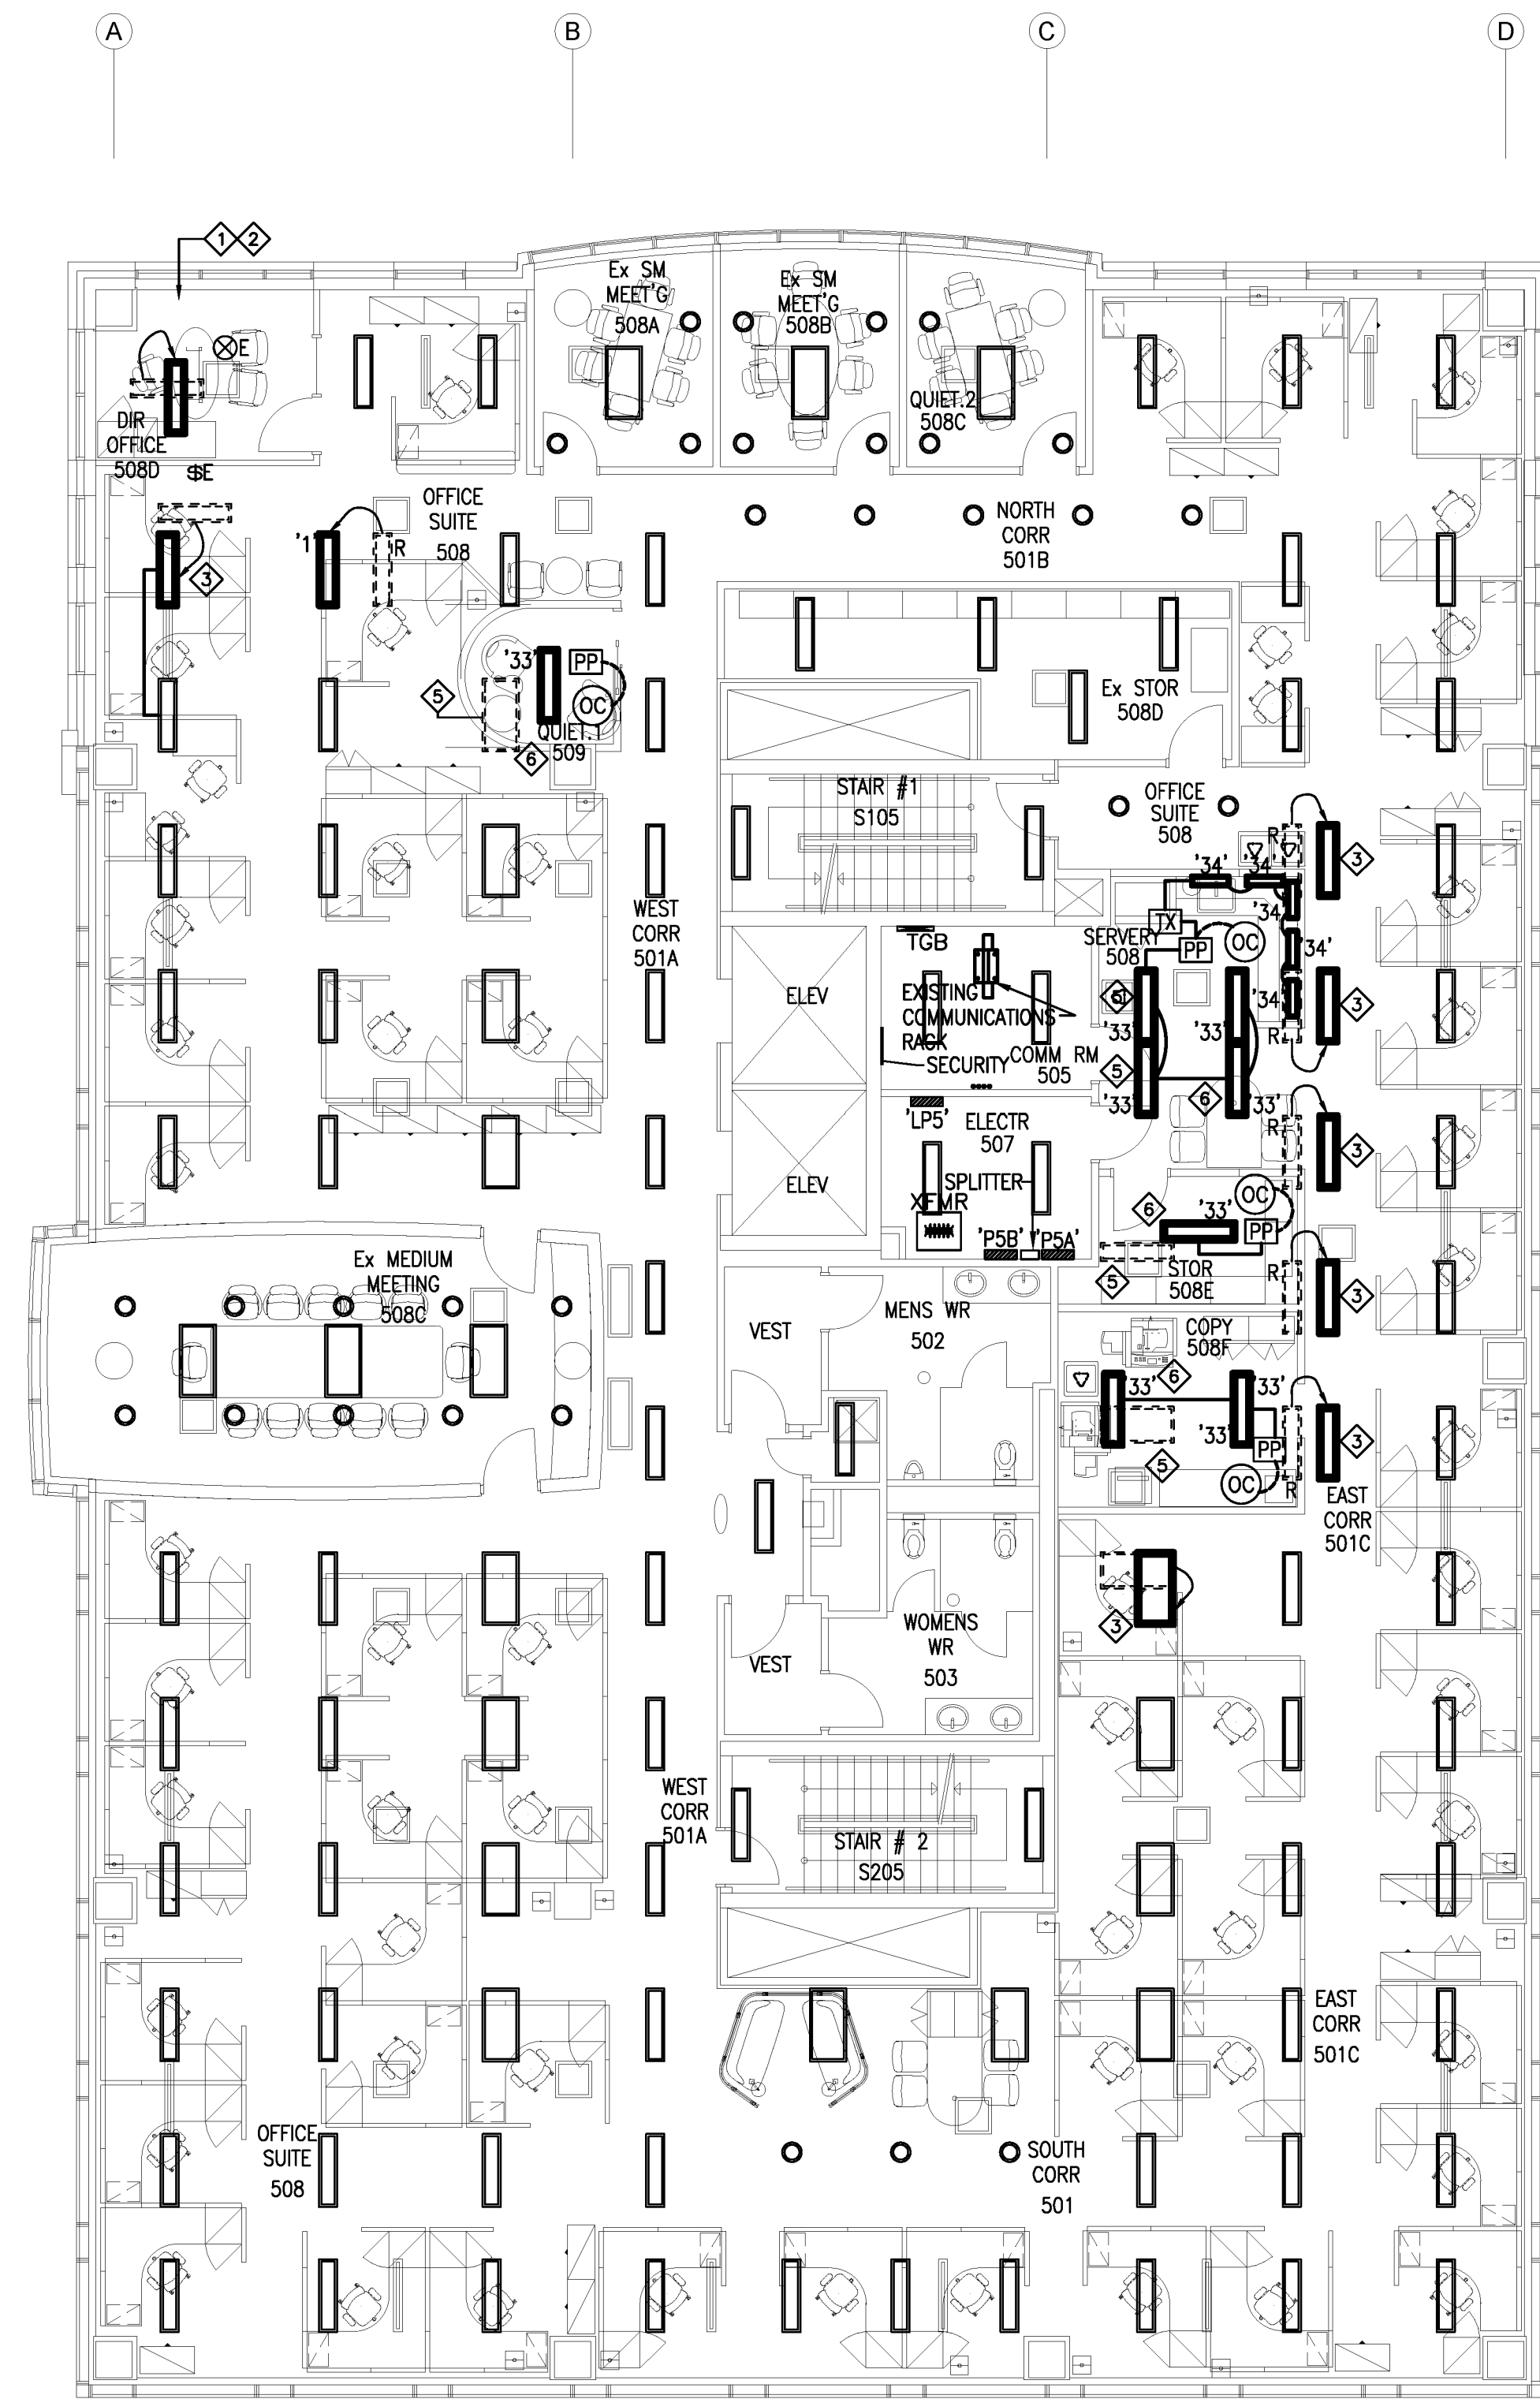

2
E.05
LEVEL 500 FLOOR PLAN - LIGHTING
SCALE : 1:100

LEVEL 500 LIGHTING NOTES:

- DISCONNECT AND REMOVE TRACK LIGHT AND ALL ASSOCIATED WIRING AND CONTROLS. MAINTAIN CIRCUIT CONTINUITY TO ALL DEVICES TO REMAIN.
- EXISTING OFFICE LIGHTING CONTROLS AND LIGHTING FIXTURE TO BE RELOCATED TO SUIT NEW CONSTRUCTION. RE-INSTALL AND RE-WIRE TO CONTROL LIGHTING WITHIN OFFICE.
- RELOCATE EXISTING FIXTURE. RE-WIRE FOR CONTROL WITH ADJACENT FIXTURE.
- RELOCATE EXISTING LIGHTING FIXTURE, EXTEND WIRING AS REQUIRED.
- DISCONNECT AND REMOVE EXISTING LIGHTING FIXTURE. MAINTAIN CIRCUIT CONTINUITY TO ALL REMAINING DEVICES.
- INSTALL NEW LIGHTING FIXTURE, OCCUPANCY SENSOR AND POWER PACK AS INDICATED. WIRE TO NEAREST AVAILABLE 347V NON-SWITCHED PORTION OF EXISTING UNLOADED LIGHTING CIRCUIT. INSTALL OCCUPANCY SENSOR IN CORNER OF ROOM AND MASK OFF SENSOR SO THAT IT DOES NOT PICK UP MOTION OUTSIDE OF ROOM.