



1 REFLECTED CEILING PLAN - LEVEL 200  
SCALE : 1:100  
0m 1m 2m 3m 4m 5m 6m 7m 8m 9m 10m

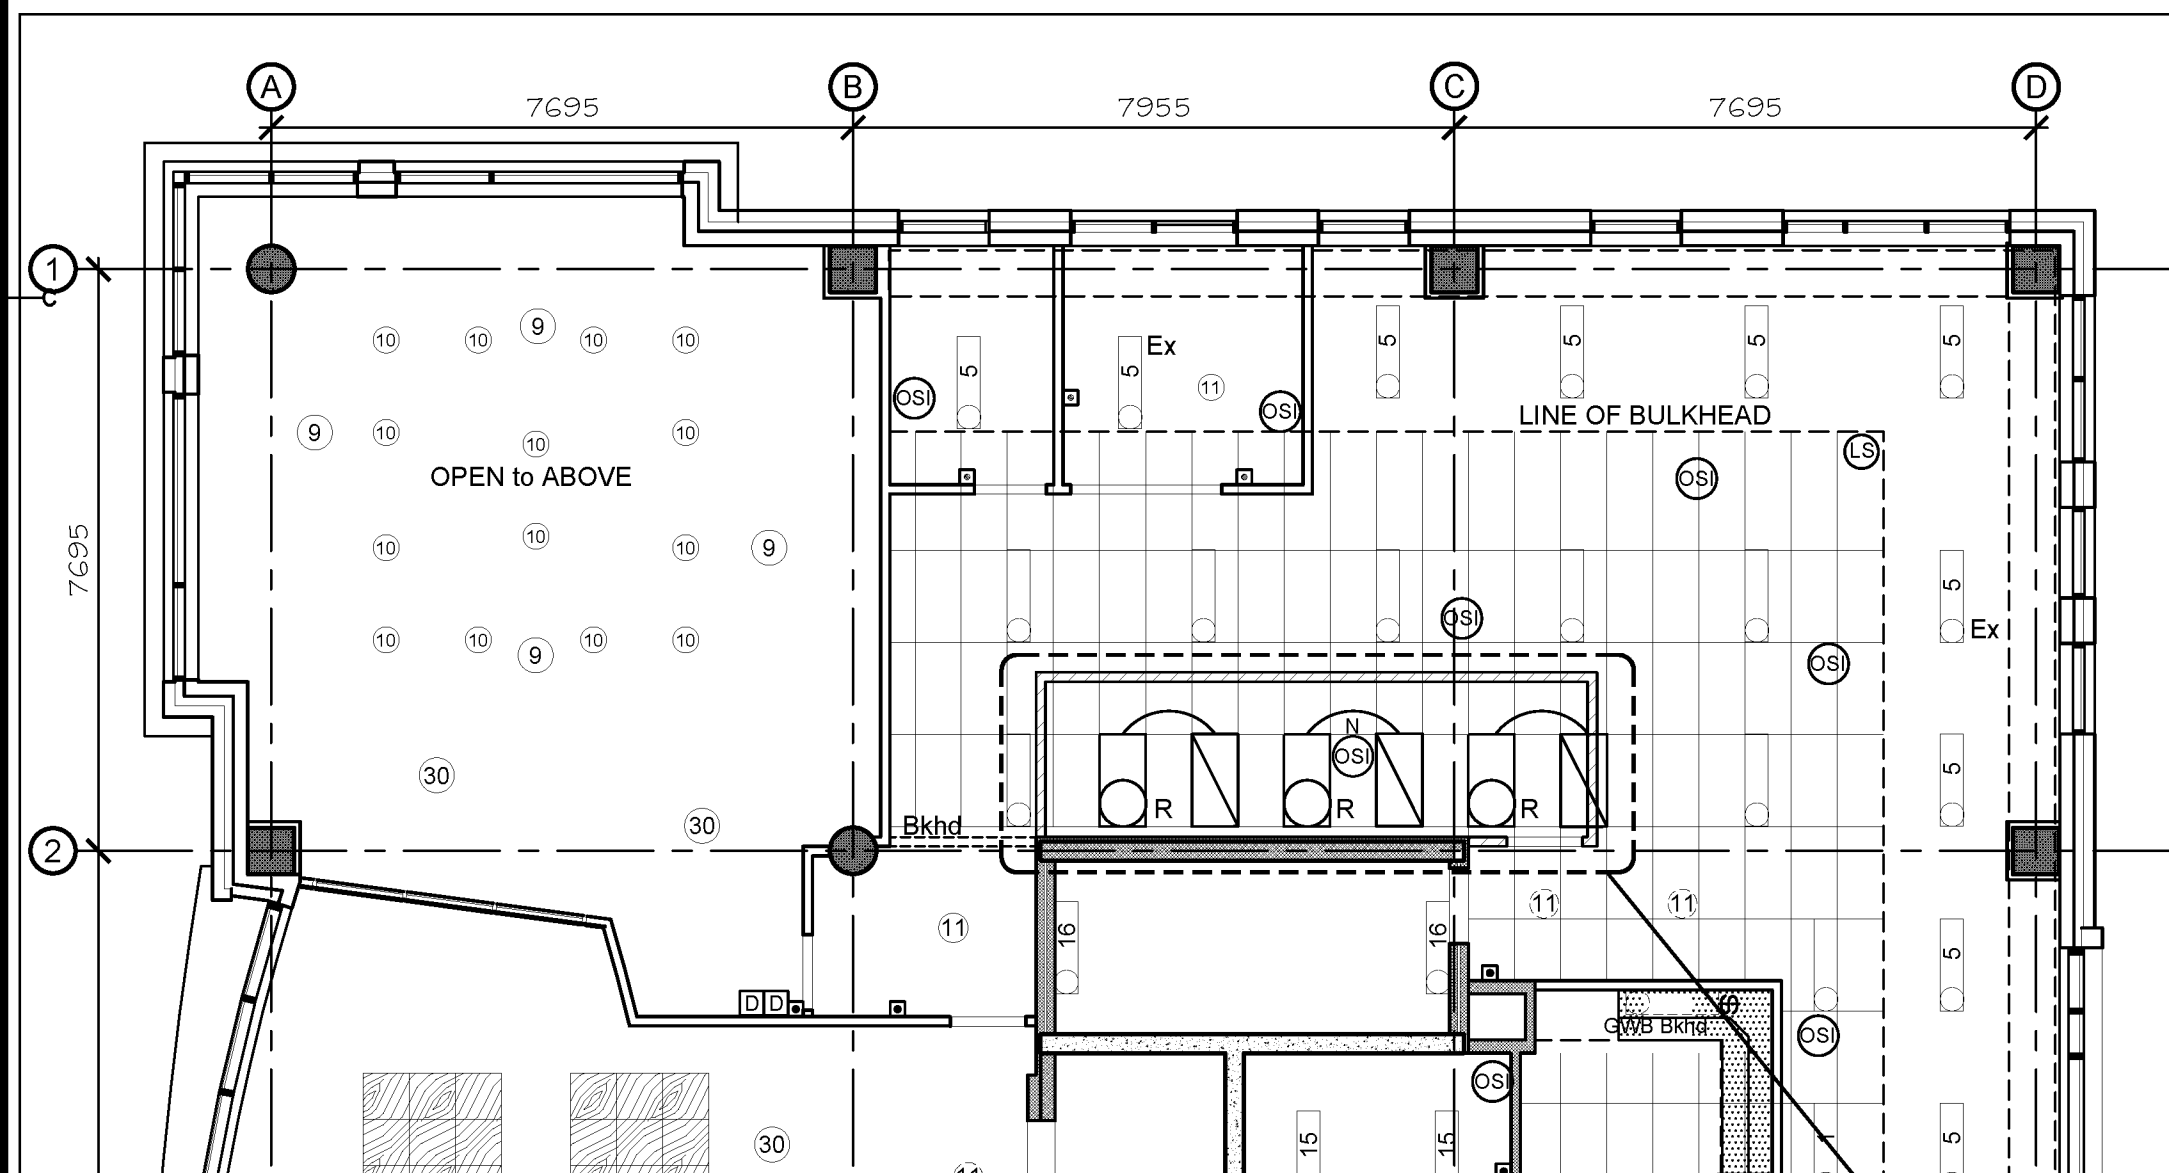

2 REFLECTED CEILING PLAN - LEVEL 300  
SCALE : 1:100  
0m 1m 2m 3m 4m 5m 6m 7m 8m 9m 10m

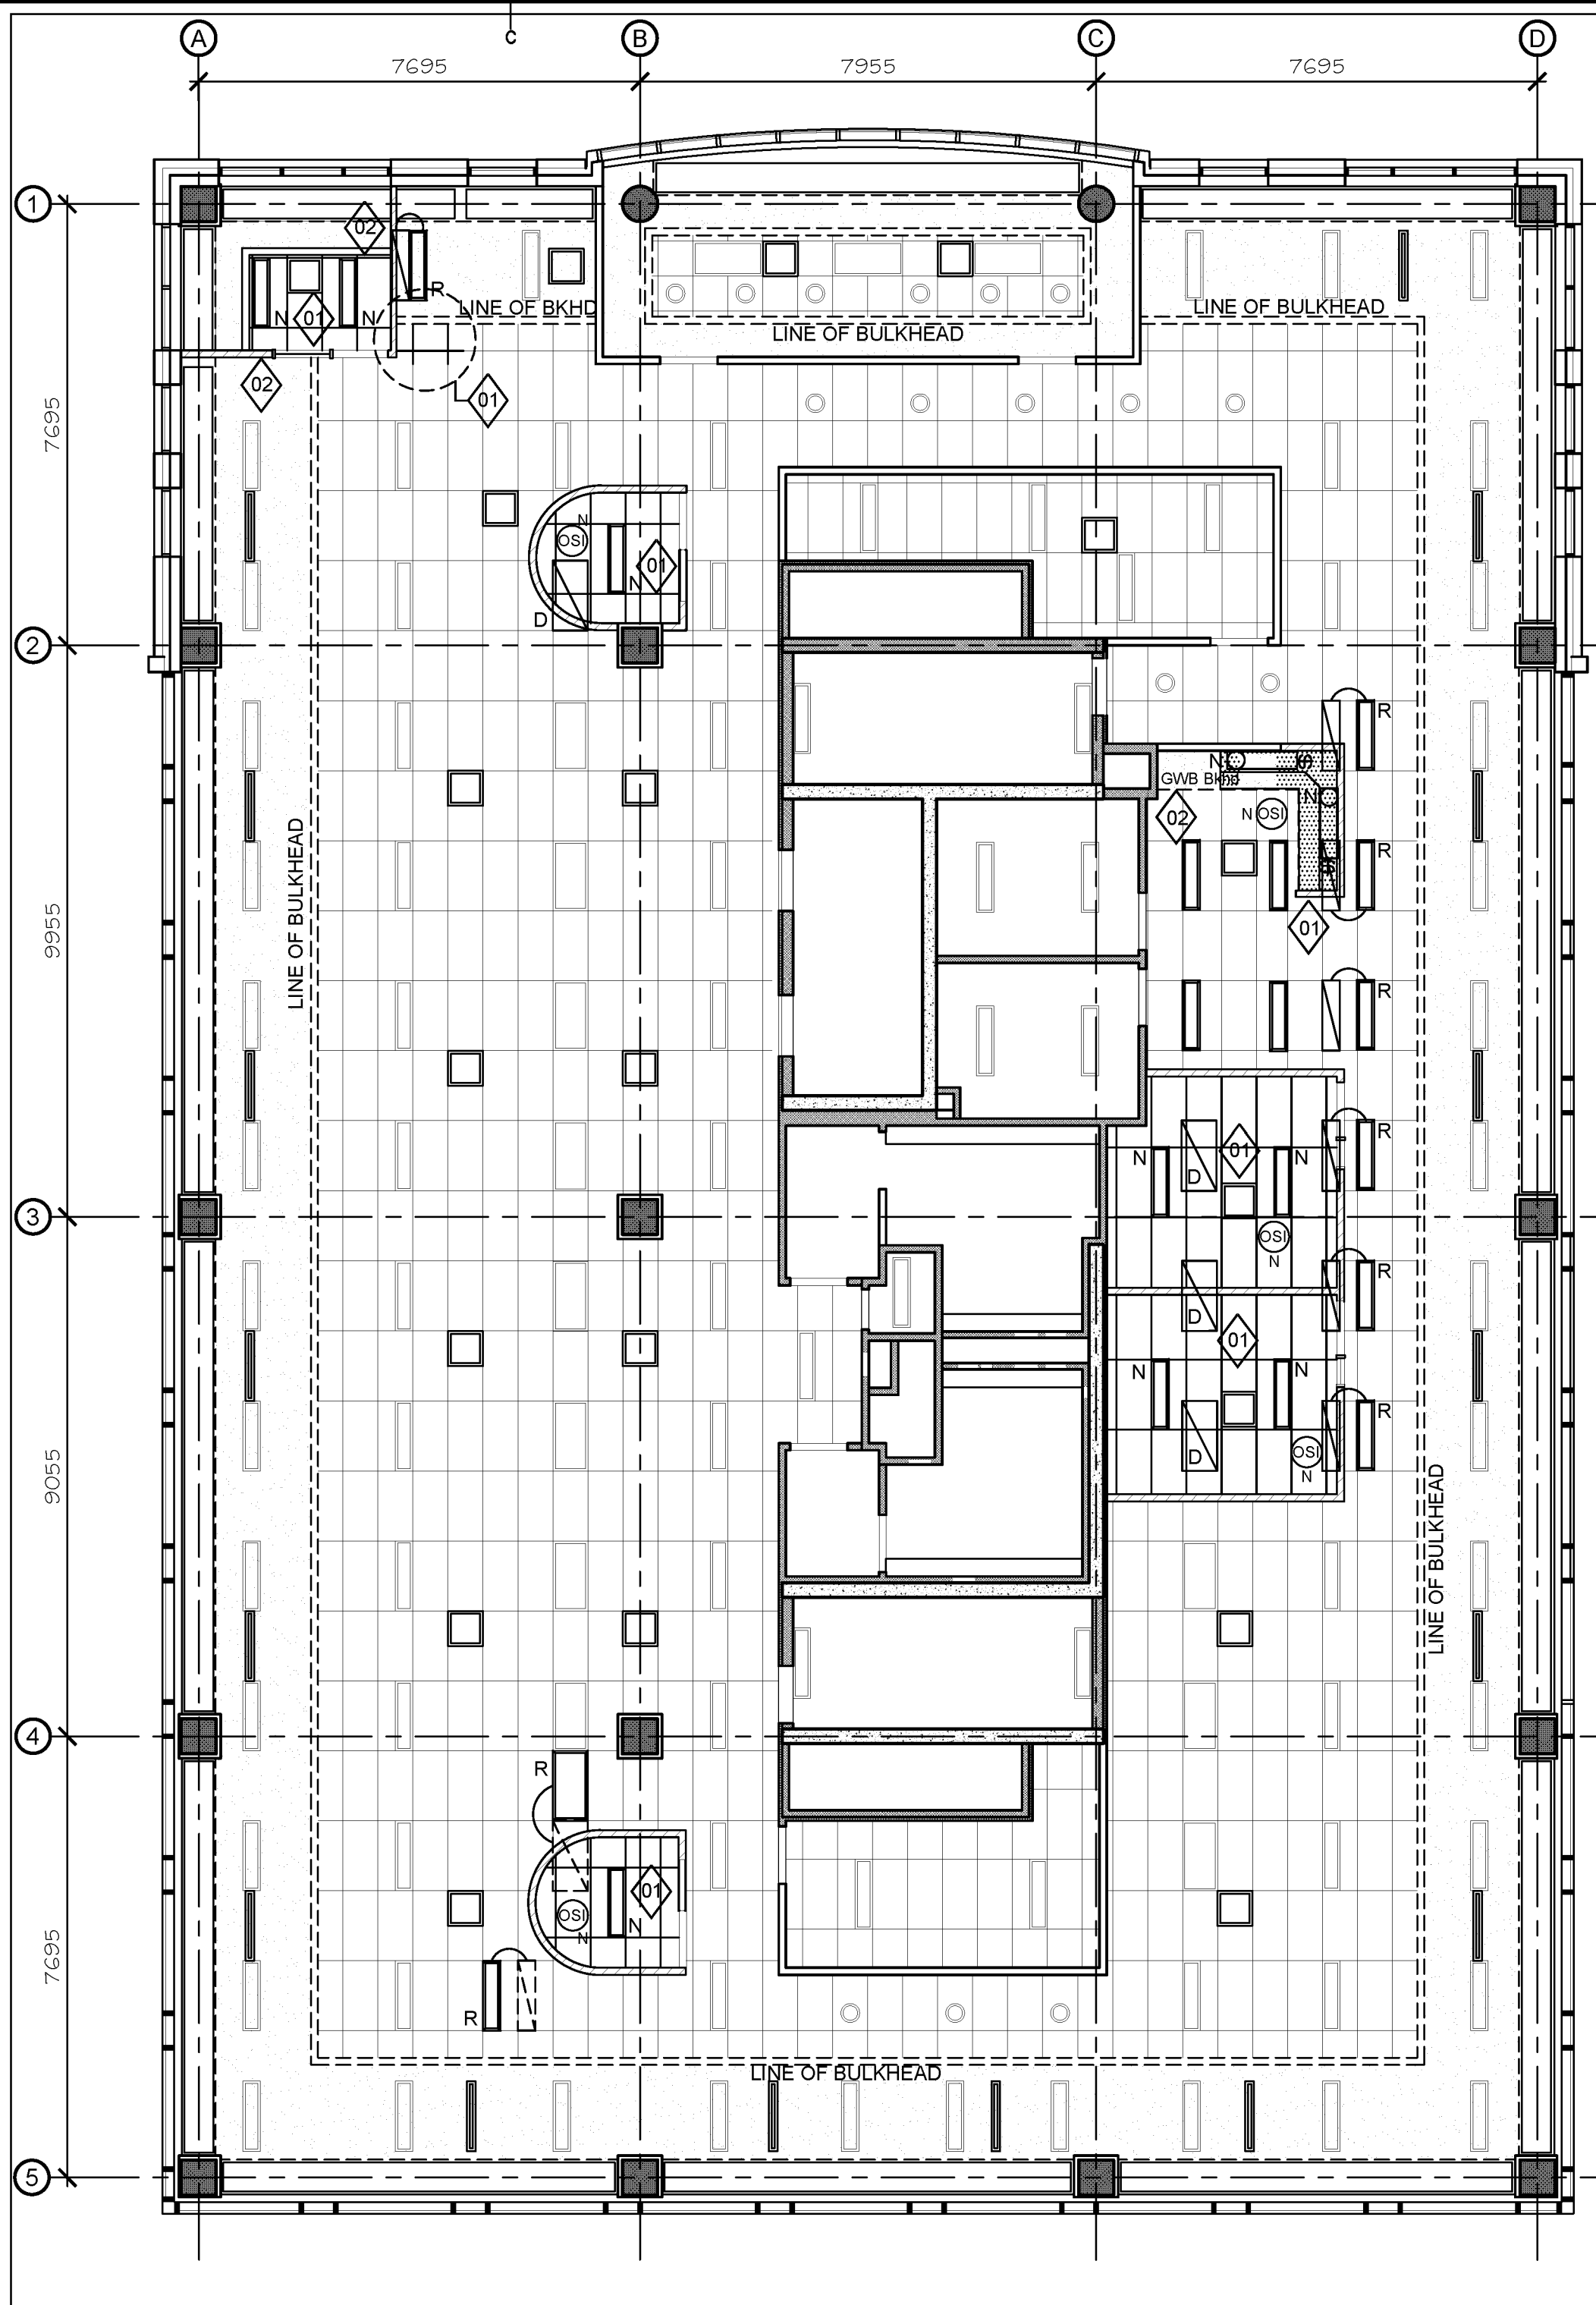

3 REFLECTED CEILING PLAN - LEVEL 400  
SCALE : 1:100  
0m 1m 2m 3m 4m 5m 6m 7m 8m 9m 10m

NOTE: OUTLINE INDICATES WORK UNDER THIS CONTRACT. THE BALANCE OF THE FLOOR WAS COMPLETED IN MAR.2017

## REFLECTED CEILING NOTES

### 1.0 GENERAL

1.1 FOR CLARIFICATION: THE ACOUSTICAL TILE SYSTEM AND GENERAL FIXTURES ARE TO REMAIN AS IS. ANY CHANGES, DELETIONS, RELOCATIONS AND ADDITIONS MADE BY THE ENGINEERS TO SUIT THE NEW TENANT LAYOUT ARE FIT-UP COSTS.

1.2 REFLECTED CEILING PLAN PROVIDED BY KADESIGNS IS INTENDED TO INDICATE LOCATIONS ONLY. REFER TO THE ELECTRICAL DRAWINGS FOR SPECIFIC SWITCHING, DETAILS, SPECIFICATIONS AND OTHER TECHNICAL INFORMATION. IN THE EVENT OF A CONFLICT BETWEEN THE INTERIOR REFLECTED CEILING AND THE ENGINEER'S ELECTRICAL DRAWINGS / SPECIFICATIONS, THE ENGINEER'S DRAWINGS TAKE PRECEDENCE.

1.3 ANY ERRORS OR DISCREPANCIES OR ANY CONFLICTING REQUIREMENTS TO THE MECHANICAL OR SPRINKLER SYSTEMS AND LIGHT FIXTURE LOCATIONS ARE TO BE BROUGHT TO THE ATTENTION OF THE SITE PROJECT MANAGER AND ENGINEERS BEFORE PROCEEDING WITH WORK.

1.4 EXIT LIGHTING FIXTURES AND EMERGENCY LIGHTING AS PER CODE. REFER TO ELECTRICAL ENGINEER'S DRAWINGS.

1.5 THE EXISTING ACOUSTICAL TILE SUSPENSION SYSTEM IS BASED ON A 610mm X 1219mm GRID, UNLESS OTHERWISE NOTED.

1.6 PLEASE NOTE THAT SUITE 308 IS OPEN TO THE SLAB ABOVE @ 3600mm AFF.

1.7 CONTRACTOR TO PROVIDE ALL OPENINGS AND ACCESS HATCHES IN ANY NEW DRYWALL BULKHEADS AND ACOUSTICAL CEILING SYSTEMS TO ACCOMMODATE SPRINKLERS, EXIT LIGHTS, ACCESS PANELS, RECESSED LUMINAIRES, AIR DIFFUSERS, CEILING FANS, ANNUNCIATORS AND / OR SPEAKERS. REFER TO ELECTRICAL ENGINEER'S DRAWINGS FOR SPECIFICS.

1.8 CONTRACTOR MUST PROVIDE LISTED FIRE STOPS ON ANY DUCTWORK PIERCING FIRE RATED CEILING ASSEMBLIES.

1.9 CONTRACTOR TO ENSURE ANY NEW OR RELOCATED LUMINAIRES AND LENSES ARE CLEAN AND FREE OF DAMAGE.

### EXISTING BUILDING LUMINAIRES



#### LEGEND

- 'D' - INDICATES ITEM TO BE REMOVED AND/OR RELOCATED
- 'R' - INDICATES ITEM HAS BEEN RELOCATED
- 'N' - INDICATE NEW ITEM IS REQUIRED
- 'EX' - INDICATES EXISTING ITEM TO REMAIN AS IS. ANY MINOR CHANGES IN WIRING AS PER ENGINEER
- 'XX' - LUMINARE NUMBER REFERS TO EXISTING ELECTRICAL SCHEMATICS AND FIXTURE TYPES

- - RECESSED LAY-IN FLUORESCENTS
- - CEILING SUSPENDED LINEAR FLUORESCENTS
- # - RECESSED OR SUSPENDED DOWNLIGHTS / WALLWASHERS
- - WALL SCONCES
- - SWITCHING, WALL BOX DIMMER
- - OCCUPANCY SENSORS
- - LOW VOLTAGE LIGHT LEVEL SENSORS

### PROJECT SPECIFIC NOTES:

- 01 CONTRACTOR TO REPLACE ACOUSTICAL CEILING SYSTEM WITH NEW IN AREAS IMPACTED BY DEMOLITION. ALIGN WITH EXISTING T-BAR.
- 02 CONTRACTOR TO MAKE GOOD EXISTING GWB BULKHEADS, DAMAGED ACOUSTICAL TILE / GRID, LUMINAIRES, ETC IMPACTED BY THE RELOCATION OF A LUMINAIRE, MOTION SENSOR, HVAC AND SPRINKLER. NEW TILE TO MATCH ADJACENT TILE - WHETHER NOTED OR NOT ON THIS DRAWING.
- 03 ANY NEW LUMINAIRE, MOTION SENSOR, CONTROLS, SPRINKLERS, ETC. AS PER ENGINEER'S SPECIFICATIONS

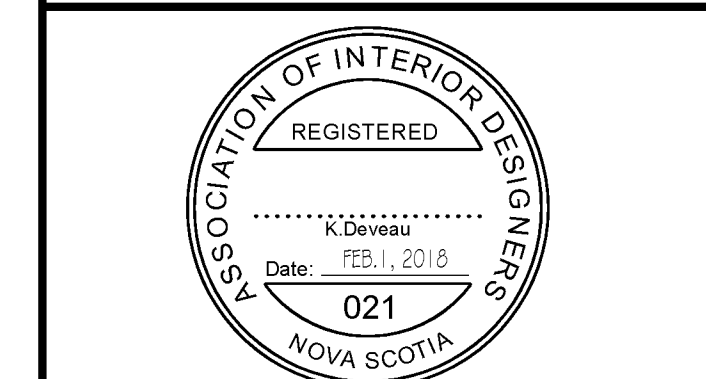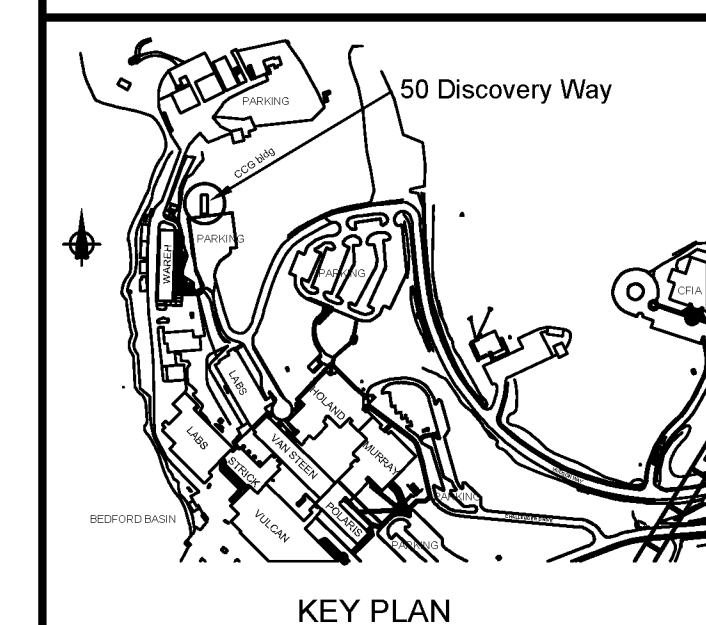

1	ISSUED FOR TENDER	01.26.2018
revisions		date
project		project

CCG WP2.0 FIT-UP  
MARITIME HEADQUARTERS  
BEDFORD INSTITUTE OF OCEANOGRAPHY  
DARTMOUTH  
NOVA SCOTIA

drawing dessin

LEVEL 200, 300 & 400  
REFLECTED CEILING  
PLAN

designed	KADesigns	conçu
date		
drawn	KAD	dessiné
date	JUN.15.2016	
approved		approuvé
date		
Tender	IAN SCELES	Soumission
project number	PWGSC Project Manager	Administrateur de projets TPSGC
	R.082156.001	
drawing no.		no. du dessin

A.07