


2
E.06 **DETAIL - NEW LIGHTING CONTROL**
SCALE: N/A



TYPICAL FOR QUIET #2 304E, SM MEET 304D, BUSINESS CENTER 304B KITCHEN 304F AND QUIET 304A.
NOTE: ELECTRICAL CONTRACTOR SHALL TURN ALL EXISTING REMOVED ENCELIUM DEVICES OVER TO OWNER.

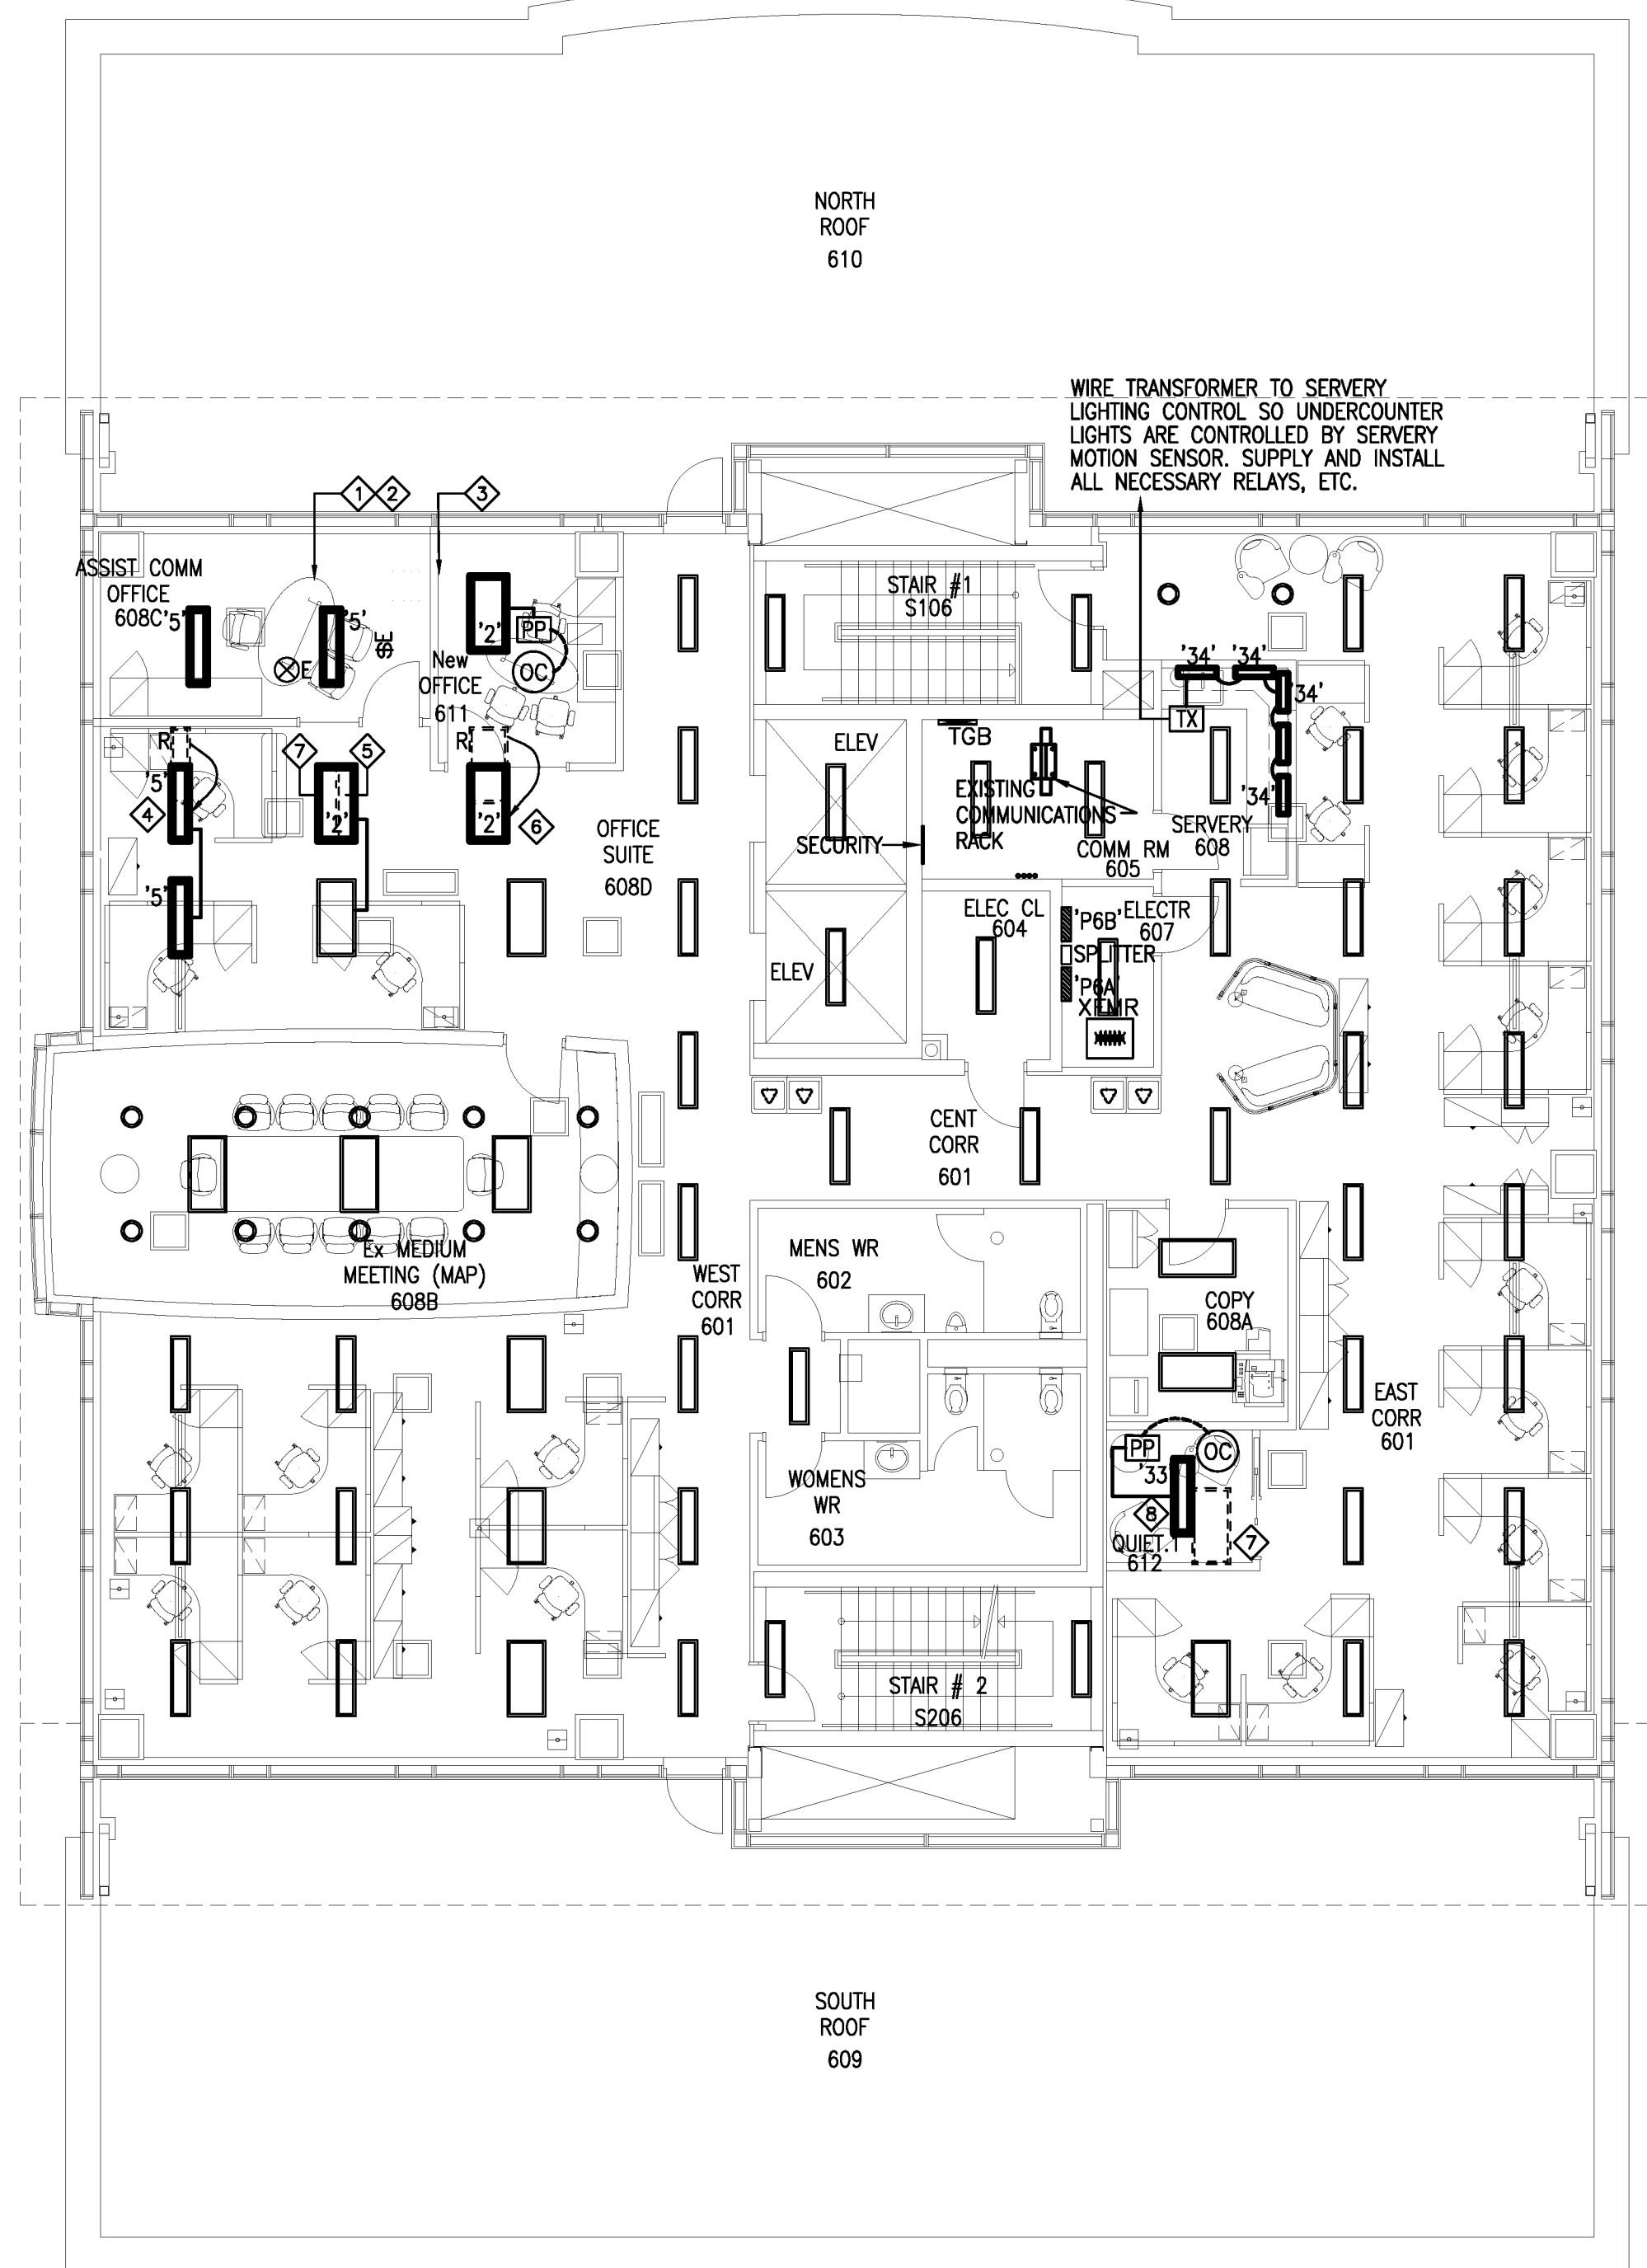


1
E.06 **LEVEL 600 FLOOR PLAN - LIGHTING**
SCALE : 1:100

LEVEL 600 LIGHTING NOTES:

1. DISCONNECT AND REMOVE TRACK LIGHT AND ALL ASSOCIATED WIRING AND CONTROLS. MAINTAIN CIRCUIT CONTINUITY TO ALL DEVICES TO REMAIN.
2. EXISTING OFFICE LIGHTING CONTROLS TO BE RELOCATED TO SUIT NEW CONSTRUCTION. RE-INSTALL AND RE-WIRE TO CONTROL LIGHTING WITHIN OFFICE ONLY.
3. EXISTING LIGHTING FIXTURE TO BE DISCONNECTED, REMOVED AND RE-INSTALLED IN NEW OFFICE CEILING. RE-WIRE EXISTING FIXTURE TO NEW OCCUPANCY SENSOR AND POWER PACK FOR SEPARATE CONTROL OF ROOM LIGHTING. WIRE POWER PACK TO NEAREST AVAILABLE 347V UNLOADED AND NON-SWITCHED LIGHTING CIRCUIT.
4. RELOCATE EXISTING LIGHTING FIXTURE. RE-CIRCUIT TO ADJACENT FIXTURE AS INDICATED.
5. INSTALL TYPE '2' LIGHTING FIXTURE, RELOCATED FROM LEVEL 500. WIRE TO ADJACENT LIGHTING FIXTURE AS INDICATED.
6. RELOCATE EXISTING LIGHTING FIXTURE. EXTEND WIRING AS REQUIRED.
7. DISCONNECT AND REMOVE EXISTING LIGHTING FIXTURE. MAINTAIN CIRCUIT CONTINUITY TO ALL EXISTING.
8. INSTALL NEW LIGHTING FIXTURE, OCCUPANCY SENSOR AND POWER PACK IN ROOM AS INDICATED. WIRE POWER PACK TO NEAREST AVAILABLE 347V NON-SWITCHED PORTION OF EXISTING UNLOADED LIGHTING CIRCUIT.

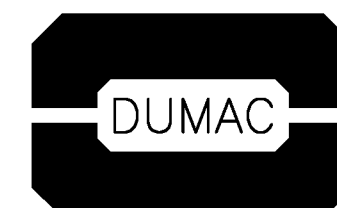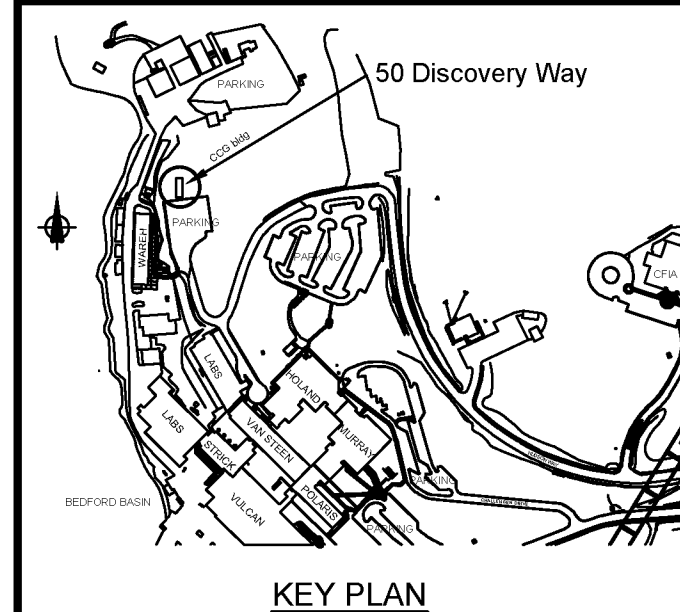

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1.	ISSUED FOR TENDER	01.26 2018
revisions		date
project		projet

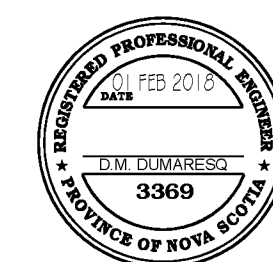**CCG WP2.0 FIT-UP
MARITIME HEADQUARTERS
BEDFORD INSTITUTE OF OCEANOGRAPHY
DARTMOUTH
NOVA SCOTIA**

drawing dessin
**CCG FIT-UP
LEVEL 600
FLOOR PLAN -
LIGHTING**

designed KADesigns	conçu
date	
drawn KAD	dessiné
date OCT.02.2017	
approved	approuvé
date	
Tender IAN SCELES	Soumission
PWGSC Project Manager	Administrateur de projets TPSGC
project number	no. du projet
R.082156.001	
drawing no.	no. du dessin
E.06	