DRAWING LIST

DRAWING LIST

COVER PAGE

CIVIL GRADING AND LANDSCAPING

BUILDING NO. 1 - NEW WATER TREATMENT PLANT

SITE PLAN

FLOOR PLAN ROOF PLAN AND ROOF DETAIL

ELEVATIONS

SECTION DETAIL a-a SECTION DETAIL b-b

DETAILS DETAILS

DOOR DETAIL & SCHEDULE WALL & FINISH SCHEDULE

PROJECT NOTES

TYPE PROJECT DETAILS
RCMP - FOUNDATION/MAIN FLOOR PLAN

RCMP - FRAMING PLAN

RCMP - SECTIONS

FLOOR PLAN PLUMBING

DETAILS

FLOOR PLAN HVAC DETAILS

BUILDING NO. 2 - OLD PUMP HOUSE

DEMOLITION PLAN

DEMOLITION ELEVATION FLOOR PLAN ROOF PLAN

ELEVATIONS A3 1 FLEVATIONS SECTION DETAIL a-a

SECTION DETAIL b-b DETAILS

DOOR DETAIL & SCHEDULE

WALL & FINISH SCHEDULE

PROJECT NOTES

RCMP - FOUNDATION/MAIN FLOOR PLAN S2.1

RCMP - FRAMING PLAN

DETAILS

ELECTRICAL BUILDING NO.1 AND NO. 2

WATER TREATMENT PLANT LIGHTING WATER TREATMENT PLANT POWER SCHEDULES AND DIAGRAM

WATER TREATMENT DRAWINGS

PROCESS LEGEND SHEET 1 PROCESS LEGEND SHEET 2 PROCESS P&ID SHEET 1

PROCESS P&ID SHEET 2

PROCESS P&ID SHEET 3

PROCESS P&ID SHEET 4 PROCESS MAIN FLOOR PLAN
PROCESS EXISTING WTP/PUMPHOUSE

EQUIPMENT DEMOLITION PLAN

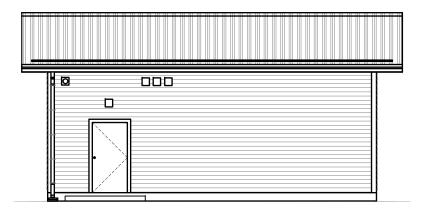
PROCESS

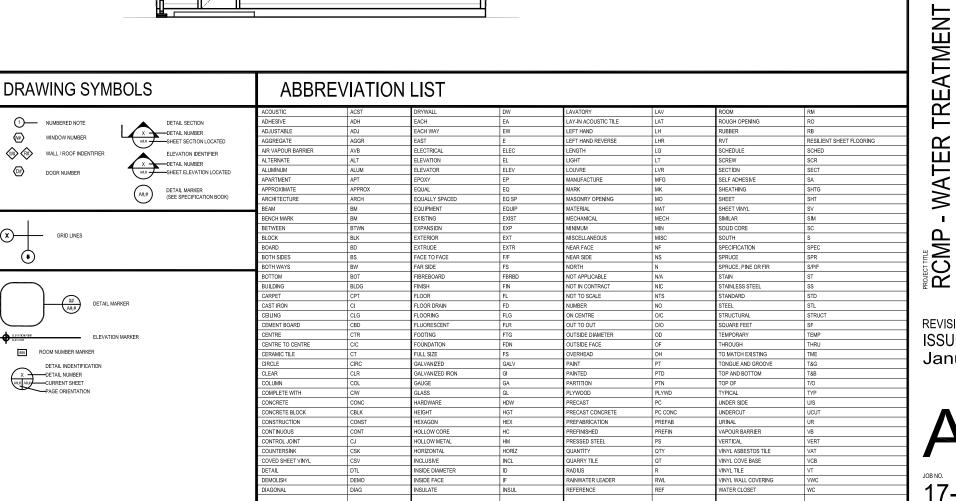
PROCESS - DETAILS

PROCESS - DETAILS
PROCESS EQUIPMENT SCHEDULE PROCESS VALVE SCHEDULE

PROCESS MAIN FLOOR PLAN 3D VIEW

ROYAL CANADIAN MOUNTED POLICE **NORWAY HOUSE** WATER TREATMENT PLANT TENDER - 18 01 26





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PLANT

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Beach Rocke

CONSULTANT LIST

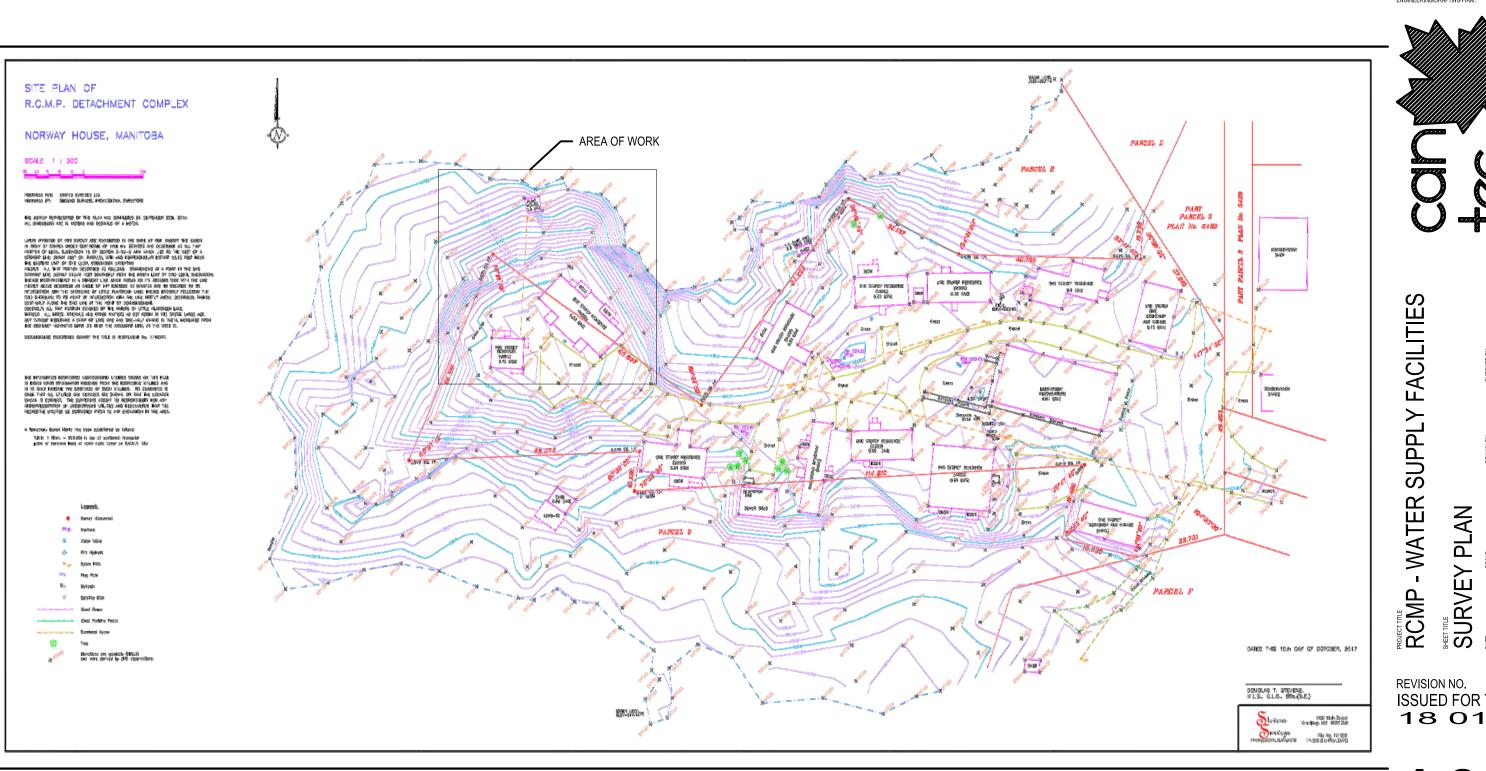
VATER TREATMENT CONSULTANT

MECHANICAL CONSULTANT:

Engineering Consultants

Winnipeg, Manitoba

6-1375 Niakwa Road E Telephone: (204) 255-4842 Facsimile: (204) 255-7679 E-mail: info@joreyelectric.com



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PRS RS

DRAWN XW

SCALE NTS

LOCATION NORWAY HOUSE,MB

ISSUED FOR TENDER 18 01 26









ISSUED FOR TENDER

DESCRIPTION

R.C.M.P.


NORWAY HOUSE DETACHMENT WATER TREATMENT PLANT


DESIGN

20174990-00

SCALE: AS SHOWN

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ISSUED FOR TENDER

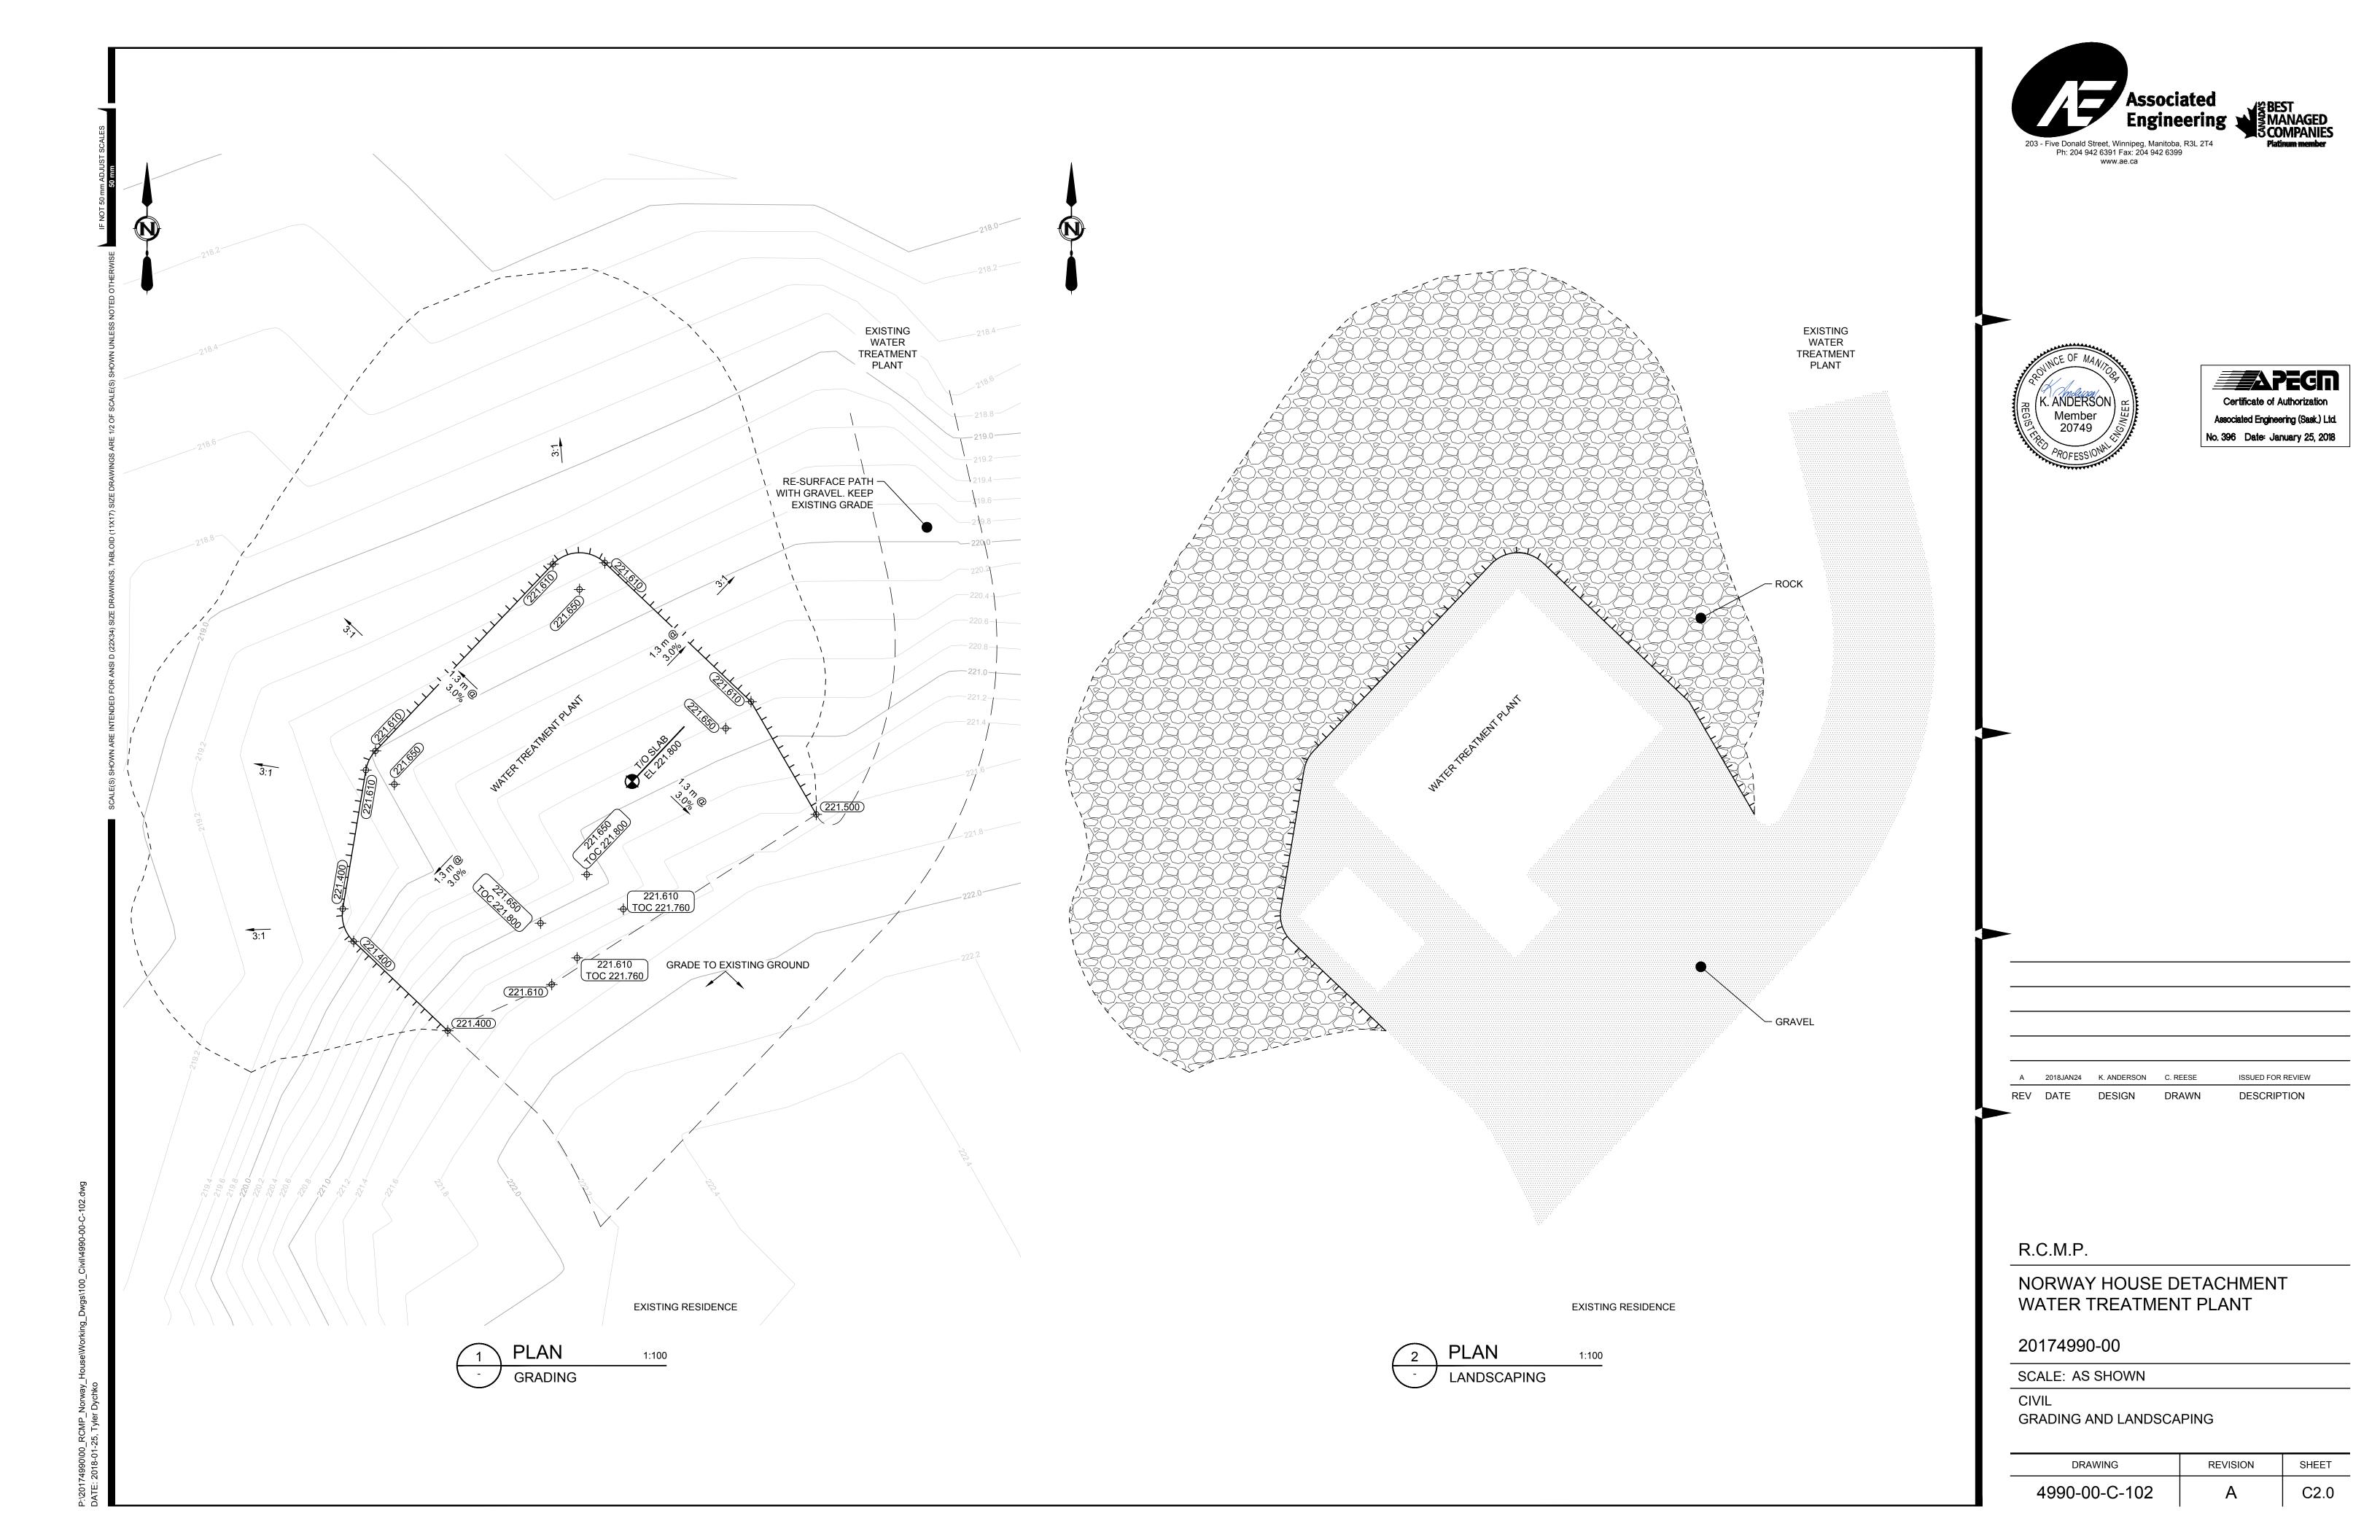DESCRIPTION

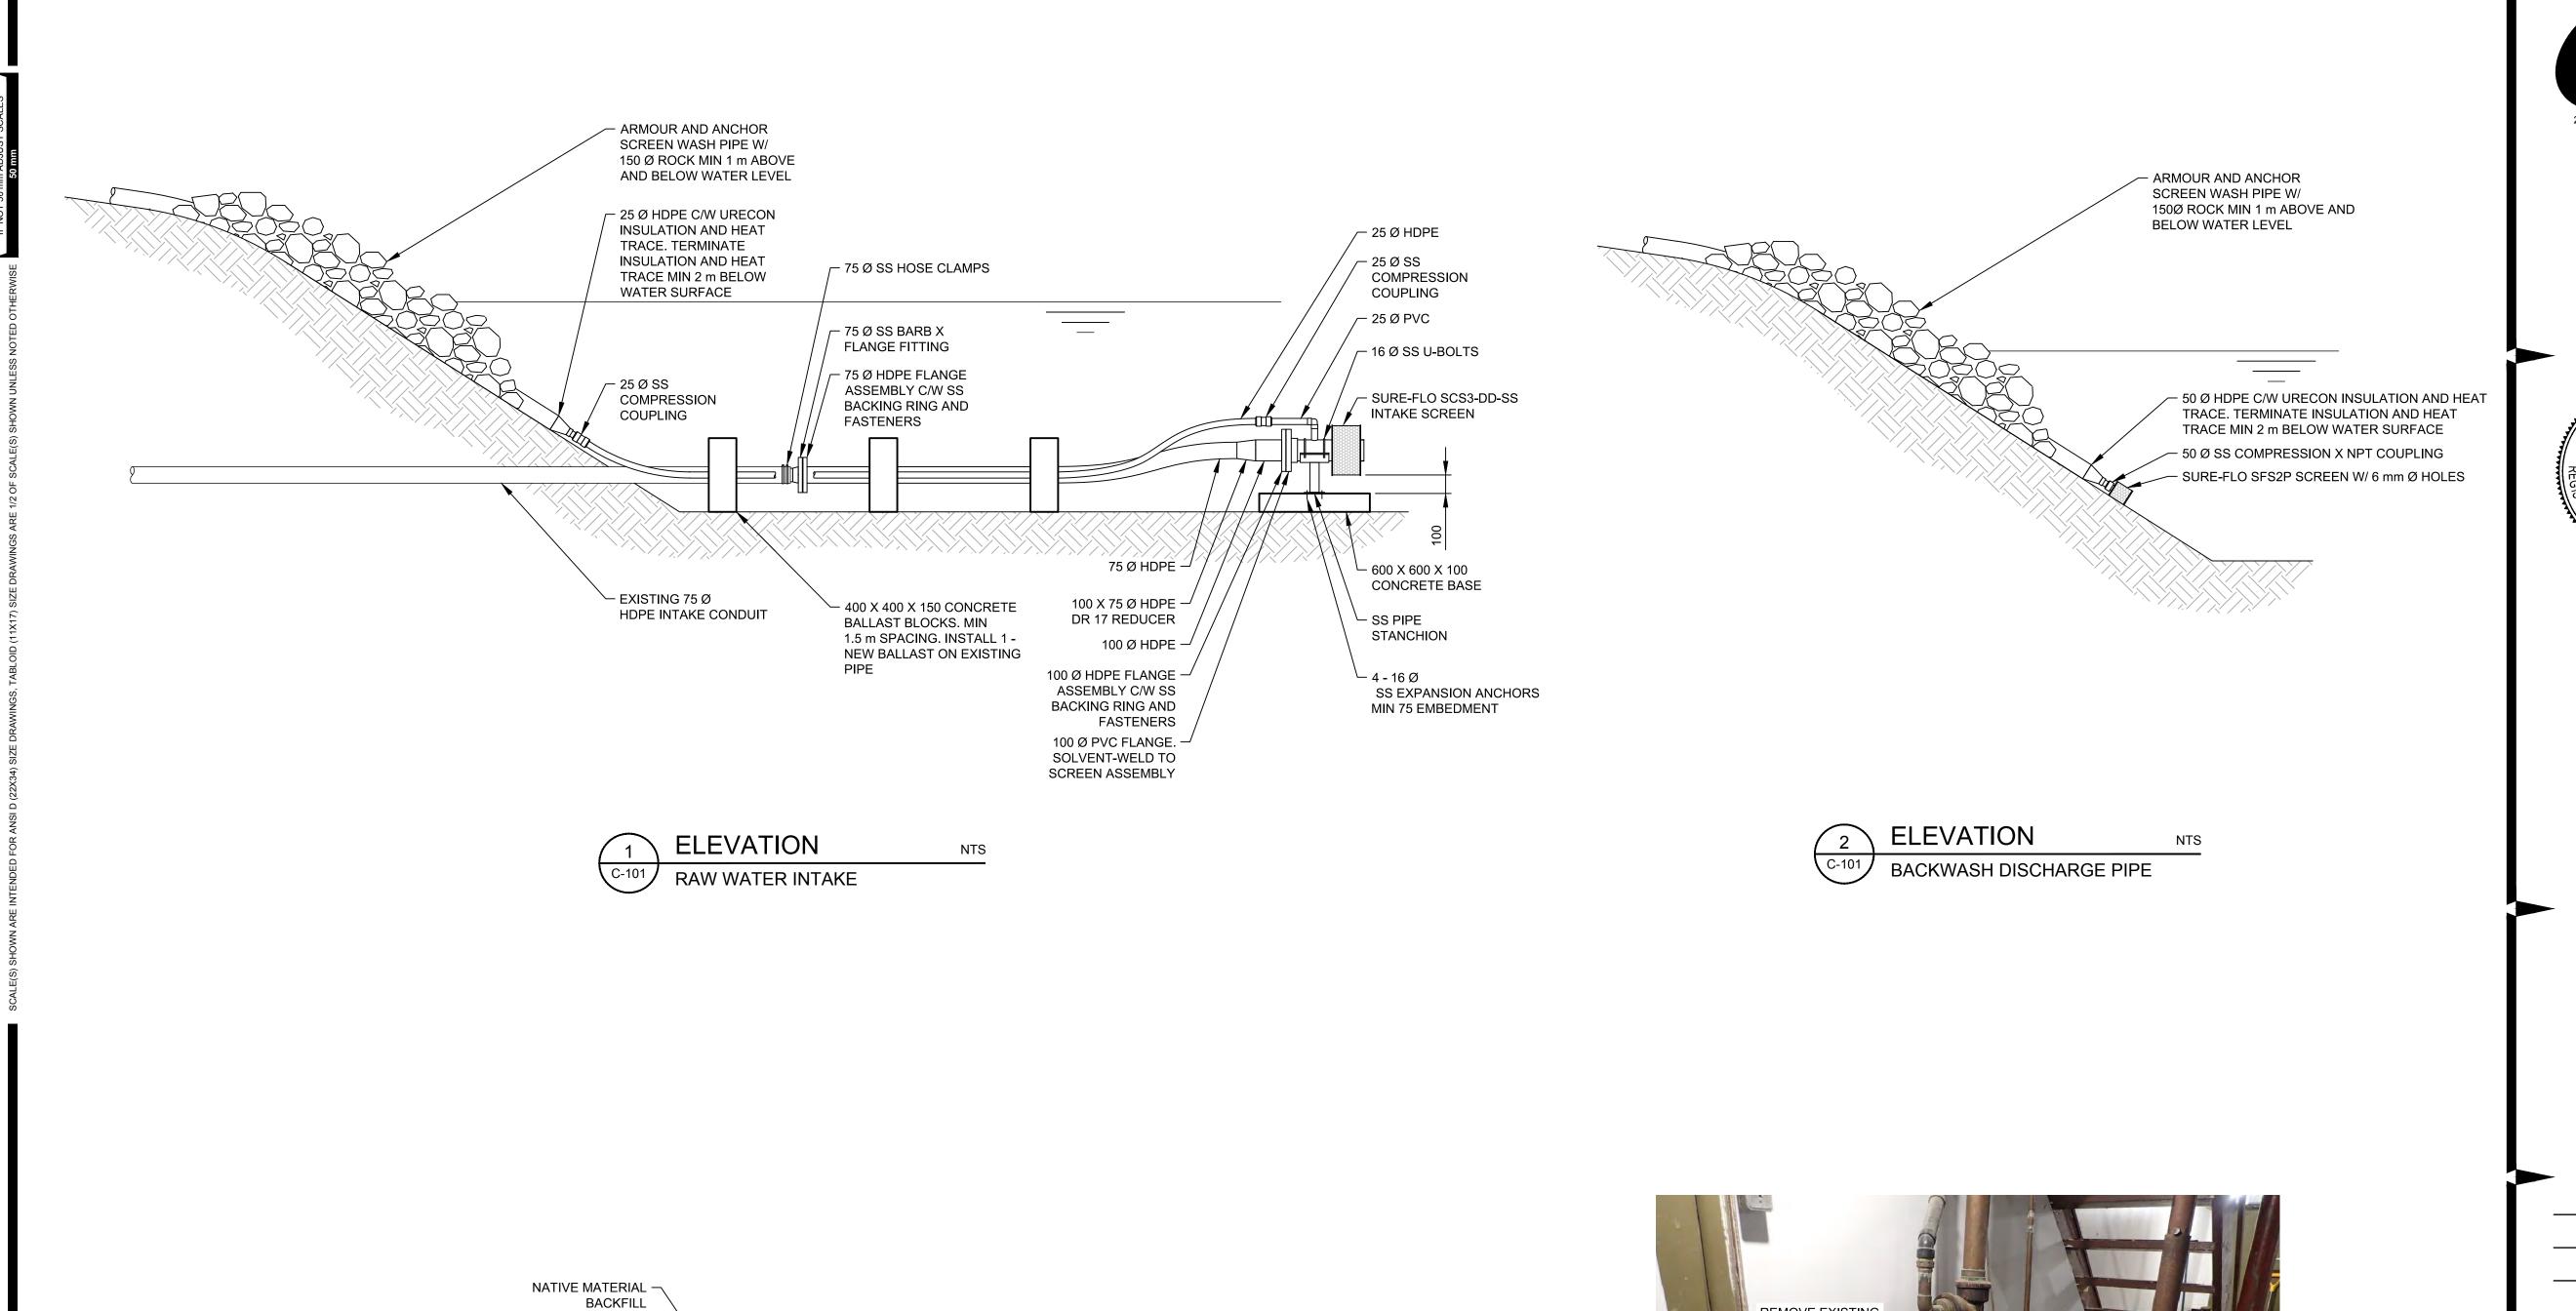

R.C.M.P.

REV DATE

NORWAY HOUSE DETACHMENT WATER TREATMENT PLANT

2018JAN25 K. ANDERSON C. REESE

DESIGN

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20174990-00

SCALE: AS SHOWN

CIVIL

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3 DETAIL NTS
- SHALLOW BURY WATER LINE

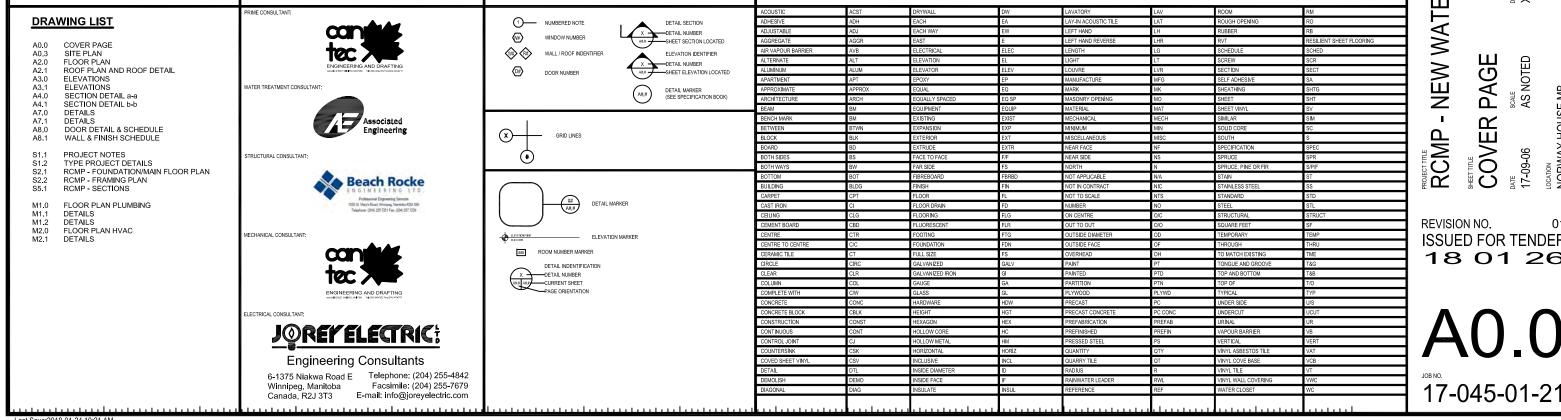


PHOTO NTS
POTABLE WATER MAIN

ROYAL CANADIAN MOUNTED POLICE

NORWAY HOUSE NEW WATER TREATMENT PLANT - BUILDING NO. 1 ISSUED FOR TENDER - 18 01 26

DRAWING SYMBOLS




ABBREVIATION LIST

TREATMENT PLANT - NEW WATER RAWN X PAGE RCMP COVE REVISION NO. **ISSUED FOR TENDER** 18 01 26

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CONSULTANT LIST

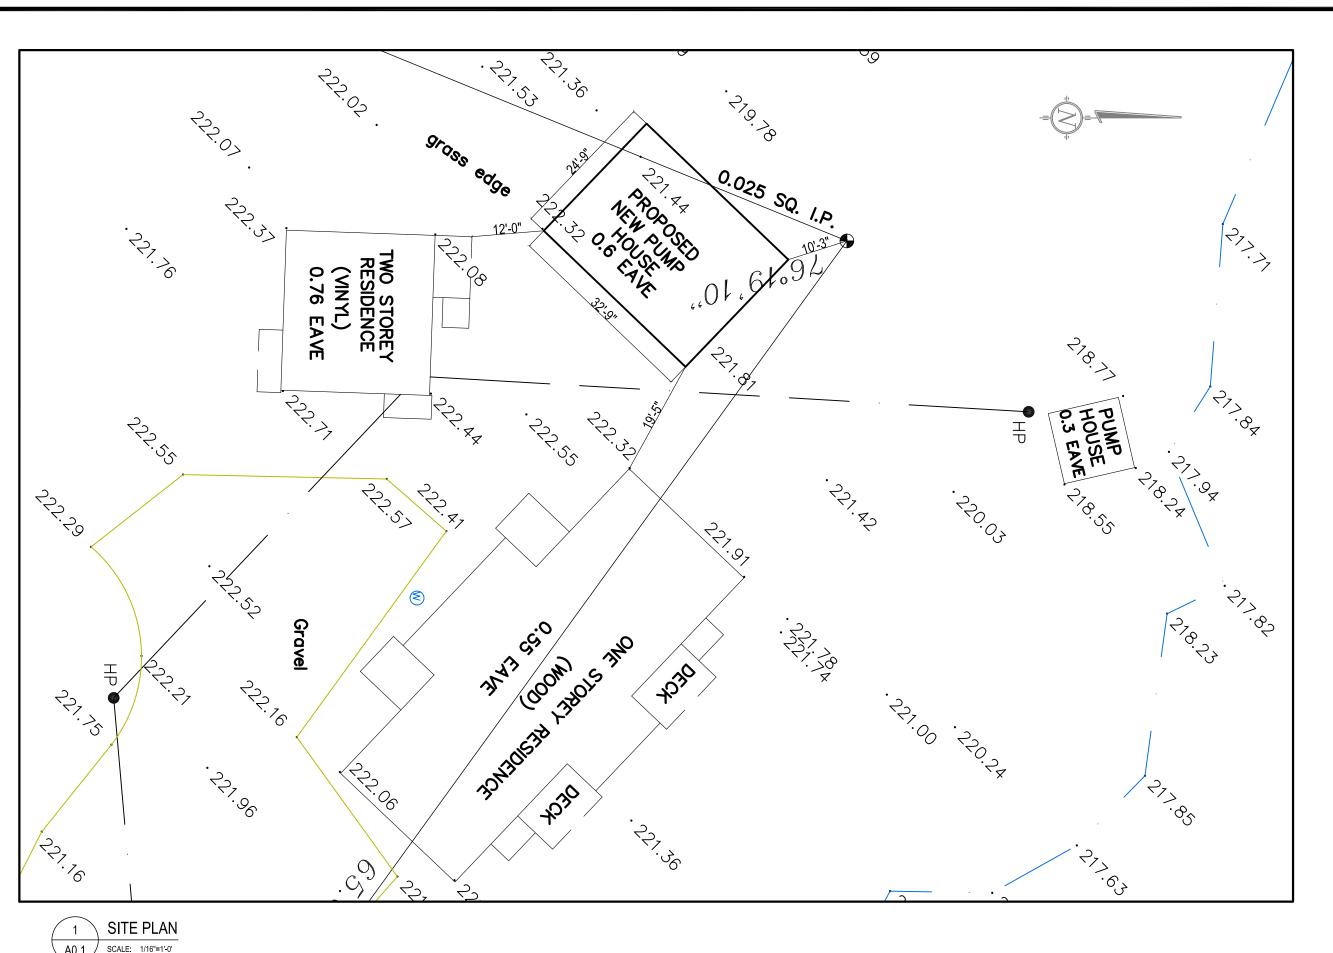

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ENGINEERING AND DRAFTING RCMP - NEW WATER TREATMENT PLANT

RS S

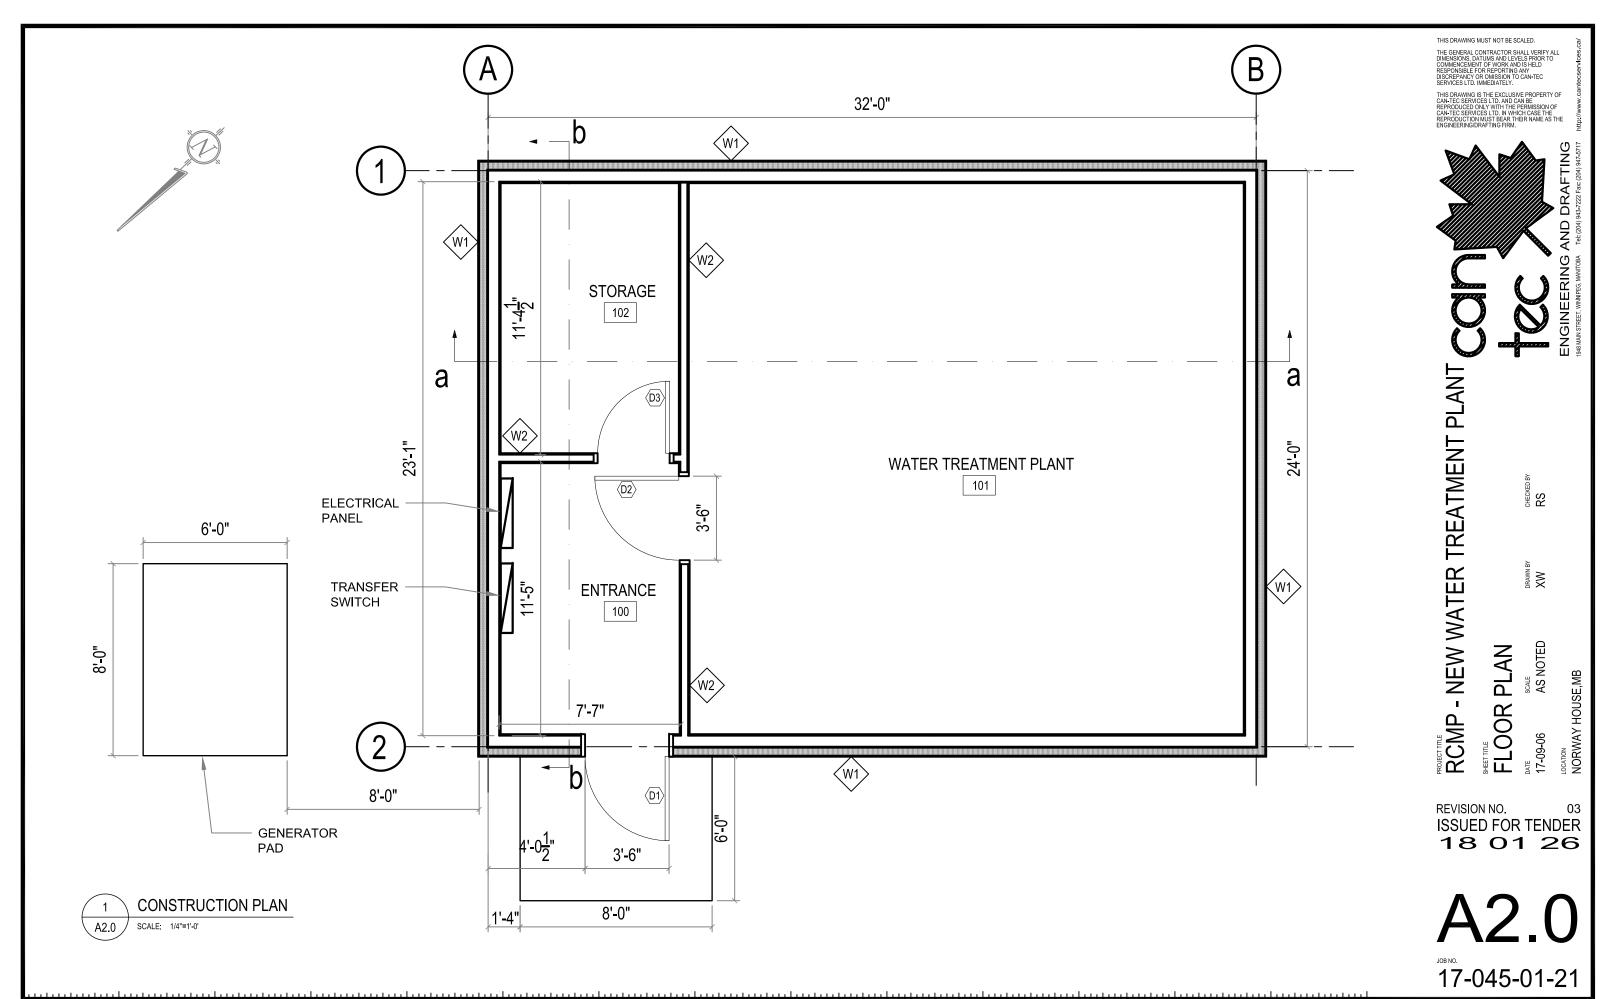
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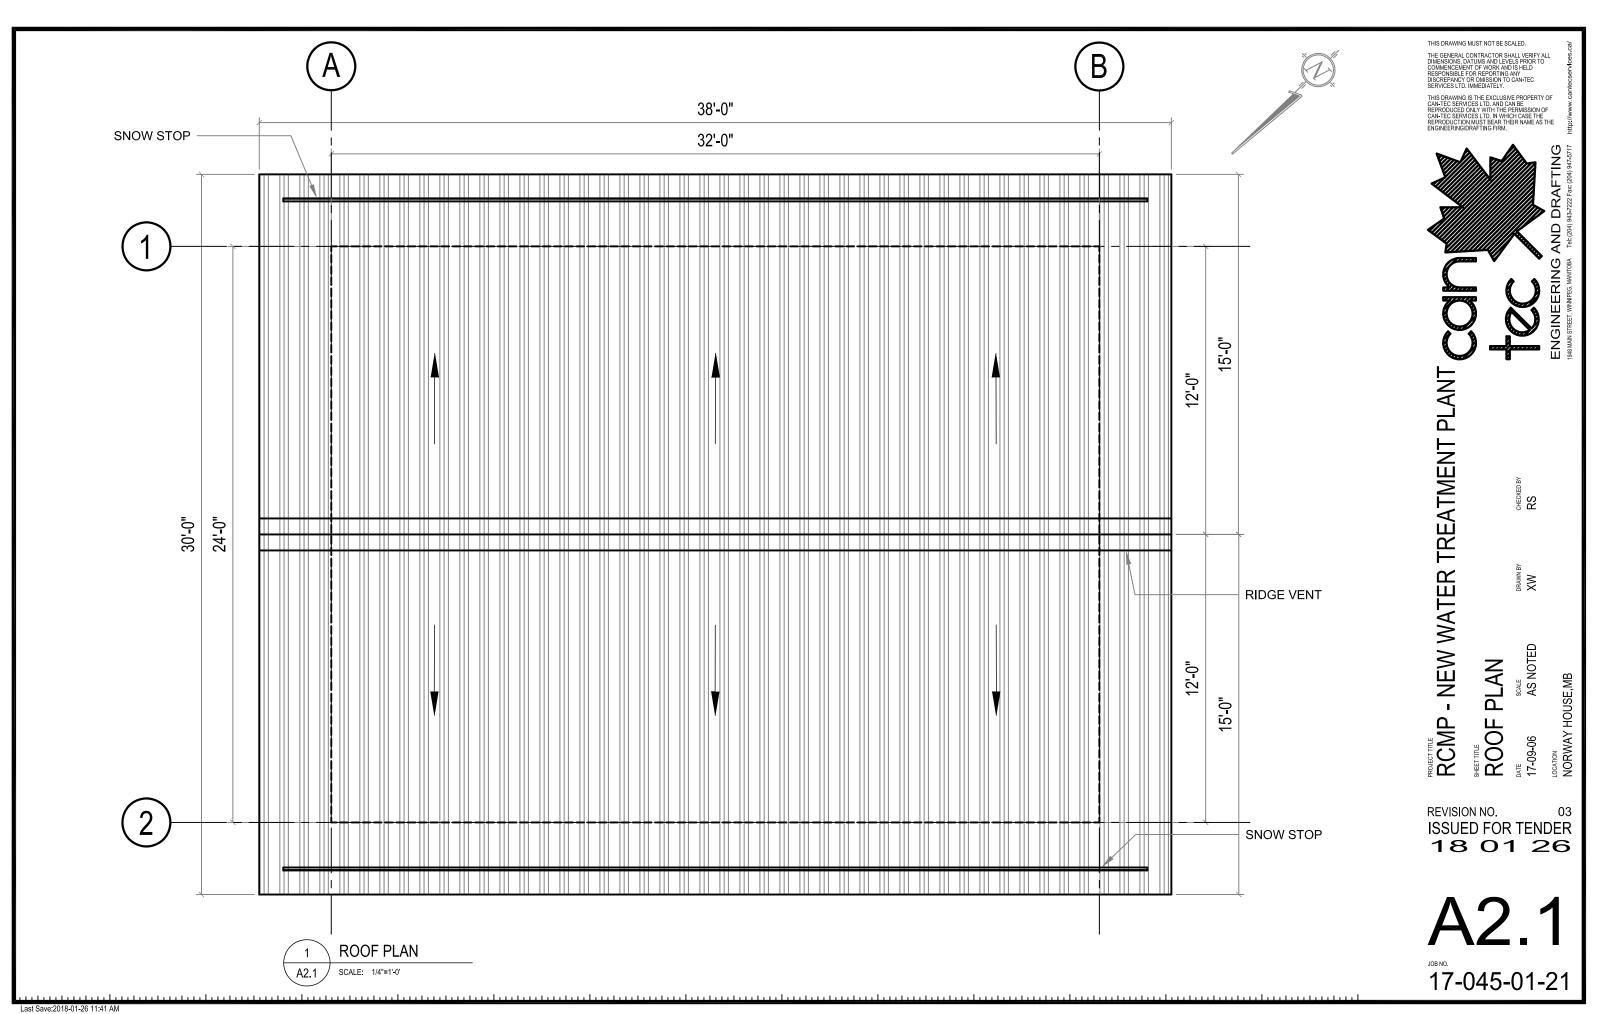
SCALE AS NOTED PLAN


LOCATION NORWAY HOUSE,MB _{рате} 17-09-06


REVISION NO. 03
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18 01 26

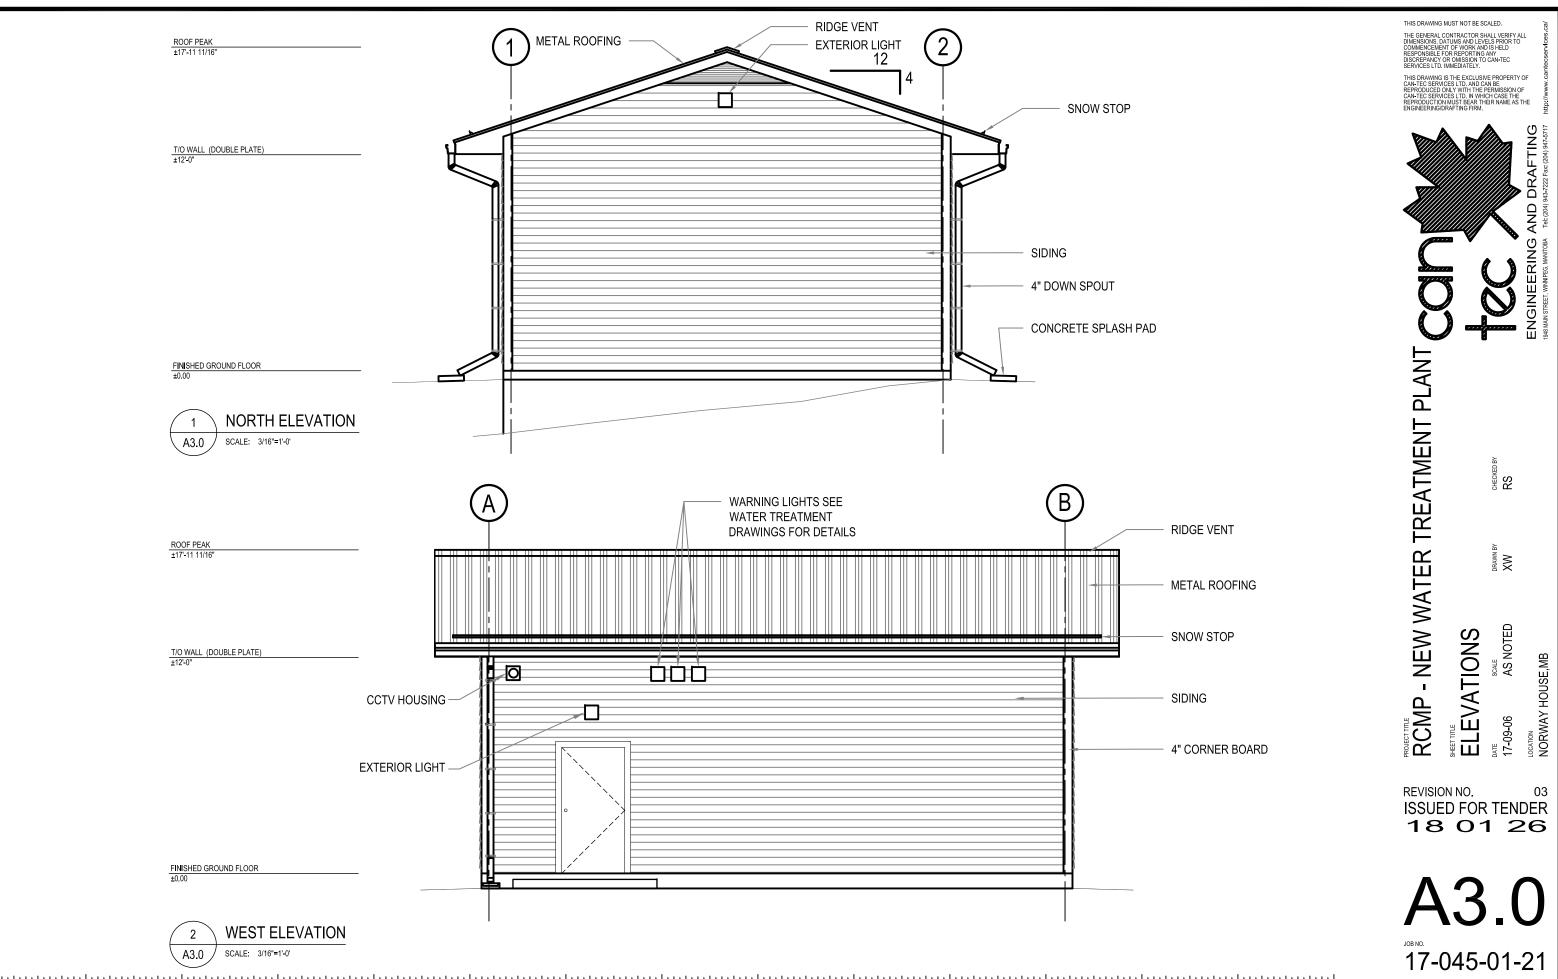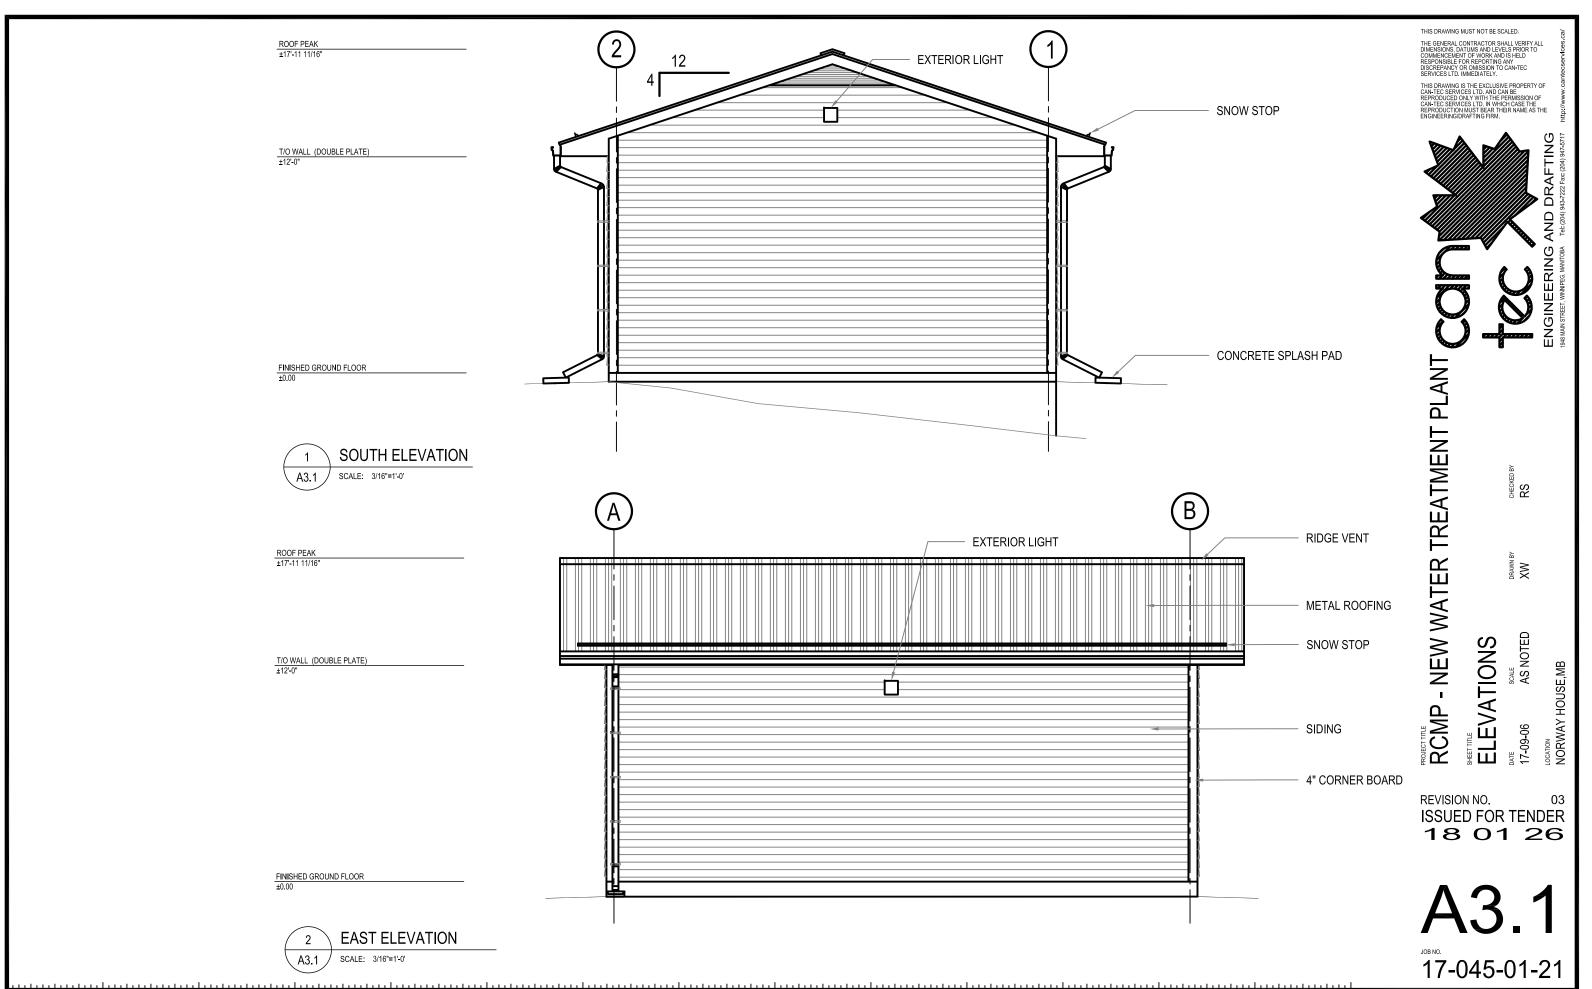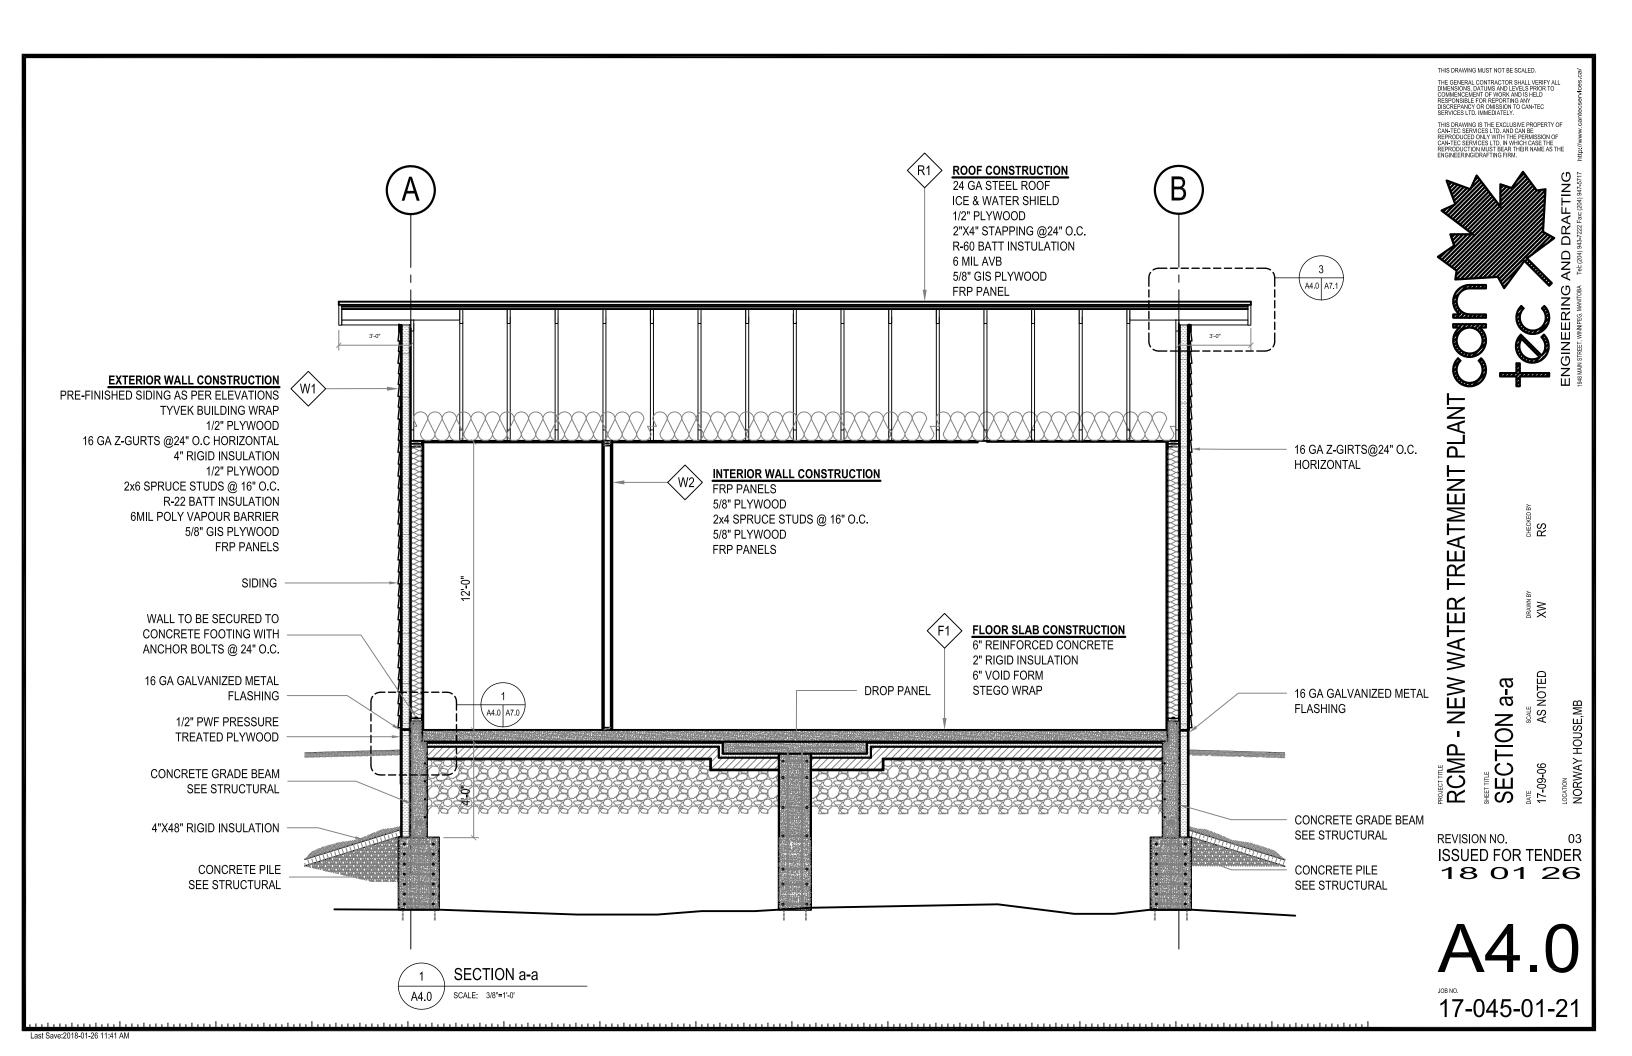
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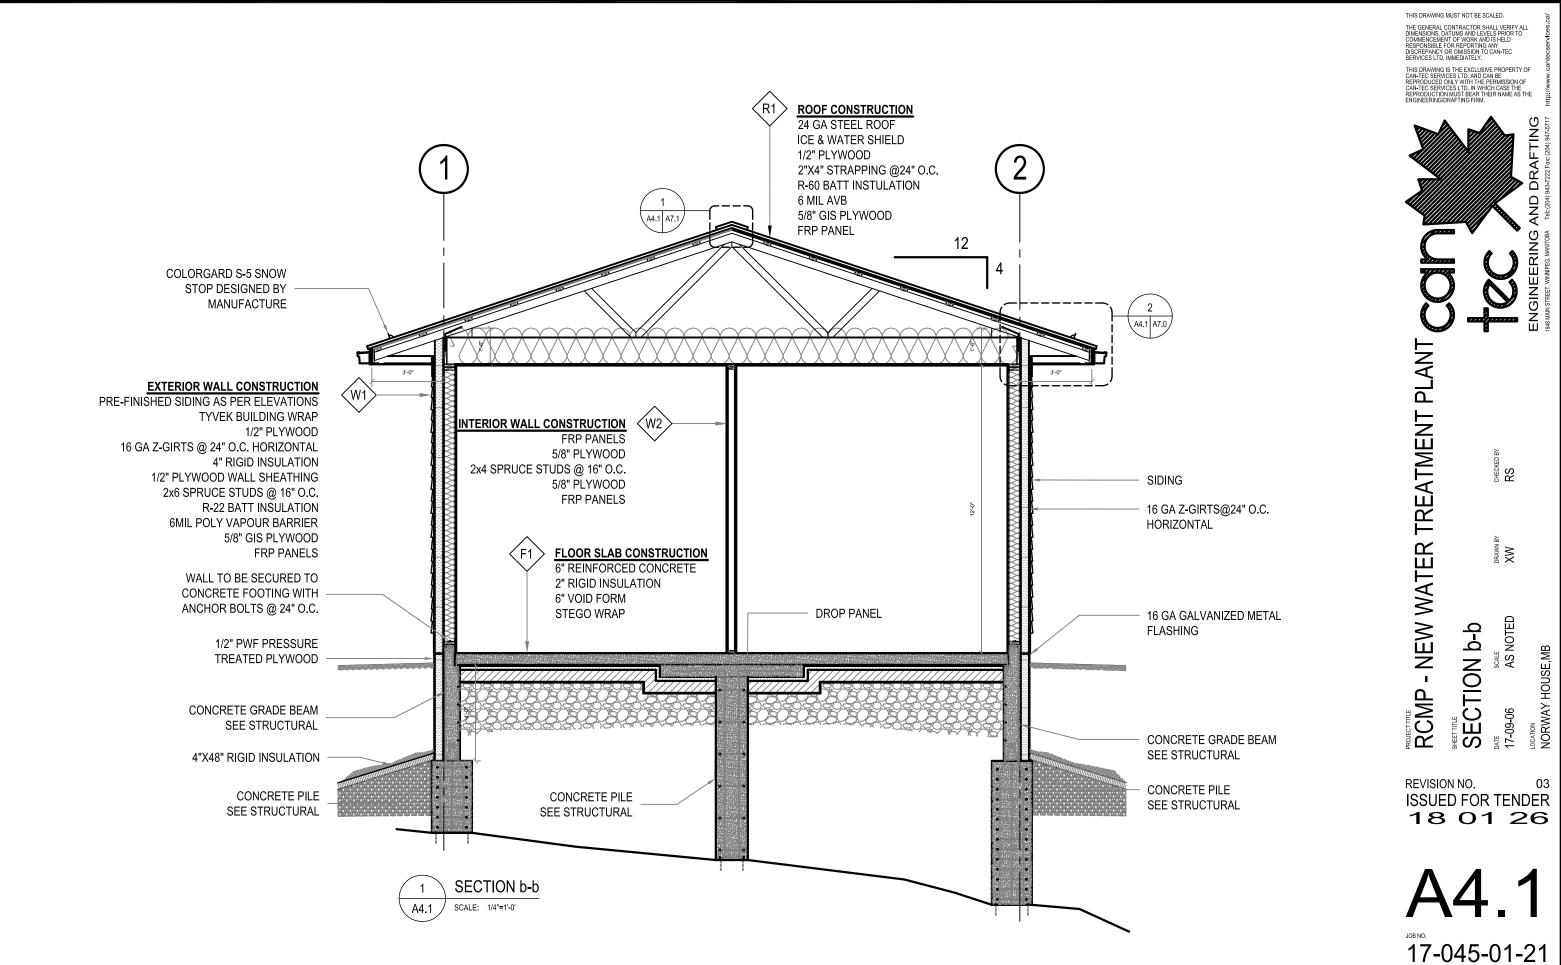


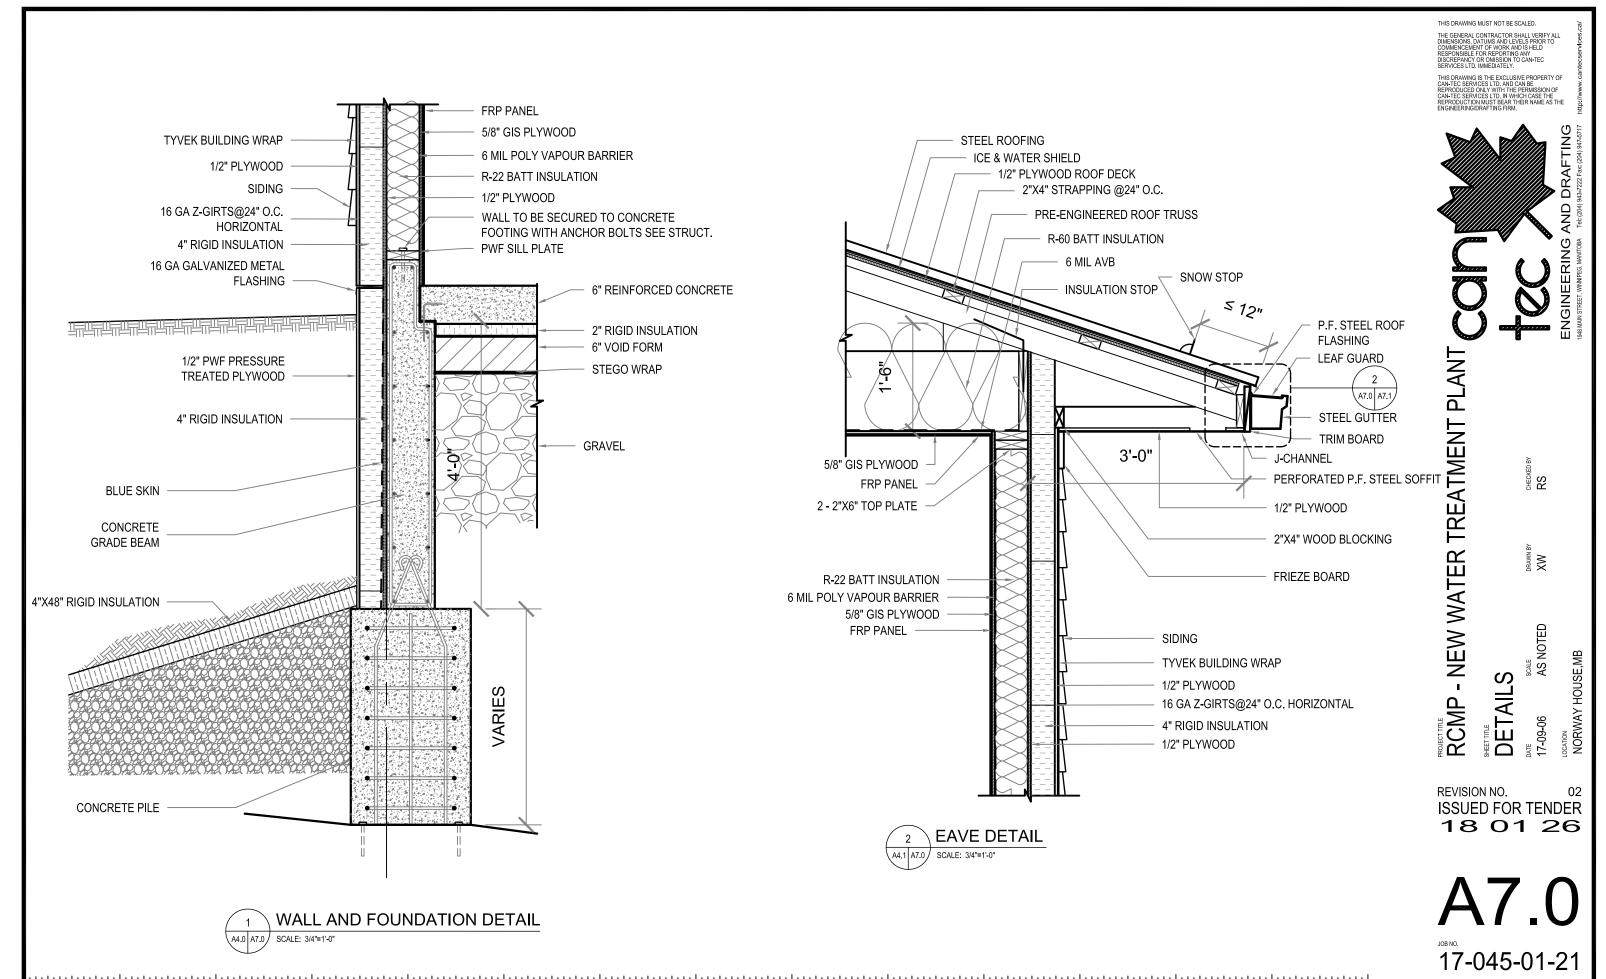


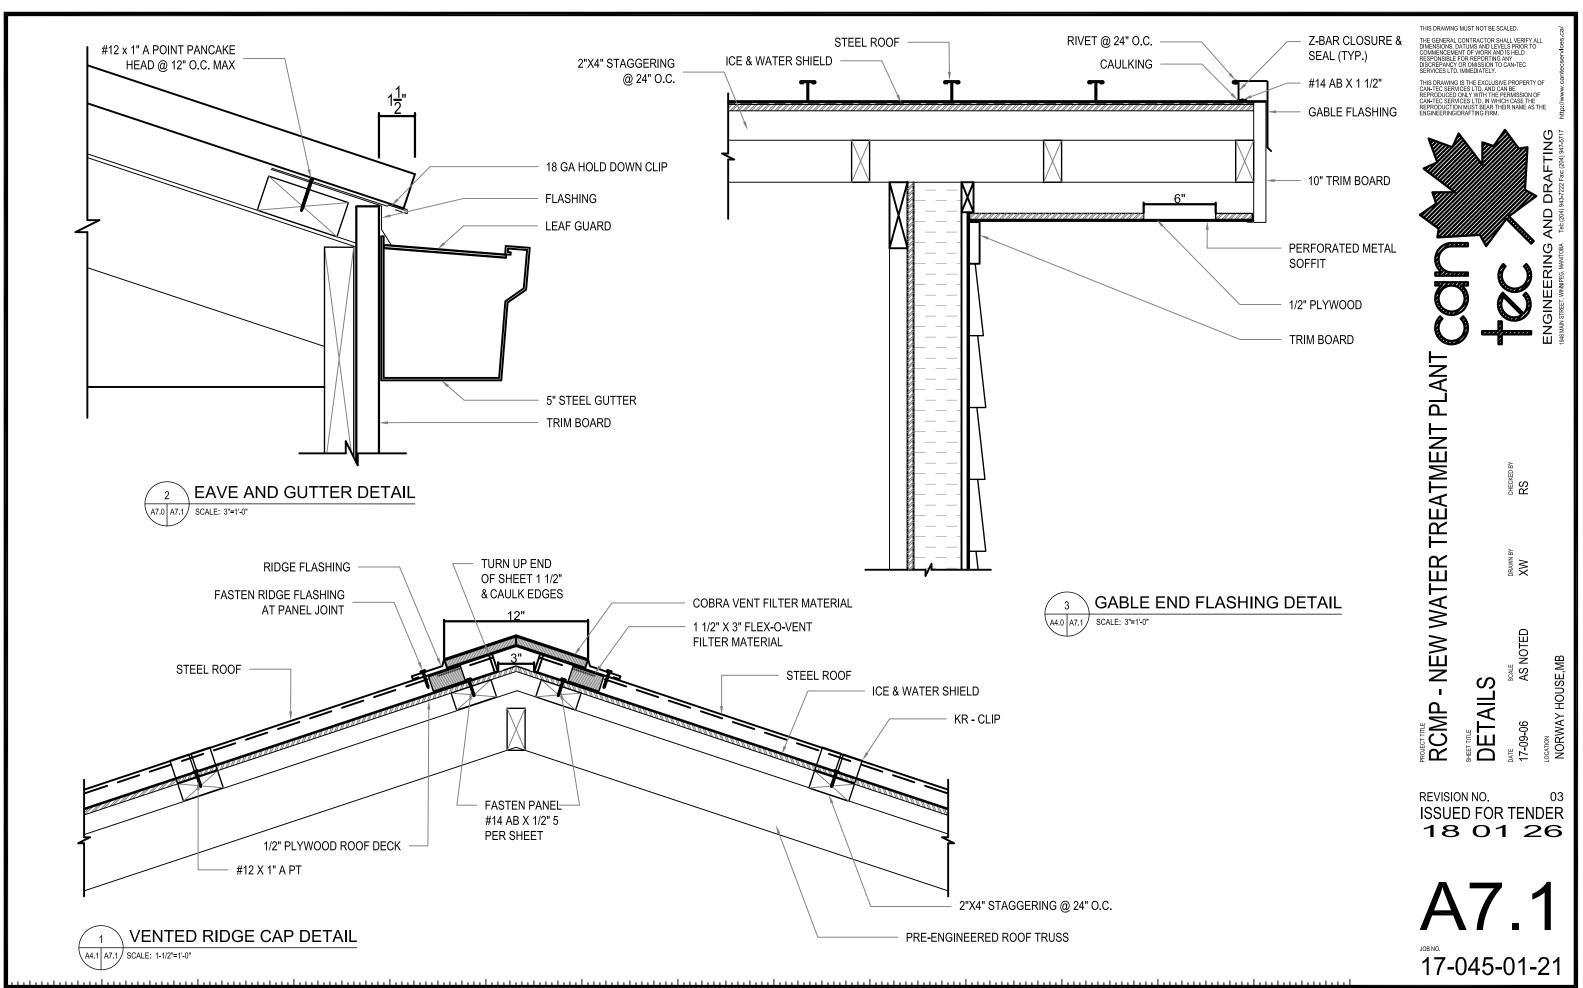


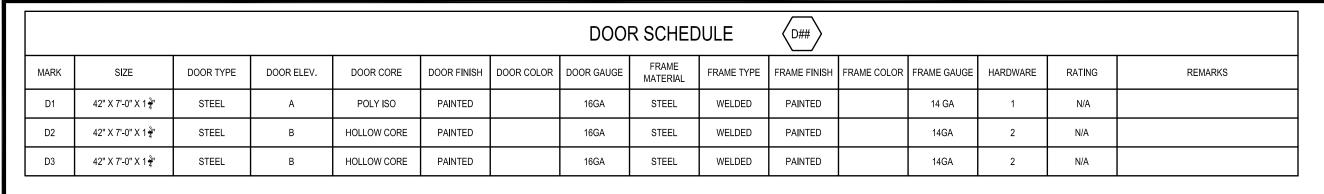













DOOR DETAILS

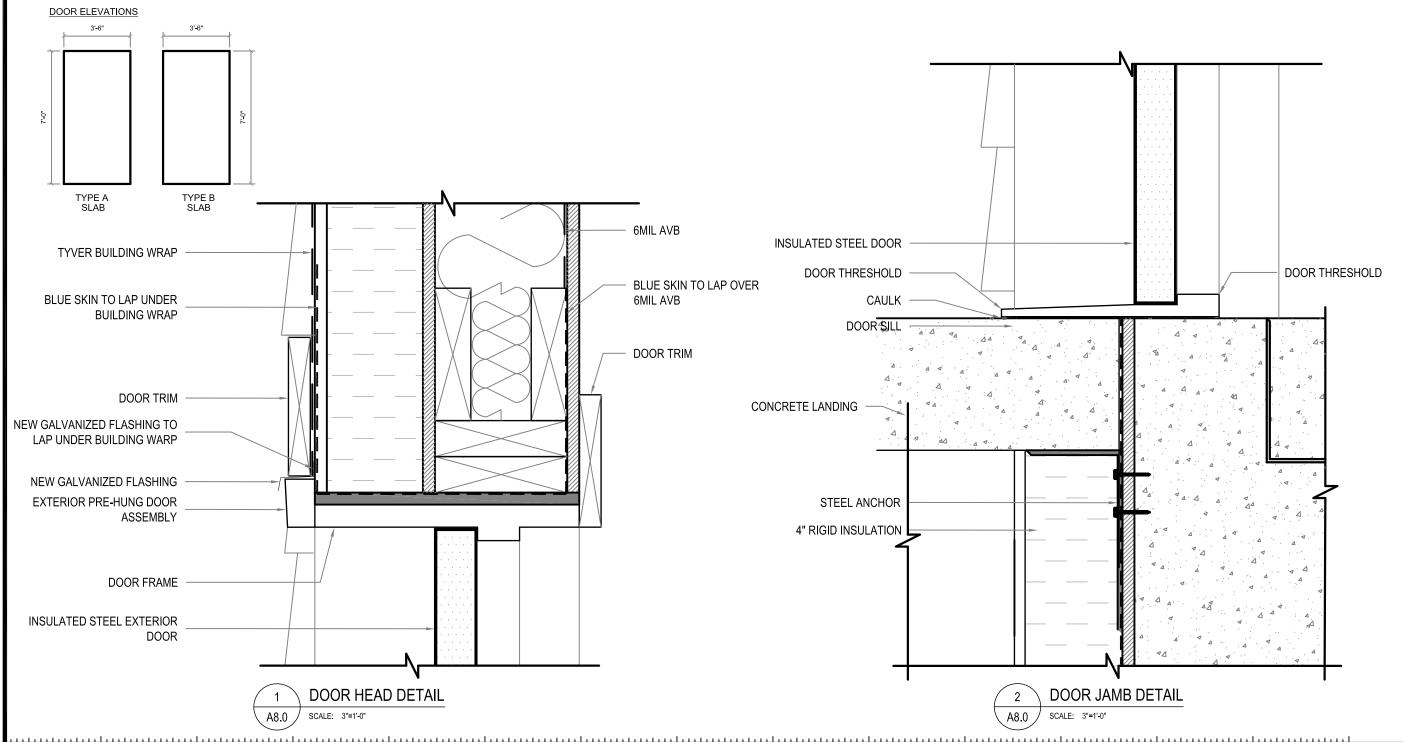

THIS DRAWING MUST NOT BE SCALED



RCMP - NEW WATER TREATMENT PLAN SCHEDULE

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REVISION NO. 03 ISSUED FOR TENDER 18 01 26

SCALE AS NOTED

WALL SCHEDULE



EXTERIOR WALL CONSTRUCTION

PRE-FINISHED SIDING AS PER ELEVATIONS TYVEK BUILDING WRAP 1/2" PLYWOOD 16 GA Z-GURTS @24" O.C HORIZONTAL 4" RIGID INSULATION 1/2" PLYWOOD 2x6 SPRUCE STUDS @ 16" O.C. R-22 BATT INSULATION 6MIL POLY VAPOUR BARRIER 5/8" GIS PLYWOOD FRP PANELS



INTERIOR WALL CONSTRUCTION

FRP PANELS 5/8" PLYWOOD 2x4 SPRUCE STUDS @ 16" O.C. 5/8" PLYWOOD FRP PANELS

ROOF SCHEDULE



ROOF CONSTRUCTION

24 GA STEEL ROOF ICE & WATER SHIELD 1/2" PLYWOOD 2"X4" STRAPPING @24" O.C. R-60 BATT INSULATION 6 MIL AVB 5/8" GIS PLYWOOD

FLOOR SCHEDULE



FLOOR SLAB CONSTRUCTION

6" REINFORCED CONCRETE 2" RIGID INSULATION 6" VOID FORM STEGO WRAP

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SCHEDUL

FINISH

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SHEETITLE WALL

RCMP.

A8.1

GENERAL NOTES:

- DO NOT SCALE DRAWINGS.
- THE DESIGN IS IN ACCORDANCE WITH THE 2011 MANITOBA BUILDING CODE
- CLIMATIC DATA (TABLE C-2) NBCC:

Ss = 2.4 kPa (50 psf) GROUND SNOW LOAD: RAIN LOAD:

Sr = 0.2 kPa (4.0 psf)HOURLY WIND PRESSURE: q (1/50) = 0.49 kPa (10.2 psf) iv) SEISMIC DATA: NOT APPLICABLE

- IMPORTANCE CATEGORY: POST DISASTER
- COORDINATE AND VERIFY ALL DIMENSIONS WITH ARCHITECTURAL DRAWINGS PRIOR TO COMMENCING CONSTRUCTION.
- SEE ARCHITECTURAL DRAWINGS FOR ELEVATIONS, SLOPES, ROUGH OPENING DIMENSIONS FOR WINDOWS, DOORS, ETC.
- SEE MECHANICAL AND ELECTRICAL DRAWINGS FOR OPENINGS IN FLOORS, ROOF, WALLS, ETC.
- DO NOT CUT OR DRILL OPENINGS IN ANY STRUCTURAL MEMBERS WITHOUT WRITTEN APPROVAL FROM BEACH ROCKE ENGINEERING LTD.
- BEACH ROCKE ENGINEERING LTD. SHALL BE NOTIFIED AT LEAST 48 HOURS IN ADVANCE OF REQUIRED SITE INSPECTIONS. (TEL: 1-204-255-7251, FAX: 1-204-257-7239)
- STRUCTURAL DRAWINGS SHOW THE COMPLETED STRUCTURE. THEY DO NOT SHOW COMPONENTS WHICH MAY BE NECESSARY FOR SAFETY DURING CONSTRUCTION. THE CONTRACTOR IS RESPONSIBLE FOR CONSTRUCTION SITE SAFETY AND TO ENSURE THAT ALL SUBTRADES CONFORM TO THE LATEST REGULATIONS OF THE PROVINCIAL "BUILDING PROTECTION ACT", TO PROVIDE ALL NECESSARY SAFETY EQUIPMENT AS REQUIRED THEREIN AND TO NOTIFY LOCAL AUTHORITIES AS REQUIRED BY LAW.
- THE CONTRACTOR SHALL CONFORM TO THE COLD WEATHER REQUIREMENTS OF THE CSA STANDARD A23.1/A23.2 AND THE NATIONAL BUILDING
- IT IS THE GENERAL CONTRACTORS RESPONSIBILITY TO LOCATE ALL SITE SERVICES PRIOR TO CONSTRUCTION.
- THE GENERAL CONTRACTOR SHALL DESIGN ALL SHORING, FORM WORK, AND BRACING TO ENSURE PROPER CONSTRUCTION AND ERECTION.
- THE CONTRACTOR SHALL VISIT THE SITE, AND NOTE ALL CHARACTERISTICS AND IRREGULARITIES AFFECTING THE WORK OF THIS SECTION.
- SHOP DRAWINGS NOT STAMPED, SIGNED, AND DATED BY THE CONTRACTOR WILL BE RETURNED AND SHALL BE CONSIDERED REJECTED, SHOP DRAWINGS FOR WORK DESIGNED BY THE CONTRACTOR SHALL BEAR THE SEAL AND SIGNATURE OF A QUALIFIED PROFESSIONAL ENGINEER IN THE PROJECTS PROVINCE.
- THE CONTRACTOR SHALL SUBMIT AT LEAST 3 COPIES OF STAMPED SHOP DRAWINGS FOR ALL PRE-FABRICATED STRUCTURAL ASSEMBLIES, INCLUDING REINFORCING STEEL TO BEACH ROCKE ENGINEERING LTD. FOR REVIEW AND APPROVAL PRIOR TO FABRICATION. ALL SHOP DRAWINGS, EXCEPT REINFORCING STEEL, SHALL BEAR THE SEAL OF AN ENGINEER REGISTERED IN THE PROJECTS PROVINCE.

CONCRETE NOTES:

- CONCRETE SHALL BE MANUFACTURED AND PLACED IN ACCORDANCE WITH CSA STANDARDS A23,1-09/A23,2-09.
- THE CONTRACTOR SHALL PROVIDE ONE SET OF STANDARD CONCRETE CYLINDER TEST RESULTS CONDUCTED BY AN INDEPENDENT TESTING FIRM FOR EACH DAYS POUR AND AN ADDITIONAL SET OF CYLINDERS FOR EVERY 50 CUBIC METERS POURED AT NO EXTRA COST TO THE OWNER. TEST RESULTS ARE TO BE FORWARDED TO BEACH ROCKE ENGINEERING LTD. IMMEDIATELY UPON RECEIPT FROM THE TESTING FIRM.
- PROVIDE A MINIMUM 150mm (6") VOID UNDER ALL BEAMS, WALLS AND STRUCTURAL SLABS. VOID TO BE SHEARMAT OR APPROVED CARDBOARD VOIDFORM.
- VIBRATE ALL CONCRETE TO ENSURE COMPLETE CONSOLIDATION.
- THE LOCATIONS OF CONSTRUCTION JOINTS IS THE RESPONSIBILITY OF THE CONTRACTOR AND SHALL BE APPROVED BY BEACH ROCKE ENGINEERING LTD.
- WHEN THE OUTSIDE TEMPERATURE FALLS BELOW 5 DEGREES CENTIGRADE, THE CONTRACTOR SHALL CONFORM TO CSA STANDARD A23.1-09/A23.2-09 AND THE NATIONAL BUILDING CODE FOR COLD WEATHER CONCRETING PROCEDURES, AND SHALL RECIEVE WRITTEN APPROVAL FROM BEACH ROCKE ENGINEERING LTD. PRIOR TO COMMENCING CONCRETE CONSTRUCTION.
- PROVIDE 1/8" x 1" SAW CUTS AT 20' O.C. BOTH WAYS IN FLOOR SLABS UNLESS OTHERWISE NOTED ON DRAWINGS.
- CONCRETE SHALL CONFORM TO THE FOLLOWING:

NAME	CONC. TYPE	STRENGTH	MAX. AGG.	AIR	EXPOSURE CLASS
PIERS	TYPE 50	32mPa @ 28 DAYS	20mm	5-8%	S-2
INTERIOR STRUCTURAL SLAB	TYPE 10	25mPa @ 28 DAYS	20mm	NONE	N
EXTERIOR STRUCTURAL SLAB	TYPE 10	25mPa @ 28 DAYS	20mm	5-8%	C-2
CONCRETE WALLS/ GRADE BEAMS	TYPE 10	25mPa @ 28 DAYS	20mm	4-7%	F-2

REINFORCING STEEL NOTES:

- REINFORCING STEEL SHALL BE NEW BILLET DEFORMED BARS MANUFACTURED AND DETAILED IN ACCORDANCE WITH CAN/CSA-G30.18-M92, WITH MINIMUM YEILD STRENGTH AS FOLLOWS: 10M BARS-300MPA, 15M BARS & LARGER - 400MPA.
- REINFORCING STEEL SHALL BE FREE FROM LOOSE RUST, MUD, OIL OR OTHER COATINGS WHICH MAY REDUCE THE BOND OR HARM THE CONCRETE
- REINFORCING STEEL SHALL BE HELD IN PLACE AND TIED WITH PROPER ACCESSORIES SUCH AS HI-CHAIRS, SPACERS. TIES, ETC. SUPPLIED BY THE REINFORCING STEEL PROVIDER. APPROPRIATE SUPPORT SHALL BE PROVIDED UNDER ALL SUPPORT ACCESSORIES TO ENSURE THAT THE REINFORCING STEEL IS ACCURATELY POSITIONED.

75mm(3")

50mm (2")

- LAP TOP BARS AT MID-SPAN AND BOTTOM BARS OVER SUPPORTS.
- BEND ALL HORIZONTAL STEEL 18" AROUND CORNERS, OR USE EXTRA 36"X36" CORNER BARS TO MATCH HORIZONTALS.
- PROVIDE 2-15M AROUND ALL SLAB, WALL, & BEAM OPENINGS, UNLESS OTHERWISE NOTED ON STRUCTURAL DRAWINGS.
- CONCRETE COVER TO REINFORCING STEEL SHALL BE AS FOLLOWS:
- CONCRETE CAST IN DIRECT CONTACT WITH SOIL
- FORMED CONCRETE IN CONTACT WITH SOIL 15M OR SMALLER
- FORMED CONCRETE IN CONTACT WITH SOIL 20M OR LARGER 7.3 40mm (1 1/2")
- 7.4. FORMED CONCRETE NOT IN CONTACT WITH SOIL (BEAMS AND COLUMNS) 50mm (2")
- FORMED CONCRETE NOT IN CONTACT WITH SOIL (SLABS AND WALLS) 20mm (3/4") @ 1 1/2HR FRR
- 25mm (1") @ 2HR FRR MISCELLANEOUS CONCRETE HOUSEKEEPING PADS AND CURBS SHALL BE REINFORCED WITH A MINIMUM 10M AT 18" O.C. EACH WAY UNLESS NOTED. SEE
- ARCHITECTURAL, MECHANICAL, AND ELECTRICAL DRAWINGS.

STRUCTURAL DRAWING LIST:

- S1.1 PROJECT NOTES
- TYP PROJECT DETAILS S1 2
- S2.1 FOUNDATION/MAIN FLOOR PLAN S2.2 ROOF FRAMING PLAN
- S5.1 SECTIONS

WOOD NOTES:

- ALL LUMBER COMPONENTS SHALL BE DESIGNED AND FABRICATED IN ACCORDANCE WITH THE CAN/CSA-086-09
- ALL LUMBER SHALL CONFORM TO "NLGA STANDARD GRADING RULES FOR CANADIAN LUMBER", AND THE GRADE SHALL BE CLEARLY IDENTIFIED ON ALL PRODUCTS.
- ALL DIMENSIONAL LUMBER SHALL BE NO.2 GRADE, OR BETTER, UNLESS NOTED OTHERWISE ON DRAWINGS.
- FRAMED WALLS AND ROOF SYSTEMS SHALL BE ADEQUATELY BRACED UNTIL CONSTRUCTION IS COMPLETED. THE CONTRACTOR SHALL SUPPLY AND ERECT ALL BRACING NECESSARY TO PROVIDE STABILITY FOR THE STRUCTURE AS A WHOLE, INCLUDING DURING THE CONSTRUCTION PHASE.
- LOAD BEARING STUD WALLS SHALL HAVE SOLID BLOCKING AT 4'-0" CENTERS.
- SHEATHING AND STRUCTURAL ACCESSORIES SHALL BE INSTALLED ACCORDING TO THE MANUFACTURER'S SPECIFICATIONS AND RECOMMENDATIONS. SHEATHING SHALL BE CANPLY EXTERIOR GRADE PLYWOOD UNLESS OTHERWISE NOTED ON THE DRAWINGS OR APPROVED BY BEACH ROCKE ENGINEERING LTD.
- LUMBER IN CONTACT WITH SOIL SHALL BE PRESERVATIVE-TREATED IN ACCORDANCE WITH THE CAN/CSA-080 SERIES-08. THE CUT ENDS AND DRILLED HOLES OF TREATED LUMBER SHALL BE TREATED WITH 3 COATS OF PRESERVATIVES.
- FASTENERS USED FOR FRAMING SHALL BE: HOT-DIPPED AND GALVANIZED FOR LUMBER ABOVE GRADE, AND, STAINLESS STEEL (TYPES 304 AND 316) FOR PRESERVATIVE-TREATED LUMBER CONFIRMING TO CSA B111-1974.
- JOINTS AND HOLES BELOW GRADE SHALL BE SEALED WITH BUTLY CAULKING COMPOUND OR EQUAL CONFORMING TO CGSB 19-GP-13 OR CGSB 19-GP-14. INSTALLED TO PROVIDE A WATER-TIGHT SEAL
- PROVIDE 3 SETS OF STAMPED AND SEALED SHOP DRAWINGS FOR ALL ROOF TRUSSES SUPPLIED BY THE TRUSS MANUFACTURER. SUBMIT SHOP DRAWINGS TO BEACH ROCKE ENGINEERING FOR APPROVAL.
- PROVIDE 3 SETS OF STAMPED AND SEALED SHOP DRAWINGS FOR ALL FLOOR JOISTS SUPPLIED BY THE JOIST MANUFACTURER. SUBMIT SHOP DRAWINGS TO BEACH ROCKE ENGINEERING FOR APPROVAL.
- ALL STRUCTURAL ENGINEERED WOOD (TIMBERSTRAND.MICROLLAM.PARALLAM.GLUE-LAMINTATED.ETC) PRODUCTS SHALL BE SUPPLIED BY MANUFACTURERS APPROVED BY BEACH ROCKE ENGINEERING LTD. PRODUCTS SHALL BE DESIGNED, FABRICATED AND ERECTED IN ACCORDANCE WITH THE CAN/CSA-086-09 TO SATISFY LOADING CONDITIONS NOTED ON THE DRAWINGS AND LOCAL BUILDING CODE REQUIREMENTS. THE MANUFACTURER SHALL PROVIDE 3 SETS OF SHOP DRAWINGS TO BEACH ROCKE ENGINEERING LTD. SEALED BY AND ENGINEER, REGISTERED IN THE PROVINCE OF MANITOBA, FOR ALL COMPONENTS PRIOR TO **FARRICATION**
- 10. FASTEN EXTERIOR SHEATHING AT 3" O.C. AT EDGES, AND 12" O.C. AT INTERMEDIATE MEMBERS.
- 11. ALL 4PLY FLUSH BEAMS AND 4PLY LVL BEAMS TO BE THRU BOLTED WITH 1/2"Ø BOLTS @ 16" O.C. STAGGERED TOP AND BOTTOM.

POST INSTALLED ANCHOR NOTES:

- EXCEPT WHERE INDICATED ON THE DRAWINGS, POST-INSTALLED ANCHORS SHALL CONSIST OF THE FOLLOWING ANCHOR TYPES;
- a) ANCHORAGE TO CONCRETE
- ADHESIVE ANCHORS FOR CRACKED AND UNCRACKED CONCRETE USE:
- (1) HILTI HIT-HY 200 SAFE SET SYSTEM WITH THE HILTI HIT-Z ROD

 ii) MEDIUM DUTY MECHANICAL ANCHORS FOR CRACKED AND UNCRACKED CONCRETE USE: HILTI KWIK BOLT 3 EXPANSION ANCHORS (UNCRACKED CONCRETE ONLY)
- iii) HEAVY DUTY MECHANICAL ANCHORS FOR CRACKED AND UNCRACKED CONCRETE USE:
- HILTI HSL-3 EXPANSION ANCHORS
- RÉBAR DOWELING INTO CONCRETE
- i) ADHESIVE ANCHORS FOR CRACKED AND UNCRACKED CONCRETE USE:
- HILTI HIT-HY 200 SAFE SET SYSTEM WITH HILTI HOLLOW DRILL BIT WITH CONTINUOUSLY DEFORMED REBAR HILTI HIT-HY 500v3 SAFE SET SYSTEM WITH HILTI HOLLOW DRILL BIT WITH CONTINUOUSLY DEFORMED REBAR
- c) ANCHORAGE TO SOLID GROUTED MASONRY
- ADHESIVE ANCHORS USE:
- HILTI HIT-HY 70 MASONRY ADHESIVE ANCHORING SYSTEM.
- STEEL ANCHOR ELEMENT SHALL BE HILTI HAS-E CONTINUOUSLY THREADED ROD OR CONTINUOUSLY DEFORMED STEEL REBAR
- ii) MECHANICAL ANCHORS USE:
- (1) HILTI KWIK BOLT-3 EXPANSION ANCHORS d) ANCHORAGE TO HOLLOW / MULTI-WYTHE MASONRY
- ADHESIVE ANCHORS USE
- HILTI HIT-HY 70 MASONRY ADHESIVE ANCHORING SYSTEM.
- STEEL ANCHOR ELEMENT SHALL BE HILTI HAS-E CONTINUOUSLY THREADED ROD OR CONTINUOUSLY DEFORMED STEEL REBAR
- THE APPROPRIATE SIZE SCREEN TUBE SHALL BE USED PER ADHESIVE MANUFACTURER'S RECOMMENDATION
- ANCHOR CAPACITY USED IN DESIGN SHALL BE BASED ON THE TECHNICAL DATA PUBLISHED BY HILTI OR SUCH OTHER METHOD AS APPROVED BY THE STRUCTURAL ENGINEER OF RECORD. SUBSTITUTION REQUESTS FOR ALTERNATE PRODUCTS MUST BE APPROVED IN WRITING BY THE STRUCTURAL ENGINEER OF RECORD PRIOR TO USE. CONTRACTOR SHALL PROVIDE CALCULATIONS DEMONSTRATING THAT THE SUBSTITUTED PRODUCT IS CAPABLE OF ACHIEVING THE PERFORMANCE VALUES OF THE SPECIFIED PRODUCT. SUBSTITUTIONS WILL BE EVALUATED BY THEIR HAVING AN ICC ESR SHOWING COMPLIANCE WITH THE RELEVANT BUILDING CODE FOR SEISMIC USES, LOAD RESISTANCE, INSTALLATION CATEGORY, AND AVAILABILITY OF COMPREHENSIVE INSTALLATION INSTRUCTIONS, ADHESIVE ANCHOR EVALUATION WILL ALSO CONSIDER CREEP, IN-SERVICE TEMPERATURE AND INSTALLATION TEMPERATURE
- INSTALL ANCHORS PER THE MANUFACTURER INSTRUCTIONS, AS INCLUDED IN THE ANCHOR PACKAGING.
- THE CONTRACTOR SHALL ARRANGE AN ANCHOR MANUFACTURER'S REPRESENTATIVE TO PROVIDE ONSITE INSTALLATION TRAINING FOR ALL OF THEIR ANCHORING PRODUCTS SPECIFIED. THE STRUCTURAL ENGINEER OF RECORD MUST RECEIVE DOCUMENTED CONFIRMATION THAT ALL OF THE CONTRACTOR'S PERSONNEL WHO INSTALL ANCHORS ARE TRAINED PRIOR TO THE

CONCRETE PIER NOTES:

- CONCRETE PIERS SHALL BEAR ON BEDROCK WITH AN ALLOWABLE BEARING CAPACITY OF 5000kPa.
- THE CONTRACTOR SHALL LOCATE ALL SITE SERVICES PRIOR TO EXCAVATION.
- BEARING SURFACE SHALL BE INSPECTED BY A QUALIFIED GEOTECHNICAL ENGINEER TO VERIFY THE ALLOWABLE BEARING CAPACITY AND TO ENSURE ALL LOOSE AND DISTURBED MATERIAL HAS BEEN REMOVED FROM TOP OF BEDROCK.
- POUR JOINTS IN THE FOUNDATION SHALL BE APPROVED BY THE ENGINEER.

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PLANT Beach Rocke

TREATMENT

NEW WATER

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CMP

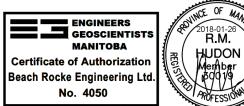
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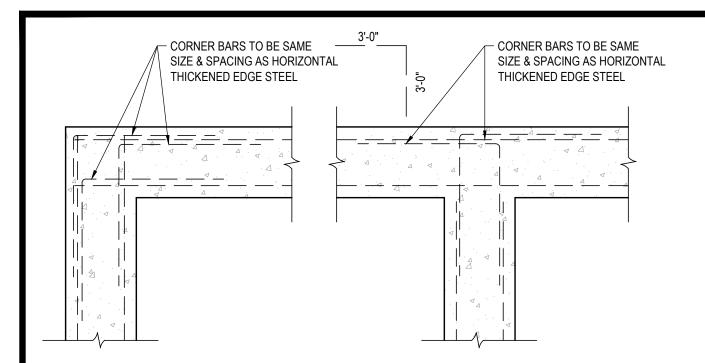
LOCATION NORWAY

REVISION NO. 01 ISSUED FOR TENDER

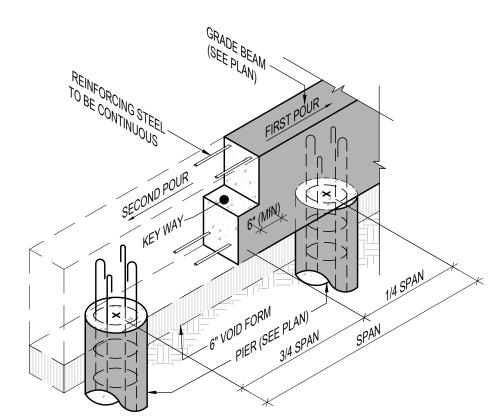
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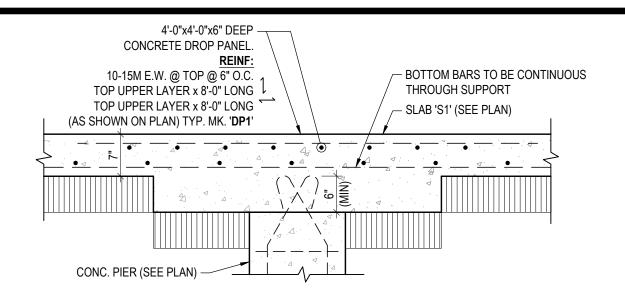
TYP. CORNER BAR DETAIL SCALE: 3/4"=1'-0"




TYP. GRADE BEAM WALL JOINT

SCALE: 1/2"=1'-0"

S1.2



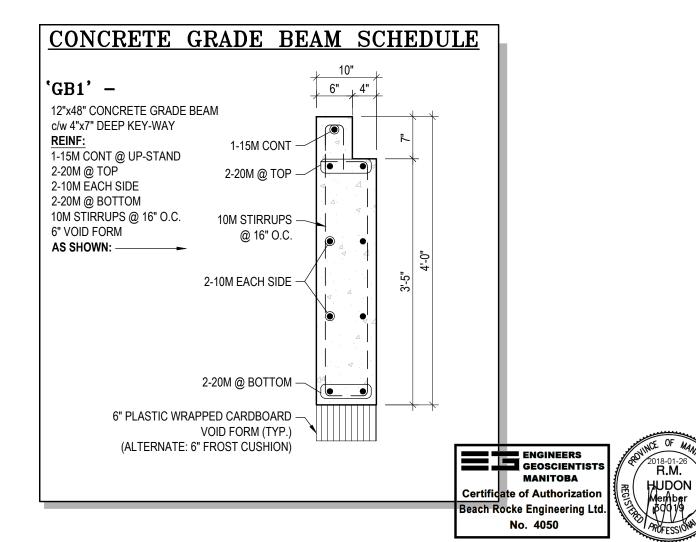TYP. DROP PANEL 'DP1' DETAIL S1.2 SCALE: 3/4"=1'-0"



RCMP - NEW WATER TREATMENT PLAN Beach Rocke SCHEDULES ∞ర **ETAILS** SCALE AS NOTED Ϋ́Р DATE 18-01-26

AND DRAFTING

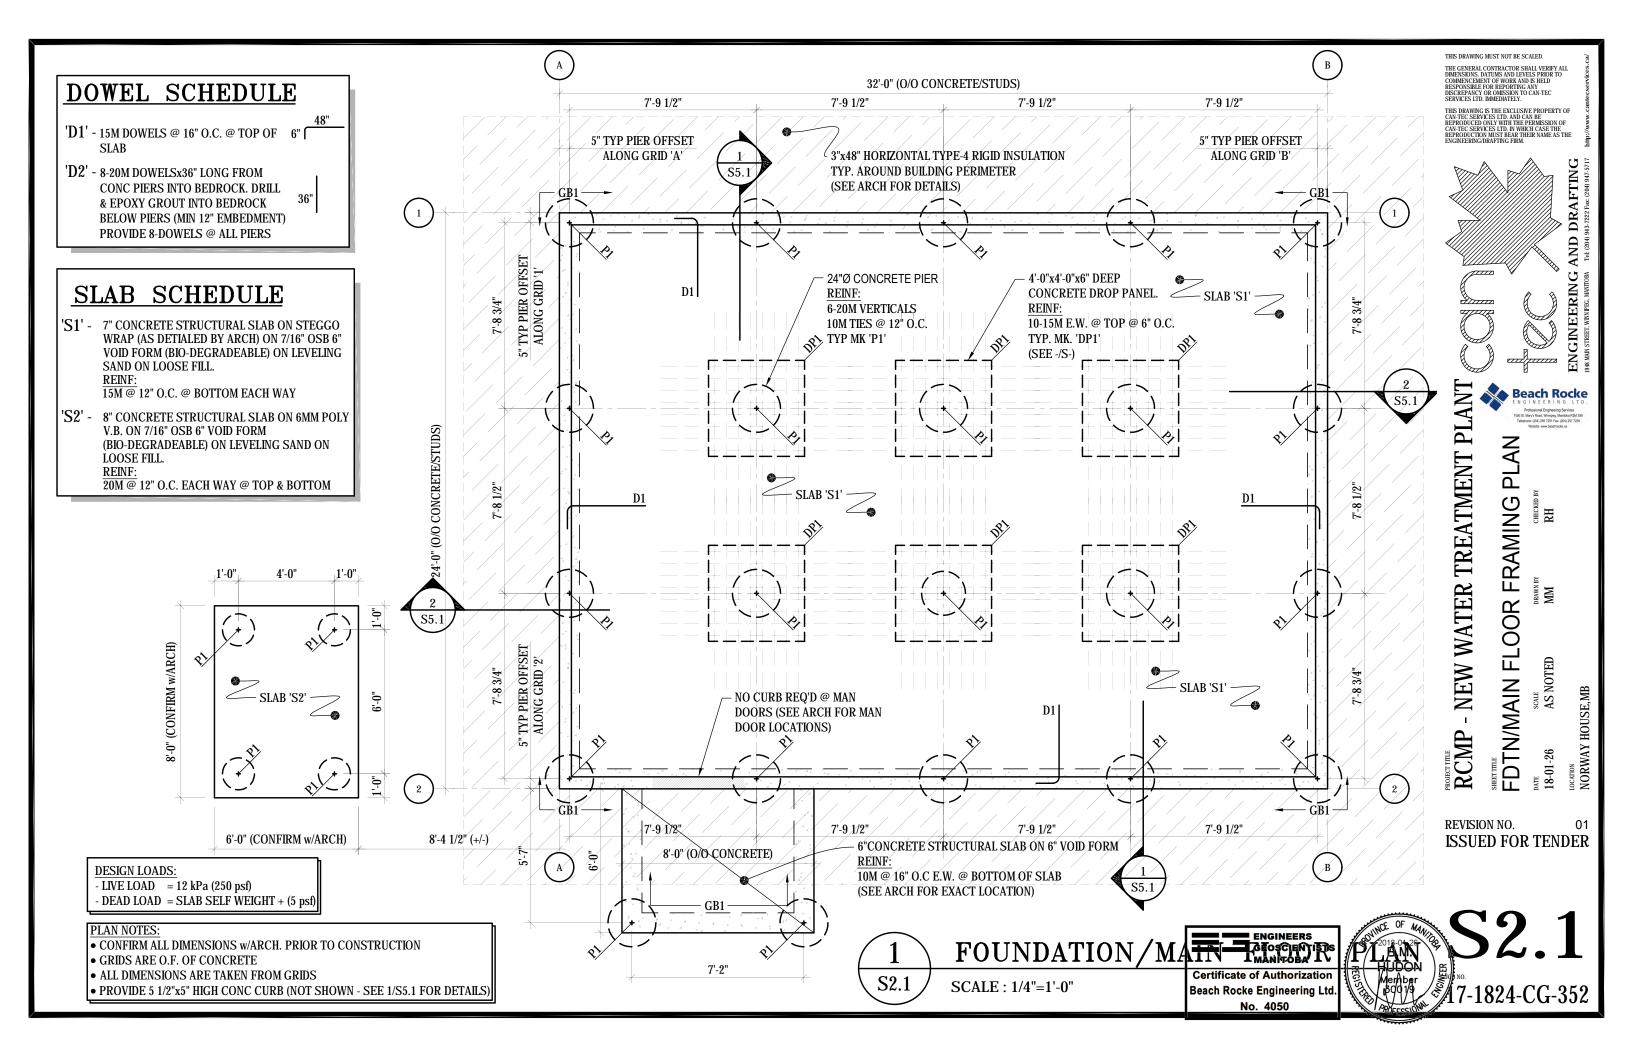
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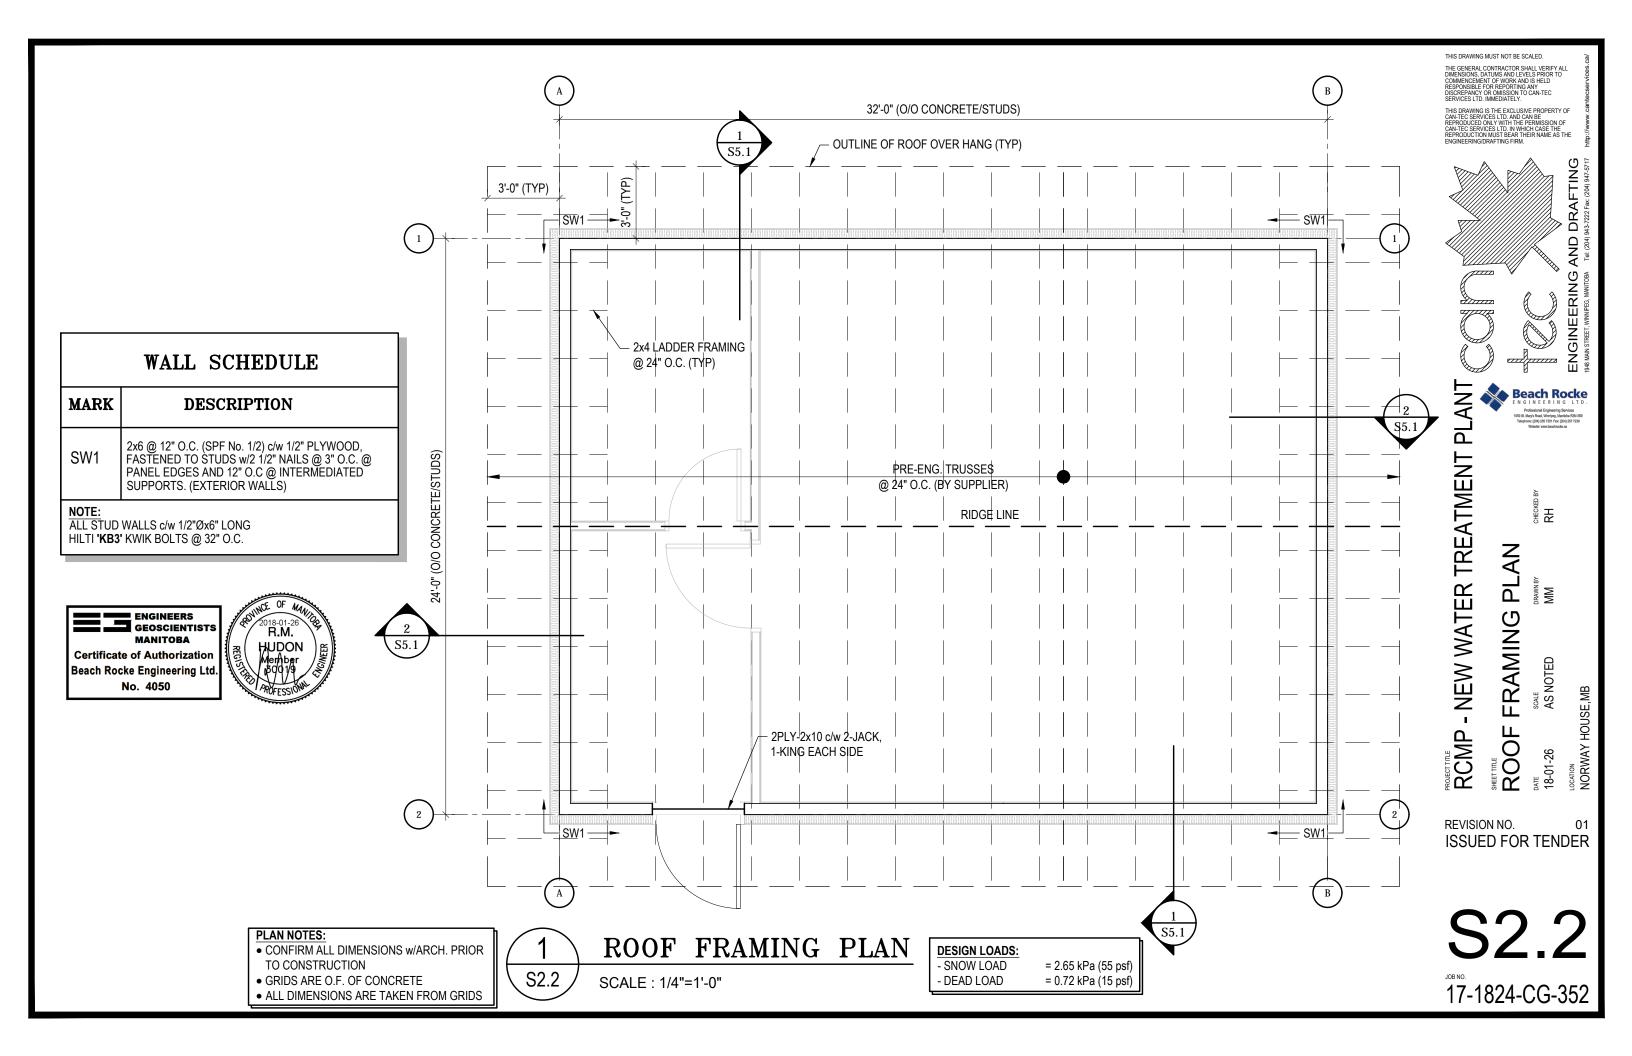
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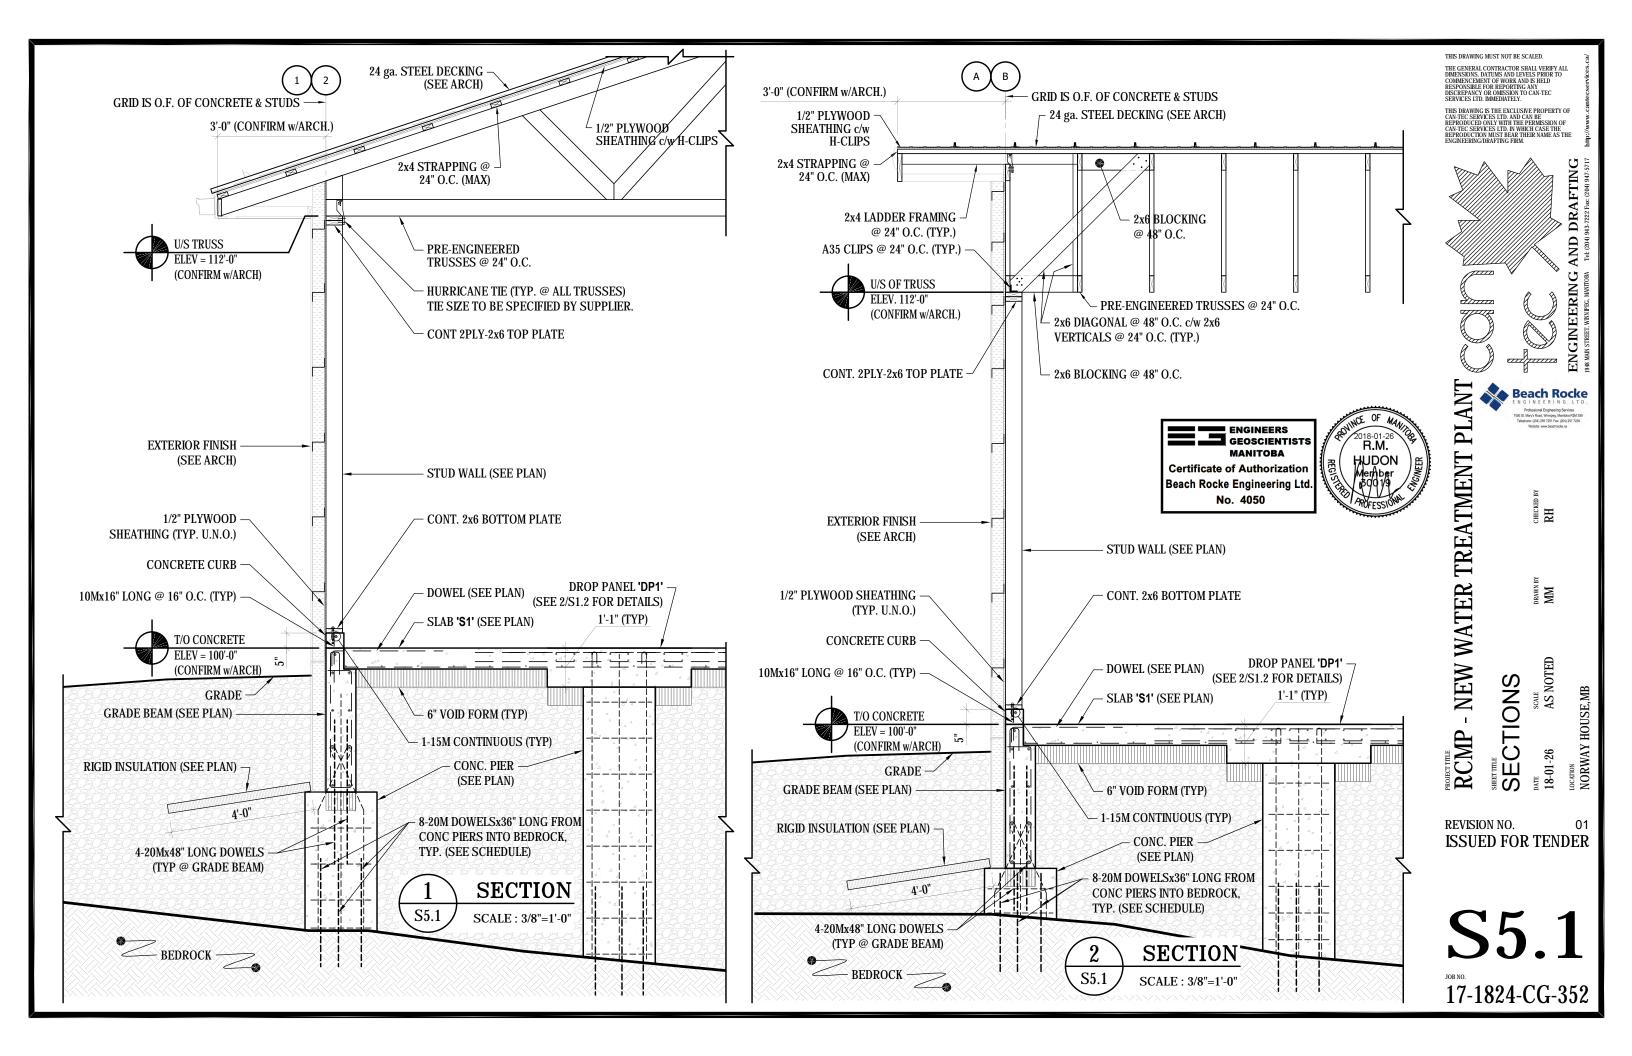
COCATION NORWAY HOUSE, MB


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018-01-26 **R.M.**








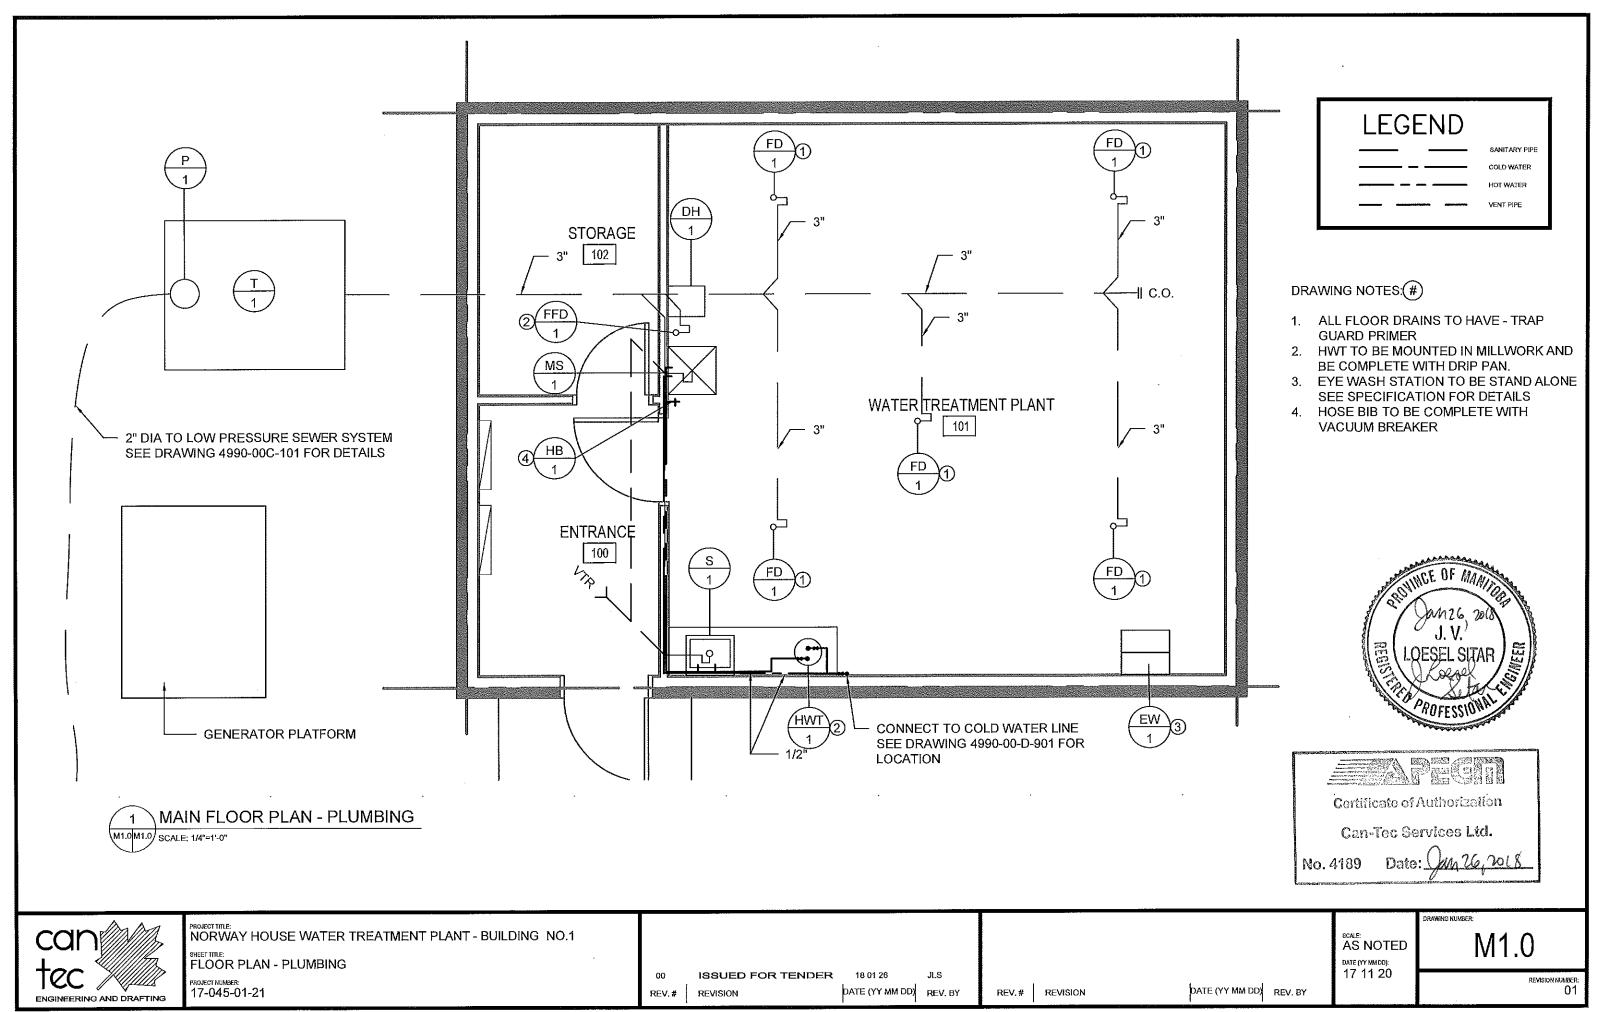

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PLUMB	PLUMBING FIXTURE CONNECTION SIZES					
SYMBOL	NAME	WATER HOT	WATER COLD	WASTE	VENT	NOTES
MS-1	MOP SINK	1/2"Ø	1/2"Ø	2"Ø	1 1/2"Ø	
HWT-1	HOT WATER TANK	1/2" Ø	1/2"Ø			
FD-1	FLOOR DRAIN			3"Ø		ALL FLOOR DRAINS TO HAVE TRAP GUARD PRIME!
FFD-1	FUNNEL FLOOR DRAIN			3"Ø		ALL FLOOR DRAINS TO HAVE TRAP GUARD PRIMER
S-1	SINK	1/2"Ø	1/2"Ø	1 1/2"Ø	1 1/2"Ø	
HB-1	HOSE BIB		1/2"Ø			C/W VACUUM BREAKER
E W -1	EYE WASH - STAND ALONE					STAND ALONE UNIT
DH-1	DEHUMIDIFIER					STAND ALONE UNIT

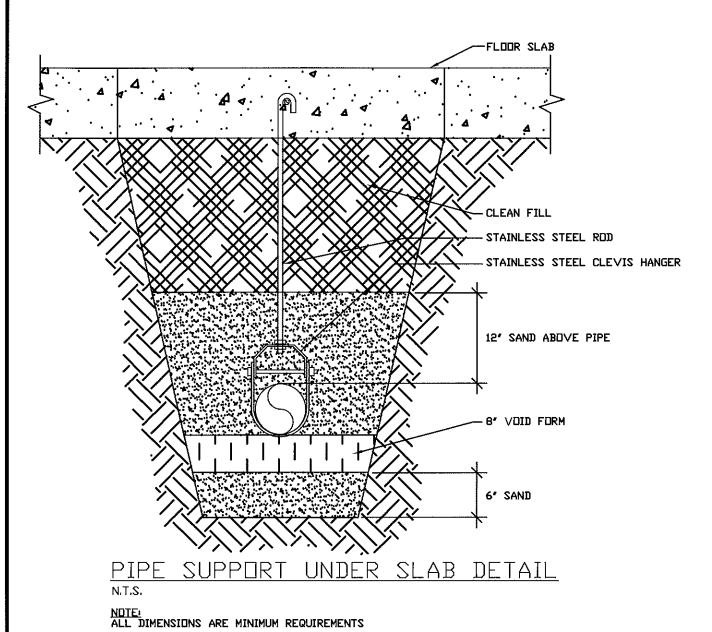Cordificate of Authorization

Can-Tec Services Ltd.

No. 4109 Date: __m 26, 2018





PROJECT TITLE:
NORWAY HOUSE WATER TREATMENT PLANT - BUILDING NO. 1

SHEET TITLE: DETAILS

PROJECT NUMBER: 17-045-01-21

ISSUED FOR TENDER 18 01 26
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DATE (YY MM DD) REV. BY

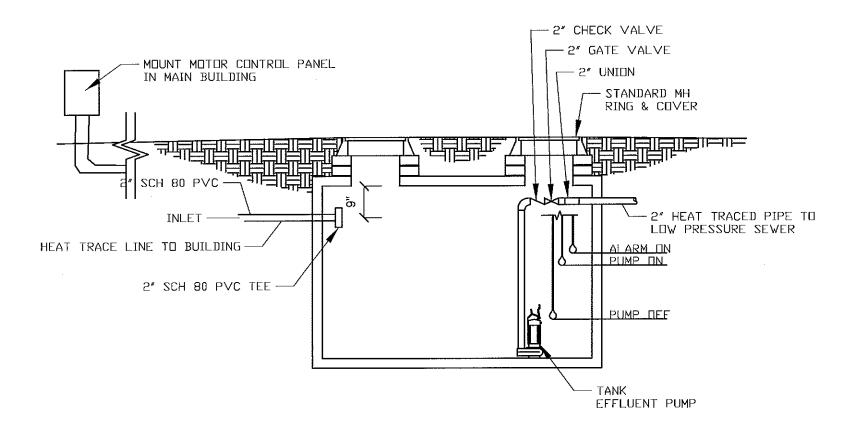
REV.# REVISION

DATE (YY MM DD) REV. BY

SCALE
AS NOTED
DATE (TY MAIDD):

M1.1

REVISION NUMBER: 01





ALARM TO BE LOCATED IN ELECTRICAL ROOM NEAR ENTERANCE FINAL LOCATION TO BE SITE DETERMINED







PROJECT TITLE: NORWAY HOUSE WATER TREATMENT PLANT - BUILDING NO. 1

SHEET TITLE: DETAILS

PROJECT NUMBER: 17-045-01-21

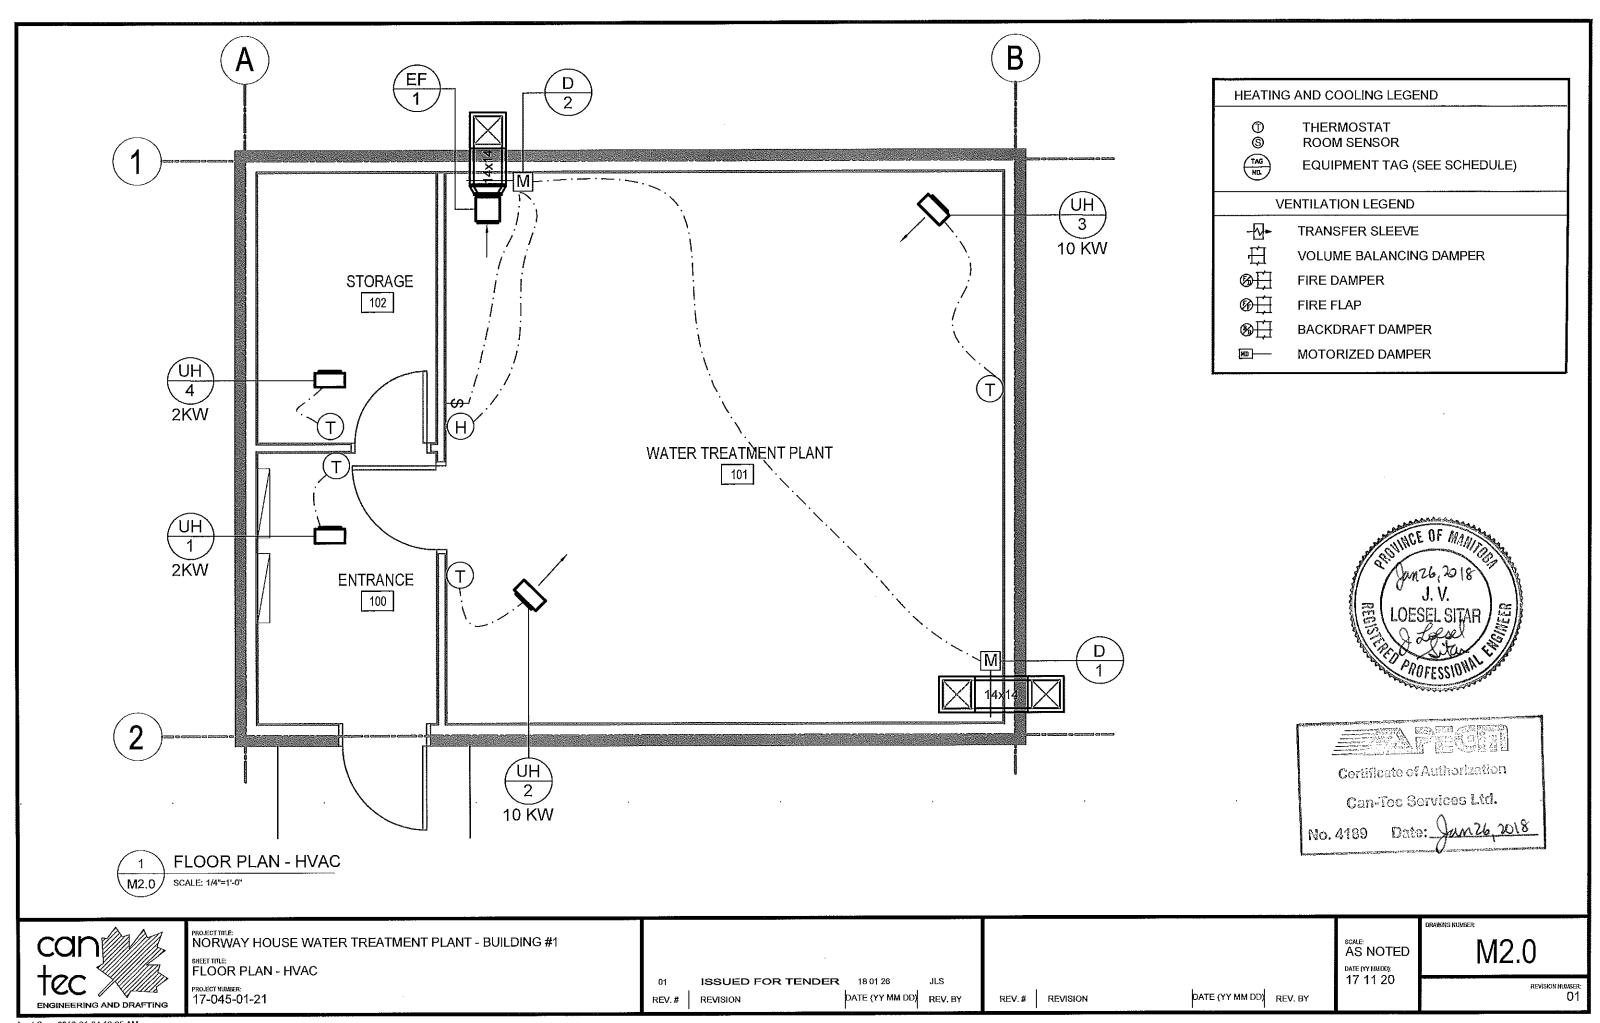
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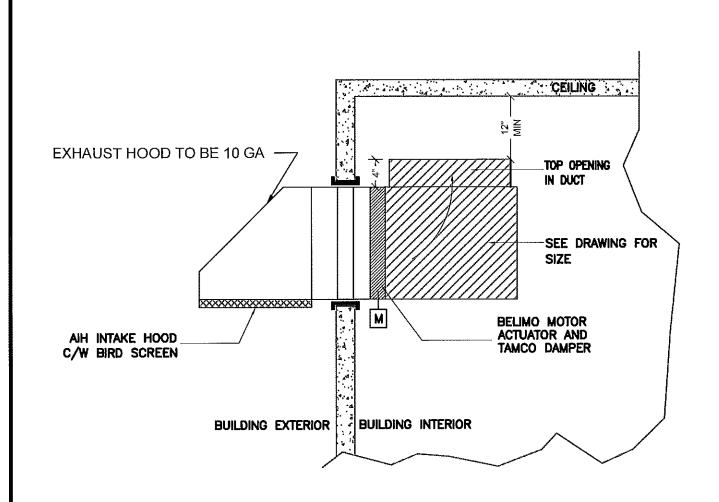
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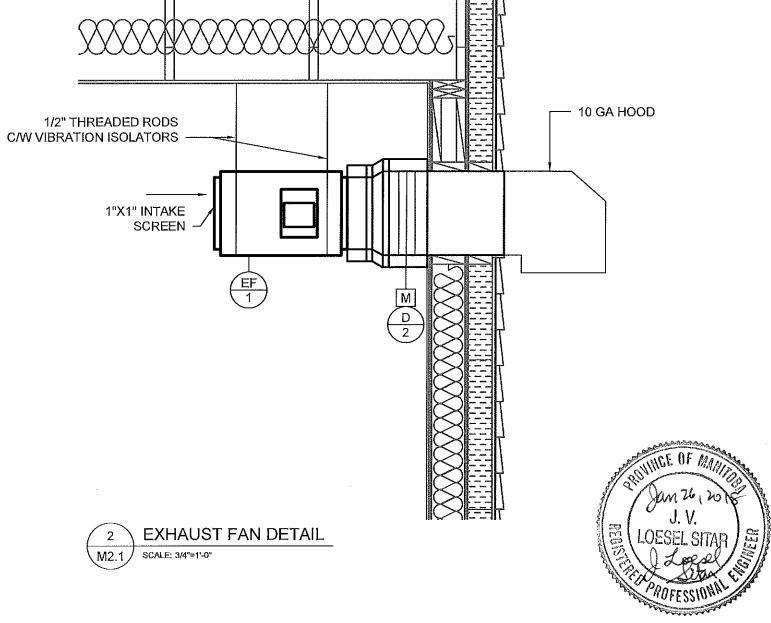
REV.# REVISION

AS NOTED DATE (YY MIM DO): 17 11 20 DATE (YY MM DD) REV. BY

M1.2







AIR INTAKE DETAIL M2.1 SCALE: NTS

> Certificate of Authorization Can-Tec Services Ltd.



PROJECT TITLE
NORWAY HOUSE WATER TREATMENT PLANT - BUILDING NO.1

SHEET TITLE: DETAILS

PROJECT NUMBER: 17-045-01-21

ISSUED FOR TENDER 18 01 26 REV.# REVISION

DATE (YY MM DD) REV. BY

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REV.# REVISION

DATE (YY MM DD) REV. BY

SCALE: AS NOTED DATE (YY MM DD): 17 11 20

M2.1

REVISION NUMBER:

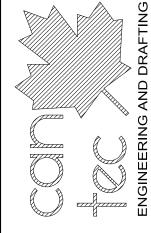
ROYAL CANADIAN MOUNTED POLICE

NORWAY HOUSE PUMP HOUSE - BUILDING NO.2

HOUSE **ABBREVIATION LIST** DRAWING LIST **CONSULTANT LIST** DRAWING SYMBOLS **DRAWING LIST** AY-IN ACQUISTIC TIL ROUGH OPENING DJUSTABLE EACH WAY FT HAND **(**/#**)** WINDOW NUMBER RESILIENT SHEET FLOORIN SHEET SECTION LOCATED GGREGATE EFT HAND REVERSE PUMP IR VAPOUR BARRIE DEMOLITION PLAN
DEMOLITION ELEVATION **₩** WALL / ROOF INDENTIFIER ELEVATION IDENTIFIER LTERNATE FLOOR PLAN LUMINUM ELEVATOR ECTION DOOR NUMBER MANUFACTURE SELF ADHESIV ARTMENT A3 0 FLEVATIONS ELEVATIONS SECTION a-a A3.1 A4.0 RCHITECTURE MASONRY OPENING QUIPMENT MATERIAL SHEET VINYL SECTION b-b DETAILS BENCH MARK EXISTING MECHANICAL SIMILAR RCMP A7.1 DETAILS DOOR DETAIL & SCHEDULE WALL & FINISH SCHEDULE TERIOR MISCELLANEOU BOARD XTRUDE FXTR NEAR FACE SPECIFICATION (*) OTH SIDES ACE TO FACE NEAR SIDE AR SIDE PRUCE, PINE OR F RCMP - EXISTING FOUNDATION & ROOF NOT APPLICABLE Beach Rocke BUILDING NOT IN CONTRACT STAINLESS STE NOT TO SCALE MAIN FLOOR PLAN - HVAC DETAIL MARKER CAST IRON LOOR DRAIN LOORING ON CENTRE EMENT BOARD LUORESCEN' UT TO OUT QUARE FEET MECHANICAL CONSULTANT OOTING OUTSIDE DIAMETER ENTRE TO CENTRE UNDATION DUTSIDE FACE AL VANIZED GALV TONGLE AND GROOVE DETAIL INDENTIFICATION DETAIL NUMBER

CURRENT SHEET PAINTED CLEAR GALVANIZED IRON TOP AND BOTTOM OMPLETE WITH LYWOOD CONCRETE PRECAST LINDER SIDE CONCRETE BLOCK CBLK PRECAST CONCRETE INDERCUT REFABRICATION ONSTRUCTION CONTINUOUS CONTROL JOINT HOLLOW METAL PRESSED STEEL ERTICAL OUNTERSINK HORIZONTAL HORIZ UANTITY VINYL ASBESTOS TILE **Engineering Consultants** QUARRY TILE VINYL COVE BASE OVED SHEET VINYL NCLUSIVE INCL NSIDE DIAMETE 6-1375 Niakwa Road E Telephone: (204) 255-4842 DEMOLISH NSIDE FACE RAINWATER LEADER INYL WALL COVERING Facsimile: (204) 255-7679 Winnipeg, Manitoba INSUL IAGONAL INSULATE REFERENCE WATER CLOSET E-mail: info@joreyelectric.com

THIS DRAWING MUST NOT BE SCALED




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PAGE

SHEET TILE COVER

REVISION NO. **ISSUED FOR TENDER** 18 01 26



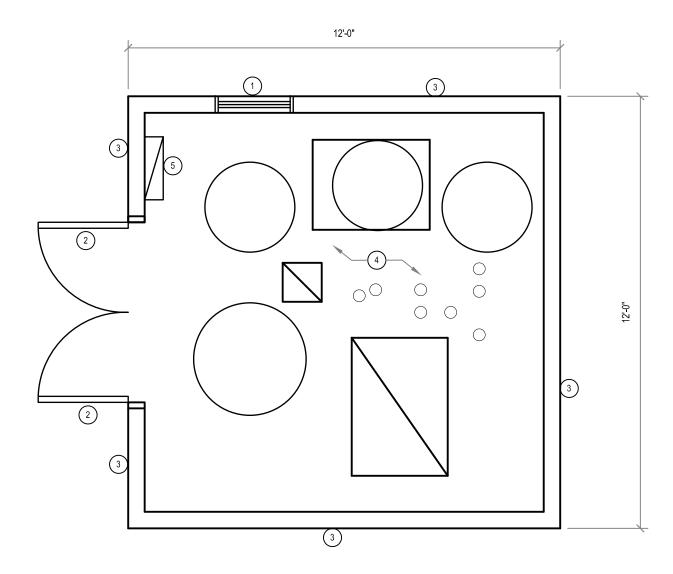DEMOLITION PLAN SCALE: 3/8"=1'-0'

DRAWING NOTES: (#)

- REMOVE EXISTING WINDOW.
 REMOVE EXISTING DOOR.

- CONDUITS.

GENERAL NOTES:

1. REMOVE ALL EXISTING EQUIPMENT ONCE THE NEW WATER TREATMENT PLANT IS COMPLETED, REFER TO NEW WATER TREATMENT PLANT DRAWINGS FOR DETAIL.

THIS DRAWING MUST NOT BE SCALED.

THE GENERAL CONTRACTOR SHALL VERIFY ALL DIMENSIONS, DATUMS AND LEVELS PRIOR TO COMMENCEMENT OF WORK AND IS HELD RESPONSIBLE FOR REPORTING ANY DISCREPANCY OR OMISSION TO CAN-TEC SERVICES LTD. IMMEDIATELY.

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RS S

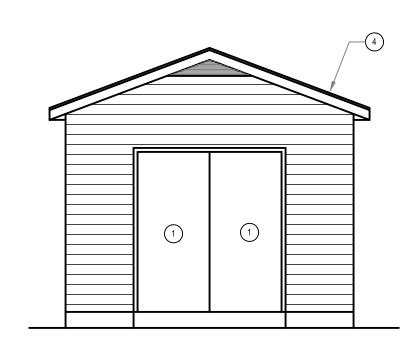
RCMP - PUMP HOUSE DRAWN XW DEMOLITION PLAN

REVISION NO. ISSUED FOR TENDER 18 01 26

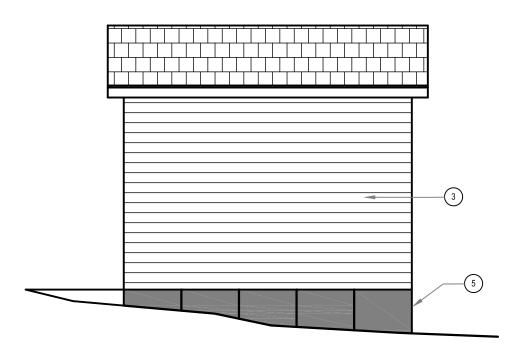
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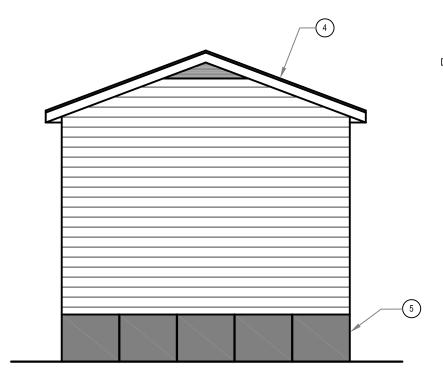
3. REMOVE ALL EXISTING WALLS. 4. REMOVE EXISTING CEILING. 5. REMOVE ELECTRICAL PANEL AND KEEP ELECTRIC








RIGHT SIDE ELEVATION





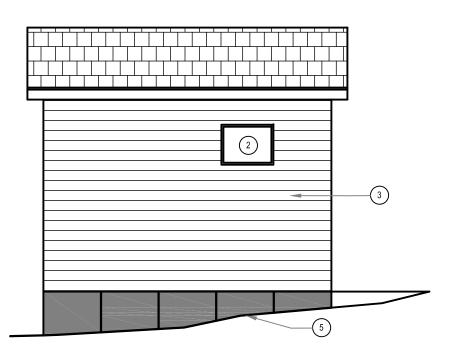

RIGHT SIDE ELEVATION A1.1

DRAWING NOTES: (#)

- REMOVE EXISTING DOOR. REMOVE EXISTING WINDOW.

- REMOVE EXISTING WINDOW.
 REMOVE EXISTING ROOF.
 REMOVE EXISTING FOUNDATION
 INSULATION.

THIS DRAWING MUST NOT BE SCALED.

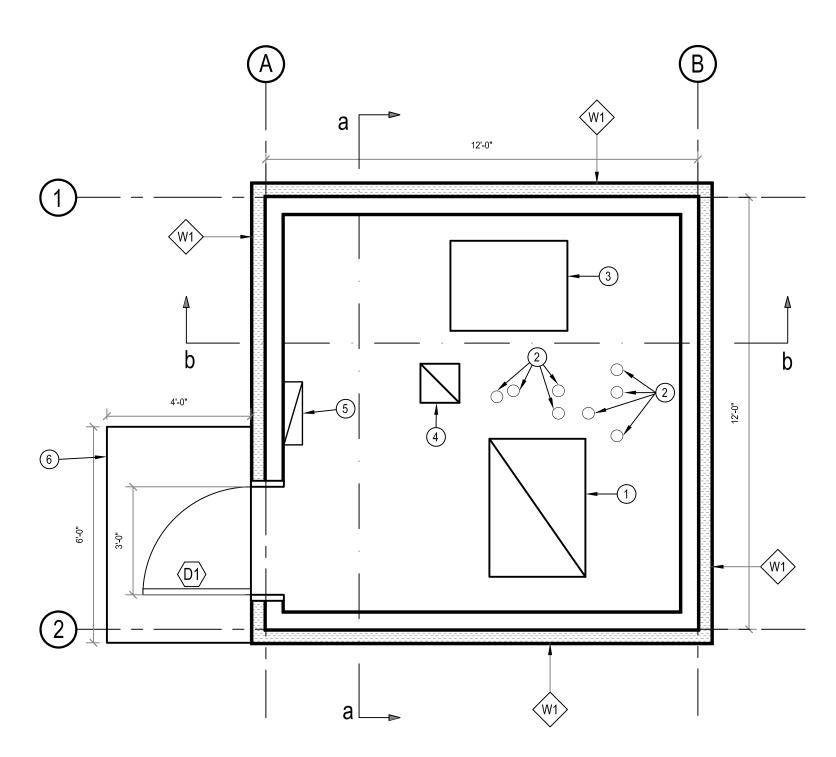
RS S

ELEVATIONS-DEMOLITION

RCMP - PUMP HOUSE

REVISION NO. ISSUED FOR TENDER 18 01 26

17-045-01-<u>21</u>



DRAWING NOTES: #

- NEW HATCH OVER PIT SEE STRUCTURAL FOR DETAILS IN-FILL HOLES IN FLOOR THAT ARE NOT BEING USED FOR NEW PUMPS
- EXISTING PUMP STAND TO REMAIN IN-FILL EXISTING HOLE IN FLOOR NEW ELECTRICAL PANEL EXISTING LANDING TO REMAIN

THIS DRAWING MUST NOT BE SCALED.

THE GENERAL CONTRACTOR SHALL VERIFY ALL DIMENSIONS, DATUMS AND LEVELS PRIOR TO COMMENCEMENT OF WORK AND IS HELD RESPONSIBLE FOR REPORTING ANY DISCREPANCY OR OMISSION TO CAN-TEC SERVICES LTD, IMMEDIATELY,

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OHECKI RS

DRAWN XW

SCALE AS NOTED PLAN

RCMP - PUMP HOUSE

SHETTITE FLOOR


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REVISION NO. 03
ISSUED FOR TENDER
18 01 26

17-045-01-21

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FLOOR PLAN SCALE: 3/8"=1'-0'



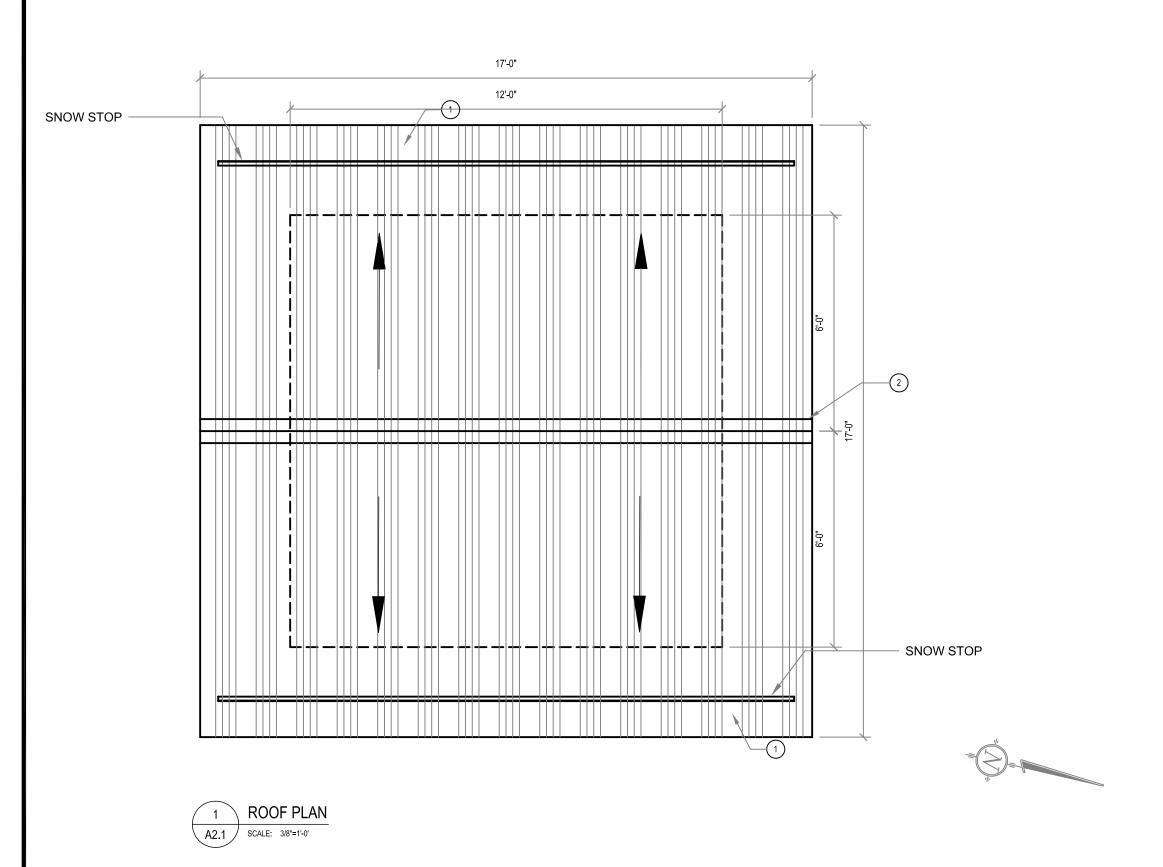DRAWING NOTES: (#)

- NEW METAL ROOF.
 NEW RIDGE VENT.

THIS DRAWING MUST NOT BE SCALED.

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OHECKI RS


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RCMP - PUMP HOUSE

SCALE AS NOTED SHET TILE ROOF PLAN

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ISSUED FOR TENDER
18 01 26



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DRAWN XW

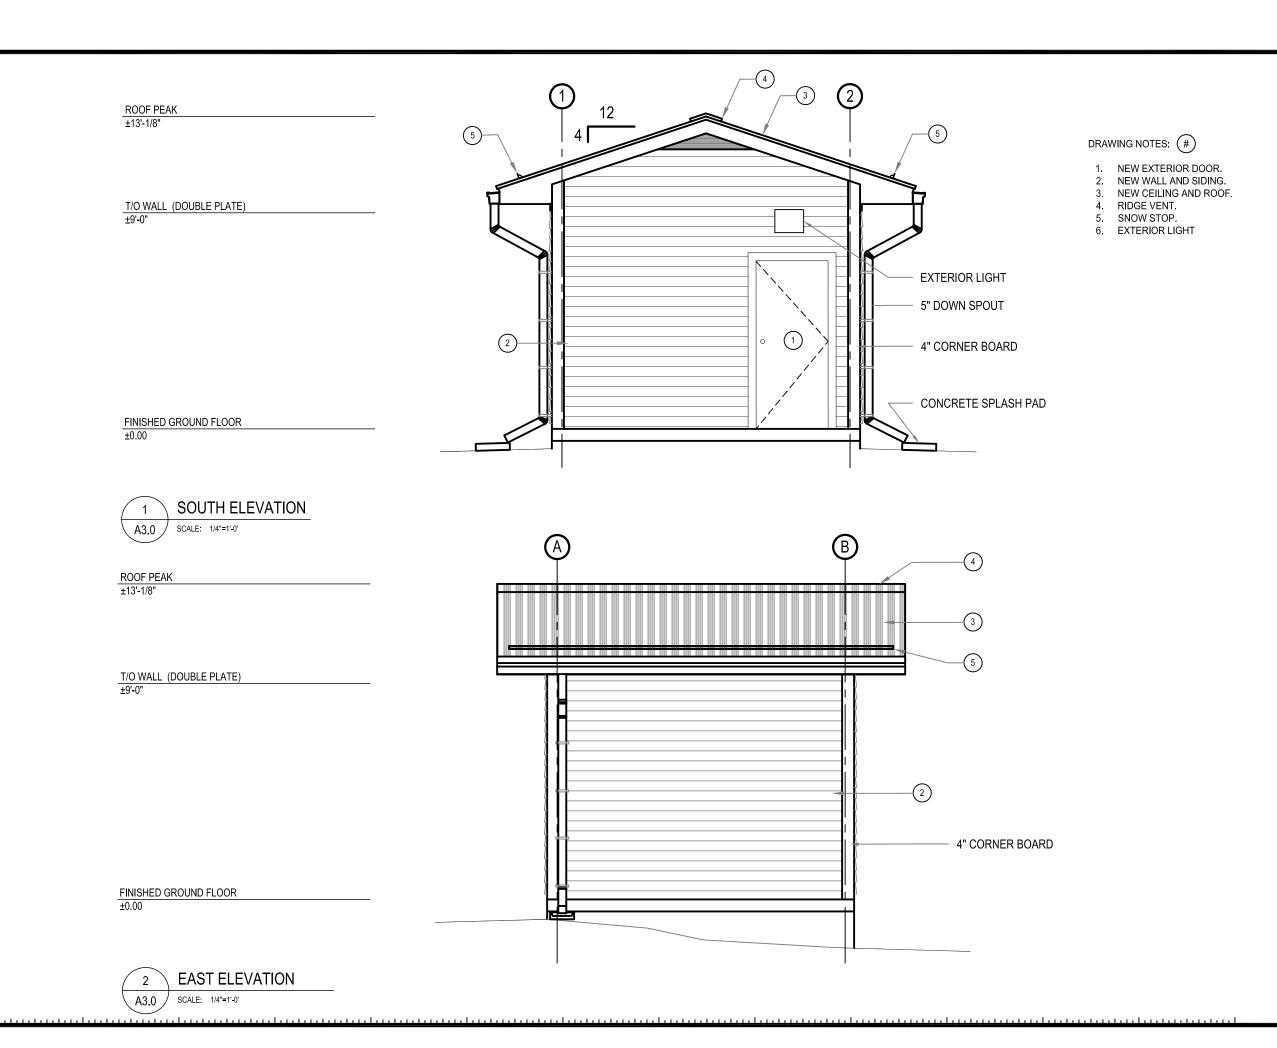
ELEVATIONS

RCMP - PUMP HOUSE

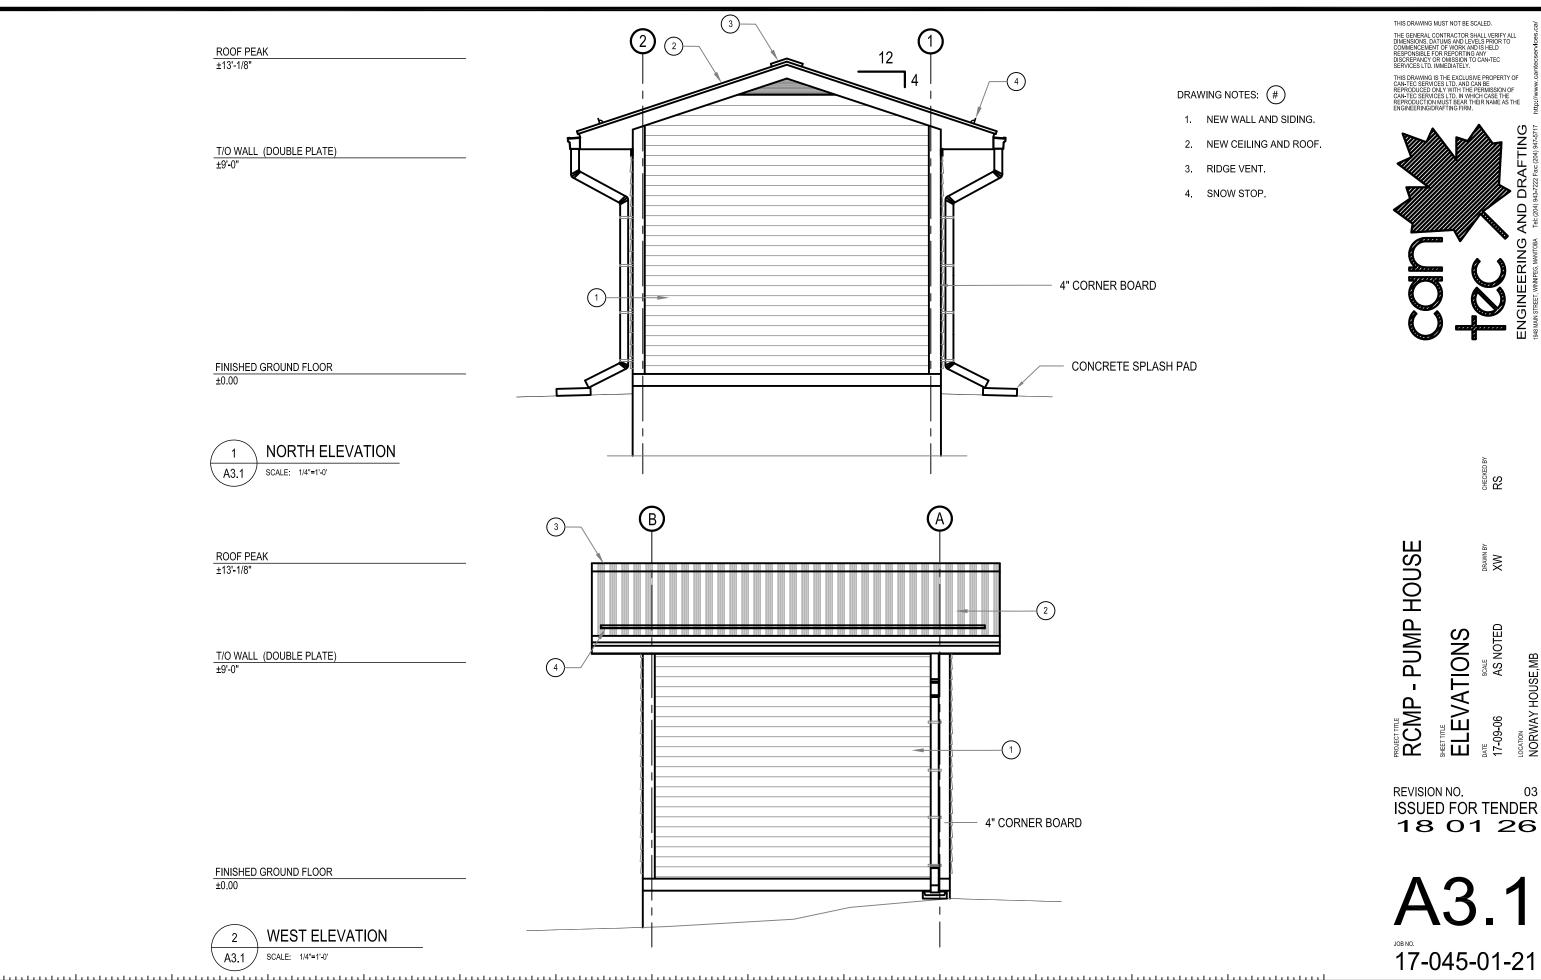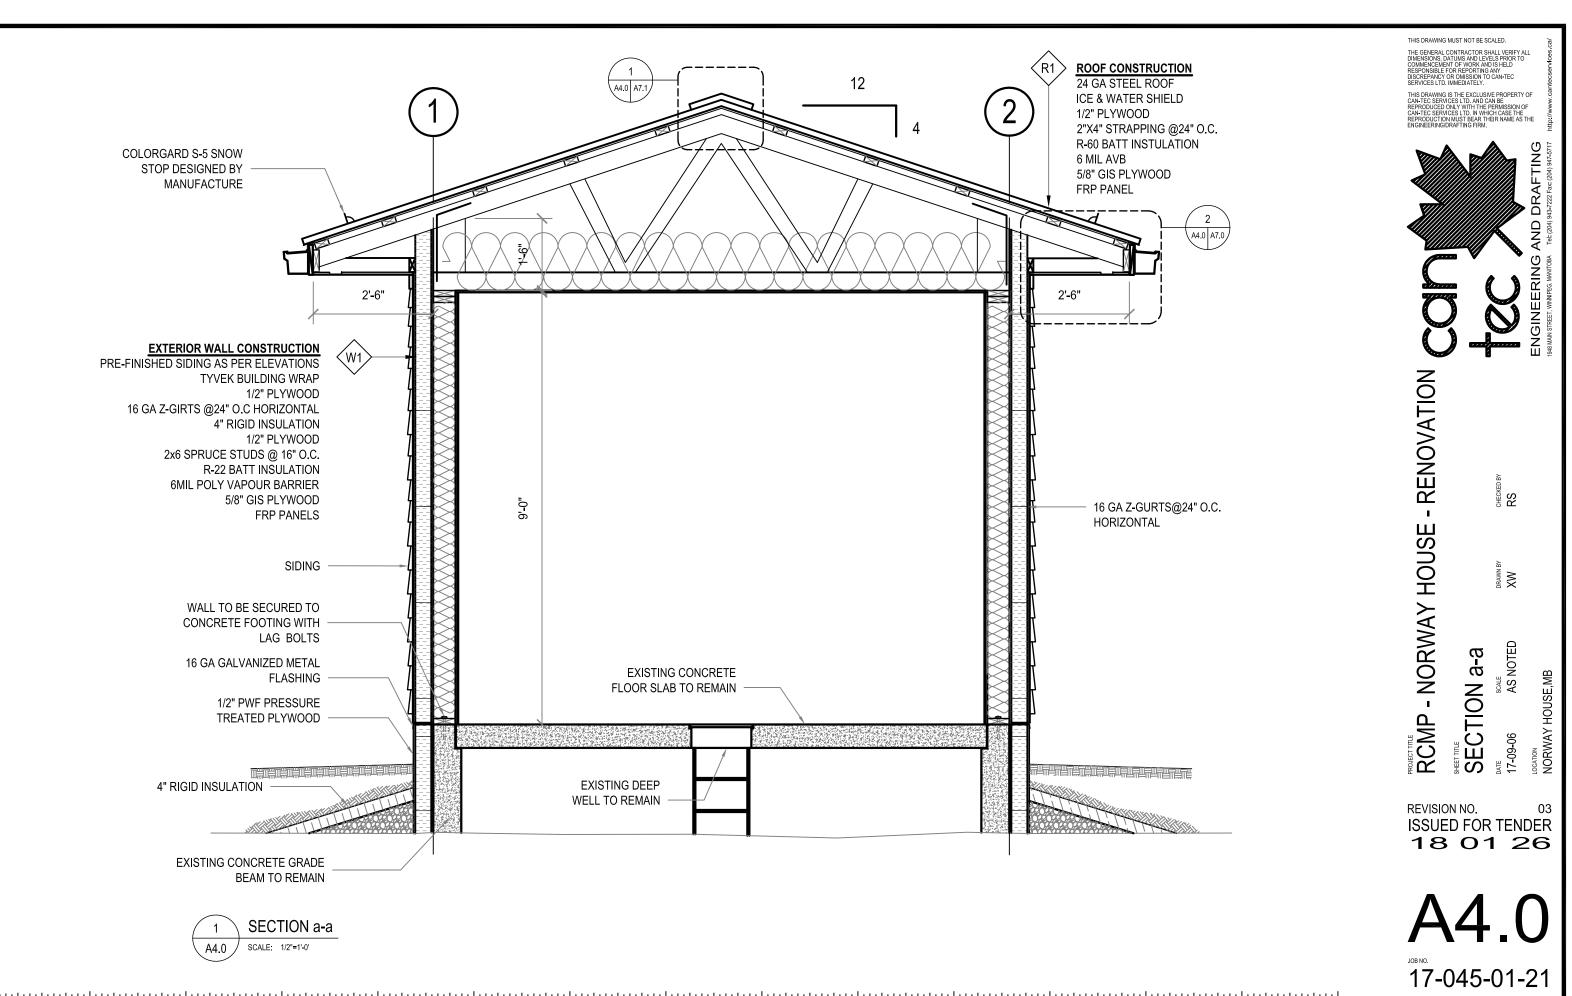
SCALE AS NOTED

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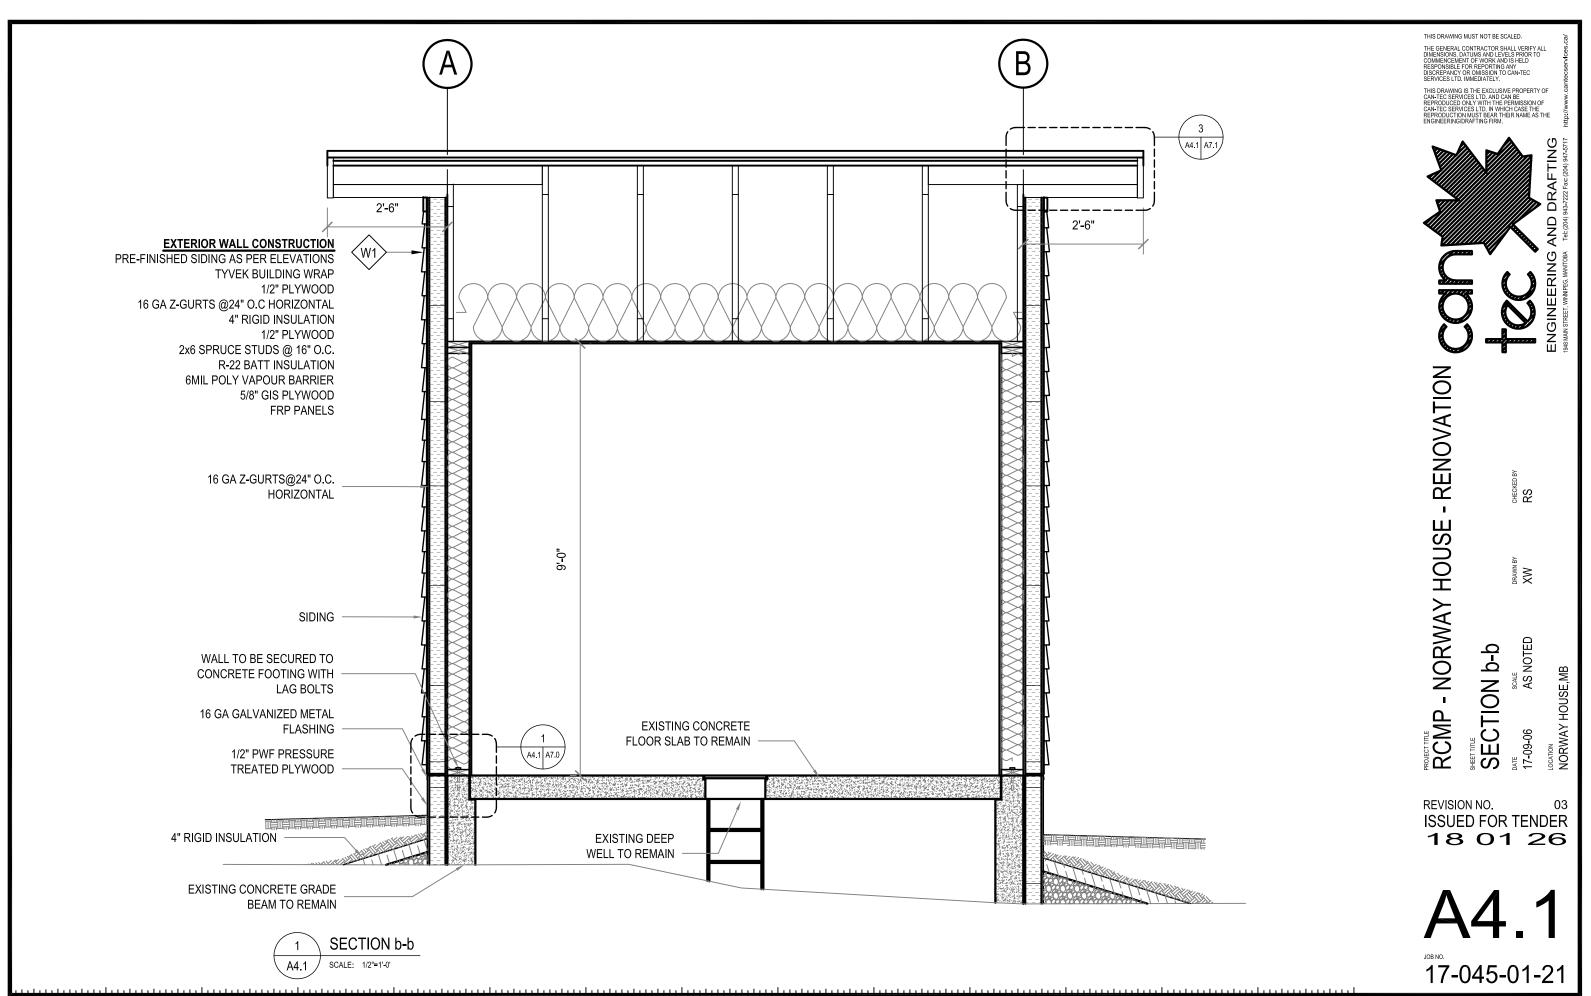
A3.0




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EAVE DETAIL SCALE: 3/4"=1'-0"



SS SS

DRAWN XW

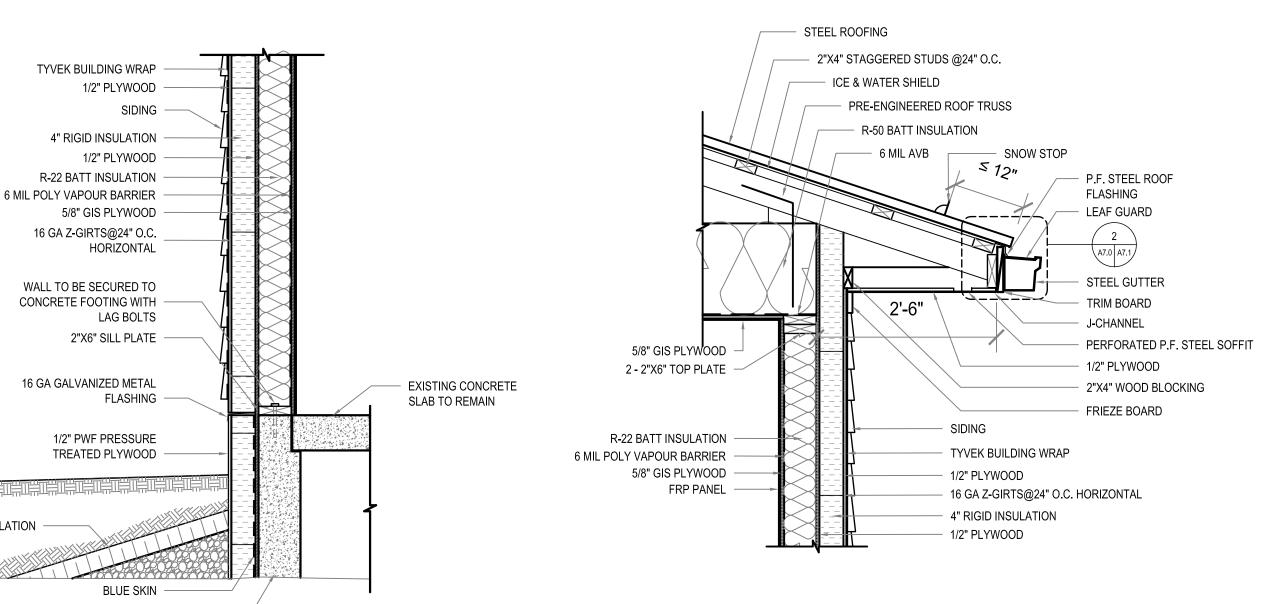- PUMP HOUSE

RCMP.

DETAILS SHEET TILE WALL

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A7.0

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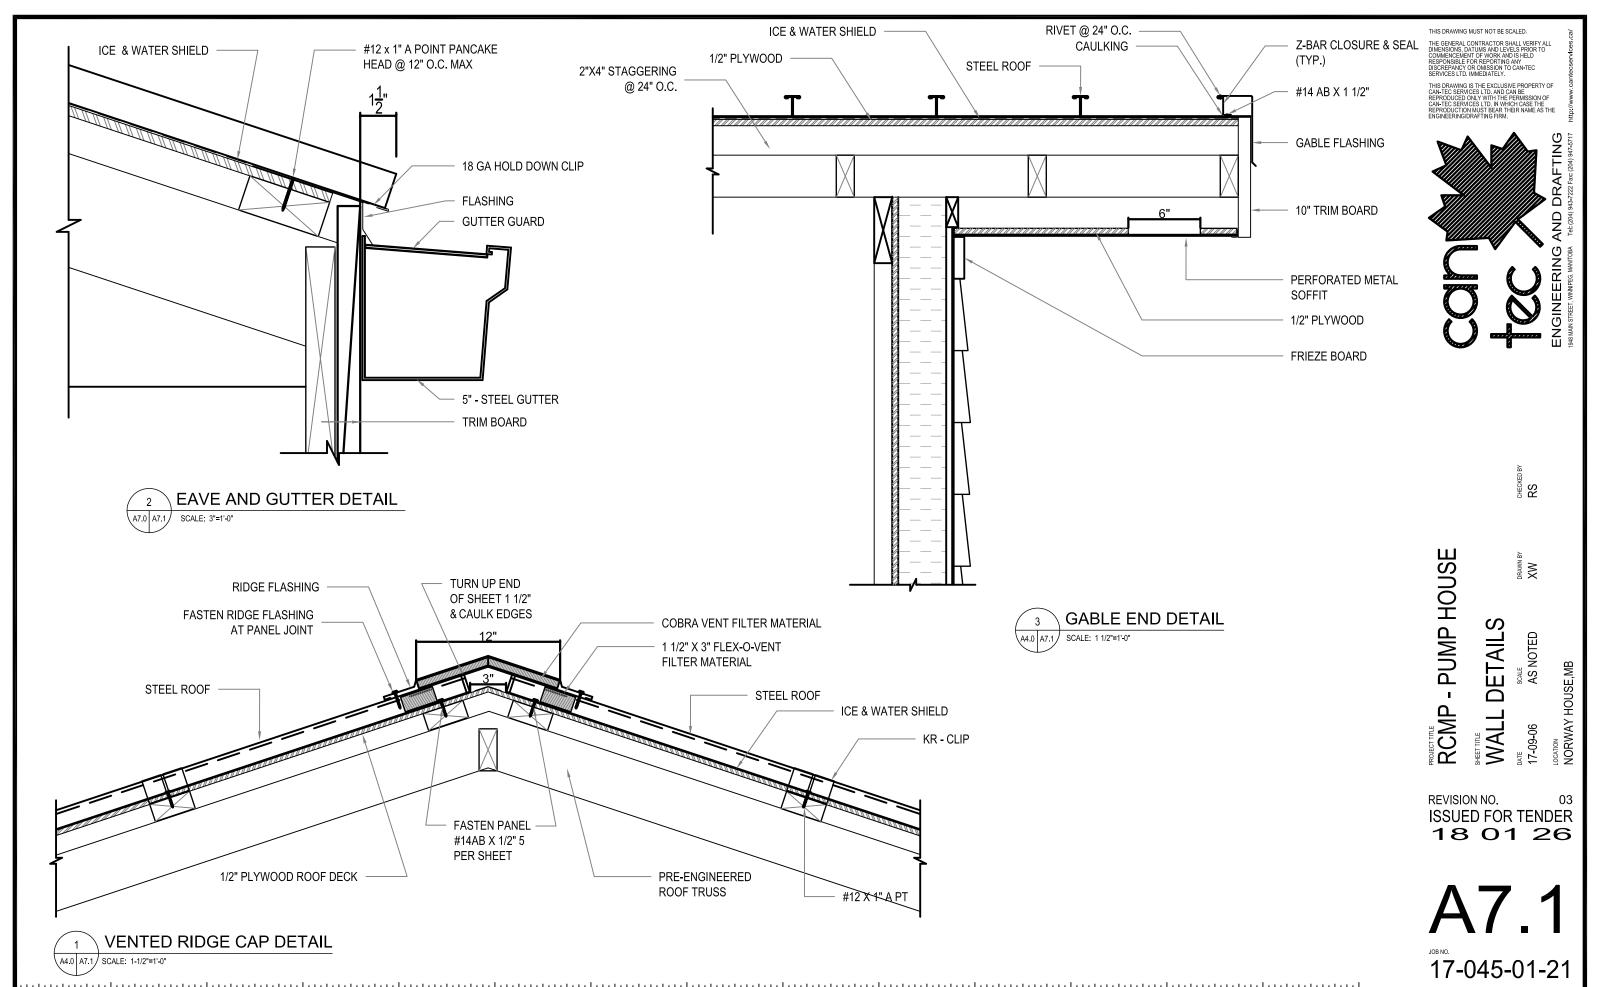
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4" RIGID INSULATION

EXISTING CONCRETE GRADE BEAM TO REMAIN

SCALE: 3/4"=1'-0"

WALL AND FOUNDATION DETAIL



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	DOOR SCHEDULE D##														
MARK	SIZE	DOOR TYPE	DOOR ELEV.	DOOR CORE	DOOR FINISH	DOOR COLOR	DOOR GAUGE	FRAME MATERIAL	FRAME TYPE	FRAME FINISH	FRAME COLOR	FRAME GAUGE	HARDWARE	RATING	REMARKS
D1	42" X 7'-0" X 1 ³ / ₄ "	STEEL	А	POLY ISO	PAINTED		16GA	STEEL	WELDED	PAINTED		14 GA	1	N/A	

THIS DRAWING MUST NOT BE SCALED.

SCHEDULE

∞ర

DETAILS


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RCMP - PUMP HOUSE SHET TITLE DOOR


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DOOR DETAILS



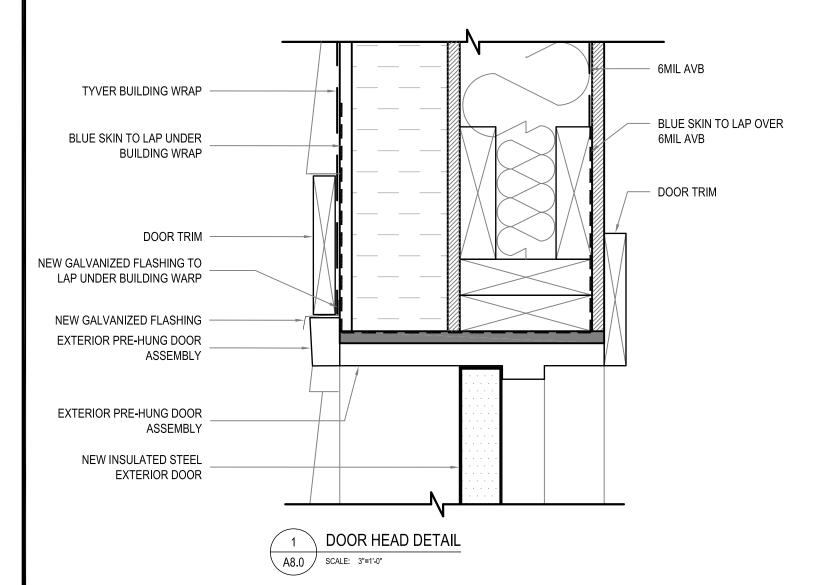WALL SCHEDULE



EXTERIOR WALL CONSTRUCTION

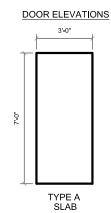PRE-FINISHED SIDING AS PER ELEVATIONS TYVEK BUILDING WRAP 1/2" PLYWOOD 16 GA Z-GURTS @24" O.C HORIZONTAL 4" RIGID INSULATION 1/2" PLYWOOD 2x6 SPRUCE STUDS @ 16" O.C. R-22 BATT INSULATION 6MIL POLY VAPOUR BARRIER 5/8" GIS PLYWOOD FRP PANELS

ROOF SCHEDULE



ROOF CONSTRUCTION 24 GA STEEL ROOF ICE & WATER SHIELD 1/2" PLYWOOD 2"X4" STAPPING @24" O.C. R-60 BATT INSULATION 6 MIL AVB 5/8" GIS PLYWOOD FRP PANEL

THIS DRAWING MUST NOT BE SCALED.

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RS S

SCHEDULE

FINISH

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RCMP - PUMP HOUSE

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18 01 26

17-045-01-21

GENERAL NOTES:

- DO NOT SCALE DRAWINGS.
- THE DESIGN IS IN ACCORDANCE WITH THE 2011 MANITOBA BUILDING CODE
- CLIMATIC DATA (TABLE C-2) NBCC:
- Ss = 2.4 kPa (50 psf) GROUND SNOW LOAD: RAIN LOAD: Sr = 0.2 kPa (4.0 psf)
- q (1/50) = 0.49 kPa (10.2 psf) HOURLY WIND PRESSURE: iv) SEISMIC DATA: NOT APPLICABLE
- IMPORTANCE CATEGORY: POST DISASTER
- COORDINATE AND VERIFY ALL DIMENSIONS WITH ARCHITECTURAL DRAWINGS PRIOR TO COMMENCING CONSTRUCTION.
- SEE ARCHITECTURAL DRAWINGS FOR ELEVATIONS, SLOPES, ROUGH OPENING DIMENSIONS FOR WINDOWS, DOORS, ETC.
- SEE MECHANICAL AND ELECTRICAL DRAWINGS FOR OPENINGS IN FLOORS, ROOF, WALLS, ETC.
- DO NOT CUT OR DRILL OPENINGS IN ANY STRUCTURAL MEMBERS WITHOUT WRITTEN APPROVAL FROM BEACH ROCKE ENGINEERING LTD.
- BEACH ROCKE ENGINEERING LTD. SHALL BE NOTIFIED AT LEAST 48 HOURS IN ADVANCE OF REQUIRED SITE INSPECTIONS. (TEL: 1-204-255-7251, FAX: 1-204-257-7239)
- STRUCTURAL DRAWINGS SHOW THE COMPLETED STRUCTURE. THEY DO NOT SHOW COMPONENTS WHICH MAY BE NECESSARY FOR SAFETY DURING CONSTRUCTION. THE CONTRACTOR IS RESPONSIBLE FOR CONSTRUCTION SITE SAFETY AND TO ENSURE THAT ALL SUBTRADES CONFORM TO THE LATEST REGULATIONS OF THE PROVINCIAL "BUILDING PROTECTION ACT", TO PROVIDE ALL NECESSARY SAFETY EQUIPMENT AS REQUIRED THEREIN AND TO NOTIFY LOCAL AUTHORITIES AS REQUIRED BY LAW.
- THE CONTRACTOR SHALL CONFORM TO THE COLD WEATHER REQUIREMENTS OF THE CSA STANDARD A23.1/A23.2 AND THE NATIONAL BUILDING
- IT IS THE GENERAL CONTRACTORS RESPONSIBILITY TO LOCATE ALL SITE SERVICES PRIOR TO CONSTRUCTION.
- THE GENERAL CONTRACTOR SHALL DESIGN ALL SHORING, FORM WORK, AND BRACING TO ENSURE PROPER CONSTRUCTION AND ERECTION.
- THE CONTRACTOR SHALL VISIT THE SITE, AND NOTE ALL CHARACTERISTICS AND IRREGULARITIES AFFECTING THE WORK OF THIS SECTION.
- SHOP DRAWINGS NOT STAMPED, SIGNED, AND DATED BY THE CONTRACTOR WILL BE RETURNED AND SHALL BE CONSIDERED REJECTED. SHOP
- DRAWINGS FOR WORK DESIGNED BY THE CONTRACTOR SHALL BEAR THE SEAL AND SIGNATURE OF A QUALIFIED PROFESSIONAL ENGINEER IN THE PROJECTS PROVINCE
- THE CONTRACTOR SHALL SUBMIT AT LEAST 3 COPIES OF STAMPED SHOP DRAWINGS FOR ALL PRE-FABRICATED STRUCTURAL ASSEMBLIES, INCLUDING REINFORCING STEEL TO BEACH ROCKE ENGINEERING LTD. FOR REVIEW AND APPROVAL PRIOR TO FABRICATION. ALL SHOP DRAWINGS, EXCEPT REINFORCING STEEL, SHALL BEAR THE SEAL OF AN ENGINEER REGISTERED IN THE PROJECTS PROVINCE.

WOOD NOTES:

- ALL LUMBER COMPONENTS SHALL BE DESIGNED AND FABRICATED IN ACCORDANCE WITH THE CAN/CSA-086-09
- ALL LUMBER SHALL CONFORM TO "NLGA STANDARD GRADING RULES FOR CANADIAN LUMBER". AND THE GRADE SHALL BE CLEARLY IDENTIFIED ON ALL PRODUCTS
- ALL DIMENSIONAL LUMBER SHALL BE NO.2 GRADE, OR BETTER, UNLESS NOTED OTHERWISE ON DRAWINGS.
- FRAMED WALLS AND ROOF SYSTEMS SHALL BE ADEQUATELY BRACED UNTIL CONSTRUCTION IS COMPLETED. THE CONTRACTOR SHALL SUPPLY AND ERECT ALL BRACING NECESSARY TO PROVIDE STABILITY FOR THE STRUCTURE AS A WHOLE, INCLUDING DURING THE CONSTRUCTION PHASE.
- LOAD BEARING STUD WALLS SHALL HAVE SOLID BLOCKING AT 4'-0" CENTERS.
- SHEATHING AND STRUCTURAL ACCESSORIES SHALL BE INSTALLED ACCORDING TO THE MANUFACTURER'S SPECIFICATIONS AND RECOMMENDATIONS. SHEATHING SHALL BE CANPLY EXTERIOR GRADE PLYWOOD UNLESS OTHERWISE NOTED ON THE DRAWINGS OR APPROVED BY BEACH ROCKE ENGINEERING LTD.
- LUMBER IN CONTACT WITH SOIL SHALL BE PRESERVATIVE-TREATED IN ACCORDANCE WITH THE CAN/CSA-080 SERIES-08. THE CUT ENDS AND DRILLED HOLES OF TREATED LUMBER SHALL BE TREATED WITH 3 COATS OF PRESERVATIVES.
- FASTENERS USED FOR FRAMING SHALL BE: HOT-DIPPED AND GALVANIZED FOR LUMBER ABOVE GRADE, AND, STAINLESS STEEL (TYPES 304 AND 316) FOR PRESERVATIVE-TREATED LUMBER CONFIRMING TO CSA B111-1974.
- JOINTS AND HOLES BELOW GRADE SHALL BE SEALED WITH BUTLY CAULKING COMPOUND OR EQUAL CONFORMING TO CGSB 19-GP-13 OR CGSB 19-GP-14. INSTALLED TO PROVIDE A WATER-TIGHT SEAL.
- PROVIDE 3 SETS OF STAMPED AND SEALED SHOP DRAWINGS FOR ALL ROOF TRUSSES SUPPLIED BY THE TRUSS MANUFACTURER. SUBMIT SHOP DRAWINGS TO BEACH ROCKE ENGINEERING FOR APPROVAL
- PROVIDE 3 SETS OF STAMPED AND SEALED SHOP DRAWINGS FOR ALL FLOOR JOISTS SUPPLIED BY THE JOIST MANUFACTURER. SUBMIT SHOP DRAWINGS TO BEACH ROCKE ENGINEERING FOR APPROVAL.
- ALL STRUCTURAL ENGINEERED WOOD (TIMBERSTRAND,MICROLLAM,PARALLAM,GLUE-LAMINTATED,ETC) PRODUCTS SHALL BE SUPPLIED BY MANUFACTURERS APPROVED BY BEACH ROCKE ENGINEERING LTD. PRODUCTS SHALL BE DESIGNED, FABRICATED AND EXECTED IN ACCORDANCE WITH THE CAN/CSA-086-09 TO SATISFY LOADING CONDITIONS NOTED ON THE DRAWINGS AND LOCAL BUILDING CODE REQUIREMENTS. THE MANUFACTURER SHALL PROVIDE 3 SETS OF SHOP DRAWINGS TO BEACH ROCKE ENGINEERING LTD. SEALED BY AND ENGINEER, REGISTERED IN THE PROVINCE OF MANITOBA, FOR ALL COMPONENTS PRIOR TO
- FASTEN EXTERIOR SHEATHING AT 3" O.C. AT EDGES, AND 12" O.C. AT INTERMEDIATE MEMBERS.
- ALL 4PLY FLUSH BEAMS AND 4PLY LVL BEAMS TO BE THRU BOLTED WITH 1/2" Ø BOLTS @ 16" O.C. STAGGERED TOP AND BOTTOM

POST INSTALLED ANCHOR NOTES:


- EXCEPT WHERE INDICATED ON THE DRAWINGS. POST-INSTALLED ANCHORS SHALL CONSIST OF THE FOLLOWING ANCHOR TYPES:
 - a) ANCHORAGE TO CONCRETE
 - ADHESIVE ANCHORS FOR CRACKED AND UNCRACKED CONCRETE USE:
 - HILTI HIT-HY 200 SAFE SET SYSTEM WITH THE HILTI HIT-Z ROD
 - ii) MEDIUM DUTY MECHANICAL ANCHORS FOR CRACKED AND UNCRACKED CONCRETE USE:
- HILTI KWIK BOLT 3 EXPANSION ANCHORS (UNCRACKED CONCRETE ONLY)
- iii) HÉAVY DUTY MECHANICAL ANCHORS FOR CRACKED AND UNCRACKED CONCRETE USE:
- HILTI HSL-3 EXPANSION ANCHORS
- b) REBAR DOWELING INTO CONCRETE
- i) ADHESIVE ANCHORS FOR CRACKED AND UNCRACKED CONCRETE USE:
- HILTI HIT-HY 200 SAFE SET SYSTEM WITH HILTI HOLLOW DRILL BIT WITH CONTINUOUSLY DEFORMED REBAR
- HILTI HIT-HY 500v3 SAFE SET SYSTEM WITH HILTI HOLLOW DRILL BIT WITH CONTINUOUSLY DEFORMED REBAR
- c) ANCHORAGE TO SOLID GROUTED MASONRY
- i) ADHESIVE ANCHORS USE:
 - HILTI HIT-HY 70 MASONRY ADHESIVE ANCHORING SYSTEM.
- STEEL ANCHOR ELEMENT SHALL BE HILTI HAS-E CONTINUOUSLY THREADED ROD OR CONTINUOUSLY DEFORMED STEEL REBAR
- ii) MECHANICAL ANCHORS USE:
- (1) HILTI KWIK BOLT-3 EXPANSION ANCHORS
- d) ANCHORAGE TO HOLLOW / MULTI-WYTHE MASONRY
- i) ADHESIVE ANCHORS USE:
- HILTI HIT-HY 70 MASONRY ADHESIVE ANCHORING SYSTEM.
- STEEL ANCHOR ELEMENT SHALL BE HILTI HAS-E CONTINUOUSLY THREADED ROD OR CONTINUOUSLY DEFORMED STEEL REBAR
- THE APPROPRIATE SIZE SCREEN TUBE SHALL BE USED PER ADHESIVE MANUFACTURER'S RECOMMENDATION
- ANCHOR CAPACITY USED IN DESIGN SHALL BE BASED ON THE TECHNICAL DATA PUBLISHED BY HILTI OR SUCH OTHER METHOD AS APPROVED BY THE STRUCTURAL ENGINEER OF RECORD. SUBSTITUTION REQUESTS FOR ALTERNATE PRODUCTS MUST BE APPROVED IN WRITING BY THE STRUCTURAL ENGINEER OF RECORD PRIOR TO USE. CONTRACTOR SHALL PROVIDE CALCULATIONS DEMONSTRATING THAT THE SUBSTITUTED PRODUCT IS CAPABLE OF ACHIEVING THE PERFORMANCE VALUES OF THE SPECIFIED PRODUCT. SUBSTITUTIONS WILL BE EVALUATED BY THEIR HAVING AN ICC ESR SHOWING COMPLIANCE WITH THE RELEVANT BUILDING CODE FOR SEISMIC USES, LOAD RESISTANCE. INSTALLATION CATEGORY, AND AVAILABILITY OF COMPREHENSIVE INSTALLATION INSTRUCTIONS, ADHESIVE ANCHOR EVALUATION WILL ALSO CONSIDER CREEP, IN-SERVICE TEMPERATURE AND INSTALLATION TEMPERATURE.
- INSTALL ANCHORS PER THE MANUFACTURER INSTRUCTIONS, AS INCLUDED IN THE ANCHOR PACKAGING.
- THE CONTRACTOR SHALL ARRANGE AN ANCHOR MANUFACTURER'S REPRESENTATIVE TO PROVIDE ONSITE INSTALLATION TRAINING FOR ALL OF THEIR ANCHORING PRODUCTS SPECIFIED. THE STRUCTURAL ENGINEER OF RECORD MUST RECEIVE DOCUMENTED CONFIRMATION THAT ALL OF THE CONTRACTOR'S PERSONNEL WHO INSTALL ANCHORS ARE TRAINED PRIOR TO THE COMMENCEMENT OF INSTALLING ANCHORS.

STRUCTURAL DRAWING LIST:

- S1.1
- **EXIST FOUNDATION & ROOF FRAMING PLAN** S2.1
- S5.1

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- PUMP HOUSE ECT NOTE RCMP RO

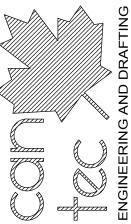
LOCATION NORWAY REVISION NO. 01 ISSUED FOR TENDER

AS NOTED





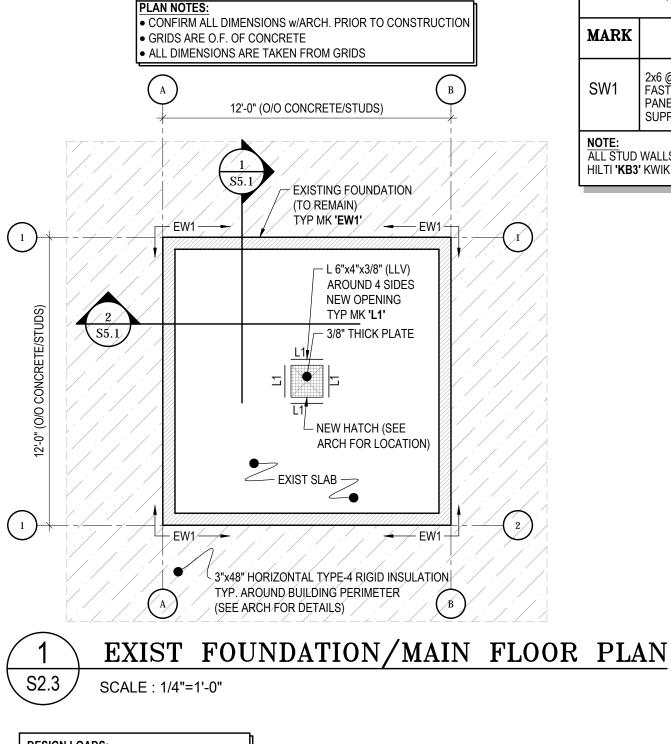17-1824-CG-352



WALL SCHEDULE **MARK DESCRIPTION** 2x6 @ 12" O.C. (SPF No. 1/2) c/w 1/2" PLYWOOD, FASTENED TO STUDS w/2 1/2" NAILS @ 3" O.C. @ PANEL EDGES AND 12" O.C @ INTERMEDIATED SW1

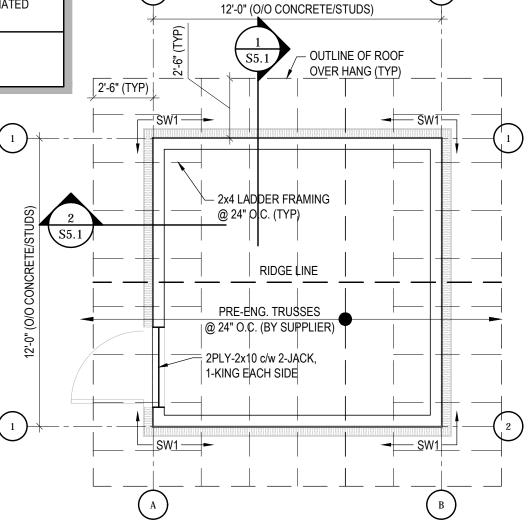
SUPPORTS. (EXTERIOR WALLS)

NOTE:

ALL STUD WALLS c/w 1/2"Øx6" LONG HILTI 'KB3' KWIK BOLTS @ 32" O.C.

PLAN NOTES:

- CONFIRM ALL DIMENSIONS w/ARCH. PRIOR TO CONSTRUCTION
- GRIDS ARE O.F. OF CONCRETE
- ALL DIMENSIONS ARE TAKEN FROM GRIDS



ROOF FRAMING PLAN

SCALE: 1/4"=1'-0"

DESIGN LOADS:

SNOW LOAD

= 2.65 kPa (55 psf) = 0.72 kPa (15 psf)

DEAD LOAD

REVISION NO. 01 **ISSUED FOR TENDER**

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AND DRAFTING

ENGINEERING

Beach Rocke

RECKE

PLAN

FRAMING

ROOF

FDTN&

SCALE AS NOTED

DATE 18-01-26

HOUSE, MB

LOCATION NORWAY H

- PUMP HOUSE

RCMP

17-1824-CG-352

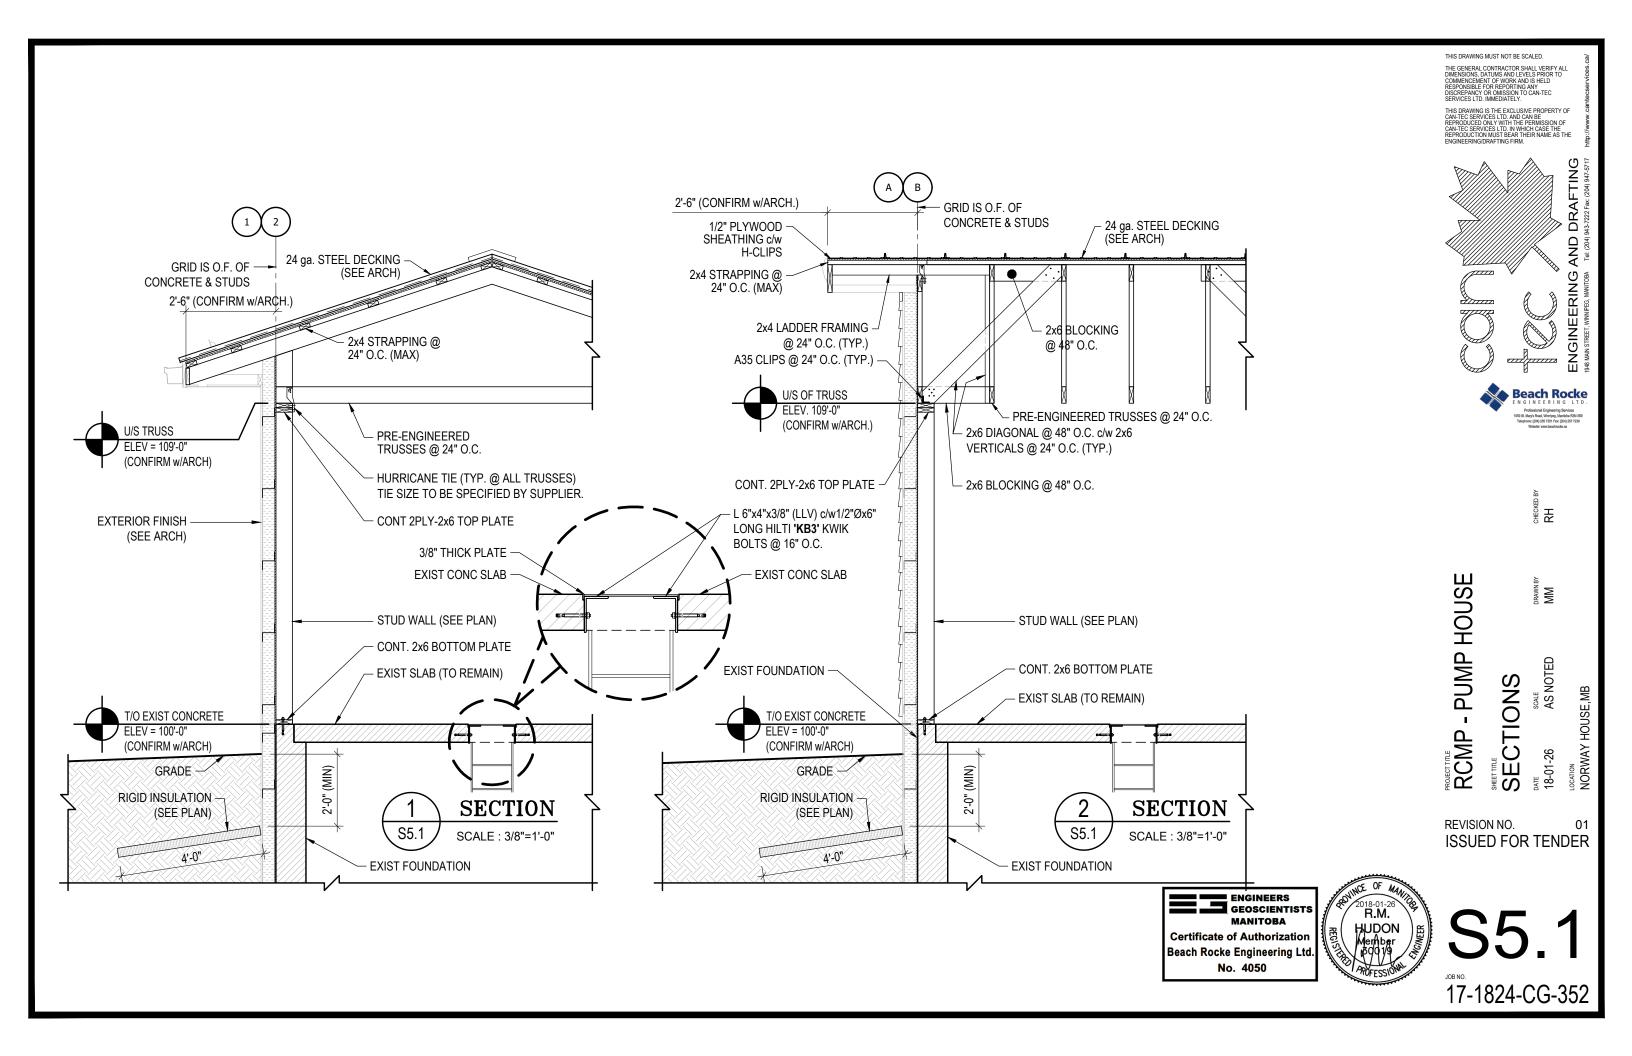
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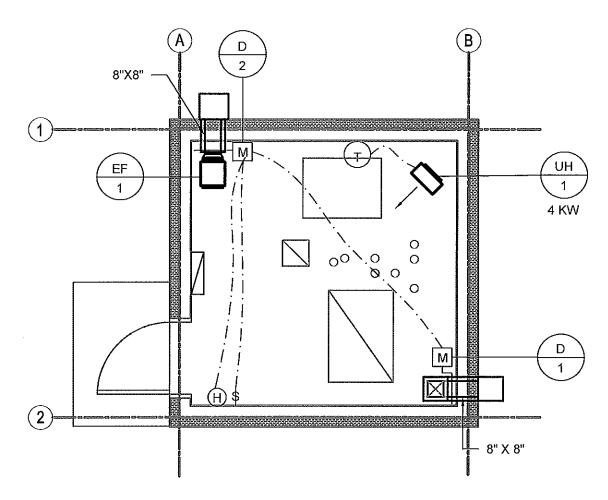
Certificate of Authorization Beach Rocke Engineering Ltd. No. 4050



DESIGN LOADS:

- LIVE LOAD = 12 kPa (250 psf) - DEAD LOAD = SLAB SELF WEIGHT + (5 psf)





\$-Q-

AIR INTAKE DETAIL

M2.0 SCALE: NTS

AIH INTAKE HOOD C/W BIRD SCREEN

EXHAUST HOOD TO BE 10 GA -

Certificate of Authorization

Can-Tec Services Ltd.

BUILDING EXTERIOR

HEATING AND COOLING LEGEND

THERMOSTAT

CEILING 3.

TOP OPENING IN DUCT

SIZE

BELIMO MOTOR ACTUATOR AND TAMCO DAMPER

SEE DRAWING FOR

A sales and the sales and the sales and the sales are

M

#BUILDING INTERIOR

© ROOM SENSOR

EQUIPMENT TAG (SEE SCHEDULE)

VENTILATION LEGEND

TRANSFER SLEEVE

VOLUME BALANCING DAMPER

Ø ☐ FIRE DAMPER

MOTORIZED DAMPER



PROJECT TITLE: NORWAY HOUSE WATER TREATMENT PLANT - BUILDING NO.2

SHEET TITLE: FLOOR PLAN - HVAC

MAIN FLOOR PLAN - HVAC

SCALE: 1/4"=1'-0"

M2.0

PROJECT NUMBER: 17-045-01-21 01 REV.#

ISSUED FOR TENDER 18 01 26
REVISION DATE (YY MI

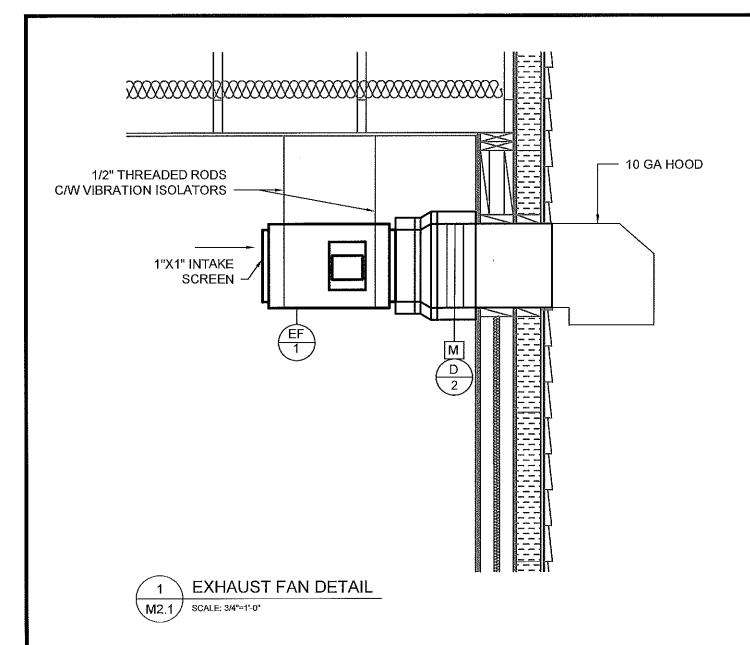
18 01 26 JLS DATE (YY MM DD) REV. BY

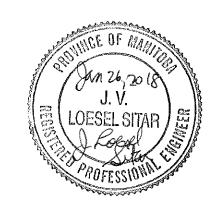
REV.# REVISION

DATE (YY MM DD) REV. BY

SCALE: AS NOTED DATE (TY MANDD): 17 11 20 M2.0

REVISION NUMBER:







Certificate of Authorization

Can-Tec Services Ltd.

No. 4189

Date:.



PROJECT TITLE
NORWAY HOUSE WATER TREATMENT PLANT - BUILDING NO.2

SHEET TITLE: FLOOR PLAN - HVAC

PROJECT NUMBER: 17-045-01-21

ISSUED FOR TENDER 18 01 26 REV.# REVISION

JLS DATE (YY MM DD) REV. BY

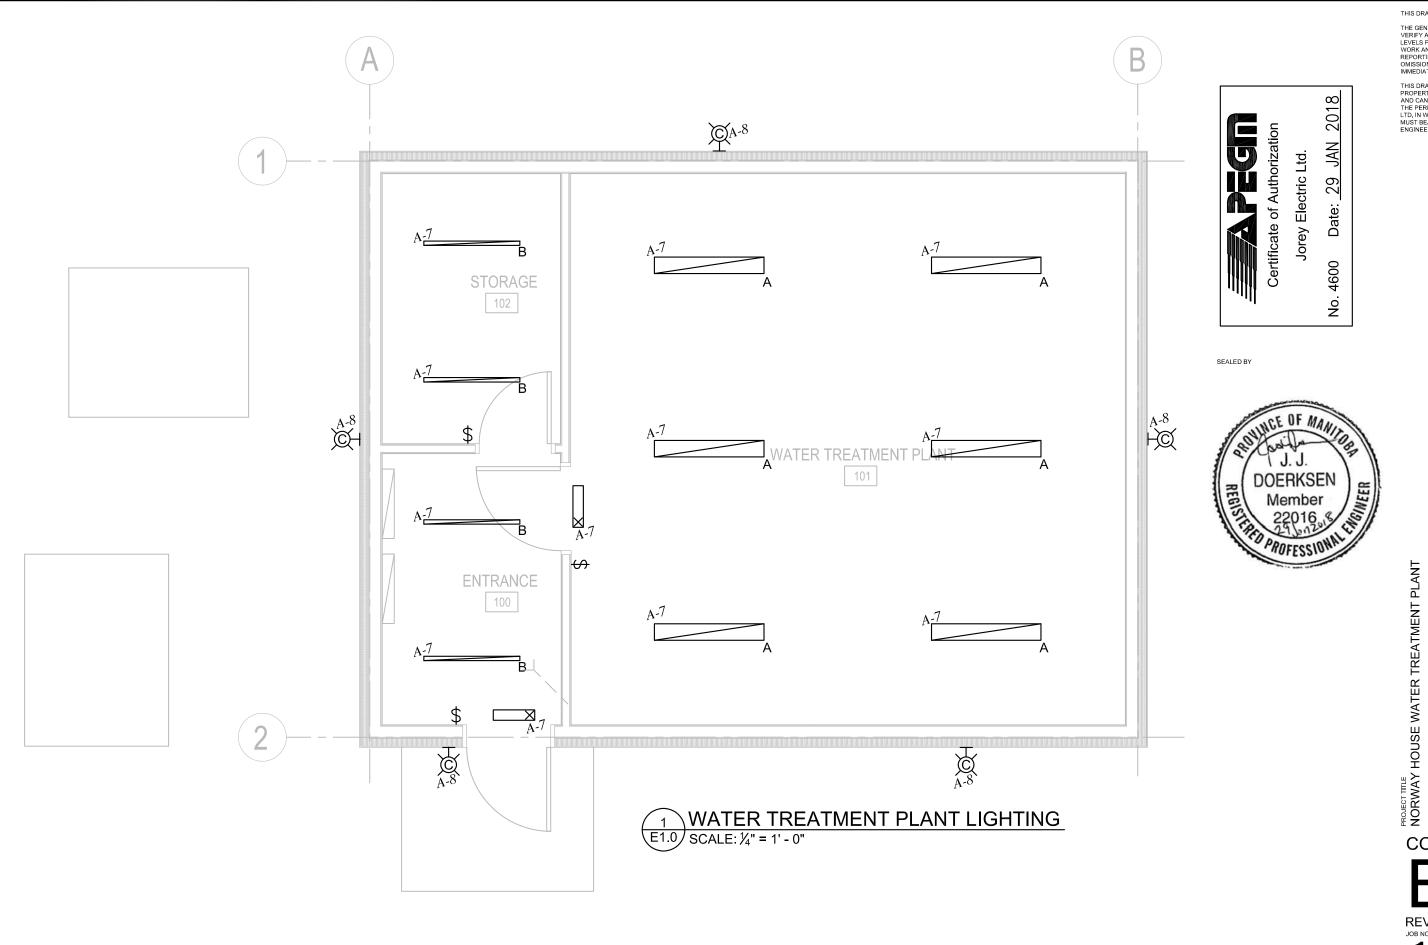
REV.# REVISION

DATE (YY MM DD) REV. BY

SCALE: AS NOTED date (YY MM DD): 17 11 20

M2.1

REVISION NUMBER:



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Engineering Consultants

6-1375 Niakwa Road E. Winnipeg, Manitoba Canada, R2J 3T3

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DRAWN E LCB

SCALE AS SHOWN

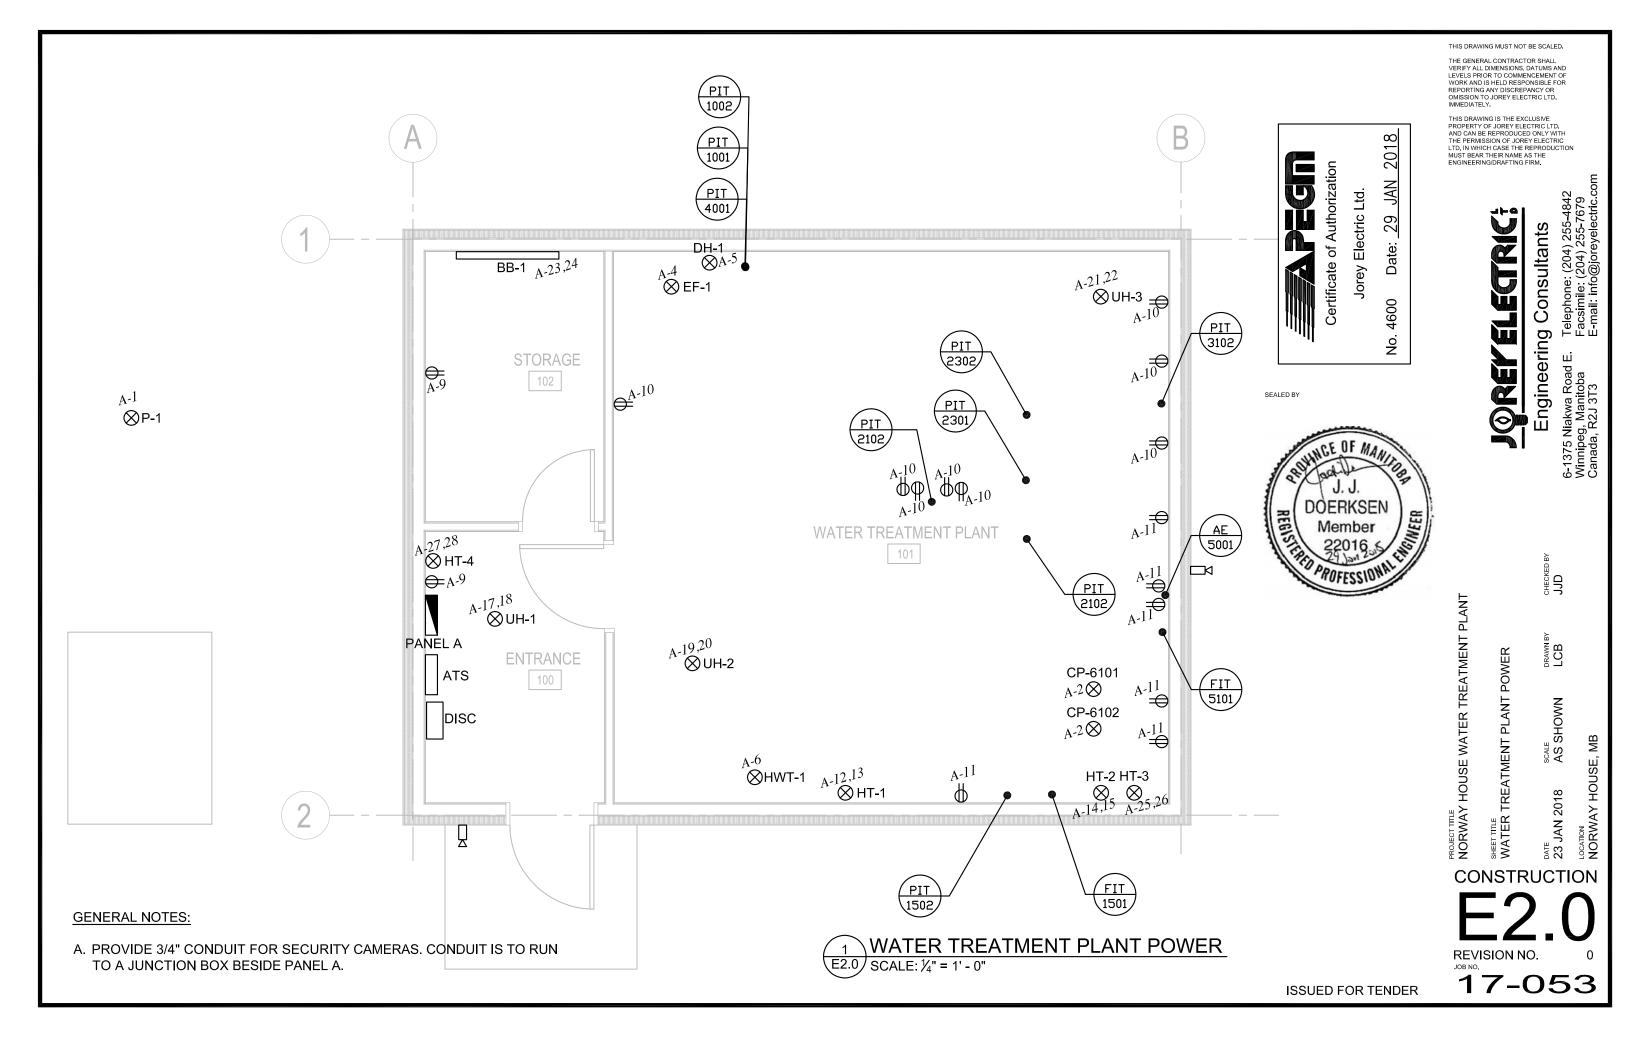
LOCATION
NORWAY HOUSE, MB

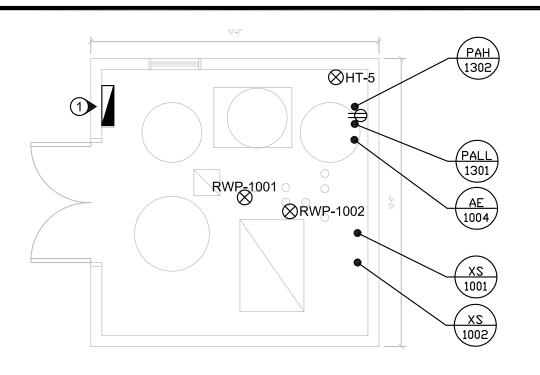
_{рате} 23 JAN 2018

CONSTRUCTION

SHEET TILE WATER TREATMENT PLANT LIGHTING

REVISION NO. 0
17-053 **ISSUED FOR TENDER**







PAH . ⊗HT-5 B-9 ⊗EF-2 \square -29,30 (1301) PANEL B B-2,41004 VFD-1001 ⊗ XS 1001 B-¹¹ VFD-1002 (XS) (1002)

PUMP HOUSE CONSTRUCTION PLAN E3.0 SCALE: 1/4" = 1' - 0"





DRAWING NOTES:

(1) EXISTING PANEL TO BE REMOVED.

GENERAL NOTES:

- A. ALL EXTERIOR LIGHTS TO BE CONTROLLED BY PHOTOCELL LOCATED ON NORTH SIDE OF BUILDING.
- B. PUMPS RWP-1001 AND RWP-1002 ARE TO REMAIN OPERATIONAL UNTIL NEW PUMPS CAN BE CONNECTED. BEFORE DISCONNECTING EXISTING PANEL, PROVIDE TEMPORARY POWER FROM NEW WATER TREATMENT PLANT TO KEEP PUMPS IN OPERATION DURING CONSTRUCTION OF NEW PUMP HOUSE.

LIGHTING AND CONTROL SCHEDULE

TYPE	DESCRIPTION	LAMPS
Α	LITHONIA-VAP-4000LM-FST-MD-MVOLT-40K-80CRI LED	42W
В	LITHONIA-Z1LN-L48-3000LM-FST-MVOLT-35K-80CRI LED STRIP LIGHT	25W
С	RC LIGHTING-WP2LED-24-RCL WALLPACK LED	24W
\$	WALL MOUNTED SWITCH LINES DENOTE NUMBER OF SWITCHES	

ELECTRIC HEATING SCHEDULE

TYPE	DESCRIPTION	KW	VOLTS/PH	LOCATION	NOTES	
UH-1	UNIT HEATER OUELLET-OAS02000	2kW	240V/1PH	WATER TREATMENT PLANT	C/W BUILT-IN STAT	
UH-2 AND UH-3	UNIT HEATERS OUELLET-10000	10kW	240V/1PH	WATER TREATMENT PLANT	C/W BUILT-IN STAT	
BB-1	BASEBOARD HEATER OUELLET-OFM2000	2kW	240V/1PH	WATER TREATMENT PLANT	C/W BUILT-IN STAT	
UH-4	UNIT HEATER OUELLET-OAS05000	5kW	240V/1PH	PUMP HOUSE	C/W BUILT-IN STAT	

EMERGENCY LIGHTING SCHEDULE

TYPE	DESCRIPTION
I IX I	LUMACELL EXIT SIGN LS-3-W-U

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онескер ЈЈ**D**

SHEET TITLE PUMP HOUSE PLAN AND SCHEDULES

SCALE AS SHOWN

PROJECT TITLE NORWAY HOUSE WATER TREATMENT PLANT

DATE 23 JAN 2018

CONSTRUCTION

17-053

SINGLE LINE DIAGRAM

3C #250MCM

DISCONNECT

ENTRANCE RATED

SERVICE

3 X 200A

3C #250MCM

AL ACWU

AL ACWU

200A

S	SYMBOL SCHEDULE							
#	DUPLEX RECEPTACLE "GF" DENOTES GFI RECEPTACLE "20" DENOTES 20A RECEPTACLE							
\otimes	ELECTRICAL CONNECTION							
	CONTROL TAG							
	CAMERA							
HX	WALL LUMINAIRE							
	LINEAR LUMINAIRE							

OVERHEAD ATTACHMENT == POINT



SEALED BY

GENERATOR 32 kW

120/240V,

1PH, 3W

3C #250MCM

AL ACWU



EQUIPMENT SCHEDULE

NUMBER	DESCRIPTION	KW/HP/A	VOLTS/PH	BREAKER	CONDUCTOR	LOCATION	NOTES
VFD-1001 AND VFD-1002	RW PUMPS	7.5A	240V/1PH	15A/2P	2 #12	PUMP HOUSE	
CP-6101 AND CP-6102	CHLORINE PUMPS	FRACTIONAL	120V/1PH	15A/1P	2 #12	WATER TREATMENT PLANT	
HT-1 TO HT-5 HEAT TRACE		24A	240V/1PH	30A/2P	2 #10	WATER TREATMENT PLANT AND PUMP HOUSE	CONFIRM REQUIREMENTS. PROVIDE GFI BREAKER
EF-1	WTP EXHAUST FAN	1/10 HP	120V/1PH	15A/1P	2 #12	WATER TREATMENT PLANT	
DH-1	DEHUMIDIFIER	8A	120V/1PH	15A/1P	2 #12	WATER TREATMENT PLANT	
P-1	SANITARY PUMP	1/3 HP	120V/1PH	15A/1P	2 #12	OUTSIDE WATER TREATMENT PLANT	
HWT-1	HOT WATER TANK	1.5kW	120V/1PH	20A/1P	2 #12	WATER TREATMENT PLANT	
EF-2	PH EXHAUST FAN	1/10 HP	120V/1PH	15A/1P	2 #12	PUMP HOUSE	

MATCH BREAKER AND WIRE SIZES TO ACTUAL NAMEPLATE RATINGS OF EQUIPMENT

PROVIDE LOCAL DISCONNECTS TO CODE

REFER TO MECHANICAL DRAWINGS AND WATER TREATMENT DRAWINGS FOR CONTROLS

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OREY

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6-1375 Niakwa Road E. Winnipeg, Manitoba Canada, R2J 3T3

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DRAWN F LCB

DIAGRAM

AND SINGLE LINE

SHEET TITLE SCHEDULES /

SCALE AS SHOWN

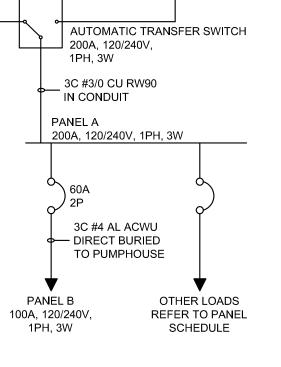
LOCATION
NORWAY HOUSE, MB _{DATE} 23 JAN 2018

CONSTRUCTION

REVISION NO.

17-053

PROJECT TITLE NORWAY HOUSE WATER TREATMENT PLANT



ISSUED FOR TENDER

PANEL A

200A 120/240V 1PH 3W

CCT#	DESCRIPTION	BREAKER SIZE	WIRE SIZE	CCT#	DESCRIPTION	BREAKER SIZE	WIRE SIZE
1	SANITARY PUMP P-1	15A	#12	17		45.	#12
2	CHLORINE PUMP CP-6101	15A	#12	18	UNIT HEATER UH-1	15A	#12
3	CHLORINE PUMP CP-6102	15A	#12	19	UNIT HEATER UH-2	60A	#6
4	EXHAUST FAN EF-1	15A	#12	20	ONIT HEATER OH-2	BUA	#6
5	DEHUMIDIFIER DH-1	15A	#12	21	UNIT HEATER UH-3	60A	#6
6	HOT WATER TANK	20A	#12	22	ONIT FILATER OFF-5	OUA	#6
7	LIGHTS, EXIT SIGNS	15A	#12	23	BASEBOARD HEATER BBH-1	15A	#12
8	EXTERIOR LIGHTS	15A	#12	24	BASEBOARD HEATER BBH-1	ISA	#12
9	STORAGE AND ENTRANCE RECEPTACLES	15A	#12	25	HEAT TRACES HT-3	30A	#10
10	WTP RECEPTACLES	15A	#12	26	THE AT THE AGE OF THE	00/1	#10
11	WTP RECEPTACLES	15A	#12	27	HEAT TRACES HT-4	30A	#10
12	HEAT TRACES HT-1	30A	#10	28	ITEAT TRACESTIT-4	30A	#10
13	TILAT TRACESTIT-T	304	#10	29	PANEL B	60A	#6
14	HEAT TRACES HT-2	30A	#10	30	I ANLL D	JUA	#6
15	TILAT TRACES HT-2	30A	#10	31			
16				32			

PANEL B 100A, 120/240V, 1PH, 3W

CCT#	DESCRIPTION	BREAKER SIZE	WIRE SIZE	CCT#	DESCRIPTION	BREAKER SIZE	WIRE SIZE
1	UNIT HEATER UH-4	30A	#10	2	VFD 1 - WELL PUMP 1	15A	#12
3	ONIT REATER OR-4	30A	#10	4	VPD 1 - WELL POWIP 1	ISA	#12
5	HEAT TRACE HT-5	30A	#10	6	VFD 1 - WELL PUMP 2	15A	#12
7	THEAT TRACE HT-5	30A	#10	8	VFD 1 - WELL POWIP 2	IDA	#12
9	EXHAUST FAN EF-2	15A	#12	10			
11	INTERIOR LIGHTS	15A	#12	12			
13	EXTERIOR LIGHTS	15A	#12	14			
15	RECEPTACLES	15A	#12	16			
17				18			
19				20			



SEALED BY



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FLEGRAC

Telephone: (204) 255-4 Facsimile: (204) 255-76 E-mail: info@joreyelect **Engineering Consultants**

6-1375 Niakwa Road E. Winnipeg, Manitoba Canada, R2J 3T3

СНЕСКЕВ ВУ **ЈЈВ**

DRAWN E LCB

SCALE AS SHOWN

LOCATION NORWAY HOUSE, MB DATE 23 JAN 2018

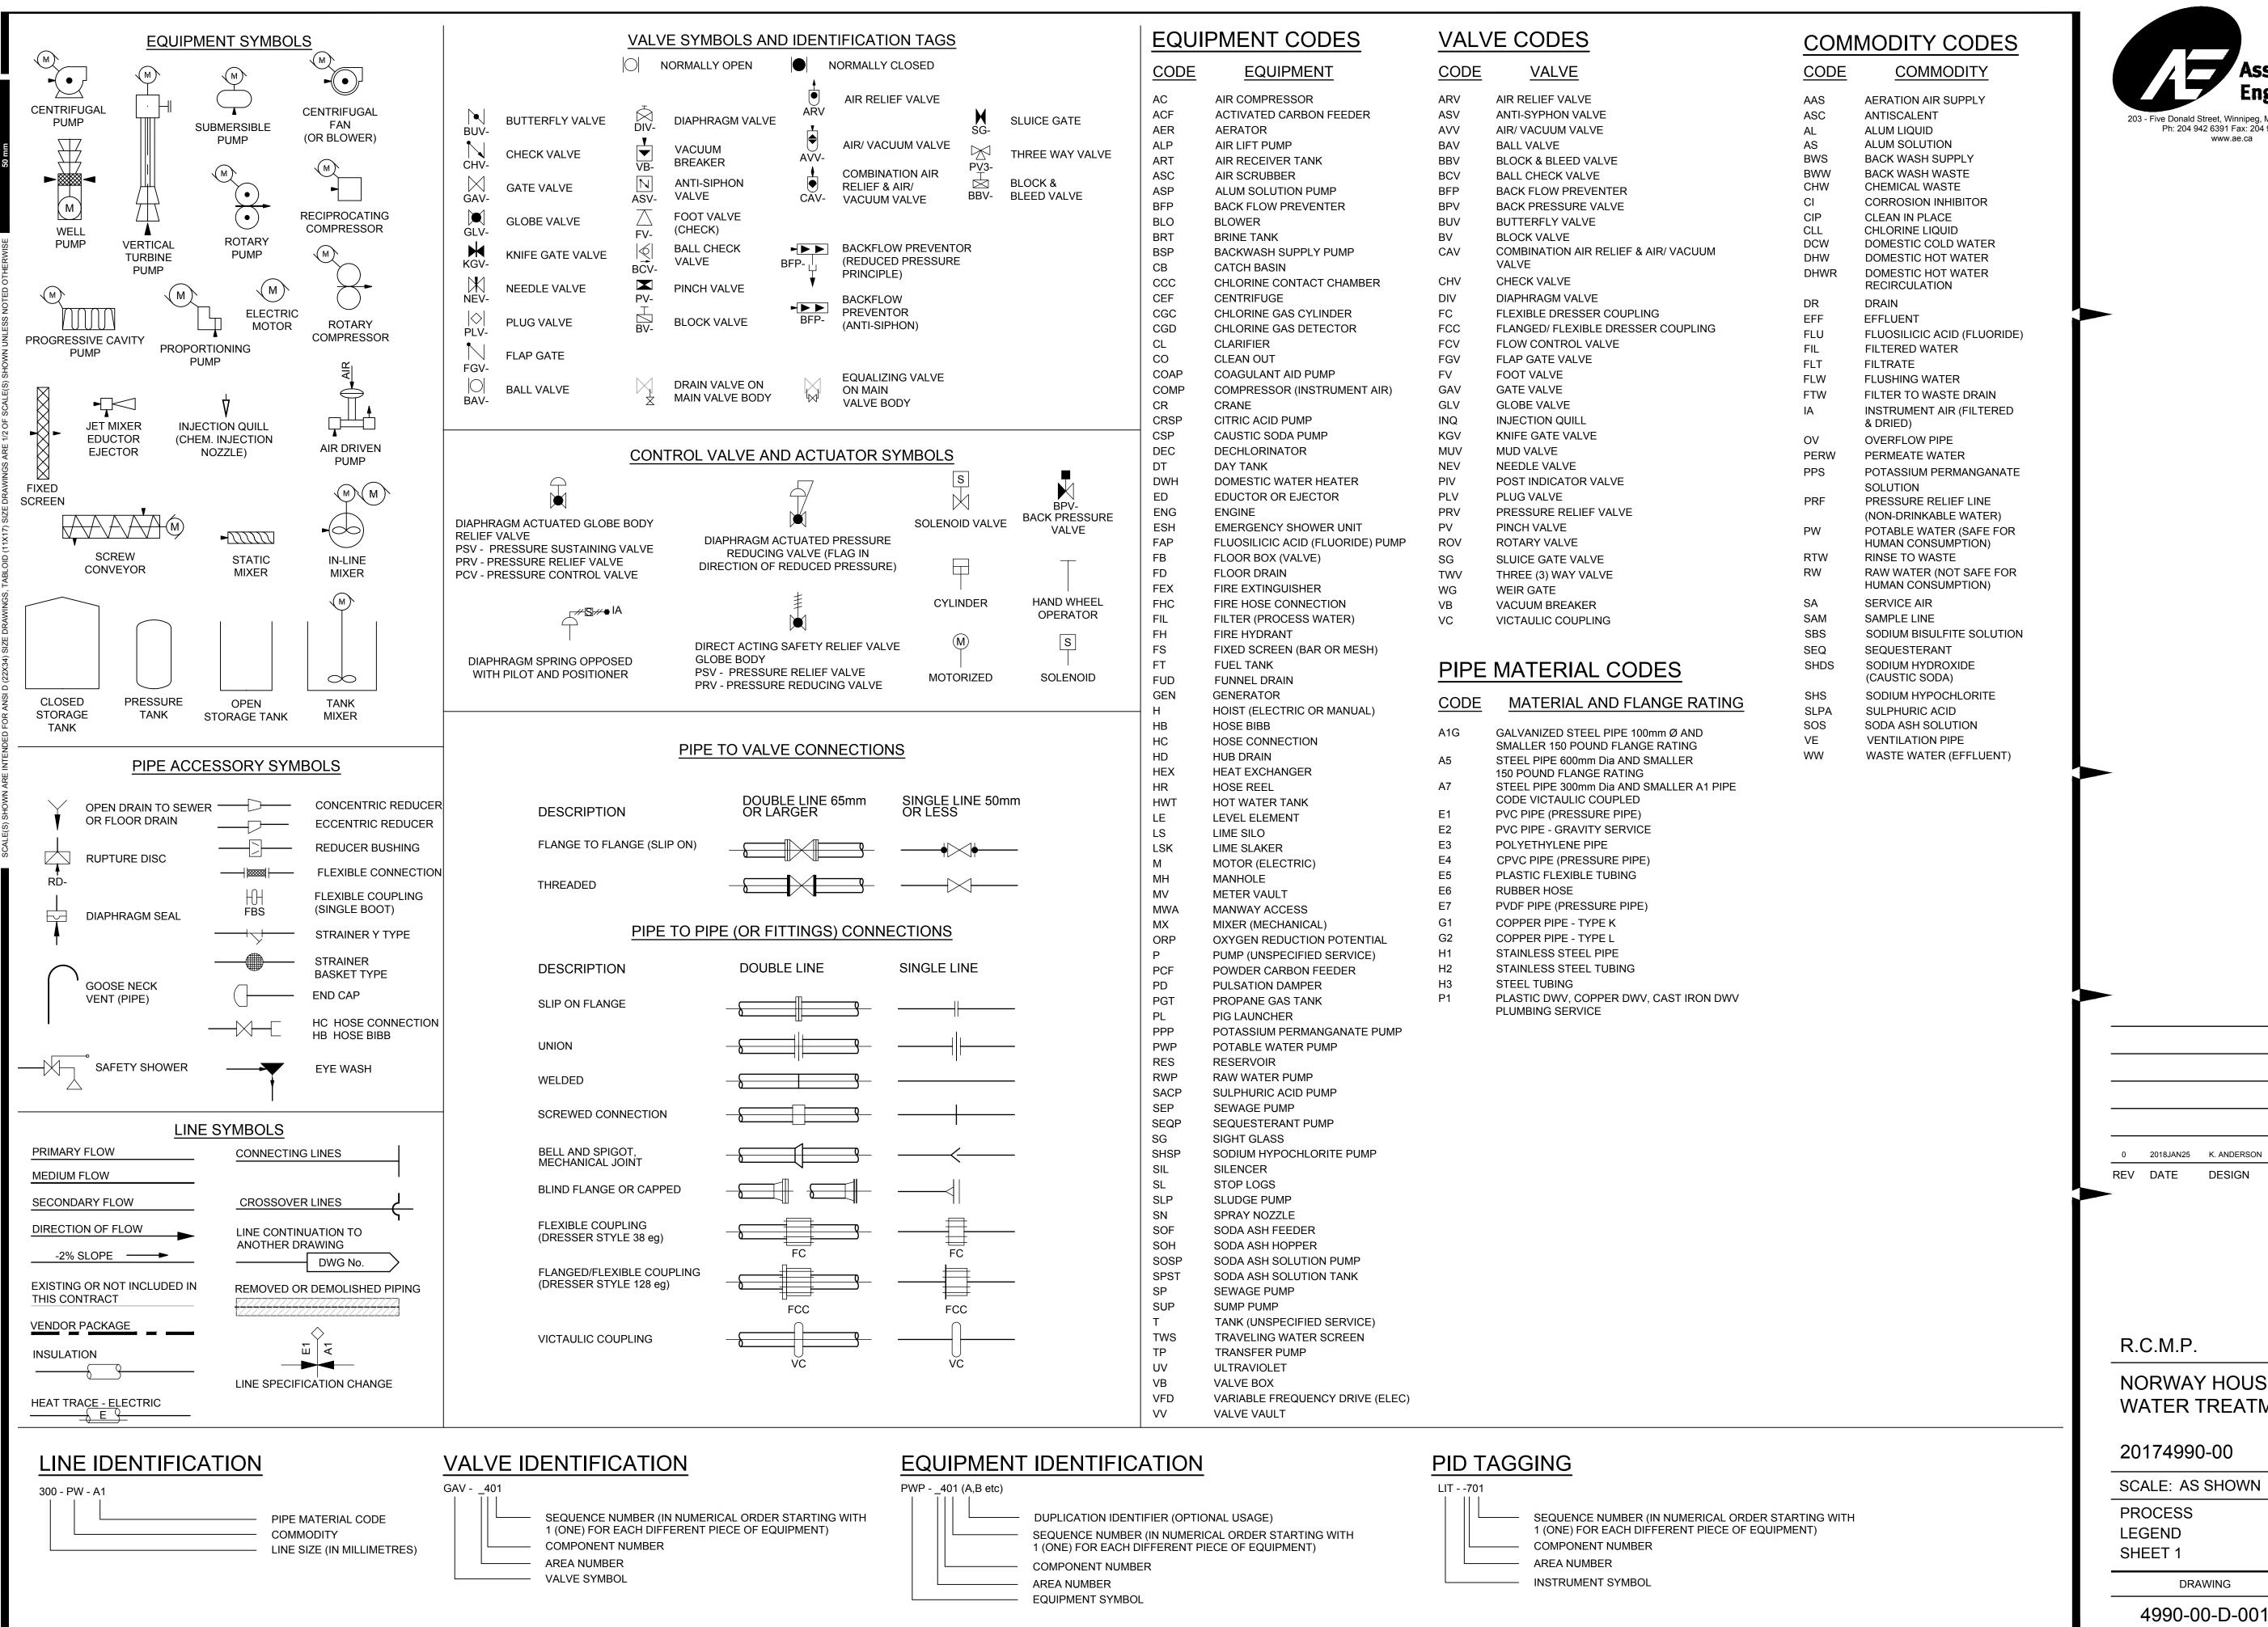
CONSTRUCTION

SHEET TITLE
PANEL SCHEUDLES

PROJECT TITLE NORWAY HOUSE WATER TREATMENT PLANT

REVISION NO. 0 17-053

ISSUED FOR TENDER



Associated 203 - Five Donald Street, Winnipeg, Manitoba, R3L 2T4 Ph: 204 942 6391 Fax: 204 942 6399

2018JAN25 K. ANDERSON C. REESE DESIGN

DRAWN

ISSUED FOR TENDER

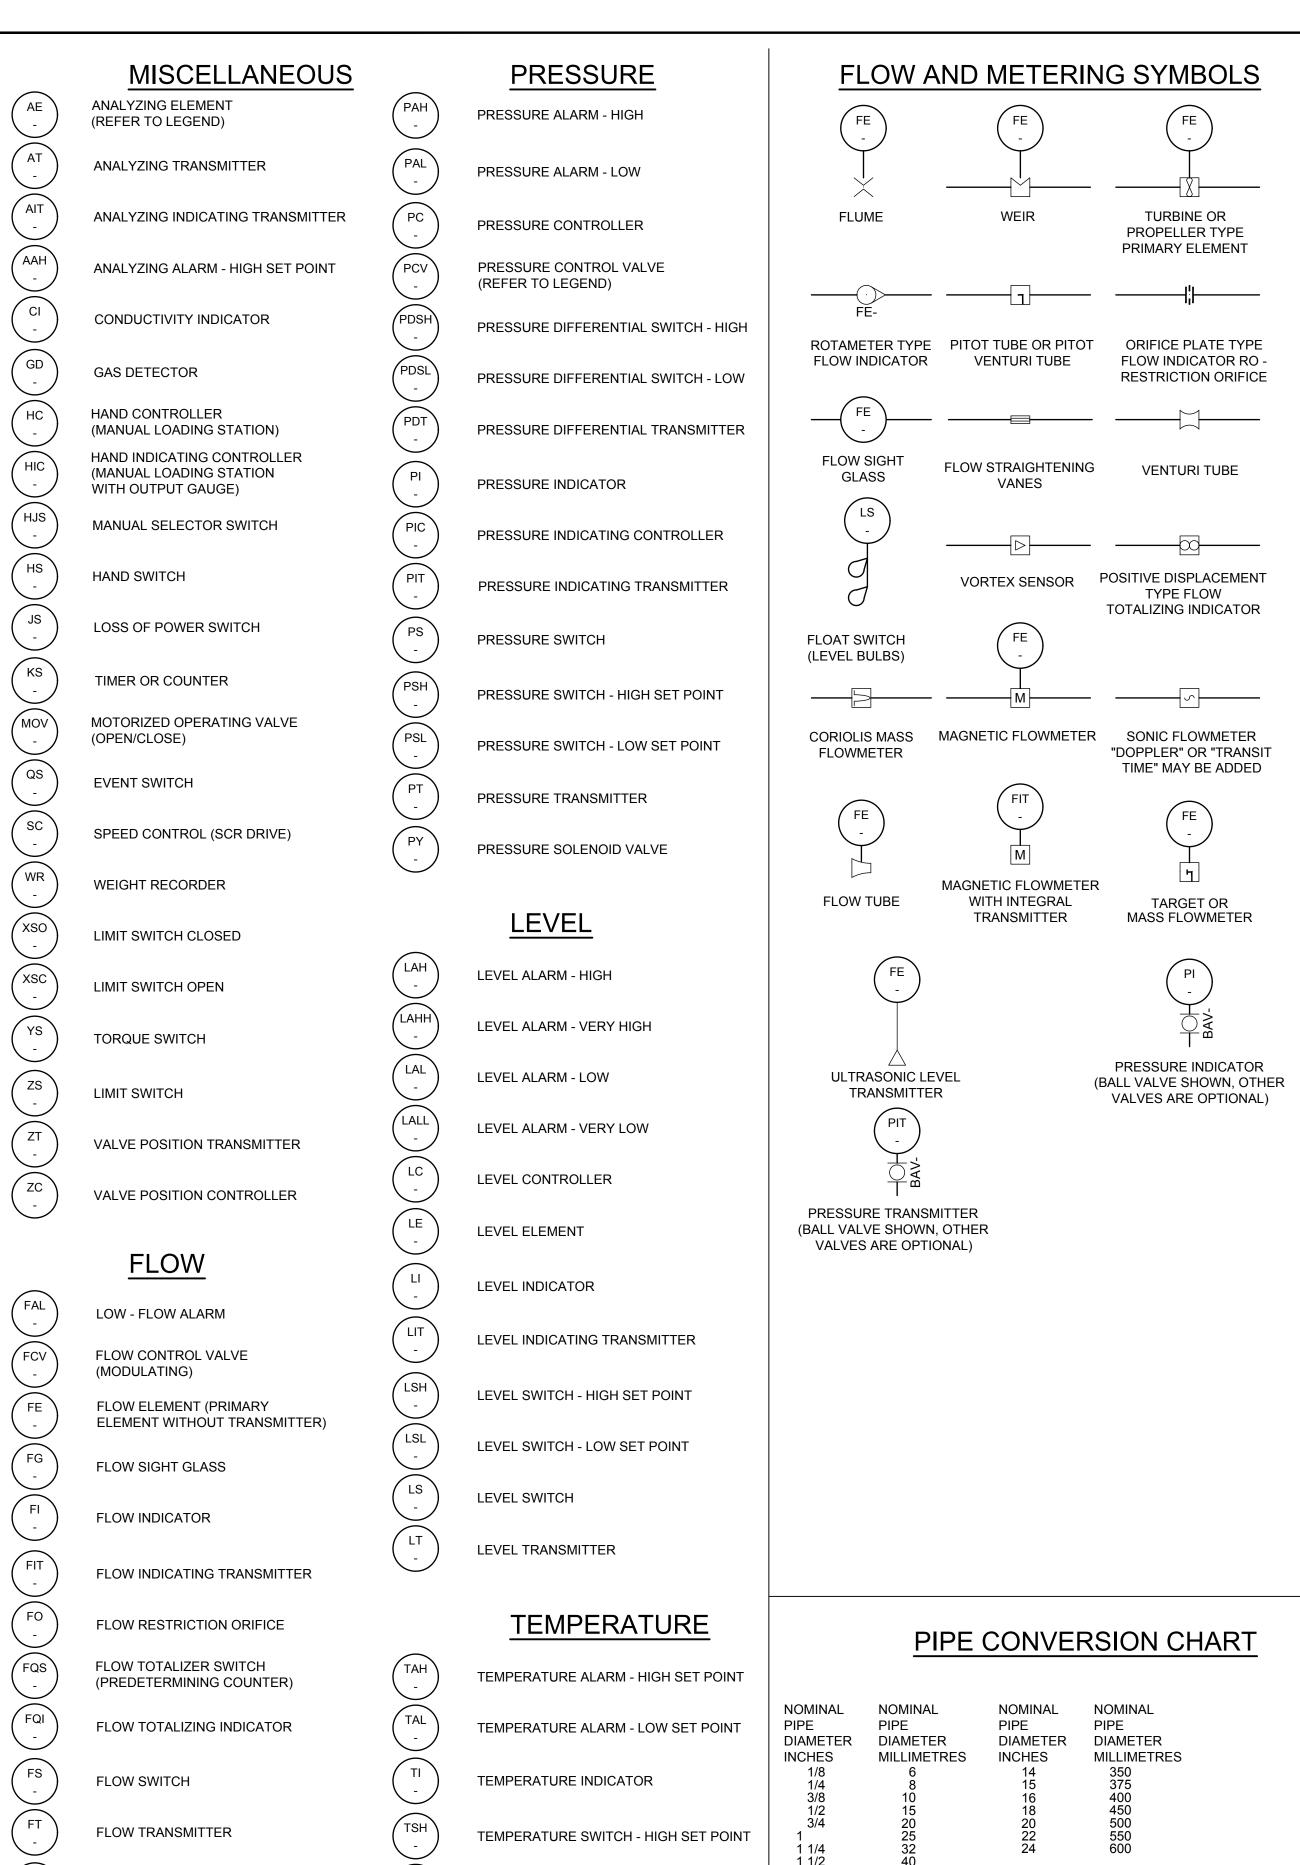
DESCRIPTION

NORWAY HOUSE DETACHMENT WATER TREATMENT PLANT

SCALE: AS SHOWN

DRAWING REVISION SHEET

D0.1 XX




TEMPERATURE SWITCH - LOW SET POINT

TEMPERATURE SWITCH

TEMPERATURE TRANSMITTER

2 1/2

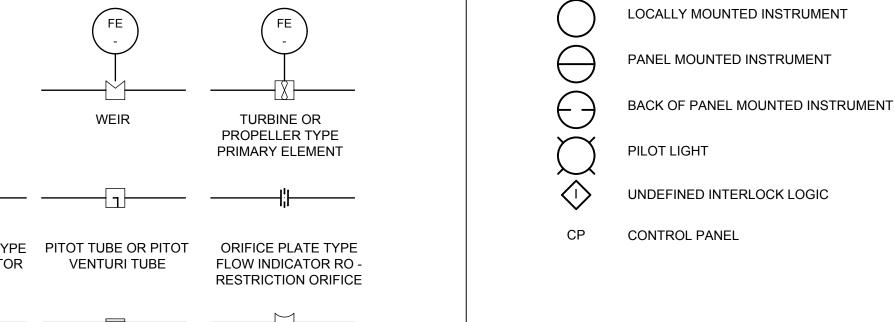3 1/2



NOTE: PIPE SIZE FROM 2" THROUGH TO 60" - CONVERSION

STANDARD OTHER PIPE SIZES ARE U.S. CONVERSIONS TO

BASED ON CSA STANDARD Z245.1 PIPE SIZE 2" AND

SMALLER - CONVERSION BASED ON EUROPEAN ISO

THE METRIC SYSTEM

200 250 300

ANALYZING ELEMENT / ALARM LEGEND

CHLORINE CON CONDUCTIVITY DO DISSOLVED OXYGEN ETC TUR TURBIDITY

PLC EQUIPMENT OPERATIONS STATUS LEGEND

HAND SWITCH POSITION INDICATION SC SPEED CONTROL ΧI

XA TRIP /UNDEFINED ALARM START/STOP VALVE POSITION INDICATION

PRESSURE CONTROL VALVE LEGEND

VALVE POSITION CONTROL

REDUCING RATE OF FLOW RELIEVING SURGE ANTICIPATING SUSTAINING VACUUM RELIEF

PROGRAMMABLE LOGIC CONTROL TAG IDENTIFICATION

PLC EQUIPMENT OPERATIONS STATUS TAG → SEQUENCE NUMBER

> PLC TAG NUMBER EXAMPLE XI-RWP-3401

	PRIMARY LOCATION ***NORMALLY ACCESSIBLE TO OPERATOR	FIELD MOUNTED	AUXILIARY LOCATION ***NORMALLY ACCESSIBLE TO OPERATOR		
DISCRETE INSTRUMENTS	1. * IP1**	2.	3.		
SHARED DISPLAY SHARED CONTROL	4.	5.	6.		
COMPUTER FUNCTION	7.	8.	9.		
PROGRAMMABLE LOGIC CONTROL	10.	11.	12.		

* SYMBOL SIZE MAY VARY ACCORDING TO THE USER'S NEEDS AND THE TYPE OF DOCUMENT. A SUGGESTED SQUARE AND CIRCLE SIZE FOR LARGER DIAGRAMS IS SHOWN ABOVE. CONSISTENCY IS RECOMMENDED.

** ABBREVIATION OF THE USER'S CHOICE SUCH AS IPI (INSTRUMENT PANEL #1), IC2 (INSTRUMENT CONSOLE #2), CC3 (COMPUTER CONSOLE #3), ECT., MAY BE USED WHEN IT IS NECESSARY TO SPECIFY INSTRUMENT OR FUNCTION LOCATION. *** NORMALLY INACCESSIBLE OR BEHIND-THE-PANEL DEVICES OR FUNCTIONS MAY BE DEPICTED BY USING THE SAME SYMBOLS BUT WITH DASHED HORIZONTAL



CONNECTION TO PROCESS, MECHANICAL LINK, OR INSTRUMENT SUPPLY THE FOLLOWING ABBREVIATIONS DENOTE TYPES OF POWER SUPPLY AIR SUPPLY (PLANT AIR, HEADER SUPPLY REGULATED

eq ADJUSTED TO 552 kPa)

FILTERED AIR SUPPLY (REGULATED eg ADJUSTED TO 138 kPa)

ELECTRIC SUPPLY

1 PSI = 6.894 kPa

WATER SUPPLY

_____________PNEUMATIC SIGNAL **

UNDEFINED SIGNAL

ELECTRICAL CONTROL SIGNAL

DEVICENET ETHERNET

---- <> ---- FIELDBUS (FF)

MODBUS — XX —

HYDRAULIC SIGNAL CAPILLARY TUBING (FILLED SYSTEM)

ELECTROMAGNETIC OR SONIC SIGNAL *** (GUIDED) \sim \sim

MECHANICAL LINK

ELECTROMAGNETIC OR SONIC SIGNAL *** (NOT GUIDED) INTERNAL SYSTEM LINK (SOFTWARE OR DATA LINK)

OPTIONAL BINARY (ON-OFF) SYMBOLS

→ → → → PNEUMATIC BINARY SIGNAL - ELECTRIC BINARY SIGNAL

NOTE: `OR' MEANS USER'S CHOICE. CONSISTENCY IS RECOMMENDED. THE FOLLOWING ABBREVIATIONS ARE SUGGESTED TO DENOTE THE TYPES OF POWER SUPPLY. THESE DESIGNATIONS MAY ALSO BE APPLIED TO PURGE FLUID SUPPLIES.

AS - AIR SUPPLY IA - INSTRUMENT AIR PA - PLANT AIR ES - ELECTRICAL SUPPLY GS - GAS SUPPLY

├ OPTIONS

HS - HYDRAULIC SUPPLY NS - NITROGEN SUPPLY SS - STEAM SUPPLY WS - WATER SUPPLY

* THE SUPPLY LEVEL MAY BE ADDED TO THE INSTRUMENT SUPPLY LINE, E.G., AS-100, A 100-PSIG AIR SUPPLY; ES-24DC, A 24 VOLT DIRECT CURRENT POWER SUPPLY. ** THE PNEUMATIC SIGNAL SYMBOL APPLIES TO A SIGNAL USING ANY GAS AS THE MEDIUM. IF A GAS OTHER THAN AIR IS USED, THE GAS MAY BE IDENTIFIED BY A NOTE ON THE SIGNAL SYMBOL OR OTHERWISE.

*** ELECTROMAGNETIC PHENOMENA INCLUDE HEAT, RADIO WAVES, NUCLEAR RADIATION,



2018JAN25 K. ANDERSON C. REESE ISSUED FOR TENDER DESCRIPTION REV DATE

R.C.M.P.

NORWAY HOUSE DETACHMENT WATER TREATMENT PLANT

20174990-00

SCALE: AS SHOWN

PROCESS LEGEND SHEET 2

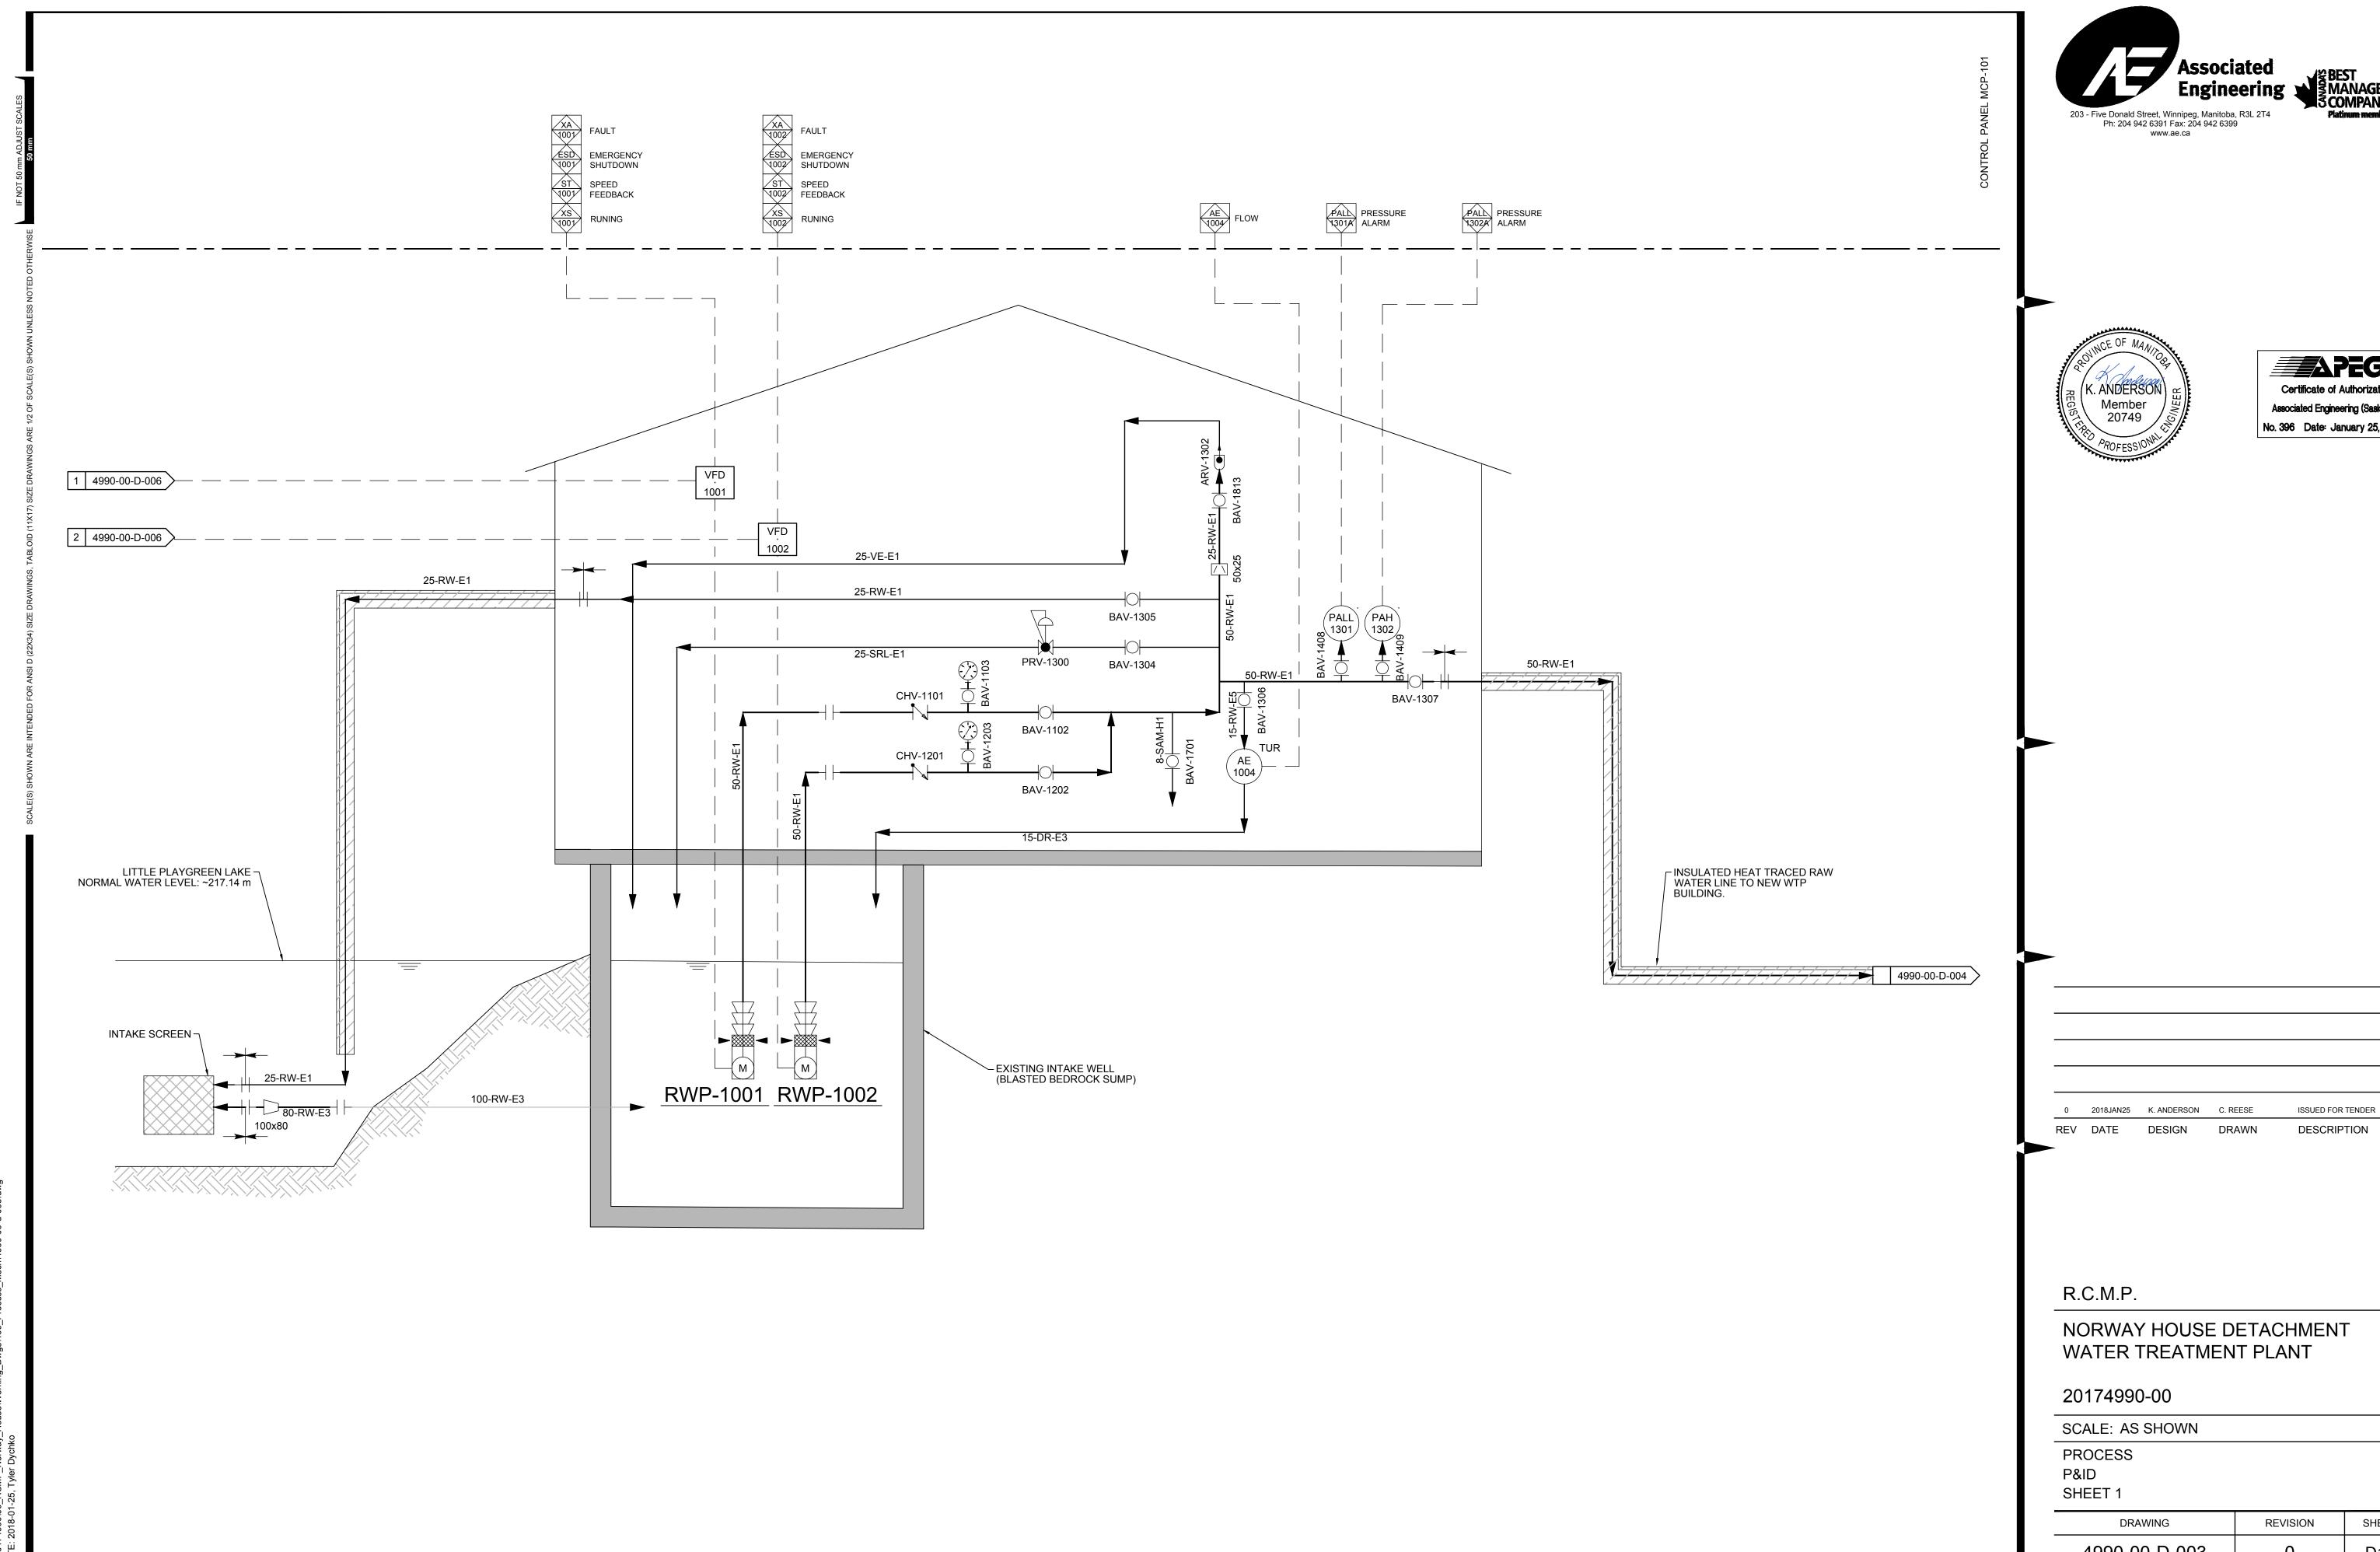
> DRAWING REVISION SHEET 4990-00-D-002 D.02

FLOW SOLENOID VALVE

INPUT / PNEUMATIC OUTPUT)


FLOW SIGNAL INTEGRATOR

FLOW SIGNAL CONVERTER (CURRENT



APEGIN Certificate of Authorization Associated Engineering (Sask.) Ltd. No. 396 Date: January 25, 2018

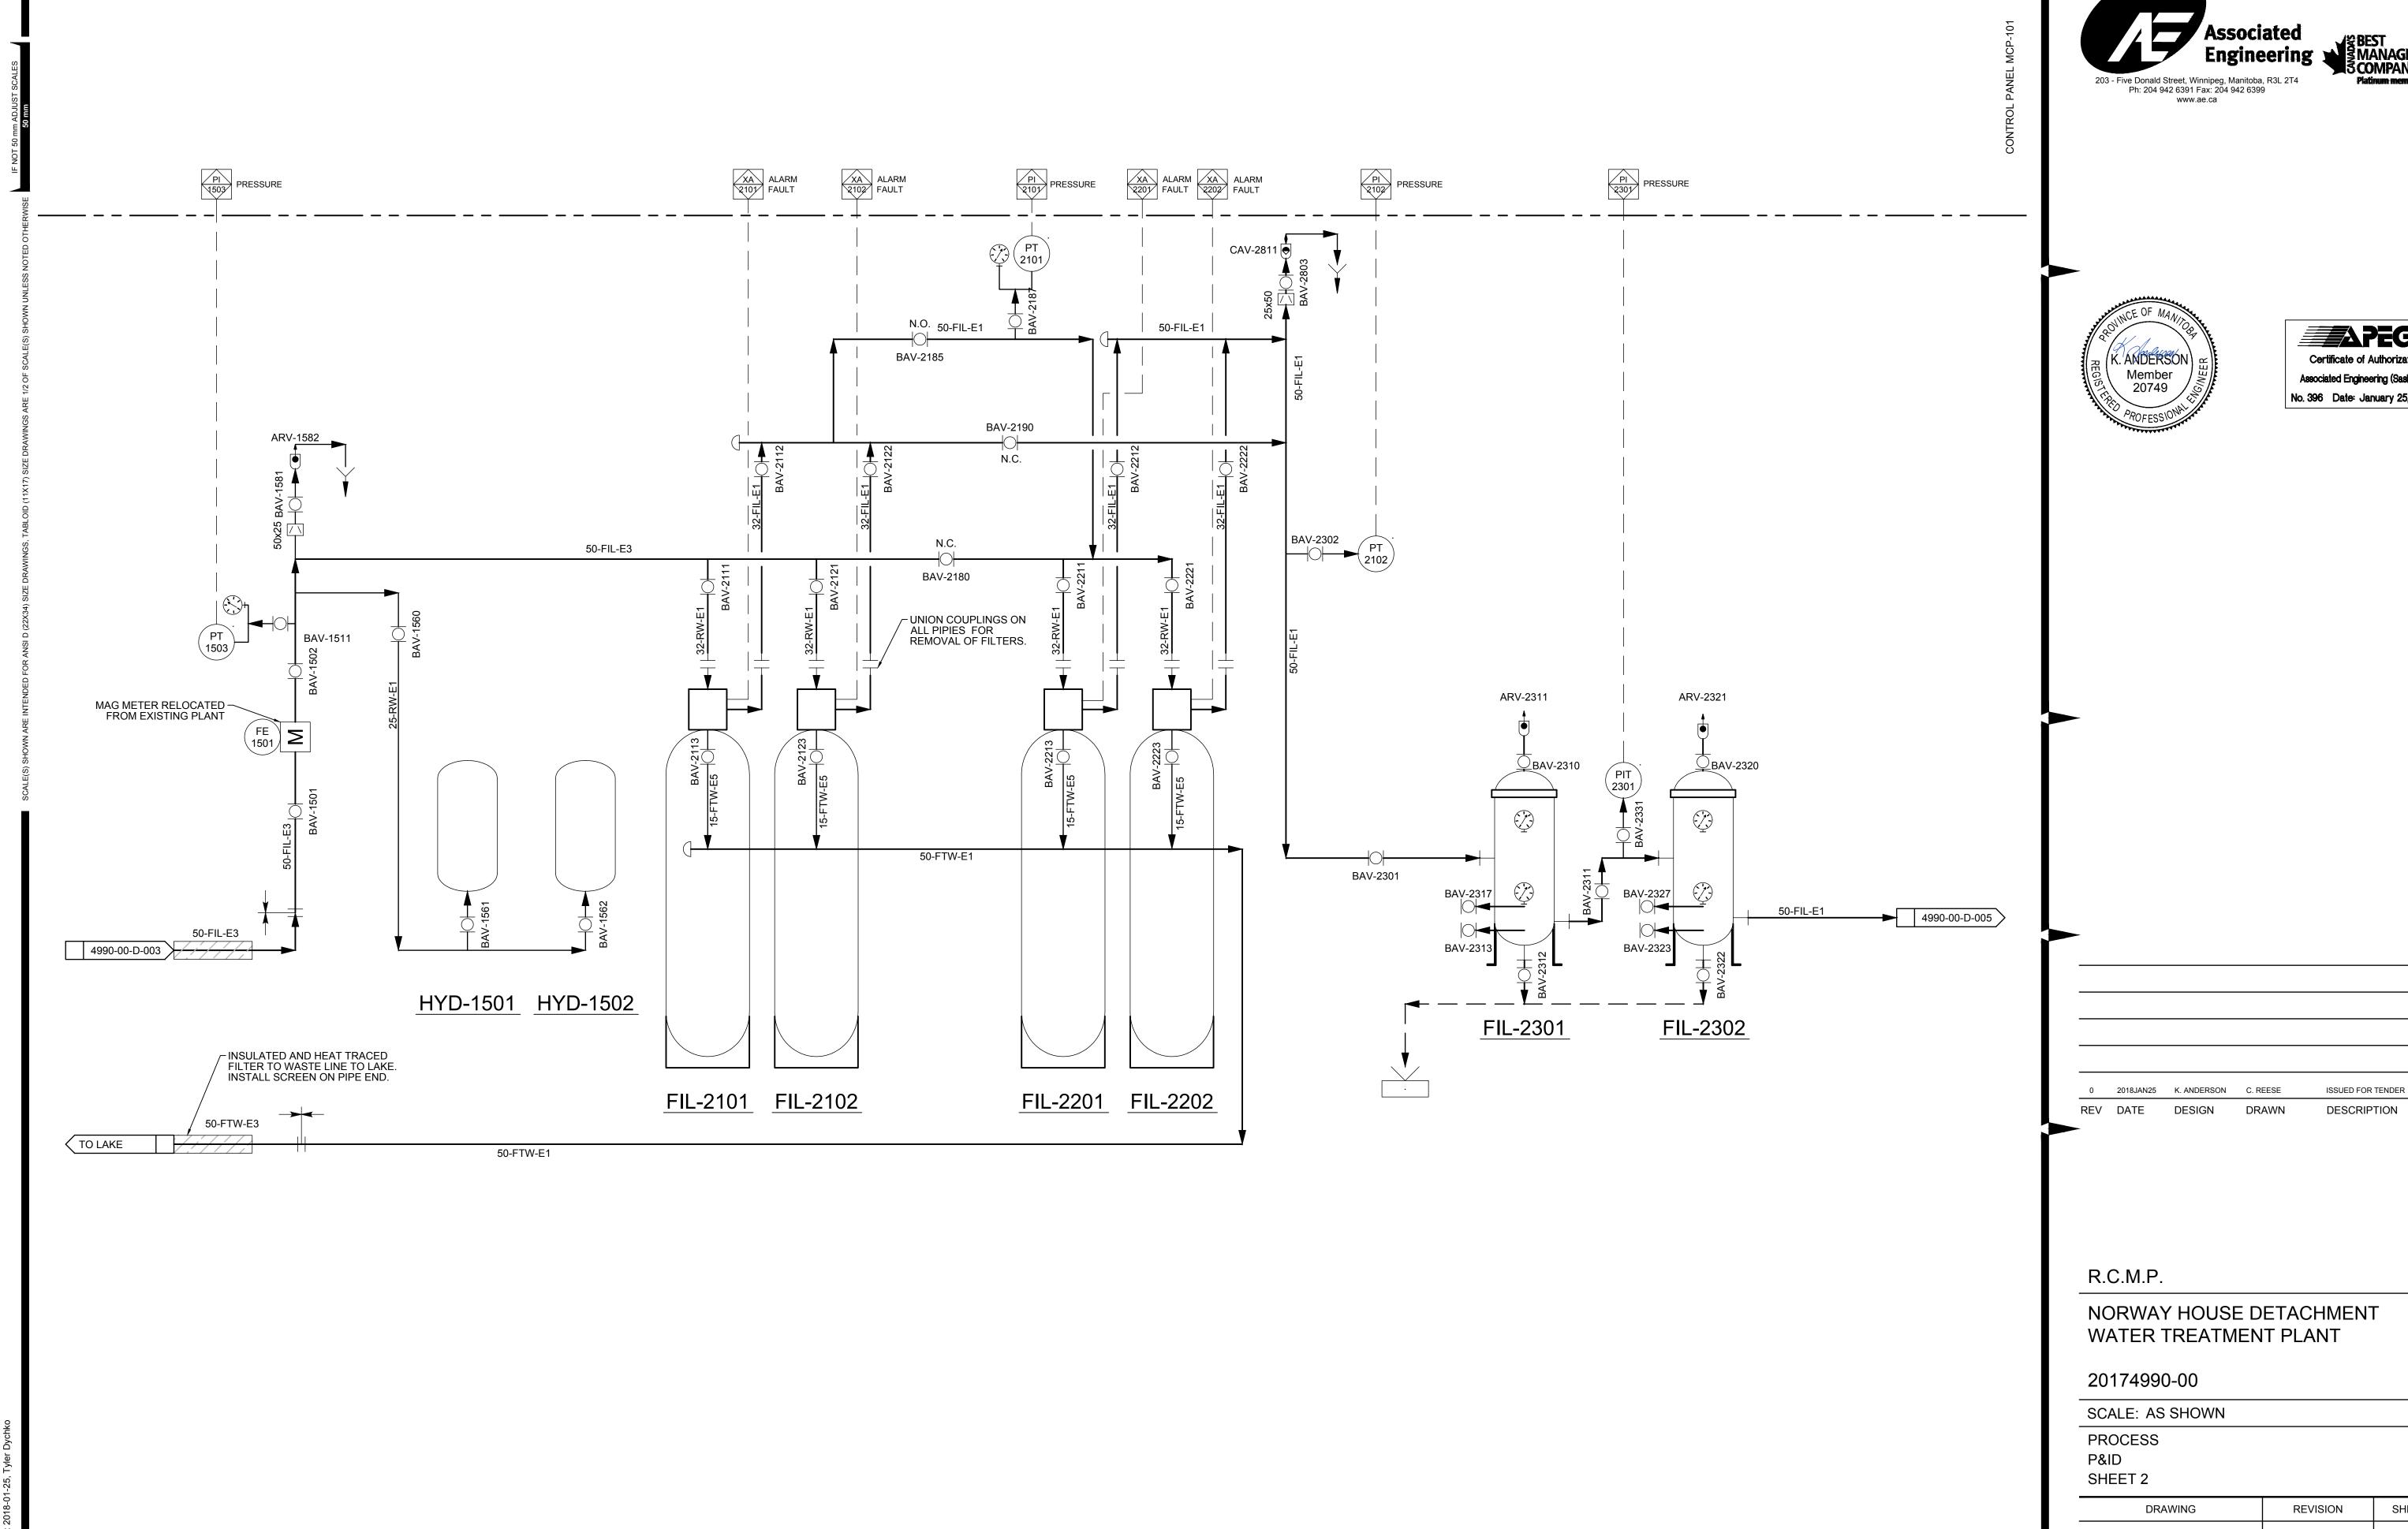SHEET 4990-00-D-003 D1.0






APEGIN Certificate of Authorization Associated Engineering (Sask.) Ltd. No. 396 Date: January 25, 2018


WATER TREATMENT PLANT

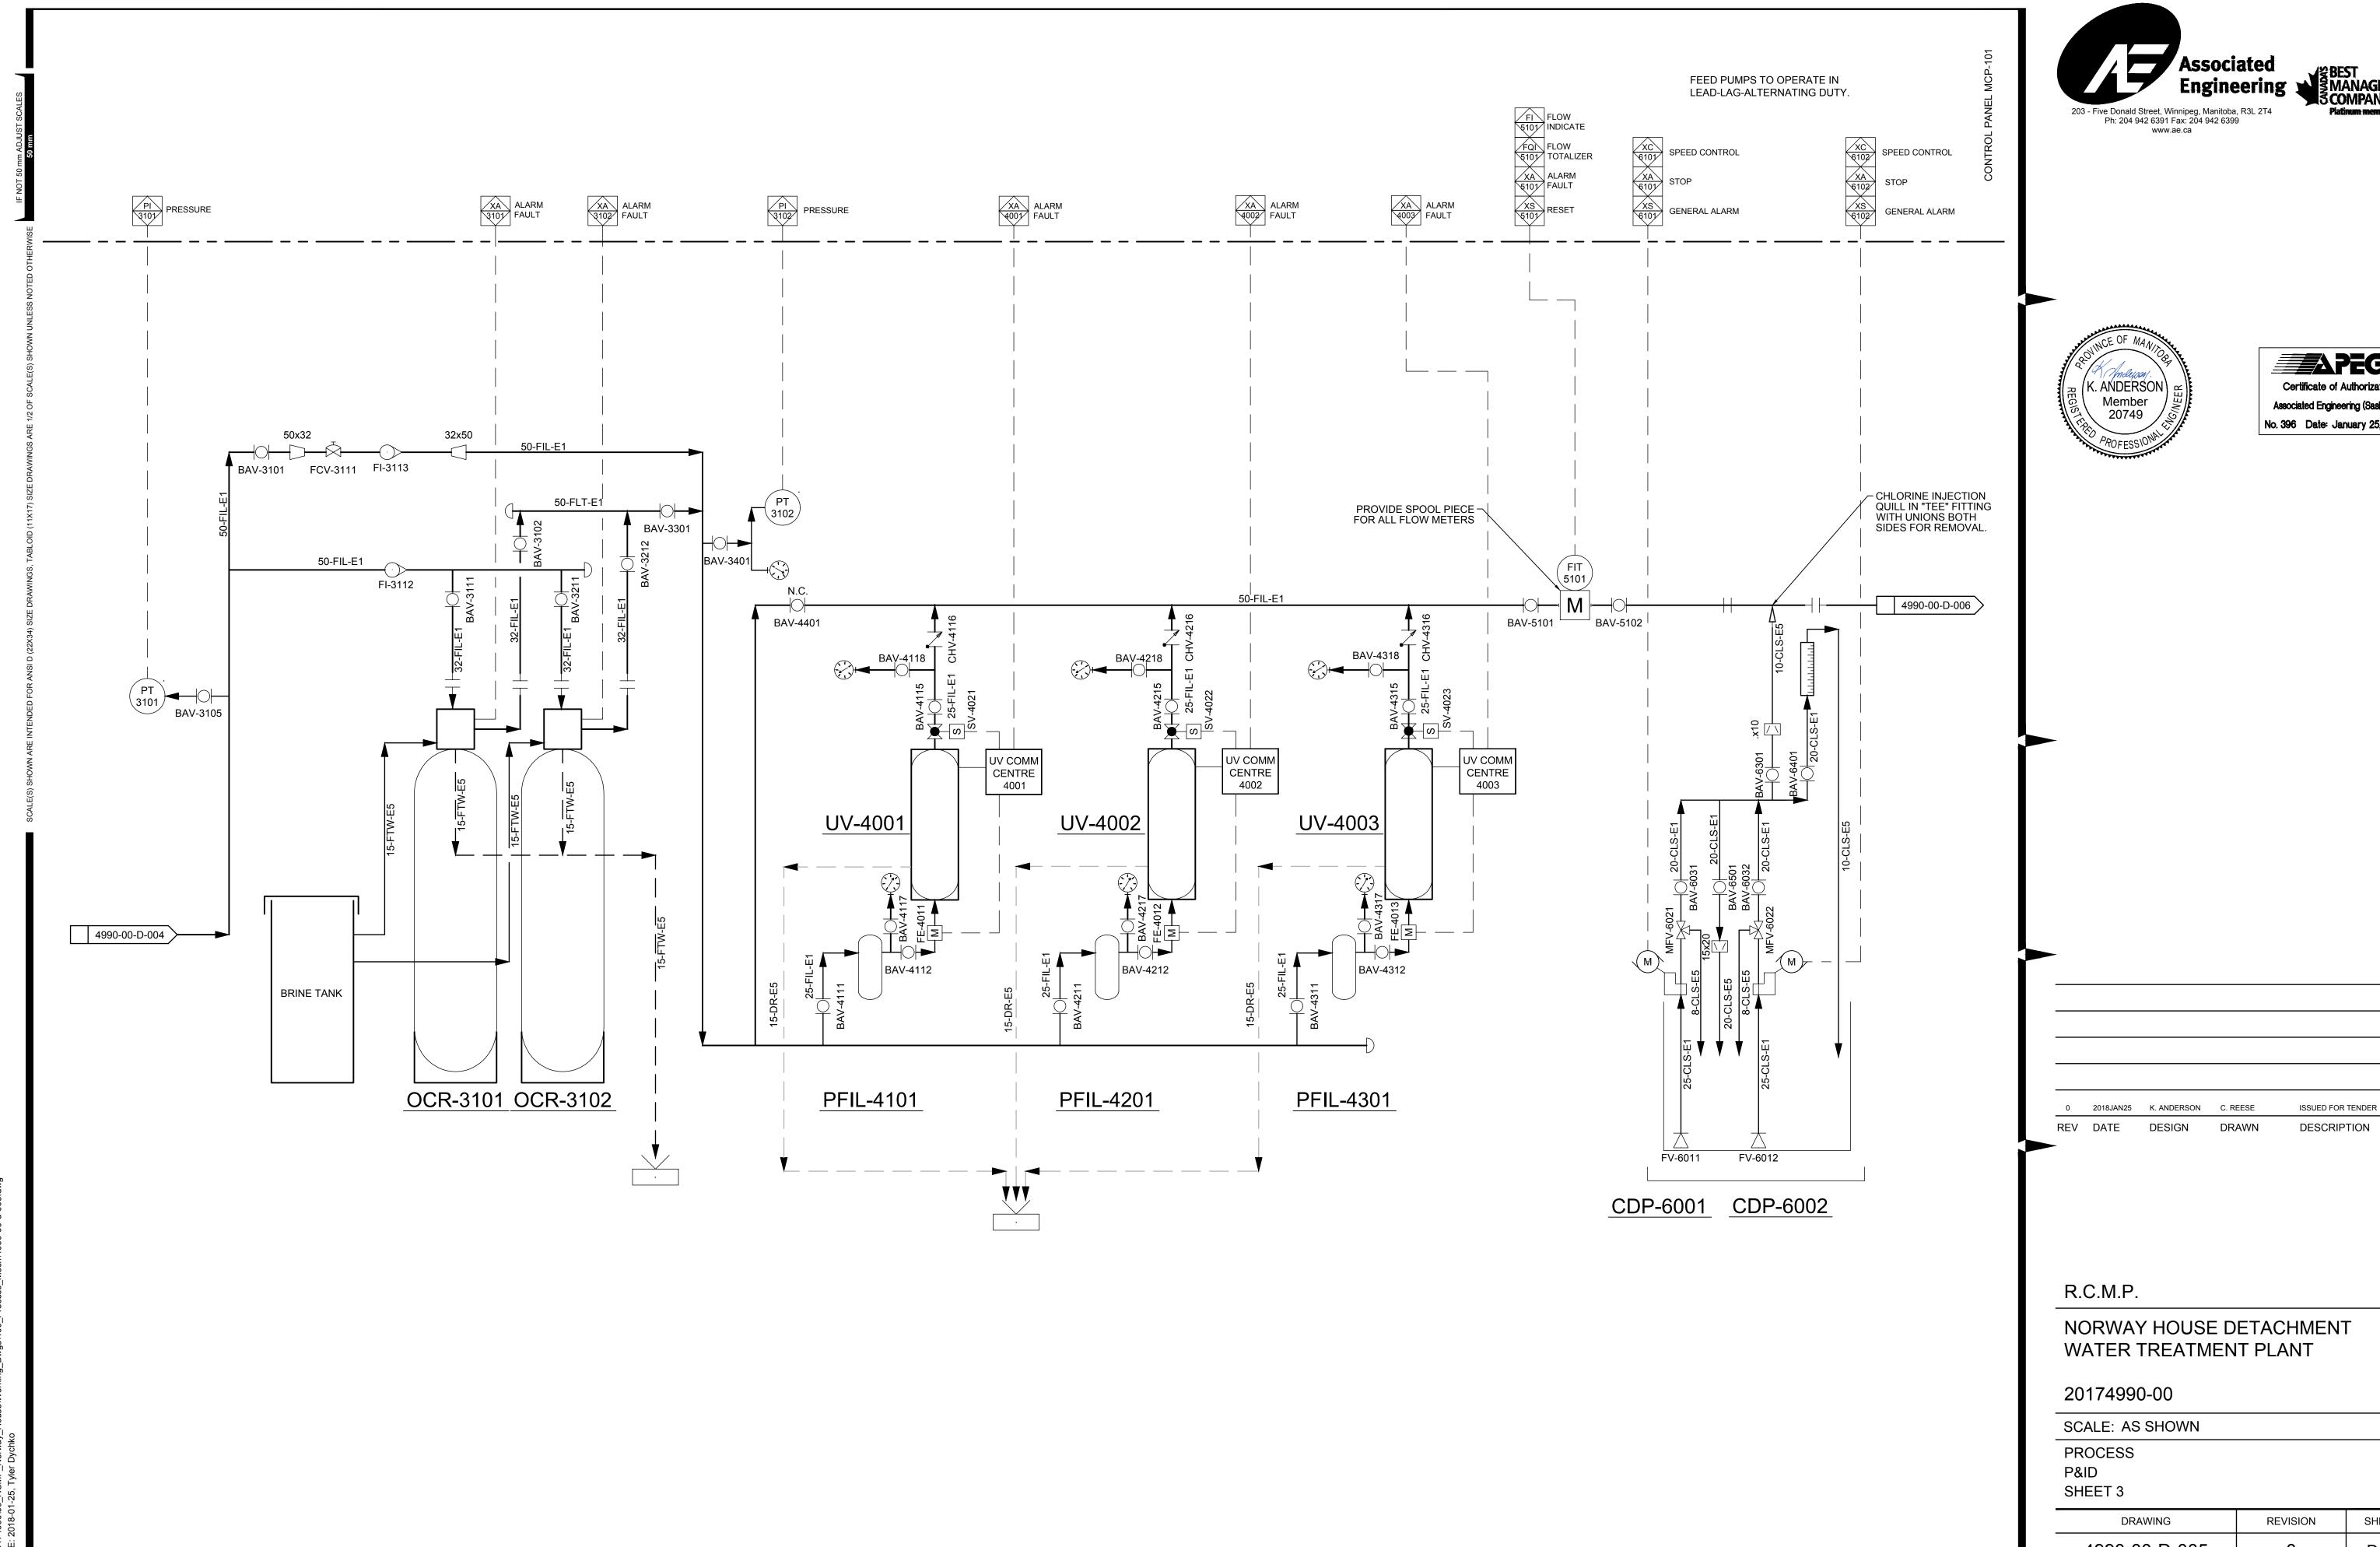SHEET REVISION 4990-00-D-004 D1.1





SHEET 4990-00-D-005 D1.2

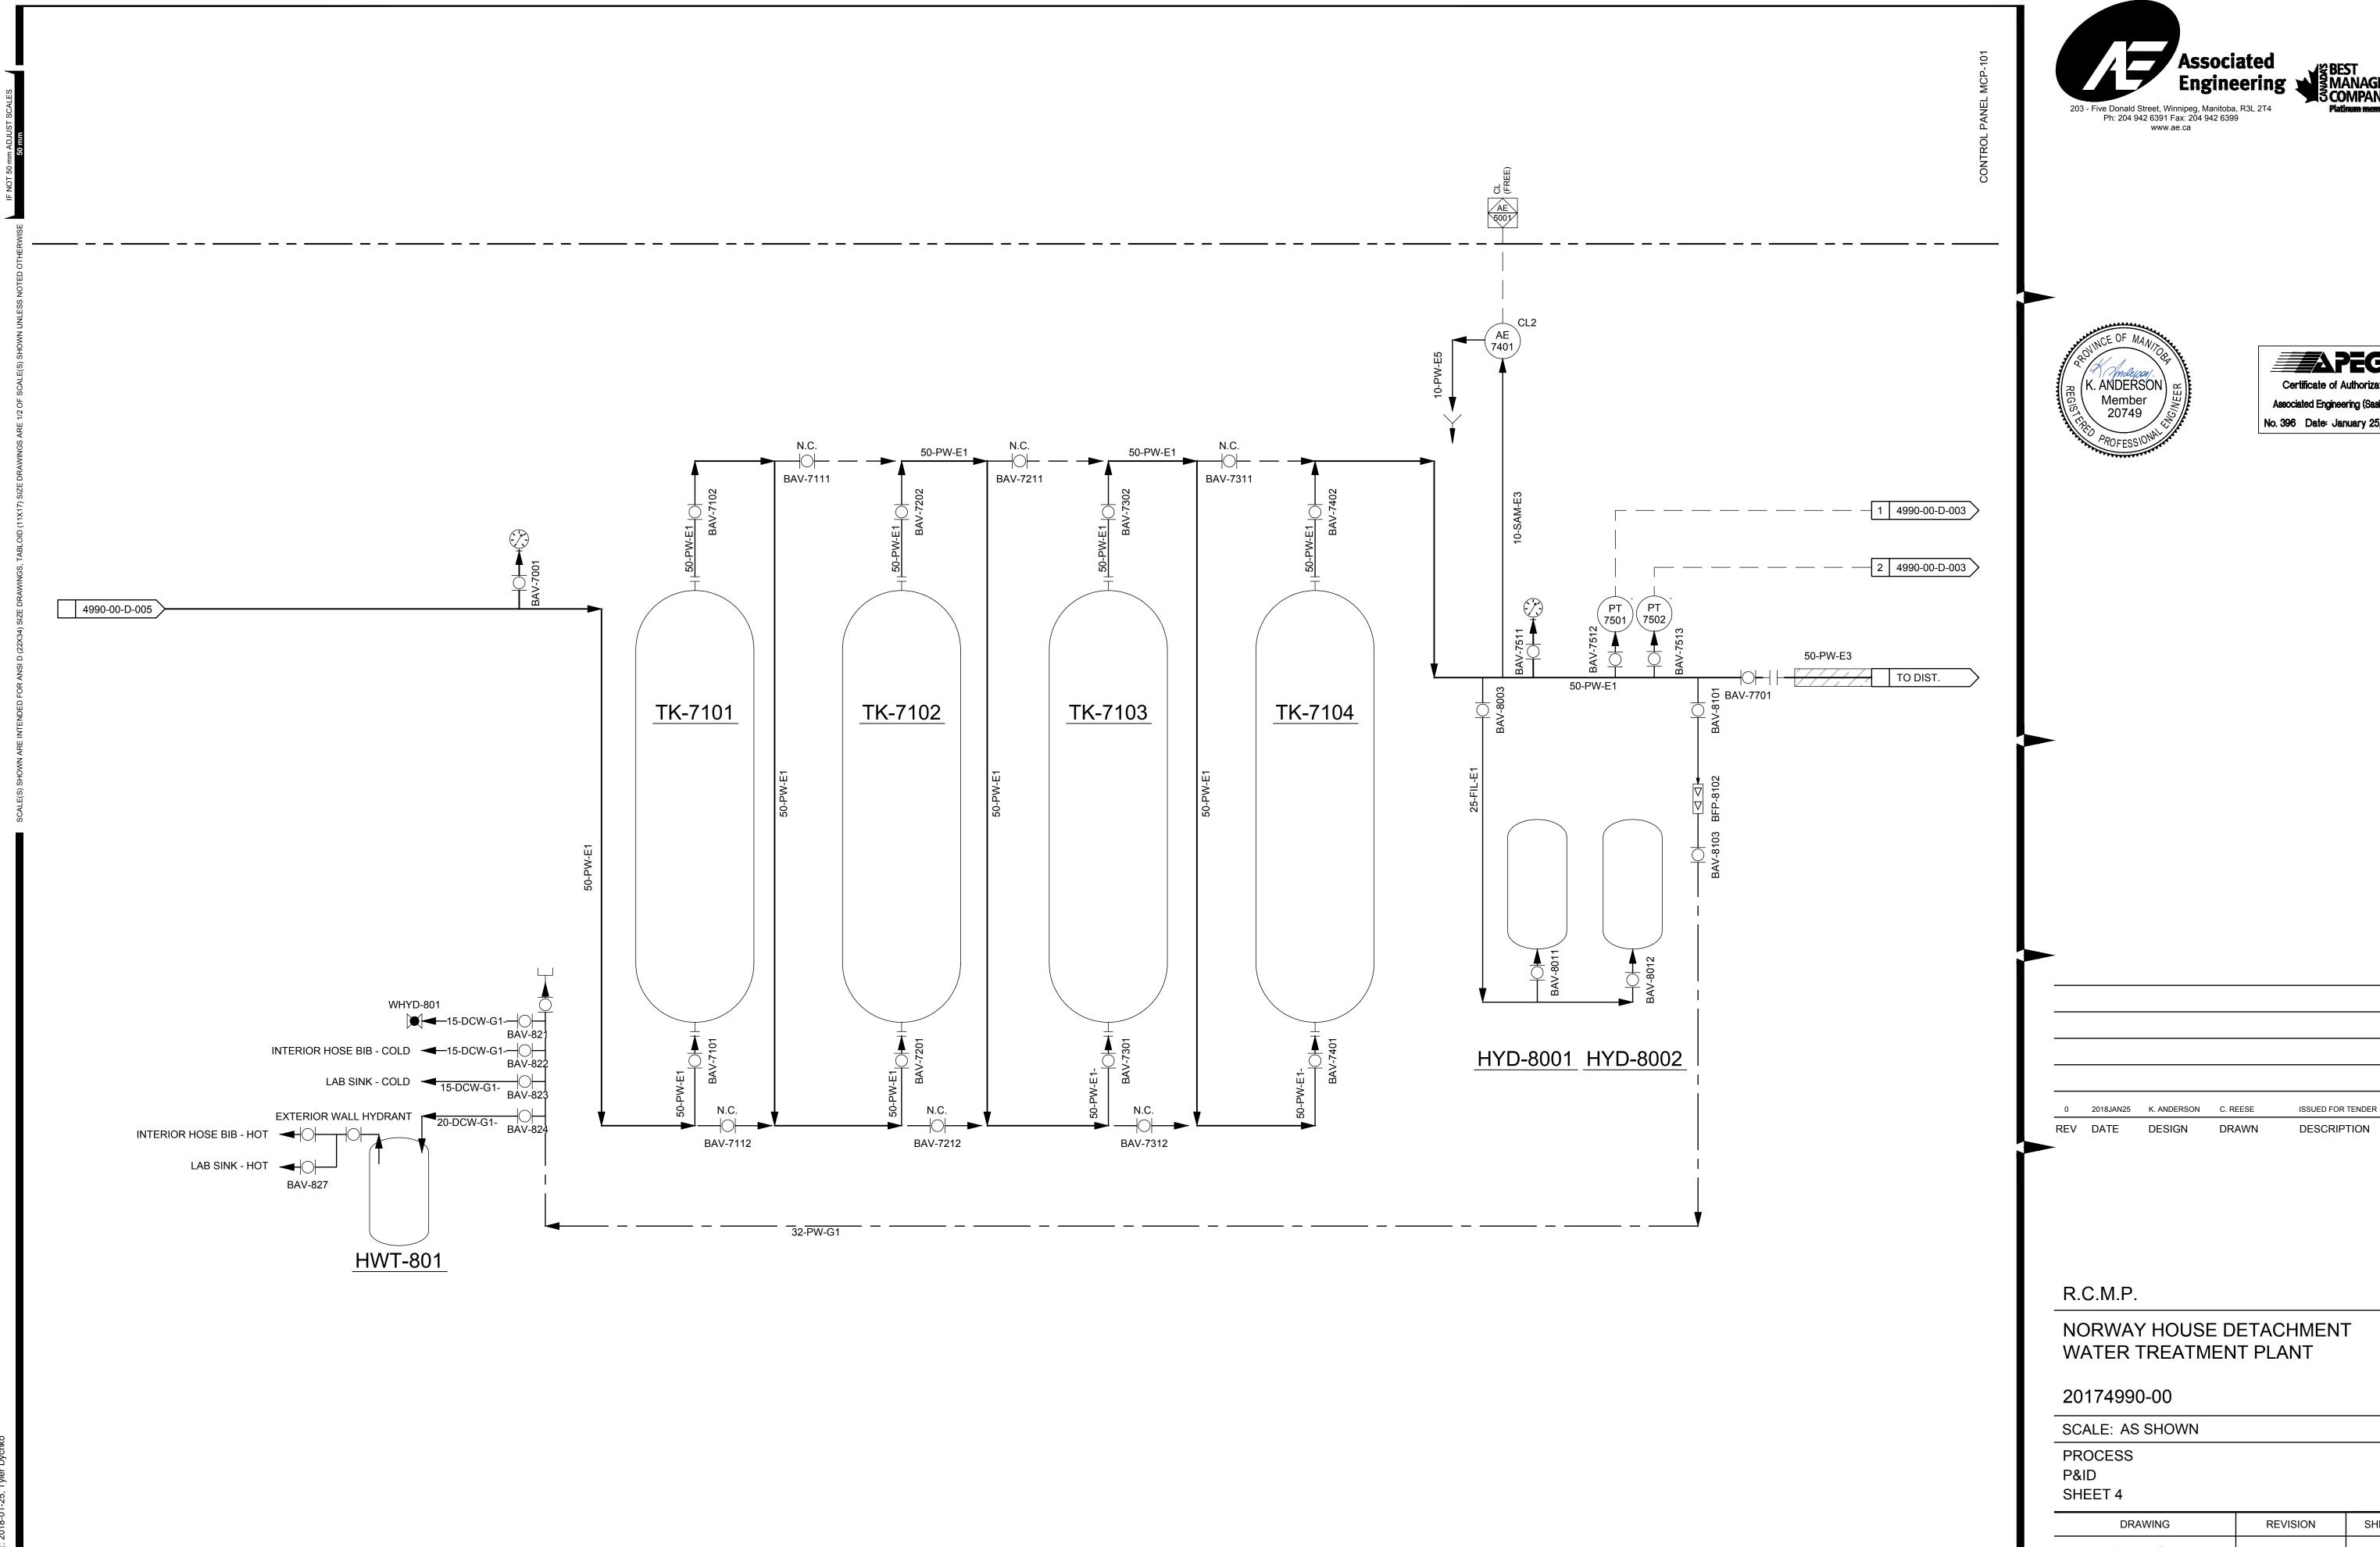






SHEET 4990-00-D-006 D1.3






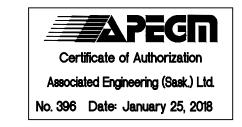

ISSUED FOR TENDER

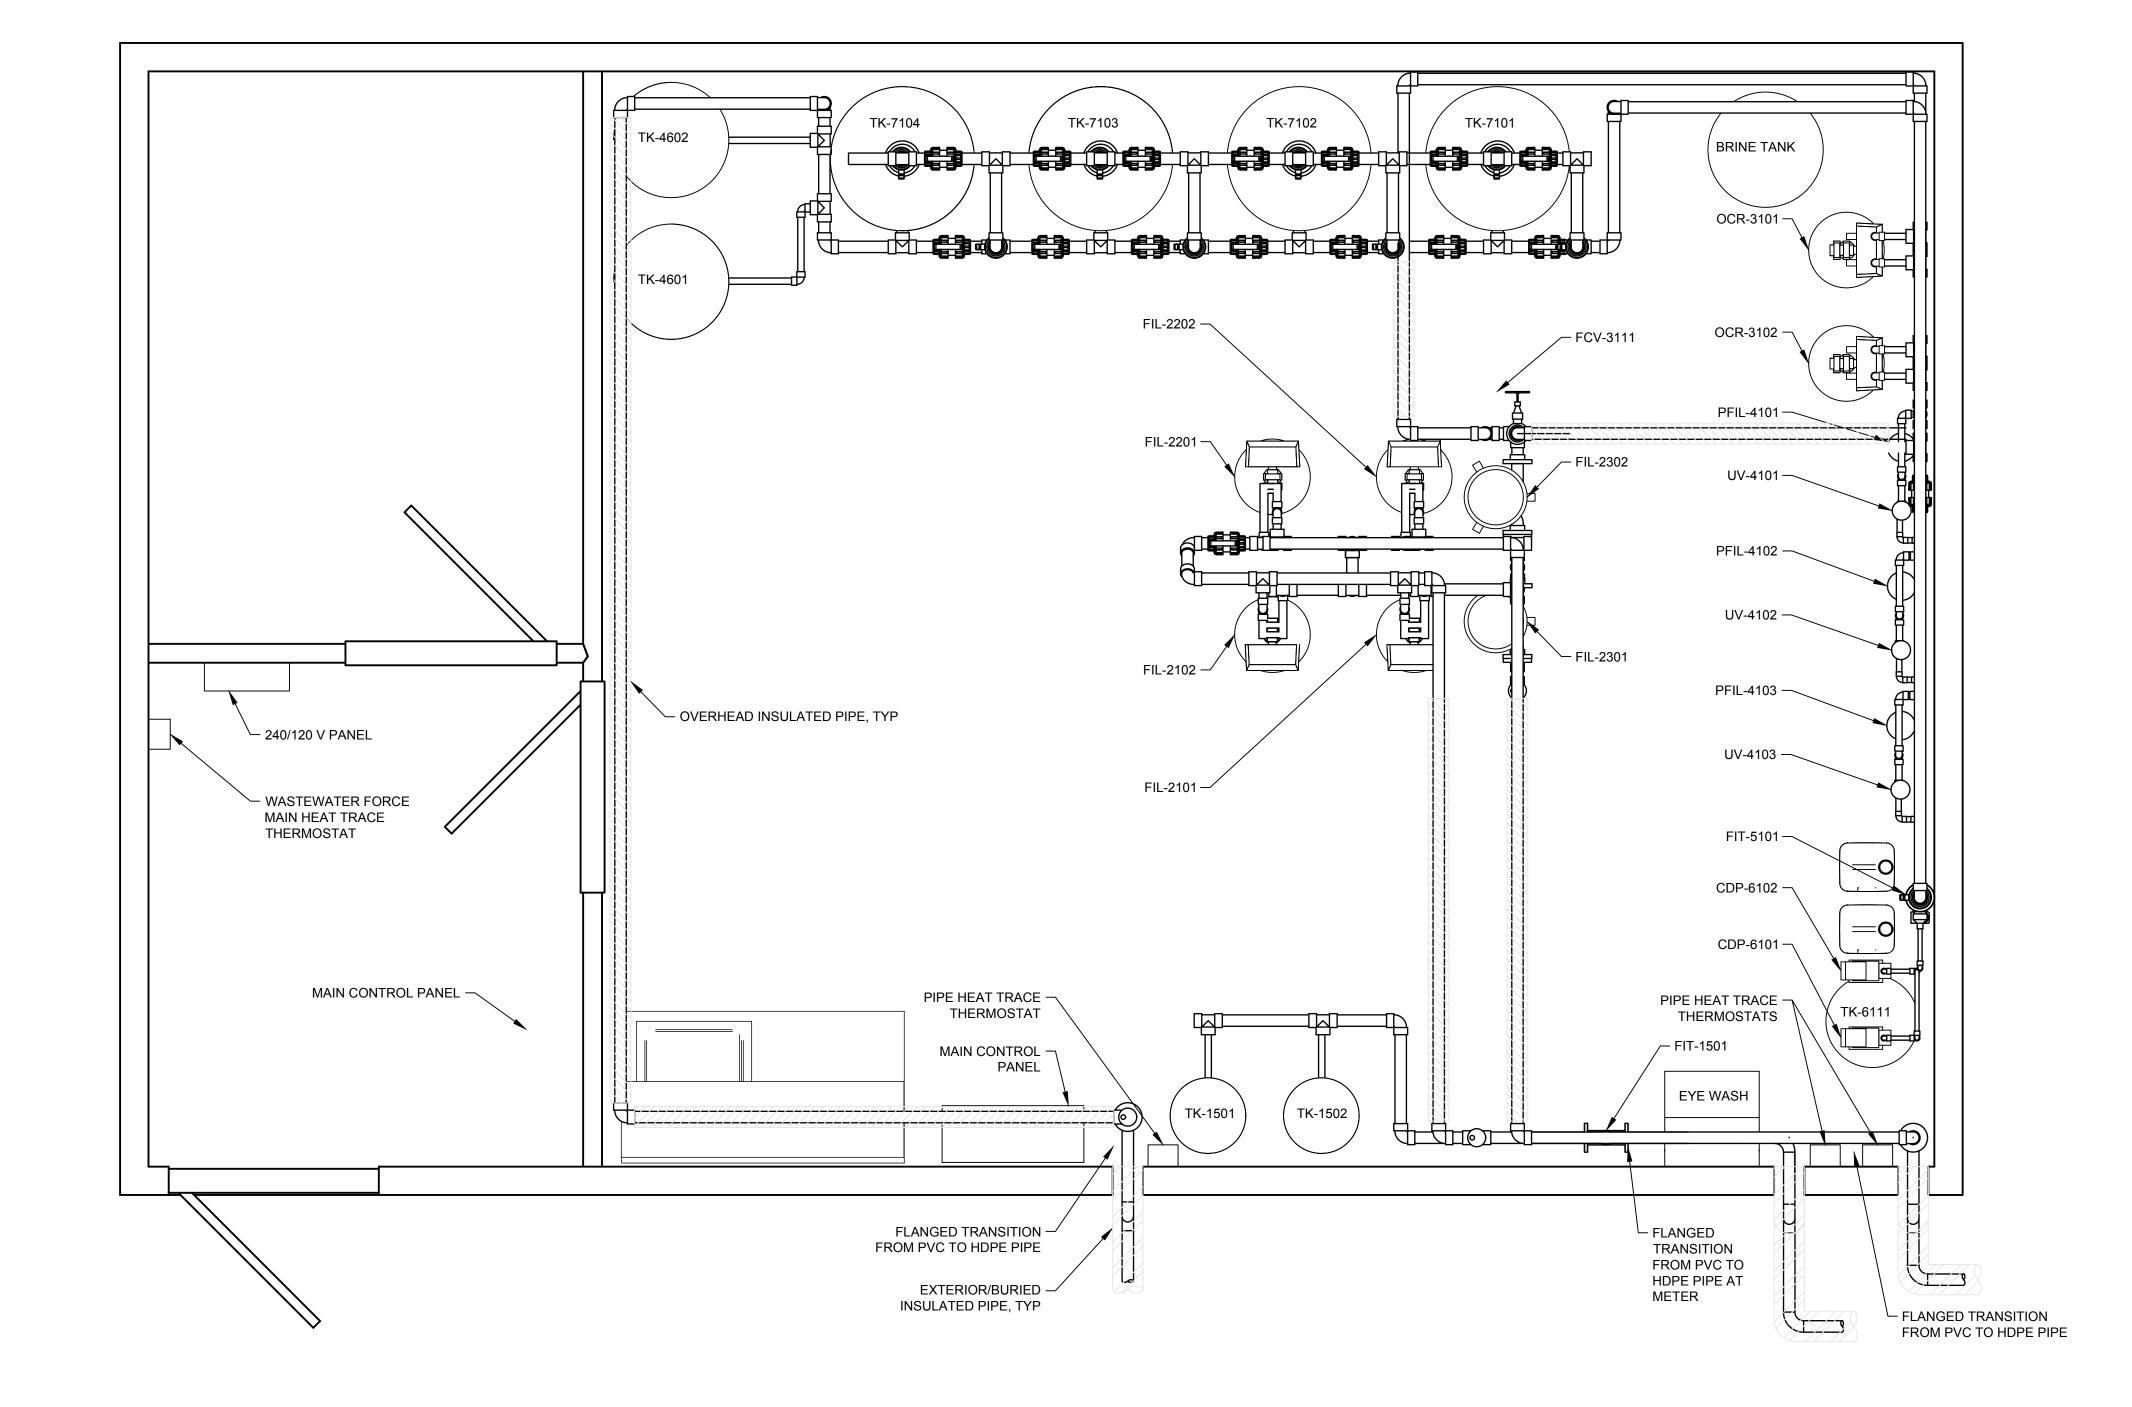DESCRIPTION



R.C.M.P.

NORWAY HOUSE DETACHMENT WATER TREATMENT PLANT

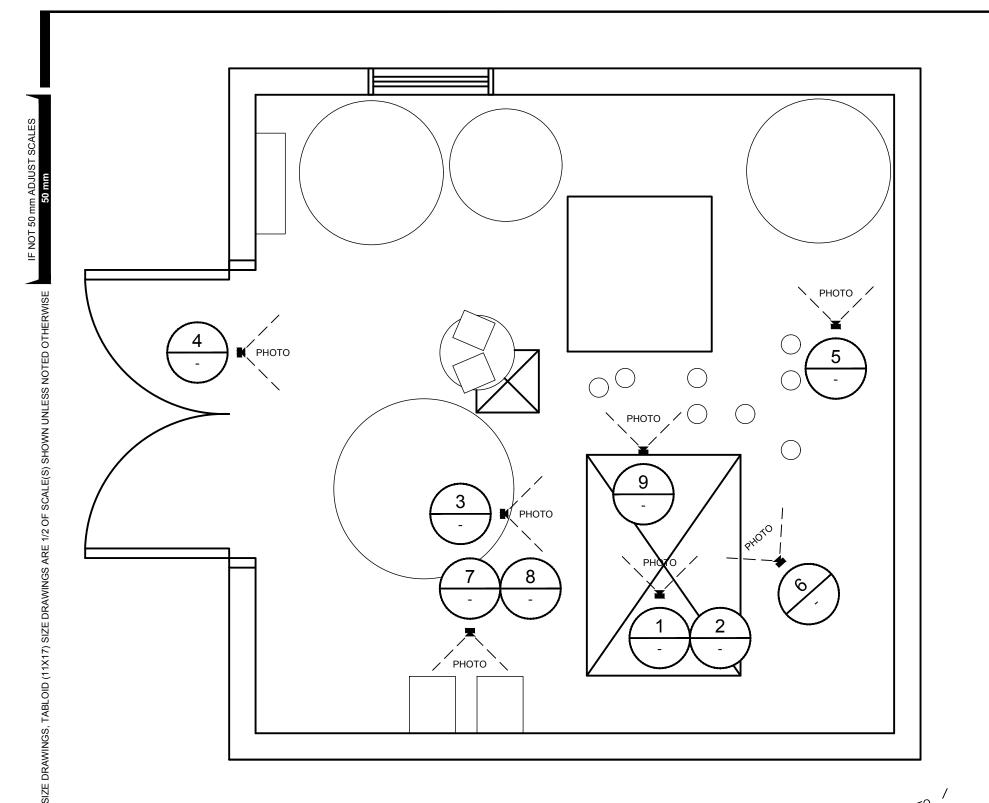
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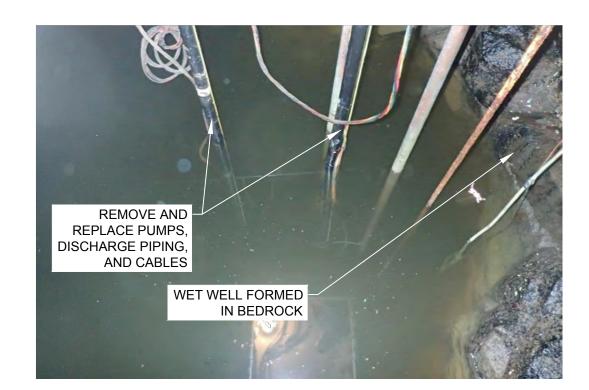
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SCALE: AS SHOWN

PROCESS
MAIN FLOOR PLAN

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PHOTO

EXISTING WET WELL

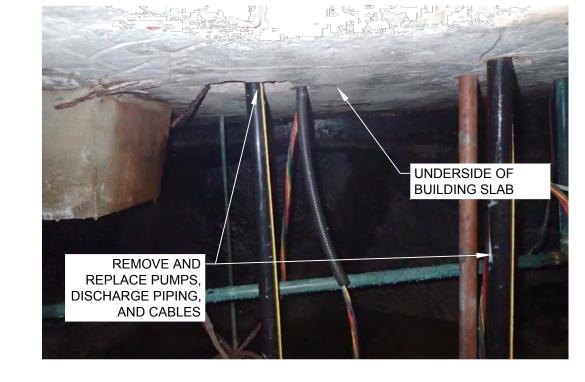




PHOTO EXISTING WET WELL CEILING

PHOTO

EXISTING TANKS

REMOVE TANKS




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ISSUED FOR TENDER

DESCRIPTION

REPLACE WOOD WET WELL ACCESS HATCH WITH ALUMINUM HATCH



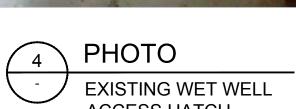




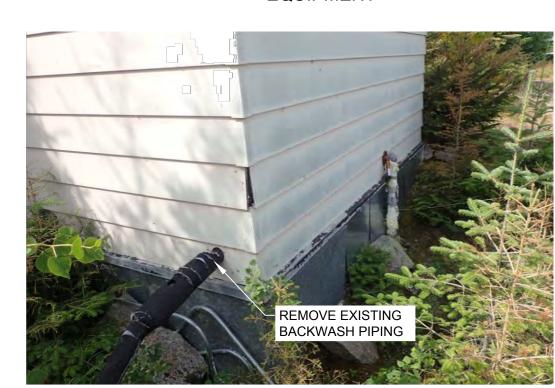


PHOTO **EXISTING BACKWASH**

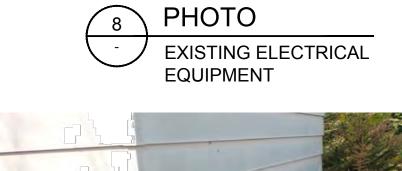





REMOVE TANK

PLAN

EXISTING PUMPHOUSE





PHOTO EXISTING VFDS



PHOTO EXISTING PUMP DISCHARGE PIPING

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NORWAY HOUSE DETACHMENT

EXISTING WTP/PUMPHOUSE EQUIPMENT

WATER TREATMENT PLANT


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PROCESS

SCALE: AS SHOWN

DEMOLITION PLAN




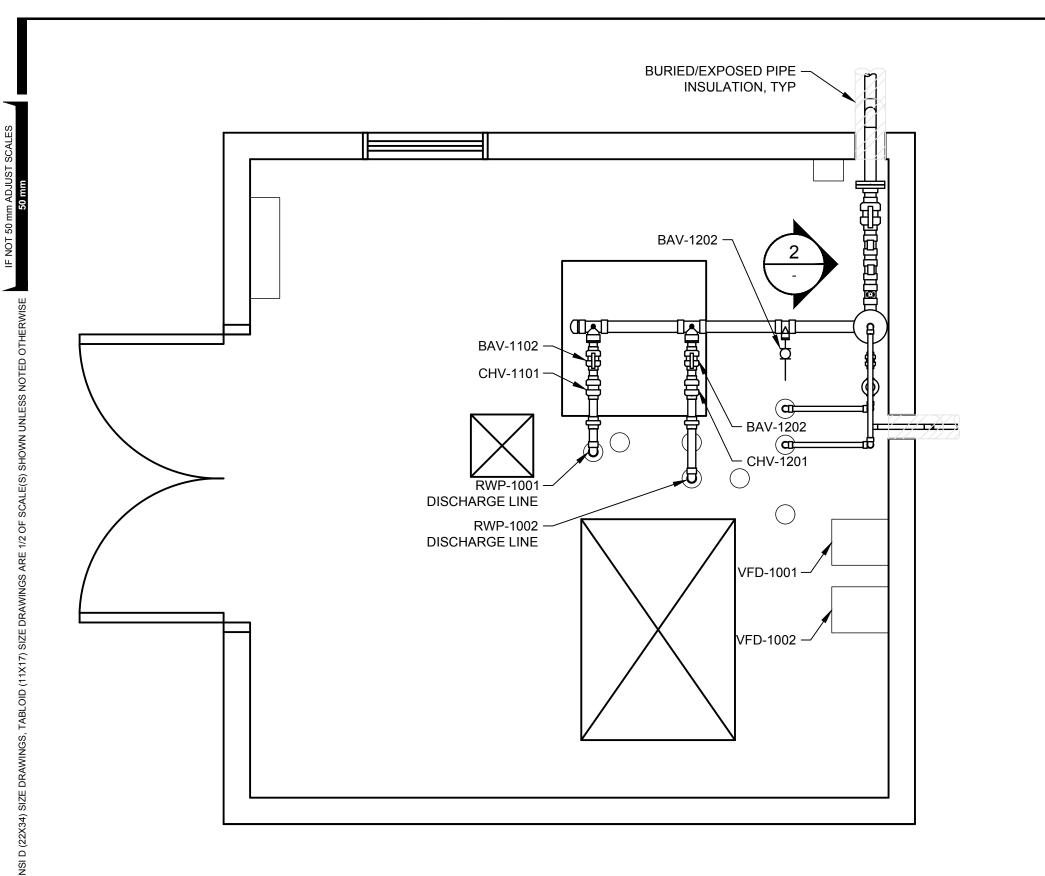PLAN

EXISTING PUMPHOUSE

MODIFICATIONS

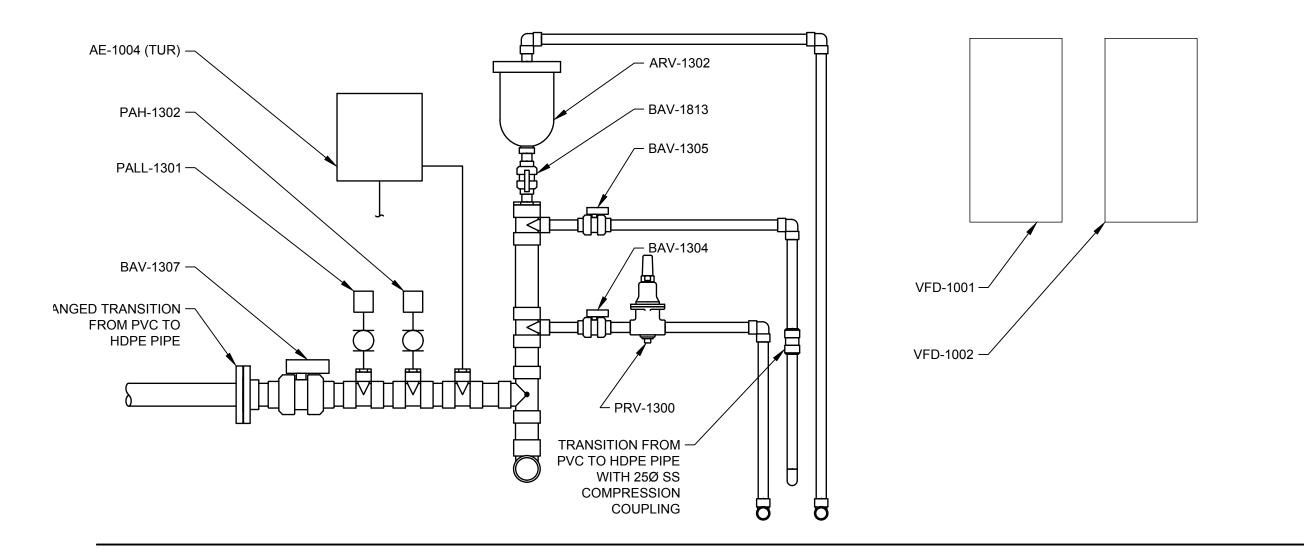1:20











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STANCHION MATERIAL SCH. 40 PIPE, OR AS PER SPECIFICATIONS.

BASE PLATE - CARBON STEEL

SHOP PRIME - 2 COATS RED OXIDE PRIMER OR GALVANIZED AS PER SPECIFICATIONS TOUCH UP FIELD WELDS WITH PRIMER OR GALVICON


PIPE STANCHION SADDLE - MAY BE MYATT FIG. 306/306S OR MUELLER (ANVIL) FIG. 259/265

PIPE SIZE	100	125	150	200	250	300	350	400	450	500	600	750	900	-
А	80	80	80	80	80	80	80	80	90	90	100	100	100	-
В	100	100	100	100	100	100	100	100	150	150	150	150	150	-
C MIN	240	255	270	310	350	370	380	425	485	510	590	670	745	-
MAX	350	370	390	425	460	485	515	540	600	625	705	785	860	-
D MAX	1200	1200	1200	1200	1200	1200	1200	1200	1850	1850	1850	1850	1850	-
THICK x E SQUARE	10 mm x 250	10 mm x 250	10 mm x 250	10 mm x 250	-	-	10 mm x 250	_	10 mm x 250	_	10 mm x 250	10 mm x 250	10 mm x 250	-
F SQUARE	200	200	200	200	200	200	200	200	200	200	200	200	200	-
G DIA. x No. HOLES		20 DIAMETER x 4												
BOLT	M16x100 GALVANIZED OR AS APPROVED													
DIA. x H		EXIST. CONCRETE USE M16 HSL HILTI												

DETAIL


NOTES:

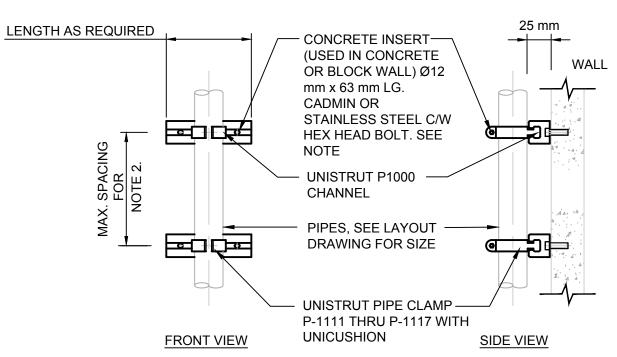PIPE SUPPORT - PIPE STANCHION WITH SADDLE (ADJUSTABLE)





MOUNTING OF VERTICAL PIPE

1.) CONCRETE INSERTS - 454kg. MAXIMUM RECOMMENDED LOAD IN GOOD CONCRETE PER INSERT ADJUST TO SUIT APPLICATION. USE BOLTS OF THE SAME RECOMMENDED LOAD WHEN FASTENING TO STEEL COLUMNS, STEEL OR WOOD WALLS.

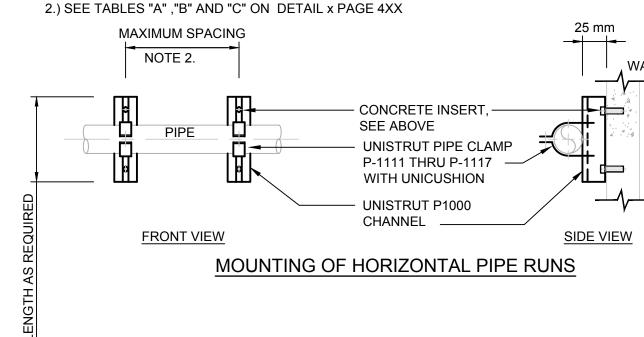



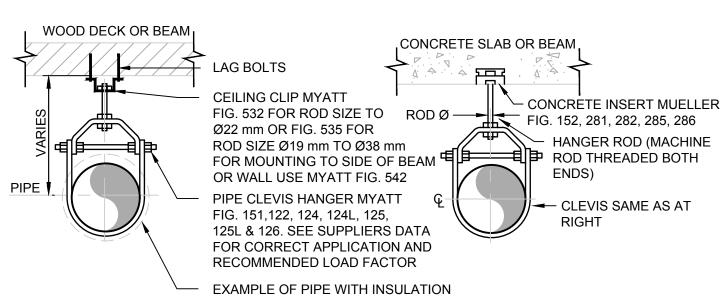

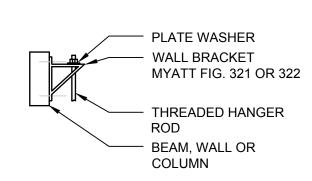

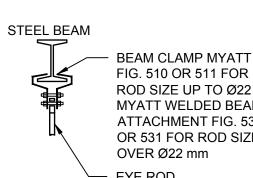


FIG. 510 OR 511 FOR ROD SIZE UP TO Ø22 mm MYATT WELDED BEAM ATTACHMENT FIG. 530 OR 531 FOR ROD SIZE OVER Ø22 mm — EYE ROD

OPTIONAL METHODS OF UPPER HANGER ROD ATTACHMENTS

DI	EPICTING	DIFFEREN	T CEILING	STRUCTURES

PIPE SIZE	10	15	20	25	30	40	50	65	80	100	150	200	250	300	350	400	450	500	600
CLEVIS No.		ROD Ø																	
MYATT 122	10	10	10	10	10	10	10	13	13	13									
MYATT 124			10	10	10	10	10	13	13	16	19	19	22	22	25	25	28	32	32
MYATT 125									19	22	25	25	28	32					
MYATT 126										19	19	22	22	25	25	32	32	32	38
MYATT 151		10	10	10	10	10	10	13	13	13	19	19	22						

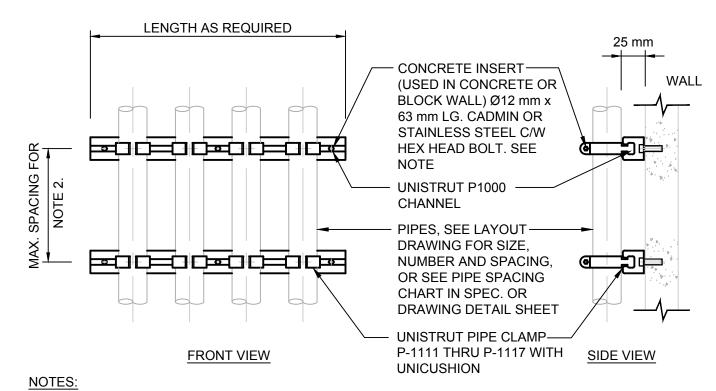
NTS

FOR ANY OTHER TYPE OF INSTALLATION, PLEASE REFER TO MANUFACTURE'S SPECIFICATIONS ALL PARTS MUST BE FROM SAME MANUFACTURER


MANUFACTURED COMPONENTS MAY BE ORDERED FROM MYATT, MUELLER OR AS APPROVED S.L. IS THE SAFE TOTAL UNIFORMLY DISTRIBUTED LOAD IN KILOGRAMS WITH A MAXIMUM DEFLECTION OF 6 mm


FABRICATED COMPONENTS SHOP PRIME WITH 2 COATS RED OXIDE PRIMER OR GALVANIZED AS PER







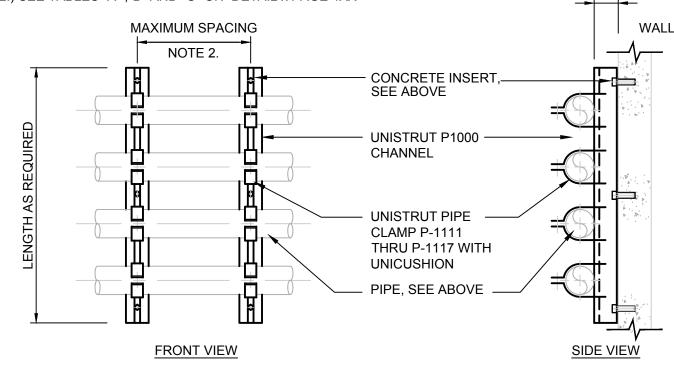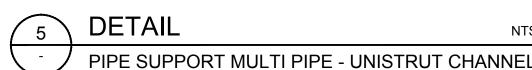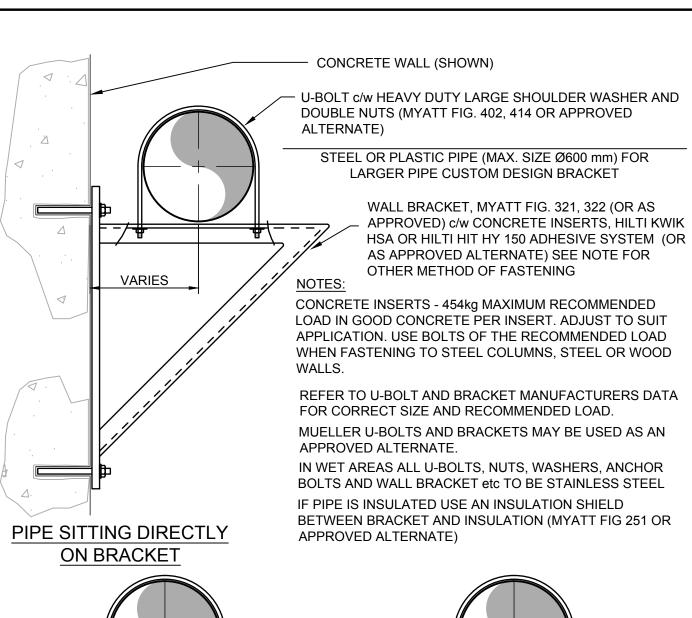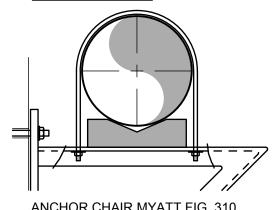1.) CONCRETE INSERTS - 454kg. MAXIMUM RECOMMENDED LOAD IN GOOD CONCRETE PER INSERT ADJUST TO SUIT APPLICATION. USE BOLTS OF THE SAME RECOMMENDED LOAD WHEN FASTENING TO STEEL COLUMNS, STEEL OR WOOD WALLS. 2.) SEE TABLES "A" ,"B" AND "C" ON DETAIL x PAGE 4XX










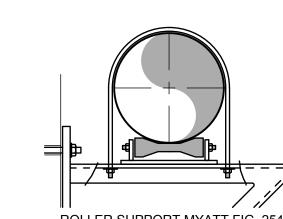ANCHOR CHAIR MYATT FIG. 310, 312 (OR AS APPROVED0 ALTERNATE PIPE SEATING USING ANCHOR CHAIR




ROLLER SUPPORT MYATT FIG. 254, 265 (OR AS APPROVED)

ALTERNATE PIPE SEATING USING PIPE ROLLER

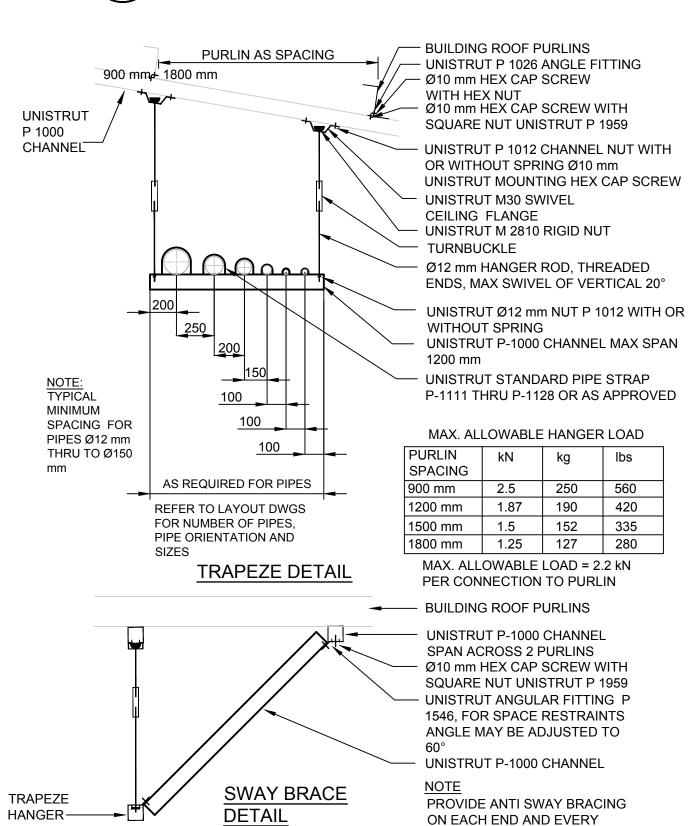THIRD TRAPEZE HANGER











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NORWAY HOUSE DETACHMENT WATER TREATMENT PLANT

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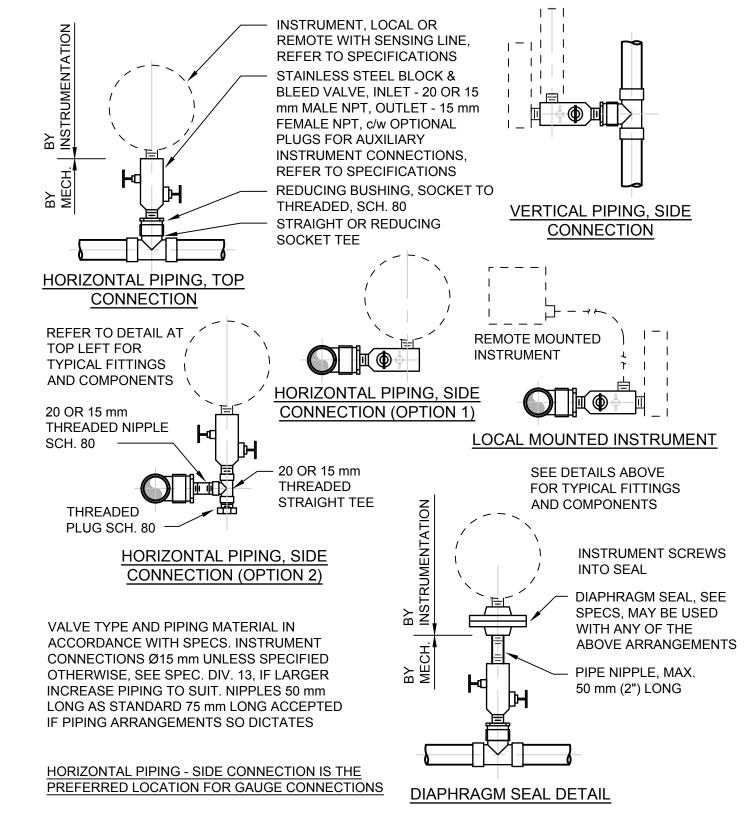
PROCESS

DETAILS

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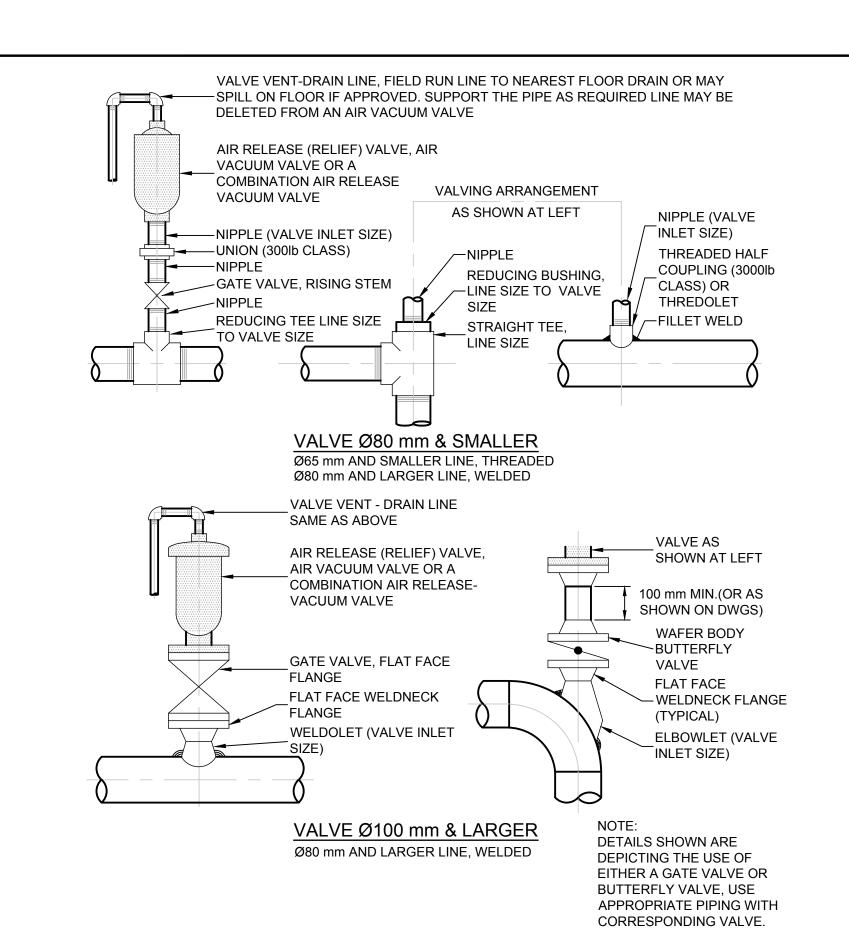
PIPE SUPPORT MULTI PIPE - UNISTRUT CHANNEL PIPING SUPPORT - TRAPEZE HANGER DETAIL


MAXIMUM HORIZONTAL SPACING BETWEEN PIPE SUPPORTS										
		NOMINAL PIPE SIZE IN MILLIMETRES								
	15	20	25	40	50	65	80	100	150	200
MAX. SPAN (mm) WATER SERVICE	1000	1000	1200	1400	1800	1800	2100	2100	2400	2400
RECOMMENDED HANGER ROD SIZE	10	10	10	10	10	13	13	16	19	19
MAXIMUM HORIZONTAL SPACING BETWEEN PIPE SUPPORTS										
	NOMINAL PIPE SIZE IN MILLIMETRES									
	250	300	350	400	450	500	600			
MAX. SPAN (mm) WATER SERVICE	2400	2400	2800	2800	2800	2800	2800			
RECOMMENDED HANGER ROD SIZE	22	22	25	25	25	25	25			



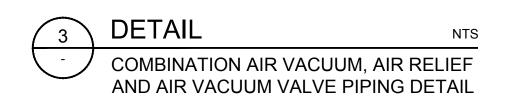PLASTIC PIPING Ø150 mm AND SMALLER











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NORWAY HOUSE DETACHMENT WATER TREATMENT PLANT


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TAG	DESCRIPTION	MANUFACTURER	MODEL NO.	COMMENTS
RWP-1001	WELL PUMP	GRUNDFOS	16\$15-14	INSTALL IN EXISTING WET WELL
RWP-1002	WELL PUMP	GRUNDFOS	16S15-14	INSTALL IN EXISTING WET WELL
AE-1004-TUR	TURBIDIMETER			
PRV-1300	CONTROL VALVE	CLA-VAL	55B-60	
PALL-1301	PRESSURE SWITCH			
PAH-1302	PRESSURE SWITCH			
FE-1501	MAGNETIC	NEPTUNE		
HYD-1501	HYDRO-PNEUMATIC TANK	PENTAIR	CPV-40T	
HYD-1502	HYDRO-PNEUMATIC TANK	PENTAIR	CPV-40T	
PT-1503	PRESSURE TRANSMITTER			
FIL-2101	MULTIMEDIA FILTER	VIQUA	C53-AG16-15SM	
FIL-2102	MULTIMEDIA FILTER	VIQUA	C53-AG16-15SM	
PT-2101	PRESSURE TRANSMITTER			
PT-2102	PRESSURE TRANSMITTER			
FIL-2201	MULTIMEDIA FILTER	VIQUA	C53-AG16-15SM	
FIL-2202	MULTIMEDIA FILTER	VIQUA	C53-AG16-15SM	
FIL-2301	FILTER	HARMSCO	HUR-170	 0.35 μm
FIL-2302	FILTER	HARMSCO	HUR-170	1.0 μm ABSOLUTE
PT-2301	PRESSURE TRANSMITTER			<u> </u>
OCR-3101	OCR FILTER	VIQUA	43X-1665-15SM-26	8 BED VOLUMES PER HOUR
OCR-3102	OCR FILTER	VIQUA	43X-1665-15SM-26	8 BED VOLUMES PER HOUR
PT-3101	PRESSURE TRANSMITTER		13/1 1003 133/1/ 20	
PT-3102	PRESSURE TRANSMITTER			
FI-3112	ROTAMETER	KING INSTRUMENT	7331-3-6-2-0-64W	
FI-3113	ROTAMETER	KING INSTRUMENT	7331-3-6-2-0-64W	
UV-4001	UV REACTOR	VIQUA	PRO 30	INCLUDE FLOW METER SELENOID VALVE AND COMM CENTRE
UV-4002	UV REACTOR	VIQUA	PRO 30	INCLUDE PREFILTER, FLOW METER, SELENOID VALVE AND COMM CENTRE
UV-4003	UV REACTOR	VIQUA	PRO 30	INCLUDE FLOW METER SELENOID VALVE AND COMM CENTRE
FE-4011	MAGNETIC			SUPPLIED W/ UV UNIT
FE-4012	MAGNETIC			SUPPLIED W/ UV UNIT
FE-4013	MAGNETIC			SUPPLIED W/ UV UNIT
SV-4021	CONTROL VALVE			SUPPLIED W/ UV UNIT
SV-4022	CONTROL VALVE			SUPPLIED W/ UV UNIT
SV-4023	CONTROL VALVE			SUPPLIED W/ UV UNIT
PFIL-4101	UV PRE-FILTER			Seri Eleb Wy ev elli
PFIL-4201	UV PRE-FILTER			
PFIL-4301	UV PRE-FILTER			
FIT-5101	MAGNETIC	E&H	PROMAG 50	
CDP-6001	CHLORINE DOSING PUMP	GRUNDFOS	DDA7.5-16AR	WITH ACCESSORIES
IQ-6001	INJECTION QUILL	SAFTFLO	EB125-S-P-50-B-V	WITH FLEXIBLE HOSE ASSEMBLY
CDP-6002	CHLORINE DOSING PUMP	GRUNDFOS	DDA7.5-16AR	WITH ACCESSORIES
TK-6111	CHLORINE TANK	NORWESCO	MODEL 43608 (22GAL)	WITH ACCESSORIES
TK-6121	SPILL CONTAINMENT	NEW PIG	POLY DRIP DECK(650x650x150)	
TK-7101	VESSEL	PENTAIR PENTAIR	RT-185F	
TK-7102	VESSEL		RT-185F	
TK-7103	VESSEL	PENTAIR	RT-185F	
TK-7104	VESSEL	PENTAIR	RT-185F	
AE-7401-CL2	CHLORINE ANALYZER			
PT-7501	PRESSURE TRANSMITTER			
PT-7502	PRESSURE TRANSMITTER	DENTAIO	CD1/C37	
HYD-8001	HYDRO TANK	PENTAIR	CPV627	
HYD-8002	HYDRO TANK	PENTAIR	CPV627	







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VALVE LIST							
TAG	SIZE	SPEC	DESCRIPTION				
CHV-1101	50	E1	CHECK VALVE				
BAV-1102	50	E1	BALL VALVE				
BAV-1103	15	H1	BALL VALVE				
CHV-1201	50	E1	CHECK VALVE				
BAV-1202	50	E1	BALL VALVE				
BAV-1203	15	H1	BALL VALVE				
ARV-1302	25	E1	AIR RELIEF VALVE				
BAV-1304	25	E1	BALL VALVE				
BAV-1305	25	E1	BALL VALVE				
BAV-1306	15	E5	BALL VALVE				
BAV-1307	50	E1	BALL VALVE				
BAV-1408	15	H1	BALL VALVE				
BAV-1409	15	H1	BALL VALVE				
BAV-1501	50	E1	BALL VALVE				
BAV-1502	50	E1	BALL VALVE				
BAV-1511	15	H1	BALL VALVE				
BAV-1560	25	E1	BALL VALVE				
BAV-1561	25	E1	BALL VALVE				
BAV-1562	25	E1	BALL VALVE				
BAV-1581	25	E1	BALL VALVE				
ARV-1582	25	E1	AIR RELIEF VALVE				
BAV-1701	8	H1	SAMPLE PETCOCK				
BAV-1813	25	E1	BALL VALVE				
BAV-2111	32	E1	BALL VALVE				
BAV-2112	32	E1	BALL VALVE				
BAV-2113	15	E5	BALL VALVE				
BAV-2121	32	E1	BALL VALVE				
BAV-2122	32	E1	BALL VALVE				
BAV-2123	15	E5	BALL VALVE				
BAV-2180	50	E1	BALL VALVE				
BAV-2185	50	E1	BALL VALVE				
BAV-2187	15	H1	BALL VALVE				
BAV-2190	50	E1	BALL VALVE				
BAV-2211	32	E1	BALL VALVE				
BAV-2212	32	E1	BALL VALVE				
BAV-2213	15	E5	BALL VALVE				
BAV-2221	32	E1	BALL VALVE				
BAV-2222	32	E1	BALL VALVE				
BAV-2223	15	E5	BALL VALVE				
BAV-2301	50	E1	BALL VALVE				
BAV-2302	15	H1	BALL VALVE				
BAV-2310	25	H1	BALL VALVE				
BAV-2311	50	E1	BALL VALVE				

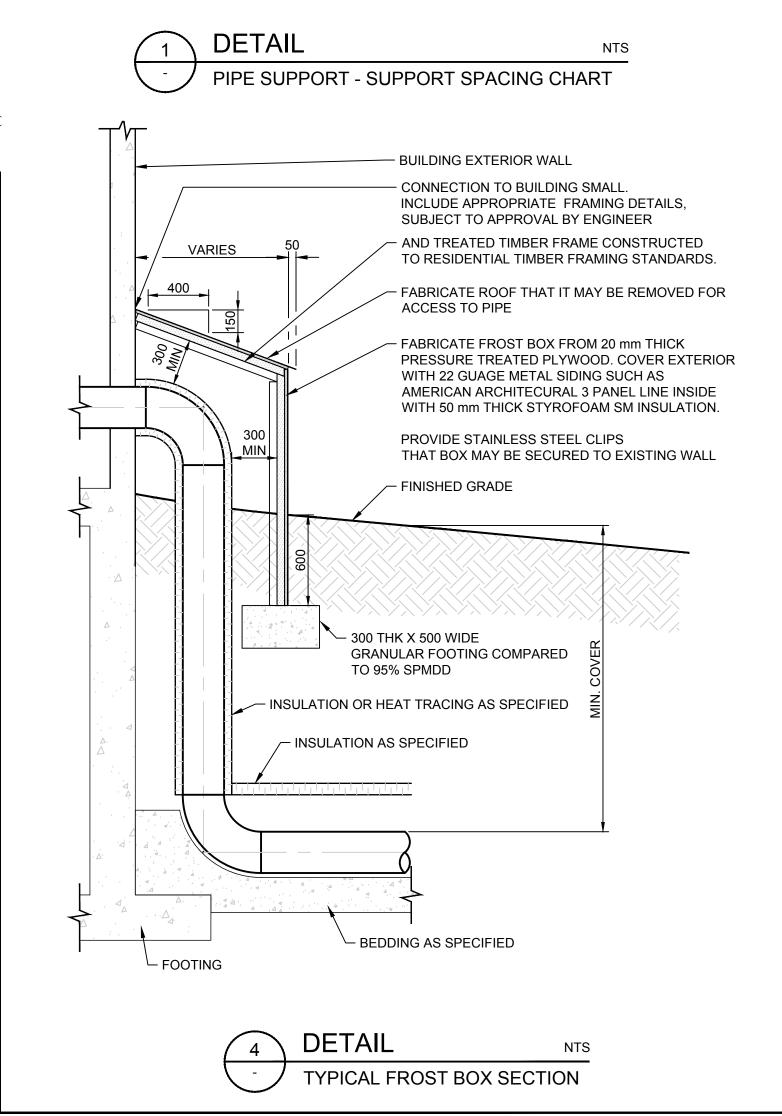ARV-2311

BAV-2312

BAV-2313

BAV-2317

BAV-2320

ARV-2321

BAV-2322

BAV-2323

BAV-2327

BAV-2331

BAV-2803

CAV-2811

BAV-3101

BAV-3102

BAV-3105

BAV-3111

FCV-3111

BAV-3211

BAV-3212

BAV-3301

BAV-3401

BAV-4111

BAV-4112

BAV-4115

CHV-4116

BAV-4117

BAV-4118

BAV-4211

25

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BALL VALVE

AIR RELIEF VALVE

BALL VALVE

BALL VALVE

BALL VALVE

BALL VALVE

BALL VALVE

COMBINATION AIR VALVE

BALL VALVE

BALL VALVE

BALL VALVE

BALL VALVE

DIAPHRAGM VALVE

BALL VALVE

CHECK VALVE

BALL VALVE

BALL VALVE

BALL VALVE

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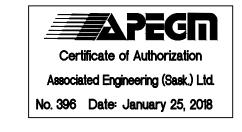
	V / \L	v L L.O.	
TAG	SIZE	SPEC	DESCRIPTION
BAV-4212	32	E1	BALL VALVE
BAV-4215	25	E1	BALL VALVE
CHV-4216	25	E1	CHECK VALVE
BAV-4217	15	H1	BALL VALVE
BAV-4218	15	H1	BALL VALVE
BAV-4311	25	E1	BALL VALVE
BAV-4312	32	E1	BALL VALVE
BAV-4315	25	E1	BALL VALVE
CHV-4316	25	E1	CHECK VALVE
	15	H1	BALL VALVE
BAV-4317			
BAV-4318	15	H1	BALL VALVE
BAV-4401	50	E1	BALL VALVE
BAV-5101	50	E1	BALL VALVE
BAV-5102	50	E1	BALL VALVE
FV-6011	25	E1	FOOT VALVE
FV-6012	25	E1	FOOT VALVE
MFV-6021			MULTI-FUNCTION VALVE
MFV-6022			MULTI-FUNCTION VALVE
BAV-6031	20	E1	BALL VALVE
BAV-6032	20	E1	BALL VALVE
BAV-6301	10	E1	BALL VALVE
BAV-6401	20	E1	BALL VALVE
BAV-6501	20	E1	BALL VALVE
BAV-7001	8	H1	BALL VALVE
BAV-7101	50	E1	BALL VALVE
BAV-7102	50	E1	BALL VALVE
BAV-7111	50	E1	BALL VALVE
BAV-7112	50	E1	BALL VALVE
BAV-7201	50	E1	BALL VALVE
BAV-7202	50	E1	BALL VALVE
BAV-7211	50	E1	BALL VALVE
BAV-7212	50	 E1	BALL VALVE
BAV-7301	50	E1	BALL VALVE
BAV-7302	50	E1	BALL VALVE
BAV-7311	50	 E1	BALL VALVE
BAV-7312	50	E1	BALL VALVE
BAV-7401	50	E1	BALL VALVE
BAV-7402	50	E1	BALL VALVE
BAV-7511	15	H1	BALL VALVE
BAV-7512	15	H1	BALL VALVE
BAV-7513	15	H1	BALL VALVE
BAV-7701	50	E1	BALL VALVE
BAV-8003	25	E1	BALL VALVE
WHYD-801	15	G1	GLOBE VALVE
BAV-8011	25	E1	BALL VALVE
BAV-8012	25	E1	BALL VALVE
BAV-8101	32	G1	BALL VALVE
BFP-8102	32	G1	BACKFLOW PREVENTOR
BAV-8103	32	G1	BALL VALVE
BAV-821	15	G1	BALL VALVE
BAV-822	15	G1	BALL VALVE
BAV-823	15	G1	BALL VALVE
BAV-824	20	G1	BALL VALVE
BAV-825	15	G1	BALL VALVE
BAV-826	15	G1	BALL VALVE
BAV-827	15	G1	BALL VALVE
RΔ\/-9810	32		ΒΔΙΙ ΛΔΙΛΈ

G1

BALL VALVE







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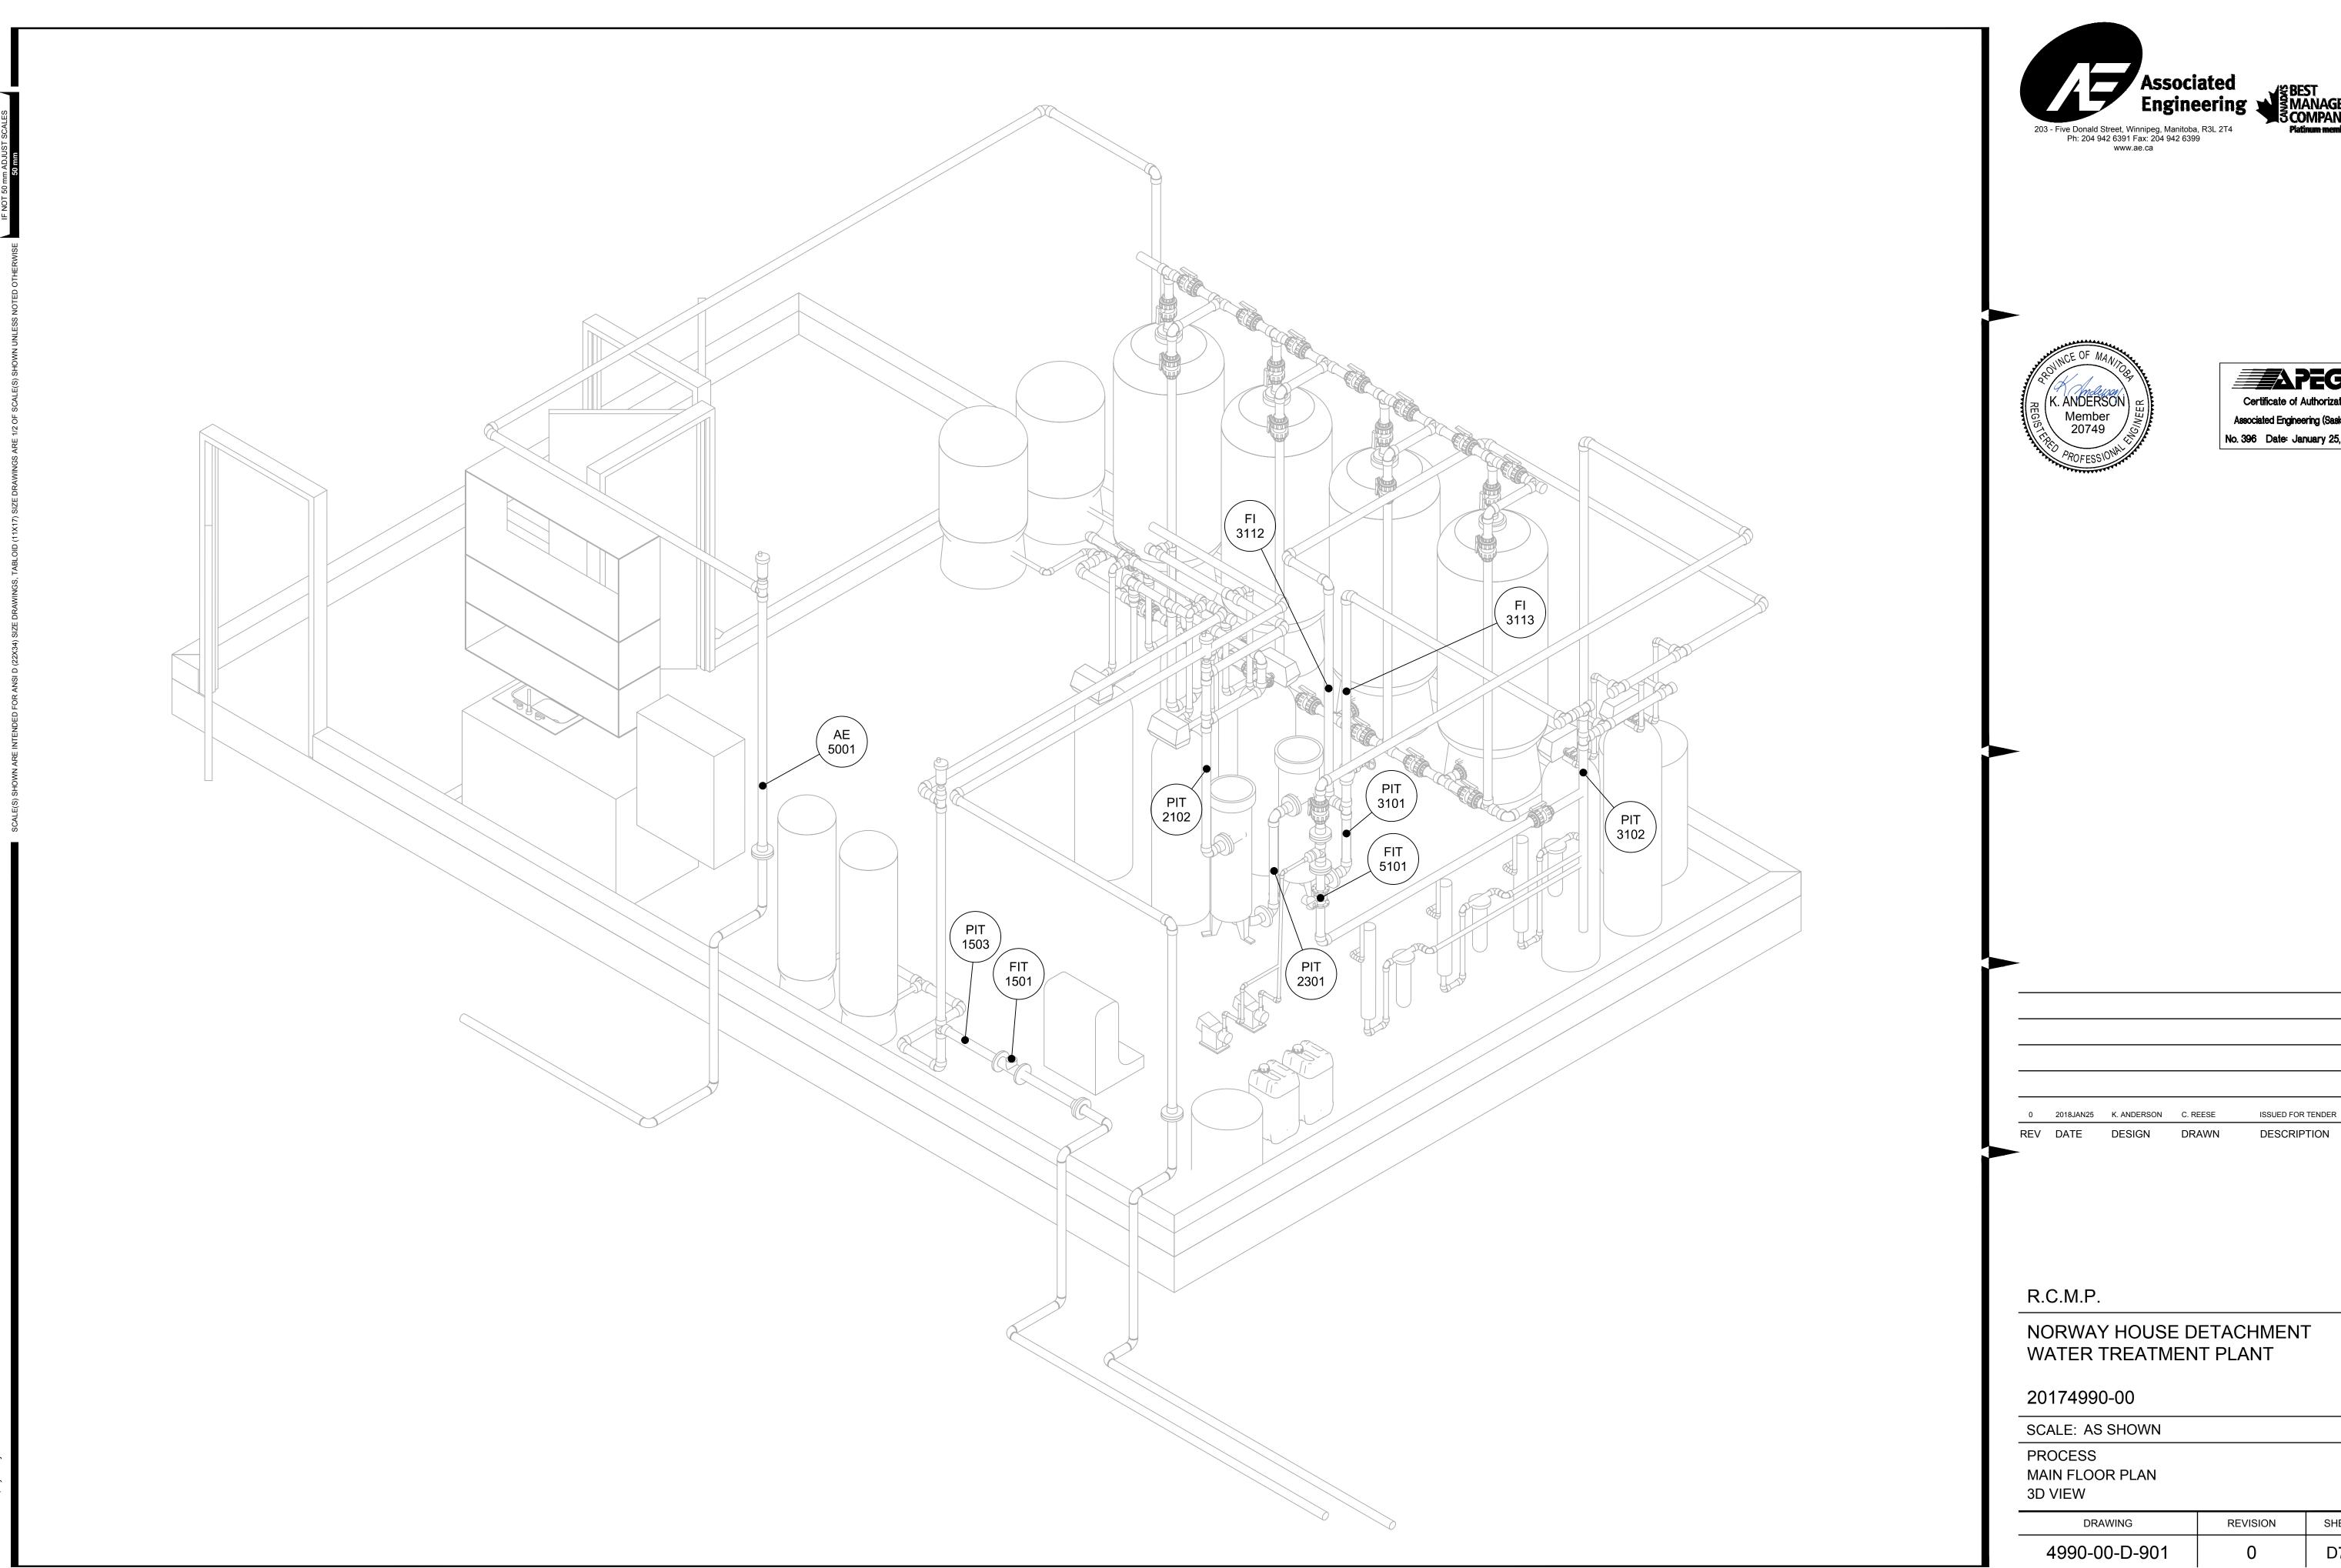
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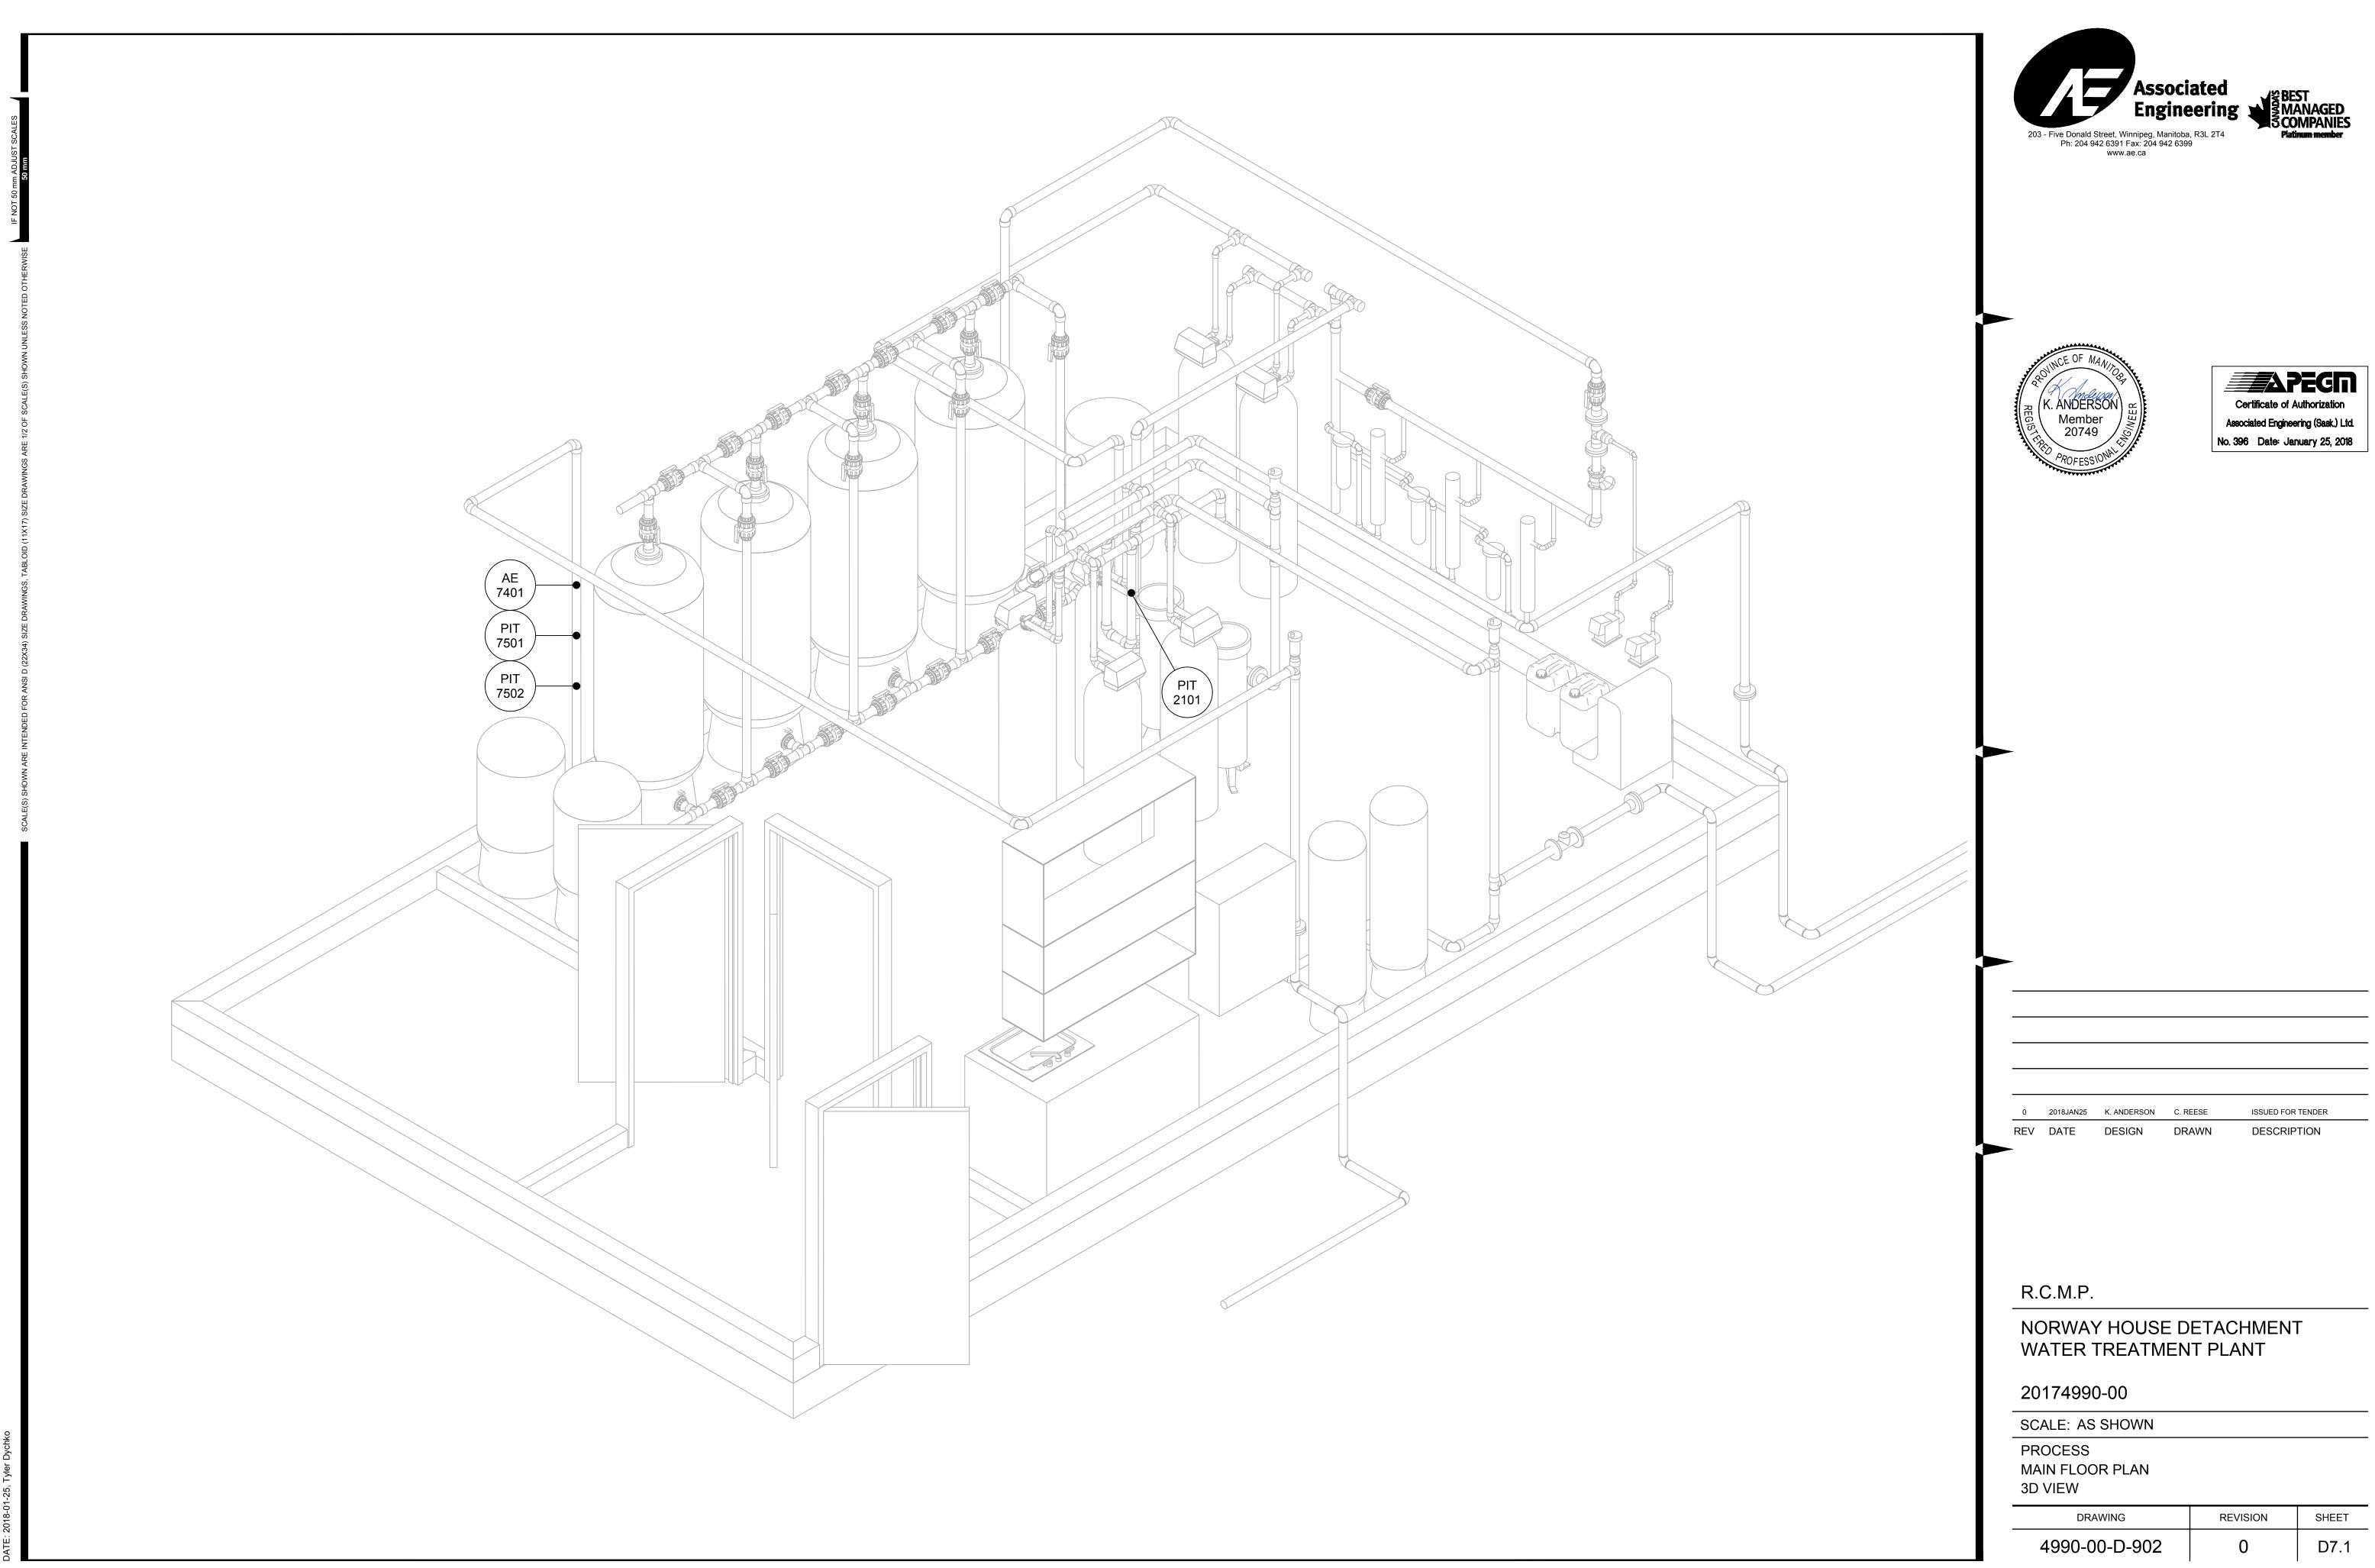
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