

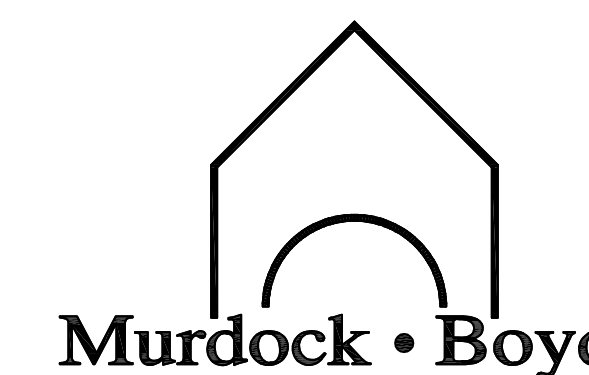


Parks  
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**GEMTEC**  
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# RENEWAL PROJECT PORT ROYAL HABITATION NATIONAL HISTORIC SITE PORT ROYAL, NS


## DRAWING LIST

A-0 KEY PLAN  
A-1 FLOOR PLANS  
A-2 ROOF PLAN  
A-3 PHOTOGRAPHS  
A-4 ELEVATIONS  
A-5 SECTION DETAILS  
A-6 SECTION DETAILS


PROJECT NO. PCA: 738 (MBA 15-567)

Canada



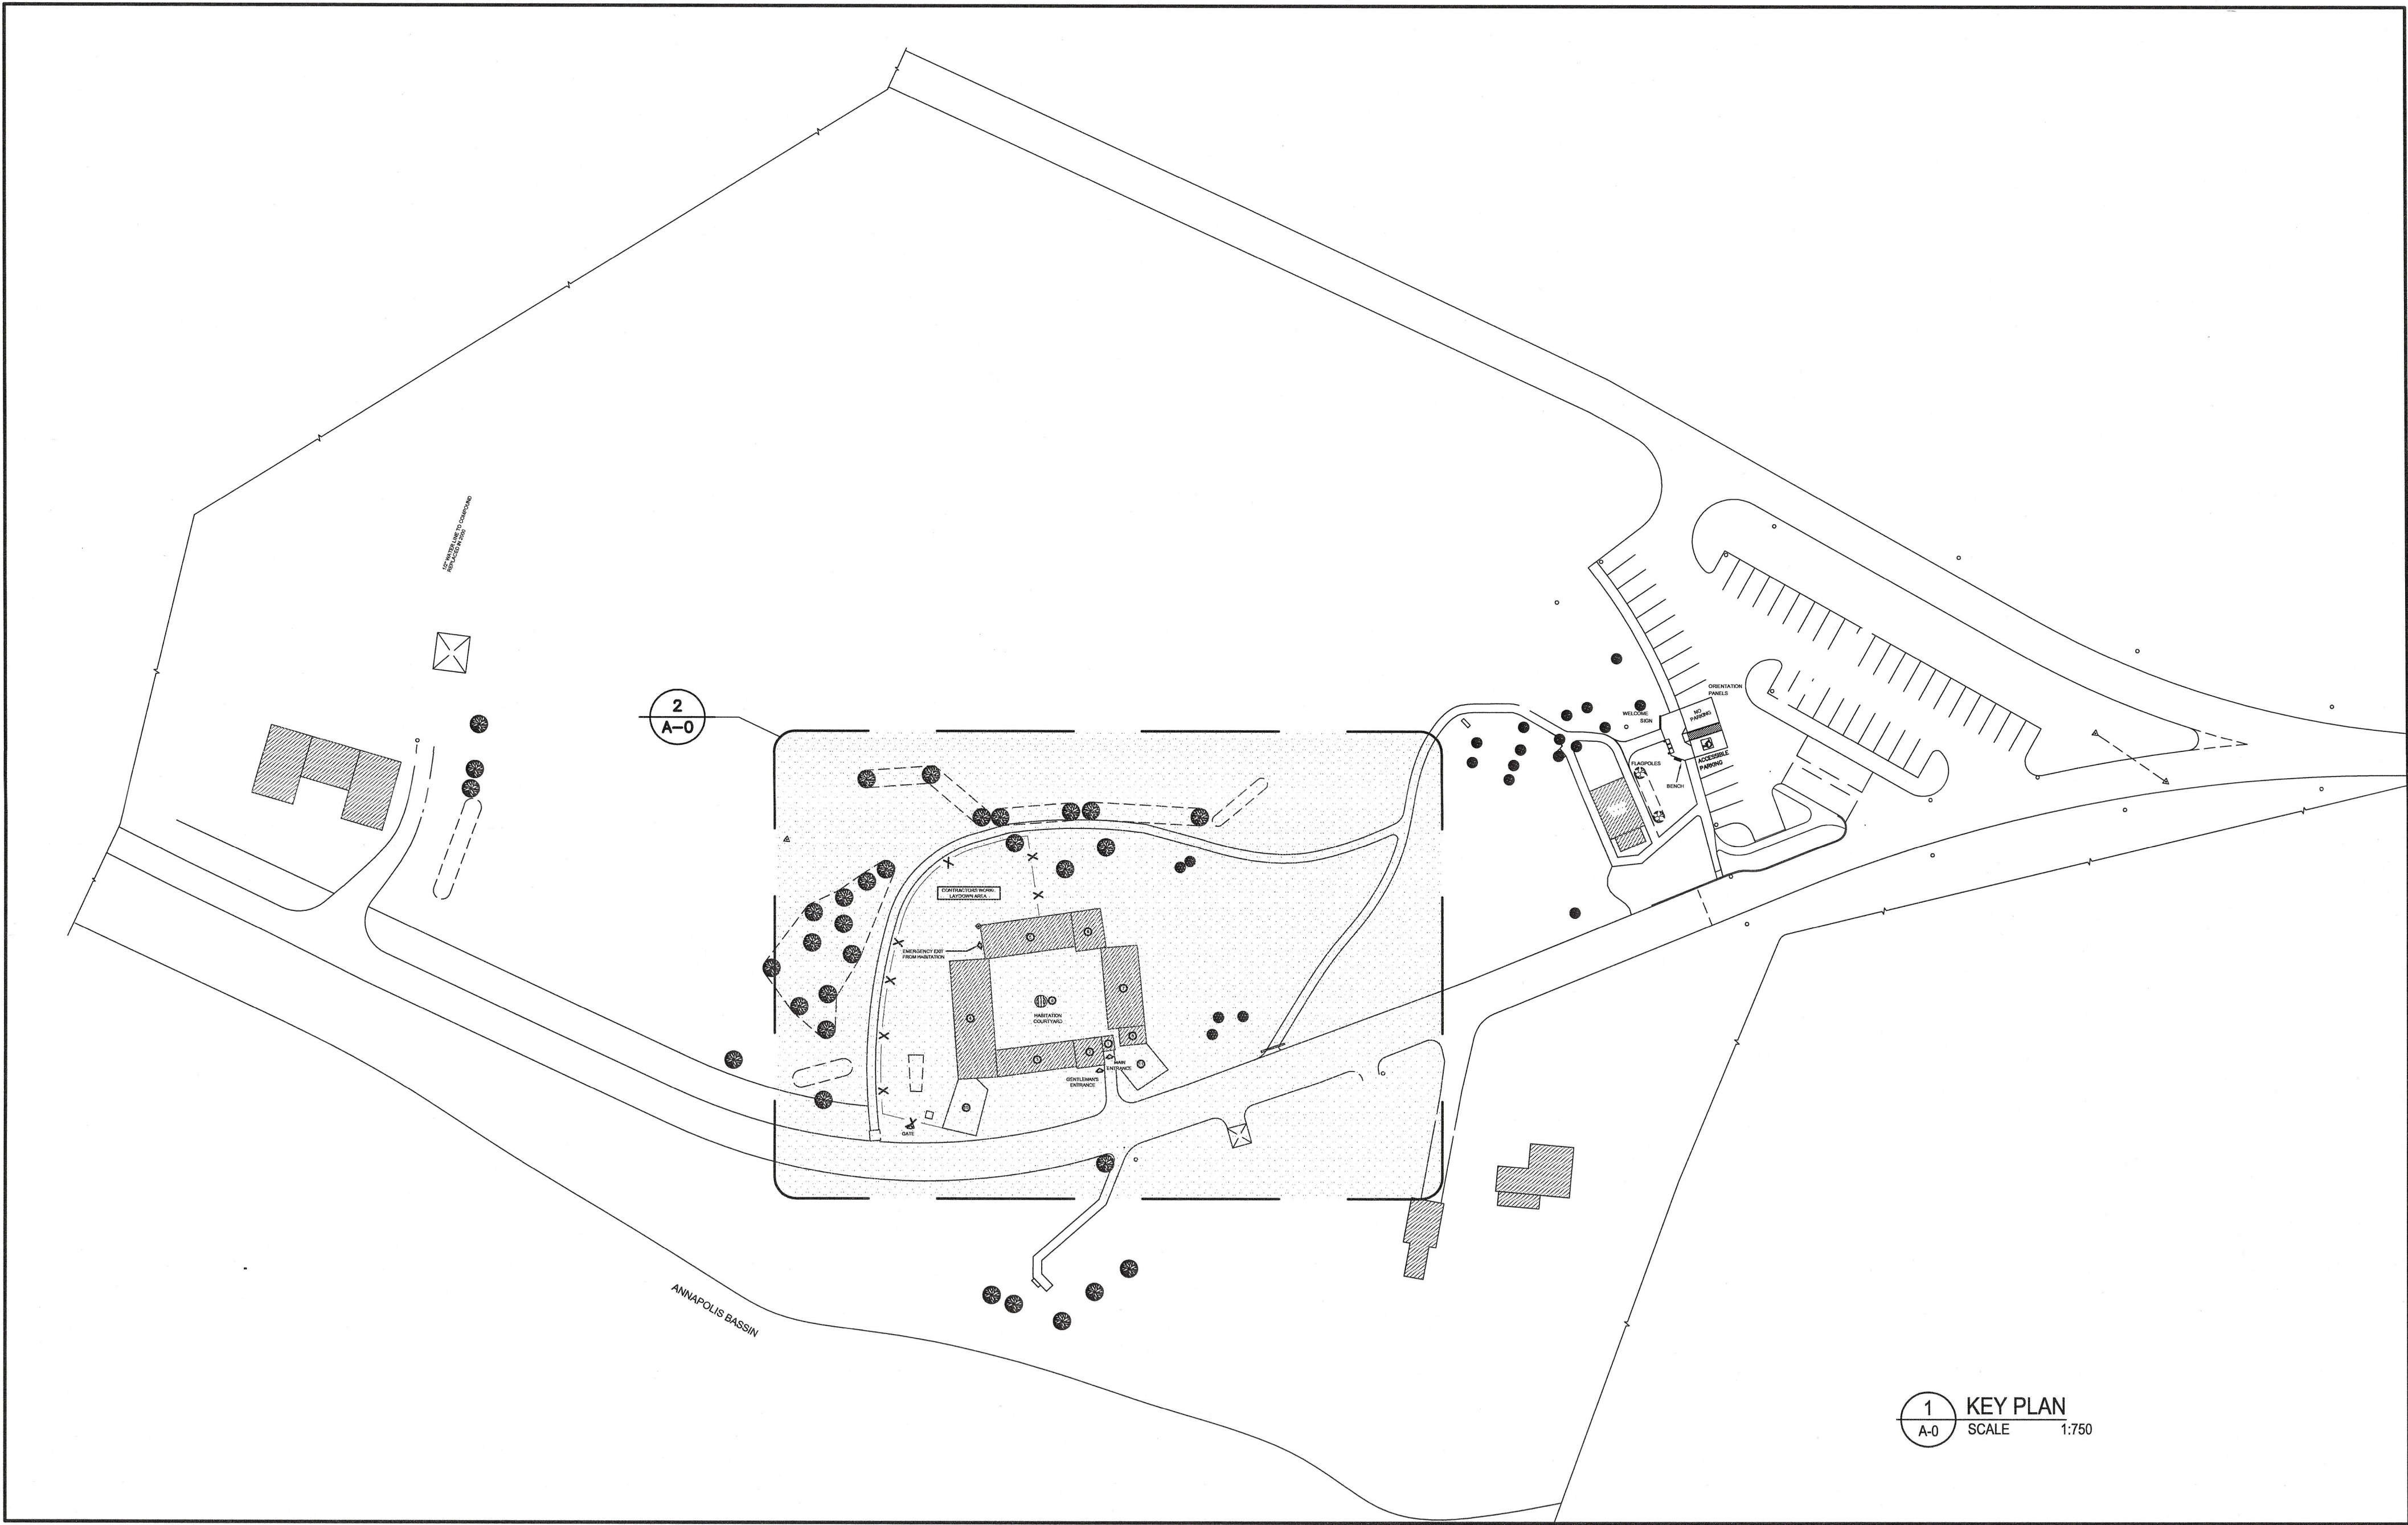

1 KEY PLAN  
SCALE 1:750

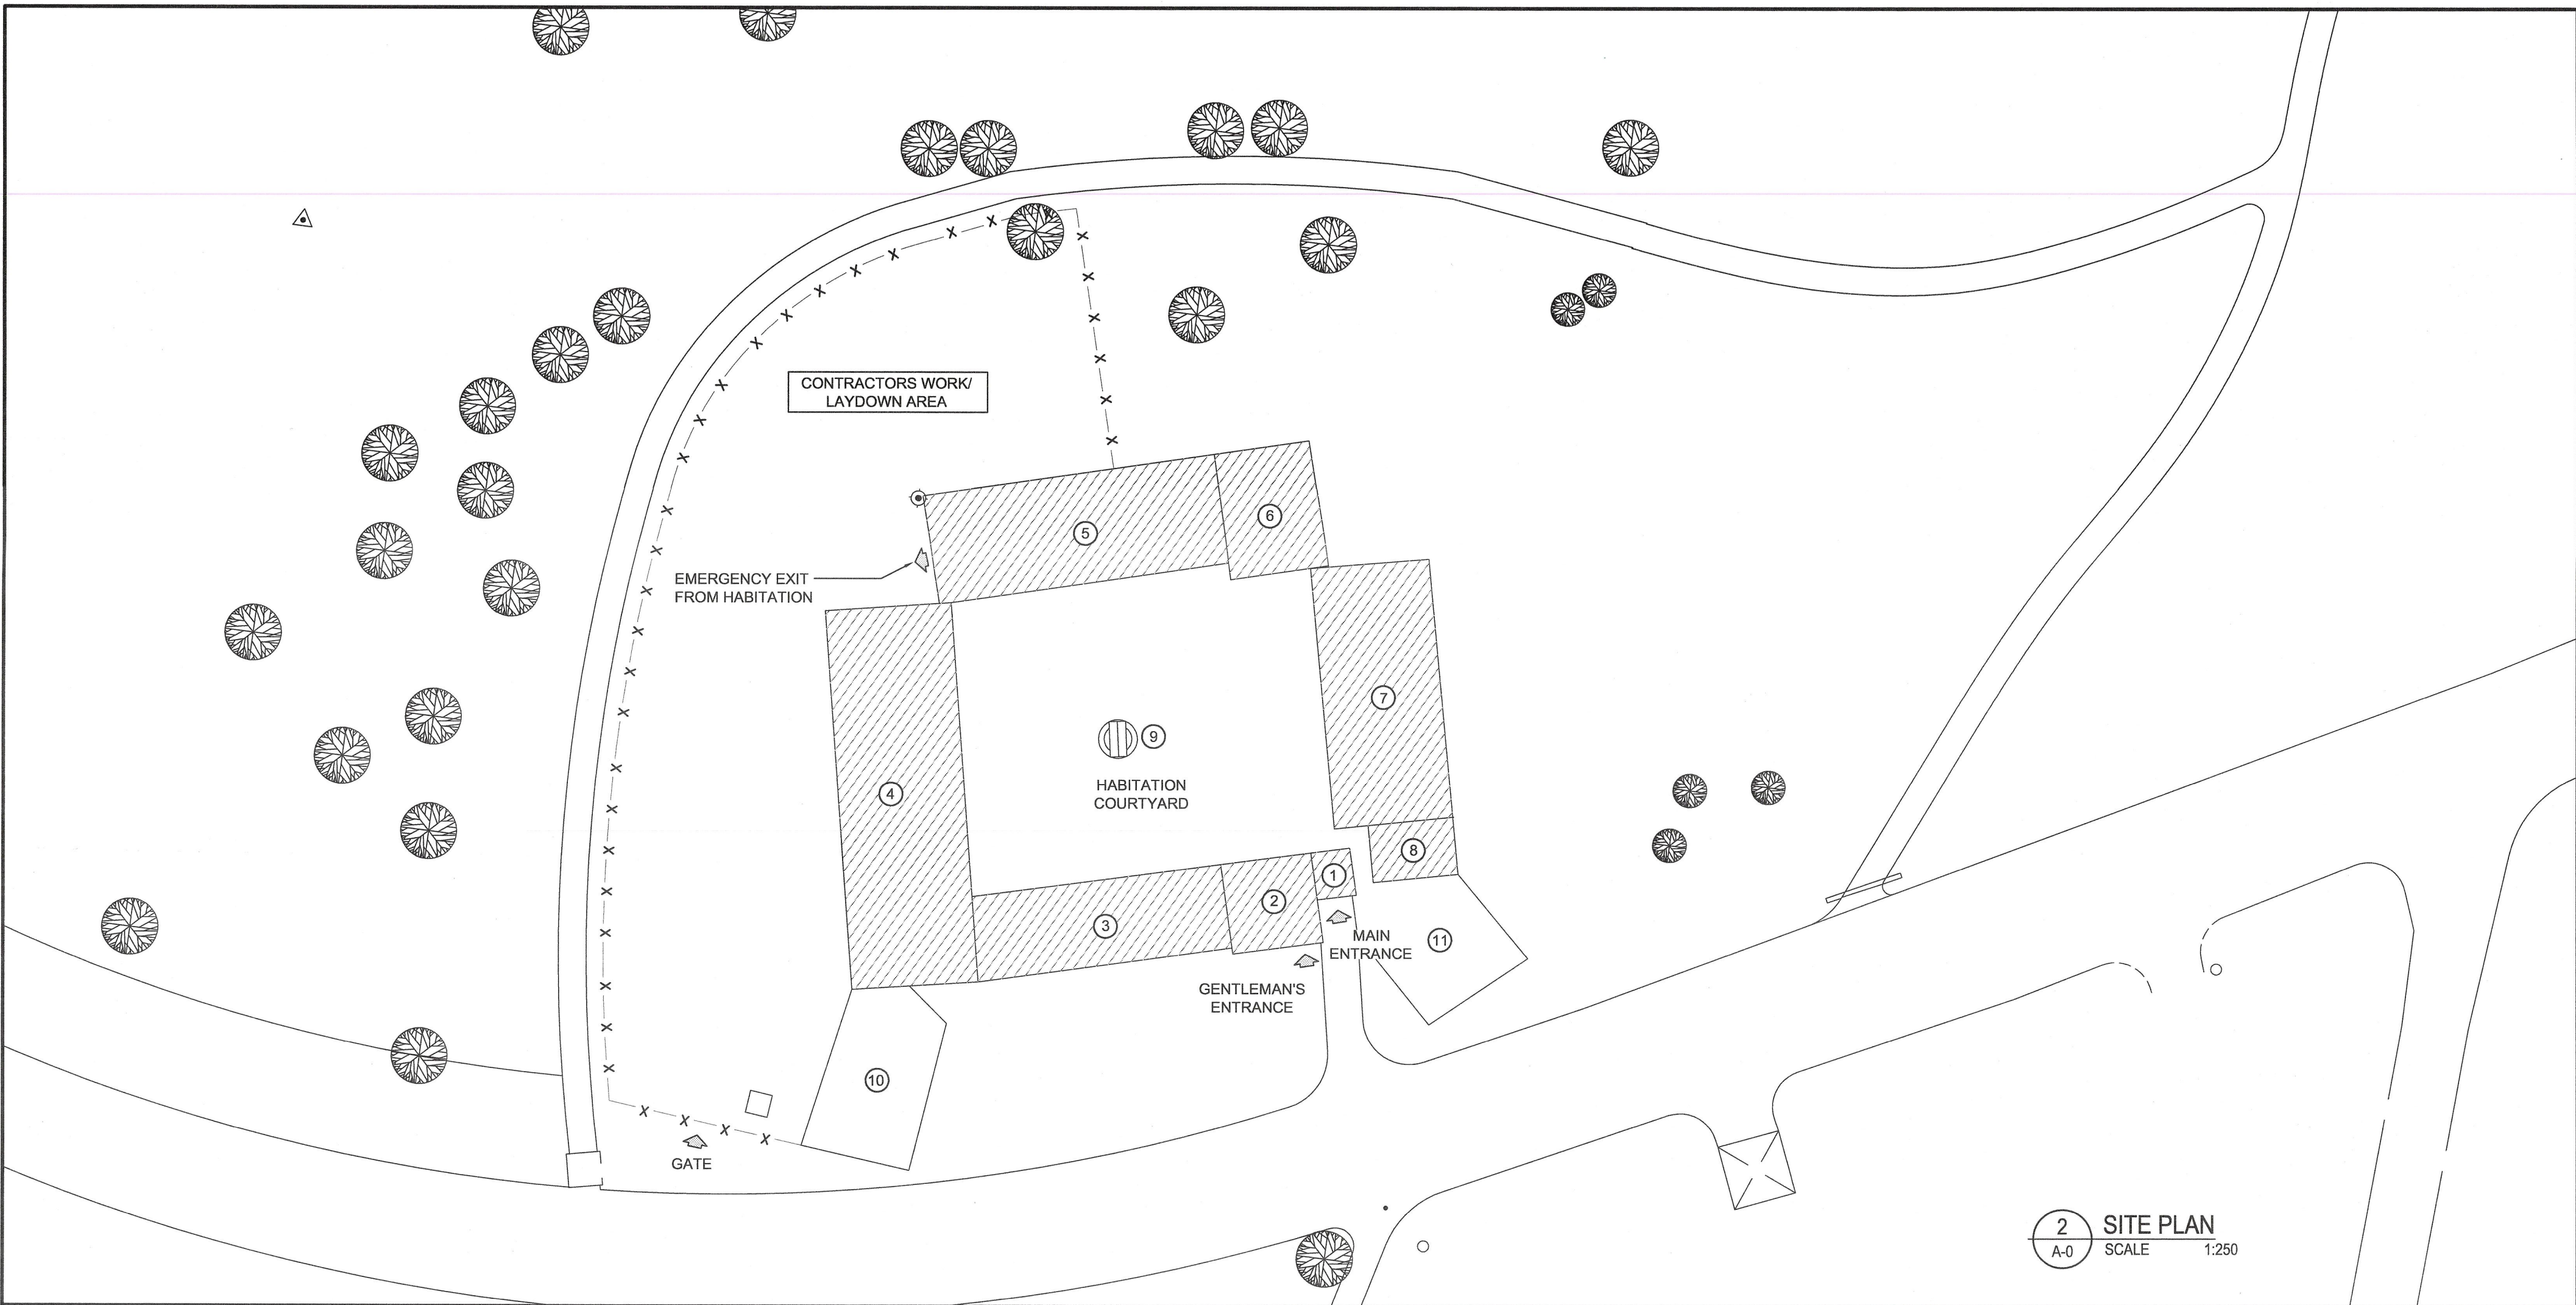


2 SITE PLAN  
SCALE 1:250

LEGEND

BUILDING NUMBERS

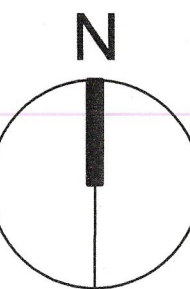1. MAIN GATE
2. GENTLEMEN'S ENTRANCE
3. KITCHEN/BLACKSMITH SHOP
4. COMMUNITY/SLEEPING QUARTERS
5. SLEEPING QUARTERS
6. GOVERNORS HOUSE
7. TRADING/STORAGE BUILDING
8. GUARD ROOM
9. WELL HOUSE
10. CANNON PLATFORM
11. PALISADE



0	ISSUED FOR TENDER	SEPT 8 2017
revisions		date

project RENEWAL PROJECT  
PORT ROYAL  
HABITATION  
NATIONAL HISTORIC SITE  
PORT ROYAL, NS

drawing HABITATION  
KEY  
PLAN

designed MRB	conçu
drawn MBA	dessiné
approved MRB	approuvé

Tender  
JN PWGSC Project Manager Administrateur de projets TPSGC  
project number 15-567

drawing no. A-0






**ROOM LEGEND**

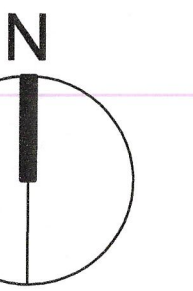1. THE GATEWAY
2. EXHIBIT ROOM
3. BLACKSMITH'S SHOP
4. KITCHEN
5. BAKE SHOP
6. COMMUNITY ROOM
7. CANNON PLATFORM
8. ARTISAN'S BUILDING
9. UPPER DORMITORY
10. THE CHAPEL
11. GENTLEMEN'S RESIDENCE
12. GENTLEMEN'S RESIDENCE
13. GENTLEMEN'S RESIDENCE
14. GENTLEMEN'S RESIDENCE
15. GOVERNOR'S HOUSE
16. UPPER STORE-ROOM
17. LOWER STORE-ROOM/WINE CELLAR
18. TRADING ROOM
19. GUARD ROOM
20. PALISADE
21. WELL
22. GOVERNOR'S SLEEPING QUARTERS
23. SAIL LOFT
24. DOVECOTE
25. ATTIC


NOTE:  
ALL DIMENSIONS ARE APPROXIMATE.  
CONTRACTOR TO SITE VERIFY

**LEGEND:**


-  WALL NUMBER ID  
 ROOM ID. SEE LEGEND ABOVE



0	ISSUED FOR TENDER	SEPT 8 2017
revisions		date
project	RENEWAL PROJECT PORT ROYAL HABITATION NATIONAL HISTORIC SITE PORT ROYAL, NS	
drawing	HABITATION MAIN & SECOND FLOOR PLAN	
designed	MRB	conçu
drawn	MBA	dessiné
approved	MRB	approuvé
Tender	JN	Submission
PMGSC Project Manager	Administrateur de projets TPSGC	
project number	15-567	no. du projet
drawing no.	A-1	no. du dessin

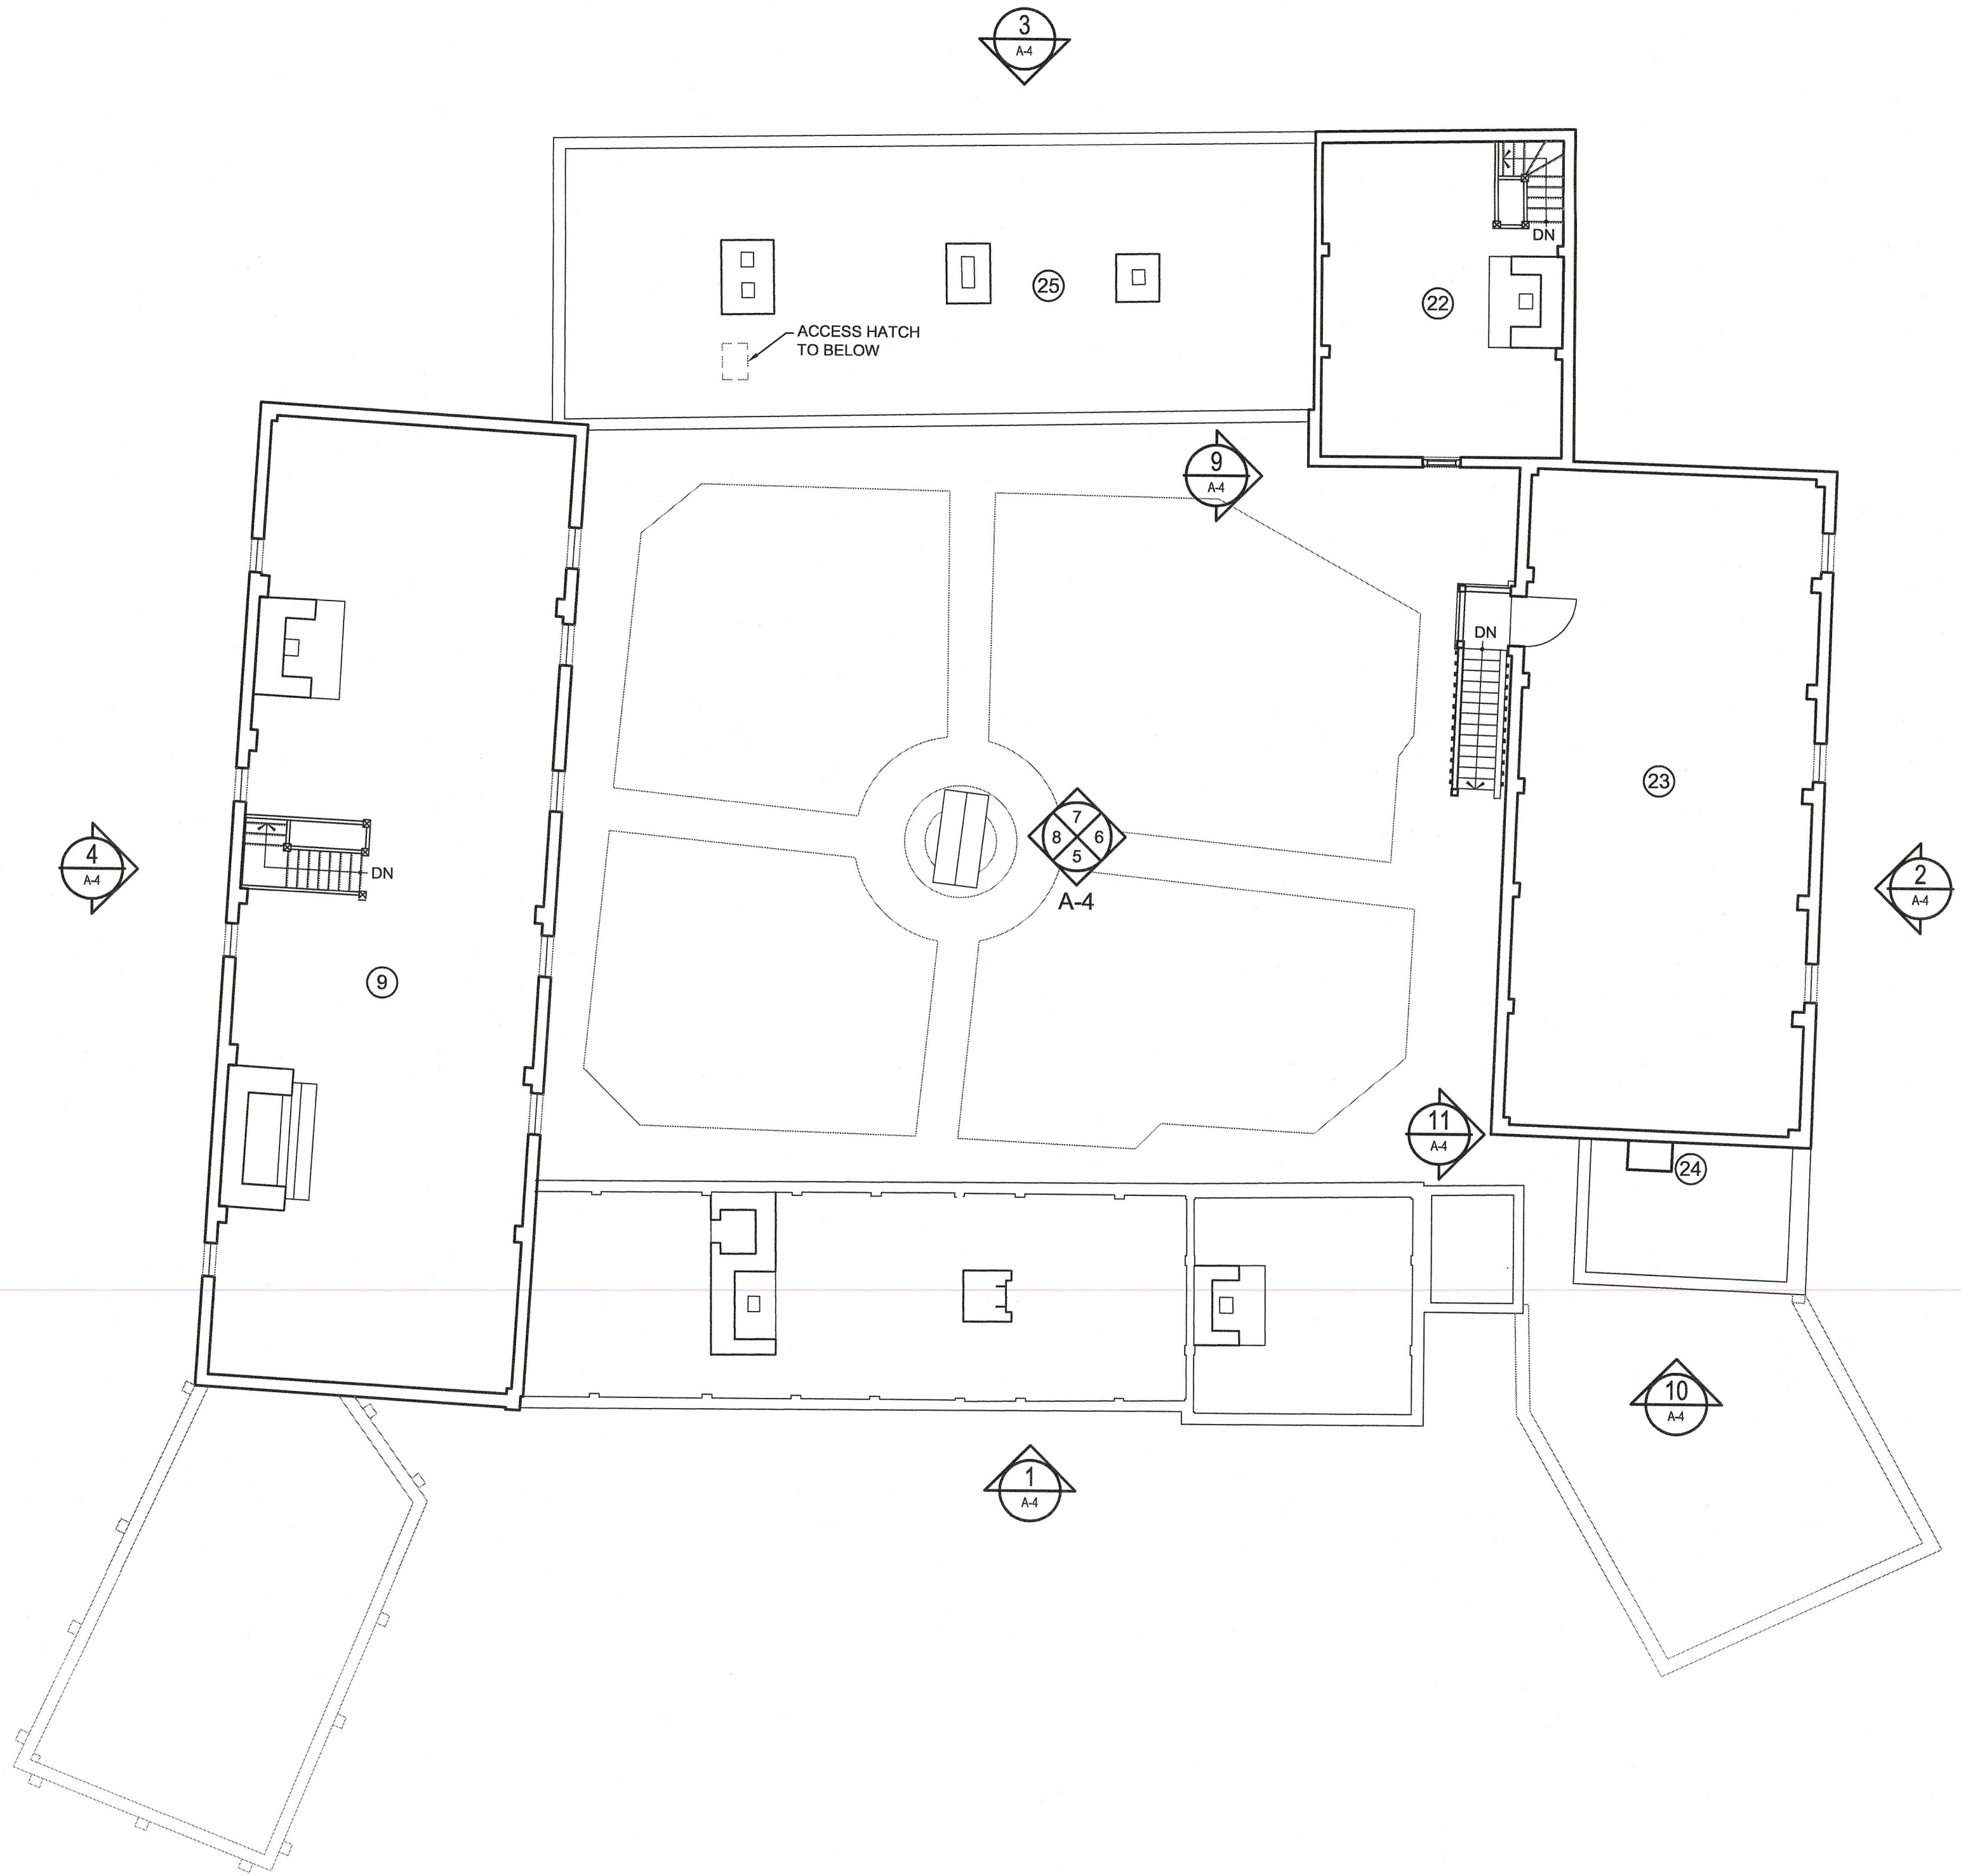


2 SECOND LEVEL  
 SCALE 1:100

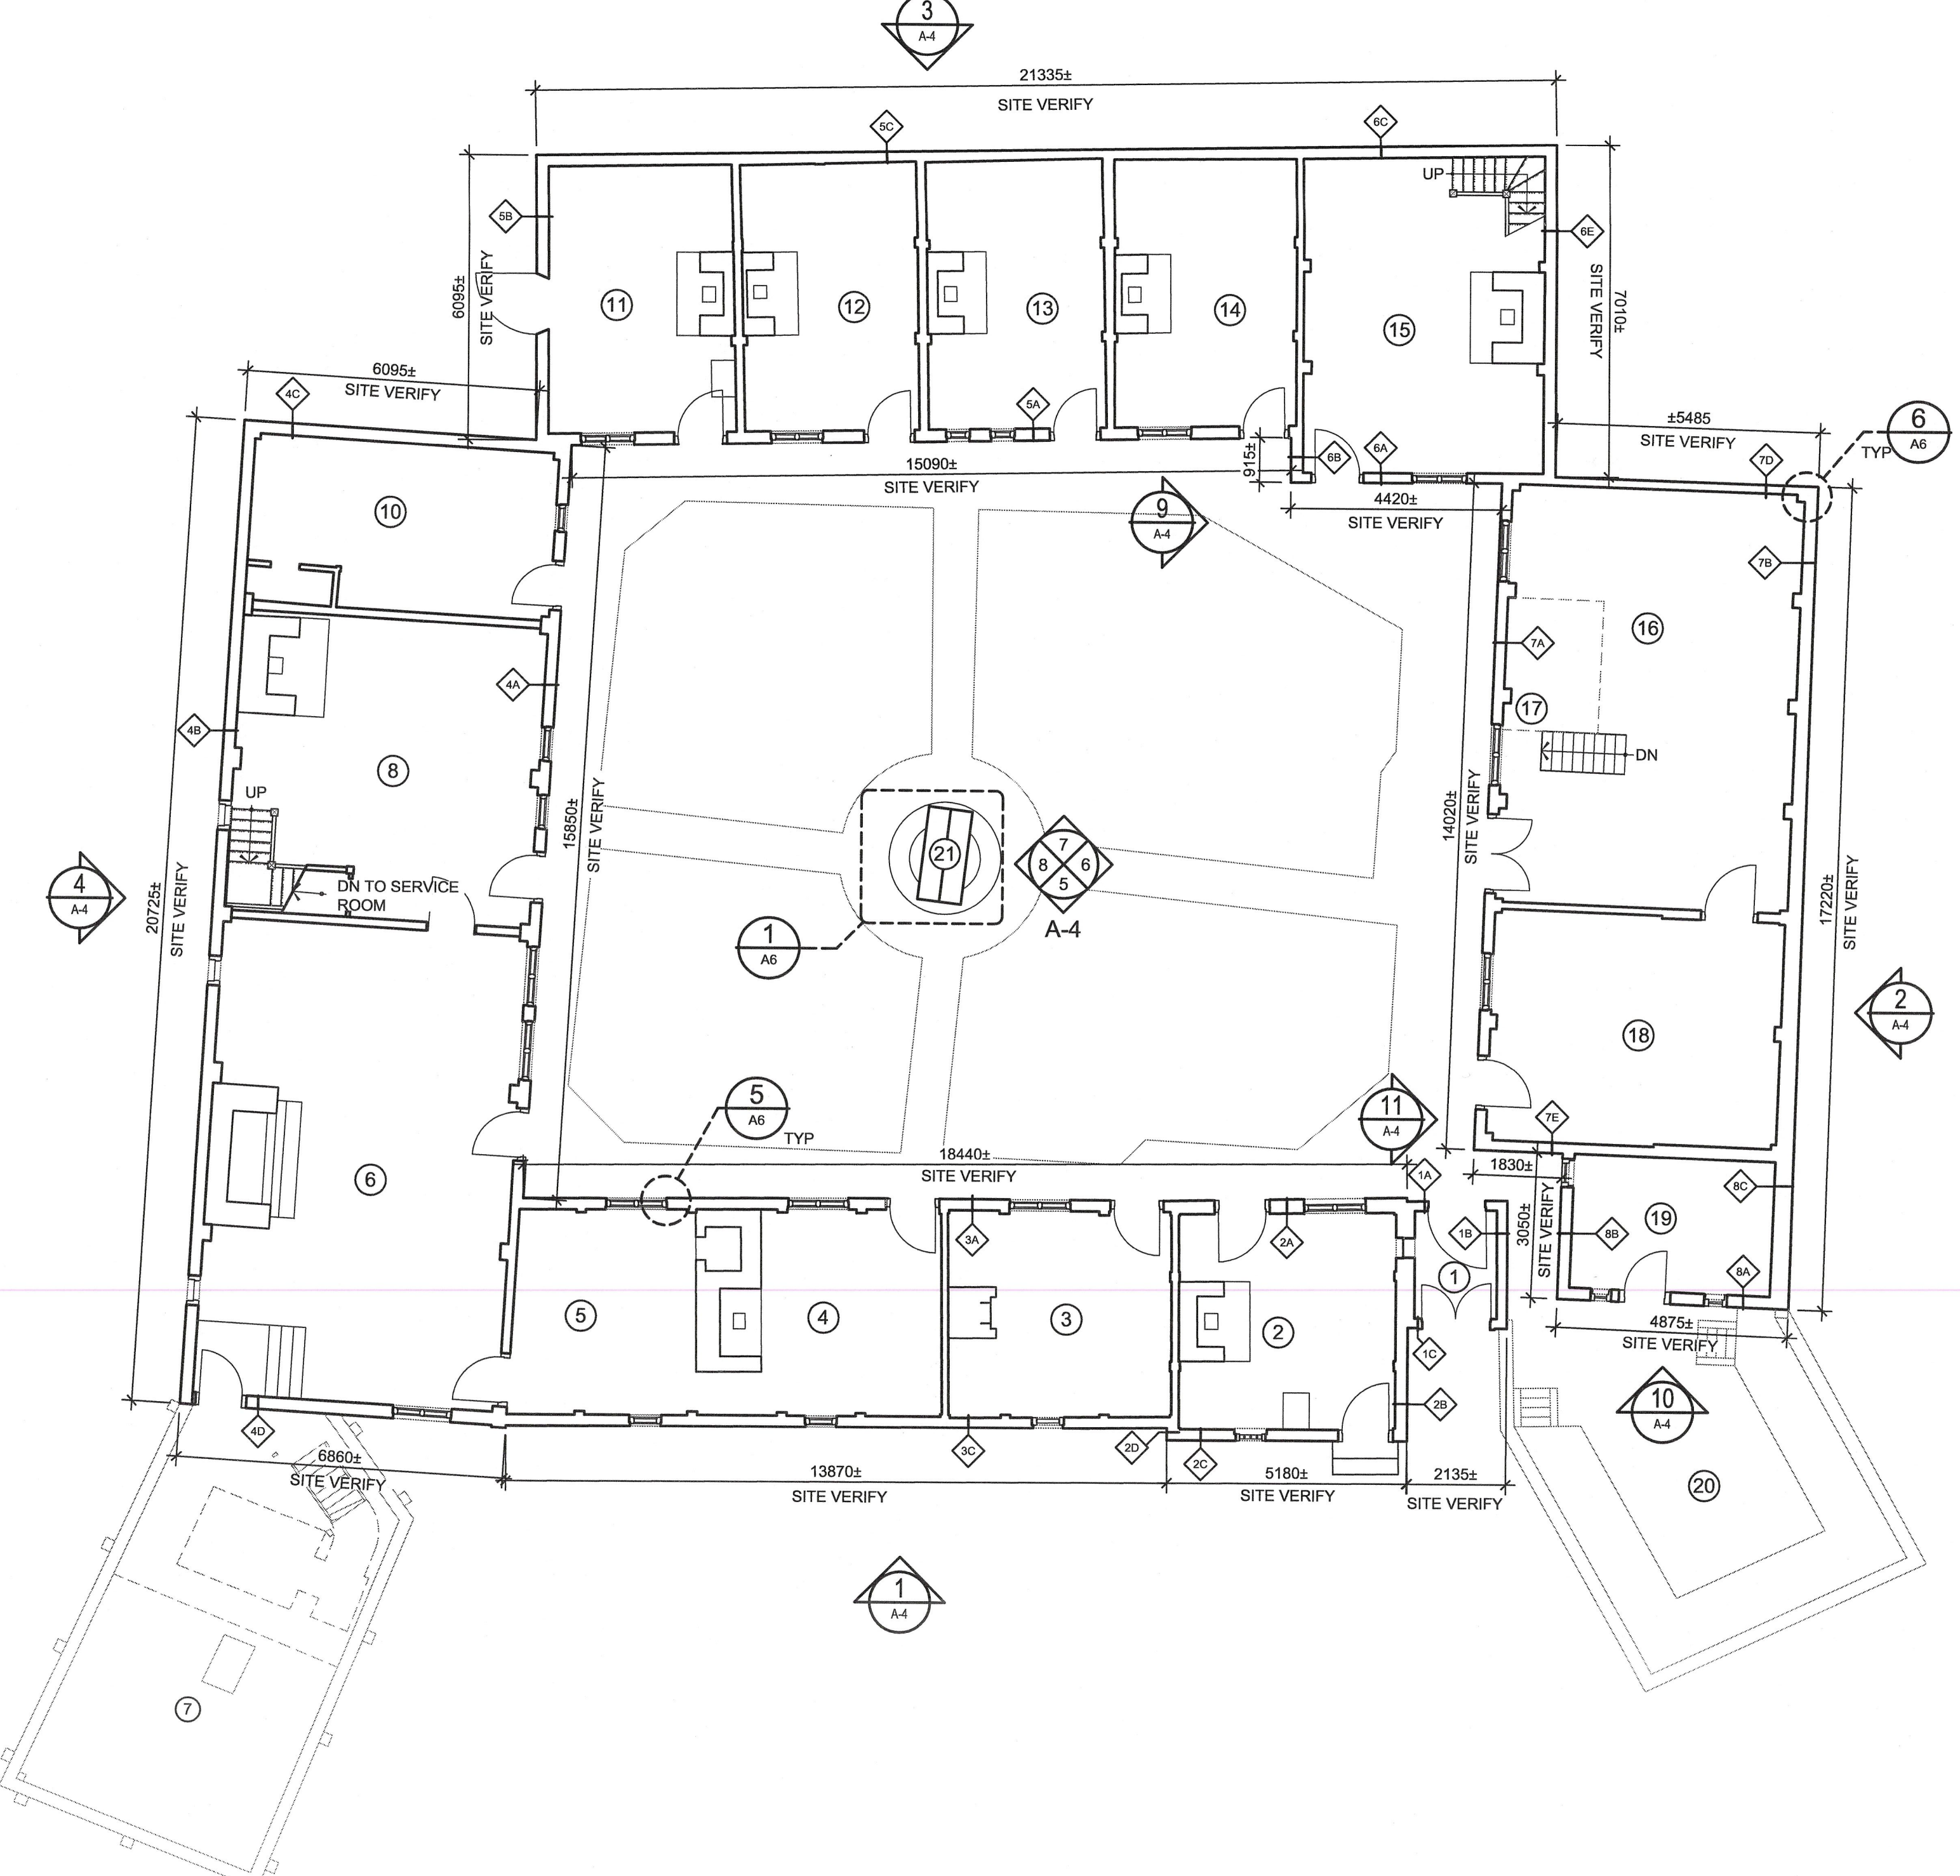

1 MAIN LEVEL  
 SCALE 1:100



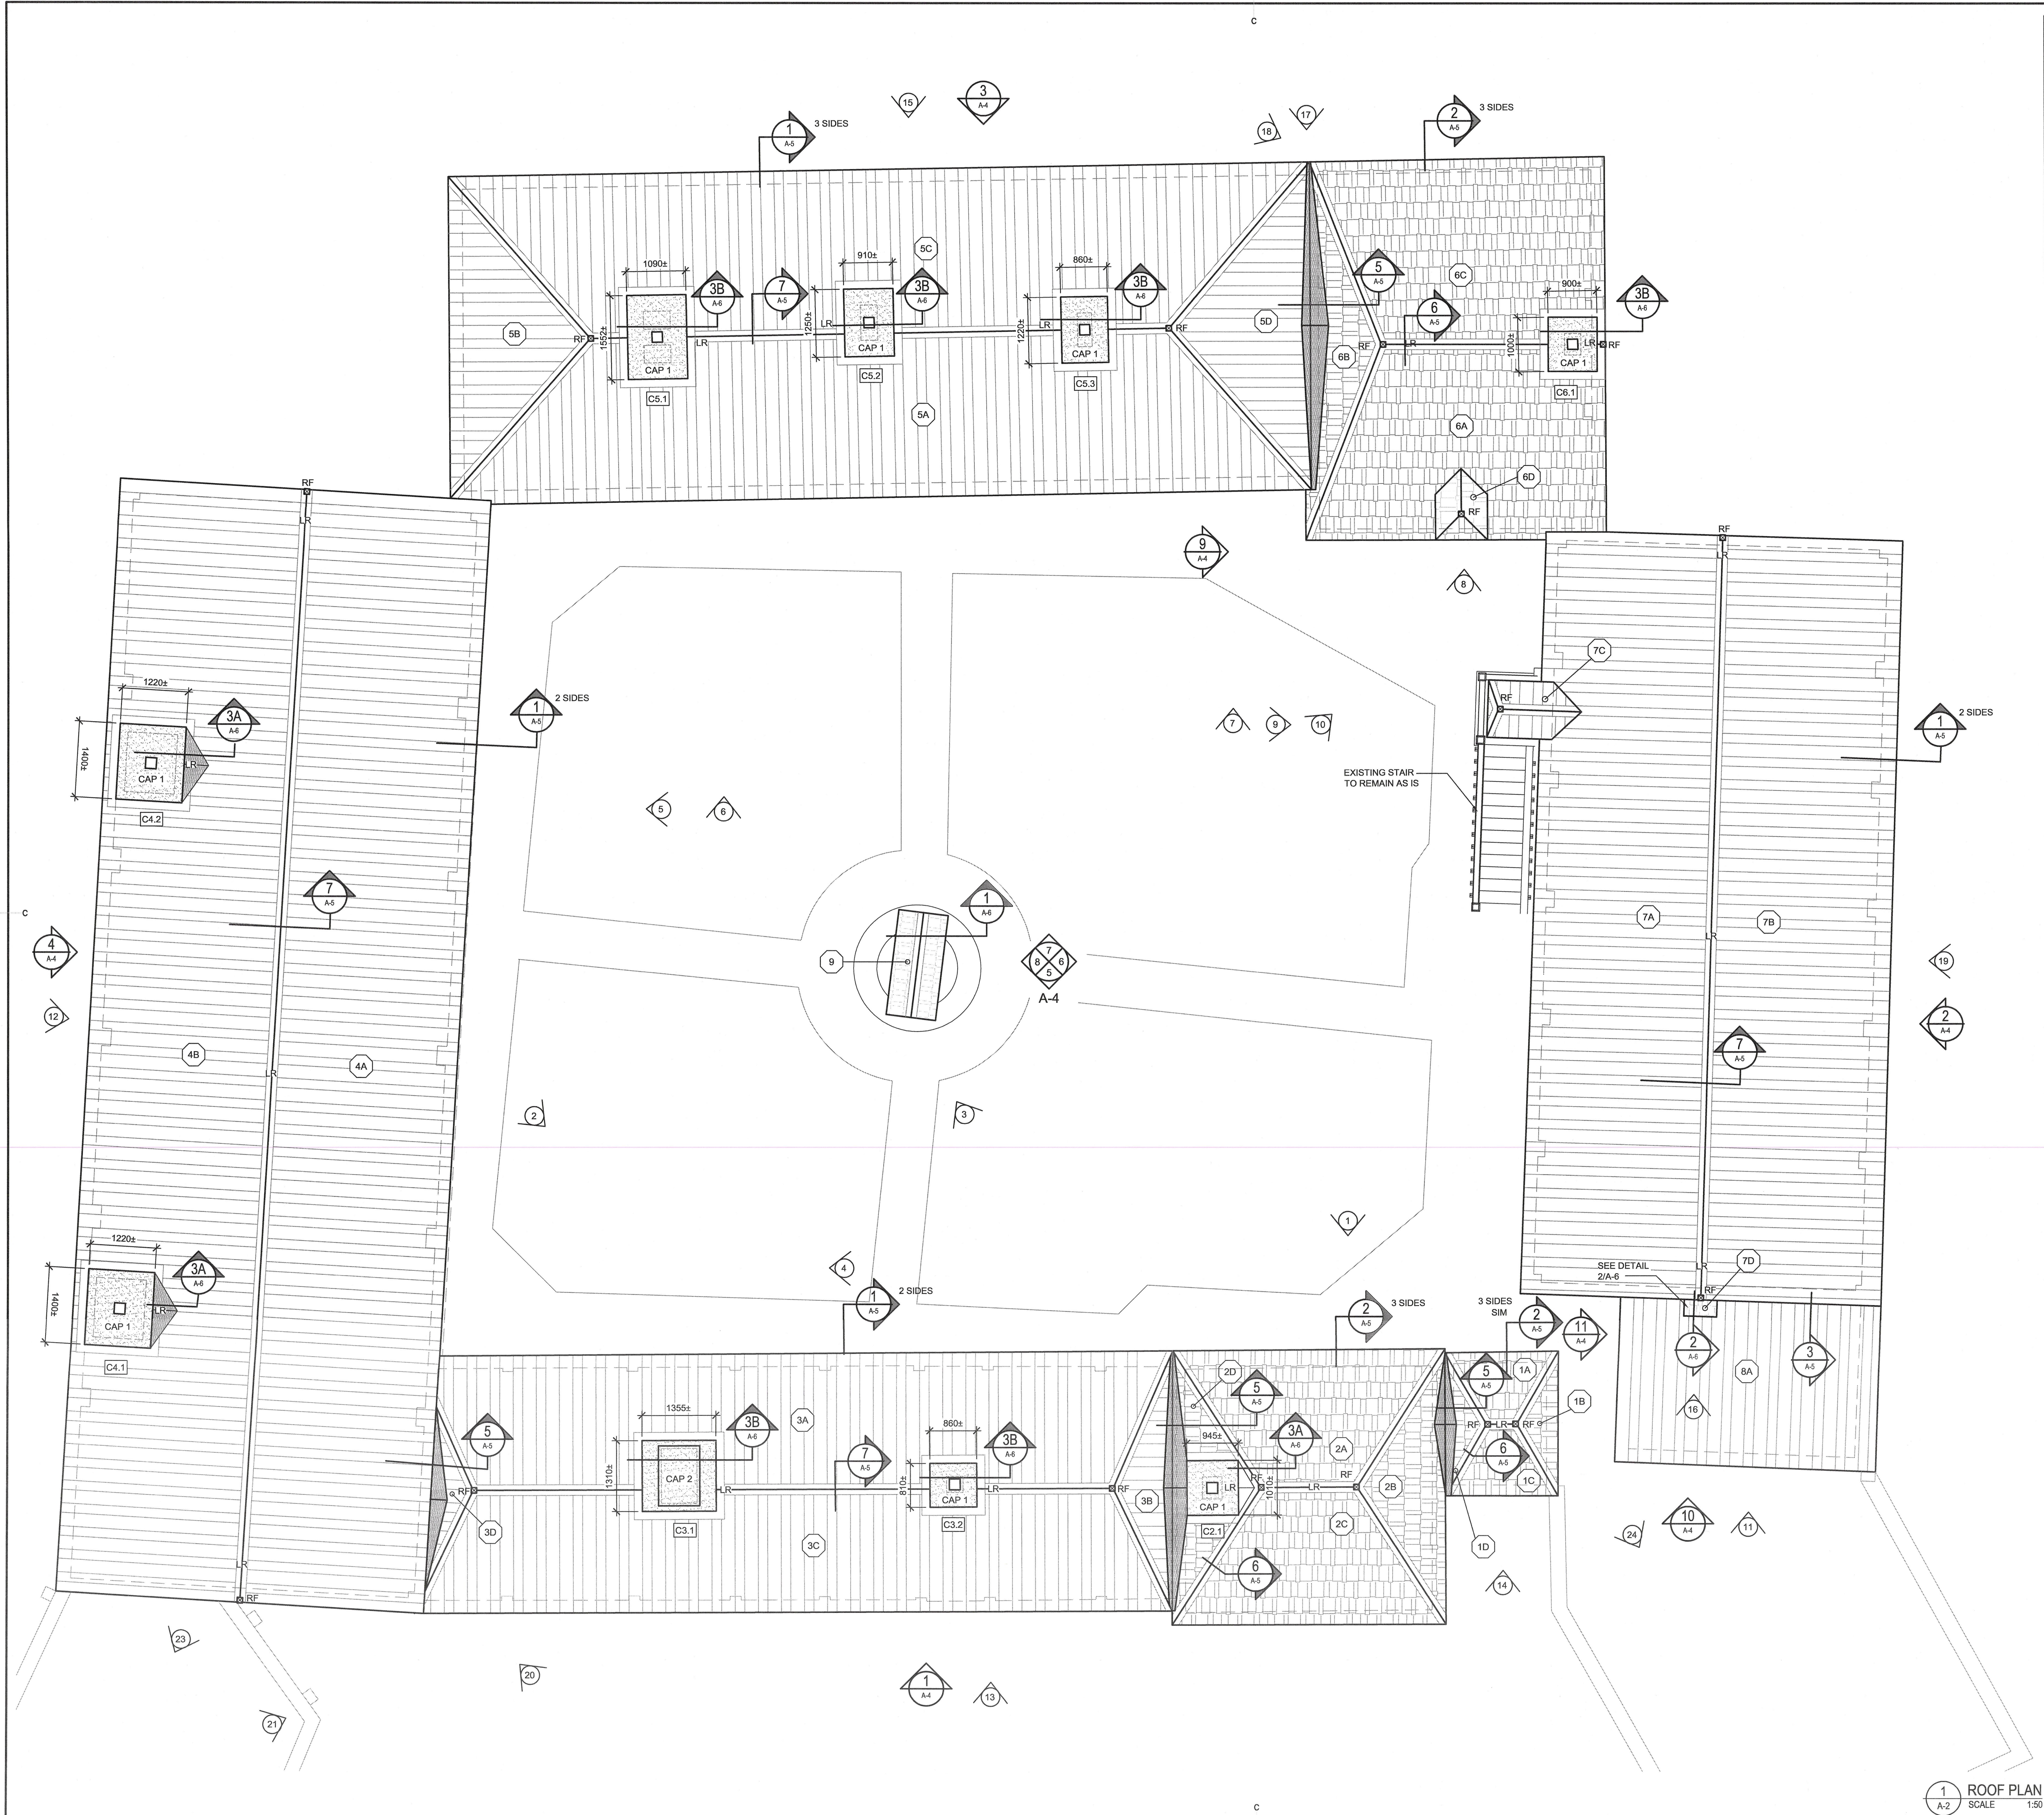

ROOFING SCHEDULE			
#A	BOARD & BATTEN	SHINGLE TYPES	
ROOF	A	B	C
1A			
1B			
1C			
1D			
2A			
2B			
2C			
2D			
3A			
3B			
3C			
3D			
4A			
4B			
5A			
5B			
5C			
5D			
6A			
6B			
6C			
6D			
7A			
7B			
7C			
7D			
8A			
9			

- ROOF SYSTEMS**
- SYSTEM A**
- BOARD AND BATTEN PINE BOARDS
  - UNDERLAYMENT MATERIAL
  - NEW AIR/VAPOUR BARRIER SYSTEM
  - EXISTING COAL TAR APPLIED FELT PAPER TO REMAIN
- SYSTEM B**
- PINE SHINGLES TO REPLACE EXISTING
  - UNDERLAYMENT MATERIAL
  - NEW AIR/VAPOUR BARRIER SYSTEM
  - EXISTING COAL TAR APPLIED FELT PAPER TO REMAIN
- SYSTEM C**
- OAK SHINGLES TO REPLACE EXISTING
  - UNDERLAYMENT MATERIAL
  - NEW AIR/VAPOUR BARRIER SYSTEM
  - EXISTING COAL TAR APPLIED FELT PAPER TO REMAIN

**GENERAL NOTES:**

TYPICAL ALL WOOD ROOFING REMOVED AND REPLACED AS SPECIFIED.

EXISTING TOP BOARDS TO BE REMOVED SO THEY CAN BE REUSED. THE INTENT IS TO REPLACE ALL THE BOTTOM BOARDS & INSPECT THE TOP BOARDS WITH A DEPARTMENTAL REPRESENTATIVE AND REUSE WHAT IS DETERMINED FIT TO REINSTALL, APPROXIMATELY 60%. THE ROOF BOARDS TO BE INSTALLED IN RANDOM WIDTH PATTERN TO MATCH EXISTING.

THERE IS A QUANTITY OF ROOFING BOARDS SUPPLIED BY THE OWNER AS FOLLOWS:

2400 METERS OF BOTTOM BOARDS IN 200,250 & 300mm WIDTHS. BOARD LENGTHS RANGE FROM 3.6m TO 4.9m. BOARD WIDTHS ARE APPROXIMATELY DISTRIBUTED AS FOLLOWS:

200mm = 27%  
250mm = 56%  
300mm = 15%

1450 METERS OF TOP BOARDS IN 200,250 & 300mm WIDTHS. BOARD LENGTHS RANGE FROM 3.6m TO 4.9m. BOARD WIDTHS ARE APPROXIMATELY DISTRIBUTED AS FOLLOWS:

200mm = 14%  
250mm = 72%  
300mm = 14%

SURPLUS BOARDS TO REMAIN PROPERTY OF PARKS CANADA.

ALL OTHER MATERIAL TO BE SUPPLIED BY CONTRACTOR.

NEW AIR BARRIER SYSTEM TO CONSIST OF THE FOLLOWING:

- FULLY APPLIED MEMBRANE LAYER TO SEAL & LEVEL OUT EXISTING COAL TAR PITCH
- PRIMER AS RECOMMENDED BY MANUFACTURER
- PEEL & STICK MOD. BIT. MEMBRANE

LEGEND

- #A NUMBERS INDICATES THE BUILDING LOCATION AND THE LETTER IS THE SIDE OF THAT ROOF
- C# NUMBERS INDICATES CHIMNEY LOCATION
- NEW ROOF CRICKET OR CHIMNEY SADDLE WITH LEAD CLADDING AS PER DETAILS
- RF DECORATIVE WOODEN ROOF FINALS - TO MATCH EXISTING.
- LR LIGHTING ROD LOCATIONS CONFIRM EXISTING CONDITION CONTRACTOR TO REMOVE AND RESTORE ALL COMPONENTS OF THE EXISTING SYSTEM(RODS & CABLES) AS REQUIRED TO COMPLETE THE WORK AND RECONNECT SIMILAR TO EXISTING. ALL WORK TO BE AS PER CSA-B72.
- # PHOTO REFERENCE (A-3)

ORDER OF ROOF CONSTRUCTION

NEW BOARDS TO BE USED UNTIL SUPPLY IS GONE (IN ORDER OF LIST BELOW)

- 3A
- 3B
- 3C
- 3D
- 4A
- 4B
- 4C
- 4D
- 5A
- 5B
- 5C
- 5D
- 6A
- 6B
- 6C
- 6D
- 7A
- 7B
- 7C
- 7D
- 8A
- 8B
- 8C
- 8D
- 9

0	ISSUED FOR TENDER	SEPT 8 2017
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revisions		date
project		project

RENEWAL PROJECT  
PORT ROYAL  
HABITATION  
NATIONAL HISTORIC SITE  
PORT ROYAL, NS

drawing dessin

HABITATION  
ROOF PLAN

designed MRB conçu

date

drawn MBA dessiné

date

approved MRB approuvé

date

Tender JN

FWGSC Project Manager Administrateur de projets TPWGC

project number no. du projet

drawing no. A-2 no. du dessin





PHOTO #1

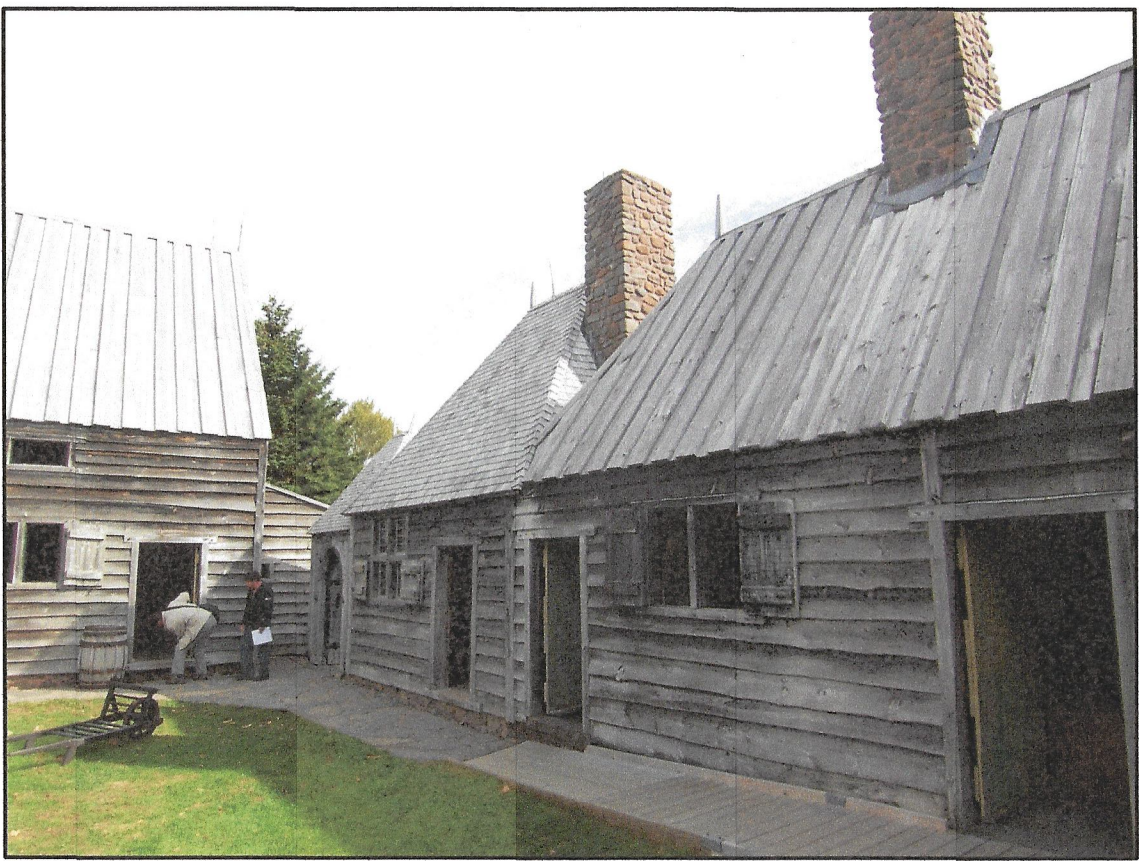


PHOTO #2



PHOTO #3



PHOTO #4



PHOTO #5

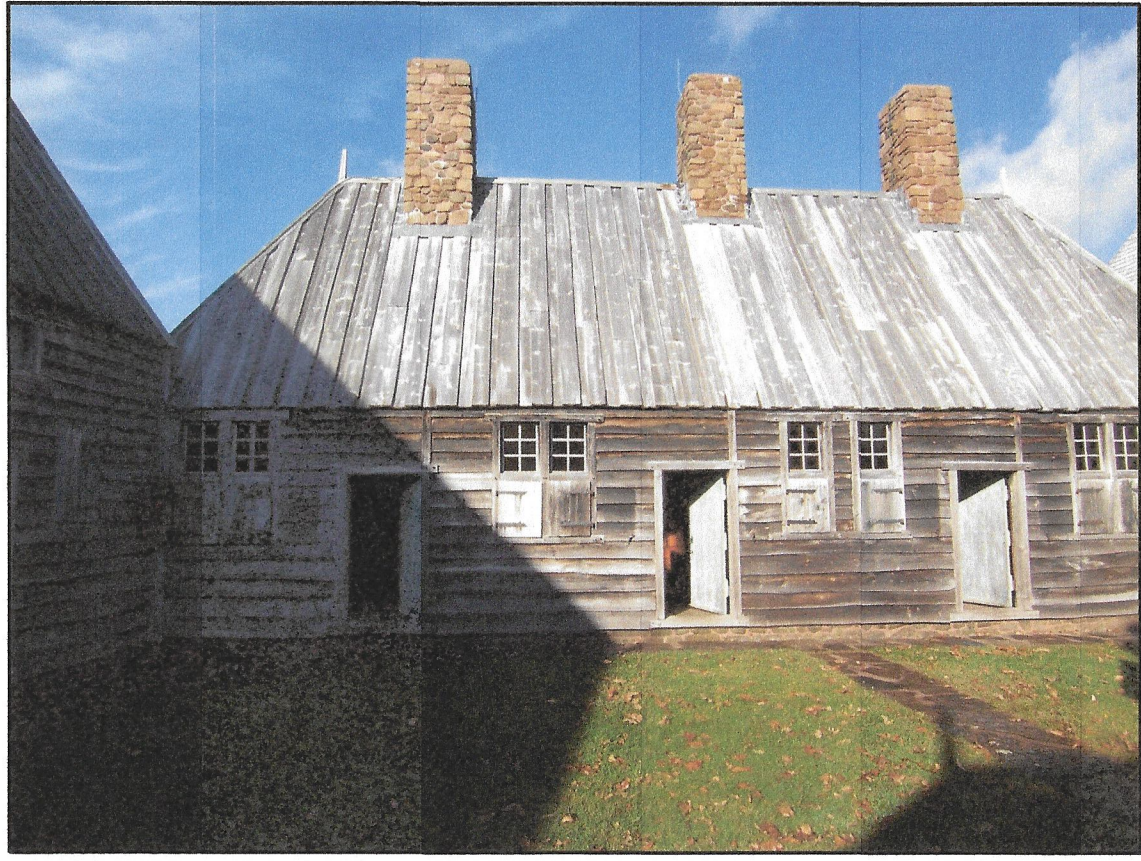


PHOTO #6



PHOTO #7



PHOTO #8



PHOTO #9



PHOTO #10

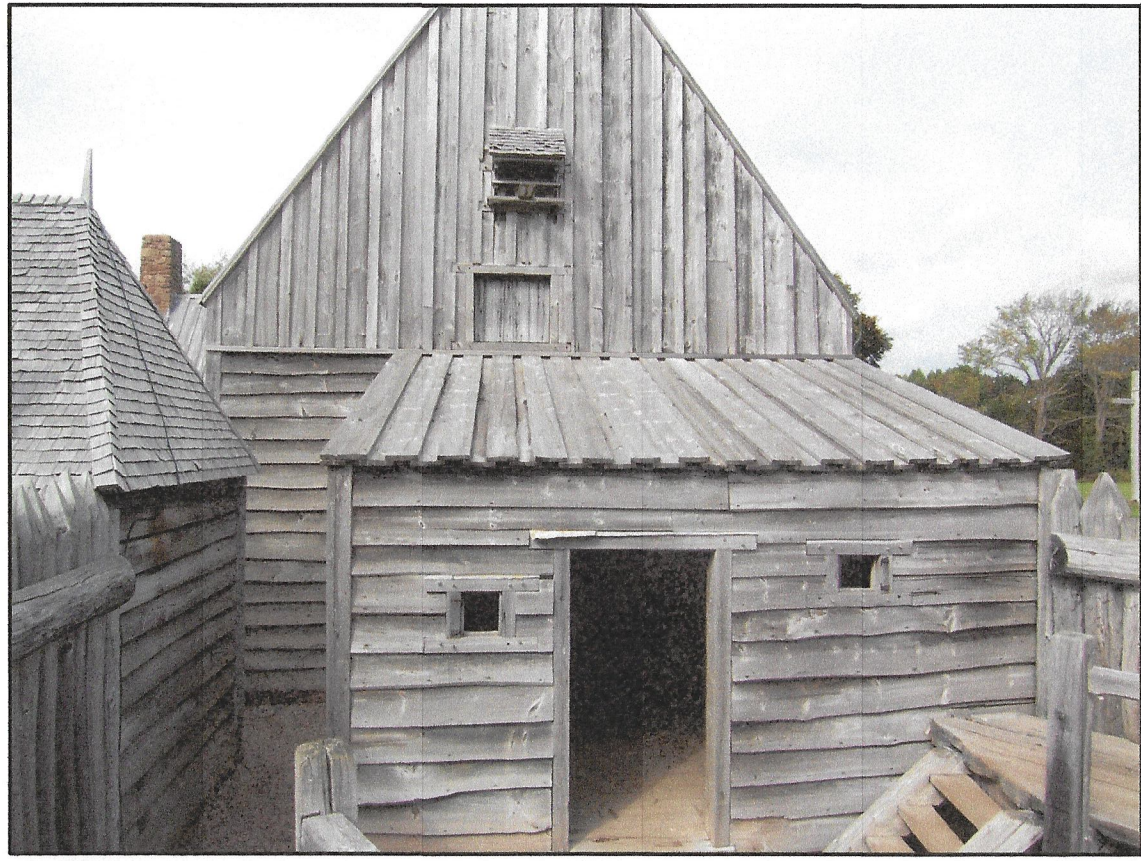


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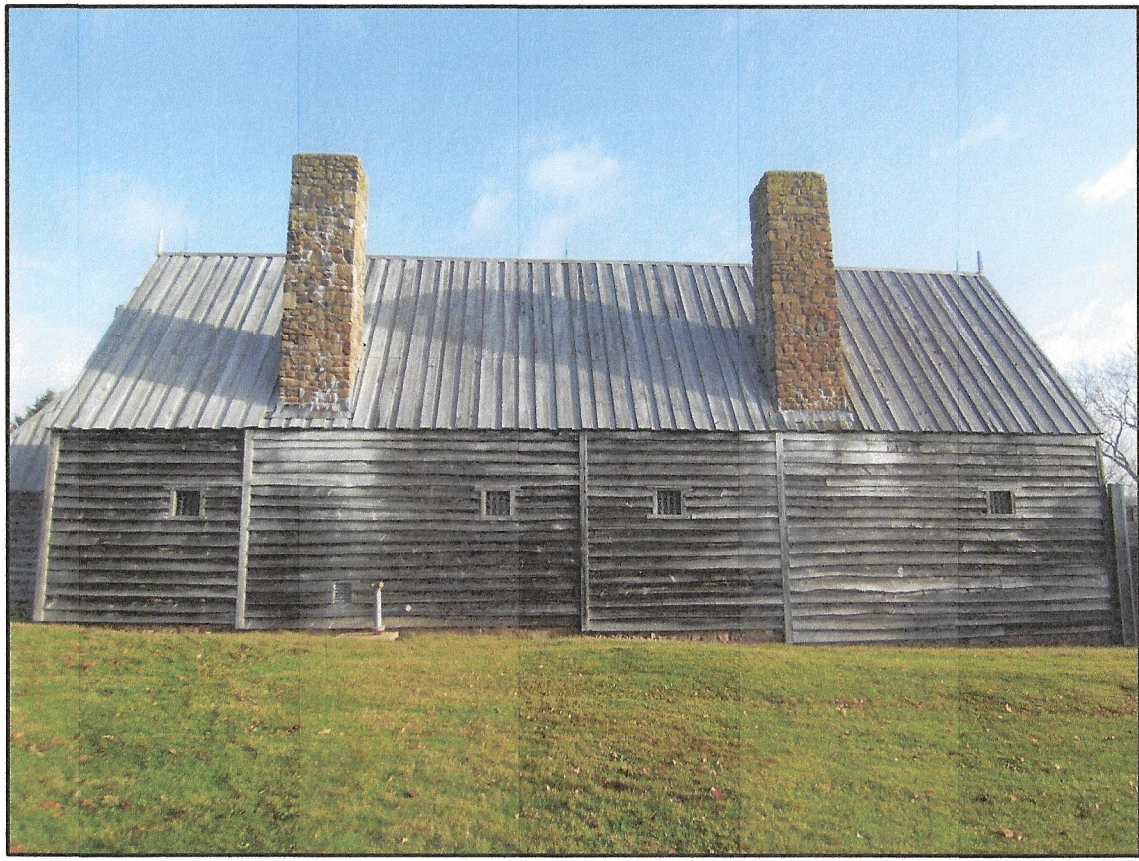


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PHOTO #13

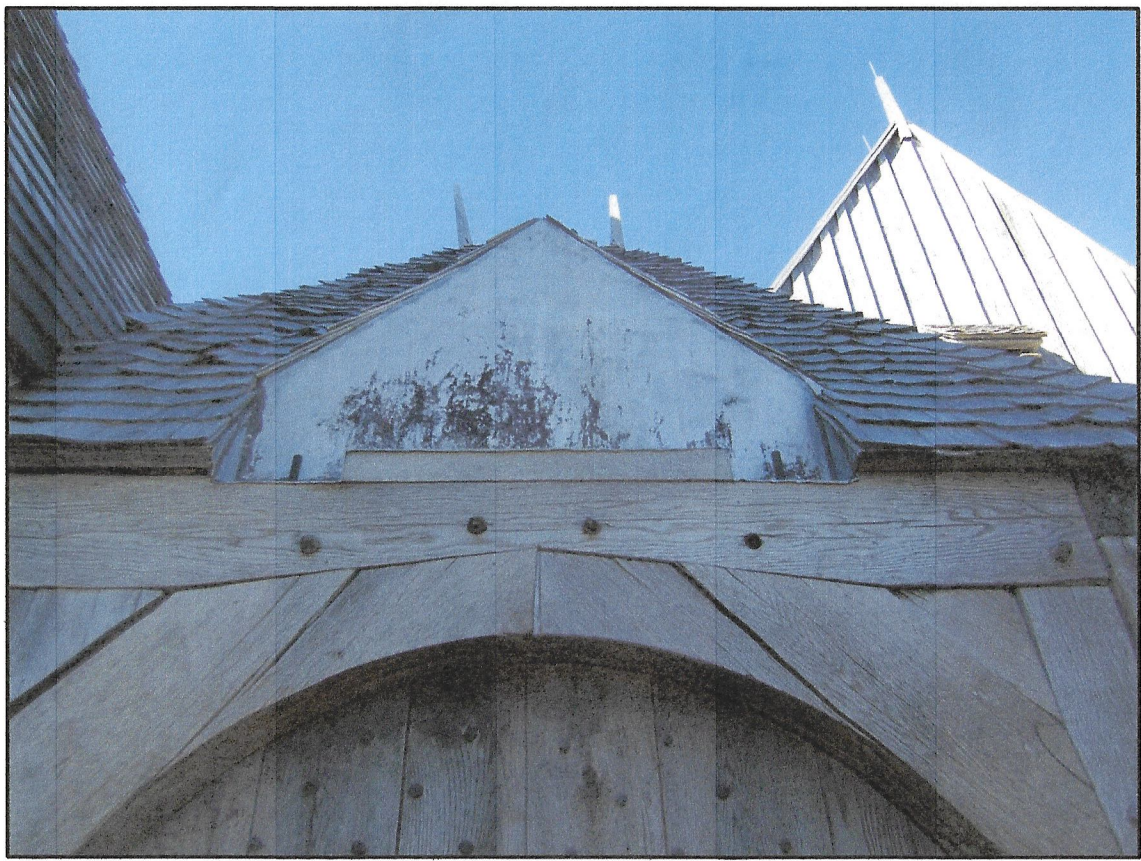


PHOTO #14



PHOTO #15

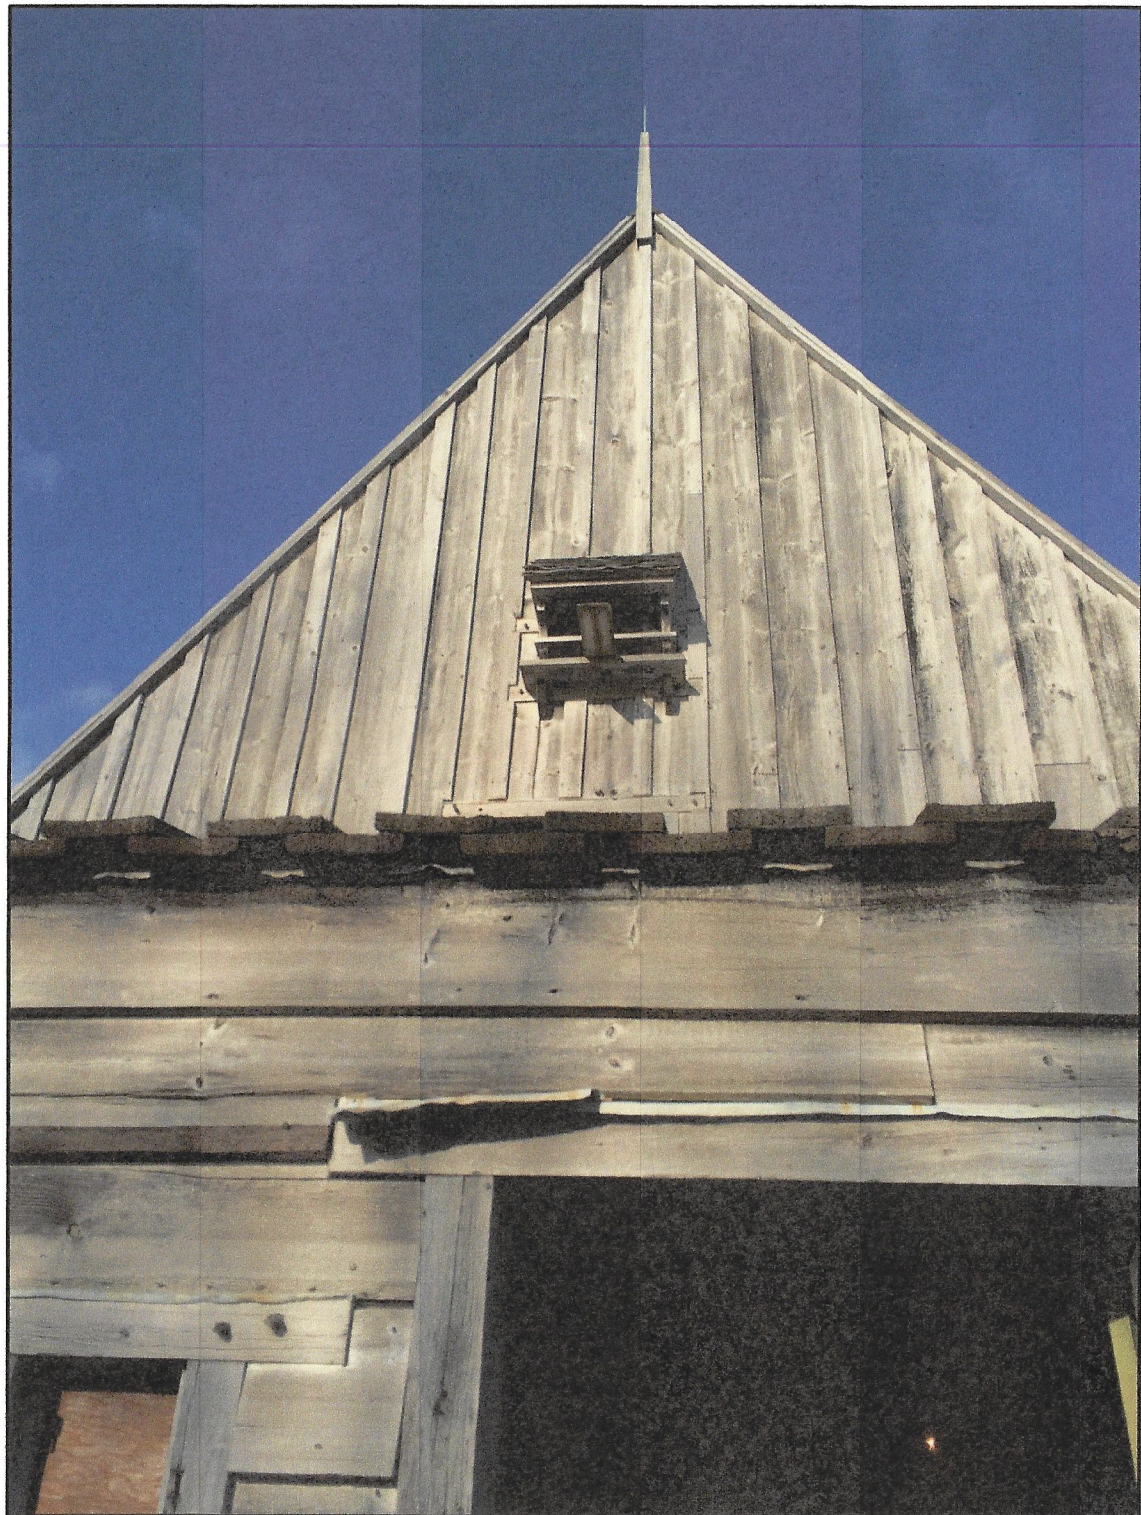


PHOTO #16



PHOTO #17

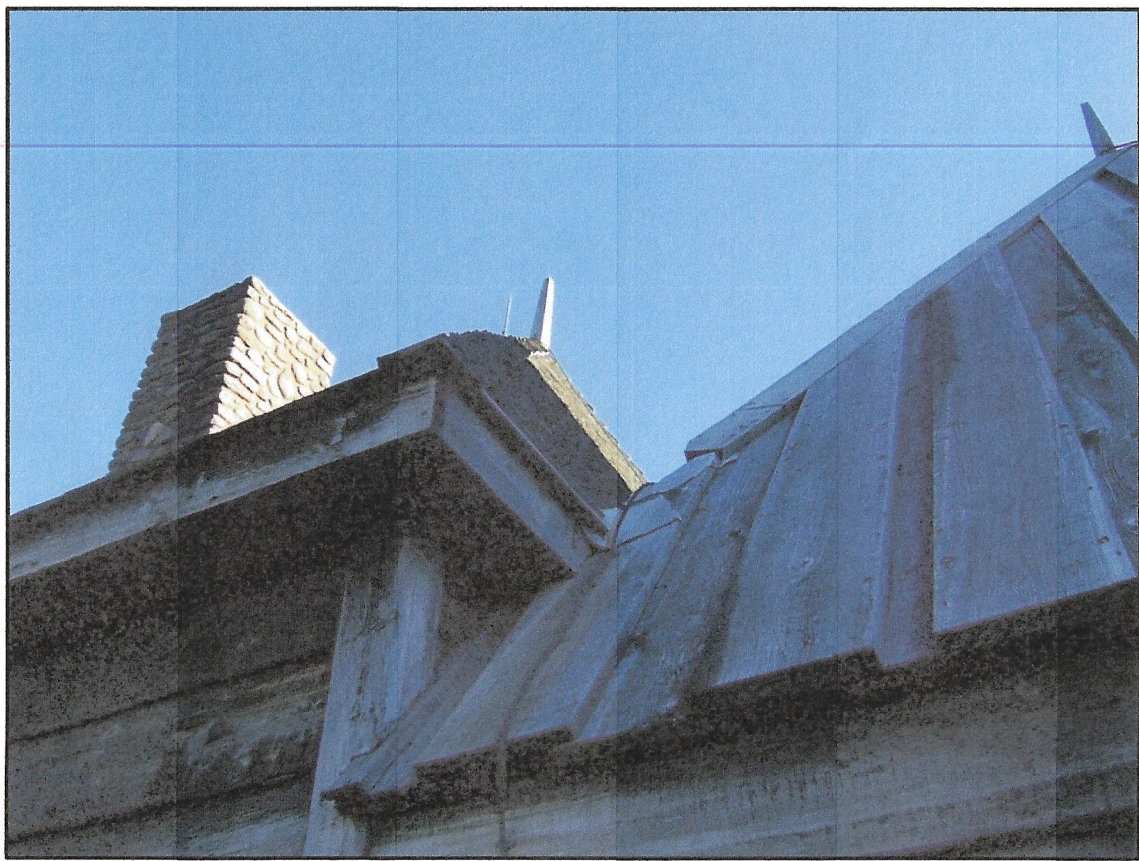


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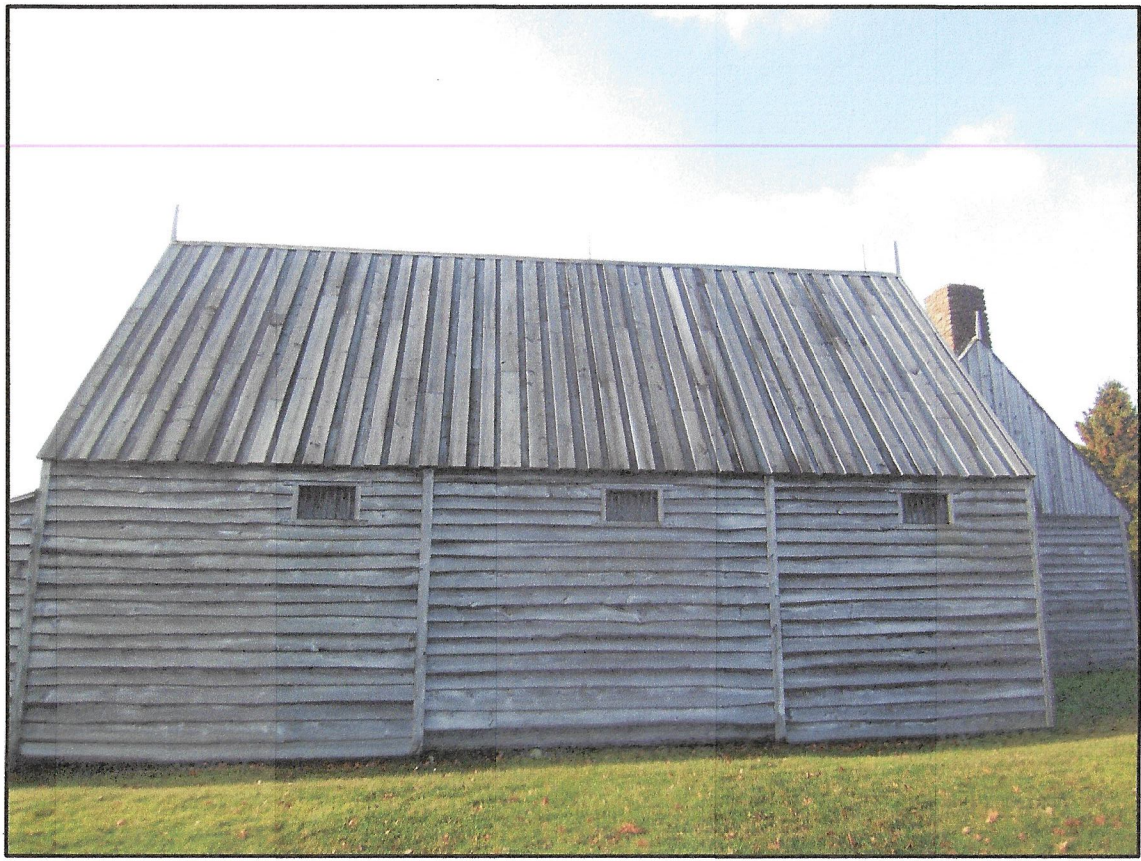


PHOTO #19



PHOTO #20

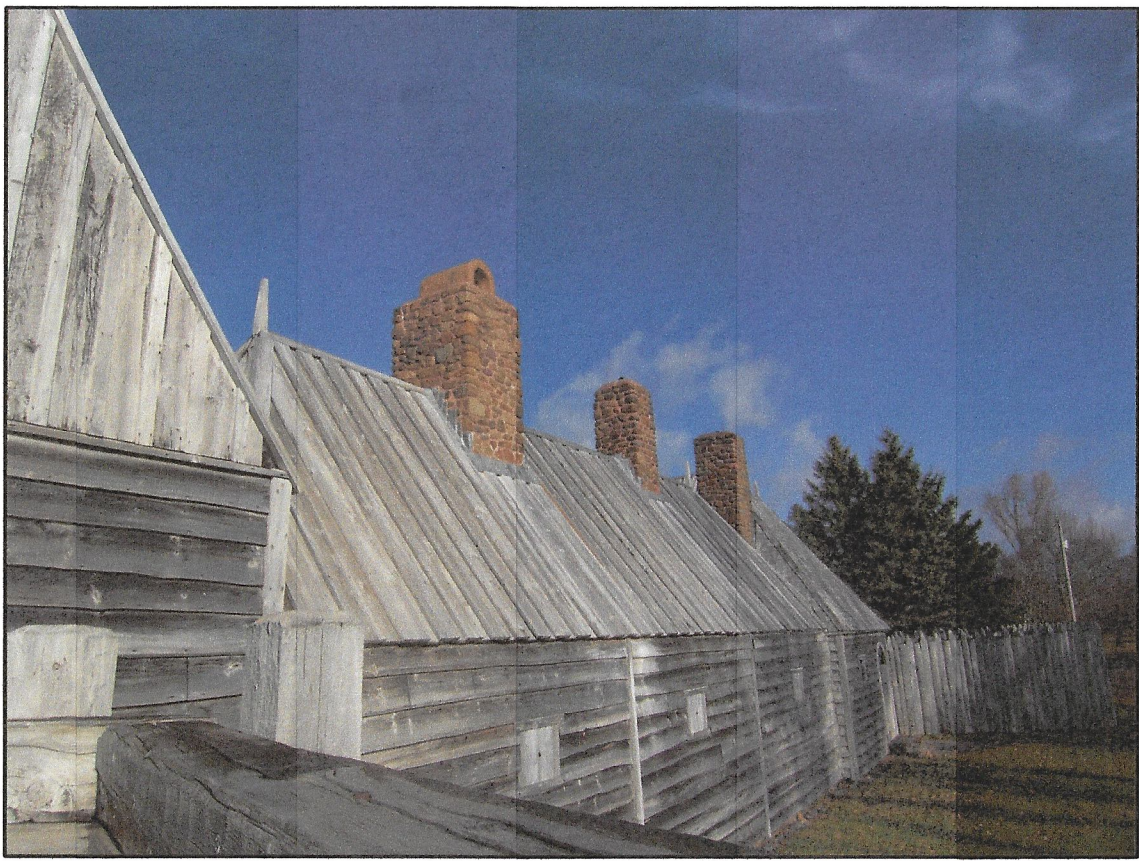


PHOTO #21



PHOTO #22



PHOTO #23



PHOTO #24

0	ISSUED FOR TENDER	SEPT 8 2017
revisions		date
project	RENEWAL PROJECT PORT ROYAL HABITATION NATIONAL HISTORIC SITE PORT ROYAL, NS	
		projet

drawing dessin  
**HABITATION  
PHOTOGRAPHS**

designed	MRB	conçu
date		
drawn	ARD	dessiné
date		
approved	MRB	approuvé
date		
Tender	JN	Soumission
PWSC Project Manager	Administrateur de projets TPSC	
project number	15-567	no. du projet
drawing no.	A-3	no. du dessin



EACH BOARD DEEMED TO BE REPLACED; WILL NEED TO BE REPLACED EXISTING. THE PAINT IS TO BE REPAIRED AS REQUIRED, WITH NEW SHEET AIR BARRIER, NEW SIDING TO BE INSTALLED TO REPLICATE EXISTING. THE QUANTITY OF SIDING BOARDS SUPPLIED BY THE OWNER AS FOLLOWS: 300 METERS OF TAPERED SIDING BOARDS THICKNESS FOR 30mm AT ONE EDGE TO APPROX. 6mm AT THE OPPOSITE EDGE. WIDTHS OF 350,400,450 AND 500mm. THE SIDING BOARDS WILL HAVE 2 "LIVE EDGES" REPLICATING EXISTING SIDING. BOARD LENGTHS TO VARY FROM 3.6m TO 4.9m. LENGTHS AND WIDTHS TO BE EVENLY DISTRIBUTED THROUGHOUT THE ORDER. NEW SIDING IN THE GABLE ENDS BOARD & BATTEN SYSTEM TO REPLICATE EXISTING.

designed	MRB		conqu
date			
drawn	MBA		dessein
date			
approved	MRB		approuvé
date			
Tender			Soumission
JN			
PWGSC Project Manager		Administrateur de projets TPSGC	
project number	15-567		no. du projet
drawing no.			no. du dessin



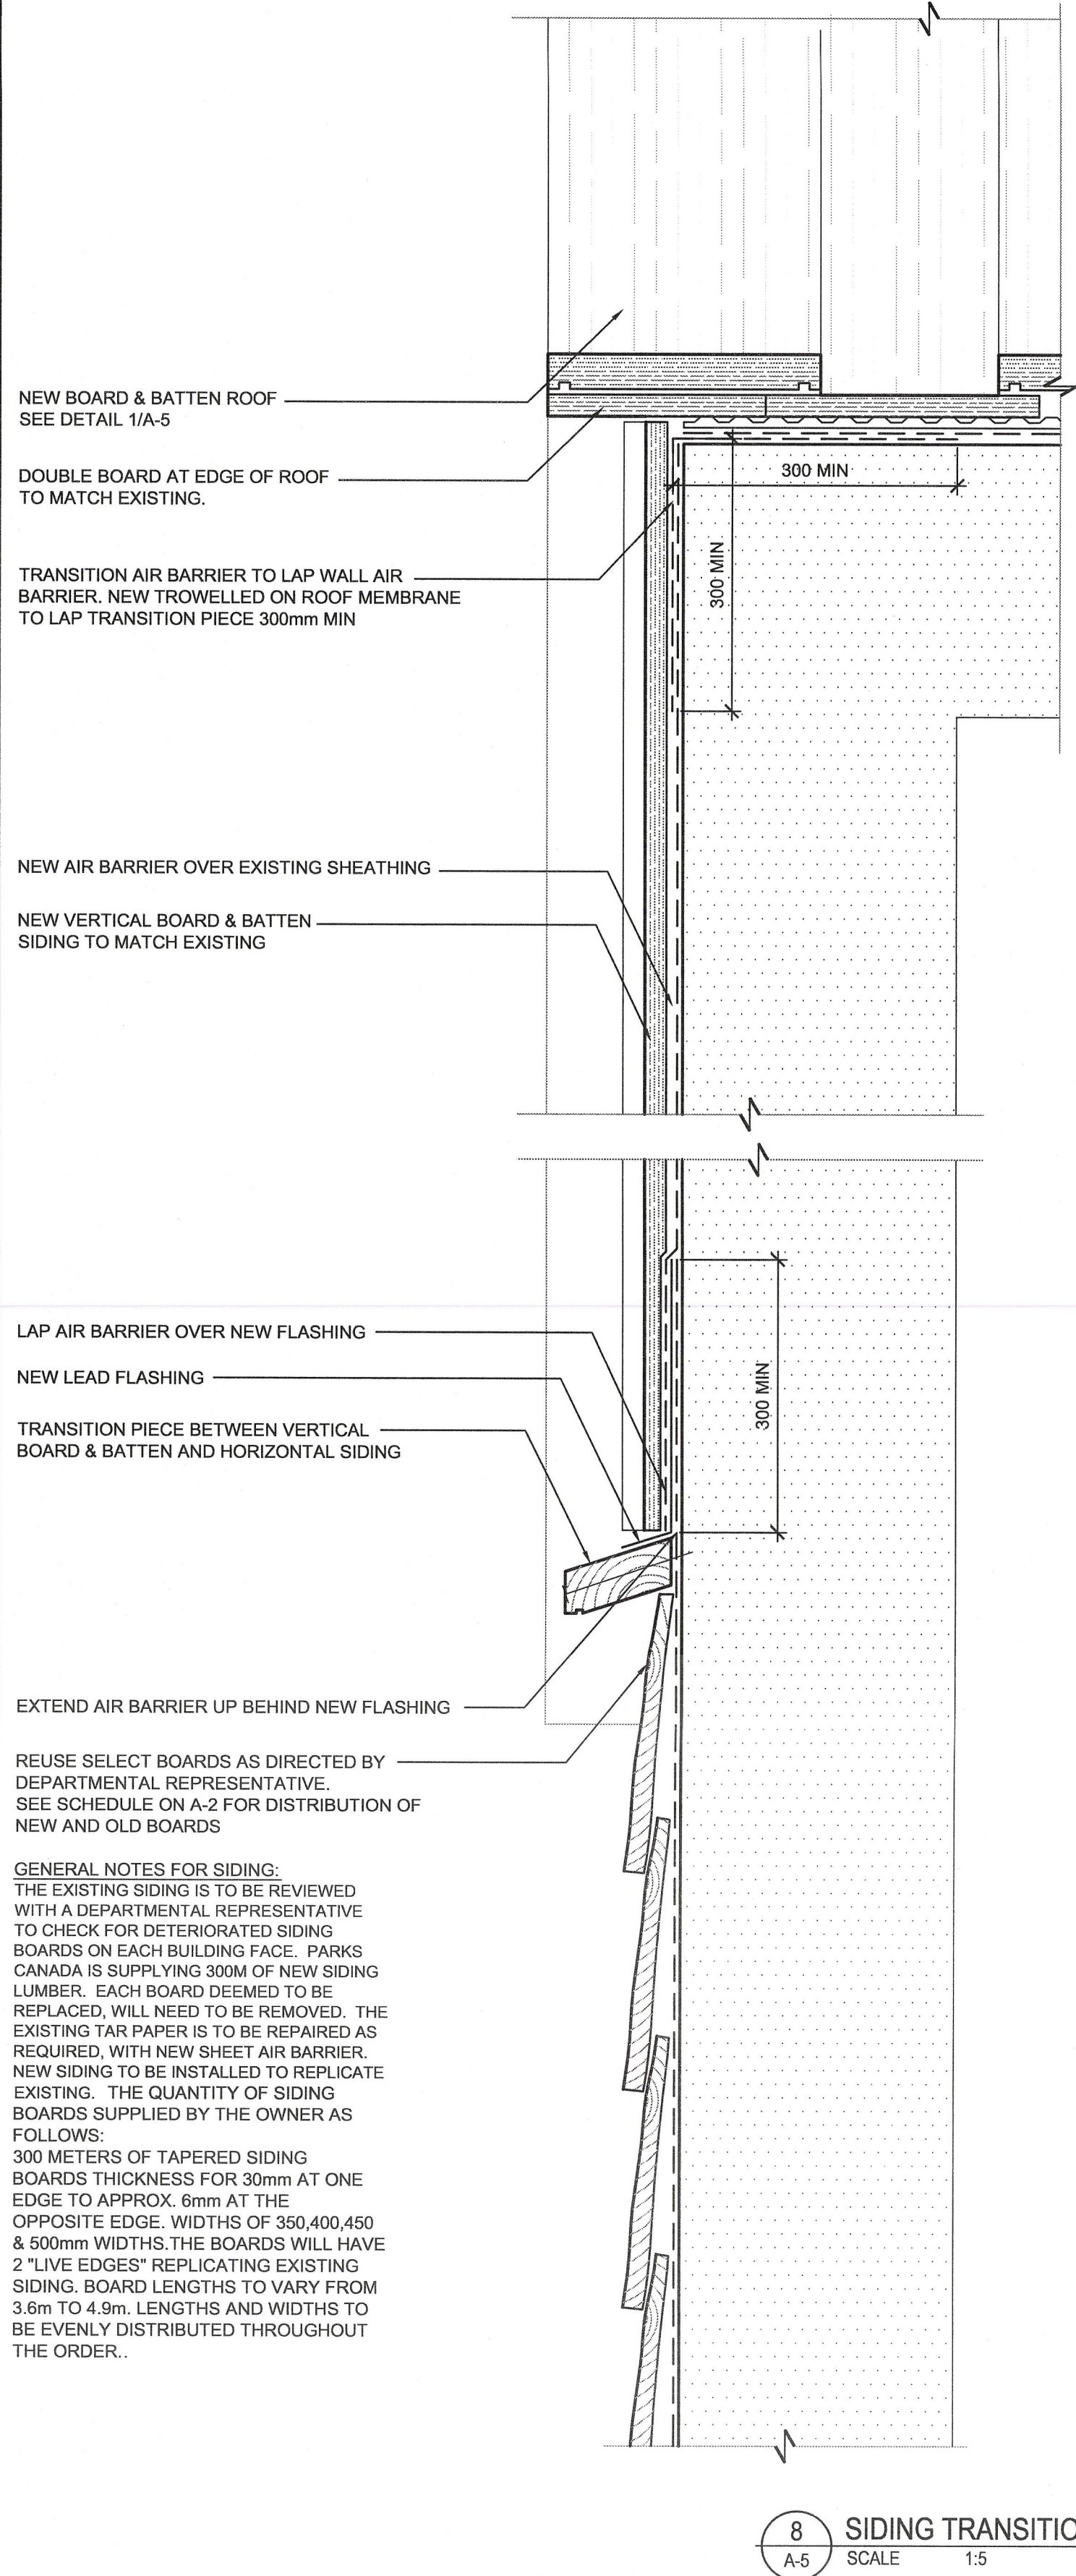
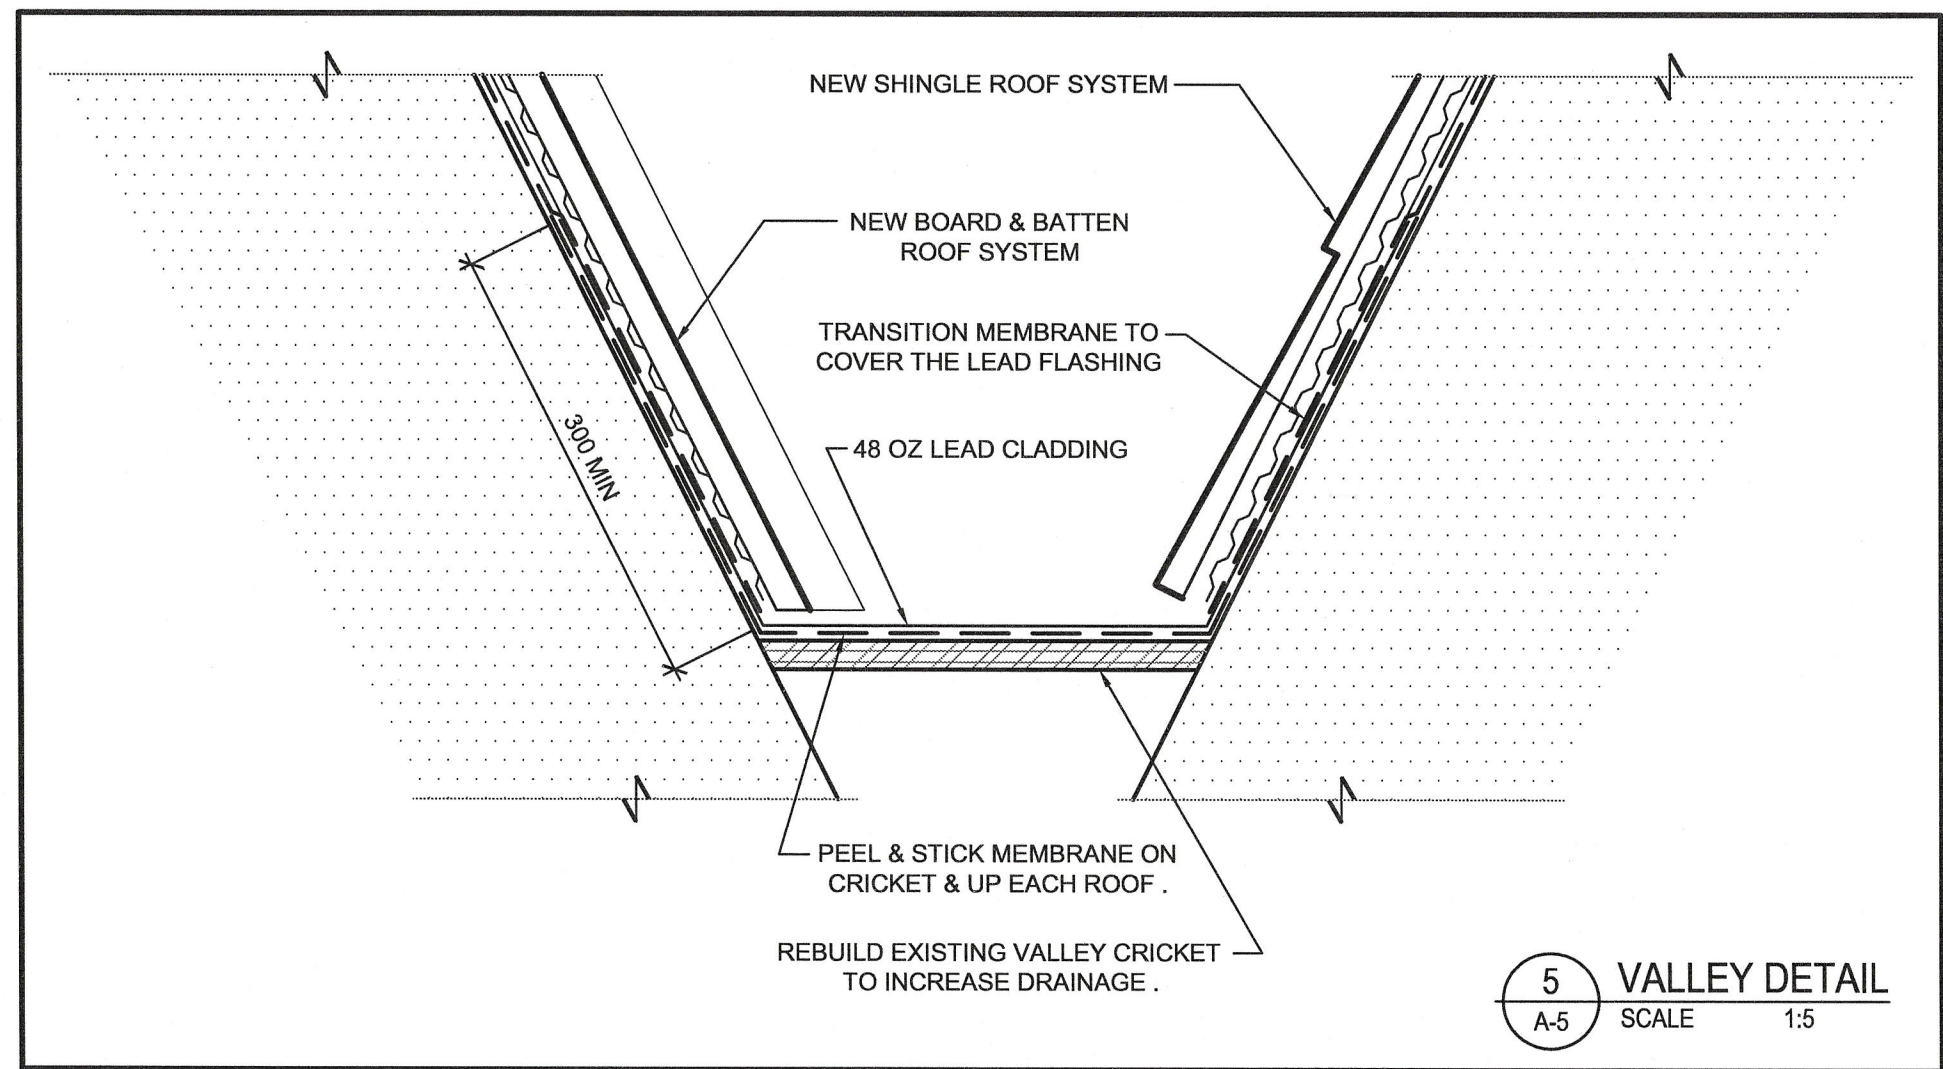
PWGSC B1 (2004)

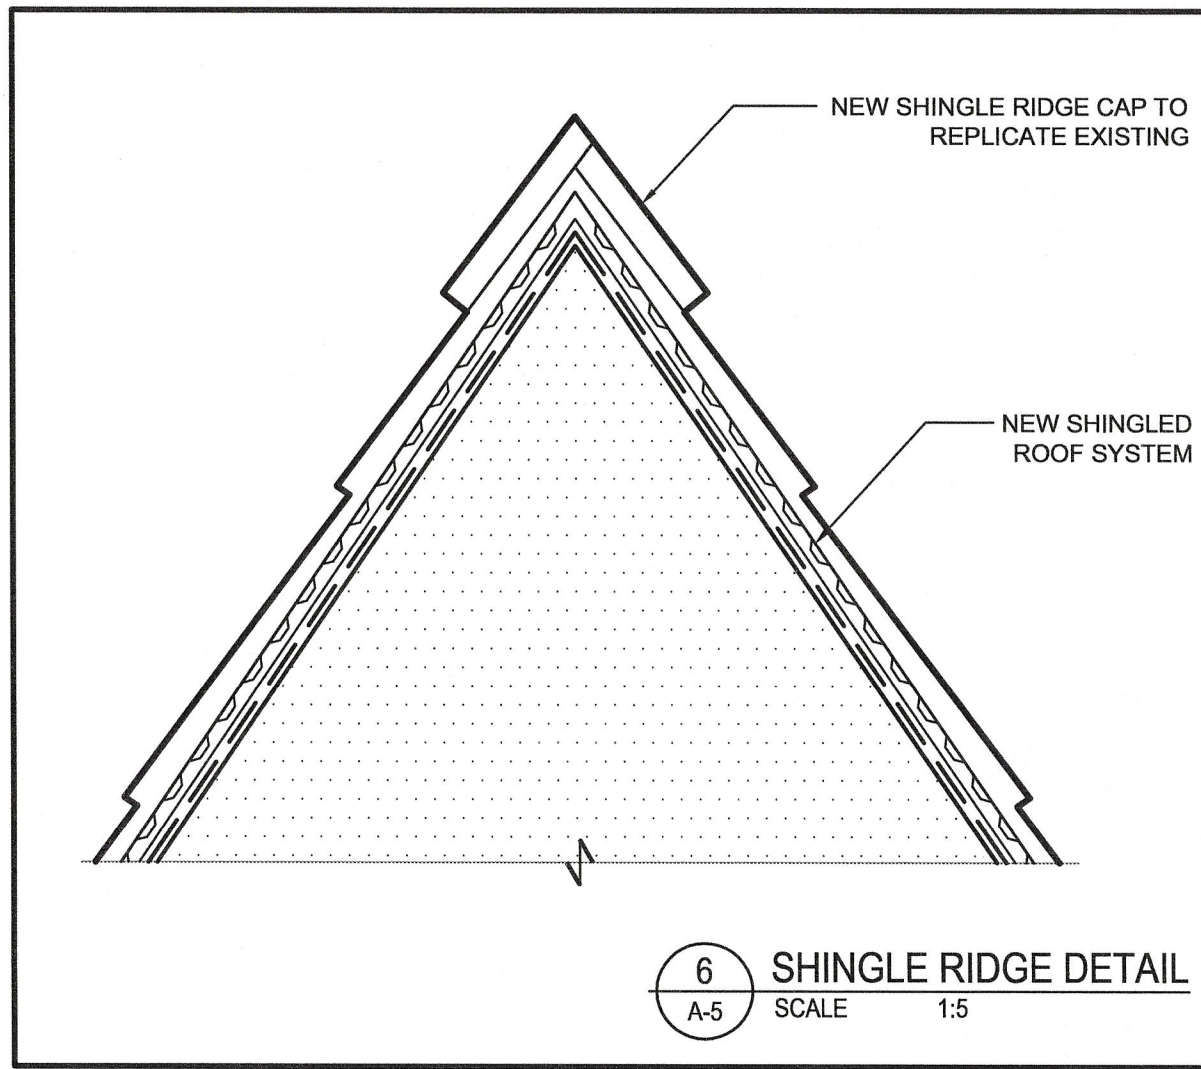Figure 1 is a line graph showing the change in the number of eggs per female over 200 days for three groups: Control (solid line), 100 mg/kg (dashed line), and 200 mg/kg (dotted line). The y-axis represents the number of eggs per female, ranging from 0 to 100. The x-axis represents time in days, ranging from 0 to 200. The Control group shows a steady increase in egg count, reaching approximately 100 eggs by day 200. The 100 mg/kg group shows a similar trend but with a slight delay in reaching the peak. The 200 mg/kg group shows a significant reduction in egg count, reaching approximately 50 eggs by day 200.




GENERAL TIMBER & FASTENING NOTES

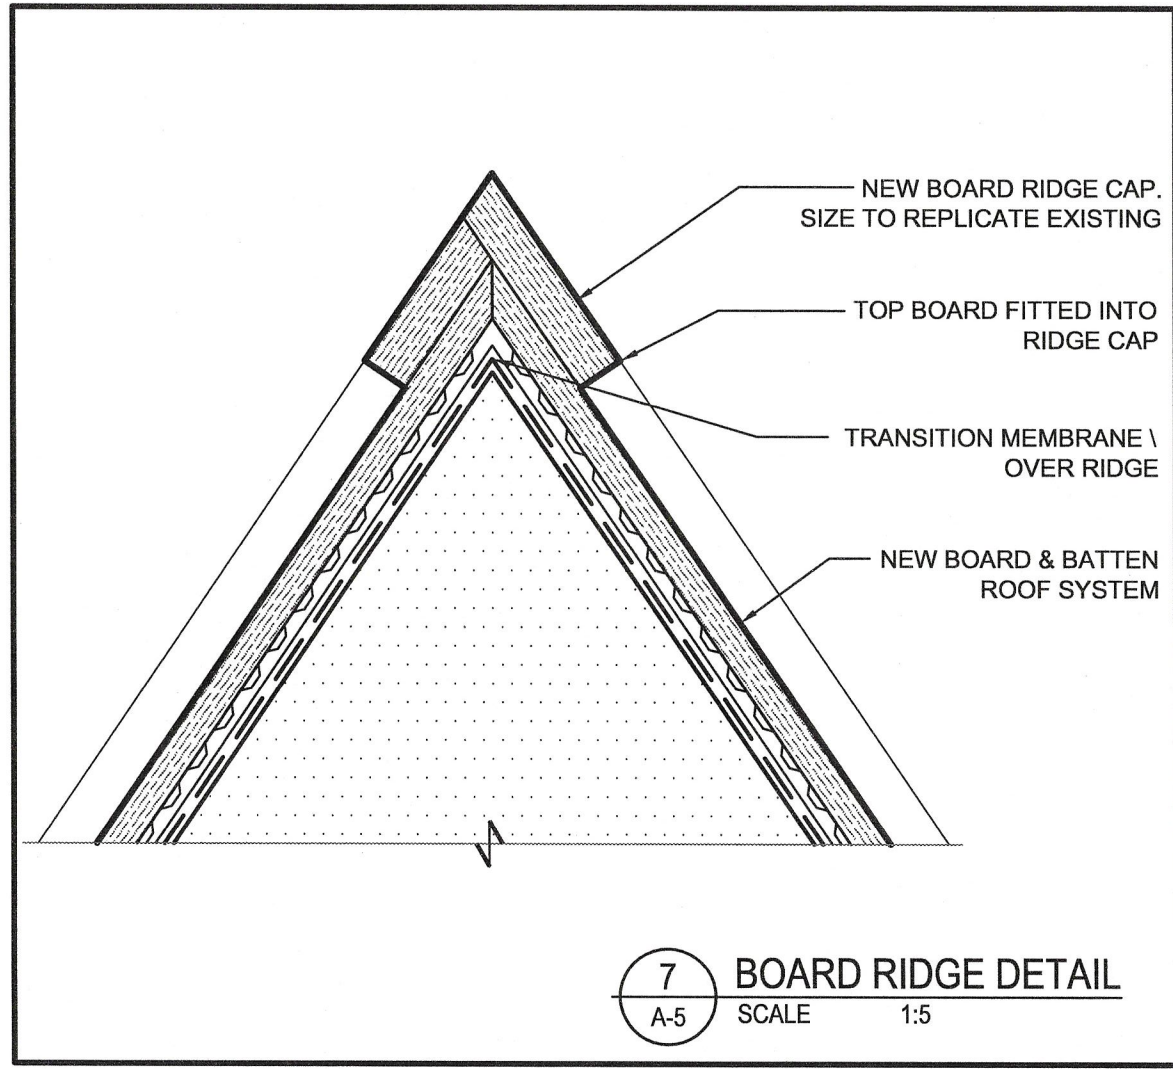1. ALL TIMBER COMPONENTS TO BE HAND CRAFTED TO REPLICATE THE EXISTING CONDITIONS.
2. ALL FASTENERS (NAILS, SCREWS, ETC.) TO HAVE A CORROSION RESISTANT FINISH.
3. ALL NAILS EXPOSED TO VIEW TO HAVE A SQUARE HEAD THAT SIMULATES THE SIZE AND SHAPE OF THE HAND WROUGHT HEADS OF THE EXISTING NAILS. SUBMIT SAMPLES FOR REVIEW BY DEPARTMENTAL REPRESENTATIVE.
4. SCREWS TO BE COUNTERSUNK AS INDICATED OR AS REQUIRED TO PROVIDE SUFFICIENT EMBEDMENT OF THE WOOD PLUGS.
5. ALL SCREWS AND NAILS TO BE INSTALLED IN PRE-DRILLED HOLES HAVING A DIAMETER OF 70% OF THE FASTENER DIAMETER UNLESS THE CONTRACTOR CAN DEMONSTRATE THAT SPLITTING OF THE WOOD WILL NOT OCCUR.
6. WHERE SPECIFIC FASTENING HAS NOT BEEN INDICATED FOR CERTAIN COMPONENTS OR WHERE SPECIAL CONDITIONS EXIST, PROVIDE FASTENINGS IN SIMILAR QUANTITIES, SPACINGS AND SIZES TO SIMILAR DETAILS INDICATED AND TO THE REQUIREMENTS OF PART 9 OF THE NATIONAL BUILDING CODE OF CANADA.




GENERAL NOTES FOR SIDING:  
THE EXISTING SIDING IS TO BE REVIEWED WITH A DEPARTMENTAL REPRESENTATIVE TO CHECK FOR DETERIORATED SIDING BOARDS ON EACH BUILDING FACE. PARKS CANADA IS SUPPLYING 300M OF NEW SIDING LUMBER. EACH BOARD DEEMED TO BE REPLACED, WILL NEED TO BE REMOVED. THE EXISTING TAR PAPER IS TO BE REPAIRED AS REQUIRED, WITH NEW SHEET AIR BARRIER. NEW SIDING TO BE INSTALLED TO REPLICATE EXISTING. THE QUANTITY OF SIDING BOARDS SUPPLIED BY THE OWNER AS FOLLOWS:  
300 METERS OF TAPERED SIDING BOARDS THICKNESS FOR 30mm AT ONE EDGE TO APPROX. 6mm AT THE OPPOSITE EDGE. WIDTHS OF 350,400,450 & 500mm WIDTHS. THE BOARDS WILL HAVE 2 "LIVE EDGES" REPLICATING EXISTING SIDING. BOARD LENGTHS TO VARY FROM 3.6m TO 4.9m. LENGTHS AND WIDTHS TO BE EVENLY DISTRIBUTED THROUGHOUT THE ORDER..



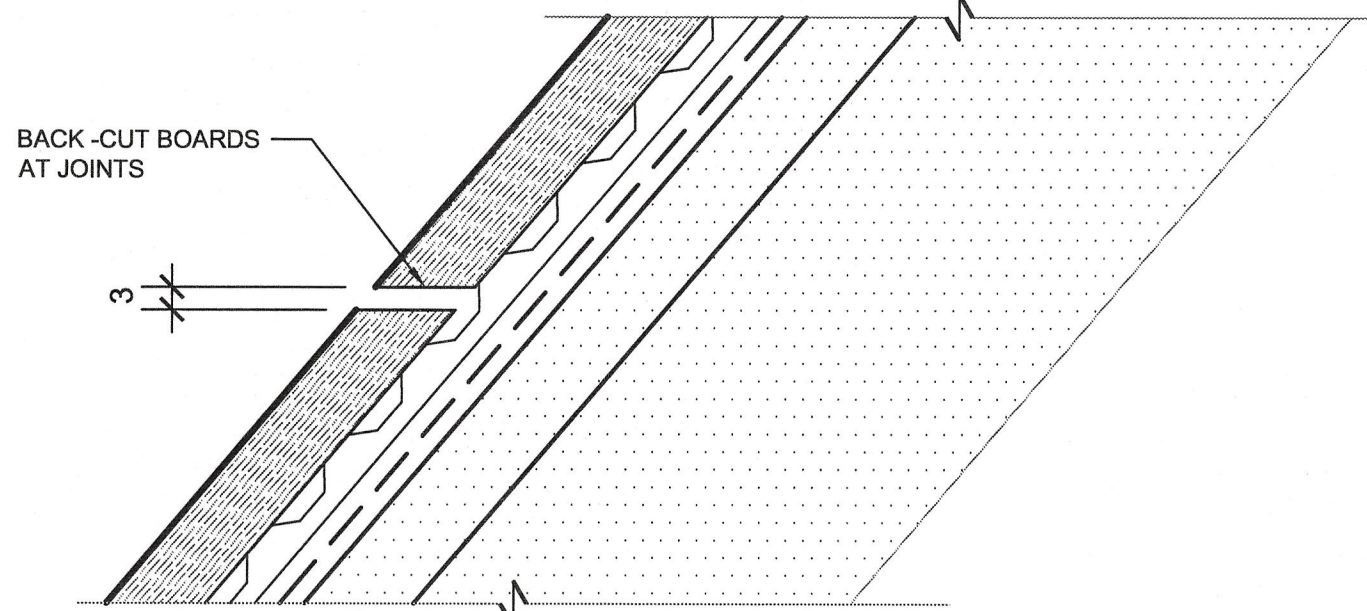
NOTE:  
REUSE SELECT BOARDS AS DIRECTED BY DEPARTMENTAL REPRESENTATIVE. SEE SCHEDULE ON A-2 FOR PLACEMENT OF NEW AND OLD BOARDS



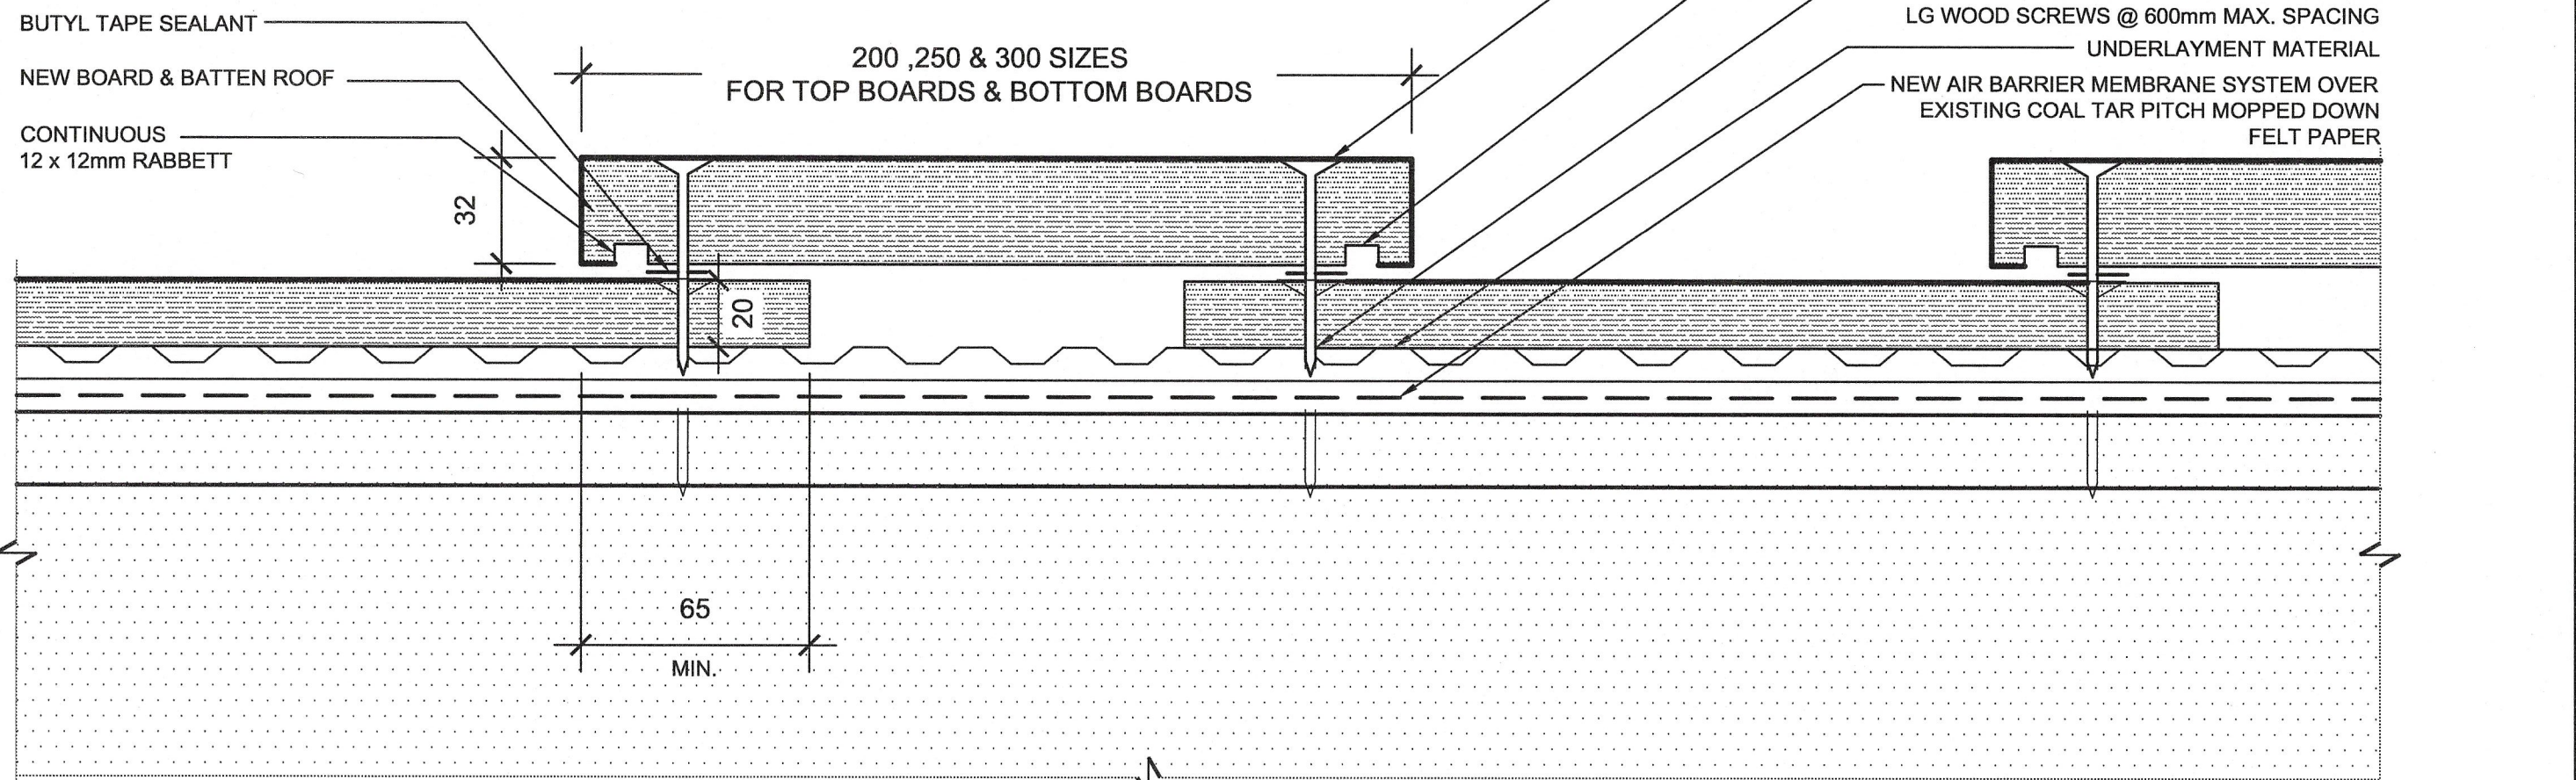NOTE:  
• THERE ARE SOME ROOF BOARDS WITH BOLTED CONNECTIONS THRU THE ROOF DECK TO BE REMOVED  
• FASTENERS IN TOP & BOTTOM BOARDS ARE TO BE IN LINE BUT STAGGERED SPACINGS. ALL FASTENER TO BE IN LINE OF BUTYL TAPE  
• ROSTING RIDGE AND TRIM BOARDS TO BE SECURED WITH 2 - 76mm (GALV.) NAILS @ 600mm MAXIMUM SPACING



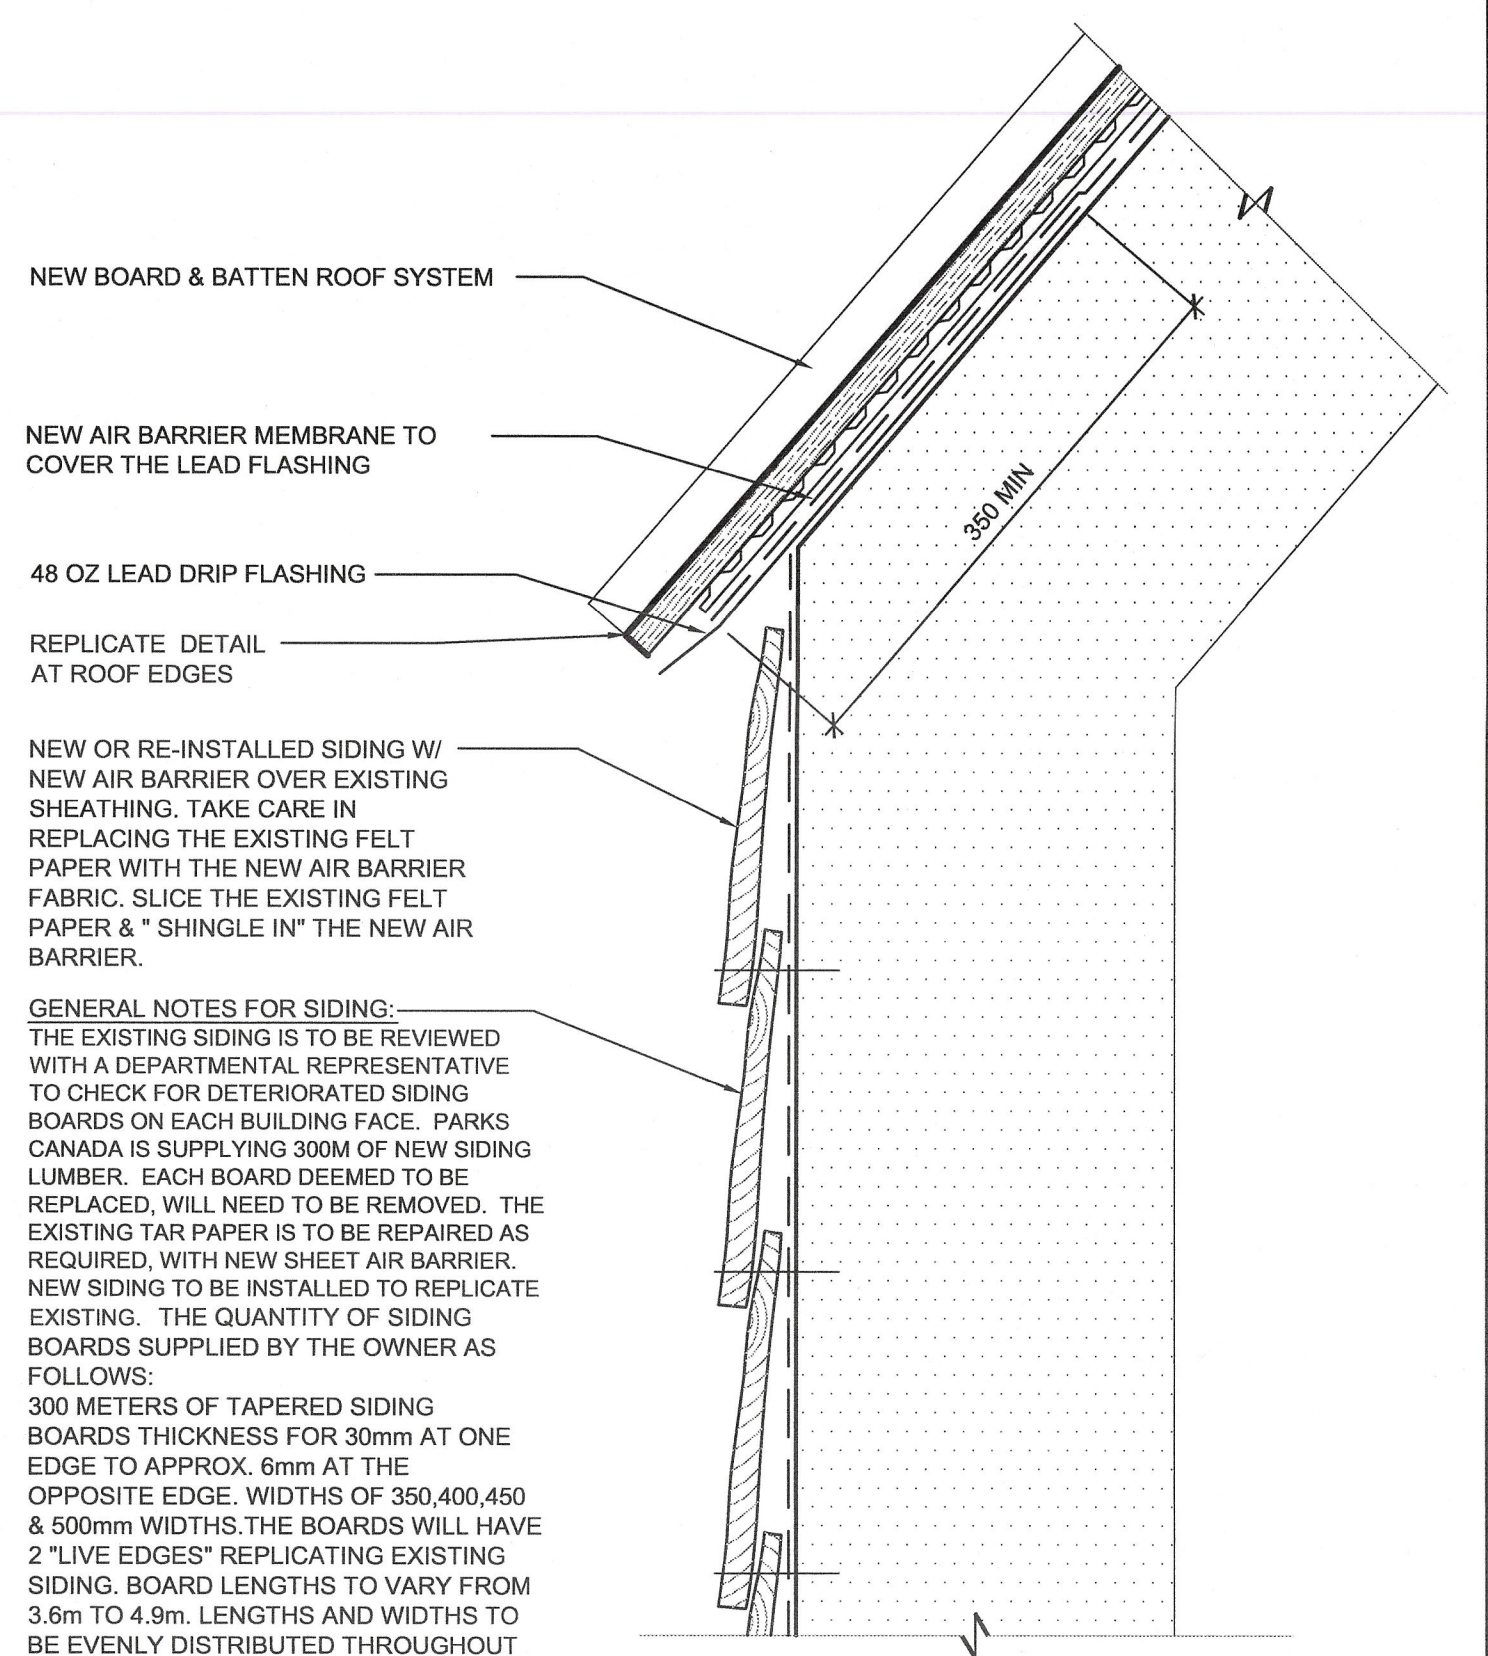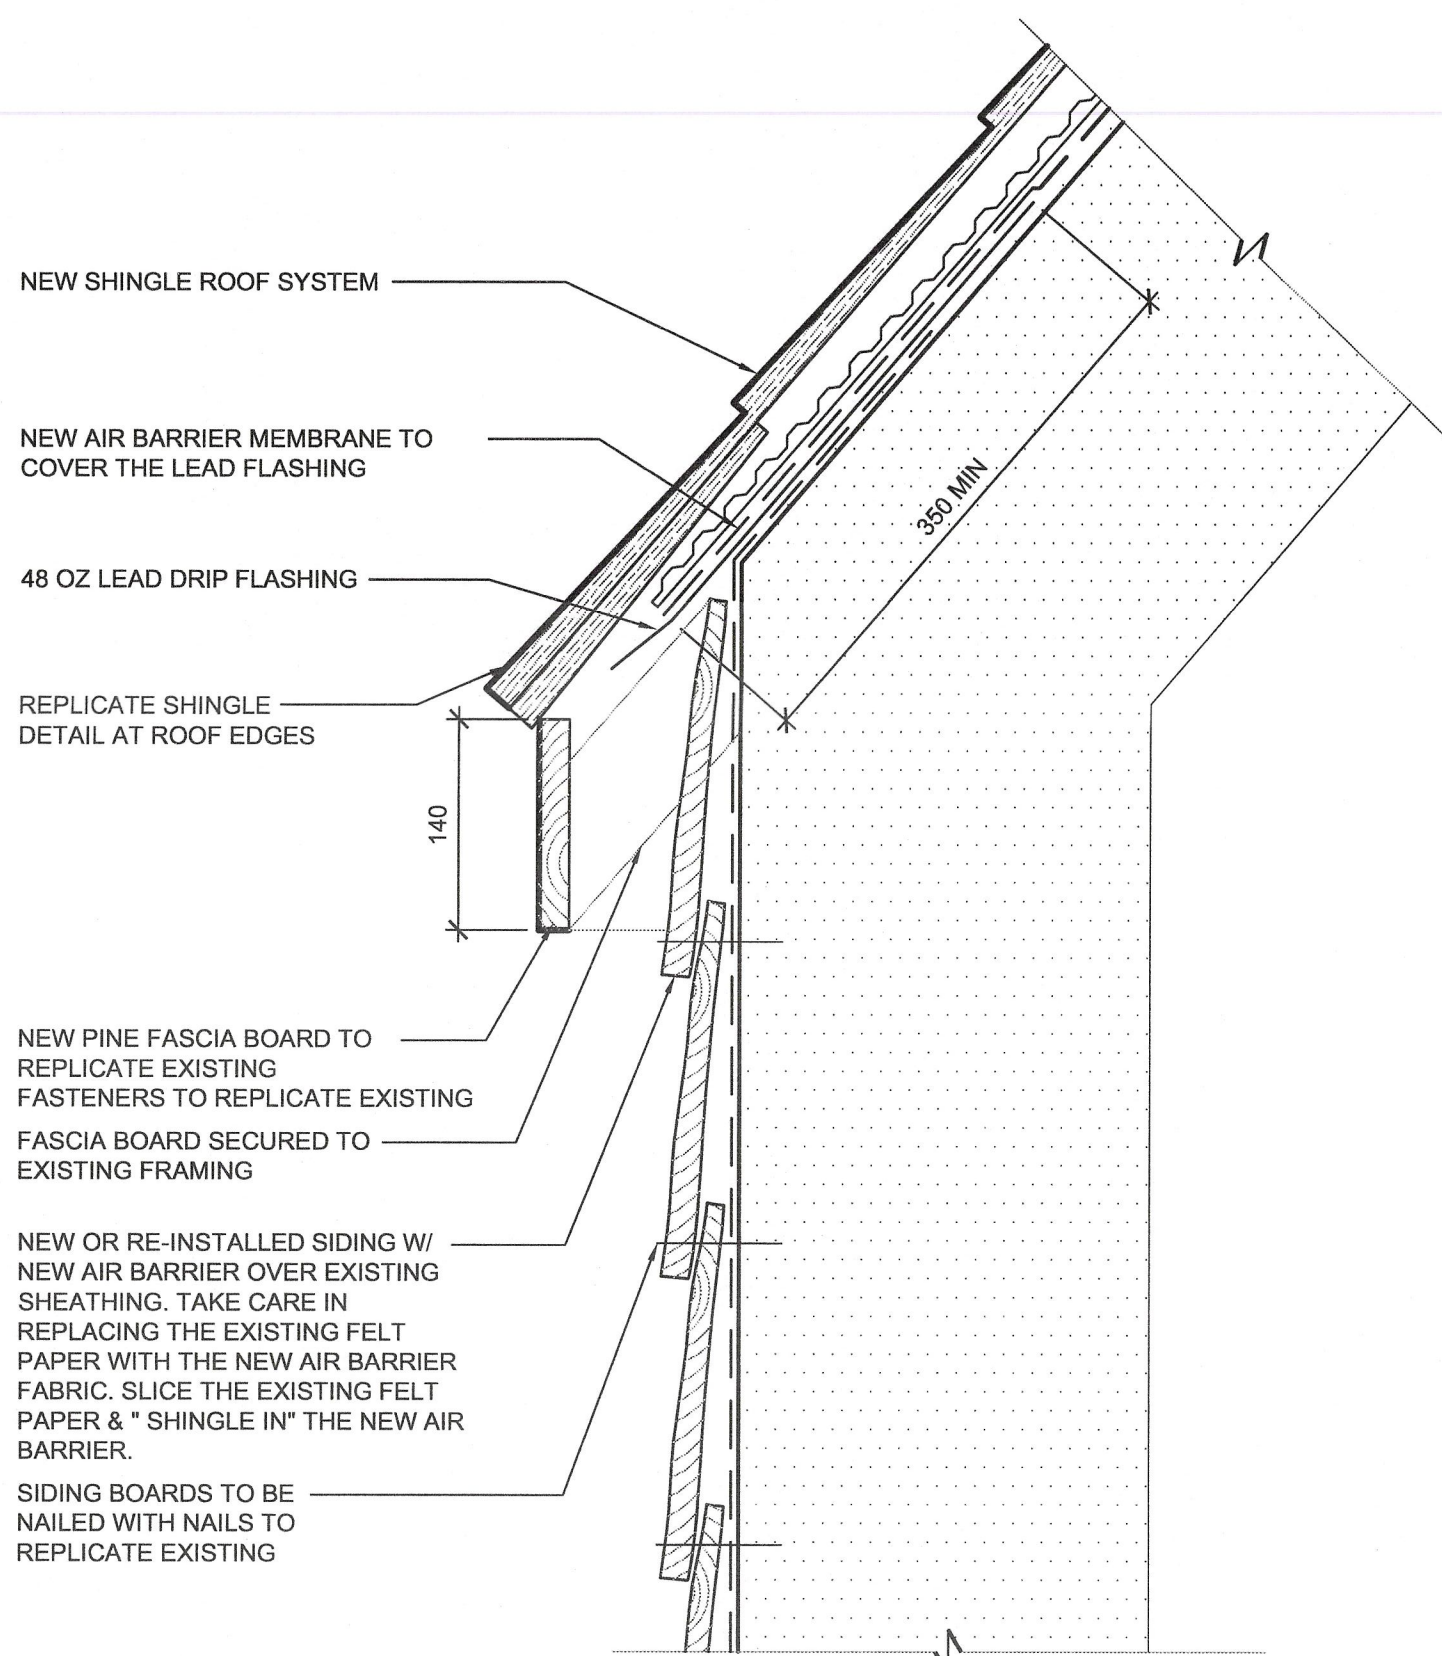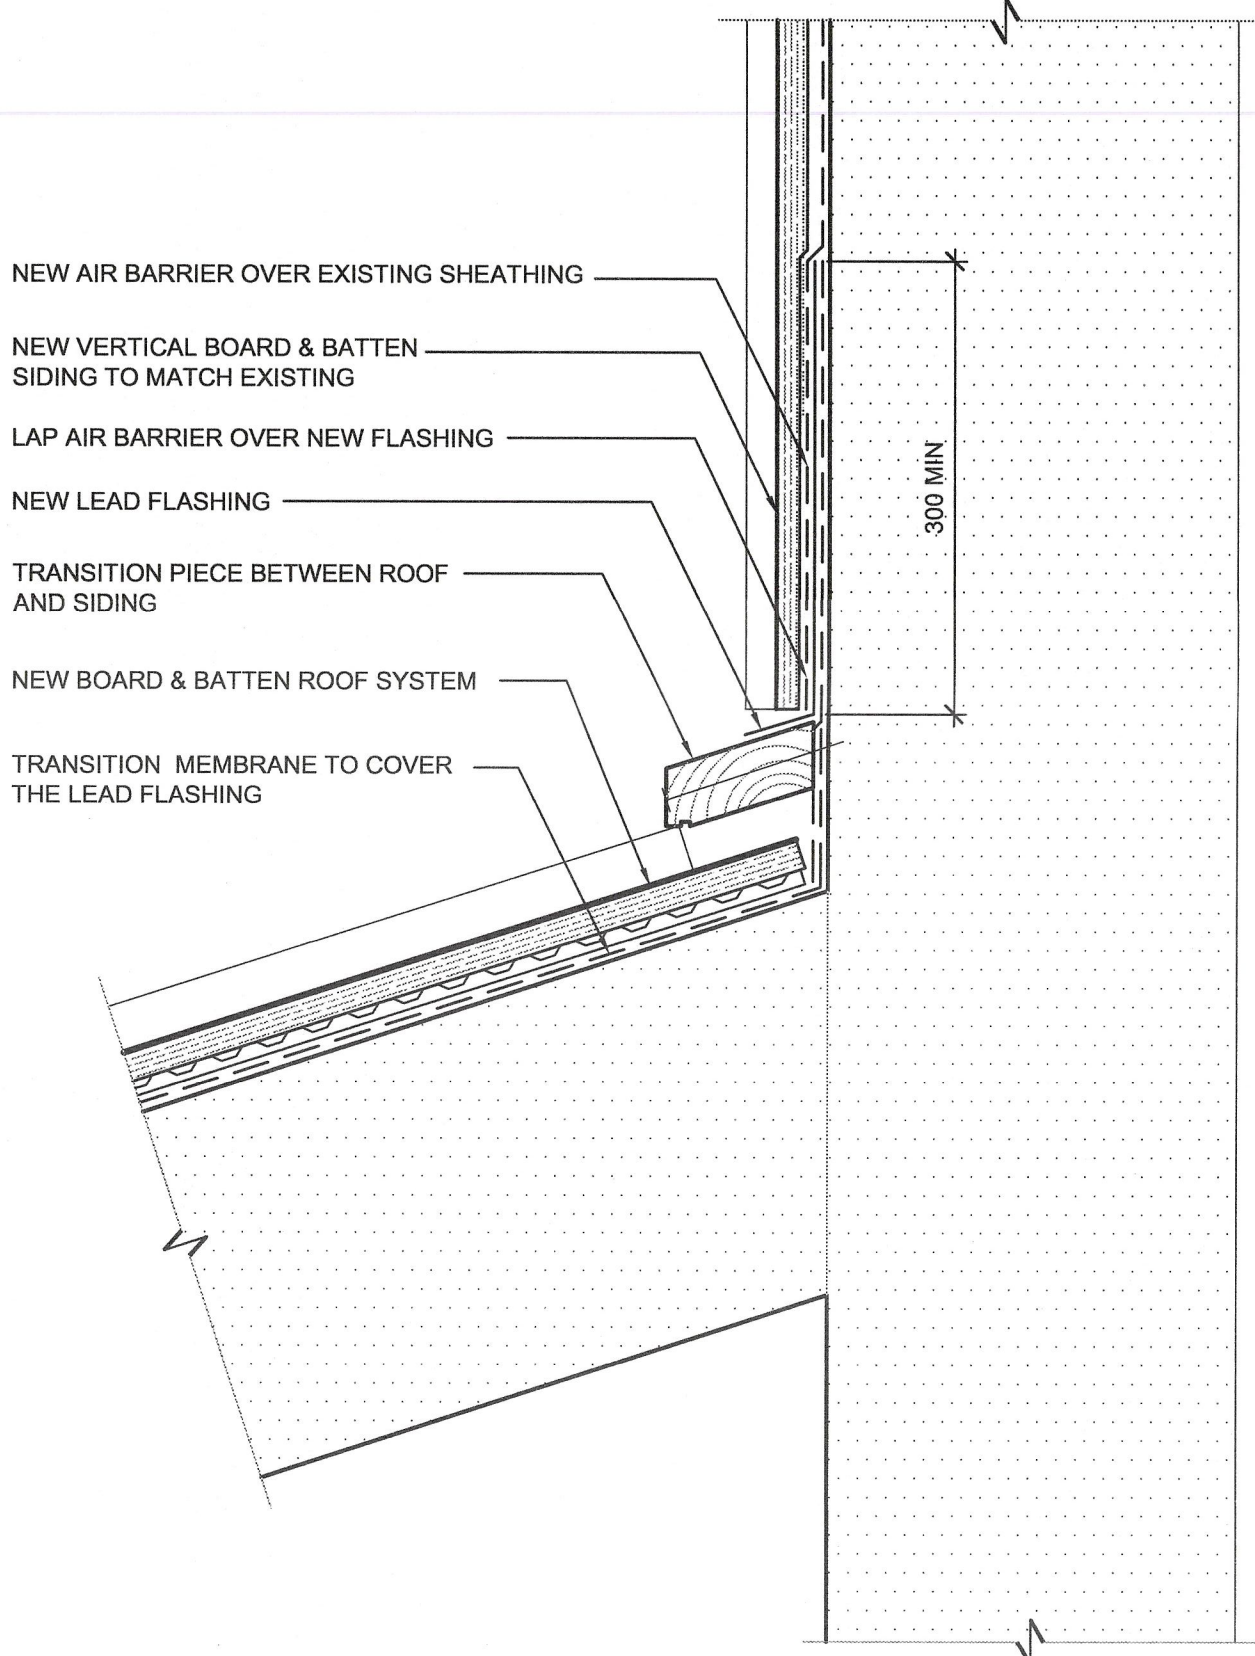NOTE:  
SIDING TRIM AND OTHER BOARDS TO BE SECURED WITH NAILS REPLICATING EXISTING.

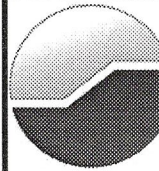


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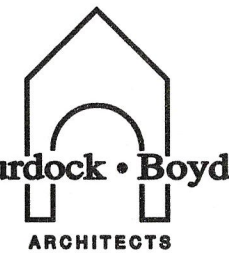


Parks Canada

Parcs Canada



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AND SCIENTISTS



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www.murdoch-boyd.com


0	ISSUED FOR TENDER	SEPT 8 2017
revisions		date
project		projet

RENEWAL PROJECT  
PORT ROYAL  
HABITATION  
NATIONAL HISTORIC SITE  
PORT ROYAL, NS

HABITATION  
SECTION DETAILS

designed	MRB	conçu
date		
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Tender	JN	Submission
PWGSC Project Manager	Administrateur de projets TPSGC	
project number	15-567	no. du projet
drawing no.	A-5	no. du dessin



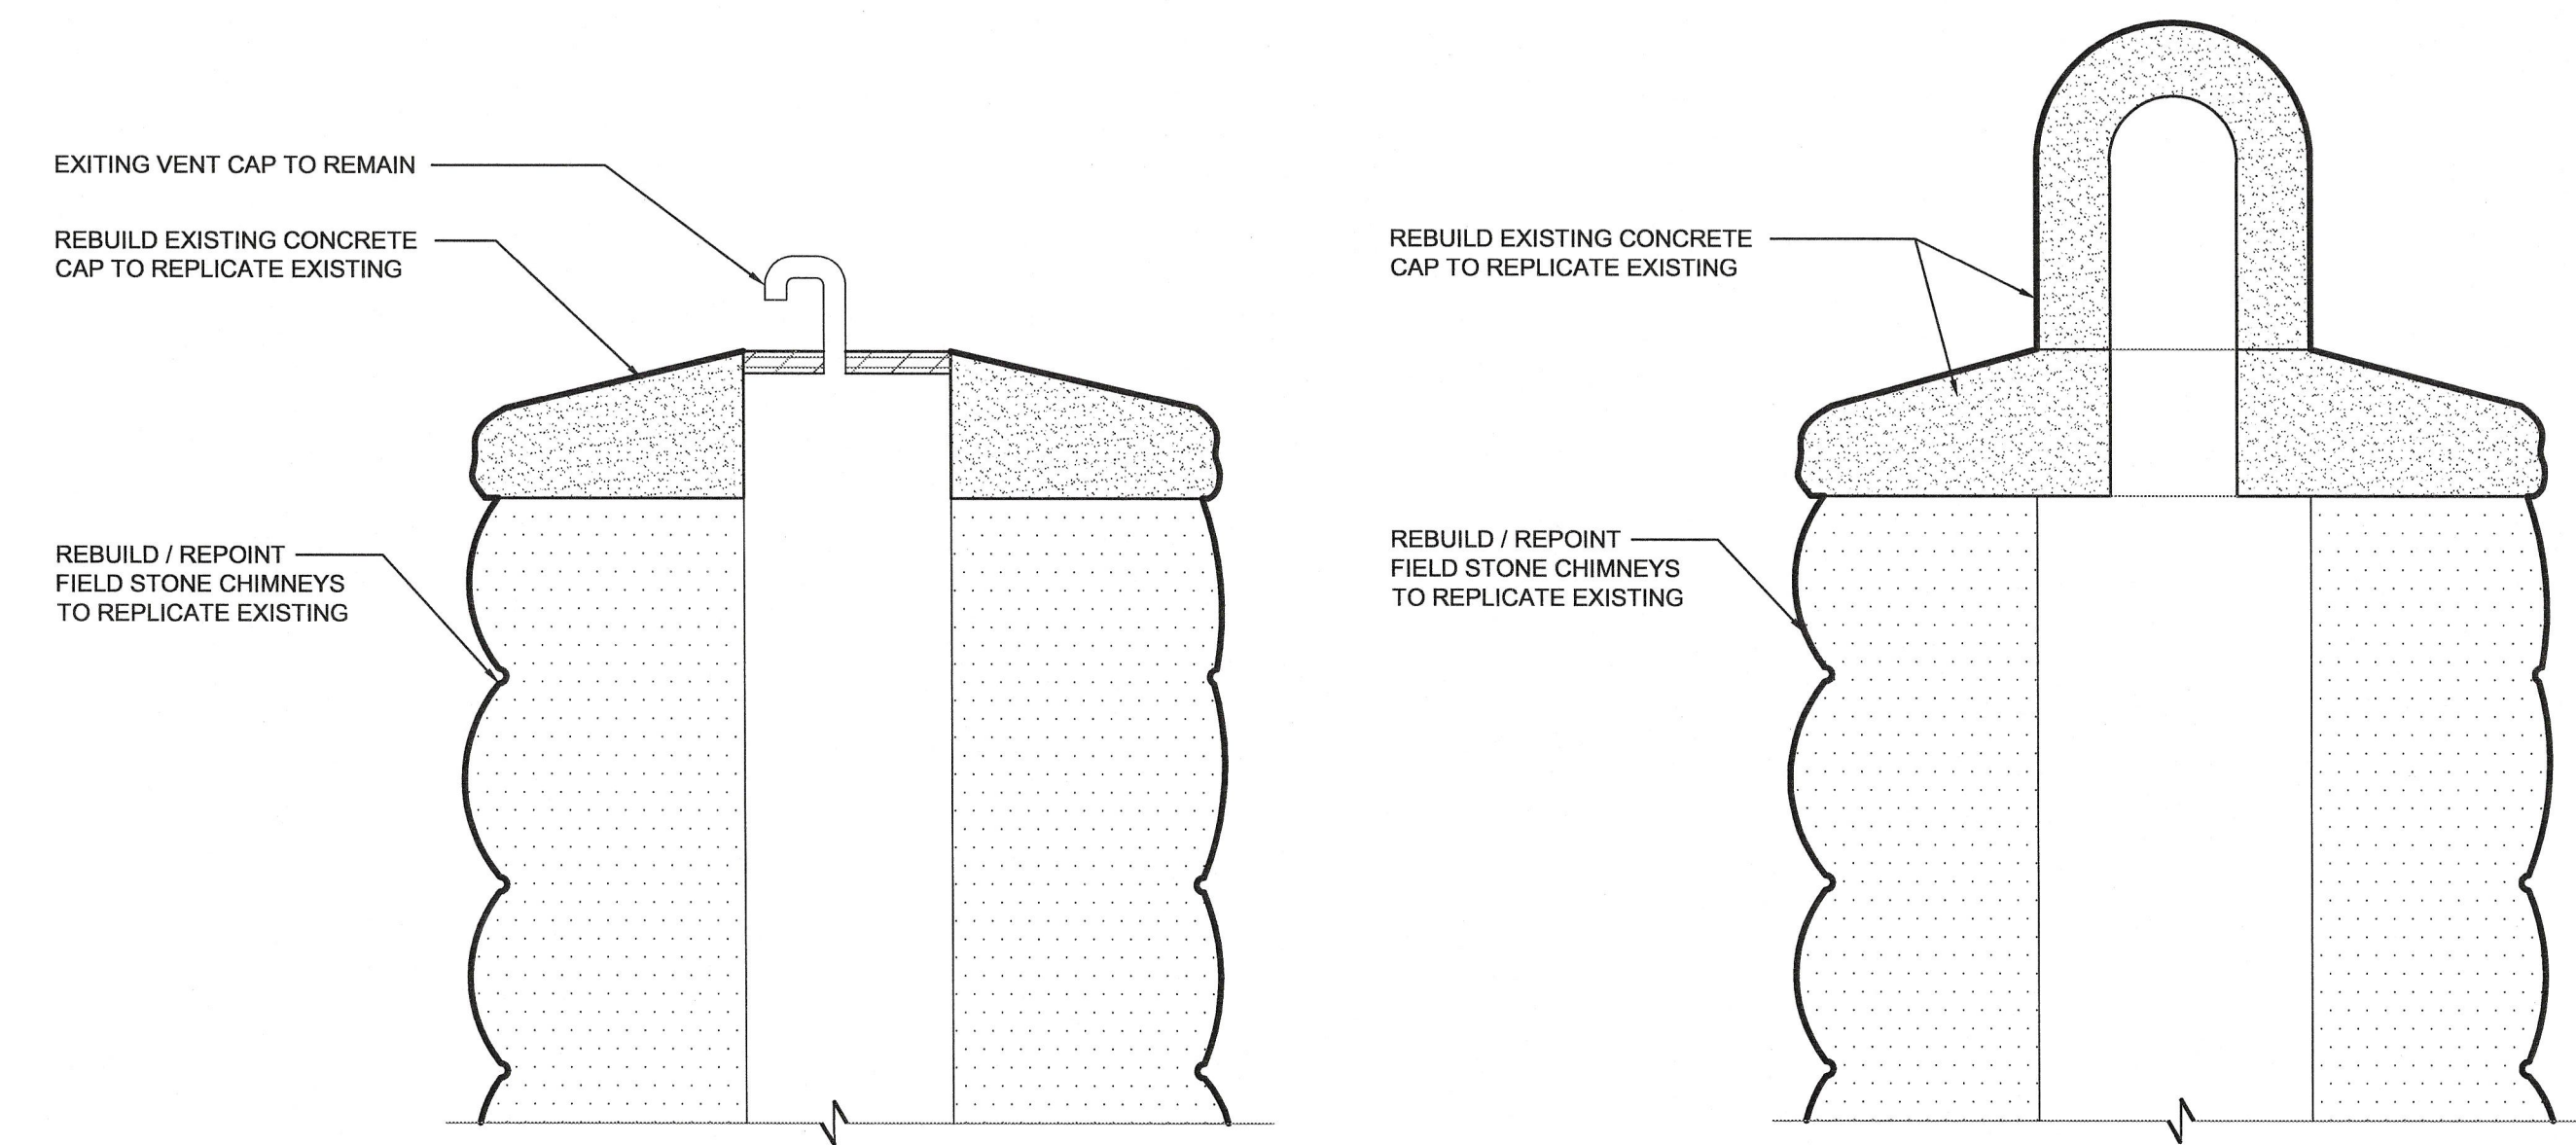


3D CHIMNEY CAP DETAIL 1 SCALE 1:5

3C CHIMNEY CAP DETAIL 2 SCALE 1:5


CHIMNEY WORK TO INCLUDE THE FOLLOWING:

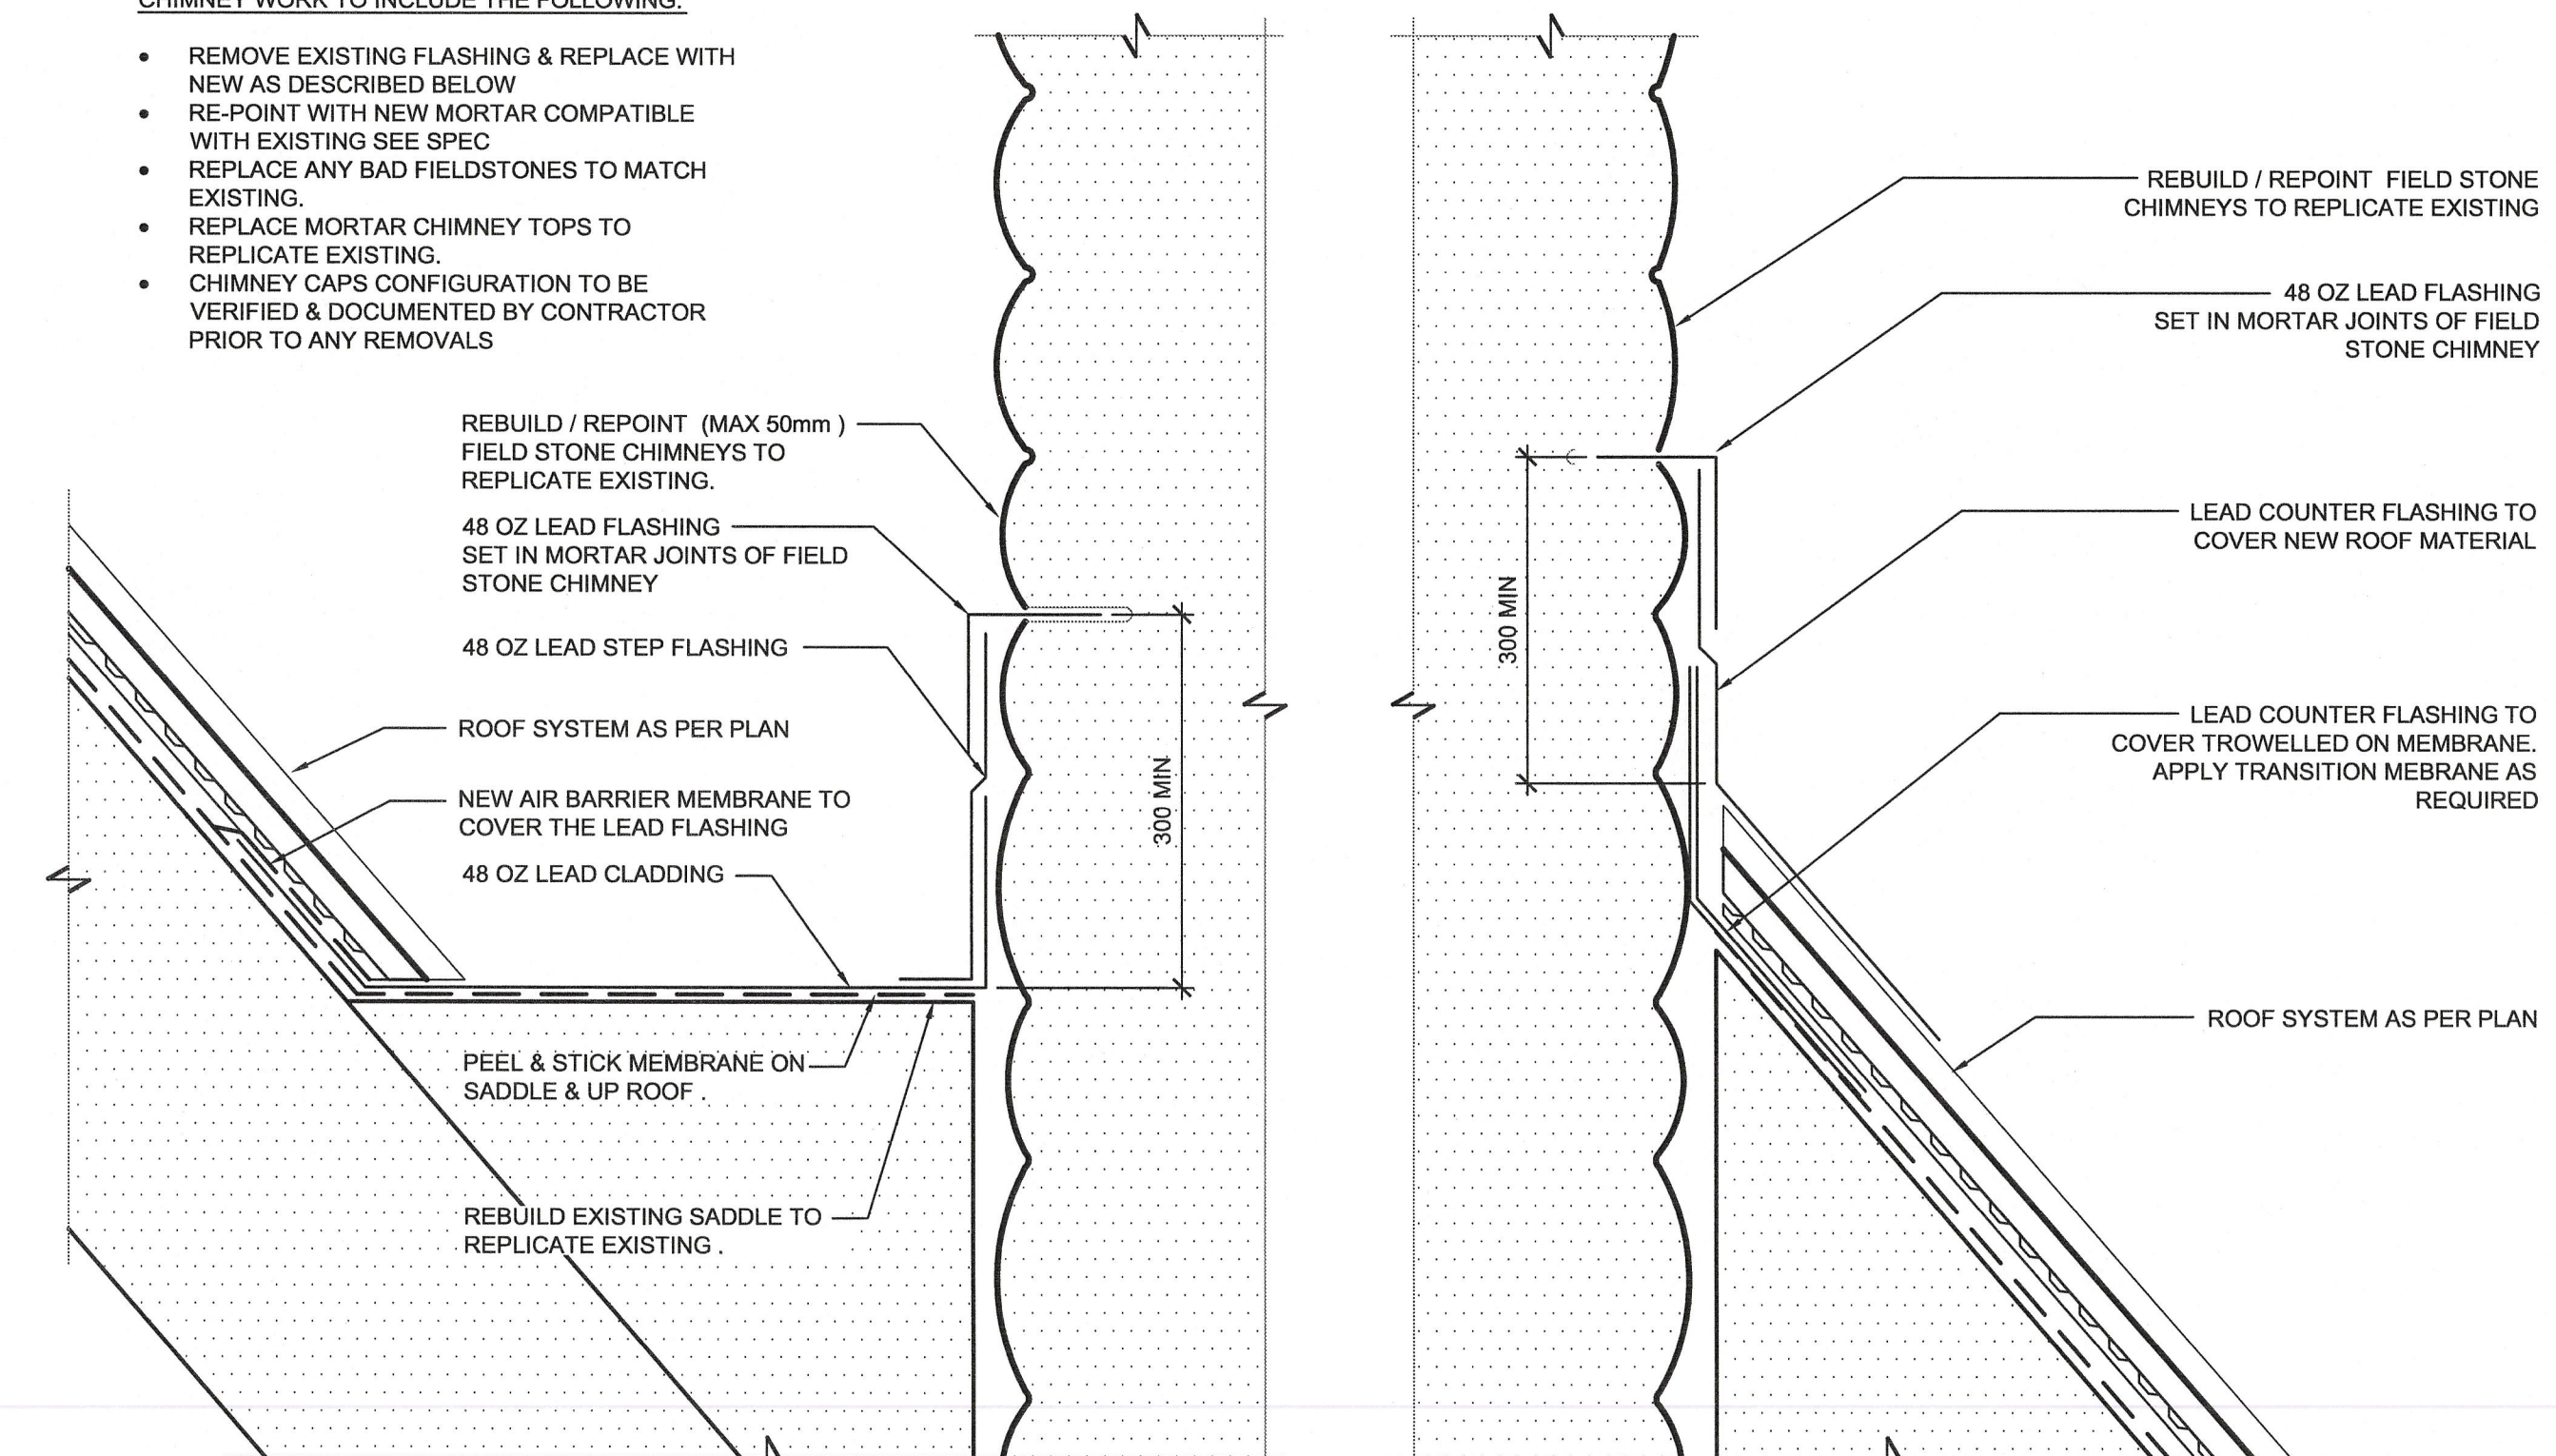- REMOVE EXISTING FLASHING & REPLACE WITH NEW AS DESCRIBED BELOW
- RE-POINT WITH NEW MORTAR COMPATIBLE WITH EXISTING SEE SPEC
- REPLACE ANY BAD FIELDSTONES TO MATCH EXISTING
- REPLACE MORTAR CHIMNEY TOPS TO REPLICATE EXISTING
- CHIMNEY CAPS CONFIGURATION TO BE VERIFIED & DOCUMENTED BY CONTRACTOR PRIOR TO ANY REMOVALS




3A CHIMNEY SADDLE DETAIL SCALE 1:5

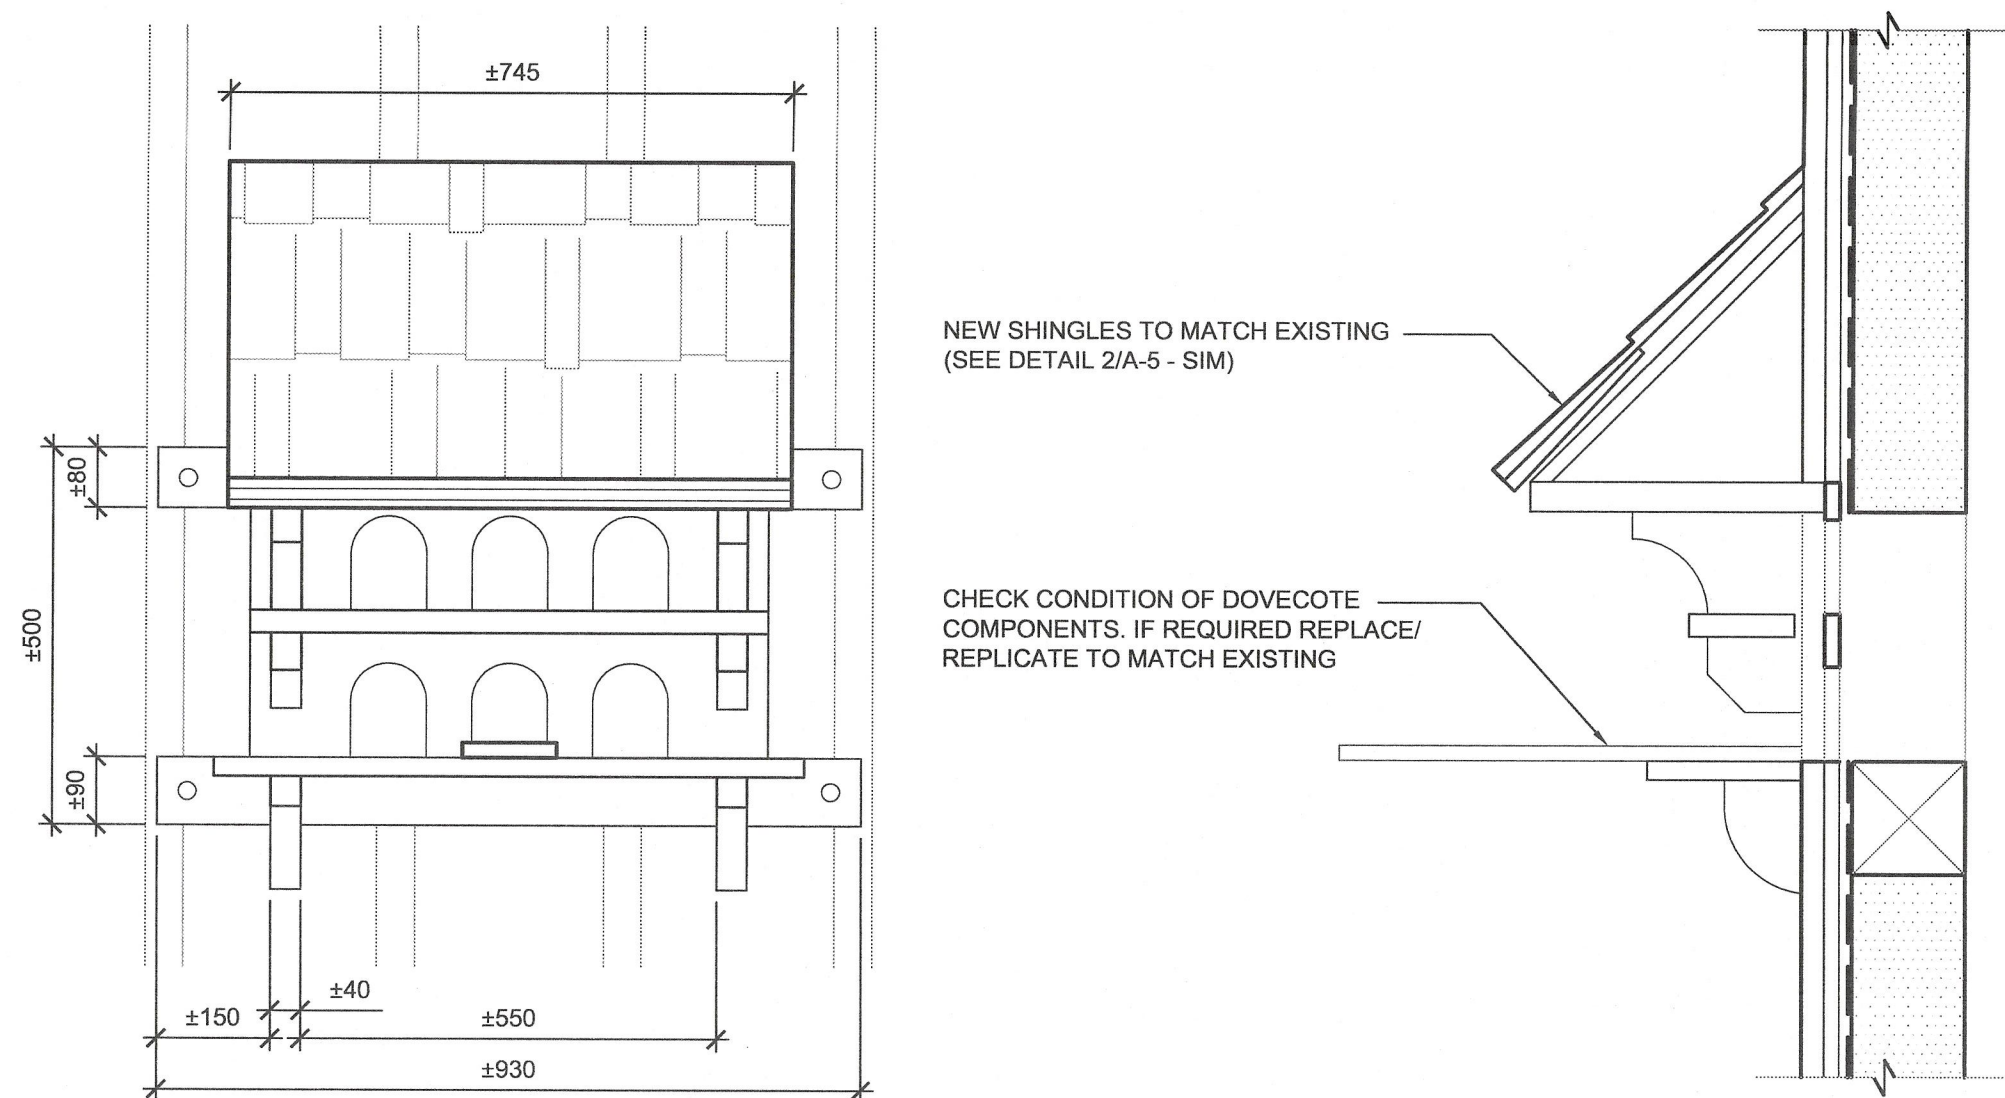3B CHIMNEY FLASHING DETAIL SCALE 1:5




2 DOVECOTE SCALE 1:10

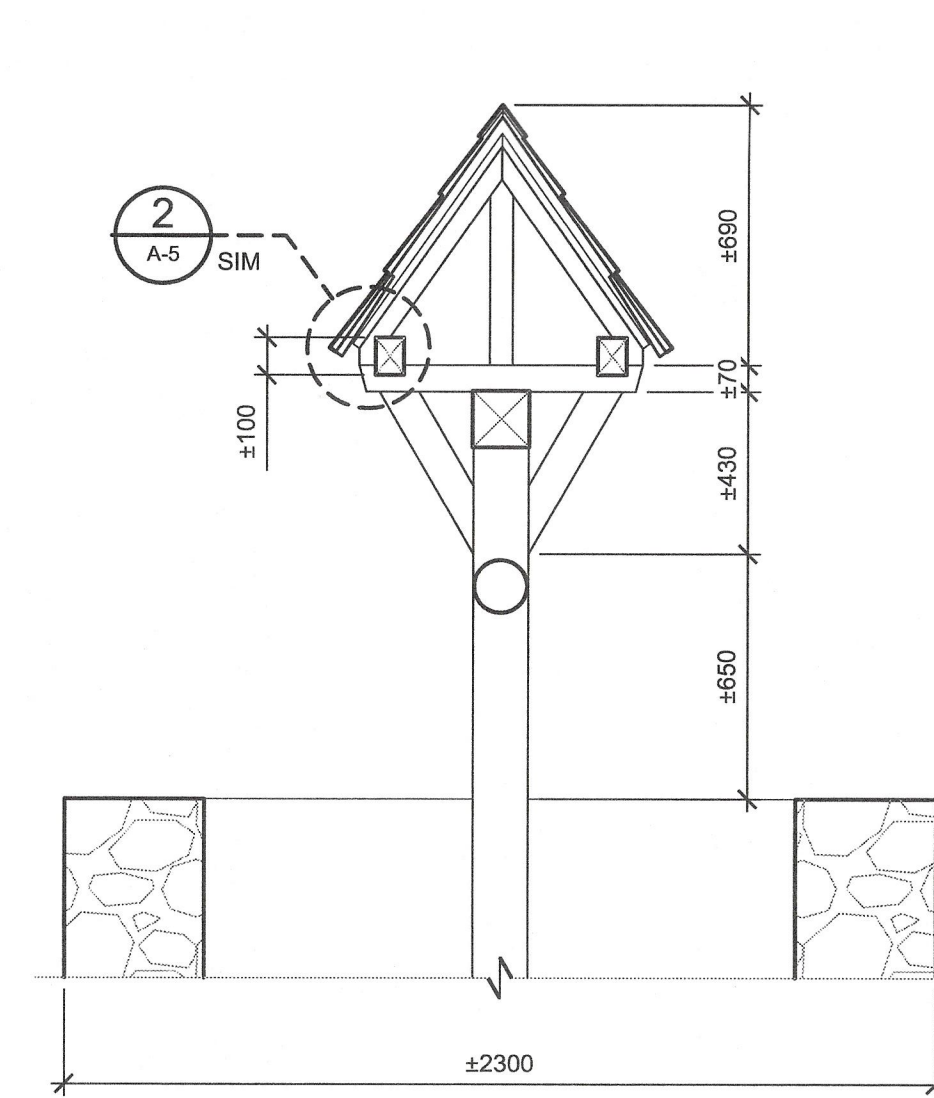



- CONCRETE NOTES**
- GENERAL - THE CONTRACTOR SHALL VERIFY ALL DIMENSIONS AND REPORT ANY DISCREPANCIES TO THE ENGINEER BEFORE PROCEEDING WITH THE WORK.
  - FOUNDATIONS ARE TO BE FOUND ON PROOF COMPACTED UNDISTURBED NATURAL MATERIAL.
  - BACKFILL - FOOTING TRENCHES TO BE BACKFILLED WITH SELECT EXCAVATED MATERIAL SIMULTANEOUSLY ON BOTH SIDES OF FOUNDATION TO PREVENT DAMAGE FROM UNEQUAL SOIL PRESSURES.
  - ALL FOUNDATION WORK SHALL BE CARRIED OUT UNDER THE DIRECTION OF THE DEPARTMENTAL REPRESENTATIVE. IF SOFT OR UNSUITABLE IN-SITU MATERIALS ARE ENCOUNTERED CORRECTIVE ACTION SHALL BE TAKEN AS DIRECTED.
  - ALL CONCRETE WORK SHALL BE CARRIED OUT IN ACCORDANCE WITH CSA A23.1 AND THE NATIONAL BUILDING CODE OF CANADA.
  - ALL CONCRETE MATERIALS SHALL CONFORM TO THE LATEST EDITION OF:  
CEMENT CSA A3001, TYPE GU  
AGGREGATES CSA A23.1  
AIR ENTRAINING ASTM C260  
CHEMICAL ADMIXTURES ASTM C494/C494M  
W/W MESH ASTM A1064/A1064M  
DESIGN MIX CSA A23.1  
REINF BAR CSA G30.18 - GRADE 400
  - CONCRETE SHALL BE PROPORTIONED IN ACCORDANCE WITH CSA A23.1-14 TO GIVE THE FOLLOWING MIX DESIGN:  
• STRENGTH CLASS 25 MPa  
• EXPOSURE CLASS F-2  
• SLUMP 80 mm  
• AIR CONTENT 4 - 7%
  - CONCRETE MIX DESIGNS SHALL BE SUBMITTED FOR REVIEW 1 WEEK PRIOR TO USE. OBTAIN ENGINEER'S APPROVAL BEFORE USING CONCRETE ADMIXTURES. USE OF CALCIUM CHLORIDE WILL NOT BE PERMITTED.
  - CONCRETE TESTING SHALL CONFORM TO CSA A23.2. MINIMUM TESTING SHALL INCLUDE 3 STRENGTH TESTS FOR EVERY CONCRETE POUR. SLUMP AND AIR TESTS TO ACCOMPANY CYLINDER TESTING. PROVIDE 24 HOURS NOTICE PRIOR TO PLACING ANY CONCRETE. COST OF TESTING TO BE PAID BY DEPARTMENTAL REPRESENTATIVE.
  - REINFORCING - BILLET STEEL, GRADE 400, DEFORMED BARS TO CSA G30.18. ALL DEFORMED CONCRETE REINFORCING BARS ARE TO BE SUPPLIED AND INSTALLED BY THE CONTRACTOR. REINFORCING BAR SPLICE LAP LENGTHS SHALL BE DETAILED AS FOLLOWS, UNLESS NOTED OTHERWISE:  

VERTICAL BARS & SLAB REINF	HORIZONTAL BARS (EXCEPT IN SLABS)
10M - 390 mm	10M - 510 mm
15M - 570 mm	15M - 740 mm
20M - 750 mm	20M - 980 mm
25M - 1170 mm	25M - 1520 mm
30M - 1410 mm	30M - 1830 mm
35M - 1640 mm	35M - 2130 mm
  - CONCRETE COVER FOR REINFORCING STEEL UNO:  
75 mm BOTTOM  
50 mm TOP & SIDES
  - USE SPACERS AND CHAIRS TO ACCURATELY LOCATE AND SUPPORT REINFORCING STEEL AND SECURE IN POSITION TO PREVENT DISPLACEMENT DURING CONCRETE PLACEMENT. PROVIDE SUPERVISION TO ENSURE THAT REINFORCING BARS ARE MAINTAINED IN POSITION.
  - CONCRETE FORMWORK SHALL BE CONSTRUCTED FROM PLYWOOD SHEETS MEETING THE REQUIREMENTS OF CSA O121. PLYWOOD SHEETS TO BE CLEAN, SOUND AND FREE FROM DEFECTS DETRIMENTAL TO THE QUALITY OF FINISHED CONCRETE SURFACES. ARRANGE PLYWOOD SHEETS TO A UNIFORM JOINT PATTERN. CONSTRUCT FORMWORK TO RESIST FLUID PRESSURE FROM WET CONCRETE AND ALL OTHER CONSTRUCTION LOADINGS WITHOUT BULGING, MOVEMENT OR DISTORTION. REUSE OF FORMWORK SUBJECT TO THE REQUIREMENTS OF CSA A23.1.
  - ALL CONCRETE SHALL BE VIBRATED USING HIGH FREQUENCY VIBRATORS. VIBRATION PRACTICES TO BE IN ACCORDANCE WITH ACI 309R.
  - EMBEDMENTS - SET ANCHOR RODS, ANGLES, INSERT PLATES, SLEEVES AND OTHER MISCELLANEOUS ITEMS EMBEDDED IN CONCRETE ACCURATELY TO EXACT GRADE AND LOCATION SHOWN ON PROJECT DRAWINGS OR AS REQUIRED TO SUIT THE WORK. SECURE TO PREVENT DISPLACEMENT DURING CONCRETE PLACEMENT. DO NOT CUT OR RELOCATE REINFORCING STEEL FOR PLACEMENT OF EMBEDDED PARTS. IF INSERTS CANNOT BE LOCATED AS SPECIFIED, OBTAIN APPROVAL OF ALL MODIFICATIONS FROM DEPARTMENTAL REPRESENTATIVE BEFORE PLACING.
  - CONCRETE CURING AND PROTECTION SHALL CONFORM TO CSA A23.1. CONTINUOUS WATER CURING IS REQUIRED FOR STRUCTURAL CONCRETE IF AIR TEMPERATURE IS AT OR ABOVE 27°C.
  - ADDITIVES AND ADMIXTURES TO BE COMPATIBLE.
  - COLD WEATHER CONCRETE SHALL BE PLACED AND PROTECTED IN ACCORDANCE WITH THE REQUIREMENTS OF CSA A23.1. COLD WEATHER PROTECTION AND CURING SHALL BE APPLIED IN ORDER TO MAINTAIN THE CONCRETE TEMPERATURE AT OR ABOVE 10°C FOR THE TIME OF CURING PERIODS SPECIFIED IN TABLE 20 OF CSA A23.1. PROVIDE CONTROLLED COOL DOWN PERIOD TO PREVENT SURFACE CRACKING AT END OF PROTECTION PERIOD. ENSURE THAT NO CONCRETE IS PLACED ON OR AGAINST FROZEN SUBGRADE, FORMWORK, OR REINFORCING STEEL.
  - FORMED CONCRETE SURFACES SHALL BE SURFACE FINISHED AS SOON AS PRACTICAL AND NOT LATER THAN 6 HOURS FOLLOWING FORMWORK REMOVAL. REMOVE ALL FORM TIES, FINS AND PROJECTIONS. PATCH THE HOLES, INDENTATIONS AND OTHER SURFACE IRREGULARITIES WITH SAND CEMENT PATCHING MORTAR  $f_c = 30$  MPa. FILL AND REPAIR HONEYCOMB AND HOLES.
  - USE WIND BREAKS/SUN SCREENS, ETC., AS REQUIRED TO PREVENT PREMATURE DRYING OF CONCRETE PRIOR TO FINISHING. SCREENS TO BE USED WHEN AIR TEMPERATURE, RELATIVE HUMIDITY, CONCRETE TEMPERATURE AND WIND VELOCITIES ARE SUCH TO CREATE SURFACE MOISTURE EVAPORATION RATES IN EXCESS OF 0.75 kg/(m<sup>2</sup>·h). PROTECTION OF CONCRETE TO BE IN ACCORDANCE WITH CSA A23.1.
  - VERTICAL FORMED SURFACES (i.e. WALLS) SHALL NOT BE MORE THAN 3 mm IN OR OUT OF CONTROL LINE (EXTERIOR FACE).
  - GROUT TO BE NON-SHRINK OF FAVORABLE CONSISTENCY WITH A MINIMUM COMPRESSIVE STRENGTH OF 35 MPa. GROUT AND PROTECT FROM FREEZING TEMPERATURES IN ACCORDANCE WITH CSA A23.1.
  - ADHESIVE ANCHOR SYSTEM TO BE HILTI HIT-HY 200 MAX OR EPICOR A7 USED IN ACCORDANCE WITH MANUFACTURER'S INSTRUCTIONS.
  - STEEL HSS MEMBERS TO CONFORM TO ASTM A500 GRADE C AND HOT-DIPPED GALVANIZED WITH A MINIMUM ZINC COATING OF 600g/m<sup>2</sup> TO CSA G164.

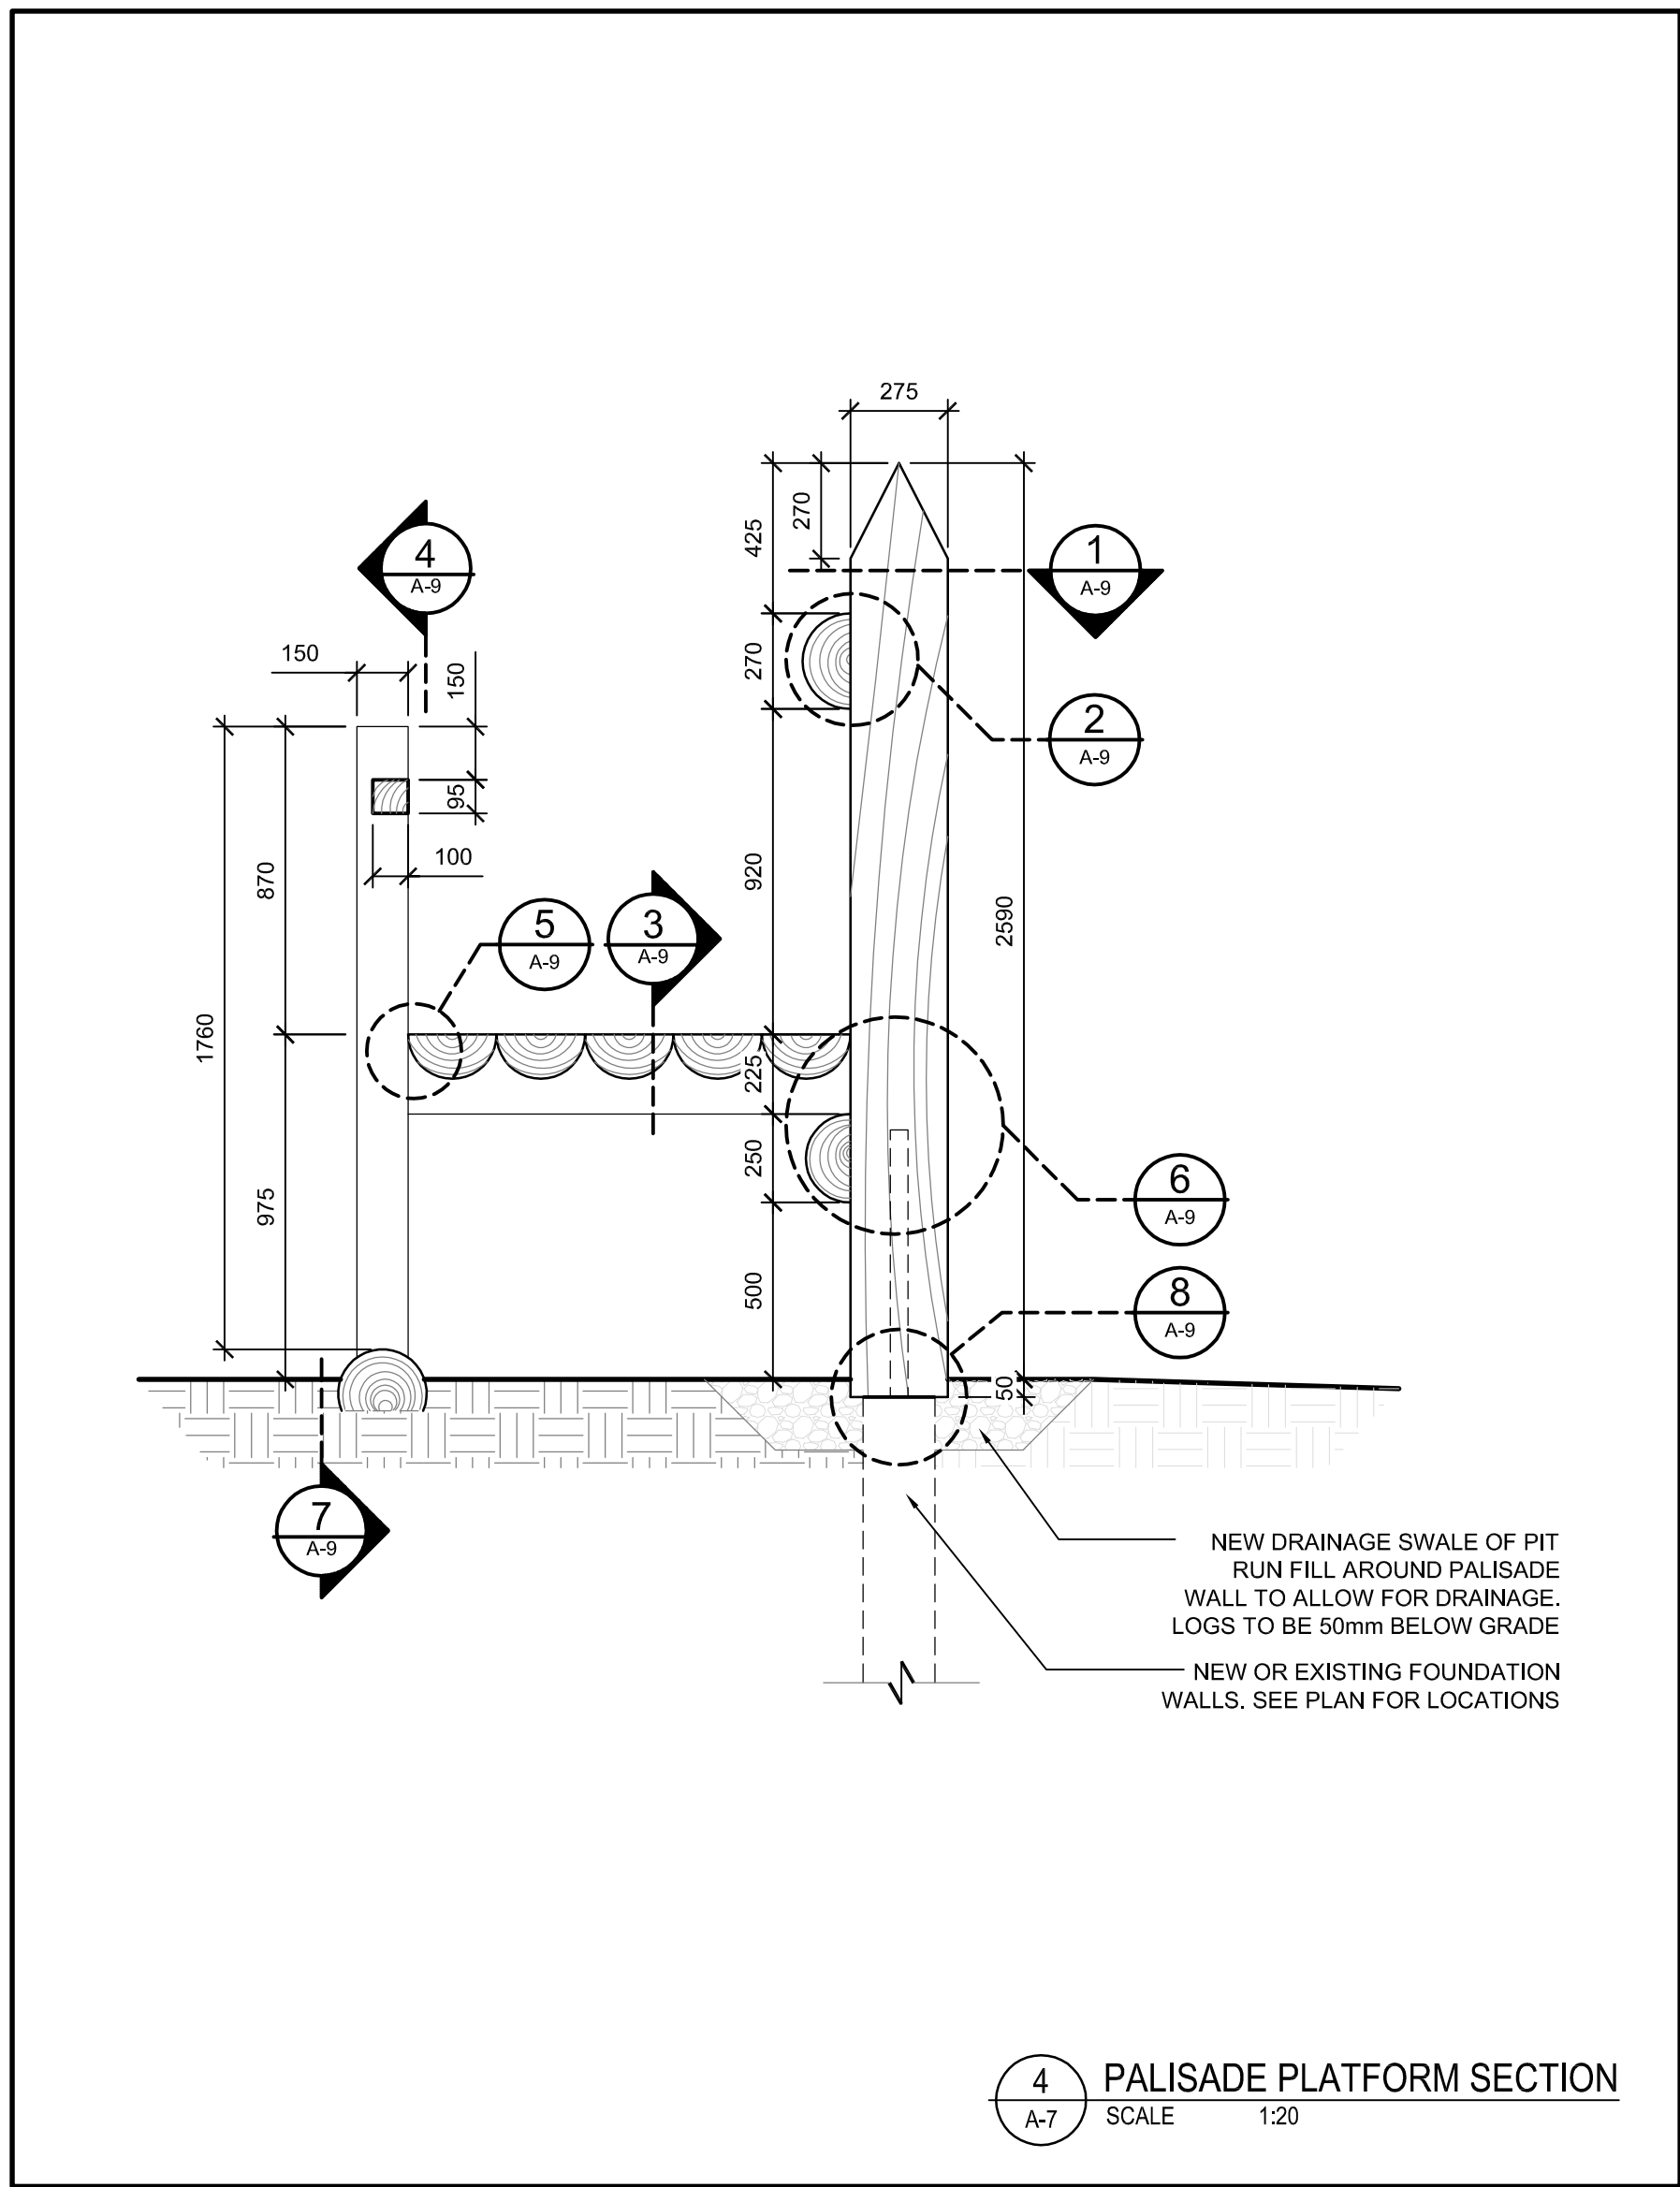



1. ALL TIMBER COMPONENTS TO BE HAND CARVED TO REPLICATE THE EXISTING CONDITIONS.
2. ALL FASTENERS (NAILS, SCREWS, ETC.) TO HAVE A CORROSION RESISTANT FINISH.
3. ALL NAILS EXPOSED TO VIEW TO HAVE A ROUNDED HEAD THAT SIMULATES THE SIZE AND SHAPE OF THE HAND WROUGHT HEADS OF THE EXISTING NAILS. SUBMIT SAMPLES FOR REVIEW BY DEPARTMENTAL REPRESENTATIVE.
4. SCREWS TO BE COUNTERSUNK AS INDICATED OR AS REQUIRED TO PROVIDE SUFFICIENT EMBEDMENT OF THE WOOD PLUGS.
5. ALL SCREWS AND NAILS TO BE INSTALLED IN PRE-DRILLED HOLES HAVING A DIAMETER OF 70% OF THE FASTENER DIAMETER UNLESS THE CONTRACTOR CAN DEMONSTRATE THAT SPLITTING OF THE WOOD WILL NOT OCCUR.
6. WOOD PLUGS SHALL BE OF THE SIZES INDICATED ON THE DRAWINGS OR TO REPLICATE THE EXISTING AND SHALL BE HAND CARVED TO FIT TIGHTLY IN THE PRE-DRILLED HOLES. PLUGS SHALL BE GLENED IN THE HOLES WITH A SUITABLE EXTERIOR GRADE ADHESIVE.
7. TIMBER COMPONENTS THAT WILL BE ENTIRELY BELOW GRADE SHALL BE PRESSURE PRESERVATIVE TREATED. END CUTS, AND PORTIONS OF UNTREATED MEMBER THAT WILL BE BELOW GRADE AND NOT VISIBL SHALL BE TREATED WITH THREE LIBERAL COATS OF 75% SOLID END CUT PRESERVATIVE.
8. THE PRE-FABRICATED TIMBER CONNECTORS AS INDICATED IN THE DRAWING DETAILS (ETBRO, JTG-HQ, JTG-HQ-25, ETC.) ARE AS MANUFACTURED BY "SIMPSON STRONG-TIE" AND SHALL HAVE A CORROSION RESISTANT FINISH. OTHER CONNECTORS THAT MAY BE REQUIRED TO COMPLETE THE WORK SHALL BE SUBMITTED FOR REVIEW BY DEPARTMENTAL REPRESENTATIVE. THE TIMBER CONNECTORS ARE TO BE INSTALLED WITH THE SPECIAL FASTENERS AS SUPPLIED BY THE MANUFACTURER. INSTALL A PLACER IN EACH HOLE PROVIDED IN THE CONNECTOR TO THE MANUFACTURERS INSTRUCTIONS.
9. ROUNDED GRAVEL TO BE PLACED AROUND THE PERIMETER OF THE PAISADE AND GUN PLATFORM TO BE CLEAN AND WELL GRADED WITH A GRADATION FROM 6mm to 25mm.





