# KUGAARUK V002 INTERIOR / EXTERIOR RENOVATIONS

# CONSTRUCTION

RAWING LIST	PRIME CONSULTANT:	DRAWING SYMBOLS	ABBRE ACOUSTIC	ACST	DRYWALL	DW	LAVATORY	Liny	Inocu	
	can	1 NUMBERED NOTE DETAIL SECTION	ADHESIVE	ADH	EACH	EA	LAY-IN ACOUSTIC TILE	LAT	ROOM	RM
TITLE PAGE	COLL	WINDOW NUMBER X DETAIL NUMBER	ADJUSTABLE	ADJ	EACH WAY	EW	LEFT HAND	LH	ROUGH OPENING	RO
DEMOLITION PLAN	+00	SHEET SECTION LOCATED	AGGREGATE	AGGR	EAST	E	LEFT HAND REVERSE	LHR	RUBBER	RB
MAIN FLOOR PLAN	Tec Tec	WALL / ROOF INDENTIFIER ELEVATION IDENTIFIER	AIR VAPOUR BARRIER	AVB	ELECTRICAL	ELEC	LENGTH	LG	RVT	RESILIENT SHEET FLOORING
ELEVATIONS	ENGINEERING AND DRAFTING	X DETAIL NUMBER	ALTERNATE	ALT	ELEVATION	EL	LIGHT	LT	SCHEDULE	SCHED
ELEVATIONS	THE PART OF THE PA	DOOR NUMBER ASS SHEET ELEVATION LOCATED	ALUMINUM	ALUM	ELEVATOR	ELEV	LOUVRE	LVR		SCR
WINDOW SECTIONS AND DETAILS DETAILS	MECHANICAL ENGINEERING::		APARTMENT	APT	EPOXY	EP	MANUFACTURE	MFG	SECTION SELF ADHESIVE	SECT
DETAILS	MESTINIONE ENGINEERING;	(A#.#) DETAIL MARKER (SEE SPECIFICATION BOOK)	APPROXIMATE	APPROX	EQUAL	EQ	MARK	MK	SHEATHING	SA
DETAILS	can	(SEE SPECIFICATION BOOK)	ARCHITECTURE	ARCH	EQUALLY SPACED	EQ SP	MASONRY OPENING	МО	SHEET	SHTG
DOORS & WINDOWS SCHEDULE	Call		BEAM	ВМ	EQUIPMENT	EQUIP	MATERIAL	MAT	SHEET VINYL	SHT
	+00		BENCH MARK	BM	EXISTING	EXIST	MECHANICAL	MECH	SIMILAR	SV
***************************************	Tec >	X GRID LINES	BETWEEN	BTWN	EXPANSION	EXP	MINIMUM	MIN	SOLID CORE	SIM
MECHANICAL - MAIN FLOOR PLAN	ENGINEERING AND DRAFTING		BLOCK	BLK	EXTERIOR	EXT	MISCELLANEOUS	MISC	SOUTH	SC
ELECTRICAL - MAIN FLOOR PLAN	The state of the s		BOARD	BD	EXTRUDE	EXTR	NEAR FACE	NF NF	SPECIFICATION	8050
ELLOTRICAL - WAIN FLOOR PLAN			BOTH SIDES	BS	FACE TO FACE	F/F	NEAR SIDE	NS	SPRUCE	SPEC
			BOTH WAYS	BW	FAR SIDE	FS	NORTH	N	SPRUCE, PINE OR FIR	SPR
		,	воттом	вот	FIBREBOARD	FBRBD	NOT APPLICABLE	N/A	STAIN	S/P/F
	<b>j</b>		BUILDING	BLDG	FINISH	FIN	NOT IN CONTRACT	NIC	STAINLESS STEEL	ST
		## DETAIL MARKER	CARPET	CPT	FLOOR	FL	NOT TO SCALE	NTS	STANDARD	SS
		A##	CAST IRON	CI	FLOOR DRAIN	FD	NUMBER	NO	STEEL	STD
		ELEVATION MARKER	CEILING	CLG	FLOORING	FLG	ON CENTRE	O/C	STRUCTURAL	STL
			CEMENT BOARD	CBD	FLUORESCENT	FLR	OUT TO OUT	0/0	SQUARE FEET	STRUCT
			CENTRE	CTR	FOOTING	FTG	OUTSIDE DIAMETER	OD OD	TEMPORARY	SF
	į.	ROOM NUMBER MARKER	CENTRE TO CENTRE	C/C	FOUNDATION	FDN	OUTSIDE FACE	OF	THROUGH	TEMP
		_	CERAMIC TILE	CT	FULL SIZE	FS	OVERHEAD	ОН	TO MATCH EXISTING	THRU
		DETAIL INDENTIFICATION .	CIRCLE	CIRC	GALVANIZED	GALV	PAINT	PT	TONGUE AND GROOVE	TME
		X DETAIL NUMBER	CLEAR	CLR	GALVANIZED IRON	GI	PAINTED	PTD	TOP AND BOTTOM	T&G
		CURRENT SHEET PAGE ORIENTATION	COLUMN	COL	GAUGE	GA	PARTITION	PTN	TOP OF	T&B
	<b>i</b>	THOU OBERTATION	COMPLETE WITH	C/W	GLASS	GL	PLYWOOD	PLYWD	TYPICAL	T/O
			CONCRETE	CONC	HARDWARE	HDW	PRECAST	PC	UNDER SIDE	TYP
	,		CONCRETE BLOCK	CBLK	HEIGHT	HGT	PRECAST CONCRETE	PC CONC	UNDERCUT	U/S
			CONSTRUCTION	CONST	HEXAGON	HEX	PREFABRICATION	PREFAB	URINAL	UCUT
			CONTINUOUS	CONT	HOLLOW CORE	нс	PREFINISHED	PREFIN	VAPOUR BARRIER	VB
			CONTROL JOINT	CJ	HOLLOW METAL	HM	PRESSED STEEL	PS	VERTICAL	VERT
			COUNTERSINK	CSK	HORIZONTAL	HORIZ	QUANTITY	QTY	VINYL ASBESTOS TILE	VAT
			COVED SHEET VINYL	csv	INCLUSIVE	INCL	QUARRY TILE	ат	VINYL COVE BASE	VCB
	İ	•	DETAIL	DTL	INSIDE DIAMETER	ID	RADIUS	R	VINYL TILE	VT
			DEMOLISH	DEMO	INSIDE FACE	IF	RAINWATER LEADER	RWL	VINYL WALL COVERING	
	ĺ		DIAGONAL	DIAG	INSULATE	INSUL,	REFERENCE	REF	WATER CLOSET	VWC WC
									TITTLE CHOOLI	TANG.
	ĺ							1	]	į
	1									
	Ī									
							}	01	ISSUED FOR CONSTRUCTI	
	<u> </u>							REV.#	REVISION	DATE (YY MM DD) REV. BY
18-05-02 4:20 PM		<del></del>	. <b>.</b>	1						1 1124.01

DIMENSIONS, DATUMS AND LEVELS PRIOR TO COMMENCEMENT OF WORK AND IS HELD RESPONSIBLE FOR REPORTING ANY
DISCREPANCY OR OMISSION TO CAN-TEC SERVICES LTD. IMMEDIATELY. THIS DRAWING IS THE EXCLUSIVE PROPERTY OF CAN-TEC SERVICES LTD. AND CAN BE REPRODUCED ONLY WITH THE PERMISSION OF CAN-TEC SERVICES LTD. IN WHICH CASE THE REPRODUCTION MUST BEAR THEIR NAME AS THE ENGINEERING/DRAFTING FIRM. ENGINEERING


EXTERIOR RENOVATIONS V002

SCALE AS NOTED

TITLE PAGE

LOCATION KUGAARUK, NUNAVUT рате (уу мим рр.) 15 10 19

CONSTRUCTION

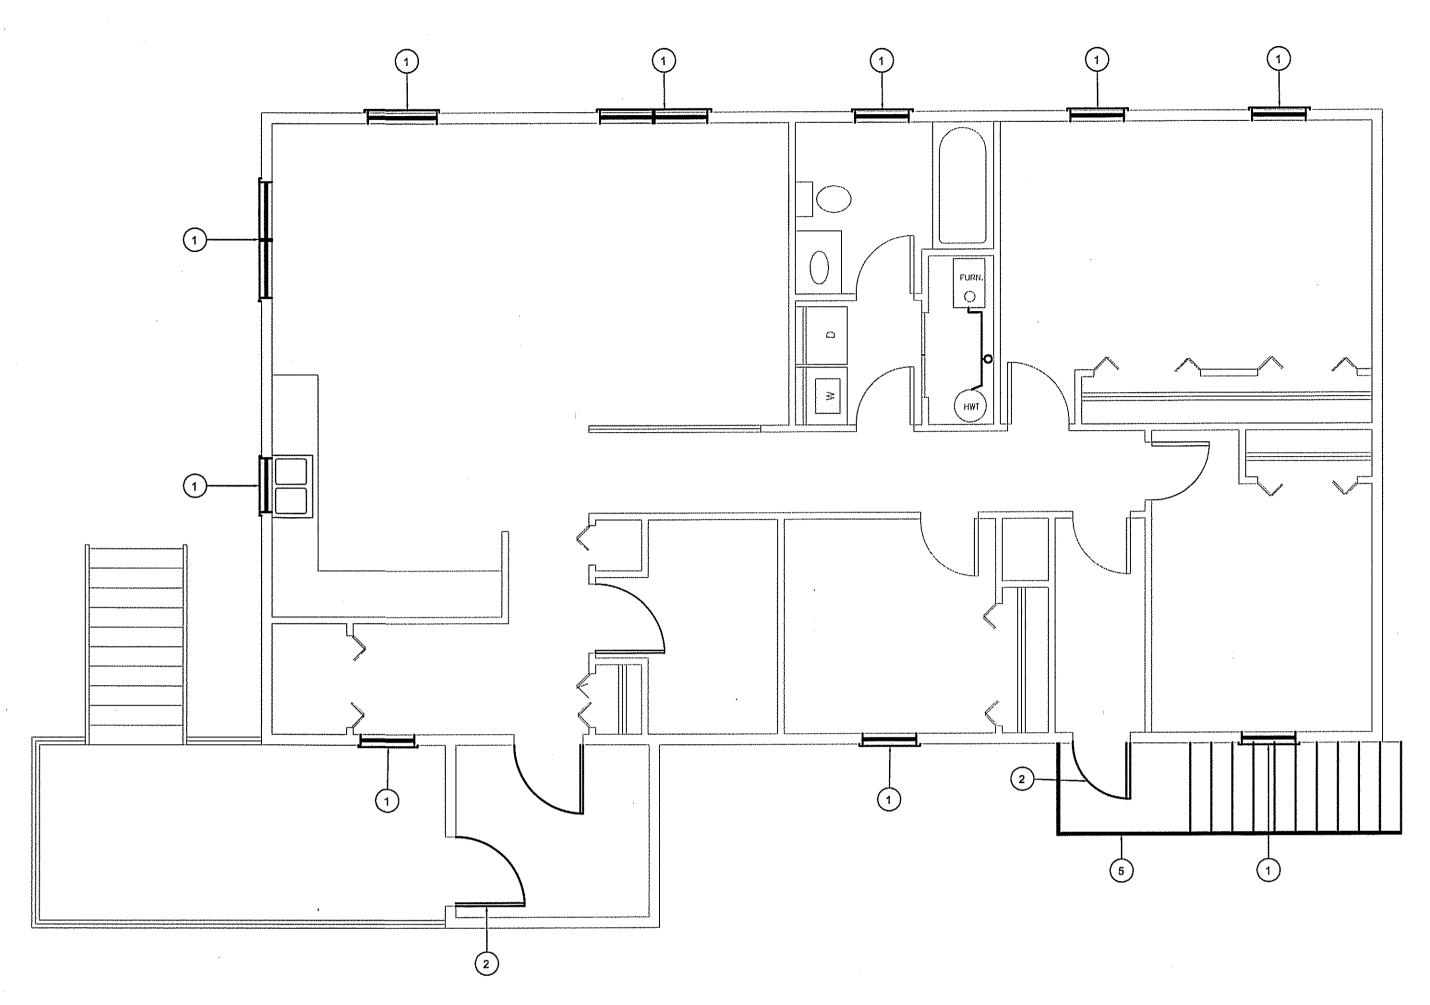



# **DEMOLITION PLAN**


SCALE: 1:50

# DRAWING NOTES #

- 1. REMOVE WINDOW REMOVE EXTERIOR DOOR
- 3. REMOVE FURNACE AND CHIMNEY
- 4. EXISTING HOT WATER TANK TO
- 5. REMOVE EXISTING STAIRS, AND ENTRY VESTIBULE (SEE DETAIL THIS SHEET)

### **DEMOLITION NOTES**

- 1. ALL DEMOLISHED MATERIALS TO BE REMOVED FROM SITE
- AND DISPOSED OF AS PER LOCAL CODES 2. REMOVE ALL WINDOW AND EXTERIOR DOOR CASINGS.

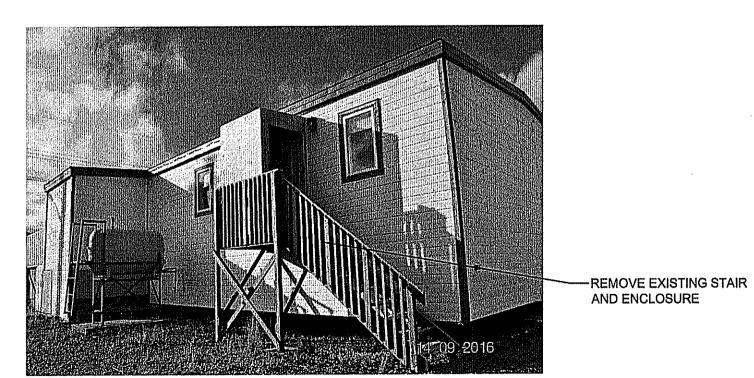


**DEMOLITION PLAN - EXISTING STAIRS** 

SCALE: 1:50

THIS DRAWING MUST NOT BE SCALED.

THE GENERAL CONTRACTOR SHALL VERIFY ALL DIMENSIONS, DATUMS AND LEVELS PRIOR TO COMMENCEMENT OF WORK AND IS HELD RESPONSIBLE FOR REPORTING ANY DISCREPANCY OR OMISSION TO CAN-TEC SERVICES LTD, IMMEDIATELY.

THIS DRAWING IS THE EXCLUSIVE PROPERTY OF CAN-TEC SERVICES LTD. AND CAN BE REPRODUCED ONLY WITH THE PERMISSION OF CAN-TEC SERVICES LTD. IN WHICH CASE THE REPRODUCTION MUST BEAR THEIR NAME AS THE ENGINEERING/DRAFTING FIRM.

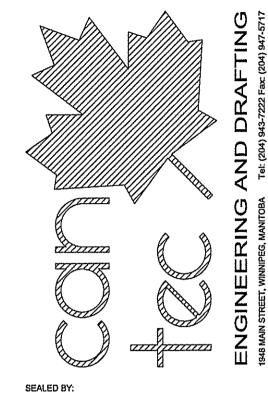


INTERIOR AND EXTERIOR RENOVATIONS V002 DEMOLITION

CONSTRUCTION

DRAWN BY RQS

LOCATION KUGAARUK, NUNAVUT

ISSUED FOR CONSTRUCTION 18 03 22 DATE (YY MM DD) REV. BY REV.# REVISION

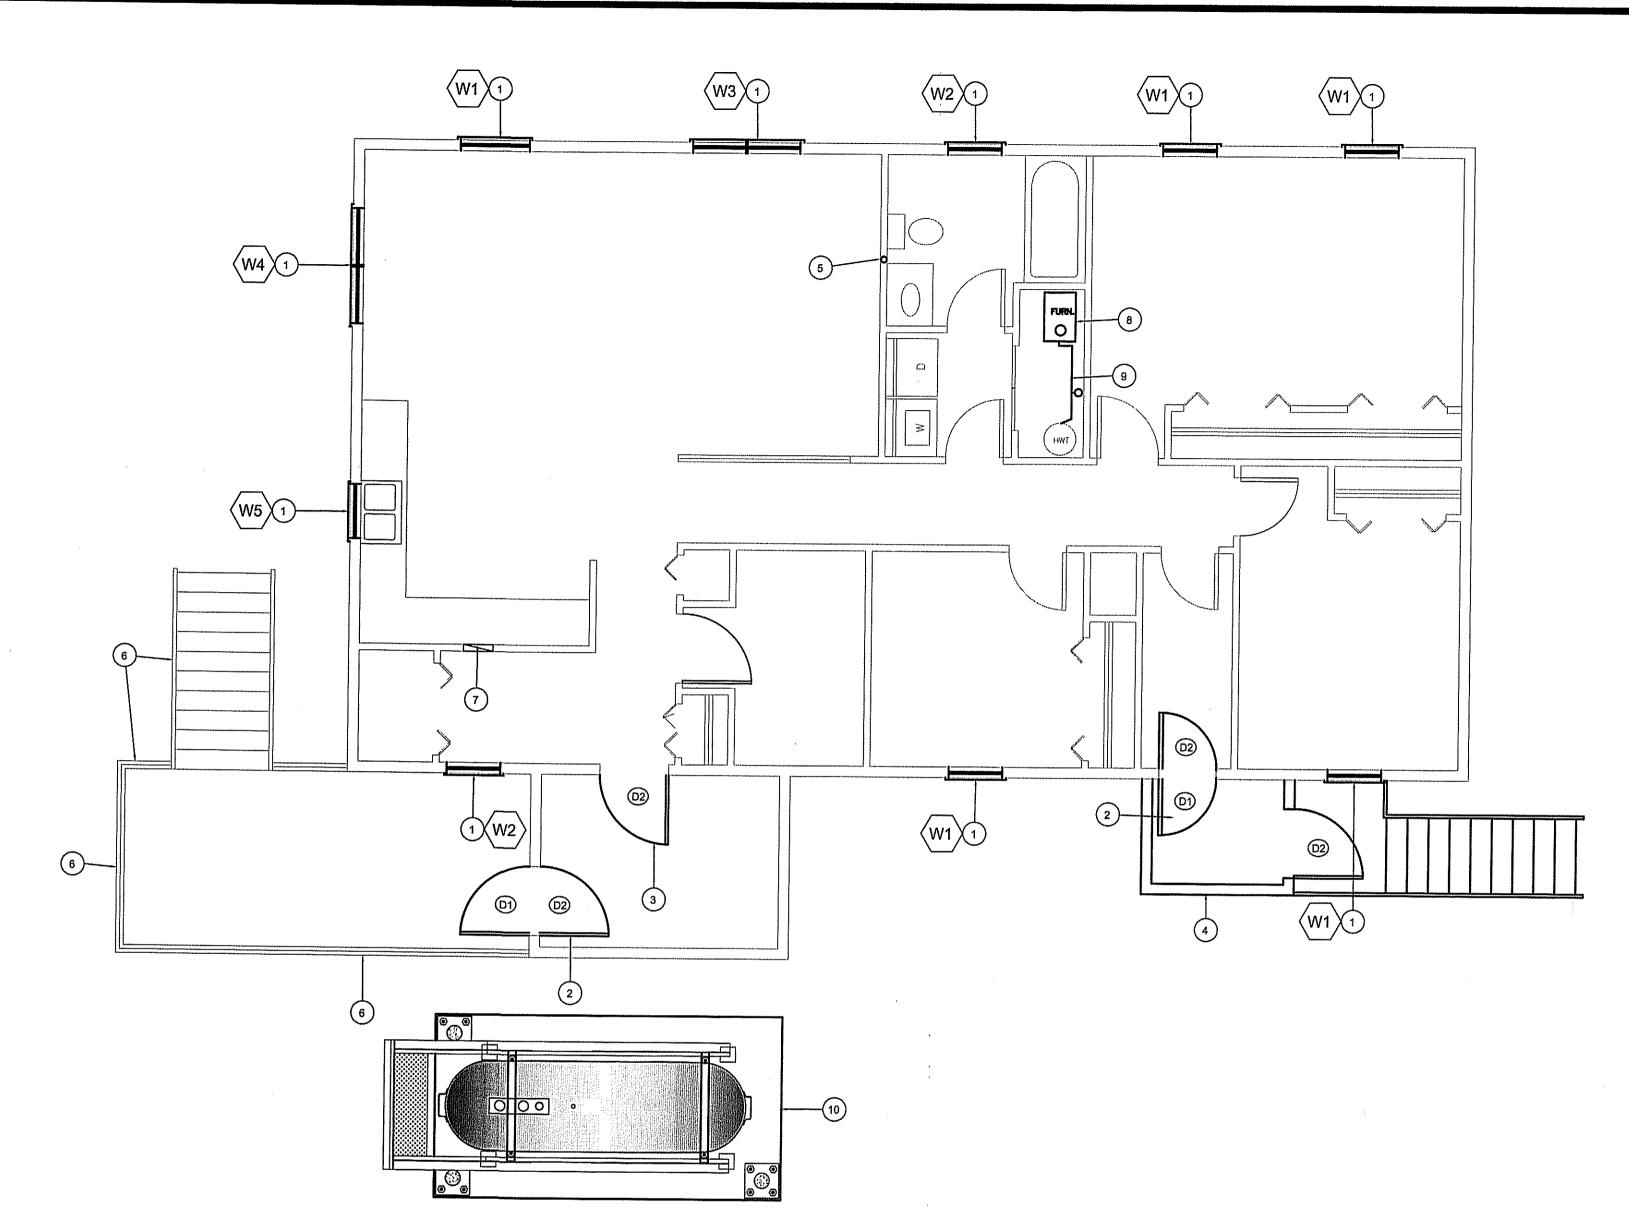



# DRAWING NOTES #

- 1. INSTALL NEW WINDOWS, EXTERIOR TRIP AND INTERIOR CASING. NEW CASING TO BE PAINTED TO MATCH EXISTING TRIM. NEW BLINDS TO BE INSTALLED SEE SPECIFICATION FOR TYPE.
- 2. INSTALL NEW EXTERIOR DOOR AND STORM DOOR 3. INSTALL NEW EXTERIOR DOOR
- 4. INSTALL NEW EXTERIOR LANDING, STAIRS AND NEW HANDRAILS.
- 5. MAKE GOOD ANY DAMAGE DONE TO WALL BY THE INSTALLATION OF NEW ARCTIC VENT
- PAINT EXISTING DECK, STAIRS AND RAILINGS
- 7. ELECTRICAL PANEL
  8. INSTALL NEW HOT FURNACE
- INSTALL NEW FUEL PIPING
- 10. INSTALL NEW FUEL TANK SEE FUEL TANK DRAWINGS FOR DETAILS


### **GENERAL NOTES**

- INSTALL NEW WINDOW CASING AROUND ALL NEW WINDOWS
   REPAIR DAMAGE TO CEILING AND WALLS AS REQUIRE TO INSTALL NEW

THIS DRAWING MUST NOT BE SCALED.

THE GENERAL CONTRACTOR SHALL VERIFY ALL DIMENSIONS, DATUMS AND LEVELS PRIOR TO COMMENCEMENT OF WORK AND IS HELD RESPONSIBLE FOR REPORTING ANY DISCREPANCY OR OMISSION TO CAN-TEC SERVICES LTD. IMMEDIATELY.

THIS DRAWING IS THE EXCLUSIVE PROPERTY OF CAN-TEC SERVICES LTD, AND CAN BE REPRODUCED ONLY WITH THE PERMISSION OF CAN-TEG SERVICES LTD. IN WHICH CASE THE REPRODUCTION MUST BEAR THEIR NAME AS THE ENGINEERING/DRAFTING FIRM.

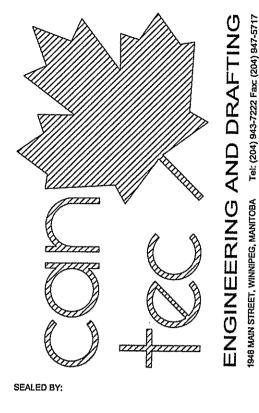

**EXTERIOR RENOVATIONS V002** INTERIOR AND

PLAN RENOVATION


RS S

DRAWN BY RQS


рате (үү мм рр) 15 10 19

CONSTRUCTION

ISSUED FOR CONSTRUCTION 18 03 22 RS DATE (YY MM DD) REV. BY REV.# REVISION

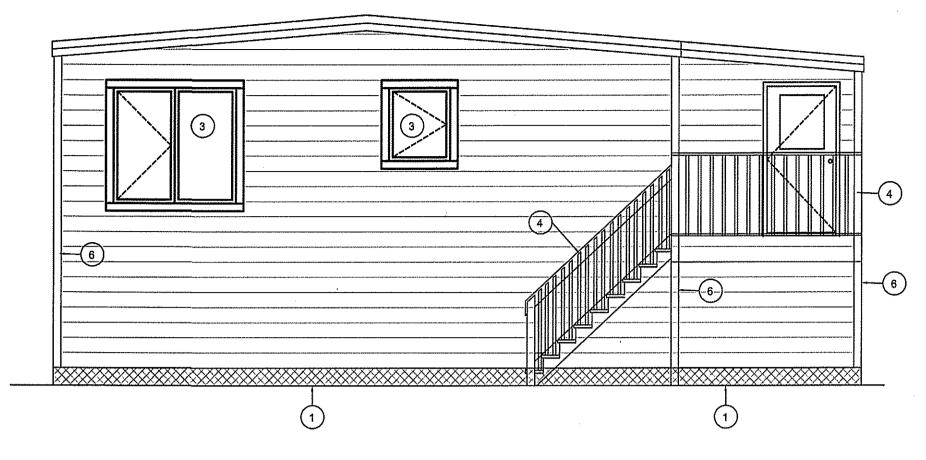



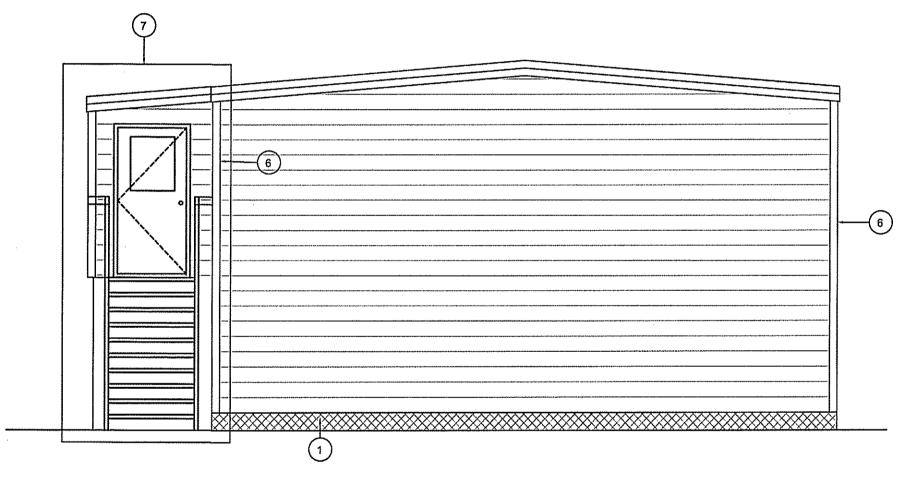



### DRAWING NOTES: #

 INSTALL NEW SKIRTING
 RE-SECURE AND RE-STAIN EXISTING SIDING AND TRIM 3. INSTALL NEW WINDOW AND PAINT TRIM

4. RE-PAINT EXTERIOR DECK AND STAIRS

5. INSTALL NEW EXTERIOR DOOR


6. PAINT TRIM

7. NEW VESTIBULE AND STAIRS

THIS DRAWING MUST NOT BE SCALED.

THE GENERAL CONTRACTOR SHALL VERIFY ALL DIMENSIONS, DATUMS AND LEVELS PRIOR TO COMMENCEMENT OF WORK AND IS HELD RESPONSIBLE FOR REPORTING ANY DISCREPANCY OR OMISSION TO CAN-TEC SERVICES LTD. IMMEDIATELY.

THIS DRAWING IS THE EXCLUSIVE PROPERTY OF CAN-TEC SERVICES LTD. AND CAN BE REPRODUCED ONLY WITH THE PERMISSION OF CAN-TEC SERVICES LTD. IN WHICH CASE THE REPRODUCTION MUST BEAR THEIR NAME AS THE ENCONDED TO SETTING FIRM

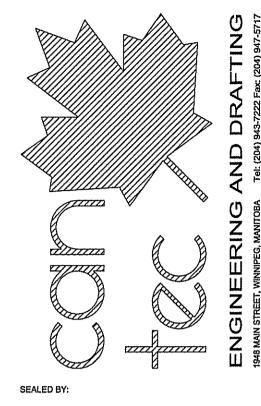

**EXTERIOR RENOVATIONS V002** INTERIOR AND

ELEVATIONS рате (тумм рр) 15 10 19

RQS


SCALE AS NOTED

CONSTRUCTION


ISSUED FOR CONSTRUCTION 18 03 22 DATE (YY MM DD) REV. BY REV.# REVISION

REVISION #: 01
JOB NO.

17-058-01-30

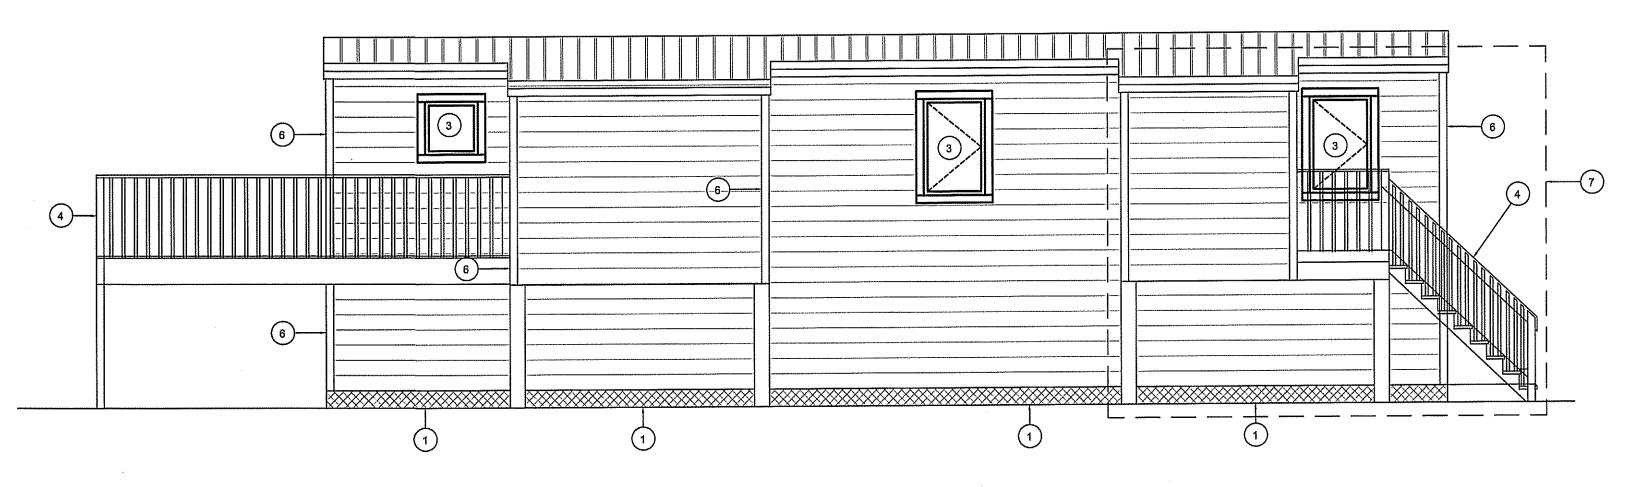

RIGHT ELEVATION A3.1 SCALE: 1:50

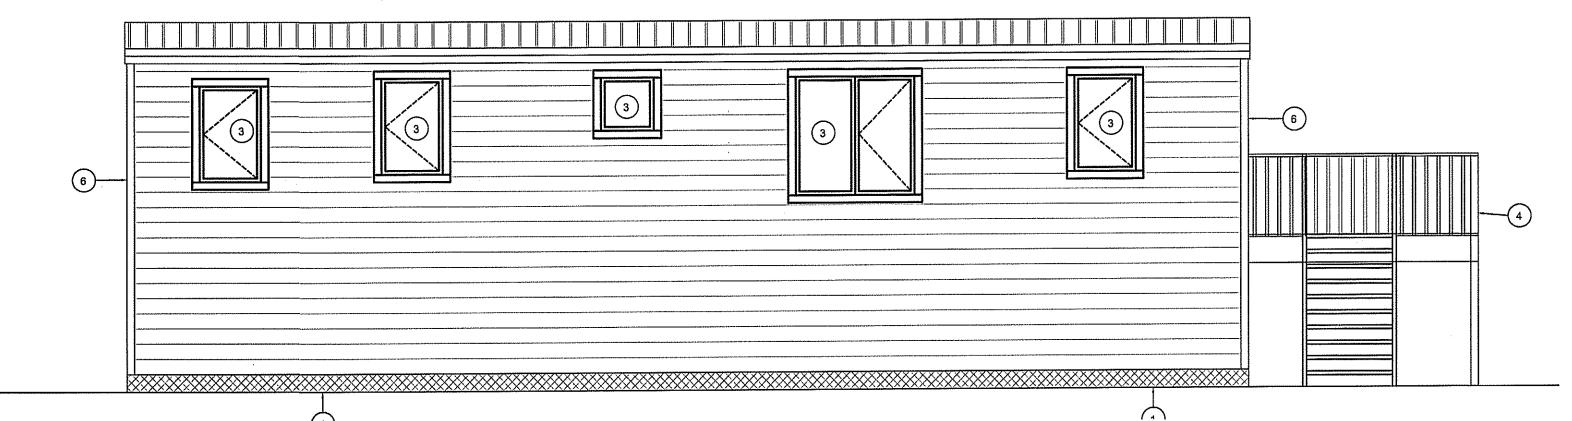

LEFT ELEVATION SCALE: 1:50


## DRAWING NOTES:#

- INSTALL NEW SKIRTING RE-SECURE AND RE-STAIN EXISTING SIDING AND TRIM
- INSTALL NEW WINDOW AND PAINT TRIM
  RE-PAINT EXTERIOR DECK AND STAIRS
- INSTALL NEW EXTERIOR DOOR
- PAINT TRIM
- 7. INSTALL NEW AND STAIRS

THIS DRAWING MUST NOT BE SCALED.

THE GENERAL CONTRACTOR SHALL VERIFY ALL DIMENSIONS, DATUMS AND LEVELS PRIOR TO COMMENCEMENT OF WORK AND IS HELD RESPONSIBLE FOR REPORTING ANY DISCREPANCY OR OMISSION TO CAN-TEC SERVICES LTD. IMMEDIATELY.

THIS DRAWING IS THE EXCLUSIVE PROPERTY OF CAN-TEC SERVICES LTD. AND CAN BE REPRODUCED ONLY WITH THE PERMISSION OF CAN-TEC SERVICES LTD, IN WHICH CASE THE REPRODUCTION MUST BEAR THEIR NAME AS THE ENGINEERING/DRAFTING FIRM.

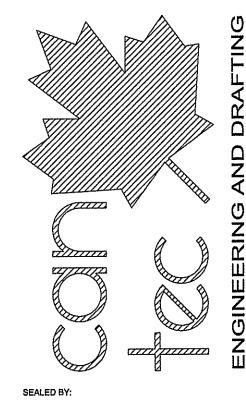

**EXTERIOR RENOVATIONS V002** INTERIOR AND ELEVATIONS

снескерт RS


DRAWN BY RQS


CONSTRUCTION

REVISION #: 01 JOB NO. 17-058-01-30

ISSUED FOR CONSTRUCTION 18 03 22

DATE (YY MM DD) REV. BY REV.# REVISION

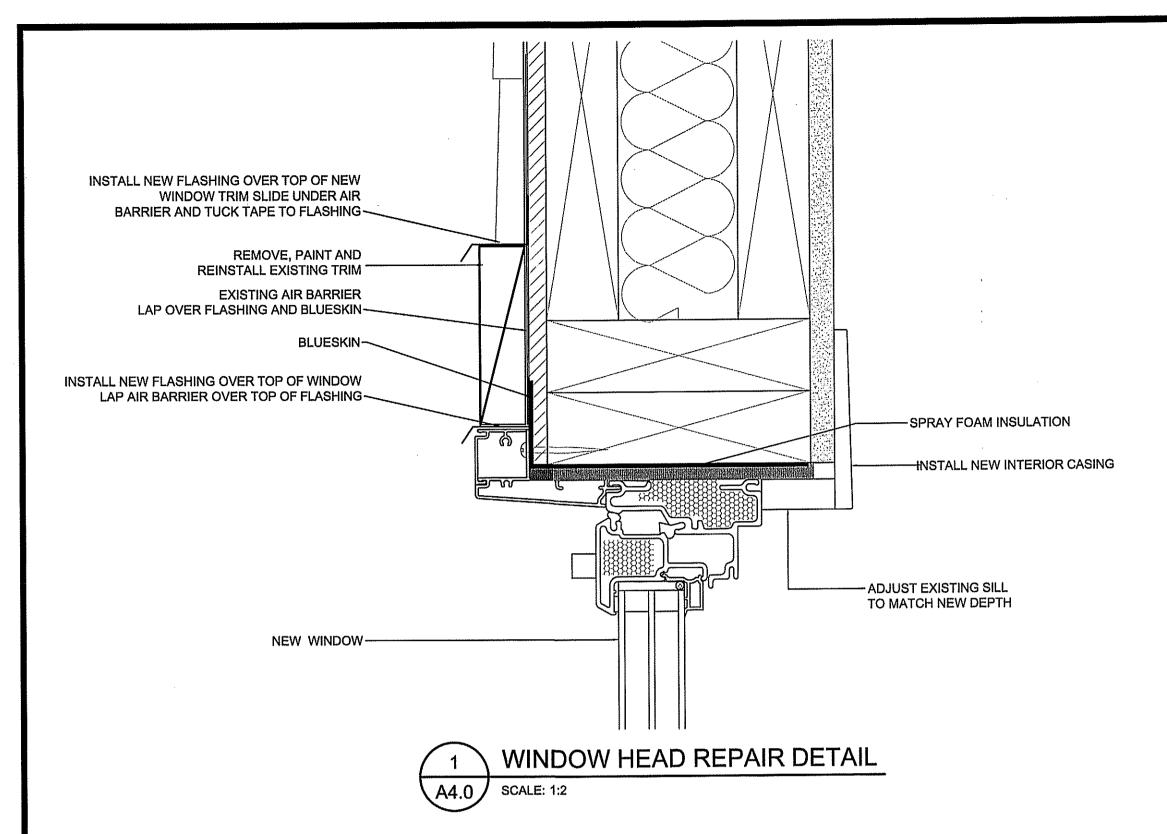


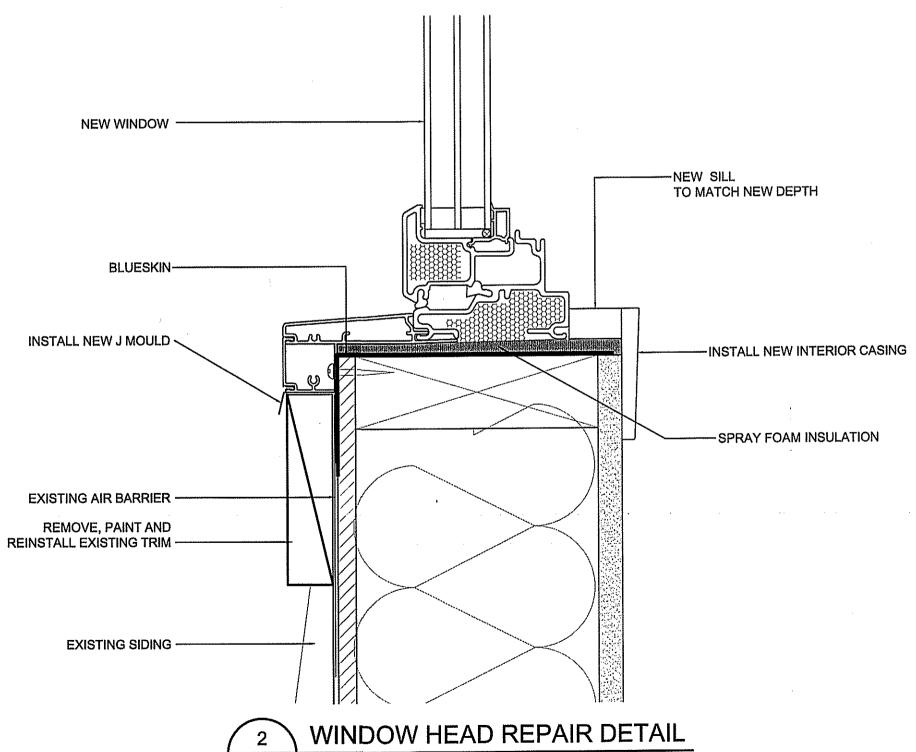

SCALE: 1:2

### WINDOW REPAIR NOTES

- REMOVE EXISTING WINDOW AND REPLACE WINDOW
- 2. CUT BACK EXISTING WOOD SIDING TO ALLOW FOR INSTALLATION OF NEW
- WINDOW AND EXTERIOR TRIM.
- 3. INSTALL NEW FLASHING SHOWN ON DETAIL.

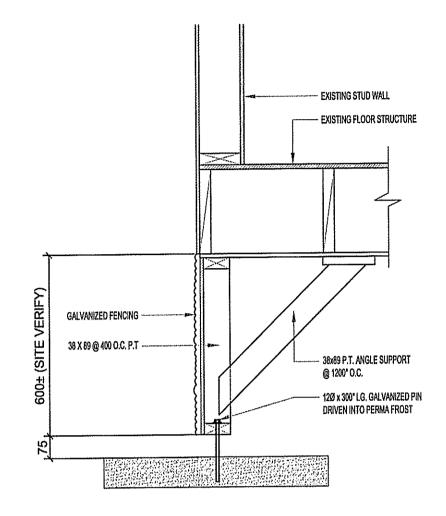




THIS DRAWING MUST NOT BE SCALED.

THE GENERAL CONTRACTOR SHALL VERIFY ALL DIMENSIONS, DATUMS AND LEVELS PRIOR TO COMMENCEMENT OF WORK AND IS HELD RESPONSIBLE FOR REPORTING ANY DISCREPANCY OR OMISSION TO CAN-TEC SERVICES LTD. IMMEDIATELY.

THIS DRAWING IS THE EXCLUSIVE PROPERTY OF CAN-TEC SERVICES LTD. AND CAN BE REPRODUCED ONLY WITH THE PERMISSION OF CAN-TEC SERVICES LTD. IN WHICH CASE THE REPRODUCTION MUST BEAR THEIR NAME AS THE ENGINEERING/DRAFTING FIRM.

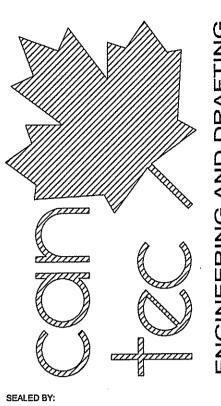

INTERIOR AND EXTERIOR RENOVATIONS V002
DOOR & WINDOW DETAIL SECTION


CONSTRUCTION


A4.0

JOB NO.

ISSUED FOR CONSTRUCTION 18 03 22 RS
REVISION PATE (YY MM DD) REV. BY

REV.# REVISION

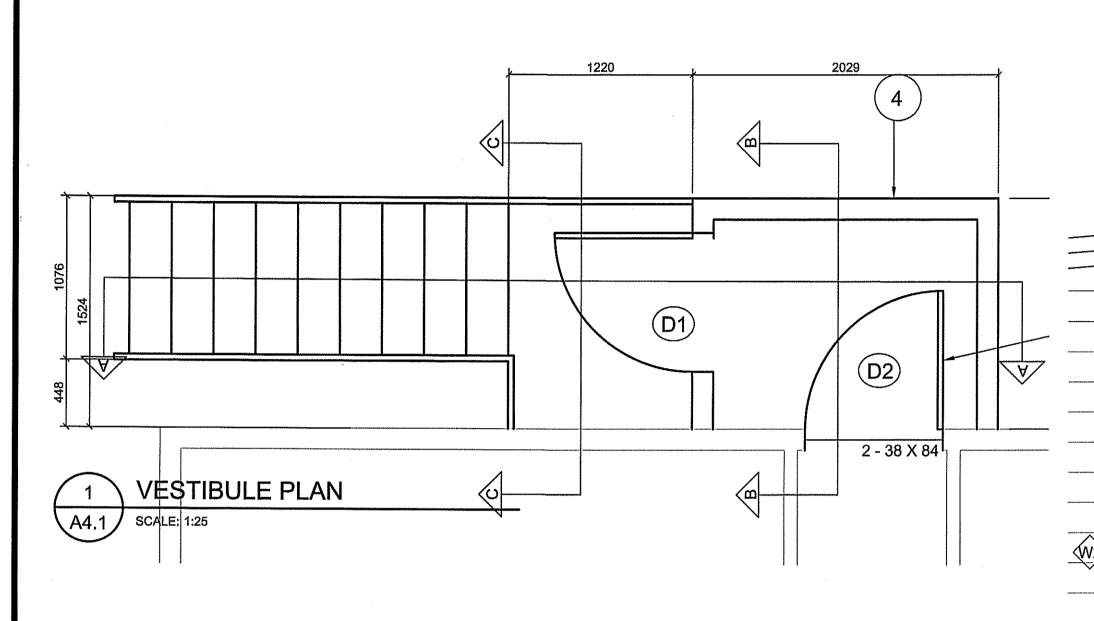

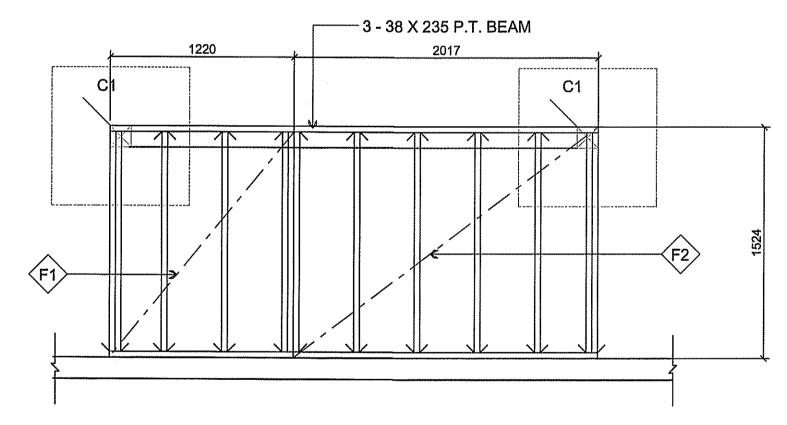

FRAMING PLAN SCALE: 1:25

### FLOOR SCHEDULE

- 19 PLYWOOD GIS 10 MIL AVB 38 X 235 N.2 SP JOISTS @ 400 O.C. MINERAL FIBER INSULATION ½" PLYWOOD
- STEEL GRATING GRIP SPAN 38 mm DEEP 38 X 235 P.T. JOISTS @ 4000.C.

### POST SCHEDULE

140 X 140 P.T. POST. 762 X 762 X 254 CONCRETE PAD

### **ROOF SCHEDULE**

26 GA STEEL ROOFING TO MATCH EXISTING ICE + WATER SHIELD. 12 mm PLYWOOD 38 X 184 JOISTS @ 400 O.C. FIBERGLASS INSULATION 6 MIL AVB <sup>1</sup>/<sub>2</sub>" PLYWOOD - PAINTED

### DRAWING NOTES

- FOOTING PAD 762 X 762 X 254
- (2) HAND RAIL 914 HIGH
- PICKETS 38 X 38 @ 75 mm BETWEEN EACH PICKET
- GRIP SPAN STAIR TREADS 280 mm
- 2 LAYERS 38 X 40 P.T. PAD UNDER STAIR END

# WALL SCHEDULE

2029



**SECTION A** 

SCALE: 1:25

D1

HARDIE BOARD SIDING COLOR TO MATCH EXISTING AIR BARRIER 13" PLYWOOD 38 X 89 # 2 SP STUDS @400 O.C. 6 MIL AVB 13 G1S PLYWOOD PAINTED

-SIMPLEX POST ANCHOR


**€**}-

1220

THIS DRAWING MUST NOT BE SCALED.

THE GENERAL CONTRACTOR SHALL VERIFY ALL DIMENSIONS, DATUMS AND LEVELS PRIOR TO COMMENCEMENT OF WORK AND IS HELD RESPONSIBLE FOR REPORTING ANY DISCREPANCY OR OMISSION TO CAN-TEC SERVICES LTD. IMMEDIATELY.

THIS DRAWING IS THE EXCLUSIVE PROPERTY OF CAN-TEC SERVICES LTD. AND CAN BE REPRODUCED ONLY WITH THE PERMISSION OF CAN-TEC SERVICES LTD. IN WHICH CASE THE REPRODUCTION MUST BEAR THEIR NAME AS THE ENGINEERING/DRAFTING FIRM.

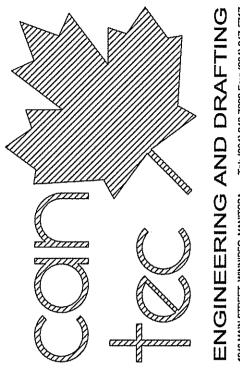

SEALED BY:

**EXTERIOR RENOVATIONS V120 NTERIOR AND** 

5

DATE (YY MM DD) REV. BY

REV.# REVISION

**DETAILS** 


CONSTRUCTION

17-058-01-30

Last Save:2018-05-02 4:24 PM


NUNAVUT

15 10 19

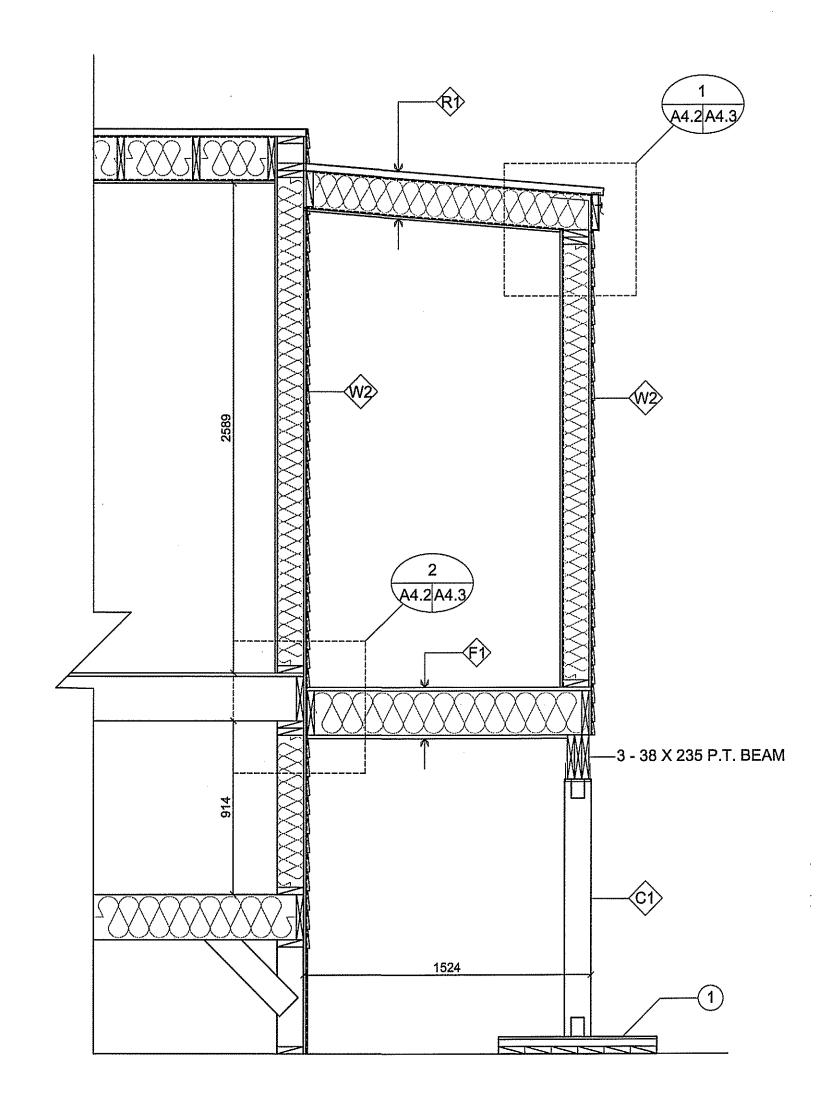

4 SECTION B

A4.2 SCALE: 1:20

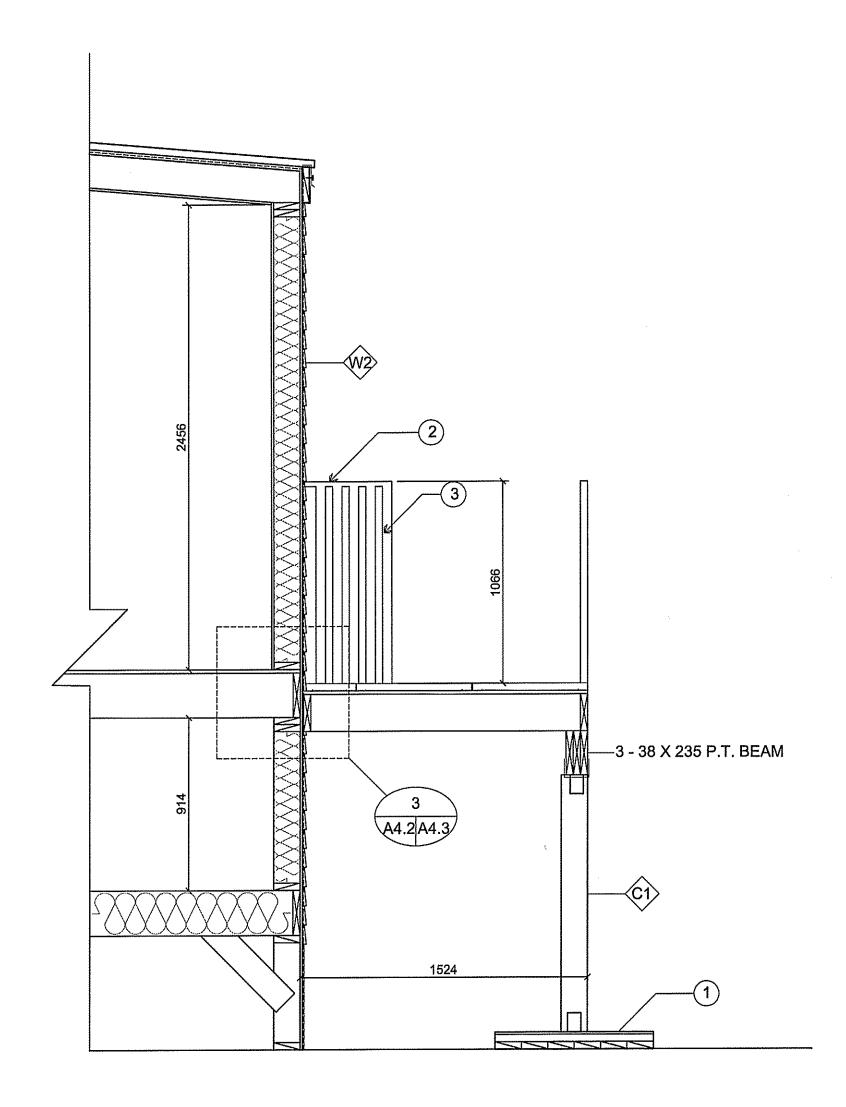


5 SECTION C
A4.2 SCALE: 1:20

THIS DRAWING MUST NOT BE SCALED.

THE GENERAL CONTRACTOR SHALL VERIFY ALL DIMENSIONS, DATUMS AND LEVELS PRIOR TO COMMENCEMENT OF WORK AND IS HELD RESPONSIBLE FOR REPORTING ANY DISCREPANCY OR OMISSION TO CAN-TEC SERVICES LTD. IMMEDIATELY.

THIS DRAWING IS THE EXCLUSIVE PROPERTY OF CAN-TEC SERVICES LTD. AND CAN BE REPRODUCED ONLY WITH THE PERMISSION OF CAN-TEC SERVICES LTD. IN WHICH CASE THE REPRODUCTION MUST BEAR THEIR NAME AS THE ENGINEERING/DRAFTING FIRM.

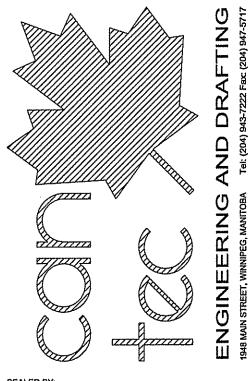

SEALED BY:

INTERIOR AND EXTERIOR RENOVATIONS V120

DETAILS

DATE (TY MAN DD)

15 10 19

AS


LOCATION

CONSTRUCTION

A4.2

 01
 ISSUED FOR CONSTRUCTION
 18 05 02
 RS

 REV. #
 REVISION
 PATE (YY MM DD)
 REV. BY

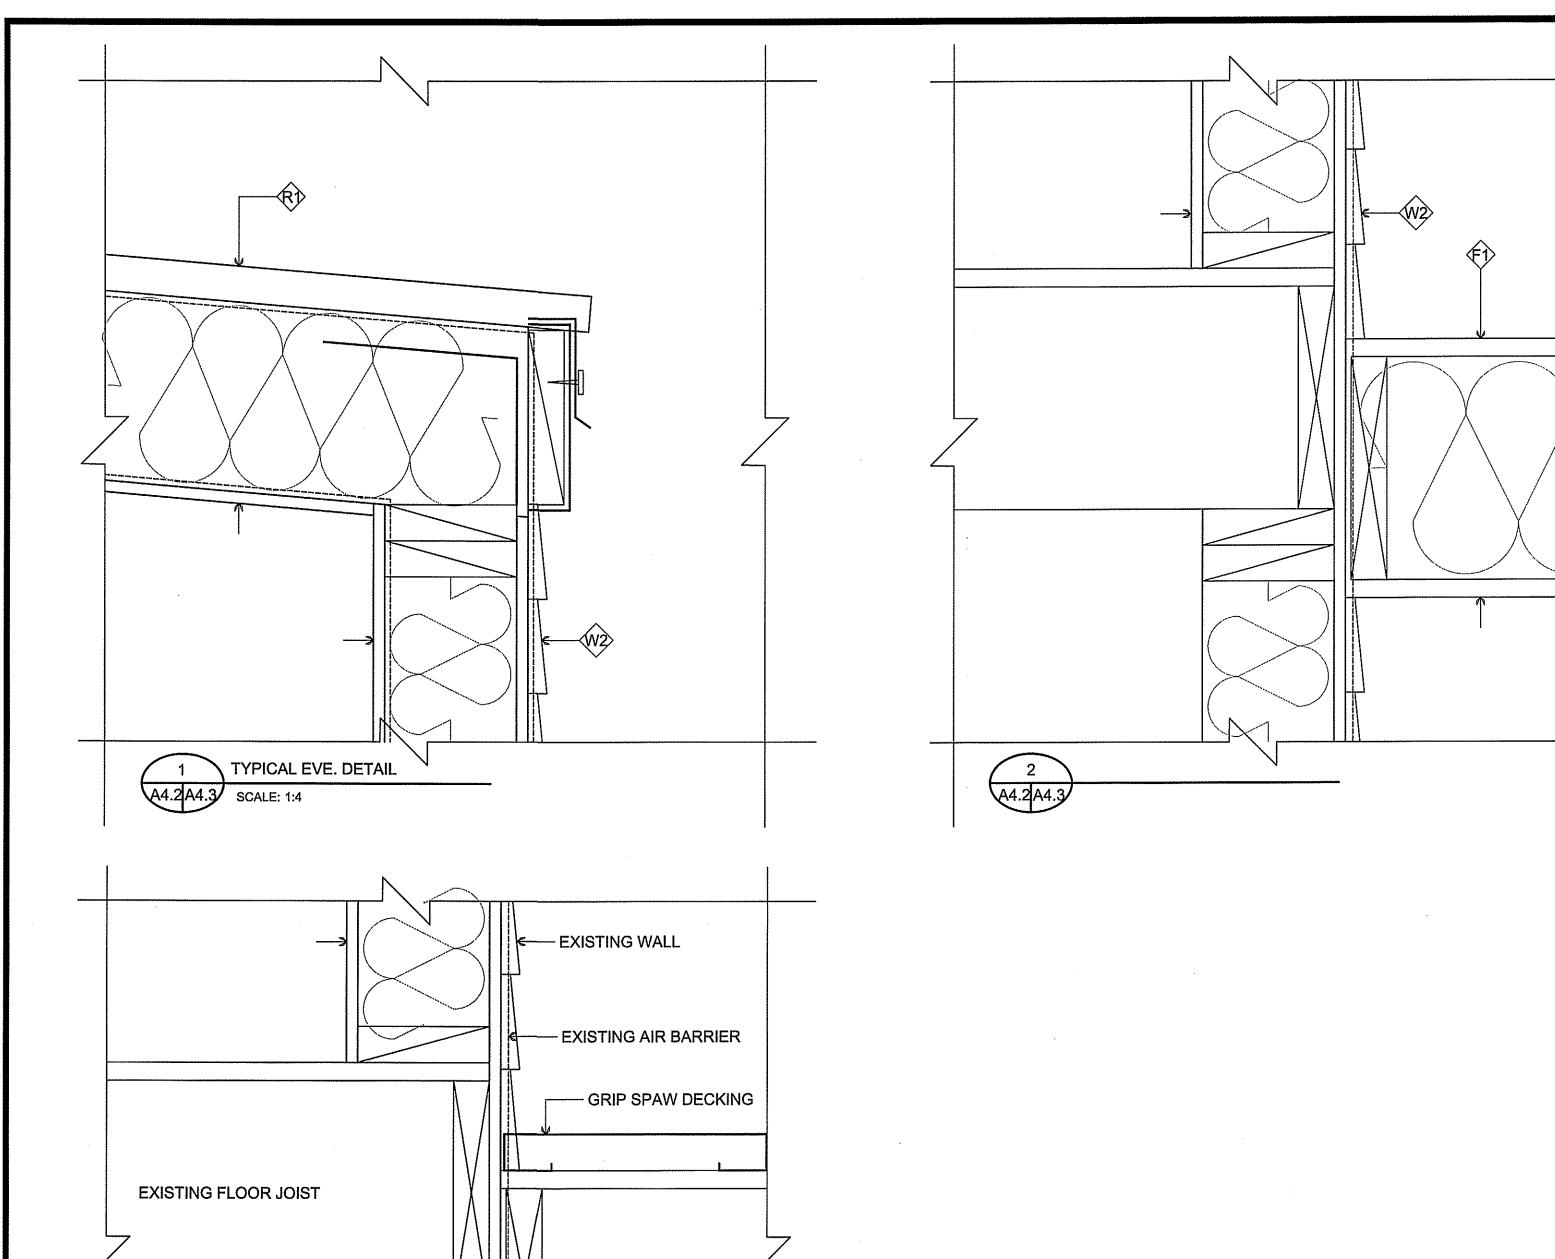


← P.T. FLOOR JOIS

- 16 GA GALVANIZED FLASHING

THIS DRAWING MUST NOT BE SCALED.

THE GENERAL CONTRACTOR SHALL VERIFY ALL DIMENSIONS, DATUMS AND LEVELS PRIOR TO COMMENCEMENT OF WORK AND IS HELD RESPONSIBLE FOR REPORTING ANY DISCREPANCY OR OMISSION TO CAN-TEC SERVICES LTD. IMMEDIATELY SERVICES LTD. IMMEDIATELY.

THIS DRAWING IS THE EXCLUSIVE PROPERTY OF CAN-TEC SERVICES LTD. AND CAN BE REPRODUCED ONLY WITH THE PERMISSION OF CAN-TEC SERVICES LTD. IN WHICH CASE THE REPRODUCTION MUST BEAR THEIR NAME AS THE ENGINEERING/DRAFTING FIRM.

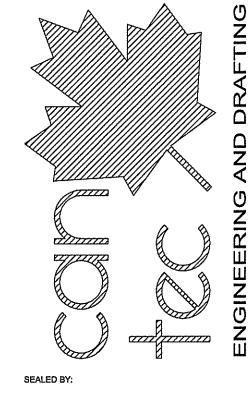

# INTERIOR AND EXTERIOR RENOVATIONS V120

DRAWN BY RQS

CONSTRUCTION

17-058-01-30

ISSUED FOR CONSTRUCTION 18 05 02 REV.# REVISION

18 05 02 RS

DATE (YY MM DD) REV. BY

CRAWL SPACE

# DOOR SCHEDULE (D#)

MARK	SIZE	TYPE	ELEV	FRAME	HARDWARE	REMARKS
D1	914 X 2032 X 38	INSULATED FIBERGLASS STORM DOOR	В	Α	2	WINDOW 1/2 LITE
D2	914 X 2032 X 38	INSULATED FIBERGLASS EXTERIOR DOOR	Α	A	1	
D3	914 X 2032 X 38	INSULATED FIBERGLASS STORM DOOR	В	A	2	WINDOW 1/2 LITE
D4	914 X 2032 X 38	INSULATED FIBERGLASS EXTERIOR DOOR	Α		1	The terms of the t

### NOTES:

- 1. ALL DOORS ACTUAL SIZES TO BE VERIFIED ON SITE.
- 2. SEE DOOR STANDARD SECTION DETAILS
- 3. INSTALL NEW CASING AROUND ALL DOORS SEE SPEC. FOR DETAILS

# DOOR HARDWARE GROUPS

HINGES

Grp 1

Complete by Door supplier AL53PD NEP

LOCKSET DEADLOCK FLOOR STOP

B660P S100 Series 626

SCHLAGE 626 STD. METAL

SCHLAGE

698 626 CANAROPA WHEATHERSTRIP, SWEEPS AND THRESHOLD COMPLETE BY DOOR SUPPLIER

# DOOR HARDWARE GROUPS

HINGES

LOCKSET

**FLOOR STOP** 

DOOR VIEWER

Grp 2

Complete by Door supplier

AL53PD NEP


S100 Series

626 SCHLAGE 626 STD. METAL

WHEATHERSTRIP, SWEEPS AND THRESHOLD COMPLETE BY DOOR SUPPLIER

# **DOOR DETAILS**

DOOR ELEVATIONS

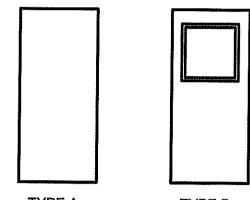



TYPE A SLAB


TYPE B 1/2 LITE


# **DOOR FRAME DETAILS**


A - MANUF SUPPLIED WOOD DOOR FRAMES C/W THERMALLY BROKEN THRESHOLD

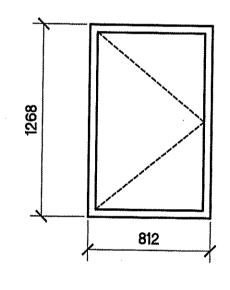

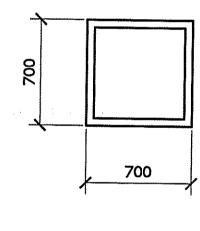

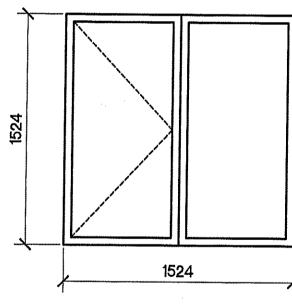

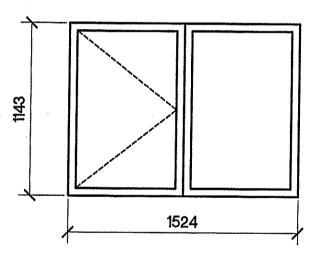

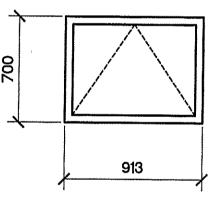












# NOTES:

- 1. 6 MIL POLY RETURNED INTO ROUGH WINDOW OPENING AND SEALED TO WOOD FRAMING
- 2. AIR BARRIER RETURNED INTO ROUGH WINDOW OPENING AND SEALED TO WOOD FRAMING
- 3. SPRAY FOAM INSULATION INTO SPACES BETWEEN WINDOW AND ROUGH OPENING
- 4. PROVIDE PRE FINISHED POST FORMED GALVANIZED STEEL FLASHING FULL WIDTH OF WINDOW AT TOP OF WINDOW
- 5. BEDROOM WINDOWS MUST MEET NBC EGRESS **REQUIREMENTS AS PER 9.7.1.3.2**
- 6. INSTALL NEW WINDOW, AND DOOR CASING TO ALL UNITS BEING REPLACED.

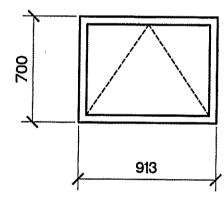

**EXTERIOR RENOVATIONS V002** NTERIOR AND

SEALED BY:

/ DETAILS

SCHEDULE

WINDOWS

**ං**ර

S

OR.

THIS DRAWING MUST NOT BE SCALED.

SERVICES LTD. IMMEDIATELY.

THE GENERAL CONTRACTOR SHALL VERIFY ALL DIMENSIONS, DATUMS AND LEVELS PRIOR TO COMMENCEMENT OF WORK AND IS HELD RESPONSIBLE FOR REPORTING ANY


THIS DRAWING IS THE EXCLUSIVE PROPERTY OF CAN-TEC SERVICES LTD. AND CAN BE REPRODUCED ONLY WITH THE PERMISSION OF CAN-TEC SERVICES LTD. IN WHICH CASE THE REPRODUCTION MUST BEAR THEIR NAME AS THE ENGINEERING/DRAFTING FIRM.

DRAWN BY RQS

AS

CONSTRUCTION

ISSUED FOR CONSTRUCTION 18 03 22 DATE (YY MM DD) REV. BY

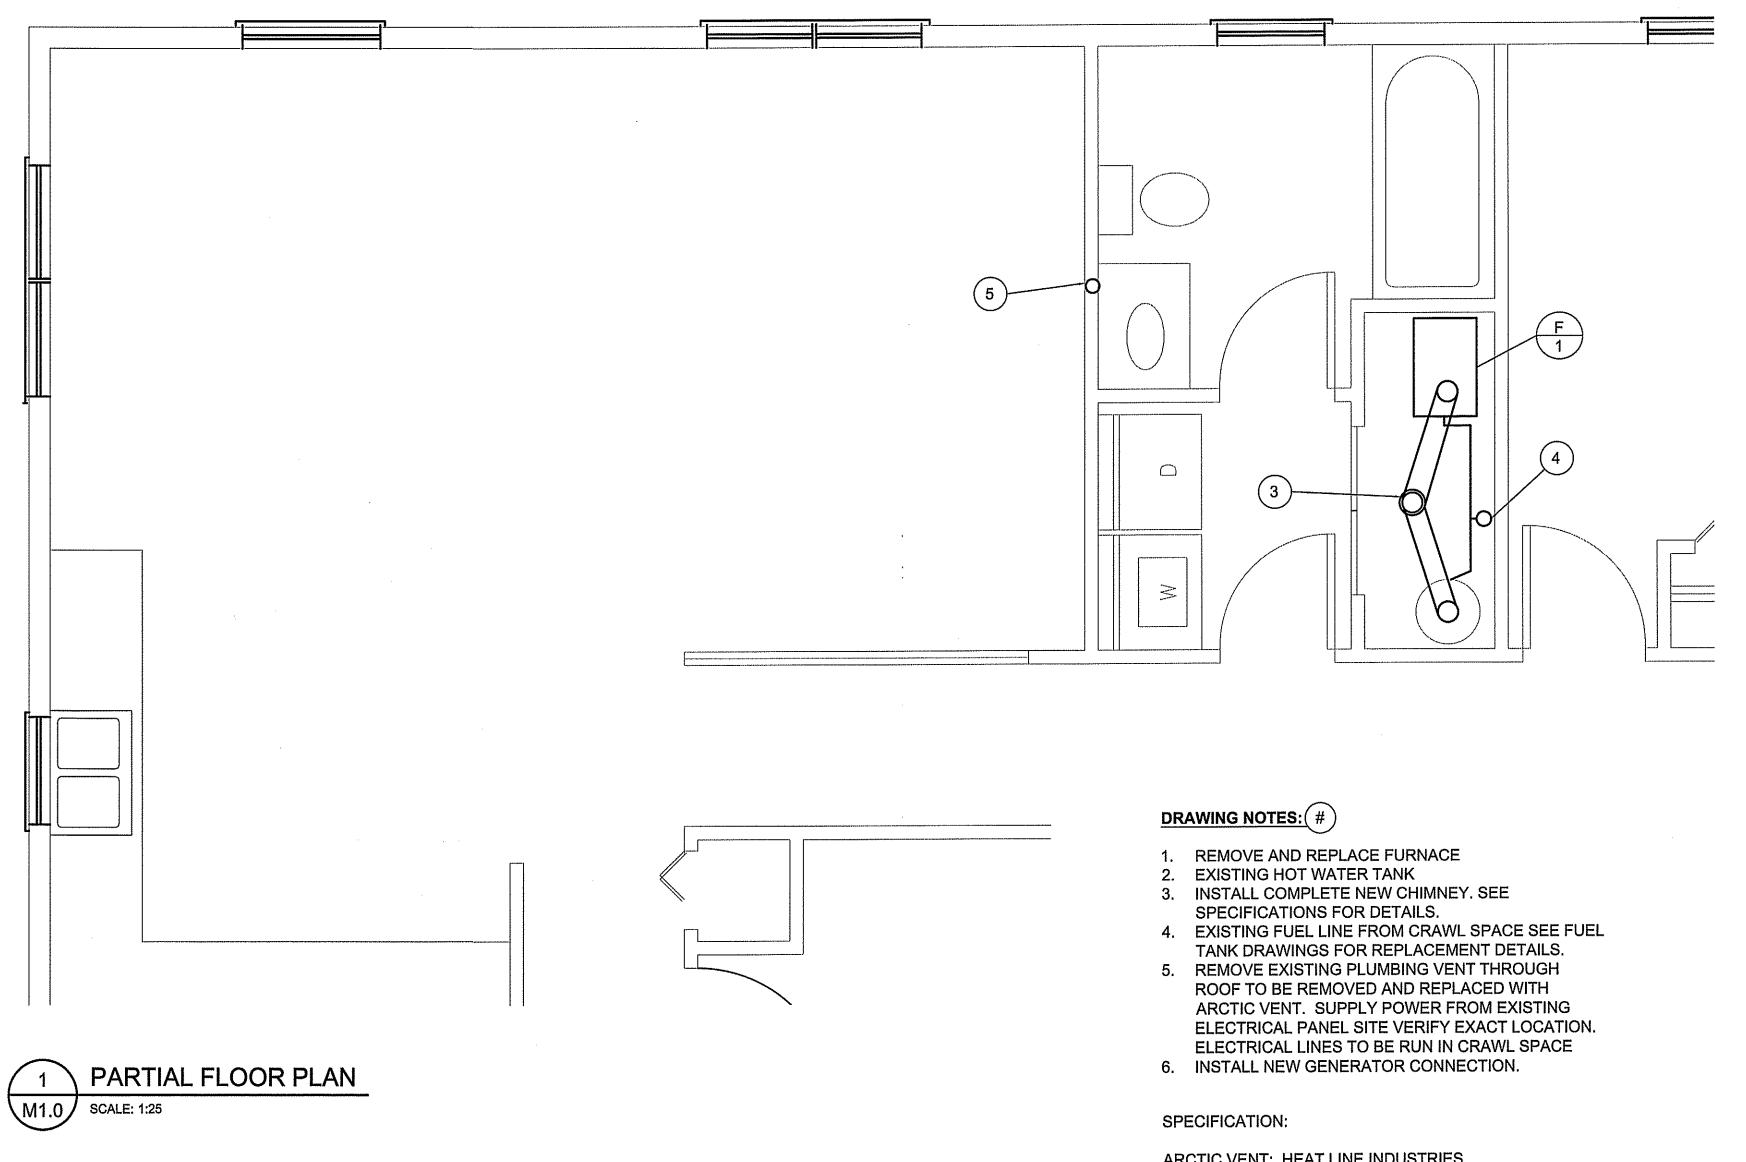


ARCTIC VENT: HEAT LINE INDUSTRIES ELECTRIC - ARCTIC VENT.

THIS DRAWING MUST NOT BE SCALED.

THE GENERAL CONTRACTOR SHALL VERIFY ALL DIMENSIONS, DATUMS AND LEVELS PRIOR TO COMMENCEMENT OF WORK AND IS HELD RESPONSIBLE FOR REPORTING ANY DISCREPANCY OR OMISSION TO CAN-TEC SERVICES LTD. IMMEDIATELY.

THIS DRAWING IS THE EXCLUSIVE PROPERTY OF CAN-TEC SERVICES LTD. AND CAN BE REPRODUCED ONLY WITH THE PERMISSION OF CAN-TEC SERVICES LTD. IN WHICH CASE THE REPRODUCTION MUST BEAR THEIR NAME AS THE ENGINEERING/DRAFTING FIRM.

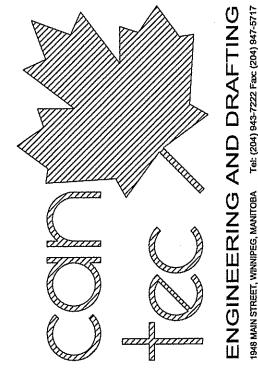


SEALED BY:

INTERIOR AND EXTERIOR RENOVATIONS V002

MECHANICAL

MAIN FLOOR

CONSTRUCTION

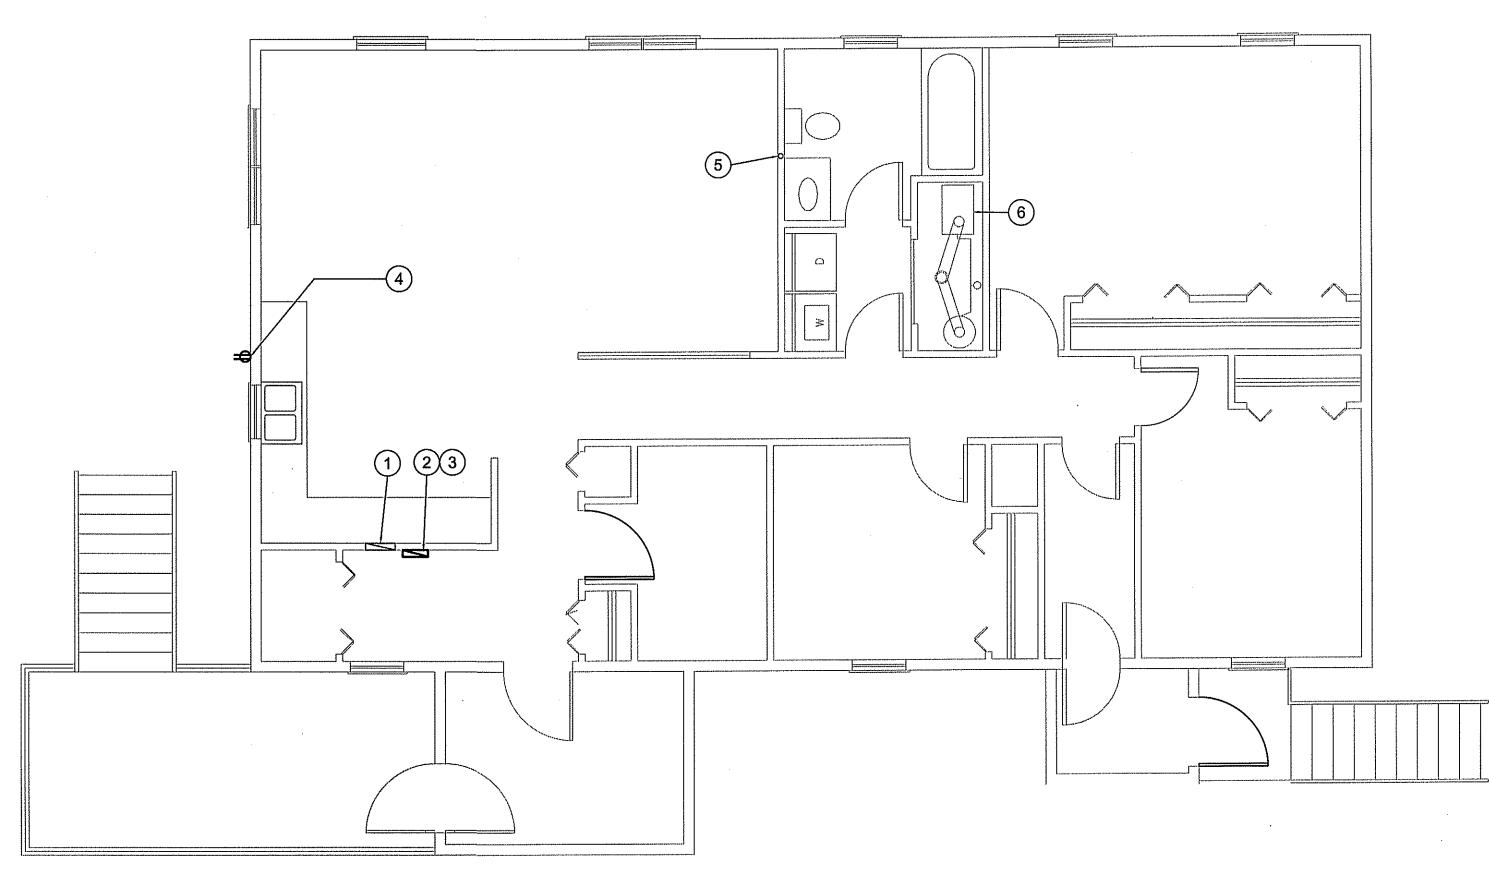



# PARTIAL FLOOR PLAN


SCALE: 1:25

# DRAWING NOTES: (#

- 1. EXISTING ELECTRICAL PANEL
- NEW ESSENTIAL PANEL
- **NEW TRANSFER SWITCH**
- 4. NEW GENERATOR CONNECTION
- 5. NEW POWER FOR ARCTIC VENT
- 6. DISCONNECT FURNACE AND RECONNECT NEW FURNACE.

### NOTES:

- 1. INSTALL IN ESSENTIAL PANEL, FURNACE, HOT WATER TANK, WATER PUMPS, MICROWAVE, FRIDGE, HEAT TAPE (IF IN BUILDING), COUNTER RECEPTACLES, LIGHTS.
- 2. ADJUST ESSENTIAL PANEL TO ACCOMMODATE GENERATOR ON SITE,
- 3. MODIFY SINGLE LINE DIAGRAM AS REQUIRED TO FIT SITE CONDITIONS.

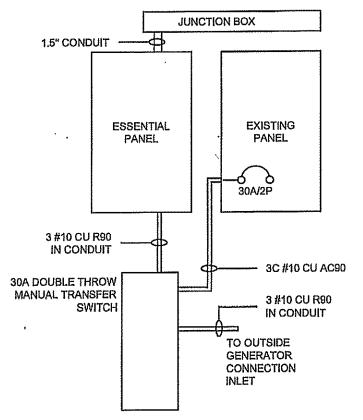

EXISTING PANEL AND REEFED THEM FROM NEW ESSENTIAL PANEL THROUGH JUNCTION BOX.

C. DO NOT GROUND THE CONNECTION FROM GENERATOR.


D. ADJUST LAYOUT OF COMPONENTS AS NECESSARY TO FIT AVAILABLE SPACE.

A. NEW COMPONENTS SURFACE MOUNTED.

B. REMOVE CIRCUITS (SHOWN ON DIRECTORY) FROM

# TYPICAL GENERATOR CONNECTION SCALE: NTS


# SINGLE LINE DIAGRAM

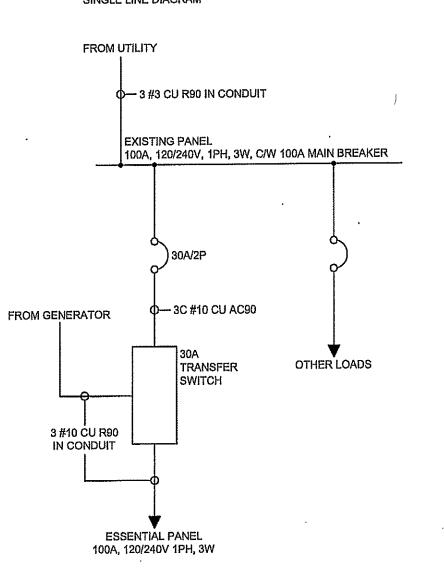

THIS DRAWING MUST NOT BE SCALED.

THE GENERAL CONTRACTOR SHALL VERIFY ALL DIMENSIONS, DATUMS AND LEVELS PRIOR TO COMMENCEMENT OF WORK AND IS HELD RESPONSIBLE FOR REPORTING ANY DISCREPANCY OR OMISSION TO CAN-TEC SERVICES LTD. IMMEDIATELY.

THIS DRAWING IS THE EXCLUSIVE PROPERTY OF CAN-TEC SERVICES LTD. AND CAN BE REPRODUCED ONLY WITH THE PERMISSION OF CAN-TEC SERVICES LTD. IN WHICH CASE THE REPRODUCTION MUST BEAR THEIR NAME AS THE ENGINEERING/DRAFTING FIRM.

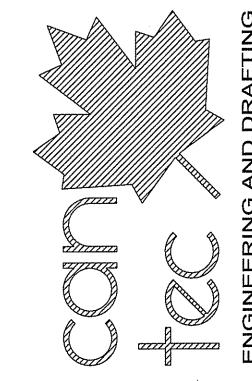

SEALED BY:

**EXTERIOR RENOVATIONS V002** MAIN FLOOR PL **NTERIOR AND** 

15 10 19

CONSTRUCTION

ISSUED FOR CONSTRUCTION 18 03 22

REV.# REVISION

DATE (YY MM DD) REV. BY