

BLOCK LINTEL SCHEDULE		
DESIGNATION	DEPTH (mm)	REINFORCING (TOP AND BOTTOM)
BL10	200	1-15M
BL20	600	2-15M

GENERAL NOTES:  
DO NOT SCALE THIS DRAWING FOR CONSTRUCTION PURPOSES. USE FIGURED DIMENSIONS AS NOTED.  
THESE DRAWINGS ARE TO BE READ IN CONJUNCTION WITH SPECIFICATIONS AND GENERAL CONTRACTUAL CONDITIONS.  
ALL DIMENSIONS AND CONDITIONS ARE TO BE VERIFIED ON SITE. ALL DISCREPANCIES ARE TO BE REPORTED TO THE DEPARTMENTAL REPRESENTATIVE AND AGREED UPON WITH THEM IN WRITING BEFORE PROCEEDING WITH WORKS.  
INFORMATION ON THESE DRAWINGS IS TO BE USED FOR THIS PROJECT ONLY AND SHALL NOT BE USED FOR ANY OTHER PURPOSE.




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revisions		date

project **CANADIAN COAST GUARD COLLEGE SYDNEY, NS SEAWATER SYSTEM & PUMPHOUSE CONSTRUCTION**

drawing **STRUCTURAL SEAWATER PUMPHOUSE PLANS AND SECTIONS**

designed M.F.	conçu
date 06/29/18	
drawn STAFF	dessiné
date 06/29/18	
approved M.C.	approuvé
date 06/29/18	
Tender	Submission
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project number <b>R.065476.711</b>	no. du projet
drawing no. <b>12-S-100</b>	no. du dessin

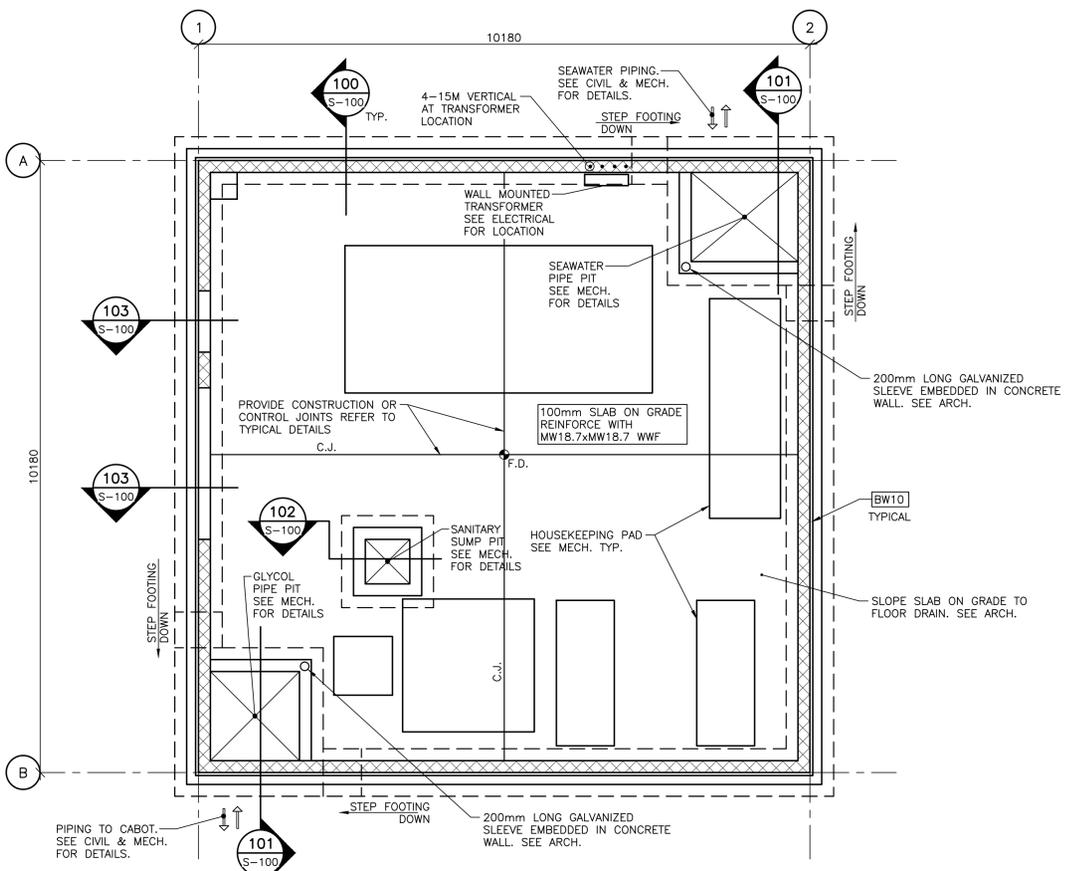


**FOUNDATION PLAN**

SCALE: 1:50



**BW10**: 200mm CONCRETE BLOCK WALL GROUT ALL CORES SOLID (12.5 MPa MIN.) REINFORCE WITH 1-15M VERTICAL ON EACH SIDE OF OPENING. 15M AT 800 c/c VERTICAL. HEAVY DUTY TRUSS-STYLE HORIZONTAL MASONRY REINFORCEMENT AT 400 c/c. VERTICAL REINFORCING TO BE CONTINUOUS THROUGH BLOCK LINTEL. PROVIDE CONTINUOUS HORIZONTAL BOND BEAM AT TOP OF WALL c/w 2-15M BARS.

F.D.: DENOTES FLOOR DRAIN


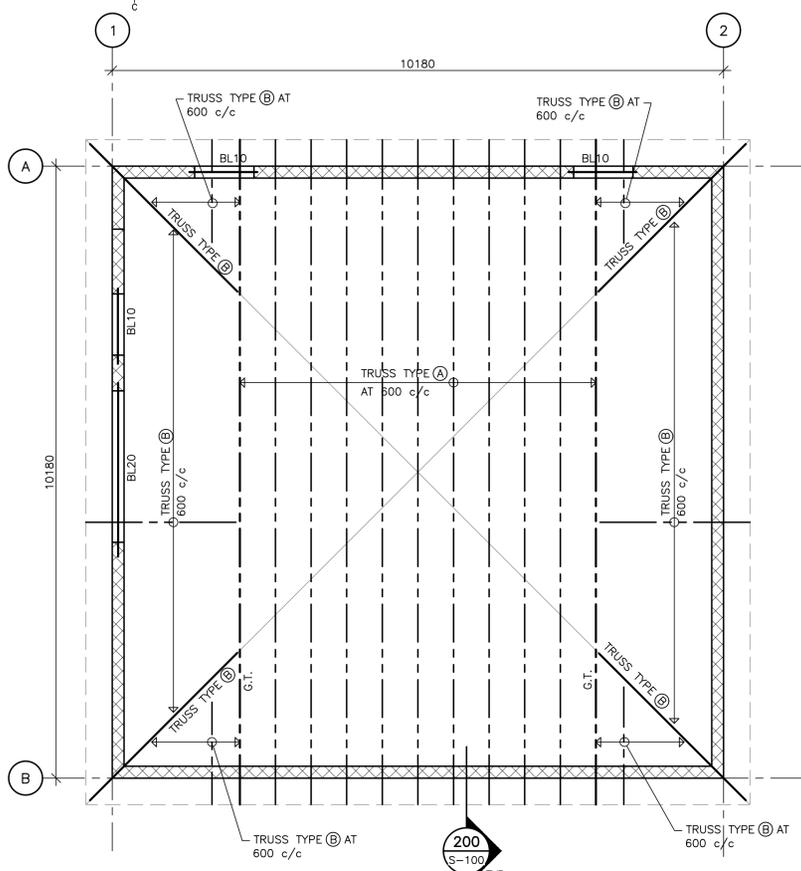


**ROOF FRAMING PLAN**

SCALE: 1:50





G.T.: DENOTES GIRDER TRUSS  
ROOF LOADS: DL = 1.0 kPa  
SL = 3.2 kPa

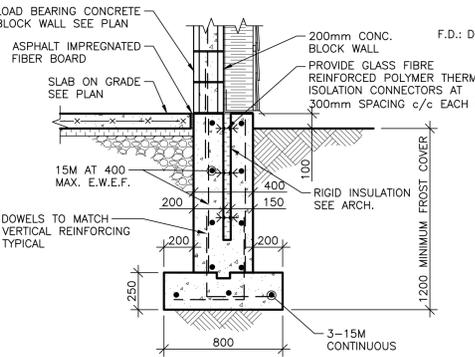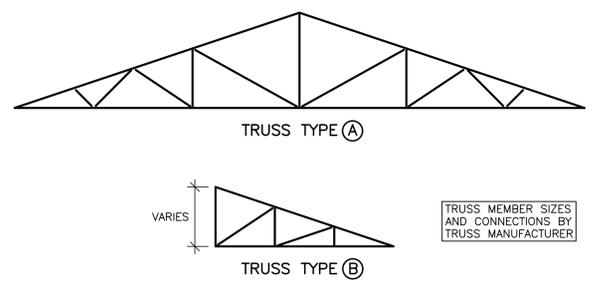


**SECTION 100**

SCALE: 1:20

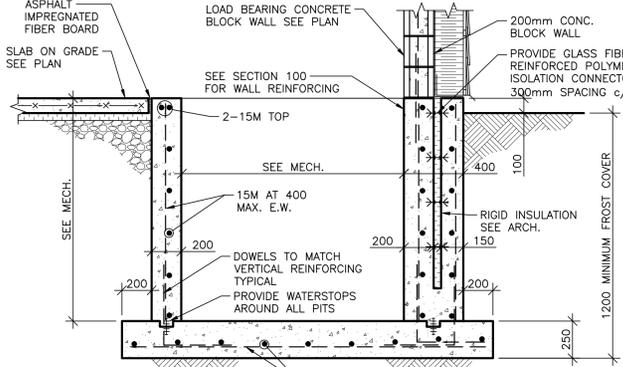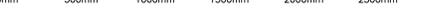


**SECTION 101**

SCALE: 1:20

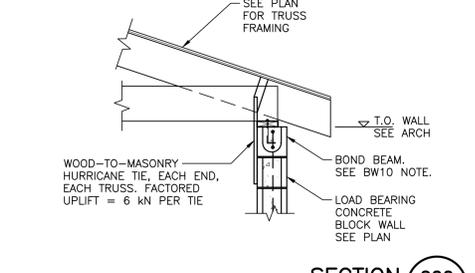



**SECTION 200**

SCALE: 1:20

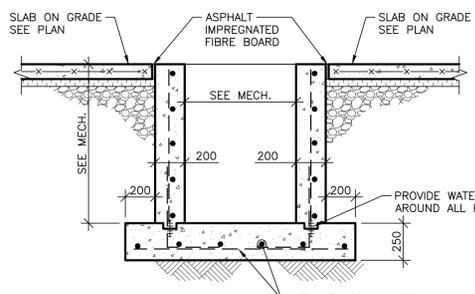

**SECTION 102**

SCALE: 1:20

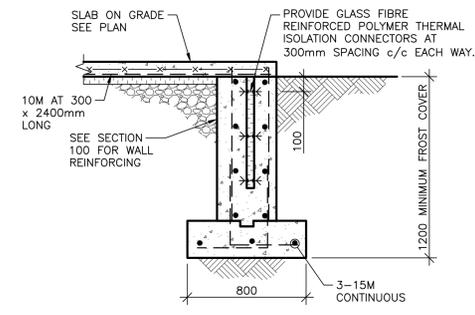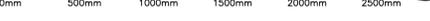

**SECTION 103**

SCALE: 1:20



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