

SHEET LIST	
SHEET #	SHEET NAME
L1	EXISTING CONDITIONS AND REMOVALS PLAN
L2	LAYOUT, GRADING AND ELECTRICAL SITE PLAN
L3	SITE DETAILS
L4	PLANTING PLAN
A1	REFERENCE SHEET
A2	LIFE SAFETY PLAN & NBC MATRIX
A3	FLOOR PLAN
A5	REFLECTED CEILING PLAN & ROOM FINISH SCHEDULE
A6	BUILDING ELEVATIONS
A7	BUILDING ISOMETRICS
A8	BUILDING SECTIONS
A9	SECTION DETAILS
A10	SECTION DETAILS
A11	PLAN DETAILS
A12	INTERIOR ELEVATIONS & MILLWORK DETAILS
A13	DOOR & WINDOW SCHEDULE
S1	STRUCTURAL - GENERAL NOTES AND DESIGN NOTES
S2	STRUCTURAL - FOUNDATION PLANS & DETAILS
S3	STRUCTURAL - SLAB ON GRADE PLANS & DETAILS
S4	STRUCTURAL - LINTEL & ROOF FRAMING PLANS
S5	STRUCTURAL - TIMBER FRAME CANOPY LAYOUT AND DETAILS
M1	MECHANICAL - LEGEND, GENERAL NOTES, SCHEMATICS AND SCHEDULES
M2	MECHANICAL - PLUMBING & DRAINAGE AND HVAC PLANS
E1	ELECTRICAL LEGEND AND GENERAL NOTES
E2	ELECTRICAL POWER AND LIGHTING PLAN
E3	ELECTRICAL DETAILS & SCHEDULES

60576731





Canada




# CYPRUS LAKE - HEAD OF TRAILS RENEWAL

CYPRUS LAKE ROAD, BRUCE PENINSULA  
NATIONAL PARK, TOBERMORY, ONTARIO CANADA

ISSUED FOR TENDER 2018-08-16

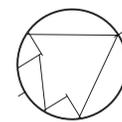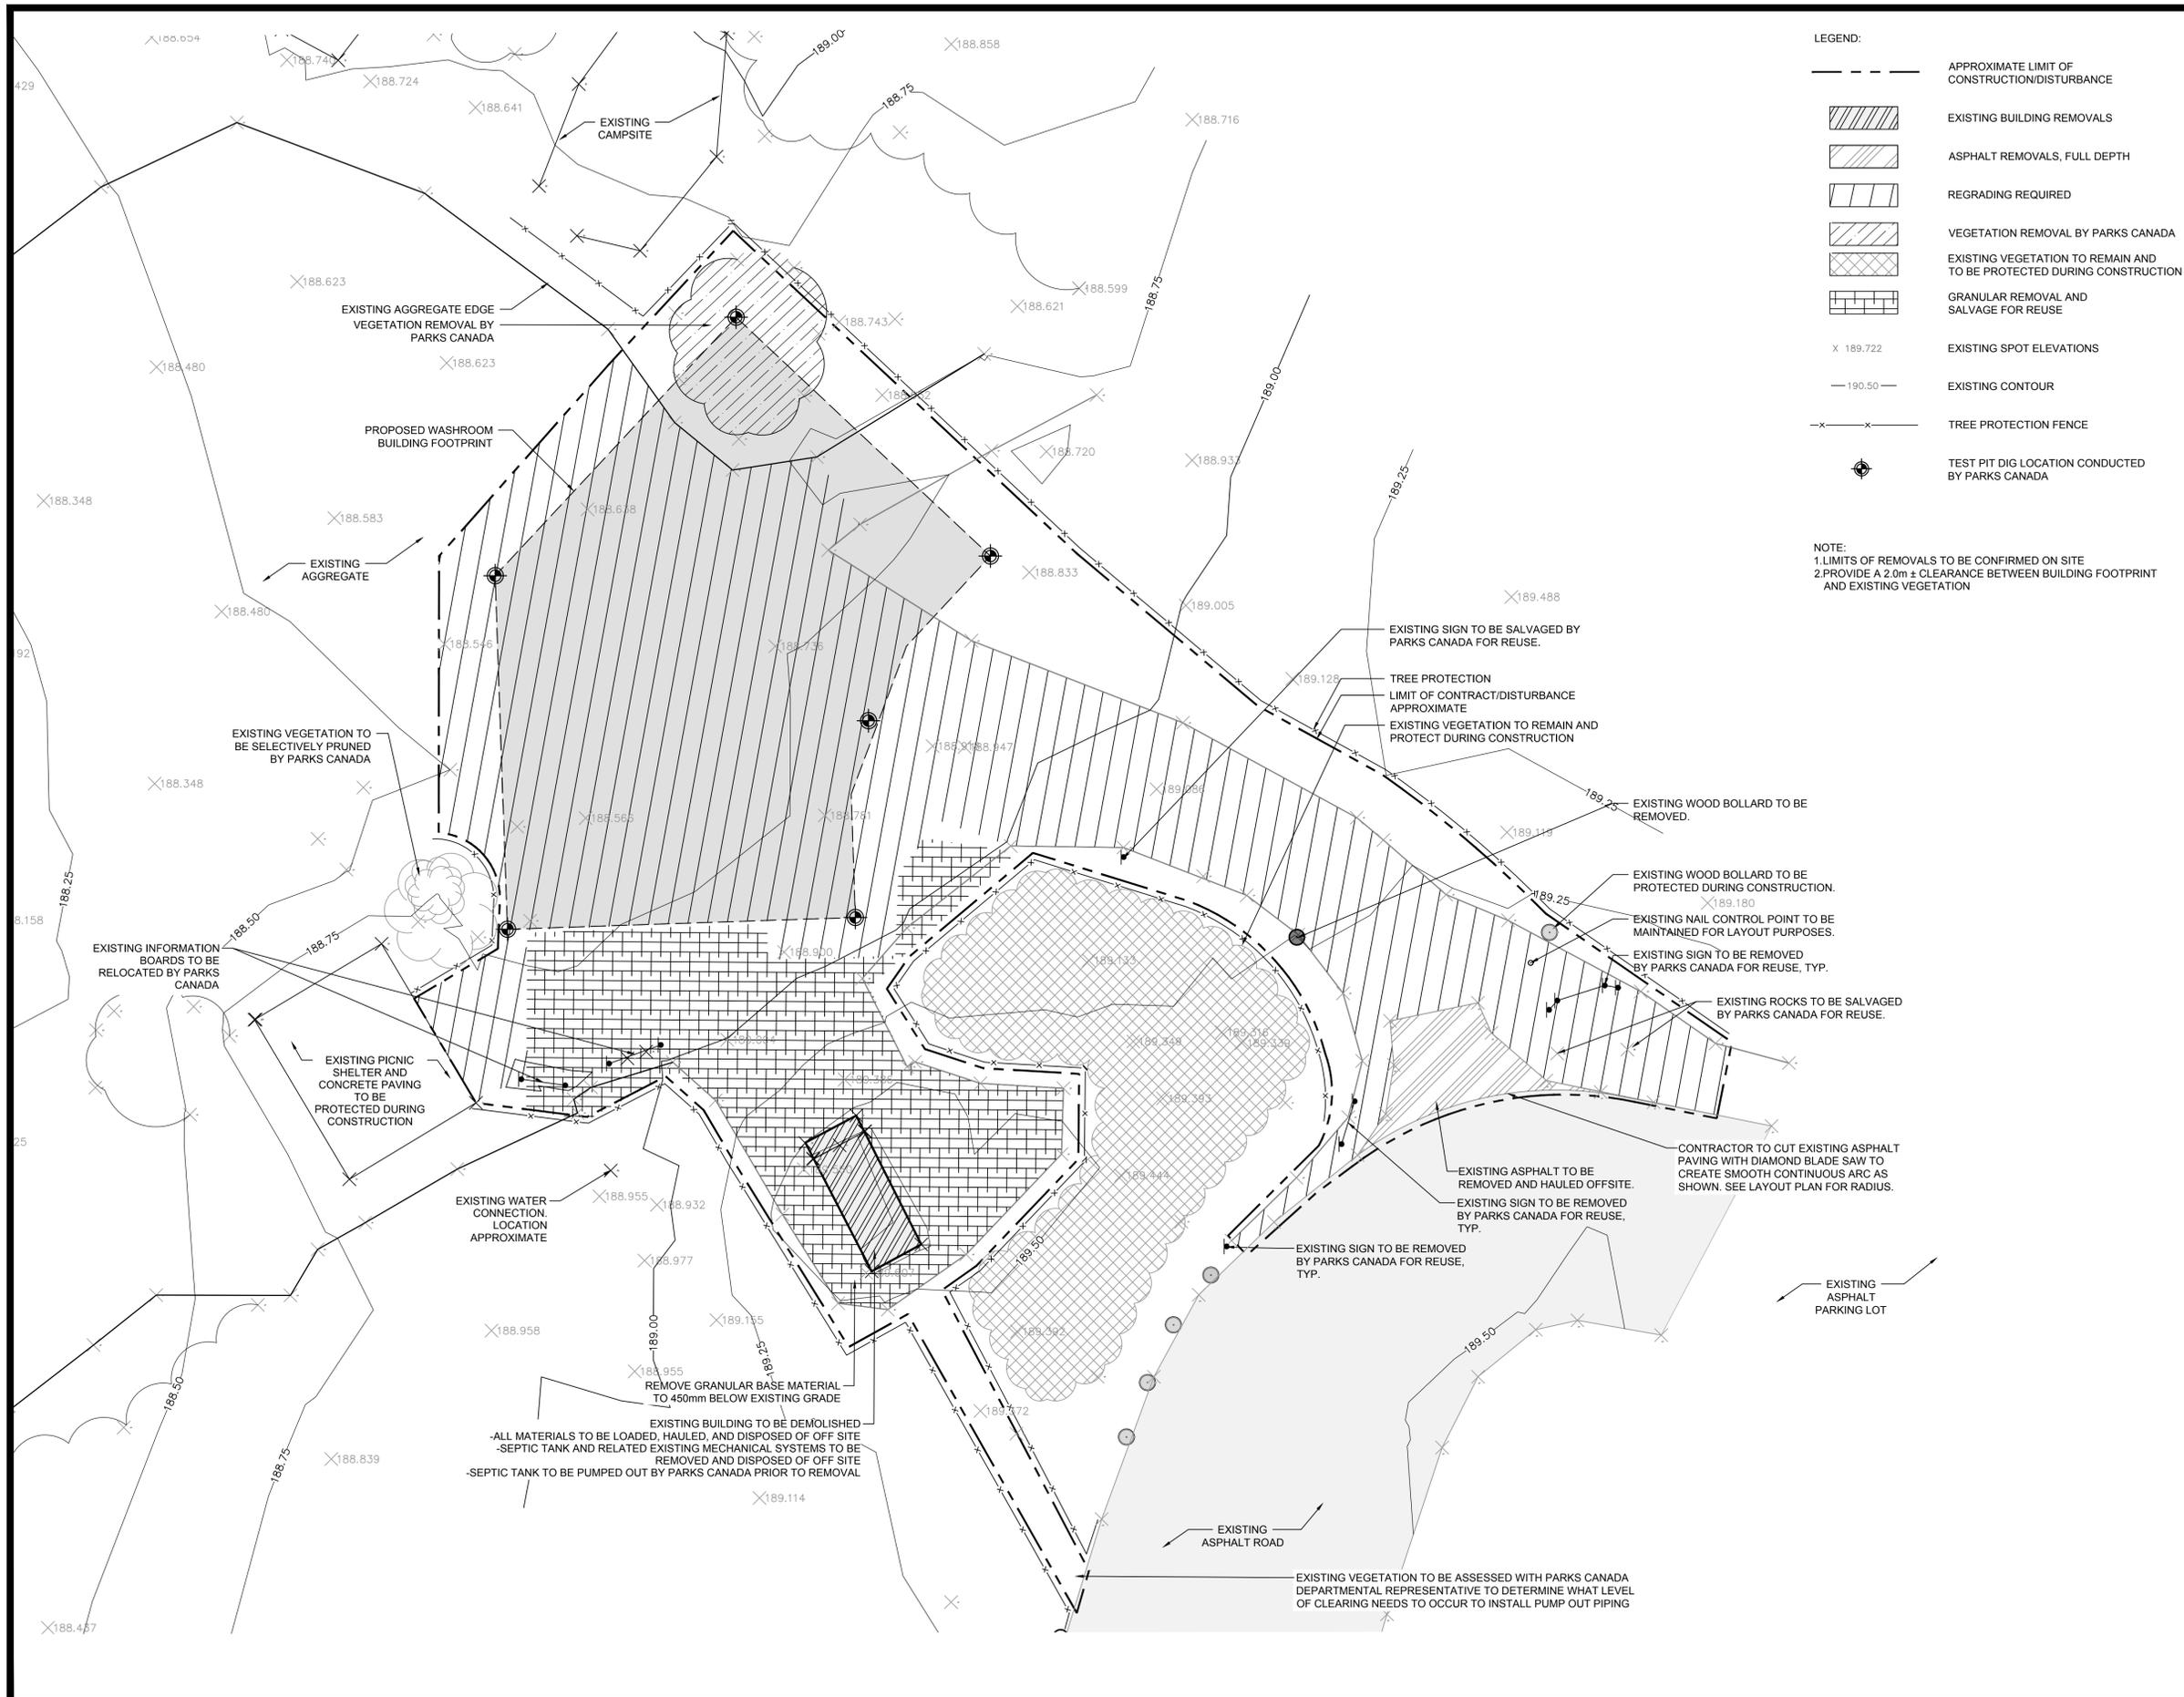


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NO.	DATE	DESCRIPTION	Drawn by / Approved / Dessiné par / Approuvé
REVISIONS			
⊕	A	Detail number	A Numero de detail
⊖	B	Sheet number	B Sur feuille numero
Linear dimensions in millimeters		Dimensions lineaires en millimetres	
<b>Canada</b>			
PARKS CANADA EASTERN ONTARIO FIELD UNIT			
Type of Record / Type d'enregistrement			
Project title / Titre du projet <b>BRUCE PENINSULA NATIONAL PARK HEAD OF TRAILS</b>			
Drawing title / Titre du dessin <b>EXISTING CONDITIONS AND REMOVALS PLAN</b>			
Plot Scale / Echelle 1:100 (Arch D 24x36 Plot Size)			
Drawn by / Dessiné par	PF	Date	2018-06-01
Field Recording by / Releve-Temoin par		Date	
Approved by / Approuvé par	RB	Date	2018-06-01
Checked by / Verifié par	RB	Date	2018-06-01
Project No./ No. du projet	Asset No.	Sheet No./ Feuille No.	
60576731		<b>L1</b>	
Drawing Re No./No. du Dessin			

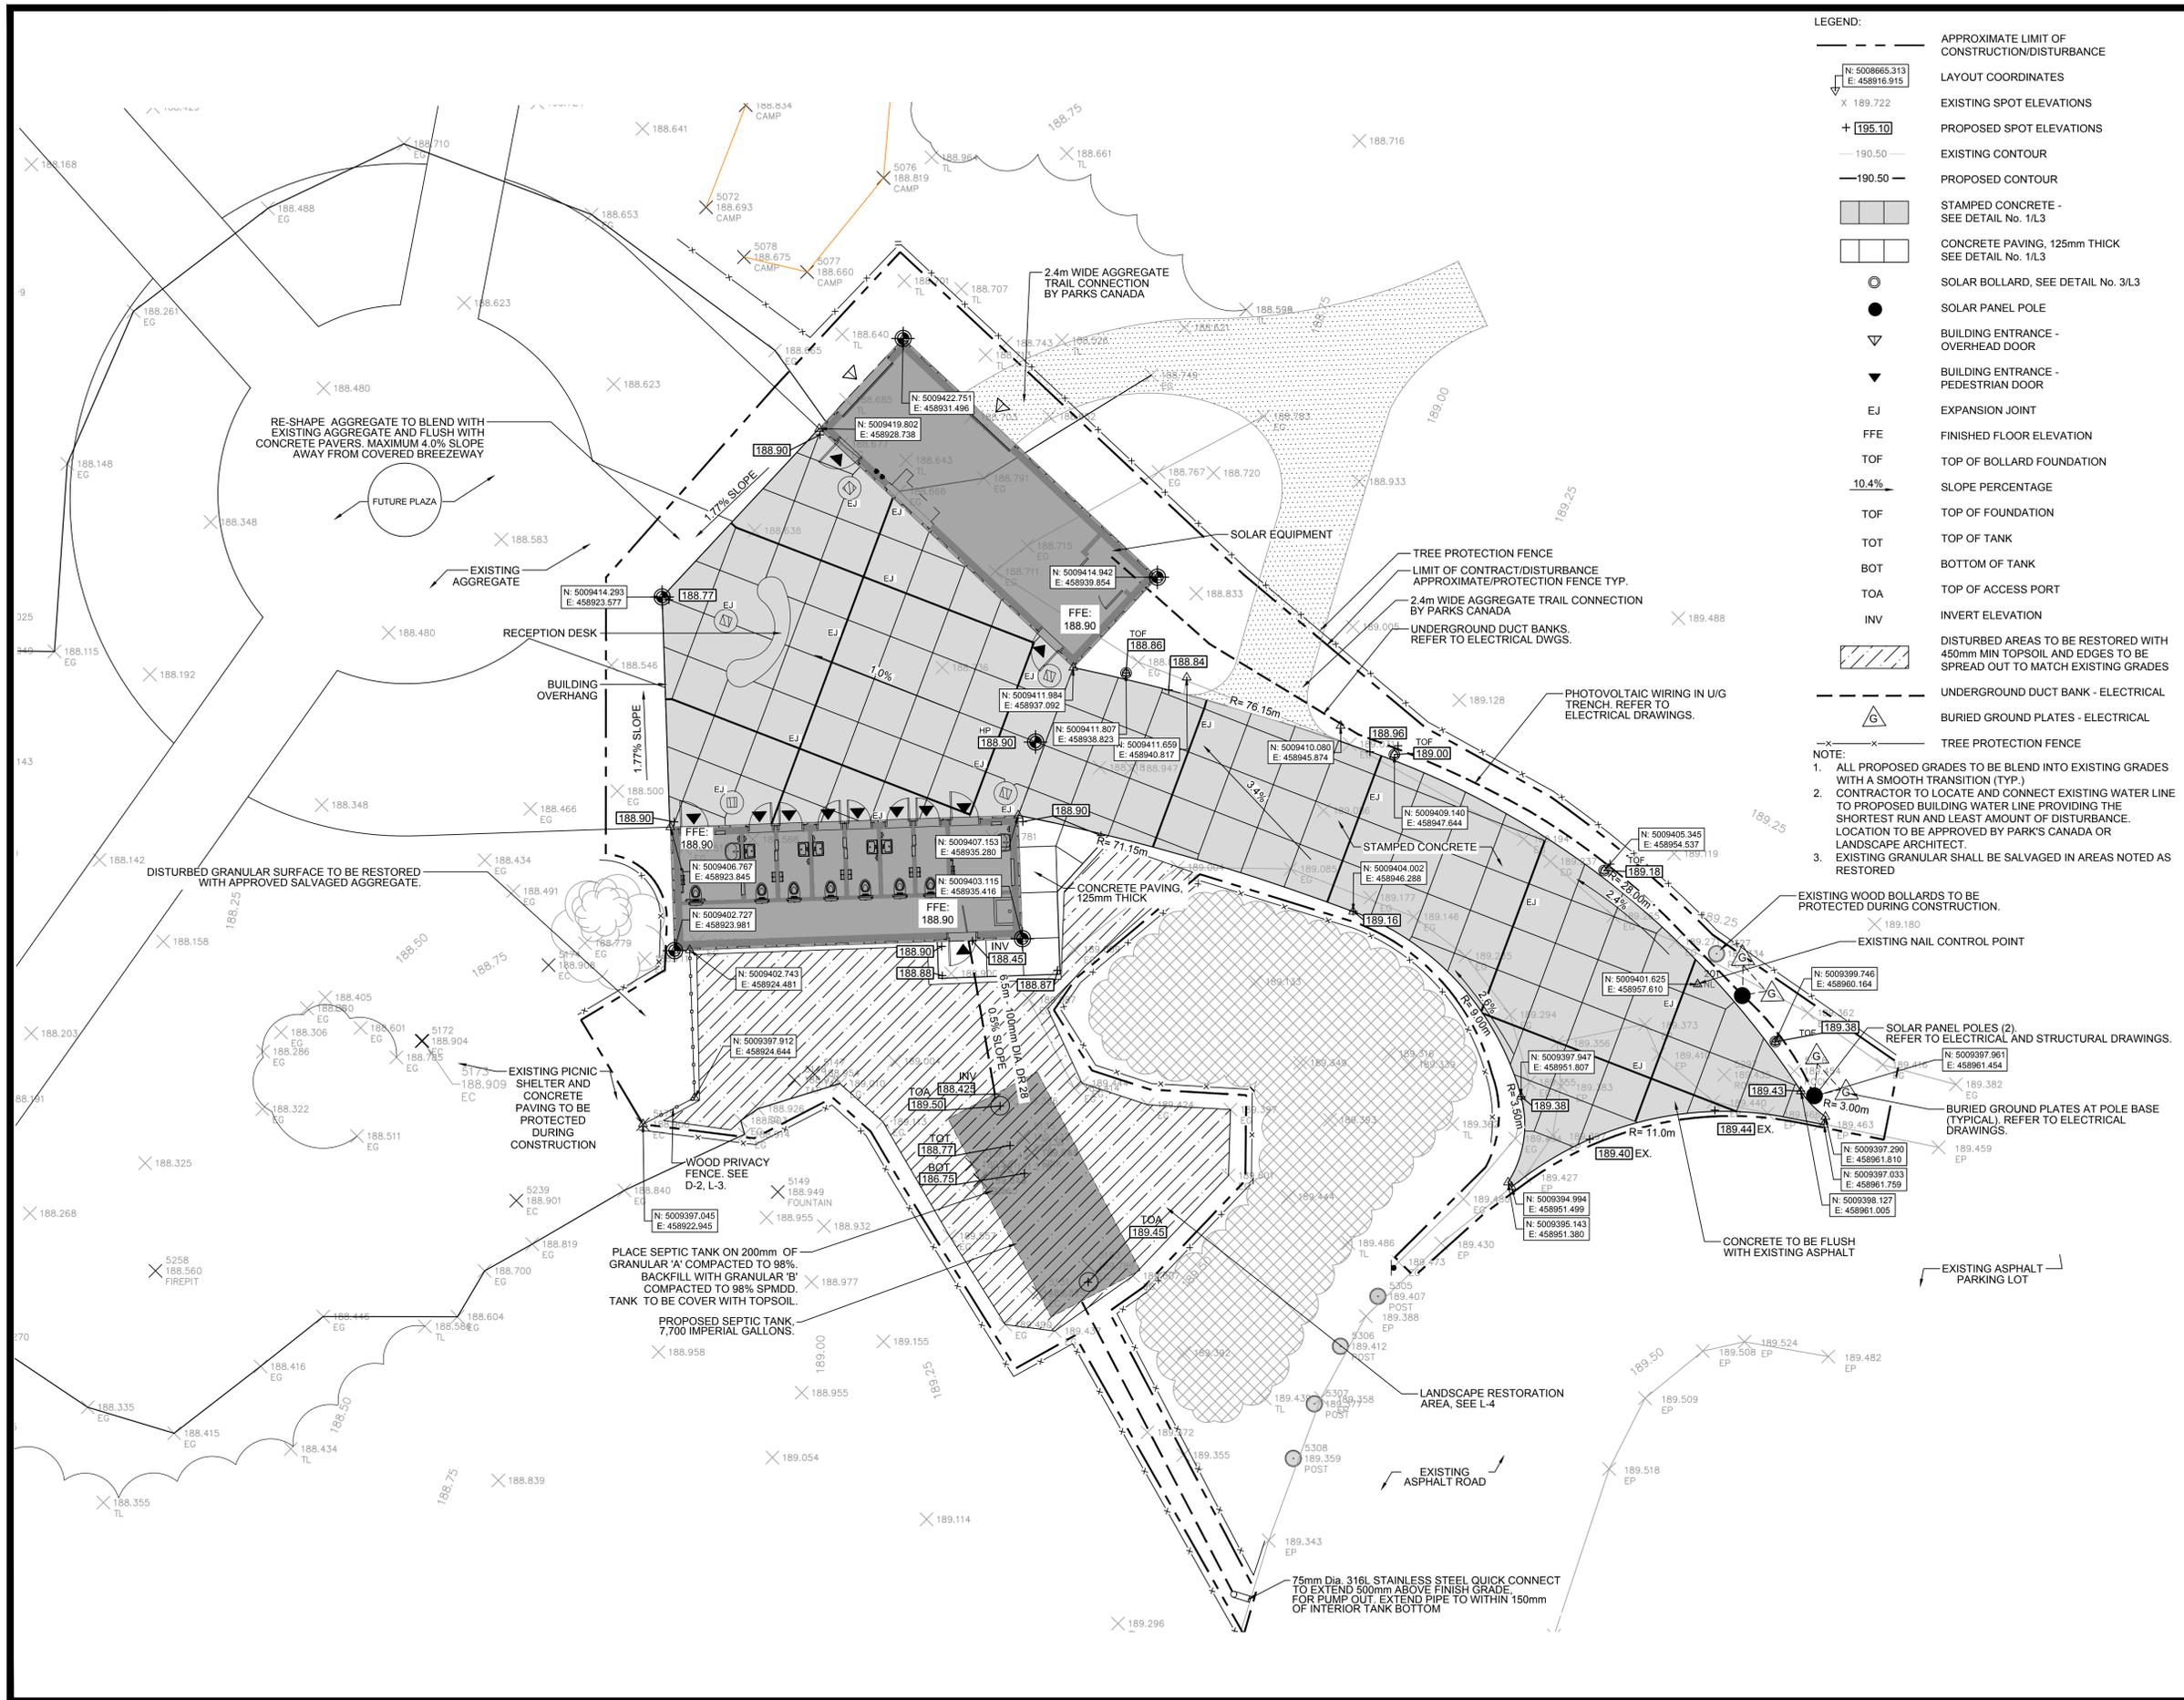


- LEGEND:**
- APPROXIMATE LIMIT OF CONSTRUCTION/DISTURBANCE
  - ⌄ N: 5008665.313  
E: 458916.915  
X 189.722 EXISTING SPOT ELEVATIONS
  - + 195.10 PROPOSED SPOT ELEVATIONS
  - 190.50 EXISTING CONTOUR
  - 190.50 PROPOSED CONTOUR
  - ▨ STAMPED CONCRETE - SEE DETAIL No. 1/L3
  - ▨ CONCRETE PAVING, 125mm THICK SEE DETAIL No. 1/L3
  - ⊙ SOLAR BOLLARD, SEE DETAIL No. 3/L3
  - SOLAR PANEL POLE
  - ▽ BUILDING ENTRANCE - OVERHEAD DOOR
  - ▼ BUILDING ENTRANCE - PEDESTRIAN DOOR
  - EJ EXPANSION JOINT
  - FFE FINISHED FLOOR ELEVATION
  - TOF TOP OF BOLLARD FOUNDATION
  - 10.4% SLOPE PERCENTAGE
  - TOF TOP OF FOUNDATION
  - TOT TOP OF TANK
  - BOT BOTTOM OF TANK
  - TOA TOP OF ACCESS PORT
  - INV INVERT ELEVATION
  - ▨ DISTURBED AREAS TO BE RESTORED WITH 450mm MIN TOPSOIL AND EDGES TO BE SPREAD OUT TO MATCH EXISTING GRADES
  - UNDERGROUND DUCT BANK - ELECTRICAL
  - △ BURIED GROUND PLATES - ELECTRICAL
  - TREE PROTECTION FENCE

**NOTE:**

- ALL PROPOSED GRADES TO BE BLEND INTO EXISTING GRADES WITH A SMOOTH TRANSITION (TYP.)
- CONTRACTOR TO LOCATE AND CONNECT EXISTING WATER LINE TO PROPOSED BUILDING WATER LINE PROVIDING THE SHORTEST RUN AND LEAST AMOUNT OF DISTURBANCE. LOCATION TO BE APPROVED BY PARK'S CANADA OR LANDSCAPE ARCHITECT.
- EXISTING GRANULAR SHALL BE SALVAGED IN AREAS NOTED AS RESTORED

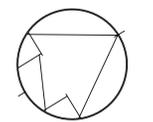


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REFERENCE DRAWINGS			
REVISIONS			
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NO.	DATE	DESCRIPTION	Drawn by Dessiné par
Approved Approuvé			
REVISIONS			
⊙	A Detail number	A Numero de detail	
⊙	B Sheet number	B Sur feuille numero	
Linear dimensions in millimeters		Dimensions lineaires en millimetres	
			
<h1>Canada</h1>			
PARKS CANADA EASTERN ONTARIO FIELD UNIT			
Type of Record / Type d'enregistrement			
Project title / Titre du projet <h2>BRUCE PENINSULA NATIONAL PARK HEAD OF TRAILS</h2>			
Drawing title / Titre du dessin <h3>LAYOUT, GRADING AND ELECTRICAL SITE PLAN</h3>			
Plot Scale / Echelle 1:100 (Arch D 24x36 Plot Size)			
Drawn by / Dessiné par	PF	Date	2018-06-01
Field Recording by / Releve-Temoin par		Date	
Approved by / Approuvé par	RB	Date	2018-06-01
Checked by / Verifié par	RB	Date	2018-06-01
Project No./ No. du projet	Asset No.	Sheet No./ Feuille No.	
60576731		L2	
Drawing Re No./No. du Dessin			

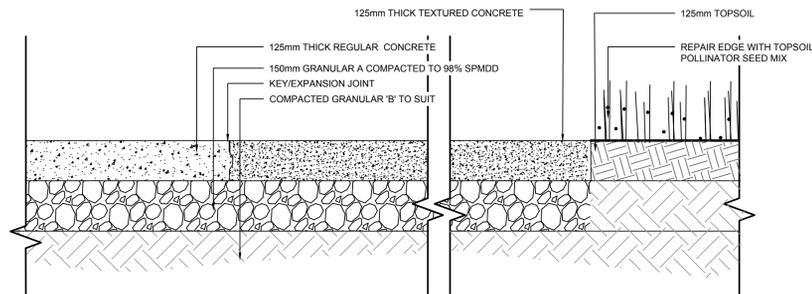


DETAIL STAMPED/REGULAR 125mm THICK CONCRETE

NTS

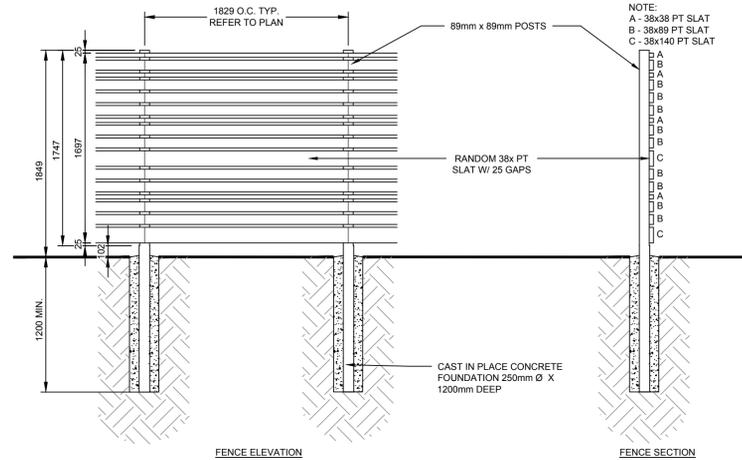


DETAIL WOOD FENCE SCREEN AT AMENITY AREA

NTS

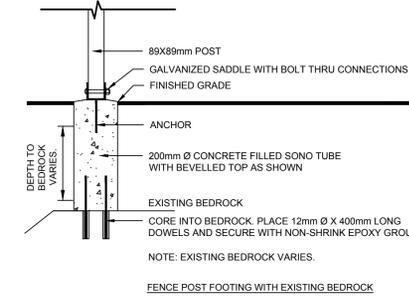


2

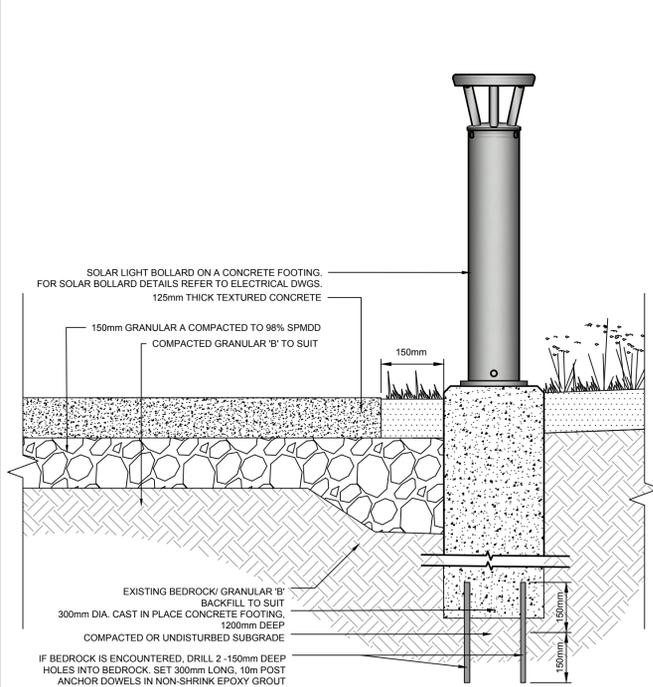

DETAIL SOLAR LIGHT BOLLARD DETAIL

SCALE 1:10

3

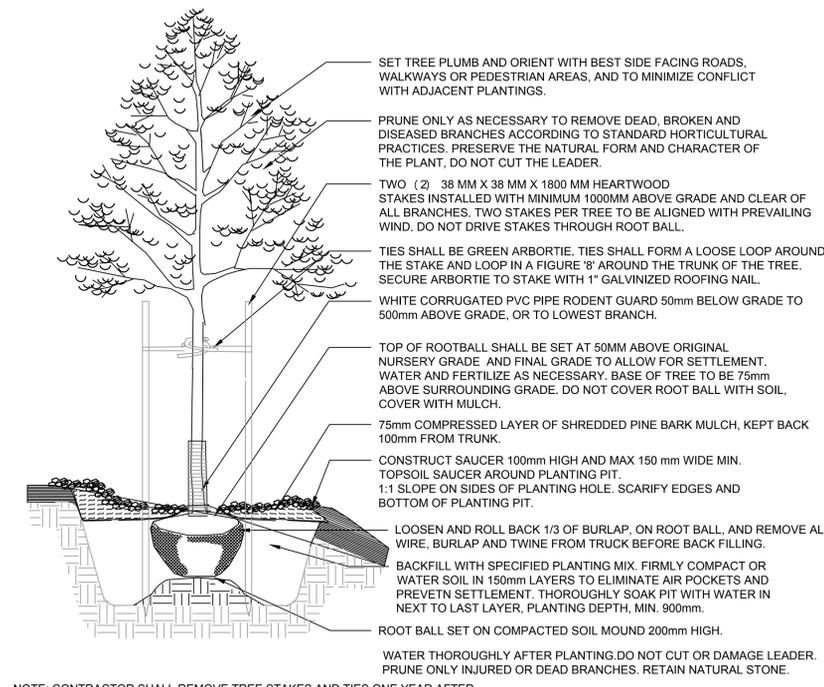


NOTE: CONTRACTOR SHALL REMOVE TREE STAKES AND TIES ONE YEAR AFTER PLANTING, OR AT THE END OF THE WARRANTY PERIOD IF STAKES ARE STILL REQUIRED.

DETAIL DECIDUOUS TREE PLANTING

N.T.S.


4

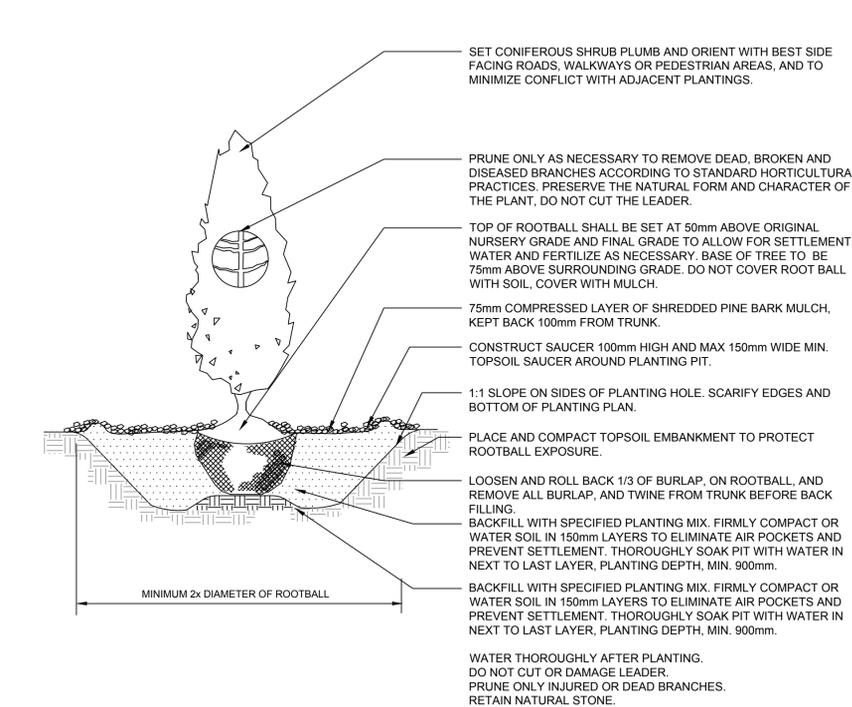

DETAIL CONIFEROUS SHRUB PLANTING

N.T.S.



5

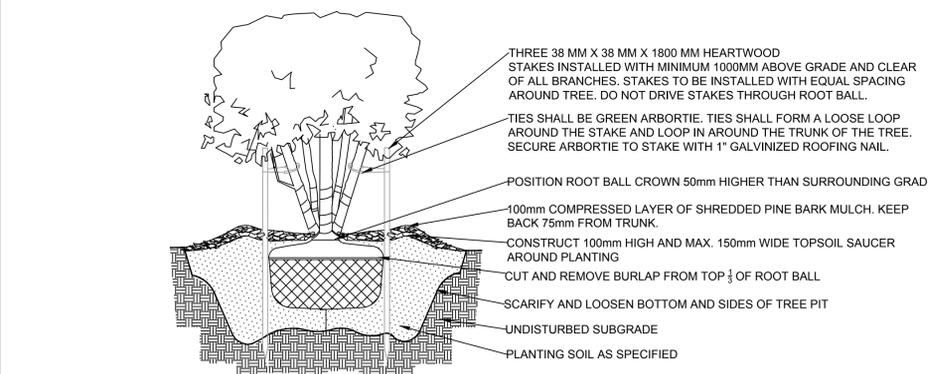

DETAIL MULTI-STEM DECIDUOUS SHRUB PLANTING

SCALE 1:10

6

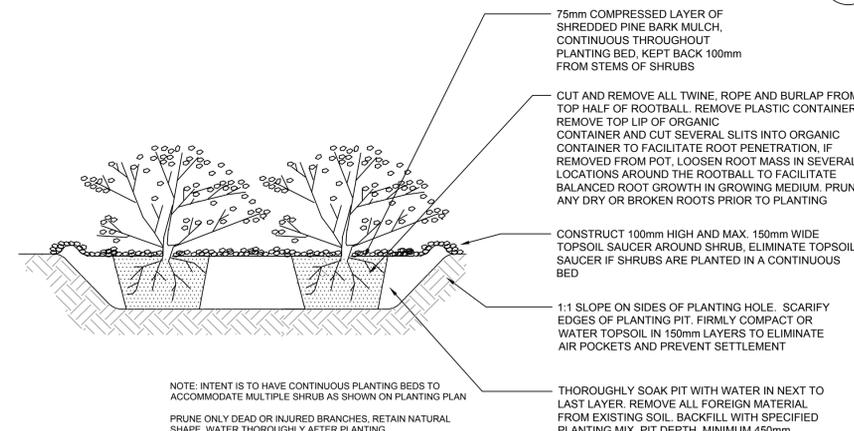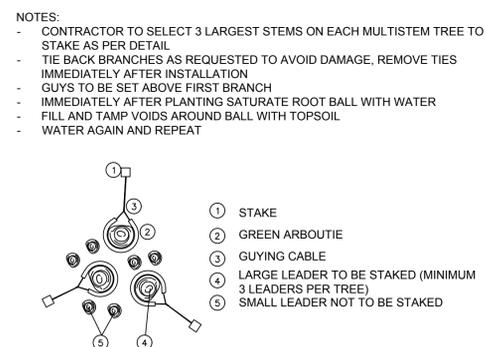

DETAIL DECIDUOUS SHRUB PLANTING

SCALE 1:10

7

DRAWING NO. DRAWING NAME

REFERENCE DRAWINGS

1	2018-08-16	ISSUED FOR TENDER	PF/AH	RB
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NO.	DATE	DESCRIPTION	Drawn by	Approved
			Dessine par	Approuve

REVISIONS

A	A Detail number	A Numero de detail
B	B Sheet number	B Sur feuille numero

Linear dimensions in millimeters Dimensions lineaires en millimetres



Canadä

PARKS CANADA EASTERN ONTARIO FIELD UNIT

Type of Record / Type d'enregistrement

Project title / Titre du projet

BRUCE PENINSULA NATIONAL PARK HEAD OF TRAILS

Drawing title / Titre du dessin

SITE DETAILS

Plot Scale / Echelle

AS NOTED (Arch D 24x36 Plot Size)

Drawn by/ Dessine par Date

Field Recording by / Releve-Temoin par Date

Approved by / Approuve par Date

Checked by/ Verifie par Date


Project No./ No. du projet Asset No. Sheet No./ Feuille No.

60576731

Drawing Re No./No. du Dessin L3



- LEGEND:**
- APPROXIMATE LIMIT OF CONSTRUCTION/DISTURBANCE
  - 190.50- EXISTING CONTOUR
  - 190.50- PROPOSED CONTOUR
  - [Grid Pattern] STAMPED CONCRETE - SEE DETAIL No. 1/L3
  - [Diagonal Lines] CONCRETE PAVING, 125mm THICK SEE DETAIL No. 1/L3
  - SOLAR BOLLARD, SEE DETAIL No. 3/L3
  - SOLAR PANEL POLE
  - ▽ BUILDING ENTRANCE - OVERHEAD DOOR
  - ▼ BUILDING ENTRANCE - PEDESTRIAN DOOR
  - [Hatched Area] DISTURBED AREAS TO BE RESTORED WITH 450mm TOPSOIL AND EDGES TO BE SPREAD OUT TO MATCH EXISTING GRADES
  - UNDERGROUND DUCT BANK - ELECTRICAL
  - x-x- TREE PROTECTION FENCE
  - [Tree Symbol] PROPOSED CONIFEROUS PLANTING
  - [Tree Symbol] PROPOSED DECIDUOUS PLANTING

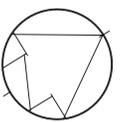

DRAWING NO.		DRAWING NAME	
REFERENCE DRAWINGS			
1	2018-08-16	ISSUED FOR TENDER	PF/AH RB
NO.	DATE	DESCRIPTION	Drawn by / Approved Dessiné par / Approuvé
REVISIONS			
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B	B Sheet number	B Sur feuille numero	
Linear dimensions in millimeters		Dimensions lineaires en millimetres	
 Parcs Canada		 Parks Canada	
<h1 style="margin: 0;">Canada</h1>			
PARKS CANADA EASTERN ONTARIO FIELD UNIT			
Type of Record / Type d'enregistrement			
Project title / Titre du projet			
<h2 style="margin: 0;">BRUCE PENINSULA NATIONAL PARK HEAD OF TRAILS</h2>			
Drawing title / Titre du dessin			
<h3 style="margin: 0;">PLANTING PLAN</h3>			
Plot Scale / Echelle			
1:100 (Arch D 24x36 Plot Size)			
Drawn by/ Dessine par		Date	
PF		2018-06-01	
Field Recording by / Releve-Temoin par		Date	
RB		2018-06-01	
Approved by / Approuve par		Date	
RB		2018-06-01	
Checked by/ Verifie par		Date	
RB		2018-06-01	
Project No./ No. du projet	Asset No.	Sheet No./ Feuille No.	
60576731		L4	
Drawing Re No./No. du Dessin			

SOURCE OF PLANT MATERIALS TO BE PROVIDED BY CONTRACTOR  
 WB - WIRE BASKET  
 3 GAL - THREE GALLON POT  
 B&B - BALLED AND BURLAP

**ABBREVIATIONS**

<b>A</b>	AT A.I.F.B. A.F.F. A.C.T. ALUM. APPROX. A.C.W.F.D.	ASPHALT IMPREGNATED FIBREBOARD ABOVE FINISHED FLOOR ACOUSTIC TILE CEILING ALUMINIUM APPROXIMATE ACOUSTIC CORE WOOD FLUSH DOOR	<b>B</b>	BLOCKING BD. BOTT. B.E.W. B.L.L. BTN. B.U.L. BLDG. BU BP	BLOCKING BOARD BOTTOM BOTTOM EACH WAY BOTTOM LOWER LAYER BETWEEN BOTTOM UPPER LAYER BUILDING STEEL BUILT-UP (TO OWSJ) BASE PLATE	<b>C</b>	CB. c/c CLC. COL. c/w CONC. CONST. CONT. CO-ORD C.J. CRS.	CATCH BASIN CENTRE TO CENTRE CLOSET COLUMN COMPLETE WITH CONCRETE CONSTRUCTION CONTINUOUS COORDINATE CONTROL JOINT COURSE	<b>D</b>	DIA. DIM. DCBHM DN DWG. DF	DIAMETER DIMENSION DOUBLE CATCH BASIN MANHOLE DOWN DRAWING DRINKING FOUNTAIN	<b>E</b>	EA. E.F. E.W. ELEC. ELEV. ED. EQUIP. EX. EXT.	EACH EACH FACE EACH WAY ELECTRICAL ELEVATION EQUIPMENT EXISTING EXTERIOR	<b>F</b>	FIN. F.E. F.R.R. F.S. FLR. F.D. FND.	FINISH/FINISHED FIRE EXTINGUISHER FIRE-RESISTANCE RATING FIRE SEPARATION FLOOR FLOOR DRAIN FOUNDATION	<b>G</b>	G1S G2S GALV. GRAN. GYP. GWB	GOOD ONE SIDE GOOD TWO SIDES GALVANIZED GRANULAR GYPSUM GYPSUM WALL BOARD	<b>H</b>	H.D. H.M.D. HORIZ. H.E.F. H.I.F. H.O.F. HR. HSS	HEAVY DUTY HOLLOW METAL DOOR HORIZONTAL HORIZONTAL EACH FACE HORIZONTAL INSIDE FACE HORIZONTAL OUTSIDE FACE HOUR HOLLOW STEEL SECTION	<b>I</b>	INCL. I.F. INSUL.	INCLUDED INSIDE FACE INSULATION	<b>J</b>	JAN.	JANITOR	<b>L</b>	L.C.C.	LEAD COATED COPPER	<b>M</b>	MH. MANUF. M.C.J. M.O. MAX. MECH. MTD. MEMB. MIRR.	MANHOLE MANUFACTURED MASONRY CONTROL JOINT MASONRY OPENING MAXIMUM MECHANICAL MOUNTED MEMBRANE MIRRORED	<b>N</b>	NBC N.I.C. N.T.S. No.	NATIONAL BUILDING CODE NOT IN CONTRACT NOT TO SCALE NUMBER	<b>O</b>	O.C. OSB O.D. O.F. OWSJ	ON CENTRE ONTARIO BUILDING CODE ORIENTED STRAND BOARD OUTSIDE DIAMETER OUTSIDE FACE OPEN WEB STEEL JOIST	<b>P</b>	PED. PLAM. PLYWD. POLY PREFIN. P.T. PTD. P.SF	PEDESTAL PLASTIC LAMINATE PLYWOOD POLYETHYLENE PREFINISHED PRESSURE TREATED PAINTED PRESSED STEEL FRAME	<b>Q</b>	Q.T.	QUARRY TILE	<b>R</b>	RAD. R.W.L. REINF. REQD REQTS. R.D. RM. R.O.	RADIUS RAIN WATER LEADER REINFORCED/REINFORCING REQUIRED REQUIREMENTS ROOF DRAIN ROOM ROUGH OPENING	<b>S</b>	SN. SC. SEP. SH SHT. SIM. SPEC. SPF SQ.FT. S.S. STL. SF. STOR. STM. STRUCT. SUSP.	SANITARY SAW CUT SEPARATION SHELF/SHELVES SHEET SIMILAR SPECIFICATION SPRUCE PINE FIR SQUARE FEET STAINLESS STEEL STEEL STEP FOOTING STORAGE STORM STRUCTURAL SUSPENDED	<b>T</b>	T.J. T.L.L. T.O. T.U.L. TYP.	TIE JOIST TOP LOWER LAYER TOP OF TOP UPPER LAYER TYPICAL	<b>U</b>	U/G U/S U.N.O.	UNDERGROUND UNDERSIDE OF UNLESS NOTED OTHERWISE	<b>V</b>	V.B. VEST. VERT. V.E.F. V.I.F. V.O.F. VCT	VAPOUR BARRIER VESTIBULE VERTICAL VERTICAL EACH FACE VERTICAL INSIDE FACE VERTICAL OUTSIDE FACE VINYL COMPOSITE TILE	<b>W</b>	WR. W.V. W.W.M. w/ W.D.	WASHROOM WATER VALVE WLEDED WIRE MESH WITH WOOD DOOR
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**SYMBOLS LEGEND**

SHEET NUMBERS SHOWN REFER TO ARCHITECTURAL DRAWINGS UNLESS INDICATED OTHERWISE.

DENOTES: DETAIL TITLE

DENOTES: BUILDING SECTION

DENOTES: WALL SECTION

DENOTES: DETAIL

DENOTES: WALL/PARTITION ASSEMBLY

DENOTES: ROOM NAME AND NUMBER

DENOTES: EXTERIOR MATERIAL KEY NOTE

DENOTES: CEILING TYPE


DENOTES: WINDOW NUMBER

DENOTES: DOOR NUMBER

DENOTES: ROOM FINISH KEYNOTE

DENOTES: ELEVATION

DENOTES: ROOF ASSEMBLY

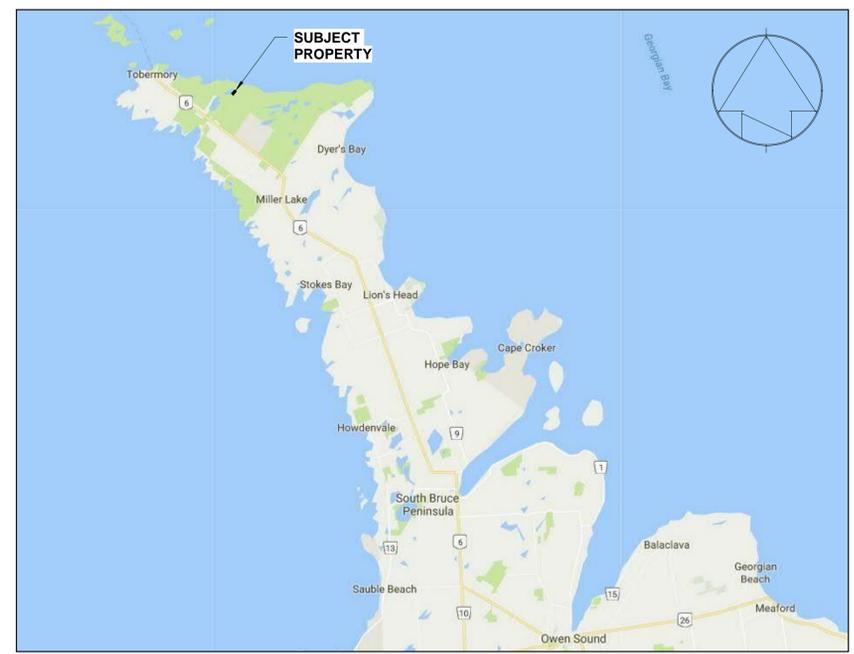

**LOCATION PLAN** **N.T.S.**

**WALL ASSEMBLIES:**

<b>EXTERIOR STONE BASE WALL</b> WT1	<ul style="list-style-type: none"> <li>90mm STONE VENER TO MATCH EXISTING CAMPGROUND ENTRANCE BUILDING.</li> <li>25mm AIR SPACE</li> <li>CONT. BUILDING WRAP AIR BARRIER</li> <li>16mm T&amp;G EXTERIOR GRADE PLYWOOD</li> <li>38X140 WOOD STUDS SPF No.1 OR No. 2 (REFER TO STRUCTURAL)</li> <li>c/w DOUBLE TOP PLATE AND 140mm MINERAL WOOL BATT INSULATION (R-23)</li> <li>CONT. 6 MIL. POLY AIR &amp; VAPOUR BARRIER</li> <li>WATER RESISTANT PRE-FINISHED INTERIOR WALL PANEL</li> </ul>	<b>INTERIOR PARTITION</b> P1	<ul style="list-style-type: none"> <li>WATER RESISTANT PRE-FINISHED INTERIOR WALL PANEL</li> <li>13mm WATER RESISTANT DENS SHIELD WALL BOARD</li> <li>38X89mm WOOD STUDS AT 400mm O.C.</li> <li>76mm SOUND ATTENUATION BATT. INSULATION WHERE INDICATED ON PLAN</li> <li>WATER RESISTANT PRE-FINISHED INTERIOR WALL PANEL</li> </ul>
<b>EXTERIOR WALL - WOOD SIDING</b> WT2	<ul style="list-style-type: none"> <li>16mm VERTICAL WOOD SIDING BY MAIBEC COLOUR AND PROFILE T &amp; D BY PARKS CANADA ALL JOINTS TO BE SEALED AS PER MANUFACTURER'S SPECIFICATIONS</li> <li>19mm x 90mm HORIZONTAL WOOD STRAPPING</li> <li>CONT. BUILDING WRAP AIR BARRIER</li> <li>16mm T&amp;G EXTERIOR GRADE PLYWOOD</li> <li>38X140 WOOD STUDS SPF No.1 OR No. 2 (REFER TO STRUCTURAL)</li> <li>c/w DOUBLE TOP PLATE AND 140mm MINERAL WOOL BATT INSULATION (R-23)</li> <li>CONT. 6 MIL. POLY AIR &amp; VAPOUR BARRIER</li> <li>WATER RESISTANT PRE-FINISHED INTERIOR WALL PANEL</li> </ul>	<b>INTERIOR PARTITION</b> P1A	<ul style="list-style-type: none"> <li>WATER RESISTANT PRE-FINISHED INTERIOR WALL PANEL</li> <li>13mm WATER RESISTANT DENS SHIELD WALL BOARD</li> <li>38X89mm WOOD STUDS AT 400mm O.C.</li> <li>13mm GYPSUM BOARD (PAINTED FINISH)</li> </ul>
<b>FOUNDATION WALL - REFER TO STRUCTURAL</b> FW1	<ul style="list-style-type: none"> <li>CAST-IN-PLACE CONCRETE WALL (REFER TO STRUCTURAL)</li> </ul>		


**ROOF ASSEMBLIES & CEILING:**

<b>INSULATED ROOF</b> RT1	<ul style="list-style-type: none"> <li>STANDING SEAM ROOFING AND SUPPORT SYSTEM</li> <li>CONT. ICE &amp; WATER SHIELD</li> <li>19mm PT. PLY-WOOD T&amp;G</li> <li>WOOD ROOF JOISTS (REFER TO STRUCTURAL)</li> <li>C/W MINERAL WOOL BATT INSULATION (R-32)</li> <li>CONT. 6 MIL. POLY AIR &amp; VAPOUR BARRIER</li> <li>19mm T&amp;G PINE CEILING FINISH</li> </ul>	<b>CANOPY ROOF</b> RT2	<ul style="list-style-type: none"> <li>STANDING SEAM ROOFING AND SUPPORT SYSTEM</li> <li>CONT. ICE &amp; WATER SHIELD</li> <li>STRUCTURAL WOOD DECKING. SEE STRUCTURAL.</li> </ul>
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**FLOOR ASSEMBLIES:**

<b>SLAB ON GRADE</b> F1	<ul style="list-style-type: none"> <li>FLOOR FINISH - REFER TO ROOM FINISH PLAN</li> <li>150mm CONCRETE SLAB (REFER TO STRUCTURAL)</li> <li>CONT. POLY VAPOUR BARRIER</li> <li>50mm RIGID INSULATION (R-10)</li> </ul>
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DRAWING NO.		DRAWING NAME	
REFERENCE DRAWINGS			
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NO.	DATE	DESCRIPTION	Drawn by/ Approved / Dessine par / Approuve
REVISIONS			
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B	B Sheet Number		B Sur feuille Numero
LINEAR DIMENSIONS IN MILLIMETERS		Dimensions lineaires en millimetres	
<b>Canada</b>			
PARKS CANADA			
Type of Record / Type d'enregistrement			
Project title / Titre du projet			
<b>CYPRUS LAKE - HEAD OF TRAILS RENEWAL</b>			
Drawing title / Titre du Dessin			
<b>REFERENCE SHEET</b>			
Plot Scale / Echelle			
As indicated			
Drawn by/ Dessin par	JA	Date	2018- 06- 05
Field Recording by/ Relevé- Terrain par	AD	Date	
Approved by/ Approuve par	RT	Date	2018- 07- 25
Checked by/ Verifie par	AD	Date	2018- 07- 25
Project No./No. du projet	Asset No.	Sheet No./ Feuille No.	
60576731		<b>A1</b>	
Drawing Re No./No. du Dessin			



1 LIFE SAFETY PLAN  
A6/A2 1:75

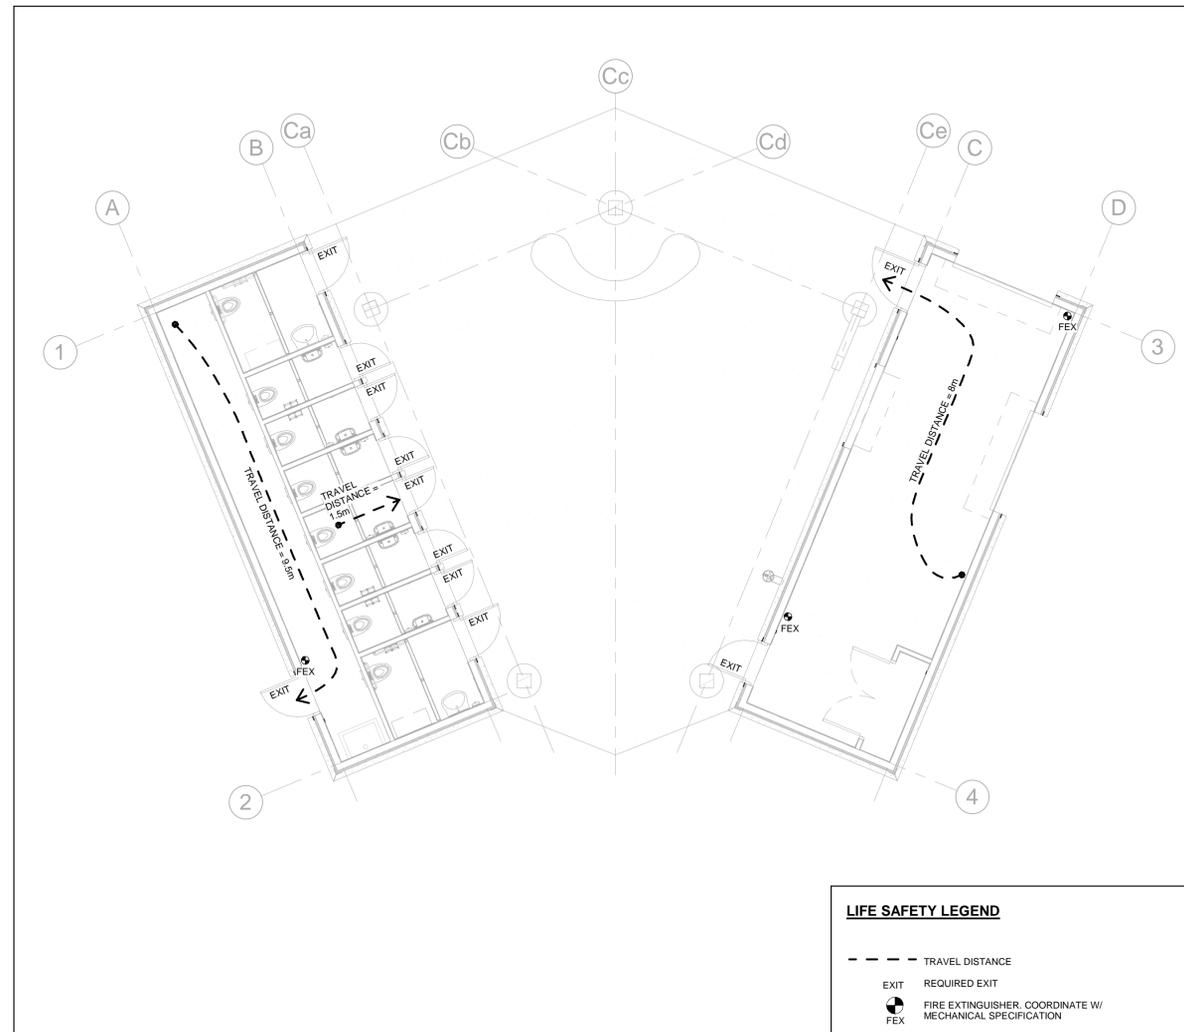**LIFE SAFETY LEGEND**

--- TRAVEL DISTANCE


EXIT REQUIRED EXIT

FIRE EXTINGUISHER, COORDINATE W/ MECHANICAL SPECIFICATION

AECOM Canada Architects Ltd.  
50 Sportsworld Crossing Road, Suite 290  
Kitchener, Ontario N2P 0A4  
519.650.5313

Project Name: CYPRUS LAKE CAMPGROUND - HEAD OF TRAILS WASHROOM BUILDING  
Location: CYPRUS LAKE ROAD, BRUCE PENINSULA NATIONAL PARK  
TOBERMORY, ONTARIO CANADA

ITEM	NATIONAL BUILDING CODE DATA MATRIX PARTS 3 & 9	NBC REFERENCE
1	Project Description: <input checked="" type="checkbox"/> New <input type="checkbox"/> Part 11 <input checked="" type="checkbox"/> Part 3 <input type="checkbox"/> Part 9 <input type="checkbox"/> Change of Use <input type="checkbox"/> Addition <input type="checkbox"/> Alteration 11.1 to 11.4	2.1,1 9.10.2.1
2	Major Occupancy (s): Group A, Division 2	3.1.2.1, (1) 9.10.2
3	Building Area (m2): Existing - New 87 Total 87	1.1.3.2 1.1.3.2
4	Gross Area (m2): Existing - New 87 Total 87	1.1.3.2 1.1.3.2
5	Number of Storeys: Above Grade 1 Below Grade 0	3.2.1.1 & 1.1.3.2 2.1.1.3
6	Number of Streets / Fire Fighter Access: 1	3.2.2.10 & 3.2.5 9.10.19
7	Building Classification: 3.2.2.28, Group A, Division 2, 1 Storey	3.2.2.20 to .83 9.10.4
8	Sprinkler System Proposed: <input type="checkbox"/> Entire Building <input type="checkbox"/> Basement Only <input type="checkbox"/> In Lieu of Roof Rating <input checked="" type="checkbox"/> Not Required	3.2.2.20 to .83 3.2.1.5 3.2.2.17 9.10.8
9	Standpipe Required: <input type="checkbox"/> Yes <input checked="" type="checkbox"/> No	3.2.9 N/A
10	Fire Alarm Required: <input type="checkbox"/> Yes <input checked="" type="checkbox"/> No	3.2.4 9.10.18.2
11	Water Service / Supply is Adequate: <input type="checkbox"/> Yes <input checked="" type="checkbox"/> No	3.2.5.7 N/A
12	High Building: <input type="checkbox"/> Yes <input checked="" type="checkbox"/> No	3.2.6 N/A
13	Permitted Construction: <input type="checkbox"/> Combustible <input type="checkbox"/> Non-Combustible <input checked="" type="checkbox"/> Both Actual Construction: <input checked="" type="checkbox"/> Combustible <input type="checkbox"/> Non-Combustible <input type="checkbox"/> Both	3.2.2.20 to .83 9.10.6
14	Mezzanine (s) Area (m2): N/A	3.2.1.1.(3) to (8) 9.10.4.1
15	Occupant Load Based On: <input type="checkbox"/> m2 / person <input checked="" type="checkbox"/> design of building Ground Floor: Occupancy: A2 Load: 12 persons Occupancy: Load: persons Occupancy: Load: persons Occupancy: Load: persons Total: Load: 12 persons	3.1.17 9.9.1.3
16	Barrier - Free Design: <input checked="" type="checkbox"/> Yes <input type="checkbox"/> No (explain)	3.8 9.5.2
17	Hazardous Substances: <input type="checkbox"/> Yes <input checked="" type="checkbox"/> No	3.3.1.2 & 3.3.1.19 9.10.1.3.(4)
18	Fire Resistance Rating (FRR)	3.2.2.20 to .83 3.2.1.4 9.10.8 9.10.9
	Horizontal Assemblies FRR (Hours)	Listed Design No. or Description (SB-2)
	Floors: 0 HOURS	
	Roof: 0 HOURS	
	Mezzanine: 0 HOURS	
	FRR of Supporting Members	Listed Design No. or Description (SB-2)
	Floors: 0 HOURS	
	Roof: 0 HOURS	
	Mezzanine: 0 HOURS	
19	Other: - MAXIMUM TRAVEL DISTANCE = 30m - NO MATERIAL INCLUDING JANITORIAL SUPPLIES ARE PERMITTED TO BE STORED IN THE MECHANICAL CHASE AS PER N.B.C. - SEASONAL REMOTE BUILDING LOCATED IN A FEDERAL PARK - FIRE EXTINGUISHERS PROVIDED FOR FIRE PROTECTION.	

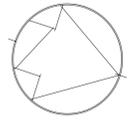

DRAWING NO. DRAWING NAME

REFERENCE DRAWINGS

NO.	DATE	DESCRIPTION	Drawn by/ Dessine par	Approved/ Approuve
1	2018- 08- 16	ISSUED FOR TENDER	JA	RT

REVISIONS

A	A Detail Number	A Numero de Detail
B	B Sheet Number	B Sur feuille Numero

LINEAR DIMENSIONS IN MILLIMETERS Dimensions lineaires en millimetres



Canada

PARKS CANADA

Type of Record / Type d'enregistrement

Project title / Titre du projet

CYPRUS LAKE - HEAD OF TRAILS RENEWAL

Drawing title / Titre du Dessin

LIFE SAFETY PLAN & NBC MATRIX

Plot Scale / Echelle

As indicated

Drawn by/ Dessin par JA Date 2018- 06- 05


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Approved by/ Approuve par RT Date 2018- 07- 25


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Project No./No. du projet Asset No. Sheet No./ Feuille No. 60576731


Drawing Re No./No. du Dessin A2



1 FLOOR PLAN  
A6/A3 1:50

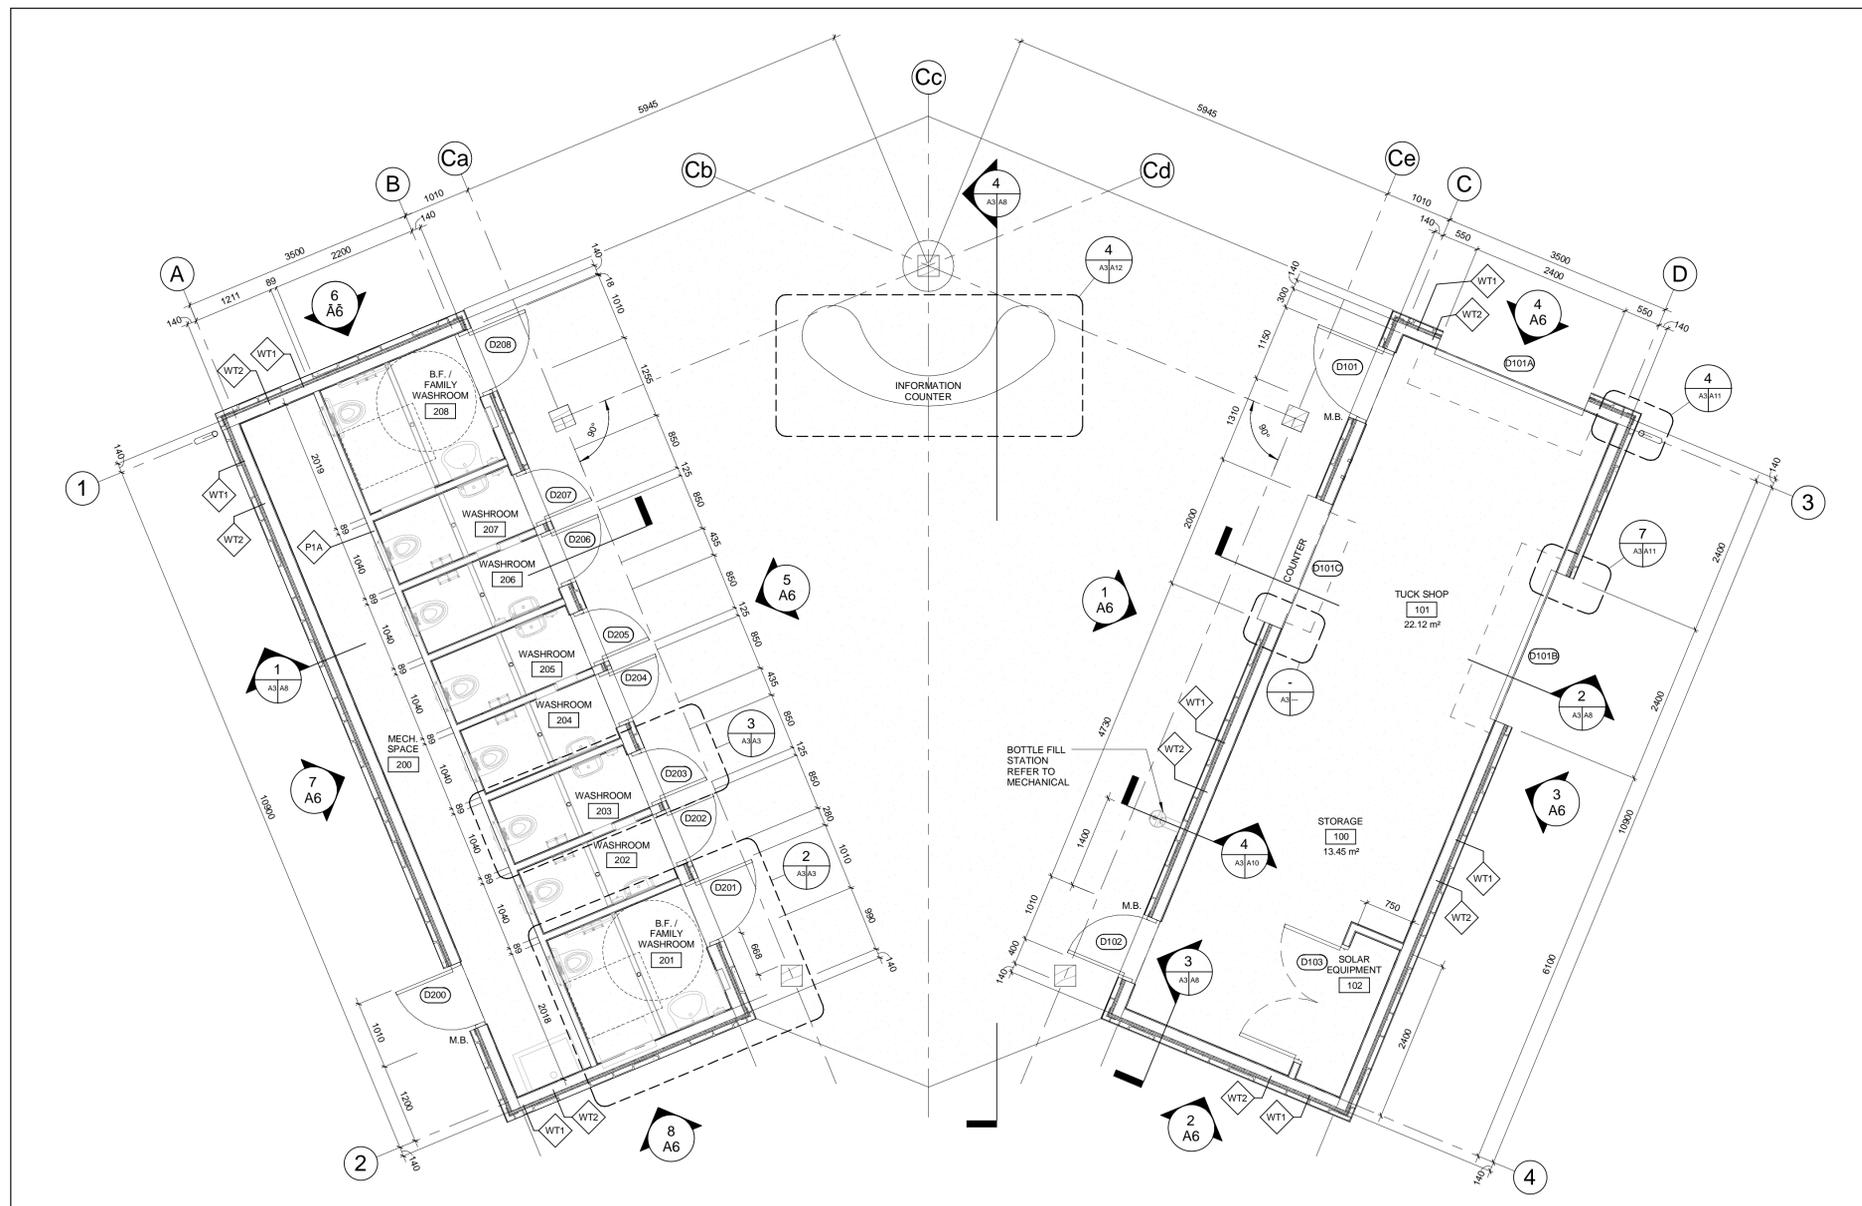

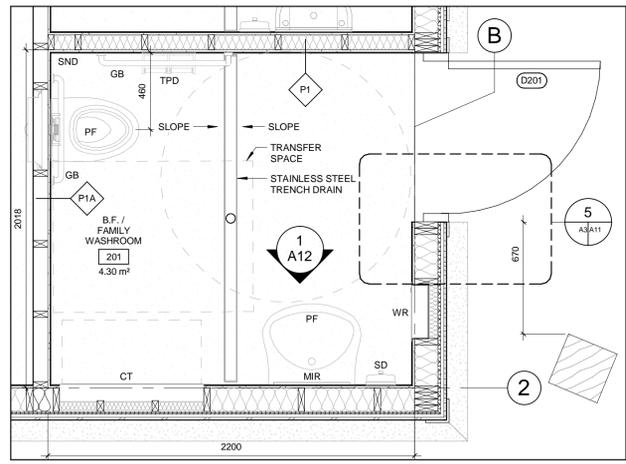2 ENLARGED FLOOR PLAN - B.F. / FAMILY WASHROOM  
A3/A3 1:20

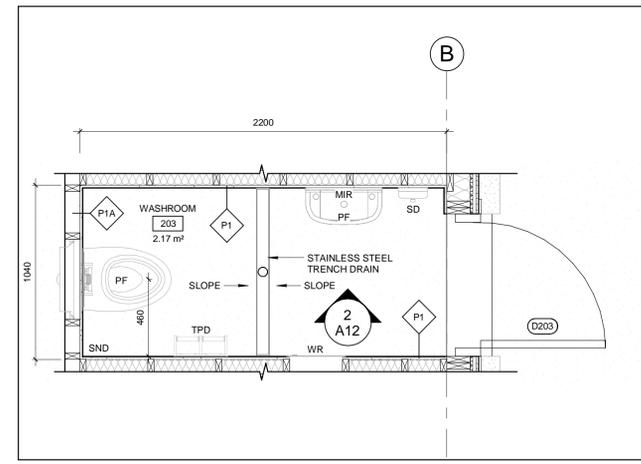

3 ENLARGED FLOOR PLAN - STANDARD WASHROOM  
A3/A3 1:20

- LEGEND:**
- GB BARRIER FREE GRAB BAR. REFER TO TYP. DETAIL
  - TPD TOILET PAPER DISPENSER
  - SND SANITARY NAPKIN DISPOSAL
  - MIR MIRROR
  - CT CHANGE TABLE
  - WR PAPER TOWEL & WASTE RECEPTACLE COMBO
  - SD SOAP DISPENSER
  - PF PLUMBING FIXTURE (REFER TO MECHANICAL)
  - M.B. MECHANICAL PUSH BUTTON KEY CODE ACCESS COORDINATE WITH DOOR SCHEDULE



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B	B Sheet Number	B Sur feuille Numero	

LINEAR DIMENSIONS IN MILLIMETERS      Dimensions lineaires en millimetres

Canada

PARKS CANADA


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Type d'enregistrement

Project title / Titre du projet  
**CYPRUS LAKE - HEAD OF TRAILS RENEWAL**


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**FLOOR PLAN**

Plot Scale / Echelle		As indicated	
Drawn by/ Dessin par	JA	Date	2018- 06- 05
Field Recording by/ Relevé- Terrain par	AD	Date	
Approved by/ Approuve par	RT	Date	2018- 07- 25
Checked by/ Verifie par	AD	Date	2018- 07- 25


Project No./No. du projet	Asset No.	Sheet No./ Feuille No.
60576731		A3
Drawing Re No./No. du Dessin		

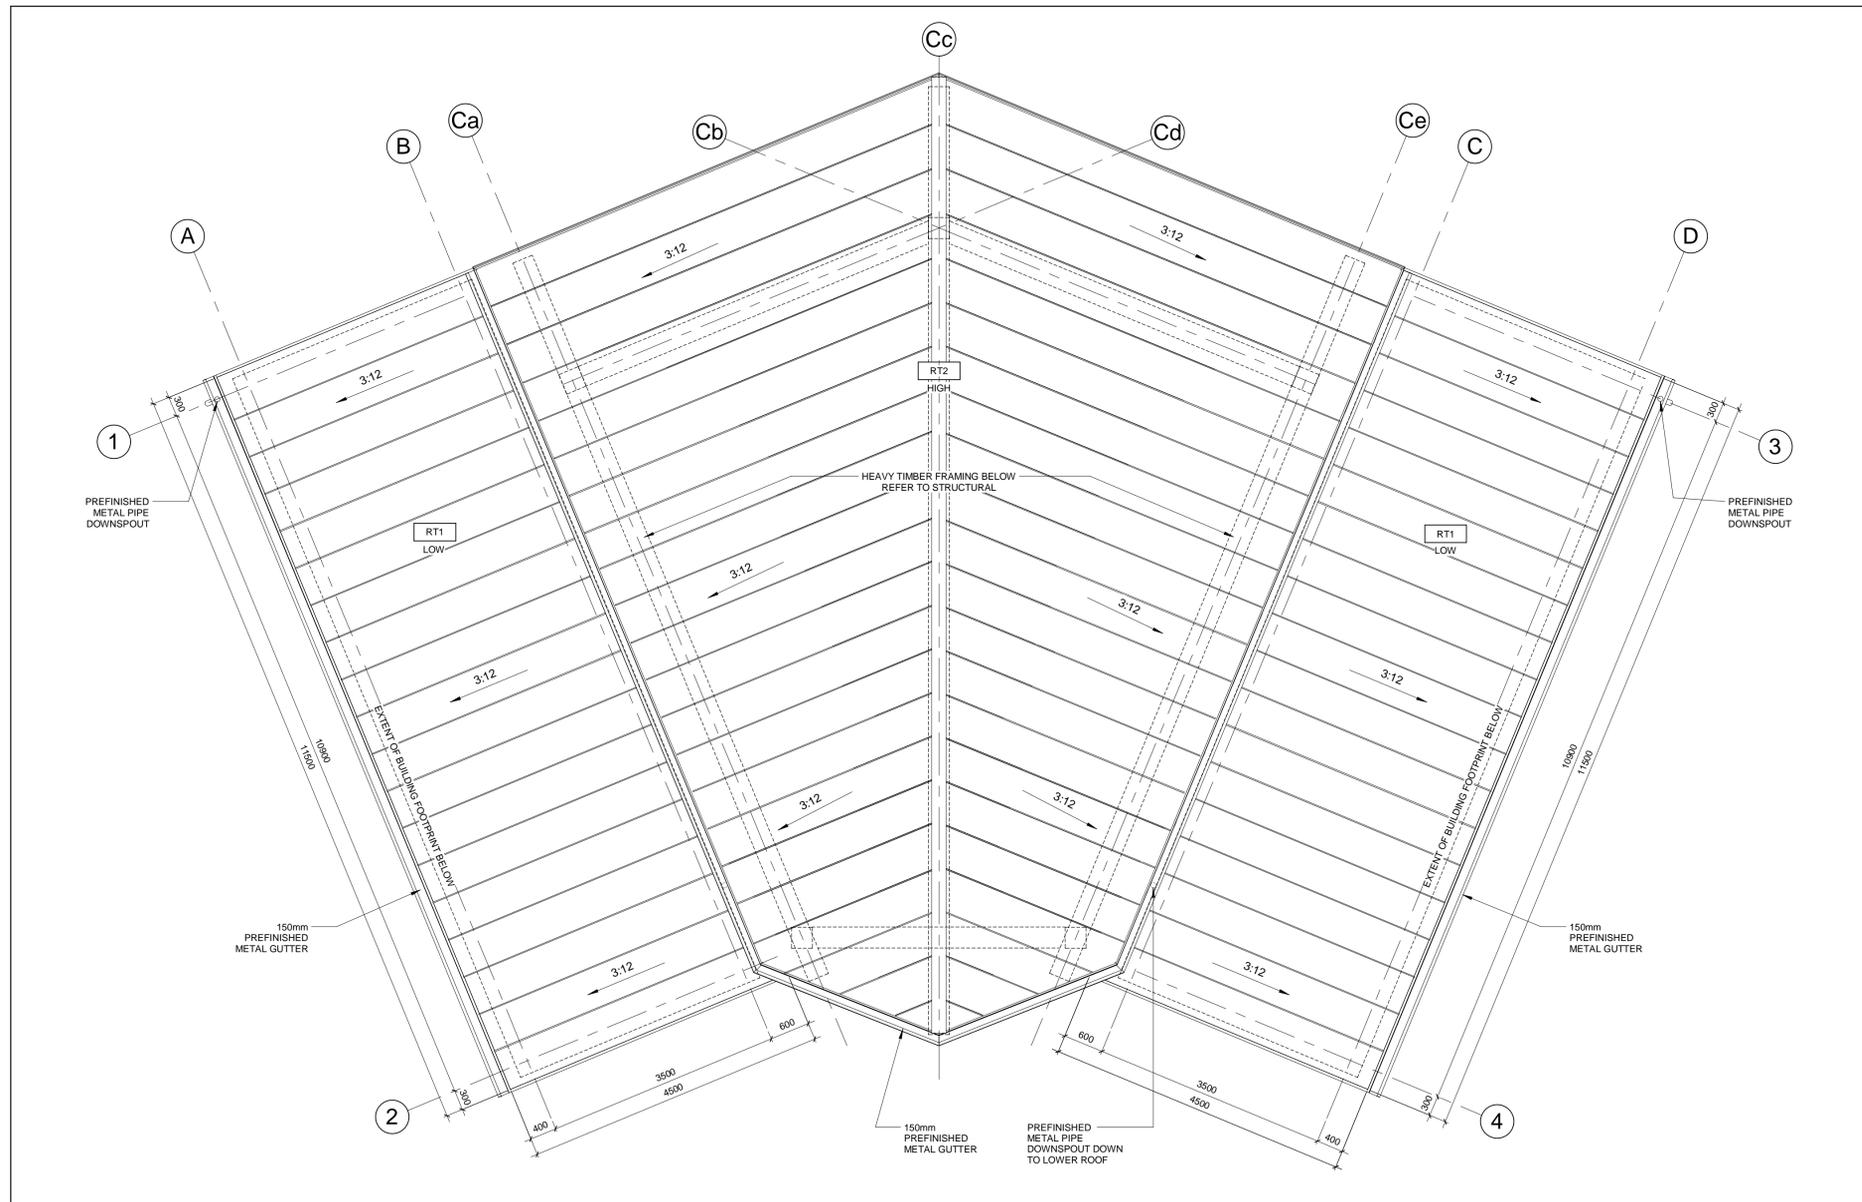

1 ROOF PLAN  
1:50

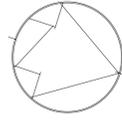

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LINEAR DIMENSIONS IN MILLIMETERS		Dimensions lineaires en millimetres	
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Canada			
PARKS CANADA			
Type of Record / Type d'enregistrement			
Project title / Titre du projet			
CYPRUS LAKE - HEAD OF TRAILS RENEWAL			
Drawing title / Titre du Dessin			
ROOF PLAN			
Plot Scale / Echelle			
1 : 50			
Drawn by/ Dessin par		Date	
JA		2018-06-05	
Field Recording by/ Relevé- Temoins par		Date	
RT		2018-07-25	
Approved by/ Approuve par		Date	
AD		2018-07-25	
Checked by/ Verifie par		Date	
AD		2018-07-25	
Project No./No. du projet	Asset No.	Sheet No./ Feuille No.	
60576731		A4	
Drawing Re No./No. du Dessin			

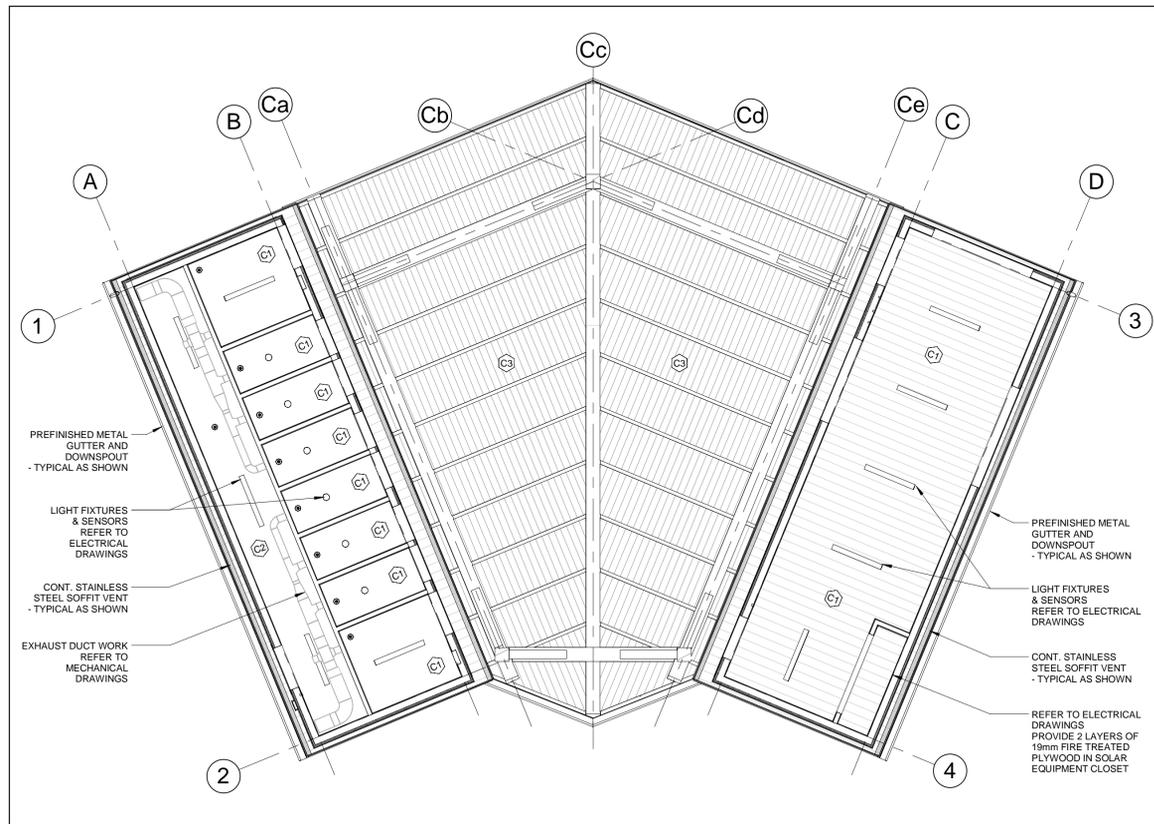

1 REFLECTED CEILING PLAN  
AG/AS 1:75

**LEGEND:**  
NOTE: ALL EXTERIOR AND INTERIOR DIMENSIONS ARE TO THE FACE OF CONCRETE OR STUD UNLESS OTHERWISE NOTED

- ⊙ LIGHTING CONTROL SENSOR, REFER TO ELECTRICAL
- ▭ LIGHT FIXTURE, REFER TO ELECTRICAL

**CEILING TYPES:**

- C1 16mm X 140mm TONG AND GROOVE PINE FINISHED TO BE SELECTED BY ARCHITECT
- C2 13mm MOISTURE RESISTANT GYPSUM BOARD PAINTED FINISH
- C3 EXPOSED GULILAM STRUCTURE AND WOOD PLANK DECKING OILED FINISH

**ROOM FINISH LEGEND**  
NOTE: ALL COLOURS, FINISHES, AND PATTERNS TO BE COORDINATED WITH THE OWNER, ARCHITECT, AND SPECIFICATIONS

**WALLS:**  
W1 - MOISTURE RESISTANT PRE-FINISHED WALL PANELS FULL HEIGHT CW RIVET FASTENERS & MATCHING TRIMS  
W2 - PAINTED MOISTURE RESISTANT GYPSUM BOARD


**FLOOR:**  
F1 - CONTINUOUS EPOXY FLOOR COATING CW NON-SLIP TEXTURE  
F2 - EXPOSED CONCRETE SLAB

**BASE:**  
B1 - CONTINUOUS EPOXY COATING 150mm HIGH  
B2 - NO BASE


**SYMBOL LEGEND**

- \* DENOTES FLOOR FINISH TRANSITION
- DENOTES FLOOR DRAIN, REFER TO MECHANICAL

**NOTES:**  
1. COORDINATE WITH REFLECTED CEILING PLANS.  
2. FINAL FINISHES AND COLOURS TO BE SELECTED AND APPROVED BY CONSULTANT AND PARKS CANADA.

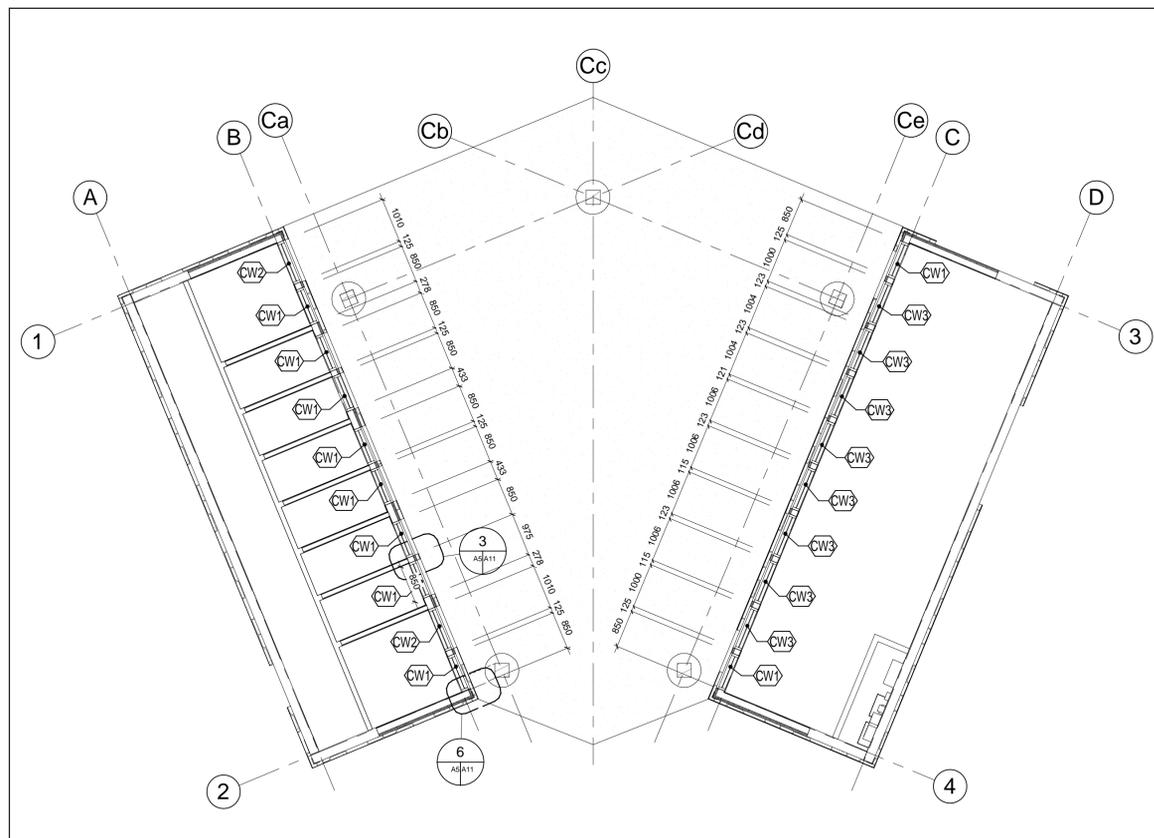

3 HIGH LEVEL WINDOW PLAN  
AG/AS 1:75

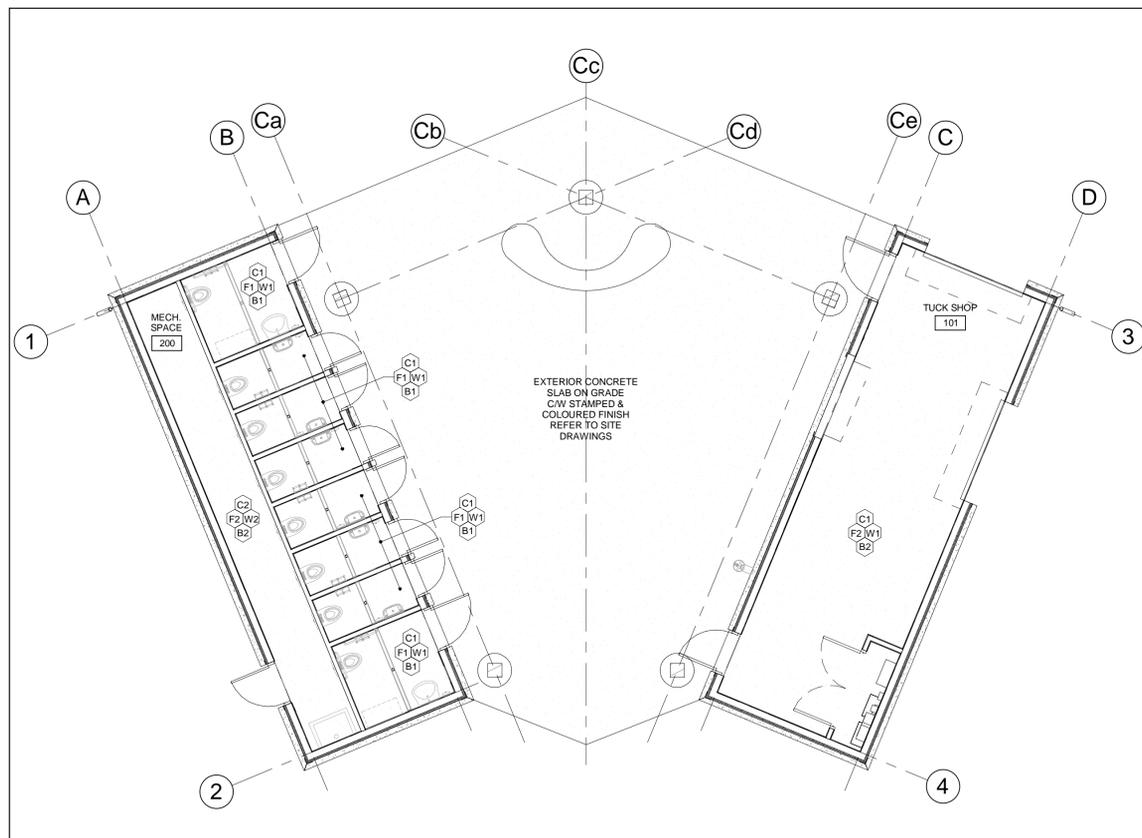

2 ROOM FINISH PLAN  
AG/AS 1:75



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LINEAR DIMENSIONS IN MILLIMETERS      Dimensions lineaires en millimetres

Parcs Canada      Parks Canada

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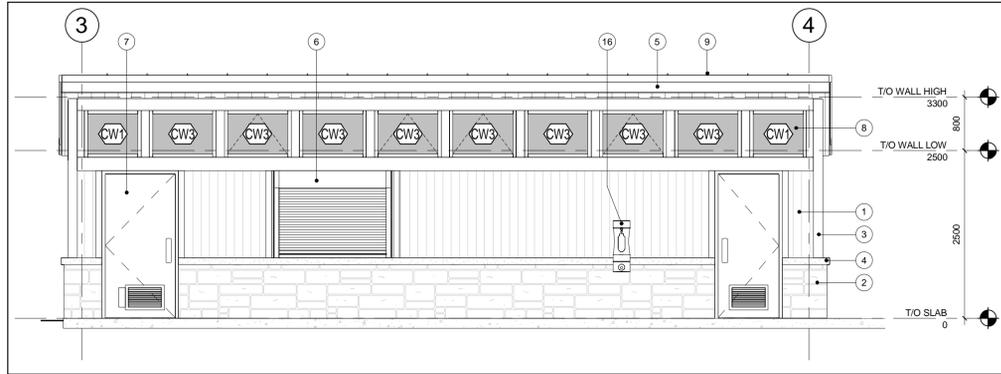
PARKS CANADA

Type of Record / Type d'enregistrement


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**CYPRUS LAKE - HEAD OF TRAILS RENEWAL**

Drawing title / Titre du Dessin  
**REFLECTED CEILING PLAN & ROOM FINISH SCHEDULE**


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Drawn by/ Dessin par	JA	Date	2018-06-05
Field Recording by/ Relevé- Terrain par	AD	Date	
Approved by/ Approuvé par	RT	Date	2018-07-25
Checked by/ Vérifié par	AD	Date	2018-07-25
Project No./No. du projet	Asset No.	Sheet No./ Feuille No.	
60576731		A5	
Drawing Re No./No. du Dessin			




1 ELEVATION 1- NORTH BUILDING  
A3/A6 1:50

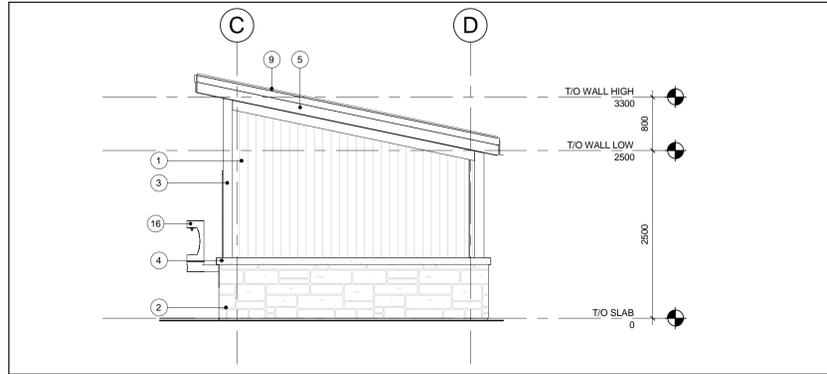


2 ELEVATION 2- NORTH BUILDING  
A3/A6 1:50

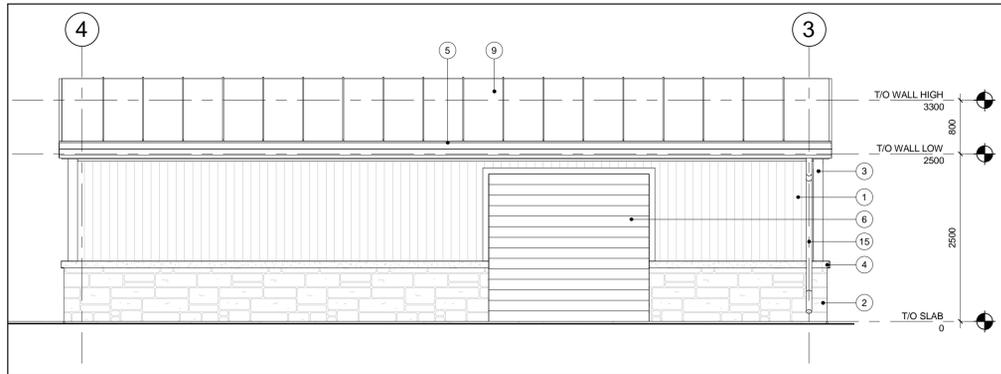


3 ELEVATION 3- NORTH BUILDING  
A3/A6 1:50

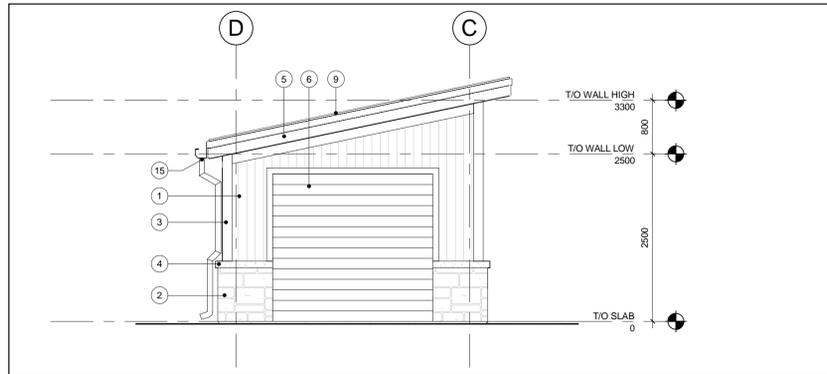


4 ELEVATION 4- NORTH BUILDING  
A3/A6 1:50

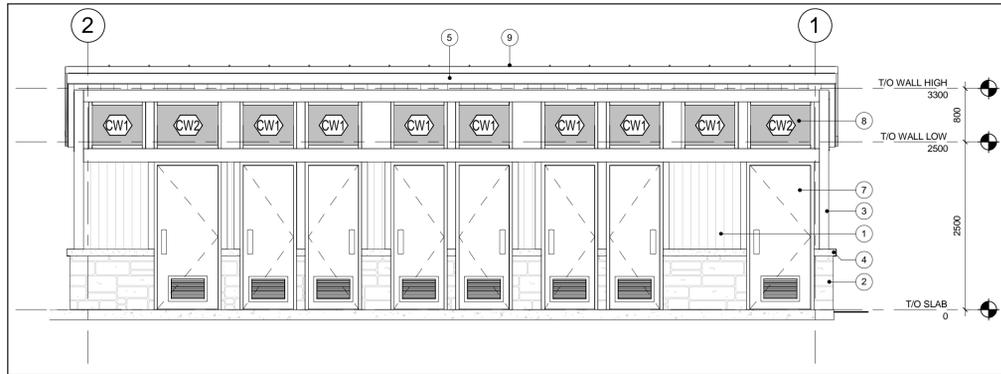


5 ELEVATION 1- SOUTH BUILDING  
A3/A6 1:50

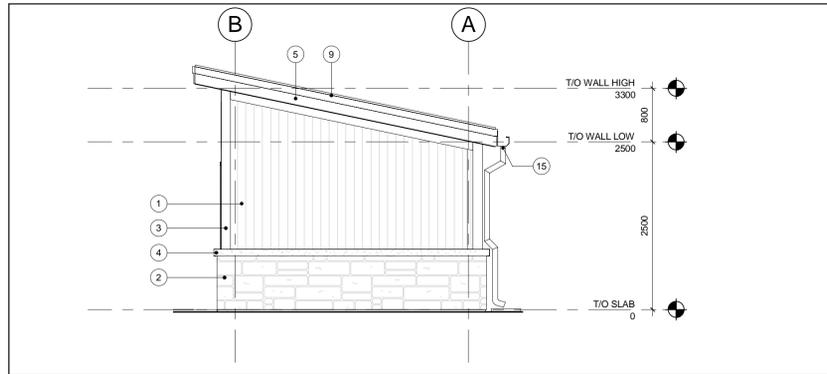

6 ELEVATION 3- SOUTH BUILDING  
A3/A6 1:50

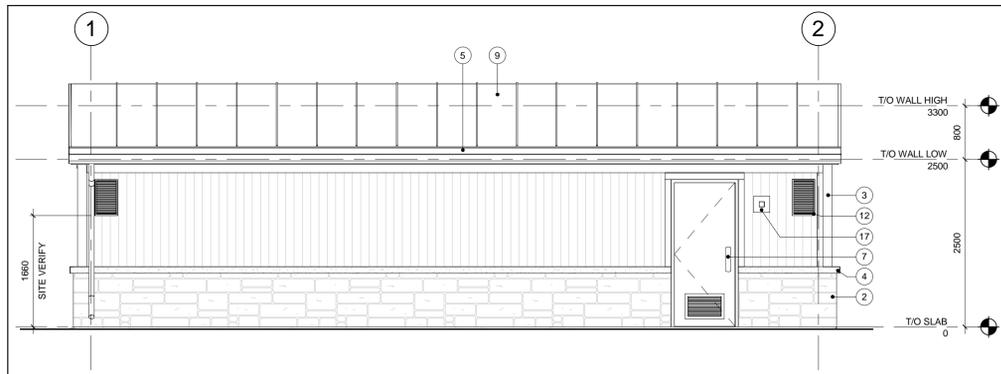

7 ELEVATION 2- SOUTH BUILDING  
A3/A6 1:50

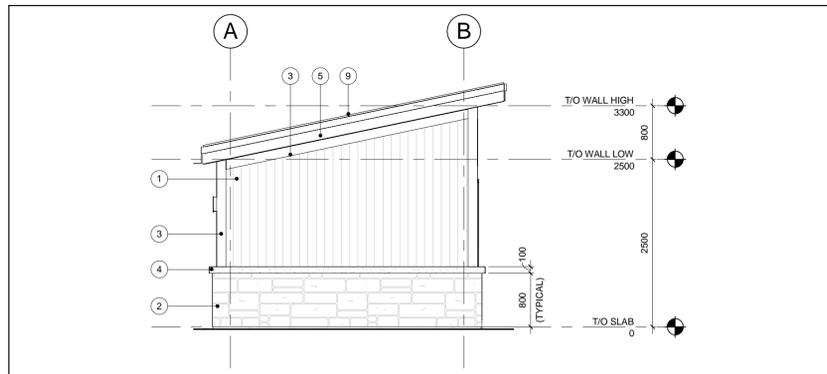

8 ELEVATION 4- SOUTH BUILDING  
A3/A6 1:50

**EXTERIOR ELEVATIONS KEYNOTES:**

- 1 PREFINISHED VERTICAL SIDING BY MAIBEC  
COLOUR TO BE APPROVED BY AECOM AND PARKS CANADA
- 2 CULTURED STONE VENEER  
COLOUR AND STYLE TO BE APPROVED BY AECOM AND PARKS CANADA
- 3 PREFINISHED MAIBEC WOOD TRIM  
COLOUR TO BE APPROVED BY AECOM AND PARKS CANADA
- 4 100mm PRE-CAST CONCRETE SILL CW WITH DRIP EDGE  
COLOUR TO BE APPROVED BY AECOM AND PARKS CANADA
- 5 PREFINISHED METAL FASCIA  
COLOUR TO BE APPROVED BY AECOM AND PARKS CANADA
- 6 INSULATED EXTERIOR COILING DOOR & FRAME.  
REFER TO DOOR SCHEDULE.
- 7 INSULATED EXTERIOR DOOR AND FRAME  
REFER TO DOOR SCHEDULE.
- 8 ALUMINUM INSULATED EXTERIOR WINDOW FRAME  
CW INSULATED DOUBLE PANE GLAZING
- 9 STANDING SEAM METAL ROOFING  
COLOUR TO BE APPROVED BY AECOM AND PARKS CANADA
- 12 PRE-FINISHED METAL EXHAUST LOUVRE  
REFER TO MECHANICAL
- 13 PLUMBING VENT  
REFER TO MECHANICAL
- 14 TAMPER-PROOF LOCKABLE HOSE BIB  
REFER TO MECHANICAL
- 15 PRE-FINISHED DOWNSPOUT  
HEAVY GAUGE DENT AND VANDAL RESISTANT
- 16 EXTERIOR BOTTLE FILL STATION  
REFER TO MECHANICAL
- 17 EXTERIOR LIGHT FIXTURE  
REFER TO ELECTRICAL

DRAWING NO. DRAWING NAME

**REFERENCE DRAWINGS**

NO.	DATE	DESCRIPTION	Drawn by/ Dessine par	Approved / Approuve
1	2018- 08- 16	ISSUED FOR TENDER	JA	RT

**REVISIONS**

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LINEAR DIMENSIONS IN MILLIMETERS      Dimensions lineaires en millimetres



**Canada**

PARKS CANADA

Type of Record /  
Type d'enregistrement

Project title / Titre du projet  
**CYPRUS LAKE -  
HEAD OF TRAILS  
RENEWAL**

Drawing title / Titre du Dessin  
**BUILDING ELEVATIONS**

Plot Scale / Echelle  
As indicated

Drawn by/ Dessin par      Date  
JA      2018- 06- 05


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Releve- Terrain par      Date

Approved by/ Approuve par      Date  
RT      2018- 07- 25


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AD      2018- 07- 25

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60576731           Feuille No.


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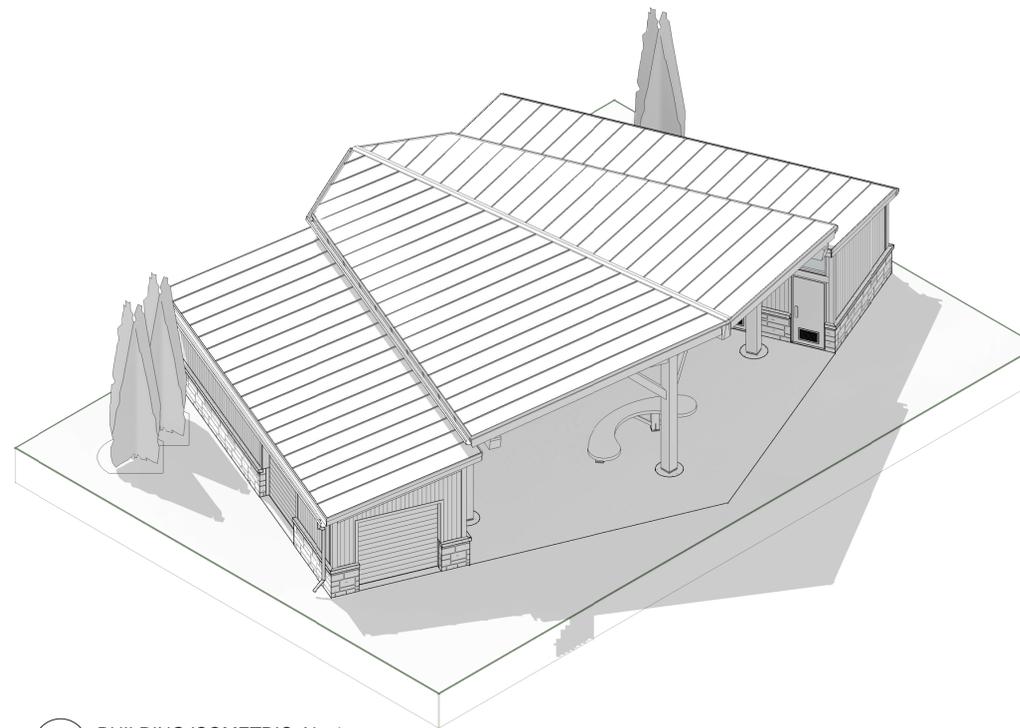
4 BUILDING ISOMETRIC No.1

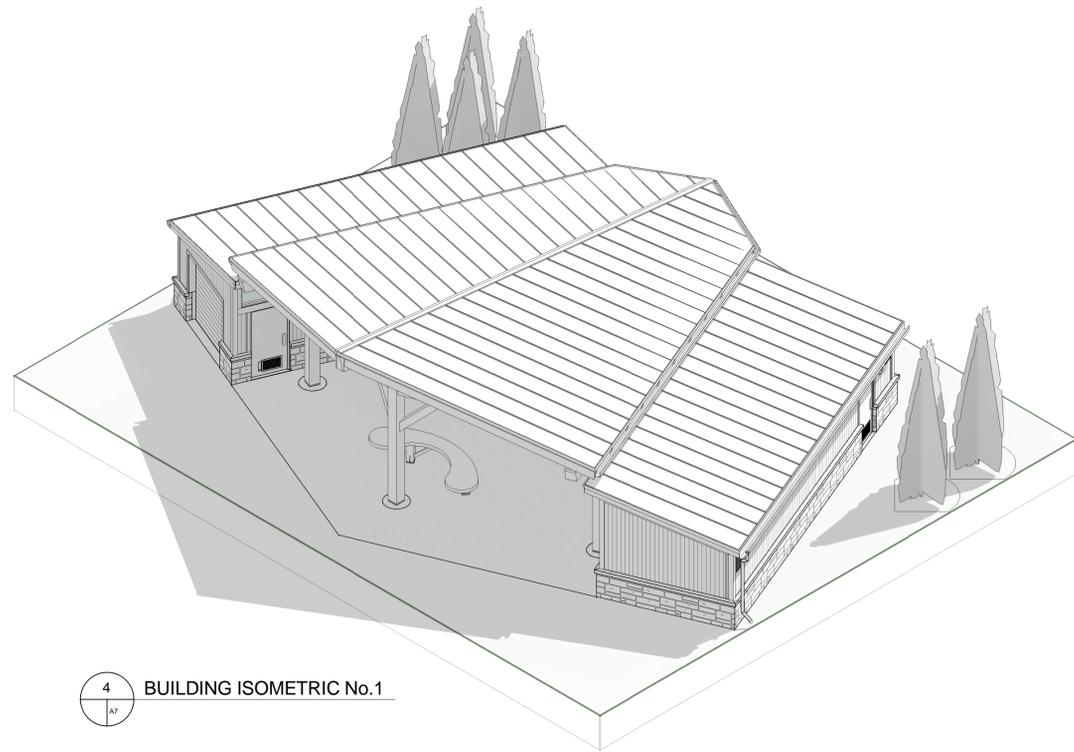

2 BUILDING ISOMETRIC No.2

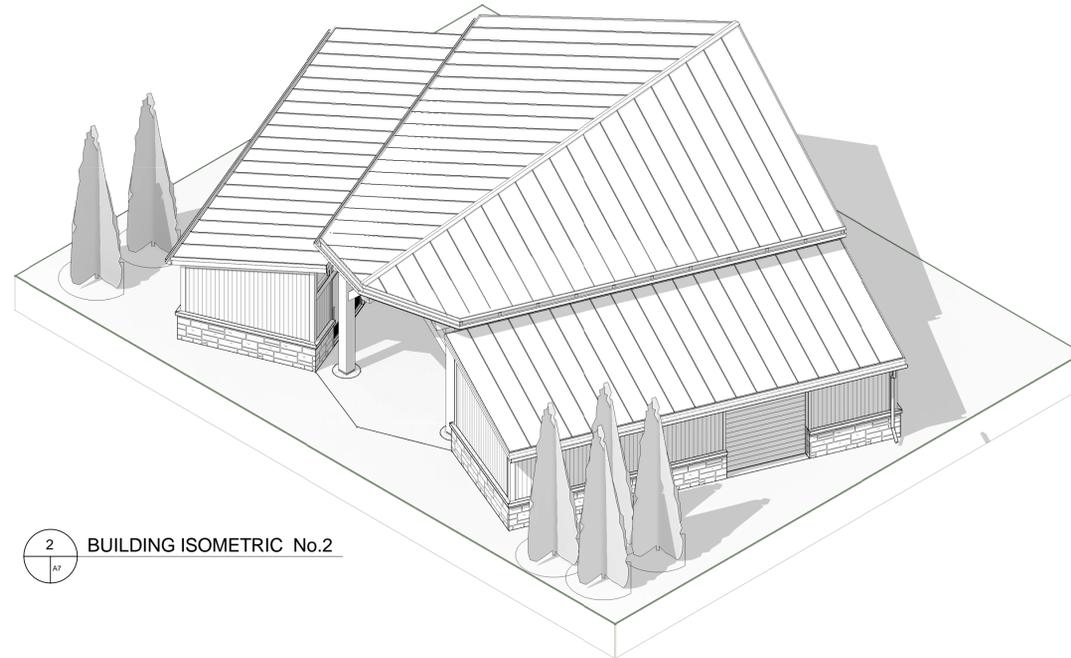

3 BUILDING ISOMETRIC No.3

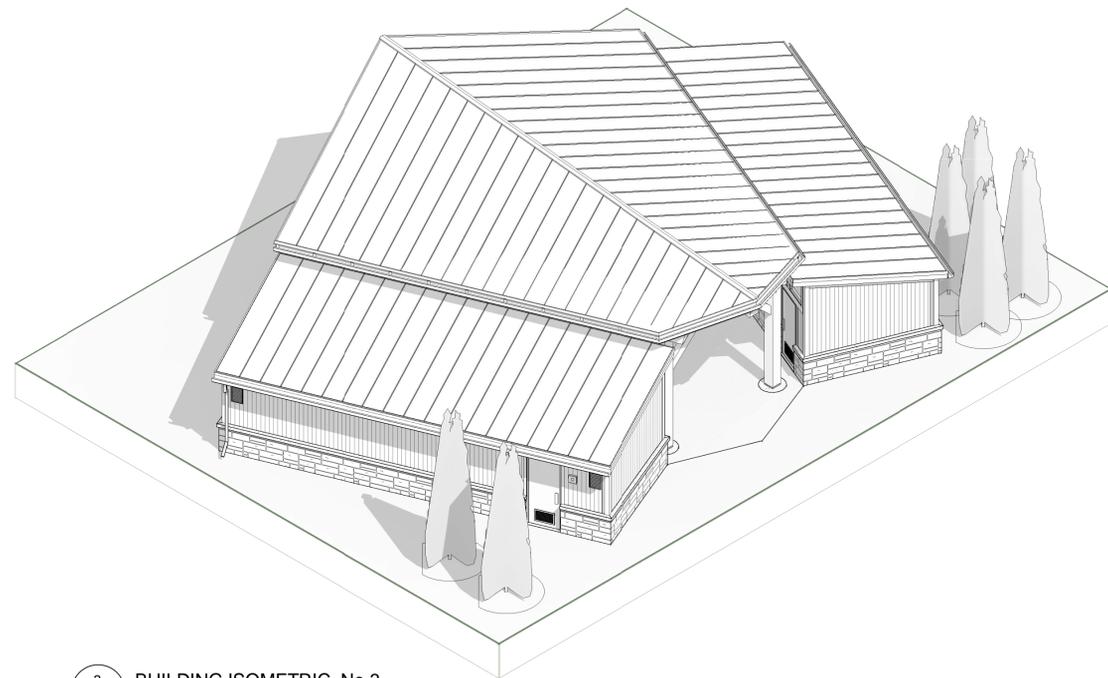

1 BUILDING ISOMETRIC No.4

DRAWING NO. DRAWING NAME

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LINEAR DIMENSIONS IN MILLIMETERS Dimensions lineaires en millimetres



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Type d'enregistrement

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**CYPRUS LAKE -  
HEAD OF TRAILS  
RENEWAL**

Drawing title / Titre du Dessin  
**BUILDING ISOMETRICS**

Plot Scale / Echelle

Drawn by/ Dessin par  
JA Date  
2018-06-05


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Approved by/ Approuve par  
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2018-07-25


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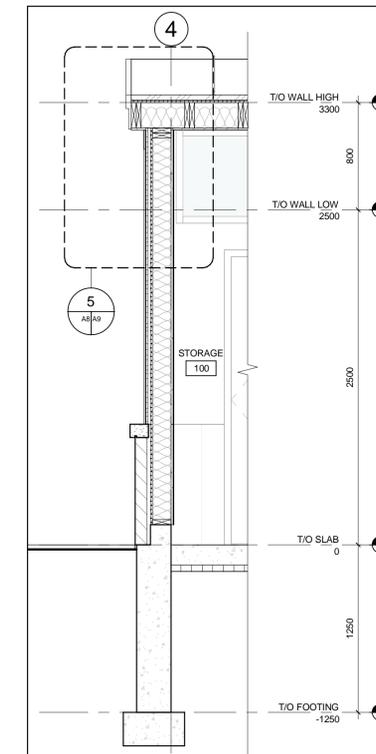
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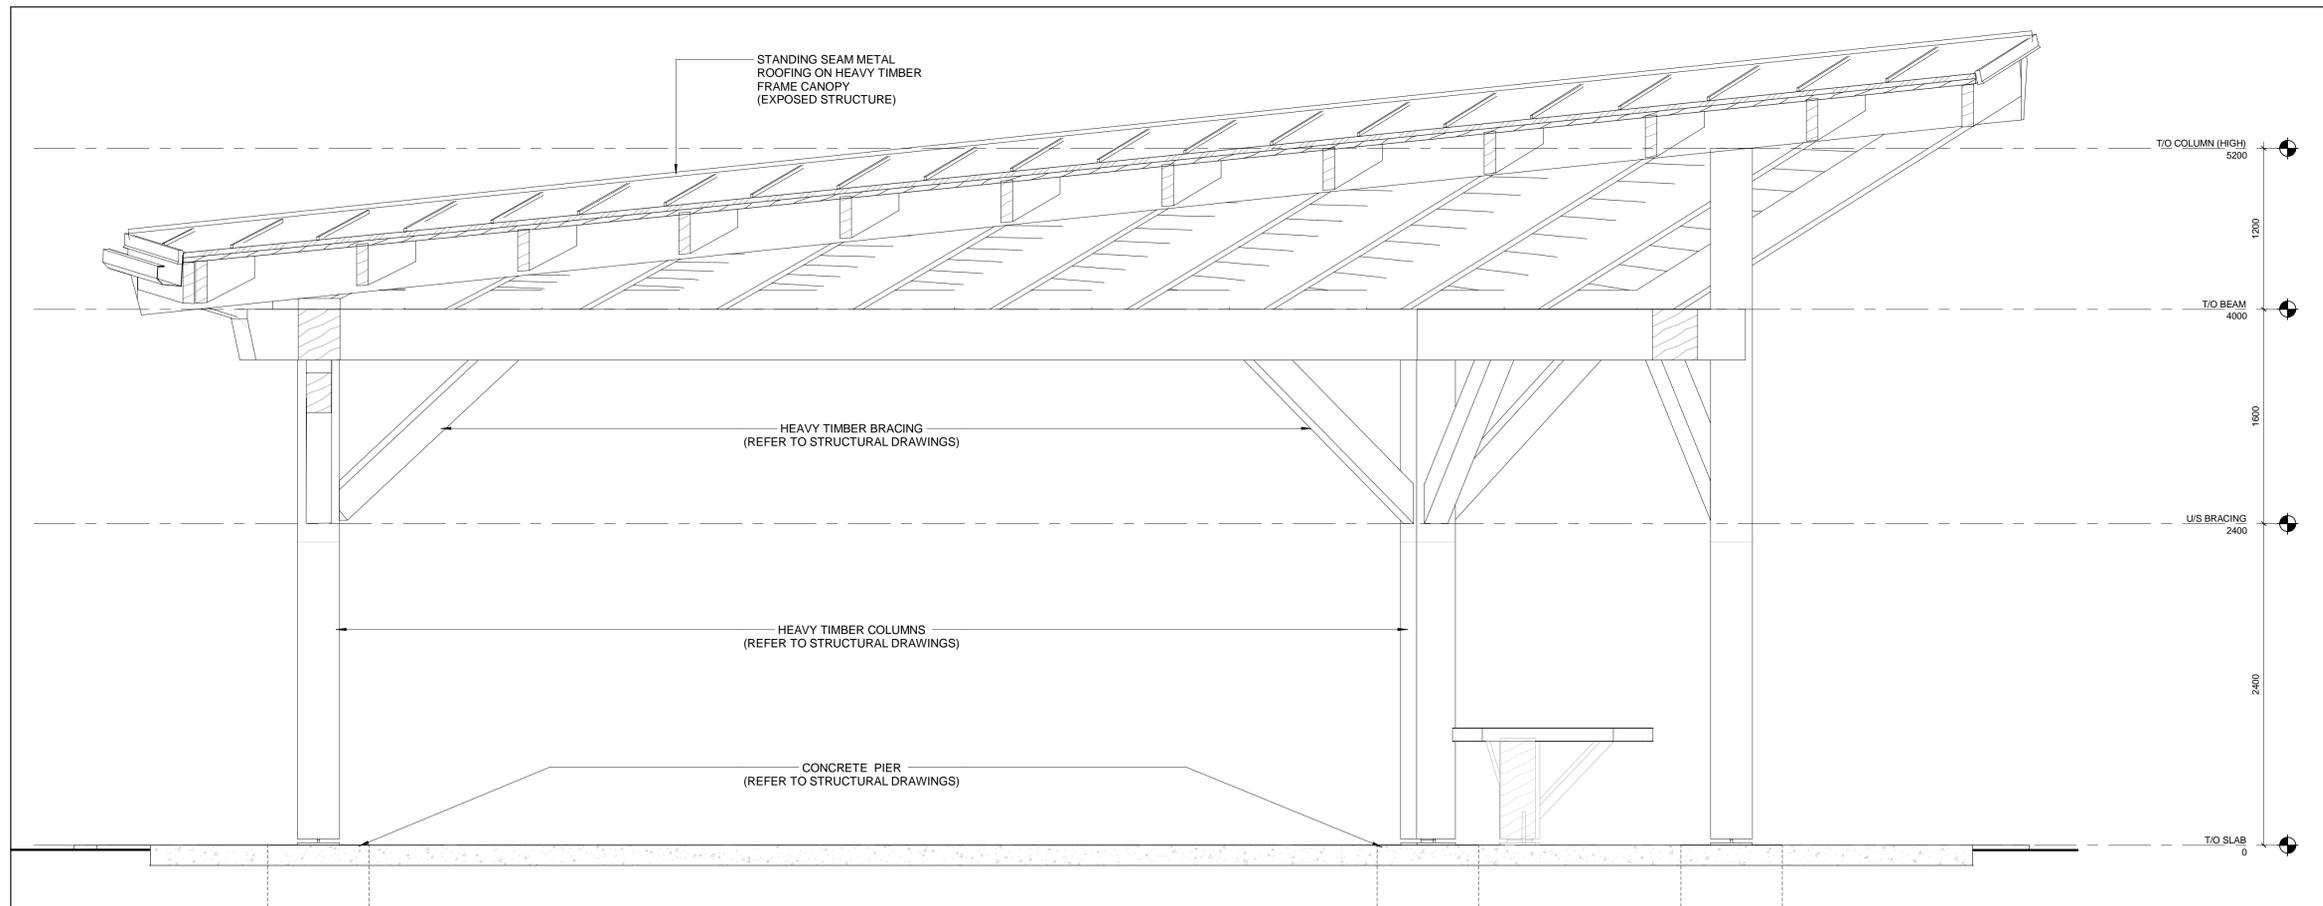
1 BUILDING SECTION I  
AS/A8 1:25



2 BUILDING SECTION II  
AS/A8 1:25

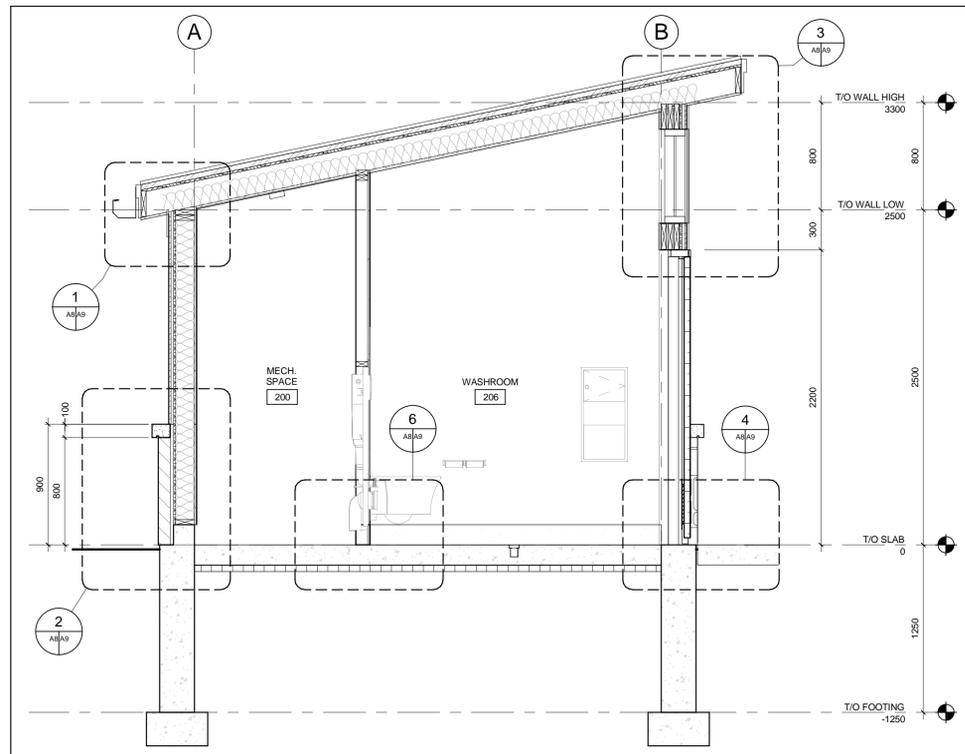

3 BUILDING SECTION III  
AS/A8 1:25

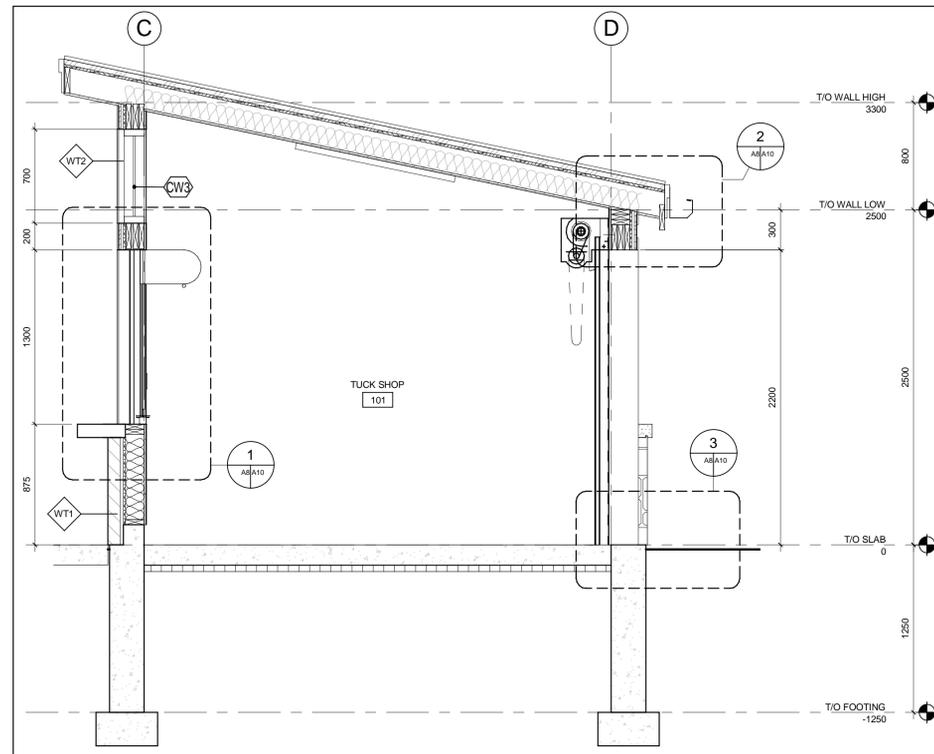

4 CANOPY - SECTION  
AS/A8 1:25

DRAWING NO. DRAWING NAME

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Project title / Titre du projet  
**CYPRUS LAKE -  
HEAD OF TRAILS  
RENEWAL**

Drawing title / Titre du Dessin  
**BUILDING SECTIONS**

Plot Scale / Echelle  
1 : 25

Drawn by/ Dessin par JA Date 2018-06-05

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Releve- Terrain par Date


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Checked by/ Verifie par AD Date 2018-07-25

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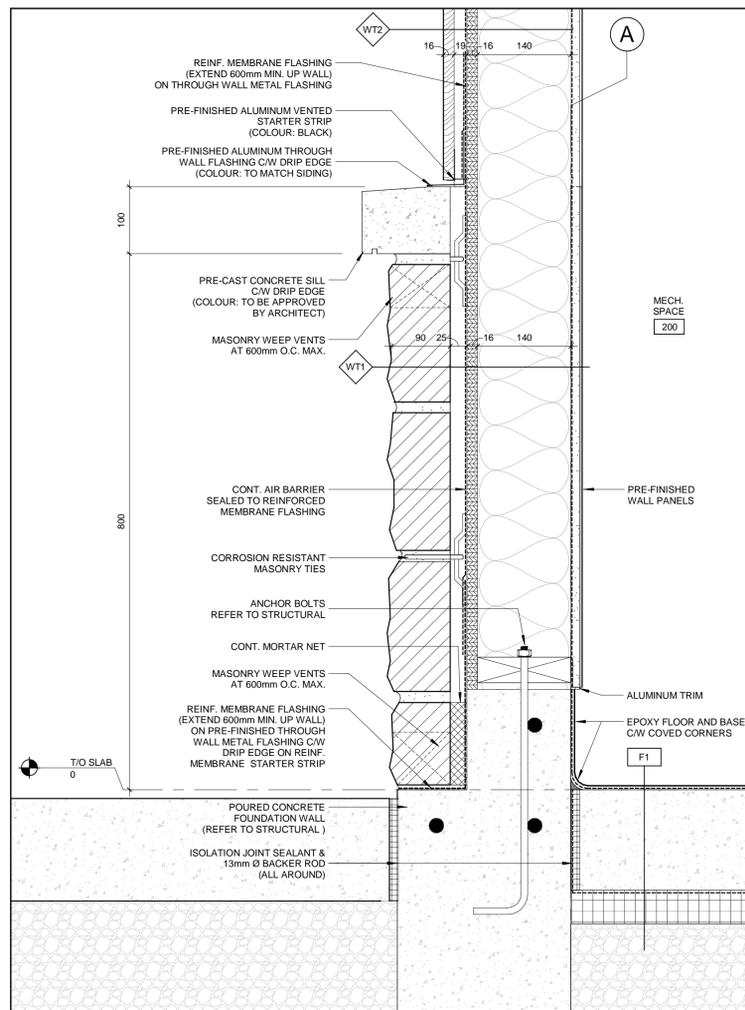
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A8




1 SECTION DETAIL - ROOF EAVE

AS AP 1:5

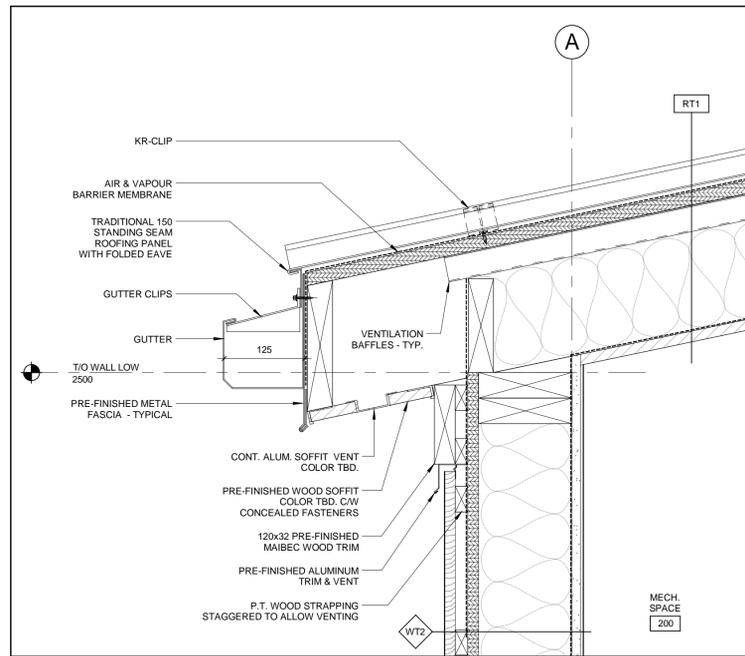


2 SECTION DETAIL - STONE BASE

AS AP 1:5

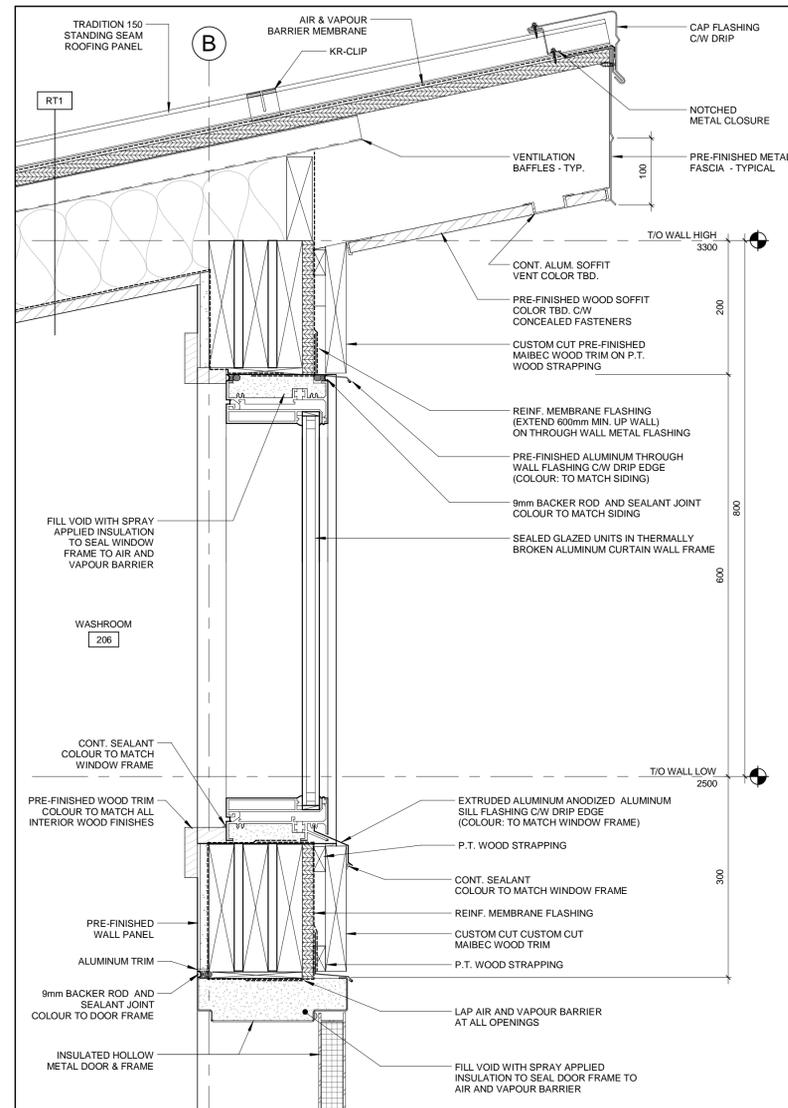


3 SECTION DETAIL - ROOF OVERHANG / WINDOW & DOOR HEAD

AS AP 1:5

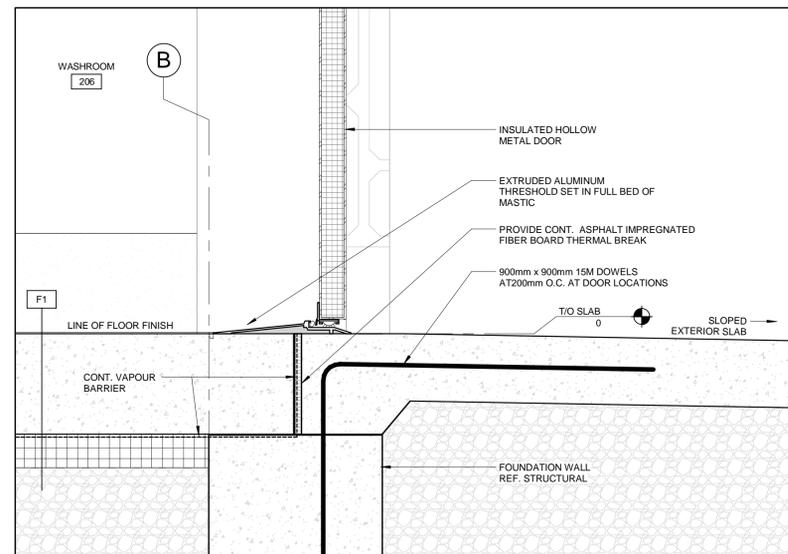


4 SECTION DETAIL - DOOR THRESHOLD

AS AP 1:5

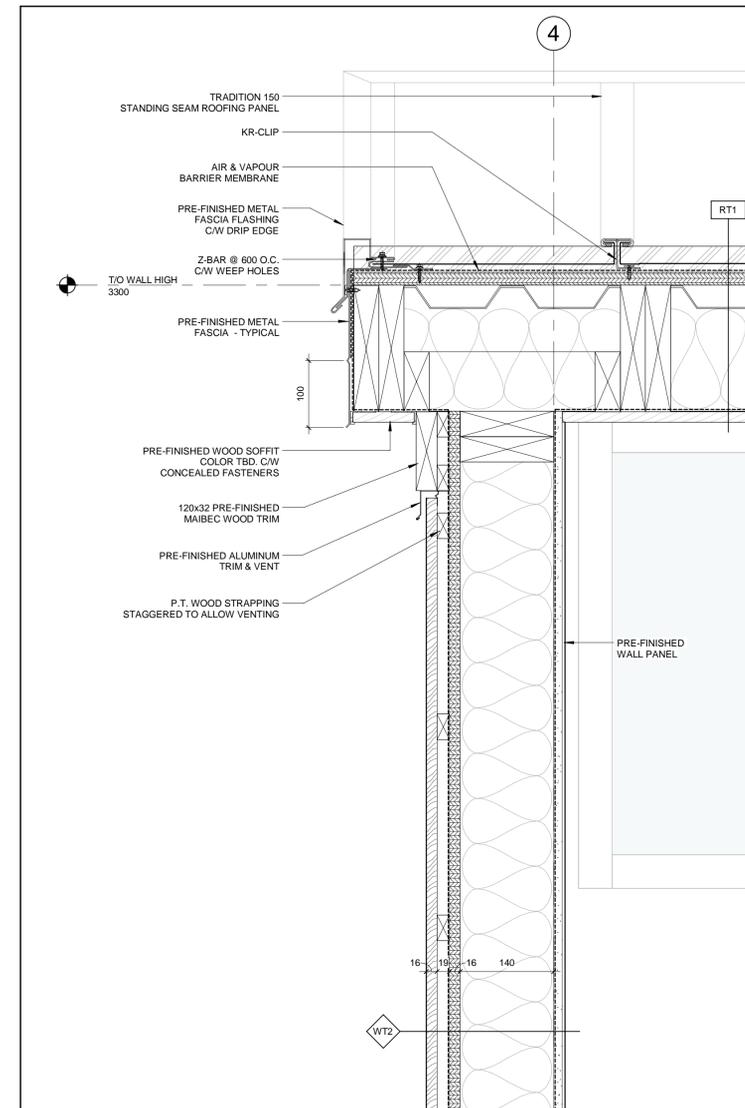

5 SECTION DETAIL - WALL / ROOF INTERSECTION

AS AP 1:5

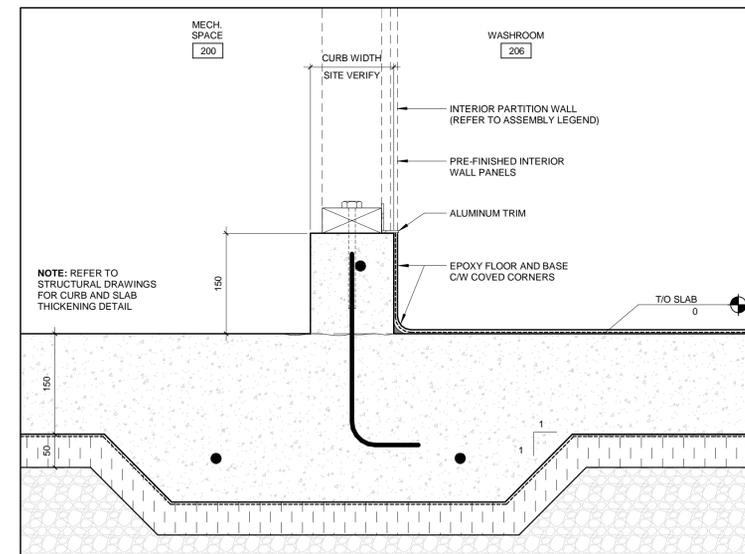

6 SECTION DETAIL - INTERIOR CURBS

AS AP 1:5

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LINEAR DIMENSIONS IN MILLIMETERS

Parcs Canada Parks Canada



Canada

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RENEWAL**

Drawing title / Titre du Dessin  
**SECTION DETAILS**

Plot Scale / Echelle  
1 : 5

Drawn by/ Dessin par  
JA Date  
2018-06-05

Field Recording by/  
Releve- Terrain par Date


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RT Date  
2018-07-25

Checked by/ Verifie par  
AD Date  
2018-07-25


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60576731 Feuille No.

Drawing Re No./No. du Dessin


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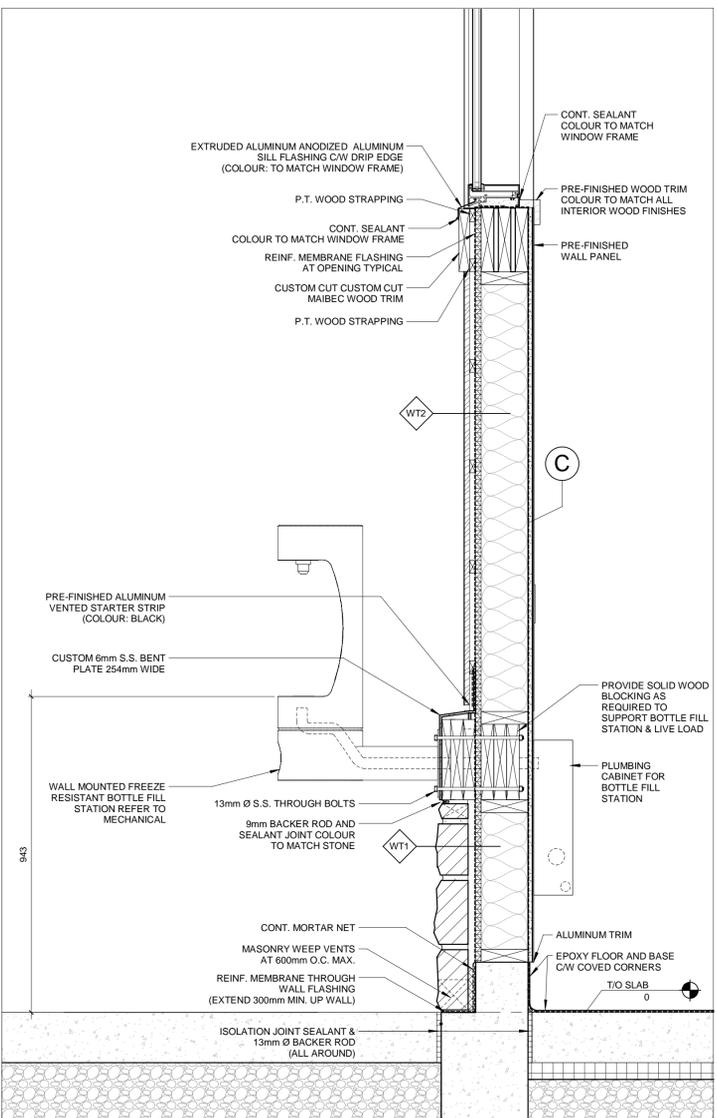
1 SECTION DETAIL - HEAD OF OVERHEAD DOOR  
AS/A10 1:5

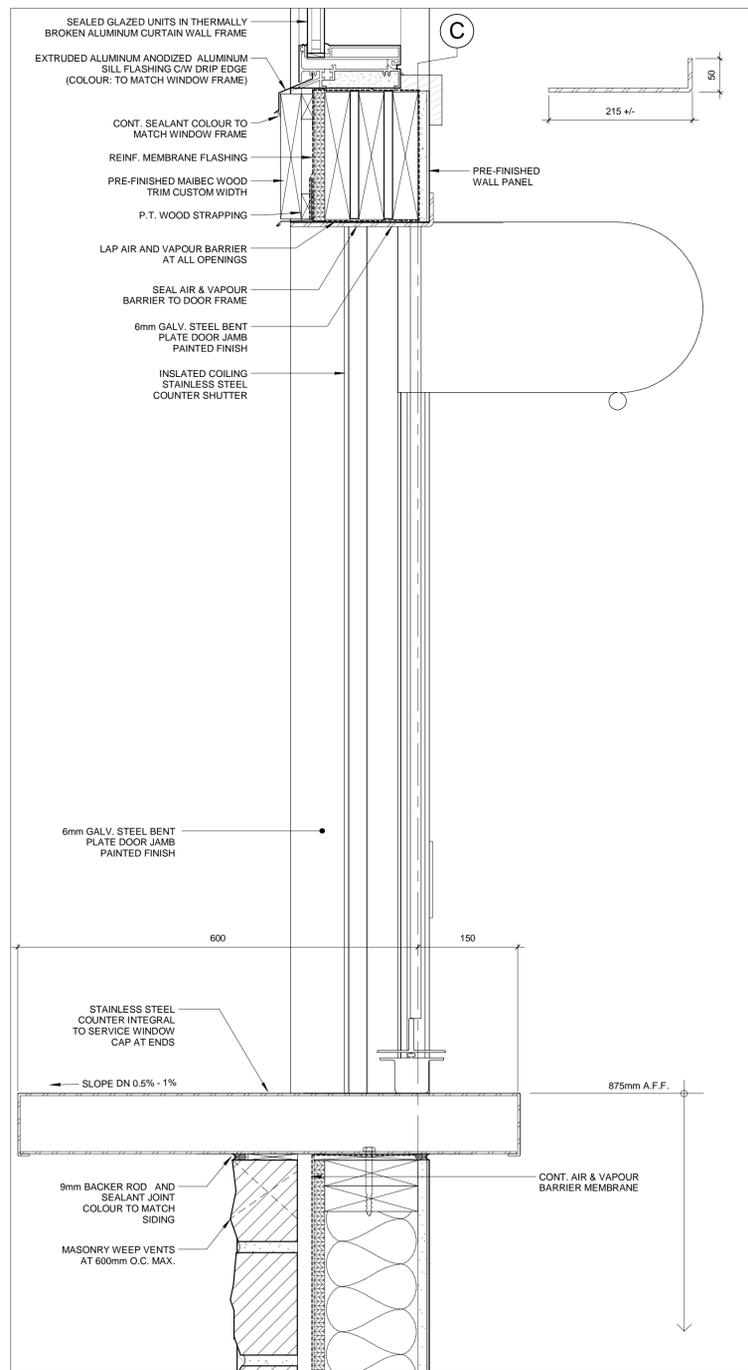

2 SECTION DETAIL - LOWER ROOF EAVE  
AS/A10 1:5

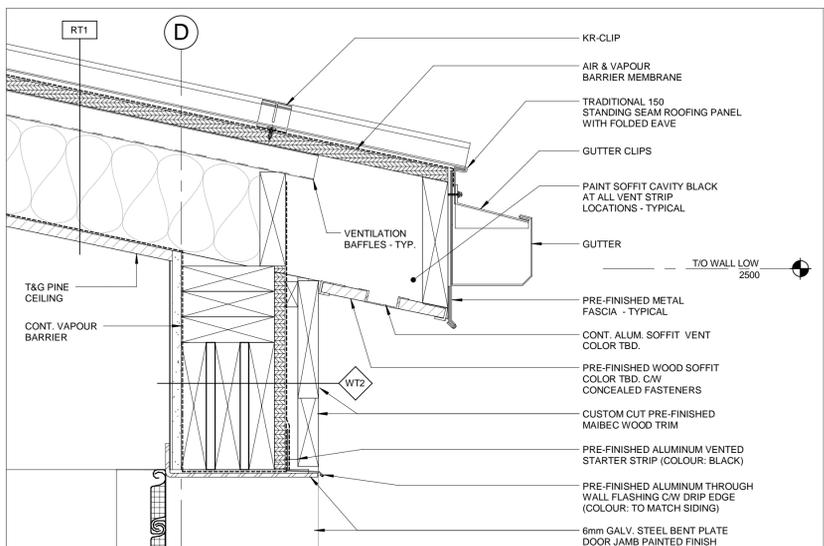

3 SECTION DETAIL - WALL / BASE CONNECTION  
AS/A10 1:5

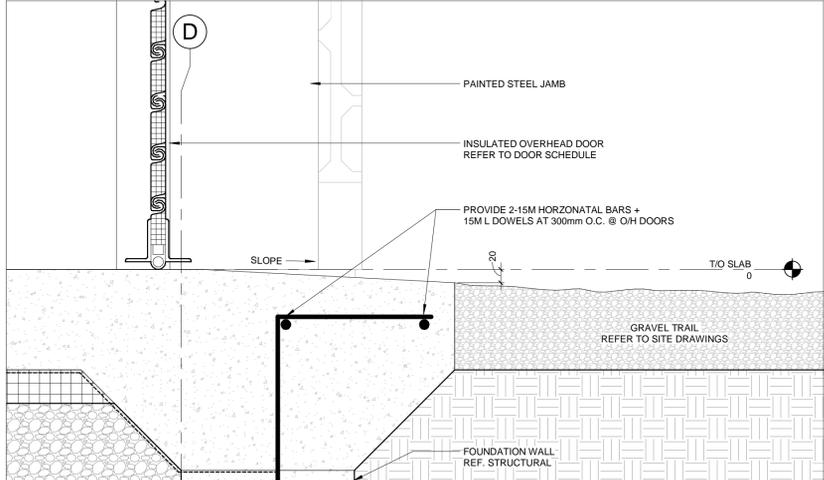

4 SECTION DETAIL - BOTTLE FILL STATION MOUNTING  
AS/A10 1:10

DRAWING NO.		DRAWING NAME	
REFERENCE DRAWINGS			
1	2018-08-16	ISSUED FOR TENDER	JA RT
NO.	DATE	DESCRIPTION	Drawn by/ Dessine par
			Approved / Approuve

REVISIONS			
A	A Detail Number	A Numero de Detail	
B	B Sheet Number	B Sur feuille Numero	

LINEAR DIMENSIONS IN MILLIMETERS      Dimensions lineaires en millimetres



**Canada**

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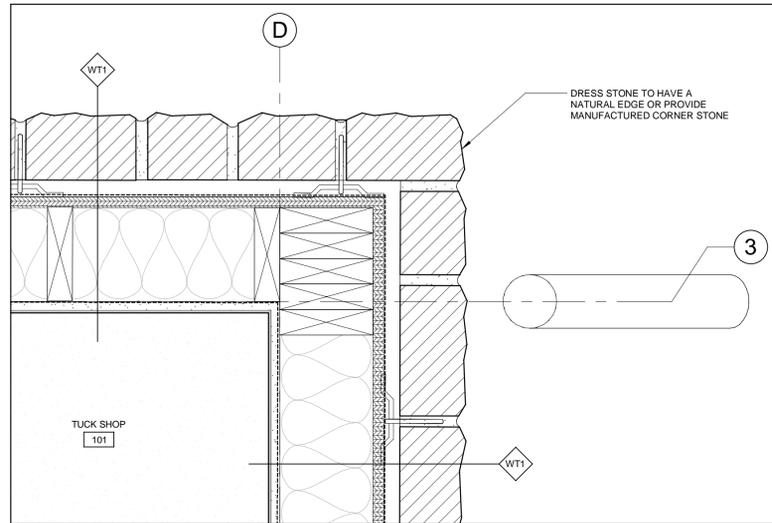
Type of Record /  
Type d'enregistrement

Project title / Titre du projet  
**CYPRUS LAKE - HEAD OF TRAILS RENEWAL**

Drawing title / Titre du Dessin  
**SECTION DETAILS**


Plot Scale / Echelle	
As indicated	
Drawn by/ Dessin par	Date
JA	2018-06-05
Field Recording by/ Relevé- Terrain par	Date
AD	
Approved by/ Approuve par	Date
RT	2018-07-25
Checked by/ Verifie par	Date
AD	2018-07-25

Project No./No. du projet	Asset No.	Sheet No./ Feuille No.
60576731		A10
Drawing Re No./No. du Dessin		




1 FLOOR PLAN - Callout 3

1:5

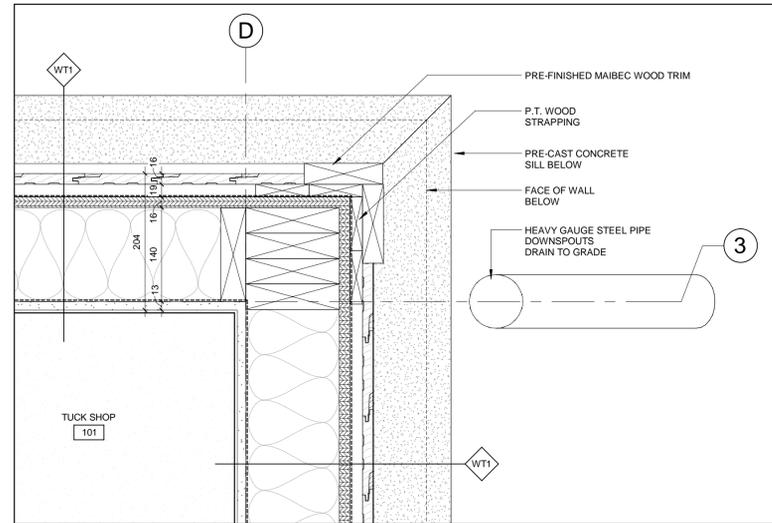


4 FLOOR PLAN - Callout 3 Copy 1

1:5

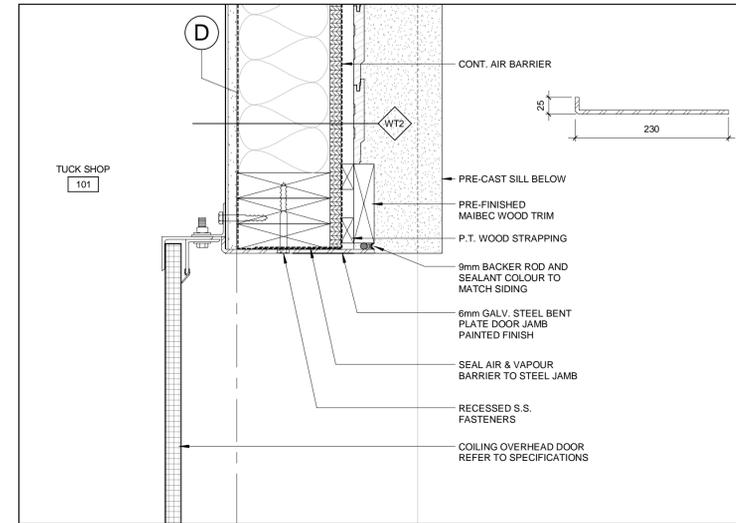


7 PLAN DETAIL - O/H DOOR JAMB & SERVICE SHUTTER JAMB

1:5

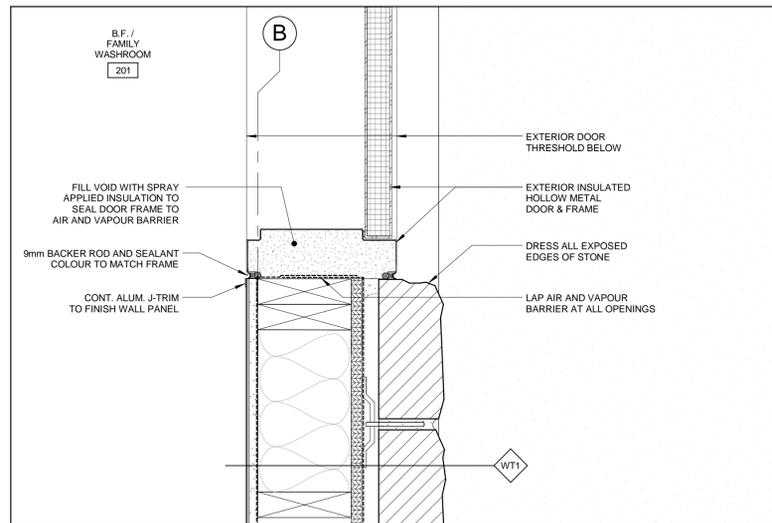


2 PLAN DETAIL - DOOR JAMB @ SIDING

1:5

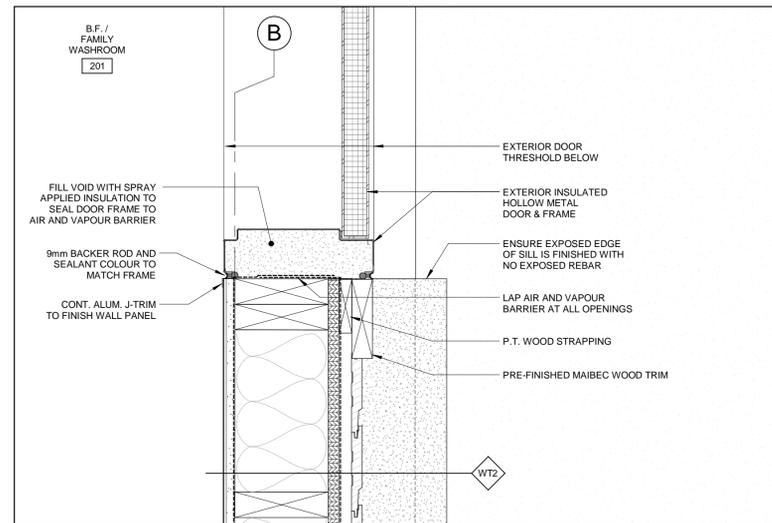


5 PLAN DETAIL - DOOR JAMB @ STONE

1:5

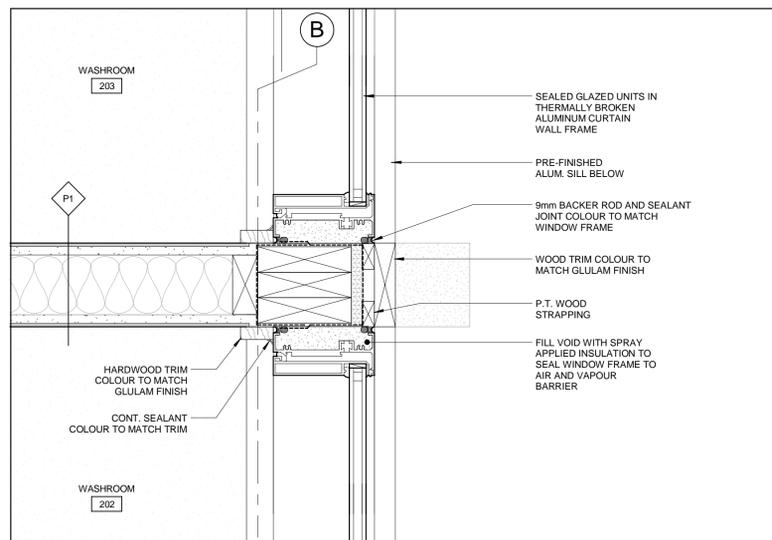

3 PLAN DETAIL - HIGH LEVEL WINDOW JAMB

1:5

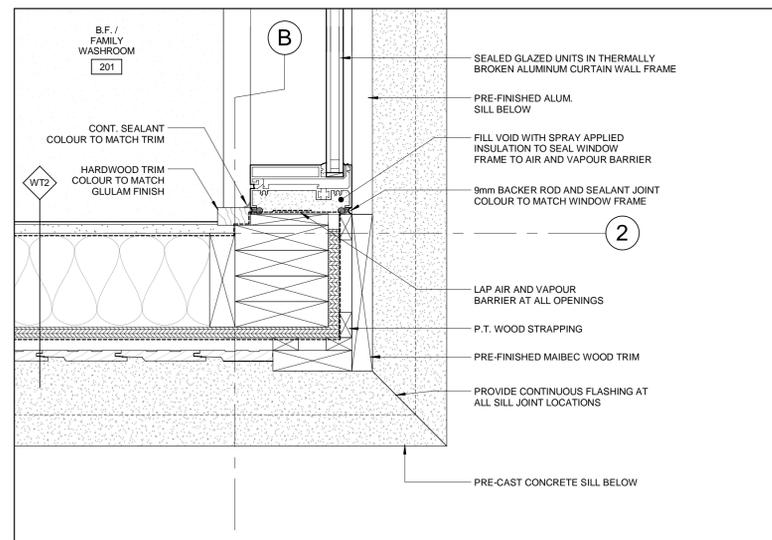

6 PLAN DETAIL - HIGH LEVEL WINDOW JAMB @ CORNER

1:5



DRAWING NO. DRAWING NAME

REFERENCE DRAWINGS

NO.	DATE	DESCRIPTION	Drawn By/ Dessine par	Approved/ Approuve
1	2018-08-16	ISSUED FOR TENDER		

REVISIONS				
NO.	DATE	DESCRIPTION	Drawn By/ Dessine par	Approved/ Approuve

REVISIONS

A	A Detail Number	A Numero de Detail
B	B Sheet Number	B Sur feuille Numero

LINEAR DIMENSIONS IN MILLIMETERS Dimensions lineaires en millimetres



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PARKS CANADA

Type of Record / Type d'enregistrement

Project title / Titre du projet  
**CYPRUS LAKE - HEAD OF TRAILS RENEWAL**

Drawing title / Titre du Dessin  
**PLAN DETAILS**

Plot Scale / Echelle  
1 : 5

Drawn by/ Dessin par  
JA Date  
2018-06-05

Field Recording by/ Relevé- Terrain par  
Date



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RT Date  
2018-07-25

Checked by/ Verifie par  
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2018-07-25


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60576731

Drawing Re No./No. du Dessin  
**A11**


**WASHROOM FIXTURE MOUNTING HEIGHTS**

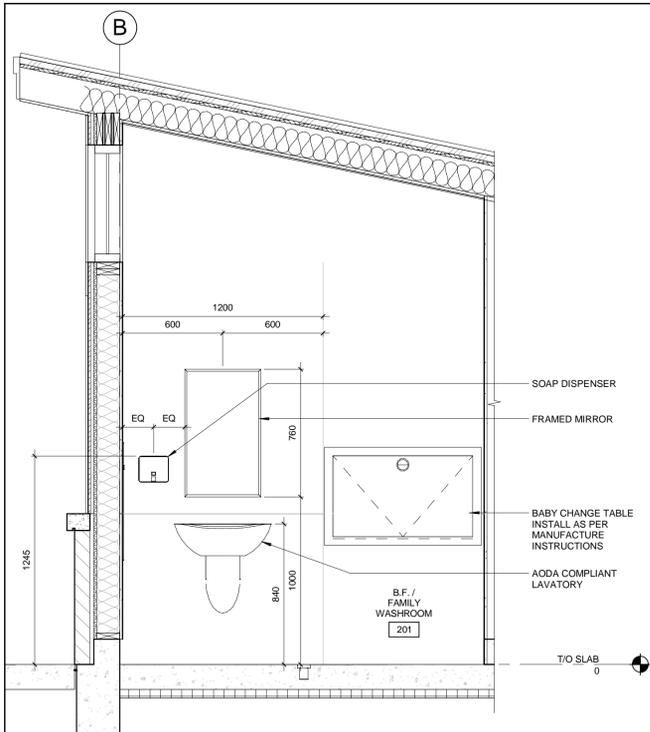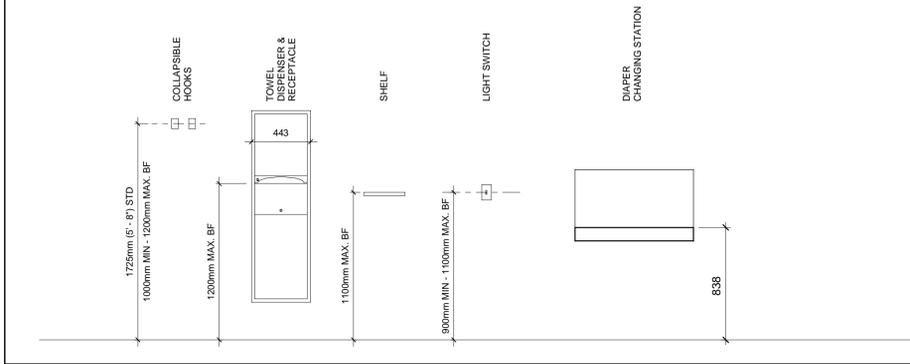


**1 INTERIOR ELEVATION - B.F. WASHROOM**  
A3/A12 1:20

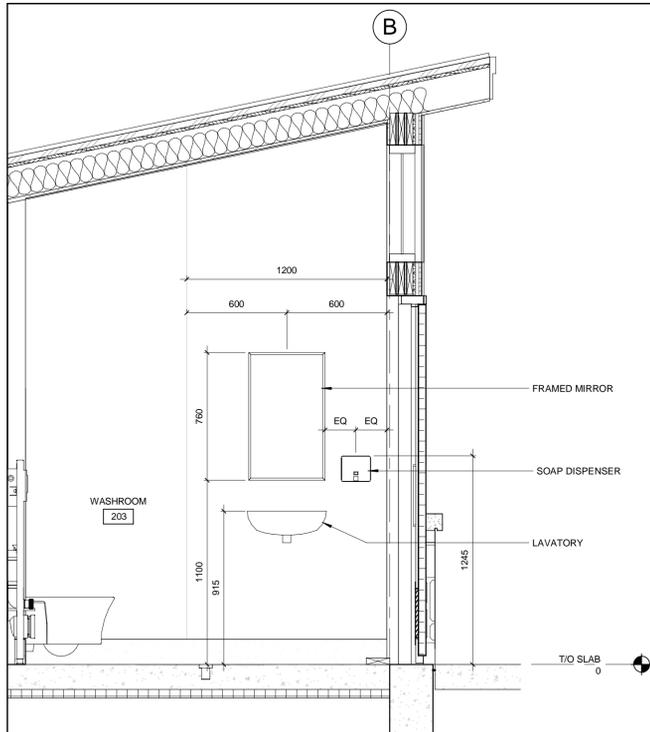


**2 INTERIOR ELEVATION - STANDARD WASHROOM**  
A3/A12 1:20

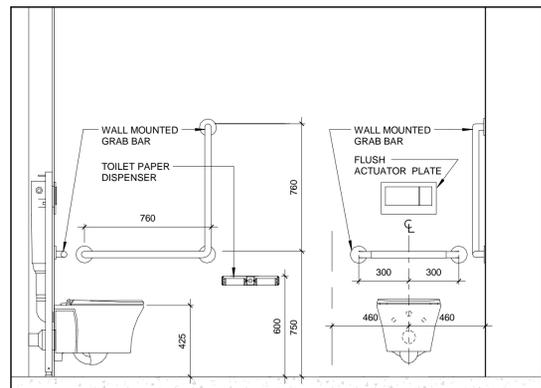


**3 TYPICAL B.F. TOILET**  
A12 1:20

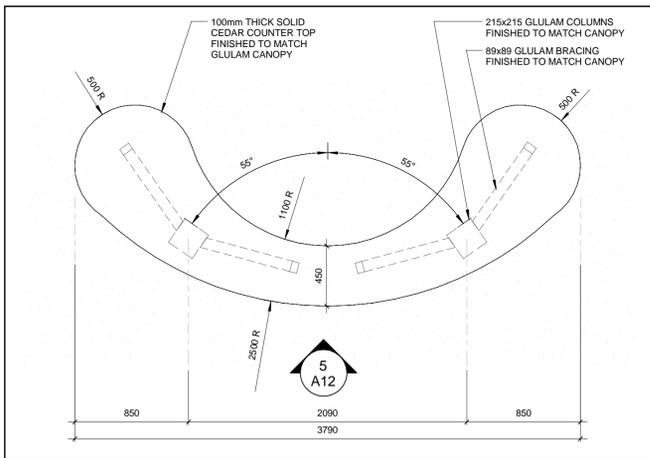

**4 PLAN - INFORMATION COUNTER**  
A3/A12 1:25

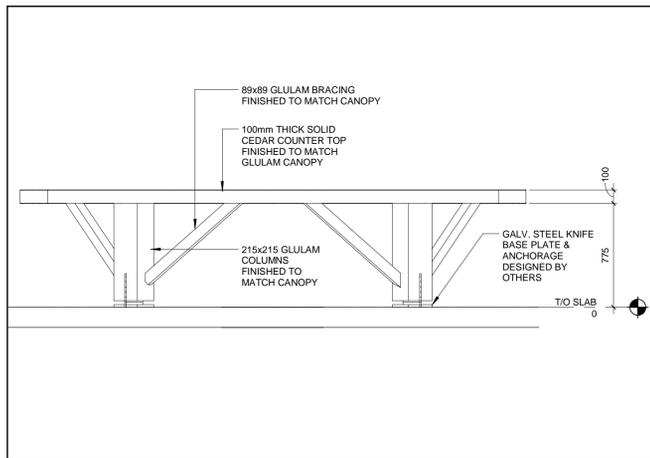

**5 ELEVATION - INFORMATION COUNTER**  
A12/A12 1:25

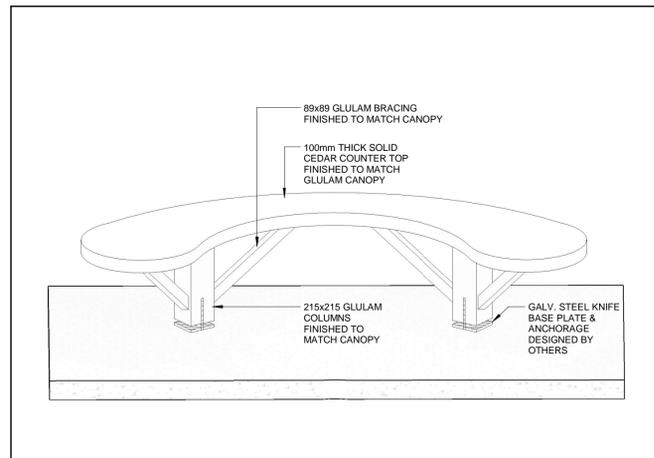

**6 ISO - INFORMATION COUNTER**  
A12 1:25

DRAWING NO.		DRAWING NAME	
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1	2018-08-16	ISSUED FOR TENDER	JA RT
NO.	DATE	DESCRIPTION	Drawn by/ Dessine par / Approuve

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LINEAR DIMENSIONS IN MILLIMETERS / Dimensions lineaires en millimetres

Parcs Canada / Parks Canada

**Canada**

PARKS CANADA

Type of Record / Type d'enregistrement

Project title / Titre du projet  
**CYPRUS LAKE - HEAD OF TRAILS RENEWAL**

Drawing title / Titre du Dessin  
**INTERIOR ELEVATIONS & MILLWORK DETAILS**

Plot Scale / Echelle		As indicated	
Drawn by/ Dessin par	JA	Date	2018-06-05
Field Recording by/ Relevé-Termin par	AD	Date	
Approved by/ Approuve par	RT	Date	2018-07-25
Checked by/ Verifie par	AD	Date	2018-07-25

Project No./No. du projet	Asset No.	Sheet No./ Feuille No.
60576731		<b>A12</b>
Drawing Re No./No. du Dessin		

MARK	LEAF		FRAME		HARDWARE								COMMENTS				
	LEAF WIDTH	LEAF HEIGHT	LEAF TYPE	LEAF MATERIAL	FRAME TYPE	FRAME MATERIAL	FINISH	INSULATED	WEATHER STRIPING	THRESHOLD	DOOR SWEEP	PUSH/PULL		LOCK SET / KEY PAD	SELF CLOSURE	DEADBOLT	DOOR STOP
D101	1050	2150	A	INSUL.HM	PAINTED	1	HM	PAINTED	*	*	*	*	*	*	*	*	
D101A	2400	2200	B	INSUL.HM	PRE-FIN	-	PRE-FIN	PRE-FIN	*	*	*	*	*	*	*	*	ALL HARDWARE BY DOOR /SHUTTER SUPPLIER.
D101B	2400	2200	B	INSUL.HM	PRE-FIN	-	PRE-FIN	PRE-FIN	*	*	*	*	*	*	*	*	ALL HARDWARE BY DOOR /SHUTTER SUPPLIER.
D101C	2000	1300	B	S.S.	S.S.	-	S.S.	S.S.	*	*	*	*	*	*	*	*	ALL HARDWARE BY DOOR /SHUTTER SUPPLIER.
D102	910	2150	A	INSUL.HM	PAINTED	1	HM	PAINTED	*	*	*	*	*	*	*	*	
D103	2-910	2150	A	INSUL.HM	PAINTED	1	HM	PAINTED	*	*	*	*	*	*	*	*	PROVIDE TWO DOOR GRILLES IN EACH DOOR, ONE HIGH LEVEL & ONE LOW LEVEL.
D200	910	2150	A	INSUL.HM	PAINTED	1	HM	PAINTED	*	*	*	*	*	*	*	*	
D201	910	2150	A	INSUL.HM	PAINTED	1	HM	PAINTED	*	*	*	*	*	*	*	*	DEADBOLT TO DISPLAY "IN USE" WHEN LOCKED AND "VACANT" WHEN UNLOCKED.
D202	750	2150	A	INSUL.HM	PAINTED	1	HM	PAINTED	*	*	*	*	*	*	*	*	DEADBOLT TO DISPLAY "IN USE" WHEN LOCKED AND "VACANT" WHEN UNLOCKED.
D203	750	2150	A	INSUL.HM	PAINTED	1	HM	PAINTED	*	*	*	*	*	*	*	*	DEADBOLT TO DISPLAY "IN USE" WHEN LOCKED AND "VACANT" WHEN UNLOCKED.
D204	750	2150	A	INSUL.HM	PAINTED	1	HM	PAINTED	*	*	*	*	*	*	*	*	DEADBOLT TO DISPLAY "IN USE" WHEN LOCKED AND "VACANT" WHEN UNLOCKED.
D205	750	2150	A	INSUL.HM	PAINTED	1	HM	PAINTED	*	*	*	*	*	*	*	*	DEADBOLT TO DISPLAY "IN USE" WHEN LOCKED AND "VACANT" WHEN UNLOCKED.
D206	750	2150	A	INSUL.HM	PAINTED	1	HM	PAINTED	*	*	*	*	*	*	*	*	DEADBOLT TO DISPLAY "IN USE" WHEN LOCKED AND "VACANT" WHEN UNLOCKED.
D207	750	2150	A	INSUL.HM	PAINTED	1	HM	PAINTED	*	*	*	*	*	*	*	*	DEADBOLT TO DISPLAY "IN USE" WHEN LOCKED AND "VACANT" WHEN UNLOCKED.
D208	910	2150	A	INSUL.HM	PAINTED	1	HM	PAINTED	*	*	*	*	*	*	*	*	DEADBOLT TO DISPLAY "IN USE" WHEN LOCKED AND "VACANT" WHEN UNLOCKED.

**DOOR SCHEDULE ABBREVIATIONS**


- D.S. - DOOR SCHEDULE \* ALL HARDWARE TO BE B-F LEVER TYPE
- PRE-FIN - PRE-FINISHED METAL
- TG. - TEMPERED GLASS
- H.M. - HOLLOW METAL
- INSUL.H.M. - INSULATED HOLLOW METAL
- PAINT - PAINTED
- BSP - BENT STEEL PLATE
- ROD - ROLL-UP COVERHEAD DOOR
- ALUM. - ALUMINUM
- ANOD. - ANODIZED
- PRE FIN. - PRE-FINISHED
- S.C. - SOLID WOOD CORE
- WD - WOOD
- ST - STAINED
- H.C. - HOLLOW WOOD CORE

**LEGEND**


◻ LAMICOID INDENT. SIGN

**DOOR ELEVATIONS**

- NOTE: - COORDINATE WITH MECHANICAL DOOR TRANSFER GRILLES
- COORDINATE DOOR AND FRAME ELEVATIONS WITH DOOR SCHEDULE
- PROVIDE WALL MOUNTED STAINLESS STEEL DOOR STOPS - TYPICAL FOR ALL DOORS

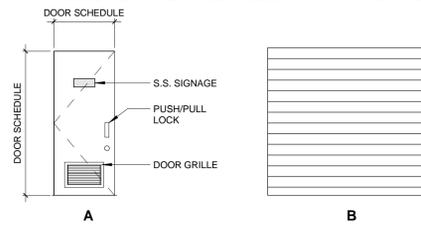

**FRAME ELEVATIONS**

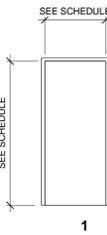


**WINDOW SCHEDULE ABBREVIATIONS**

GL. CLEAR INSULATED GLAZING PANEL

**NOTE**

- 1) ALL WINDOW SCREEN ELEVATIONS INDICATE FINISHED DIMENSIONS.
- 2) PROVIDE NECESSARY ROUGH OPENING DIMENSIONS IN SHOP DRAWING PACKAGE TO BE REVIEWED AND APPROVED BY CONSULTANT.
- 4) ALL WINDOWS SET IN INSULATED THERMALLY BROKEN ALUMINUM FRAMES.
- 5) OPERATE WINDOWS TO INCLUDE INSECT SCREENS.

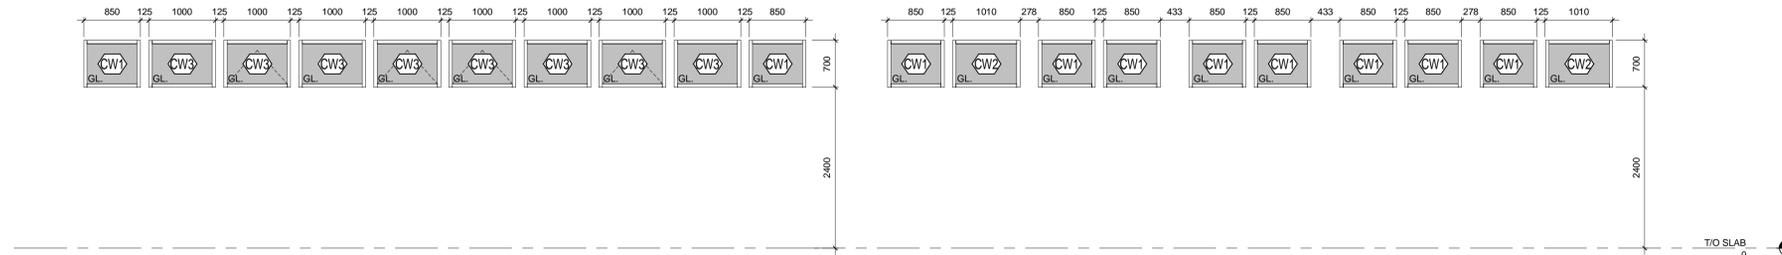


DRAWING NO. DRAWING NAME

**REFERENCE DRAWINGS**


1	2018-08-16	ISSUED FOR TENDER	JA	RT
NO.	DATE	DESCRIPTION	Drawn by/ Dessine par	Approved / Approuve

**REVISIONS**

A	A Detail Number	A Numero de Detail
B	B Sheet Number	B Sur feuille Numero

LINEAR DIMENSIONS IN MILLIMETERS Dimensions lineaires en millimetres



**Canada**

PARKS CANADA

Type of Record / Type d'enregistrement

Project title / Titre du projet  
**CYPRUS LAKE - HEAD OF TRAILS RENEWAL**

Drawing title / Titre du Dessin  
**DOOR & WINDOW SCHEDULE**

Plot Scale / Echelle  
1 : 50

Drawn by/ Dessin par JA Date 2018-06-05

Field Recording by/ Relevé- Terrain par Date

Approved by/ Approuve par RT Date 2018-07-25

Checked by/ Verifie par AD Date 2018-07-25

Project No./No. du projet 60576731 Asset No. Sheet No./ Feuille No.

Drawing Re No./No. du Dessin **A13**

**GENERAL NOTES:**

- THESE DRAWINGS SHALL BE READ IN CONJUNCTION WITH THE ARCHITECTURAL, MECHANICAL, ELECTRICAL, CIVIL, AND OTHER PROJECT DRAWINGS.
- ALL MATERIALS AND WORKMANSHIP SHALL BE IN ACCORDANCE WITH THE MOST STRINGENT REQUIREMENTS OF: THE 2015 NATIONAL BUILDING CODE, THE 2012 ONTARIO BUILDING CODE, AND STRUCTURAL COMMENTARIES (PART 4 OF THE NATIONAL BUILDING CODE), THE OCCUPATIONAL HEALTH AND SAFETY ACT (INCLUDING LATEST AMENDMENTS), AND REQUIREMENTS OF OTHER LOCAL AUTHORITIES HAVING JURISDICTION.
- ALL DIMENSIONS, ELEVATIONS, OPENINGS FOR PIPES, SLEEVES, EQUIPMENT LOCATIONS AND THE LIKE SHALL BE CHECKED WITH THE ARCHITECTURAL, MECHANICAL, ELECTRICAL, AND CIVIL DRAWINGS. REPORT ANY DISCREPANCIES TO THE CONSULTANT BEFORE PROCEEDING WITH THE WORK.
- PROVIDE ALL NECESSARY PROFESSIONAL ENGINEER CERTIFIED SHORING, SCAFFOLDING AND UNDERPINNING TO EXECUTE THE PROJECT SAFELY.
- MAKE GOOD ANY DAMAGES DONE DURING CONSTRUCTION.
- THE CONTRACTOR SHALL FAMILIARIZE HIMSELF WITH THE SITE CONDITIONS AND CHECK AND VERIFY THE LOCATION OF ANY UNDERGROUND UTILITIES OR OTHER EXISTING SERVICES WHICH MAY INTERFERE WITH THE WORK OF THIS PROJECT AND COORDINATE WITH THE OWNER, ENGINEER OR OTHER AUTHORITIES AS MAY BE REQUIRED FOR THEIR RELOCATION, REMOVAL, OR TEMPORARY SUPPORT. PROTECT EXISTING UNDERGROUND UTILITIES, AND OTHER EXISTING CONDUITS, PIPING OR UTILITY SERVICES DURING CONSTRUCTION. MAKE GOOD ANY DAMAGE RESULTING FROM WORK ON THIS PROJECT.
- THE CONTRACTOR SHALL SUPPLY, REMOVE AND TAKE RESPONSIBILITY FOR ALL TEMPORARY BRACING, EXCAVATION SUPPORT SYSTEM AND DEWATERING NECESSARY TO UNDERTAKE THE WORK.
- ALL ASPECTS OF WORK SCHEDULING, ACCESSIBILITY AND LOGISTICS SHALL BE COORDINATED AND AGREED WITH THE OWNER PRIOR TO COMMENCEMENT.
- DO NOT SCALE THESE DRAWINGS.
- OMITTED DIMENSIONS ON FRAMING PLANS AND ELEVATIONS SCHEMATICS INDICATE MEMBERS EQUALLY SPACED BETWEEN DEFINED LINES.

**EXCAVATION**

- IT IS REQUIRED THAT THE BUILDINGS HAVE 1.5m DEEP FROST PROTECTED FOUNDATION WALLS. IT IS NOTED THAT BEDROCK DEPTHS VARY THROUGHOUT THE SITE AND THAT EXCAVATION THRU THE BEDROCK WILL VARY DEPENDING ON THE SITE LOCATION. REFER TO THE GEOTECHNICAL REPORT FOR APPROXIMATE DEPTHS.
- FOLLOW THE EXCAVATION DIAGRAM FOR EXCAVATION DEPTHS.

**CONSTRUCTION**

- FORMWORK SHALL CONFORM TO THE REQUIREMENTS OF C.S.A. SPECIFICATION A23M AND A.C.I. SP-4.
- FORMWORK SHALL BE DESIGNED BY A REGISTERED PROFESSIONAL ENGINEER OF THE PROVINCE OF ONTARIO, TO WITHSTAND ALL SUPERIMPOSED LOADS DURING CONSTRUCTION.
- SHORING, RE-SHORING, AND CONSTRUCTION LOADS SHALL BE CONTROLLED TO ENSURE THAT NO STRUCTURAL ELEMENT IS OVERSTRESSED.
- MAKE NECESSARY ALLOWANCE FOR FORMWORK CREEP AND DEFLECTION AND ADJUST ACCORDINGLY TO ACHIEVE THE ELEVATION FOR THE COMPLETION OF THE JOB.
- CONSTRUCTION JOINTS SHALL BE MADE AND LOCATED SO AS NOT TO IMPAIR THE STRENGTH OF THE STRUCTURE.
- THE CONTRACTOR SHALL MAKE NECESSARY ALLOWANCE FOR ANY VARIATION AND/OR ANY REVISIONS MADE ON ACCOUNT OF SUB-TRADES AND PRODUCT SELECTION FOR THE COMPLETION OF THE PROJECT.

**FOUNDATIONS**

- ALL PERTAINING SOILS INFORMATION AS PER GEOTECHNICAL REPORT BY GM BLUE PLAN ENGINEERING LIMITED, No. 217291, DATED OCTOBER 2017 (AND SUBSEQUENT REVISIONS), SHALL BE USED.
- ALL EXTERIOR FOOTINGS SHALL BE CARRIED DOWN AT LEAST 1500mm BELOW FINISHED GRADE FOR FROST PROTECTION UNLESS NOTED OTHERWISE.
- PROTECT FOUNDATIONS, WALLS, SLABS ON GRADE, GRADE BEAMS, FOOTINGS AND ADJACENT SOIL AGAINST FREEZING AND FROST ACTION AT ALL TIMES DURING CONSTRUCTION.
- ALL FOOTINGS SHALL BE PLACED ON COMPETENT BEARING STRATA, AS DESCRIBED BELOW, HAVING A MINIMUM GEOTECHNICAL BEARING RESISTANCE OF 150 kPa AT THE SERVICEABILITY LIMIT STATES (SLS) AND 210 kPa AT THE ULTIMATE LIMIT STATES (ULS), AND MUST BE INSPECTED, REVIEWED, AND APPROVED BY THE GEOTECHNICAL ENGINEER BEFORE PLACING FOOTINGS.
  - TO AVOID DIFFERENTIAL SETTLEMENTS, THE FOOTINGS FOR ANY ONE BUILDING MUST BEAR ON THE SAME STRATA AS FOLLOWS: EITHER COMPETENT BEDROCK, OR COMPETENT CLAYEY SILT TILL.
  - IF THE BEDROCK IS NOT EXPOSED DURING THE EXCAVATION, FOOTINGS MAY BEAR DIRECTLY ON THE COMPETENT CLAYEY SILT TILL AT THE SPECIFIED DEPTHS.
  - SHOULD BEDROCK BE EXPOSED DURING THE EXCAVATION, THE BEDROCK IS TO BE EXCAVATED IN ACCORDANCE WITH THE EXCAVATION DIAGRAM. IF IT IS DETERMINED THAT ALL THE FOOTINGS CAN BEAR ON THE COMPETENT BEDROCK AT THE SPECIFIED DEPTHS, ALL THE FOOTINGS SHALL BEAR DIRECTLY ON THE BEDROCK. IF IT IS DETERMINED THAT NOT ALL THE FOOTINGS CAN BEAR ON BEDROCK, A 150mm LAYER OF COMPACTED GRANULAR 'A' SHALL BE INSTALLED ABOVE THE BEDROCK TO ENSURE ALL THE FOOTINGS ARE ON THE NATIVE COMPETENT TILL (OR EQUIVALENT ENGINEERED FILL).
- ENGINEERED STRUCTURAL FILL SHALL BE USED AS BACK-FILL AGAINST THE FOUNDATION WALLS, PIERS AND TO REPLACE THE EXISTING FILL UNDERNEATH THE FLOOR SLAB. ENGINEERED STRUCTURAL FILL SHOULD COMPRISE OF APPROVED IMPORTED FREE-DRAINING OPSS PROV GRANULAR 'B' PLACED IN 200mm LAYERS AND COMPACTED TO 100% SPMD TO THE PROPOSED SUB-GRADE ELEVATIONS.
- DO NOT BACKFILL AGAINST WALLS RETAINING EARTH UNTIL ELEMENTS PROVIDING LATERAL SUPPORT ARE COMPLETED. PLACE BACKFILL SIMULTANEOUSLY ON BOTH SIDES OF WALLS BELOW GRADE.
- WHERE ANY EXISTING FILL OR OBSTRUCTION IS ENCOUNTERED, THE FOOTING SHALL STEP DOWN TO COMPETENT FOUNDING SOIL AT A SLOPE OF 10 HORIZONTAL TO 7 VERTICAL.
- ALL COLUMNS, PIERS AND WALL FOOTINGS SHALL BE CENTERED ON THE COLUMN, PIER OR WALL RESPECTIVELY UNLESS NOTED.
- REFER TO ARCHITECTURAL, ELECTRICAL, MECHANICAL, AND CIVIL DRAWINGS FOR DIMENSIONS, ELEVATIONS, DETAILS AND LOCATIONS OF SLAB DEPRESSIONS, SLOPES, TRENCHES, ETC.
- PROVIDE A 20mm CHAMFER AT EXPOSED CORNERS.
- PROVIDE TEMPORARY SHORING, ETC., ADEQUATE TO SUPPORT EXISTING STRUCTURES DURING CONSTRUCTION.
- REMOVAL ALL TOP SOIL, ORGANIC AND LOOSE MATERIAL FROM THE BUILDING ADDITION ENVELOPE AS DIRECTED BY GEOTECHNICAL ENGINEER.

**CONCRETE**

- CONCRETE CONSTRUCTION SHALL CONFORM TO ALL C.S.A. A23 SERIES STANDARDS.
- MINIMUM CONCRETE STRENGTH AFTER 28 DAYS SHALL BE AS FOLLOWS:

TYPE	STRENGTH	CLASS OF EXPOSURE
LEAN CONCRETE FILL, MUD SLAB	10 MPa	N
FOOTINGS	20 MPa	N
PIERS, FOUNDATION WALLS	25 MPa	F-2
INTERIOR SLAB ON GRADE	25 MPa	N
EXTERIOR SLAB ON GRADE	32 MPa	C-2

- REINFORCING STEEL SHALL BE PROPERLY SUPPORTED WITH WIRE BAR SUPPORTS. MINIMUM CONCRETE COVER TO REINFORCING BARS:

EXPOSURE CONDITION	N	F-2	C-2
CAST AGAINST AND PERMANENTLY EXPOSED TO EARTH	75mm	75mm	75mm
FORMED SIDES OF WALLS	40mm	40mm	40mm
TOP SURFACE OF SLABS	50mm	50mm	50mm
RATIO OF COVER TO NOMINAL BAR DIAMETER	1.0	1.5	2.0
RATIO OF COVER TO NOMINAL MAXIMUM AGGREGATE SIZE	1.0	1.5	2.0

- USE PORTLAND TYPE GU FOR ALL CONCRETE UNLESS NOTED OTHERWISE.
- JOINT CHAMFER: ALL FLUSH CONCRETE SURFACES MEETING AT JOINTS IN VISIBLE LOCATIONS SHALL BE FORMED WITH A 'V' SHAPED REGLET AT FACE (20mm DEEP).
- FILL AND REFINISH ALL VOIDS, FORM-WIRE LOCATIONS ETC.
- BONDING AGENT FOR POURING NEW CONCRETE AGAINST EXISTING, APPLY THE EPOXY BONDING ADHESIVE TO EXPOSED EXISTING SURFACES IN STRICT ACCORDANCE WITH THE MANUFACTURER'S SPECIFICATIONS. USE SIKADUR 32 HI-MOD BY SIKA OR ENGINEER APPROVED EQUAL.
- DOWELLING INTO EXISTING CONCRETE: FOR DOWELLING REINFORCING STEEL BARS INTO THE EXISTING CONCRETE, DRILL AND PREPARE A CONCRETE HOLE, 3mm LARGER THAN THE BAR DIAMETER. SET THE BAR INTO THE SPECIFIED HOLE USING THE EPOXY BONDING ADHESIVE IN STRICT ACCORDANCE WITH THE MANUFACTURER'S SPECIFICATIONS. USE HIT HY 200 ADHESIVE BY HILTI OR ENGINEER APPROVED EQUAL.

**REINFORCING STEEL**

- ALL REINFORCING STEEL SHALL BE IN ACCORDANCE WITH C.S.A. G30.18M - GRADE 400.
- REINFORCING BARS SHALL BE CONTINUOUS ACROSS CONSTRUCTION JOINTS AND ELEVATION VARIATIONS UNLESS NOTED. CONTINUOUS BARS SHALL BE FULLY DEVELOPED BY LAPPING WHERE SPLICED.
- DETAIL, BEND, PLACE, AND SUPPORT REINFORCING STEEL IN CONFORMANCE WITH RS10 MANUAL OF STANDARD PRACTICE UNLESS NOTED OTHERWISE.

**SLAB-ON-GRADE**

- SEE PLAN FOR SLAB THICKNESS.
- SLAB ON GRADE SHALL BE PLACED ON 150mm BASE COURSE OF GRANULAR 'A' BACKFILLED AS PER OPSS PROV 1010 COMPACTED TO 100% SPMD MINIMUM. ALL INFILLING BELOW THE GRANULAR 'A' SHALL BE WELL GRADED FREE DRAINING GRANULAR 'B' TYPE 1 BACKFILL AS PER OPSS PROV 1010 COMPACTED TO A MINIMUM OF 100% SPMD. ALL ENGINEERED FILL MUST BE INSPECTED, APPROVED AND COMPACTION VERIFIED BY THE GEOTECHNICAL ENGINEER.
- PRIOR TO PLACING GRANULAR FILL MATERIALS, PROOF-ROLL EXISTING SUB-GRADE TO IDENTIFY INCONSISTENCIES OR SOFT AREAS. PROCEED WITH GRANULAR PLACEMENT ONLY AFTER THESE AREAS HAVE BEEN RE-WORKED AND COMPACTED TO THE SATISFACTION OF THE GEOTECHNICAL ENGINEER.
- DO NOT POUR CONCRETE UNTIL ALL ELECTRICAL AND MECHANICAL CONDUITS, PIPING OR OTHER EMBEDDED SERVICES ARE INSTALLED, AND VERIFIED.
- MAINTAIN SLAB THICKNESS INDICATED ON THE DRAWINGS IN ALL CASES.
- AGREE TO LOCATIONS OF CONSTRUCTION JOINTS WITH ENGINEER PRIOR TO CONSTRUCTION.
- PROVIDE SAW-CUT CONTROL JOINTS OF 30 x 1 ft (t = SLAB THICKNESS) MAXIMUM SPACING (FOR JOINTED FLOORS) UNLESS NOTED OTHERWISE.
- PERFORM SAW-CUTTING FOR CONTROL JOINTS USING DRY METHOD (SOFT-CUT SAW) AS SOON AS POSSIBLE AFTER CONCRETE PLACEMENT WITHOUT LEAVING TREAD MARKS, DISLODGING AGGREGATE AND BEFORE UNCONTROLLED SHRINKAGE OCCURS. FILL CONTROL JOINTS, AS SPECIFIED, NO SOONER THEN 120 DAYS AFTER CONCRETE POUR.
- PROVIDE SLAB ON GRADE THICKENING TO SUIT ANY ANCHORS OR INSERTS AS REQUIRED, UNLESS NOTED.
- FOR CONCRETE FINISH, THE EXTERIOR SLAB-ON-GRADE SHALL RECEIVE A TROWEL 'SWIRL' FINISH (TEXTURE), TO PROVIDE A GOOD NON-SLIP SURFACE.
- FOR THE INTERIOR SLAB-ON-GRADE CONCRETE FINISH, REFER TO THE ARCHITECTURAL SPECIFICATIONS.
- SEALER FOR THE CONCRETE SLAB SHALL BE AN EXTERIOR APPLICATION, ULTRAVIOLET RESISTANT, SEALER, USE 'SUPER DIAMOND CLEAR' BY EUCLID, OR EQUIVALENT AS APPROVED BY THE ENGINEER.

**STRUCTURAL STEEL**

- THE CONTRACTOR SHALL FIELD CHECK AND VERIFY ALL CONDITIONS AND MEASUREMENTS AT THE SITE AND REPORT TO THE CONSULTANT ANY DISCREPANCIES OR UNSATISFACTORY CONDITIONS WHICH MAY ADVERSELY AFFECT THE PROPER COMPLETION OF THE WORK BEFORE PROCEEDING WITH THE WORK.
- ALL SHOP CONNECTIONS SHALL BE WELDED. ALL FIELD CONNECTIONS SHALL BE WELDED OR BOLTED USING HIGH TENSILE BOLTS. BEARING TYPE CONNECTIONS SHALL BE C.I.S.C. DOUBLE ANGLE BEAM CONNECTIONS OR SHEAR PLATES USING A325 BOLTS AND E49XX FILLET WELDS, MINIMUM SIZE OF BOLTS = 20mm DIAMETER. THEY SHALL BE CAPABLE OF SUPPORTING 50% OF THE TOTAL UNIFORM LOAD CAPACITY CALCULATED USING UNIFORM LOAD CONSTANTS FOR BEAMS LATERALLY SUPPORTED EXCEPT WHERE SPECIFICALLY NOTED OR DETAILED.
- FOR LOCATIONS OF DOOR FRAMES, WALL OPENINGS, AND ROOF OPENINGS, ETC. AND RELATED DETAILS, SEE ARCHITECTURAL, MECHANICAL, AND ELECTRICAL DRAWINGS.
- THE MINIMUM END CONNECTION OF ANY MEMBER SHALL BE MADE WITH TWO(2) A325 BOLTS OR EQUIVALENT WELD.
- ALL STRUCTURAL STEEL SHALL BE IN ACCORDANCE WITH CSA G40.21M GRADE 300W UNLESS NOTED OTHERWISE.
- ALL STRUCTURAL STEEL 'W' SHAPES SHALL CONFORM TO CSA G40.21M GRADE 350W.
- ALL HOLLOW STRUCTURAL STEEL SECTIONS SHALL CONFORM TO CSA G40.21M GRADE 350W - CLASS H.
- FABRICATION, ERECTION AND WORKMANSHIP SHALL CONFORM TO CAN/CSA S16-01.
- ALL WELDING SHALL CONFORM TO CSA S16-01 AND THE LATEST VERSION OF W59 AND SHALL BE PERFORMED BY A WELDER QUALIFIED UNDER THE LATEST VERSION OF CSA W47.
- WELDING ELECTRODES SHALL BE E49XX.
- SURFACES TO BE WELDED SHALL BE THOROUGHLY CLEANED OF ALL FOREIGN MATTER INCLUDING PAINT FILM.
- ALL JOINTS SHALL BE WELDED USING E49XX ELECTRODES OR BEARING TYPE CONNECTIONS USING M20 ASTM A325M HIGH STRENGTH BOLTS, UNLESS NOTED.
- SUBMIT SHOP DRAWINGS TO THE CONSULTANT FOR REVIEW AND APPROVAL. SHOP DRAWINGS SHALL BE STAMPED AND SIGNED BY A PROFESSIONAL ENGINEER REGISTERED IN THE PROVINCE OF ONTARIO FOR CONNECTION DESIGN.
- FOR PRIME PAINTING / PAINTING OF STRUCTURAL STEEL REFER TO SPECS. TOUCH-UP DAMAGED AREAS IN FIELD WITH SAME SYSTEM.
- ANCHOR BOLTS CONFORMING TO ASTM A307.
- ALL EXTERIOR (EXPOSED) STRUCTURAL STEEL MUST BE HOT DIP GALVANIZED TO CONFORM TO CSA G164 AND TO HAVE A MINIMUM ZINC COATING OF 600 g/sq. m.

**ANCHOR TYPES**

- CAST-IN-PLACE ANCHOR BOLTS FOR THE COLUMNS BASES AND THE WALL BASE ANCHORAGE SHALL CONFORM TO ASTM A307. THE EXPOSED PORTION OF THE ANCHOR BOLTS ARE TO BE HOT-DIPPED GALVANIZED.
  - SET-IN-PLACE ANCHORS SHALL BE HILTI ANCHOR SYSTEM INSTALLED IN STRICT ACCORDANCE WITH THE HILTI SPECIFICATIONS, FOR THE LOAD INDICATED, OR ENGINEER APPROVED EQUAL.
- ANCHOR TYPE 1: (TO CONCRETE)  
HILTI KWIK BOLT 3 EXPANSION ANCHOR SYSTEM, USING 16mm DIAMETER ANCHORS WITH A 80mm EMBEDMENT, FOR AN ALLOWABLE (UNFACTORED) SHEAR LOAD OF 35 kN AND TENSION LOAD OF 15 kN PER ANCHOR.
- ANCHOR TYPE 2: (TO CONCRETE)  
HILTI HIT-HY 200 ADHESIVE ANCHOR SYSTEM, USING 19mm DIAMETER HARSER RODS WITH A 170mm EMBEDMENT, FOR AN ALLOWABLE (UNFACTORED) SHEAR LOAD OF 35 kN AND TENSION LOAD OF 40 kN PER ANCHOR.

**WOOD FRAMING**

- SAWN TIMBER SHALL BE IN ACCORDANCE WITH: CSA STANDARDS CAN/CSA-O86-14, "ENGINEERING DESIGN IN WOOD" -THE CANADIAN WOOD COUNCIL "WOOD DESIGN MANUAL 2015" -THE NBCC 2015 -THE CBC 2012
- ALL GLULAM SHALL BE SPRUCE-PINE 20'E STRESS GRADE. THE GLULAM SHALL MEET THE MEMBER MINIMUM RESISTANCES IN THE WOOD GLULAM BEAM SCHEDULE. FOR THE GLULAM FINISH COATING REQUIREMENTS, REFER TO THE ARCHITECTURAL DRAWINGS AND SPECIFICATIONS.
- THE WOOD GLULAM CONNECTIONS SHALL BE IN ACCORDANCE WITH CSA STANDARD CAN/CSA-O86-14 ENGINEERING DESIGN IN WOOD, TO THE DIMENSIONS, DETAILS, AND DESIGN LOAD CRITERIA SHOWN ON THE DRAWINGS. SHOP DRAWINGS OF THE WOOD GLULAM MEMBERS AND CONNECTION DETAILS, SHALL BEAR THE STAMP OF A REGISTERED PROFESSIONAL ENGINEER OF THE PROVINCE OF ONTARIO AND SHALL BE SUBMITTED TO THE CONSULTANT FOR REVIEW BEFORE FABRICATION.
- ALL STRUCTURAL COMPOSITE LUMBER, SUCH AS LAMINATED VENEER LUMBER (LVL), SHALL BE DESIGNED IN ACCORDANCE WITH CSA STANDARD CAN/CSA-O86-14 "ENGINEERING DESIGN IN WOOD" TO THE MINIMUM DESIGN LOADS SHOWN ON THE DRAWINGS. PROVIDE ALL NECESSARY FASTENERS AND BLOCKING/BRIDGING FOR THE LVL BEAM SYSTEM TO RESIST THE DESIGN LOADINGS. SHOP DRAWINGS OF THE LVL BEAMS SHALL BEAR THE STAMP OF A REGISTERED PROFESSIONAL ENGINEER OF THE PROVINCE OF ONTARIO AND SHALL BE SUBMITTED TO THE CONSULTANT FOR REVIEW BEFORE FABRICATION.
- ALL OTHER WOOD FRAMING SHALL BE GRADE S-P-F NO.1/2 OR BETTER, U.N.O.
- ALL TIMBER SHALL BE WELL SEASONED OR KILN DRIED TO PREVENT POSSIBLE DISTORTION OF THE FRAMING.
- PROVIDE METAL TIE-DOWN ANCHORS TO THE ROOF JOISTS FOR THE NET FORCES DUE TO UPLIFT.
- THE STRUCTURAL SYSTEM SHALL BE ADEQUATELY BRACED BY THE CONTRACTOR DURING ERECTION.
- BUILT-UP LINTEL BEAMS SHALL BE IN ACCORDANCE WITH THE CANADIAN WOOD COUNCIL WOOD DESIGN MANUAL 2015.
- ALL SAWN TIMBER CONNECTORS SUCH AS STEEL BRACKETS, SEATS, ANCHORS, AND THRU-BOLTS, SHALL BE GALVANIZED.

**DESIGN NOTES:**


**ENVIRONMENTAL LOADS FOR WIARTON, ONTARIO:**

- BUILDING IMPORTANCE CATEGORY, NORMAL.
  - LIVE LOAD DUE TO SNOW (1/50):  
Is = 1.00 FOR ULTIMATE LIMIT STATES (ULS)  
Is = 0.90 FOR SERVICEABILITY LIMIT STATES (SLS)  
Ss = 2.70 kPa, Sr = 0.40 kPa, BASIC ROOF SNOW; S = 2.56 kPa  
SNOW ACCUMULATION TO BE IN ACCORDANCE WITH THE NATIONAL BUILDING CODE 2015, AND THE NATIONAL BUILDING CODE 2010 STRUCTURAL COMMENTARIES (PART 4).
  - ONE DAY RAIN (1/50): 103mm
  - LIVE LOAD DUE TO WIND:  
Iw = 1.00 FOR ULTIMATE LIMIT STATES (ULS)  
Iw = 0.75 FOR SERVICEABILITY LIMIT STATES (SLS)  
q(1/10) = 0.37 kPa, q(1/50) = 0.48 kPa, INTERNAL PRESSURE CATEGORY 2.
  - WIND PRESSURES ARE TO BE IN ACCORDANCE WITH THE NATIONAL BUILDING CODE 2015, AND PRESSURE COEFFICIENTS FROM THE NATIONAL BUILDING CODE 2010 STRUCTURAL COMMENTARIES (PART 4).
  - LIVE LOAD DUE TO SEISMIC:  
Ie = 1.0 FOR ULTIMATE LIMIT STATES (ULS)  
Ss(2.0) = 0.110, Sd(5.0) = 0.083, Sd(1.0) = 0.053, Sa(2.0) = 0.018, PGA = 0.036
- SOIL SITE CLASS 'D'


**BUILDING LOADS:**

6. ROOF DEAD LOAD:	
METAL ROOFING	0.15 kPa
ICE SHIELD/INSULATION	0.10 kPa
19mm PLYWOOD DECKING	0.15 kPa
ROOF FURLING	0.20 kPa
ROOF BEAMS	0.20 kPa
ADDITIONAL LOAD ALLOWANCE	0.20 kPa
TOTAL DL:	1.00 kPa

- FLOOR LIVE LOAD = 4.8 kPa
  - SOLAR PANEL SUPPORT POLE FORCES AT POLE BASE (UNFACTORED):  
MOMENT = 65 kN-m (47,950 FT-LBS)  
HORIZONTAL SHEAR = 10 kN (2,250 LBS)
- LOADS BASED ON PRELIMINARY DESIGN OF A 7.2m TALL POLE. CONFIRM FINAL LOADING FROM POLE SUPPLIER / SHOP DRAWINGS PRIOR TO CONSTRUCTING FOUNDATIONS.
- APPROXIMATE BEDROCK DEPTHS AT PROPOSED WASHROOM LOCATIONS:  
(FOR MORE ACCURATE TESTHOLE INFORMATION, REFER TO THE GEOTECHNICAL REPORT)

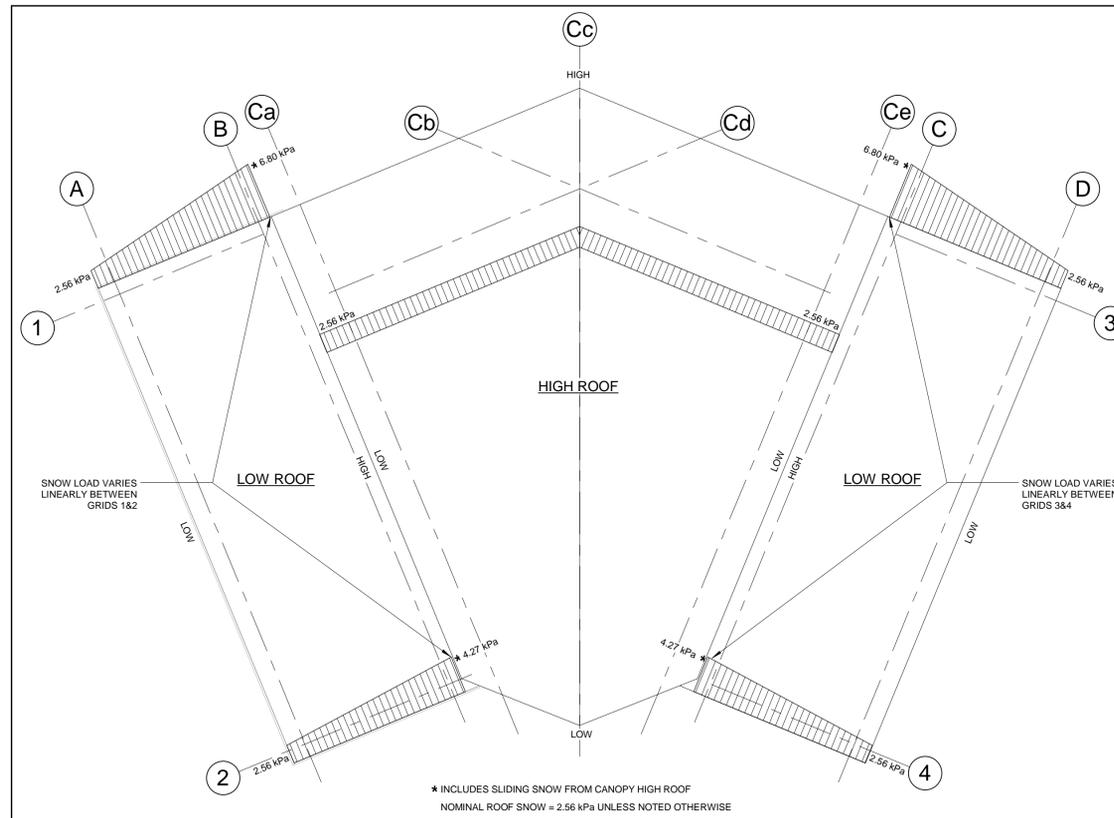

1 SNOW LOAD DIAGRAM  
A4/51 1:75

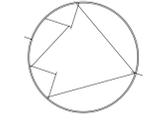

DRAWING NO.	DRAWING NAME

REFERENCE DRAWINGS				

NO.	DATE	DESCRIPTION	Drawn By/ Dessine par	Approved Approuve
1	2018- 08- 16	ISSUED FOR TENDER	JA	AW

REVISIONS				
A	A Detail Number		A Numero de Detail	
B	B Sheet Number		B Sur feuille Numero	

LINEAR DIMENSIONS IN MILLIMETERS	Dimensions lineaires en millimetres



PARKS CANADA

Type of Record / Type d'enregistrement

Project title / Titre du projet  
**CYPRUS LAKE - HEAD OF TRAILS RENEWAL**

Drawing title / Titre du Dessin  
**STRUCTURAL - GENERAL NOTES AND DESIGN NOTES**

Plot Scale / Echelle  
As indicated

Drawn by/ Dessin par  
JA Date  
2018- 06- 25

Field Recording by/ Releve- Terrain par  
Date  
N/A

Approved by/ Approuve par  
AW Date  
2018- 07- 06

Checked by/ Verifie par  
MM Date  
2018- 07- 06


Project No./No. du projet  
60576731

Asset No. Sheet No./ Feuille No.  
S1

Drawing Re No./No. du Dessin





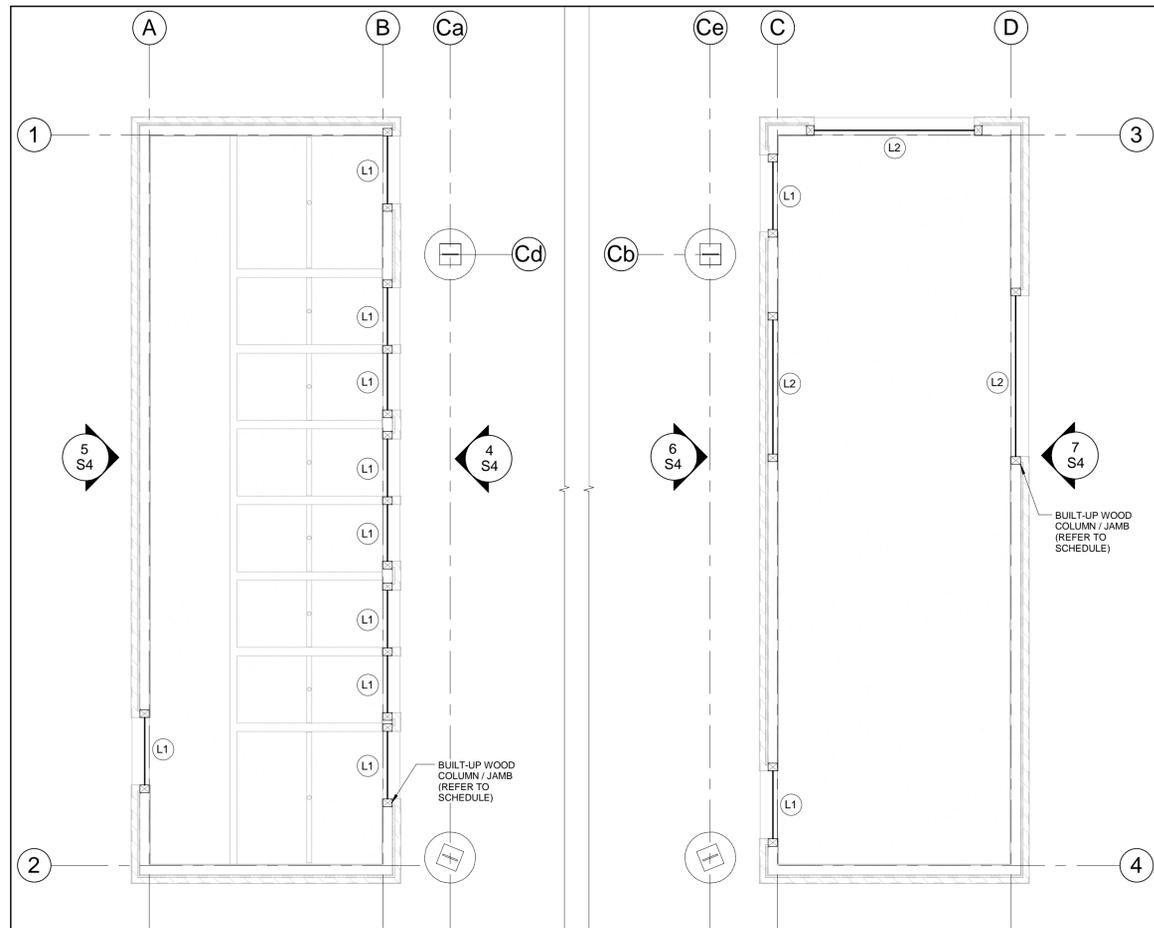


1 LINTEL PLANS  
A6 S4 1:50




2 ROOF FRAMING PLANS  
A6 S4 1:50

WOOD BEAM AND LINTEL SCHEDULE						
MARK	BEAM SIZE	Mr...	Vr...	Est min.	COLUMNS AT BEAM ENDS	BEAM END BEARING
		kN.m	kN	x10 <sup>9</sup> ...		
L1	2-38x184	-	-	-	3-PLY 38x140	1 STUD *
L2	2-44x184 LVL	17.4	36	620	3-PLY 38x140	2 STUDS *


\* PROVIDE END BEARING SPECIFIED IN TABLE OR EQUIVALENT HANGER / BRACKET SUPPORT.

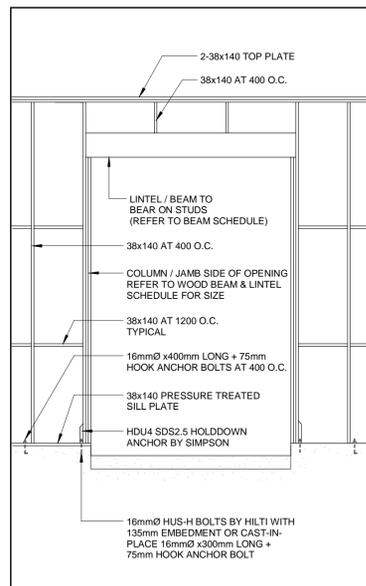


3 TYPICAL WOOD LINTEL FRAMING  
S4 N.T.S.

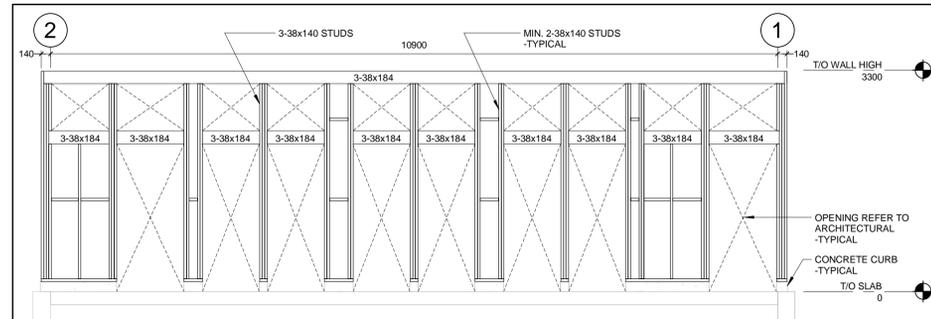


4 FRAMING ELEVATION - GRID B  
S4 S4 1:50

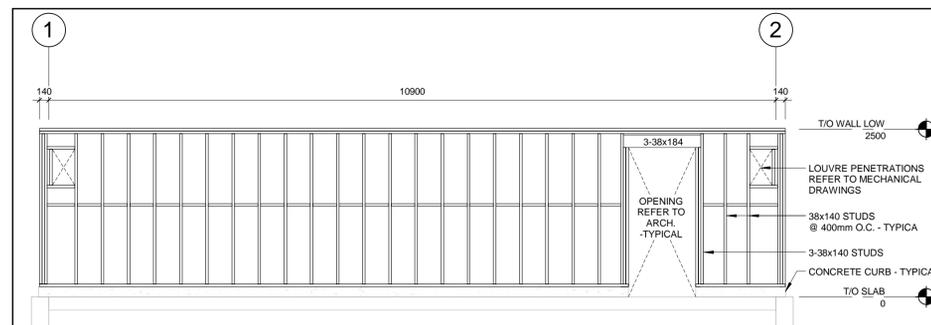

5 FRAMING ELEVATION - GRID A  
S4 S4 1:50

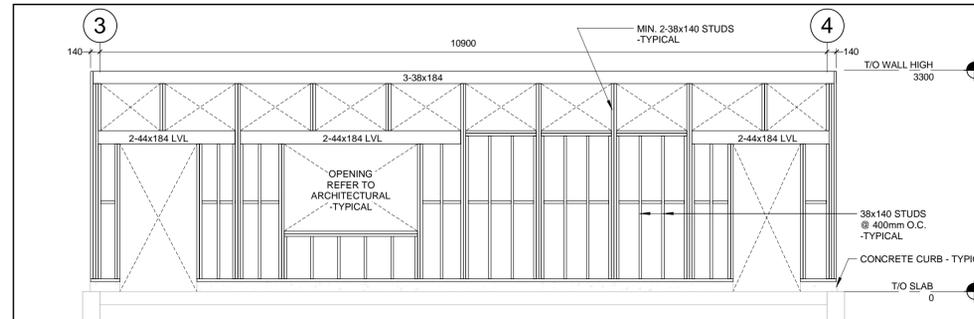

6 FRAMING ELEVATION - GRID C  
S4 S4 1:50

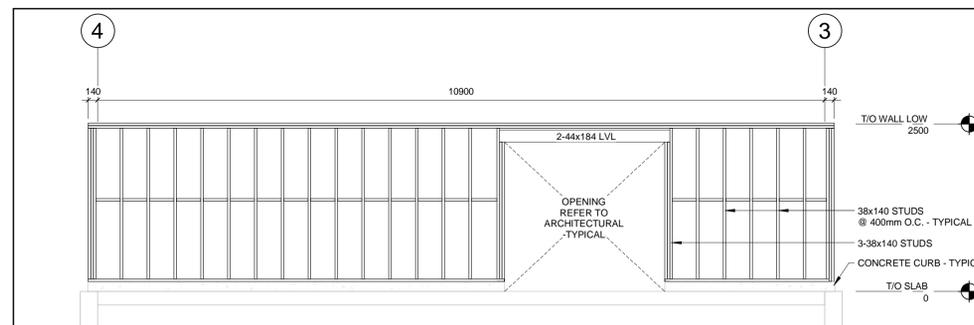

7 FRAMING ELEVATION - GRID D  
S4 S4 1:50

DRAWING NO. DRAWING NAME

REFERENCE DRAWINGS

NO.	DATE	DESCRIPTION	Drawn By/ Dessine par	Approved / Approuve
1	2018-08-16	ISSUED FOR TENDER	JA	AW

REVISIONS

A	A Detail Number	A Numero de Detail
B	B Sheet Number	B Sur feuille Numero

LINEAR DIMENSIONS IN MILLIMETERS Dimensions lineaires en millimetres

Parcs Canada Parks Canada

Canadä

PARKS CANADA

Type of Record / Type d'enregistrement

Project title / Titre du projet  
**CYPRUS LAKE - HEAD OF TRAILS RENEWAL**

Drawing title / Titre du Dessin  
**STRUCTURAL - LINTEL & ROOF FRAMING PLANS**

Plot Scale / Echelle  
1 : 50

Drawn by/ Dessin par  
JA Date  
2018-06-25


Field Recording by/ Relevé-Terminé par  
Date  
N/A

Approved by/ Approuvé par  
AW Date  
2018-07-06

Checked by/ Vérifié par  
MM Date  
2018-07-06


Project No./No. du projet Asset No. Sheet No./ Feuille No.  
60576731

Drawing Re No./No. du Dessin  
**S4**

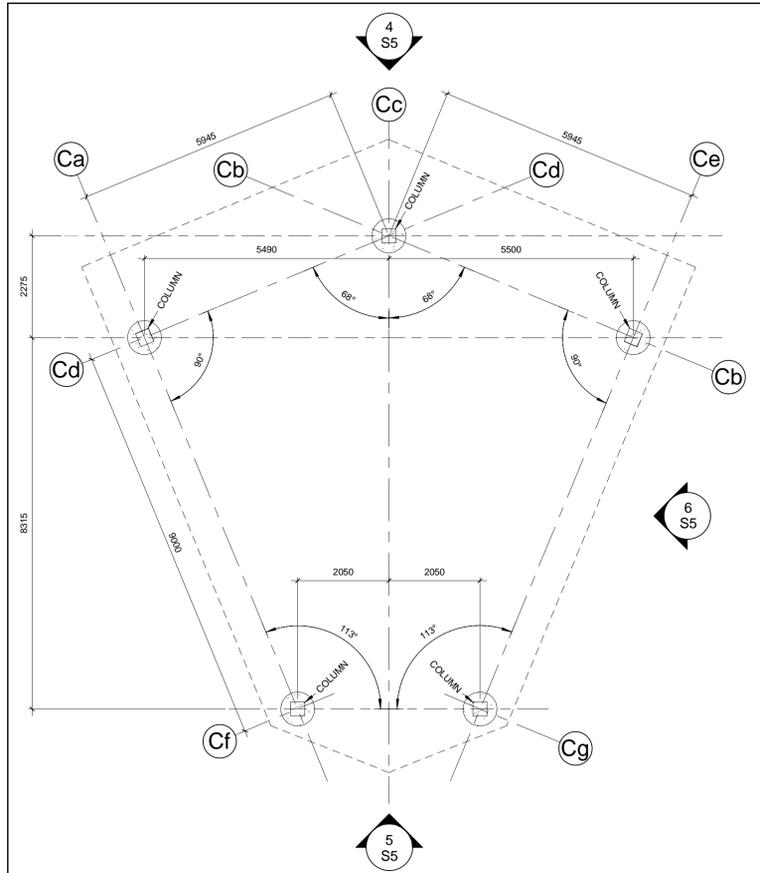


1 FRAMING PLAN @ COLUMN BASE PLATE

1:75

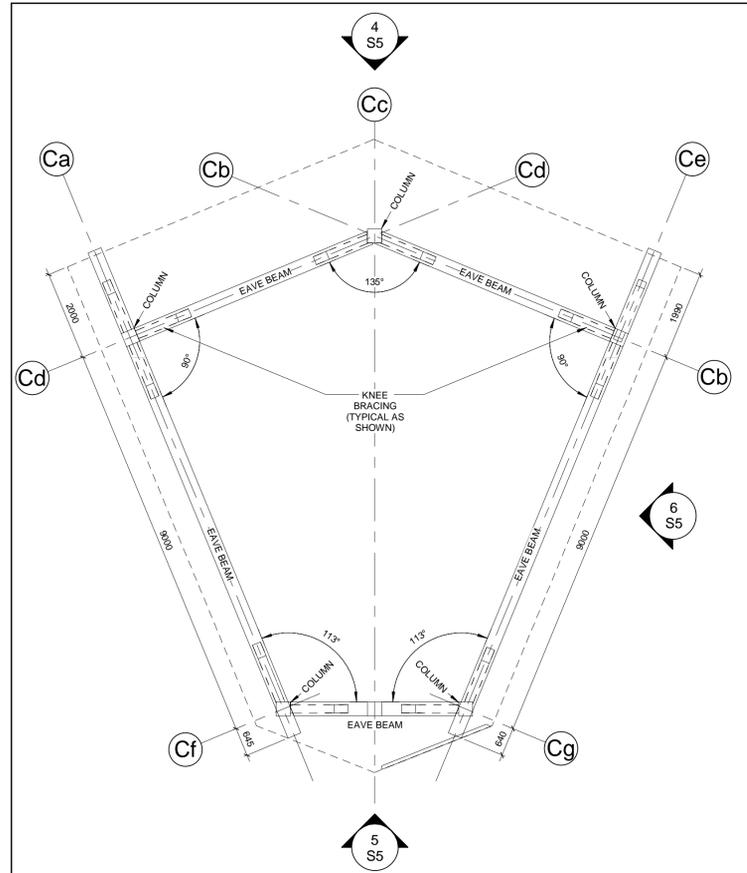


2 FRAMING PLAN @ LOW BEAMS

1:75

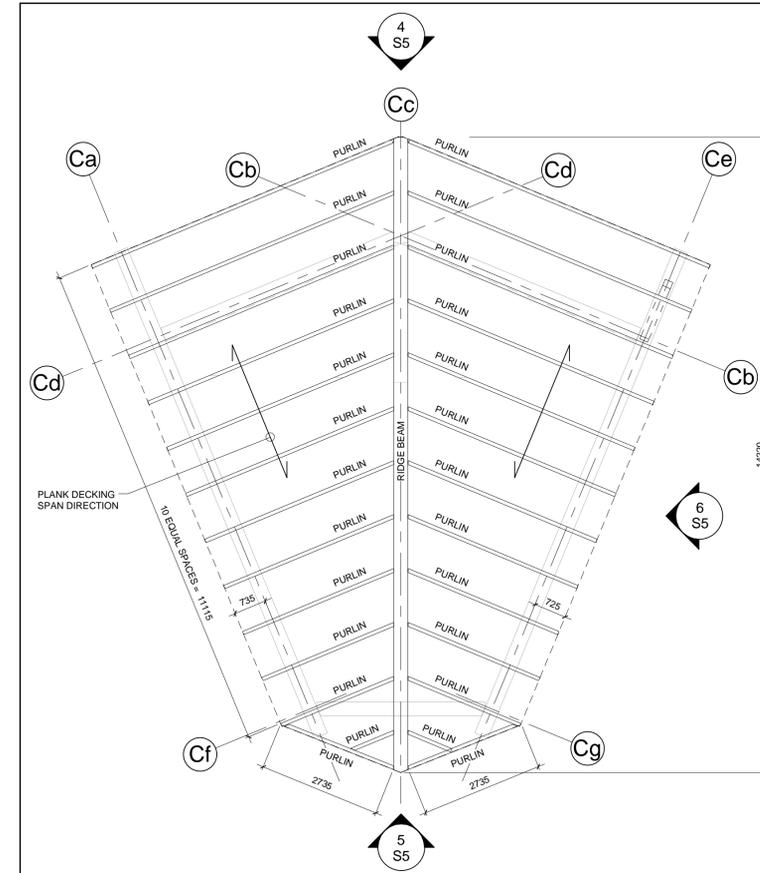


3 FRAMING PLAN @ RIDGE

1:75

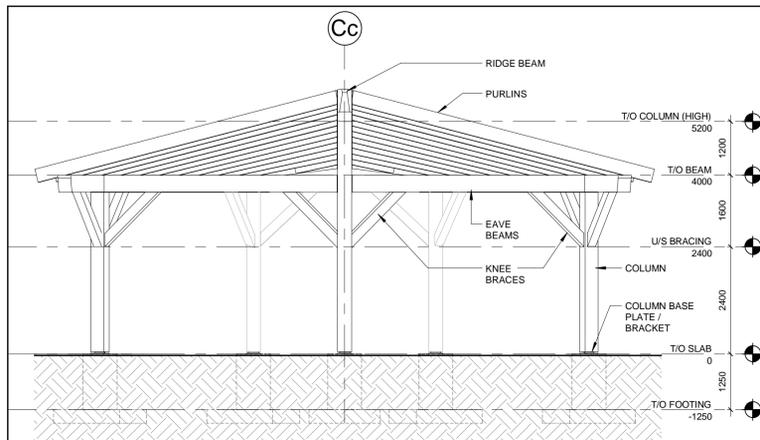


4 ELEVATION I - CANOPY

1:75

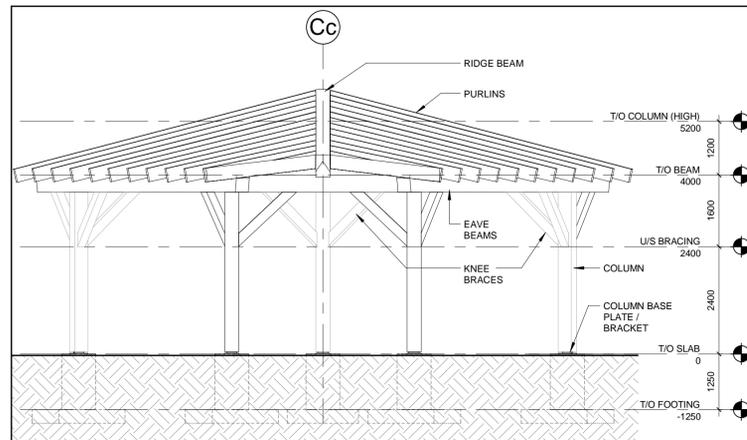

5 ELEVATION II - CANOPY

1:75

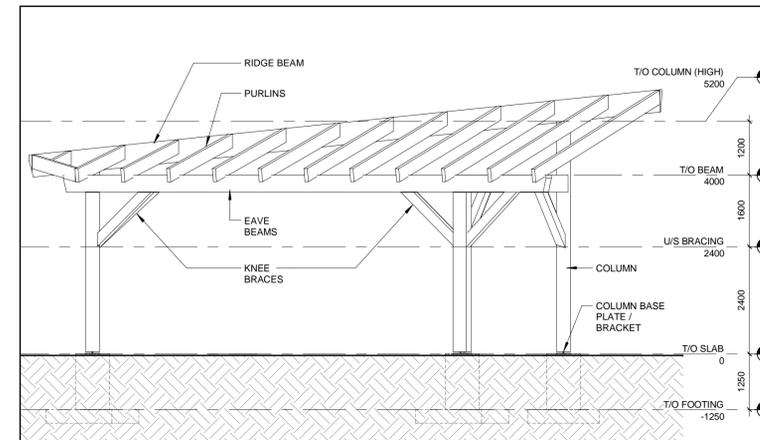

6 ELEVATION III - CANOPY

1:75

**WOOD CANOPY DESIGN LOADS**

1. REFER TO THE ENVIRONMENTAL DESIGN LOADS ON DRAWING S1.

2. ROOF DEAD LOAD:

STANDING SEAM ROOFING	0.15 kPa
ICE SHIELD	0.05 kPa
38mm PLANK DECKING	0.30 kPa
ROOF PURLINS	0.10 kPa
ROOF BEAMS	0.20 kPa
ADDITIONAL LOAD ALLOWANCE	0.20 kPa
<b>TOTAL DL:</b>	<b>1.00 kPa</b>

3. ALLOWABLE VERTICAL DEFLECTION, BASED ON UNFACTORED LOADS, SHALL BE:  
L/180 FOR TOTAL LOAD  
L/240 FOR SNOW LOAD

**WOOD CANOPY DESIGN AND FRAMING**

1. WOOD FRAMING DESIGN AND FRAMING SHALL BE IN ACCORDANCE WITH:  
-CSA STANDARDS CAN/CSA-086-14, "ENGINEERING DESIGN IN WOOD"  
-THE CANADIAN WOOD COUNCIL, "WOOD DESIGN MANUAL 2015"  
-THE NBC 2015  
-THE OBC 2012

2. THE WOOD CANOPY STRUCTURAL SYSTEM SHALL BE ENGINEERED, DESIGNED, AND BUILT IN ACCORDANCE WITH CSA STANDARD CAN/CSA-086-14 ENGINEERING DESIGN IN WOOD, TO THE DIMENSIONS, DETAILS, AND DESIGN LOAD CRITERIA SHOWN ON THE DRAWINGS. SHOP DRAWINGS OF THE WOOD CANOPY STRUCTURE, CONNECTION DETAILS, AND WOOD COLUMN BASE REACTIONS AND ANCHORAGE, SHALL BEAR THE STAMP OF A REGISTERED PROFESSIONAL ENGINEER OF THE PROVINCE OF ONTARIO AND SHALL BE SUBMITTED TO THE CONSULTANT FOR REVIEW BEFORE FABRICATION.

3. THE WOOD CANOPY SYSTEM REGISTERED PROFESSIONAL ENGINEER SHALL PERFORM A GENERAL REVIEW OF THE COMPLETED STRUCTURE AND SUBMIT A LETTER OF GENERAL REVIEW AT THE COMPLETION OF THE PROJECT.

4. THE COLUMN BASE CONNECTION SHALL BE BASED ON A PIN-TYPE CONNECTION (NO TRANSFER OF SIGNIFICANT MOMENT TO THE FOUNDATION PIERS). THE WOOD COLUMN BASE REACTIONS SHALL BE SUBMITTED TO THE CONSULTANT FOR REVIEW BEFORE FABRICATION. ANCHOR BOLTS SHALL BE DESIGNED AND SUPPLIED TO THE SITE FOR THE FOUNDATION CONSTRUCTION.

5. ALL WOOD FRAMING SHALL BE GLULAM SPRUCE-PINE 201-E STRESS GRADE. THE FOLLOWING MINIMUM SIZES SHALL BE USED TO ACHIEVE THE DESIRED APPEARANCE OF THE STRUCTURE. THE FINAL DESIGNED SIZES SHALL BE NO LESS THAN THE GIVEN MINIMUM SIZES.

RIDGE BEAM:	315 mm W X 494 mm D
EAVE BEAMS:	315 mm W X 380 mm D
PURLINS:	80 mm W X 304 mm D
COLUMNS:	315 mm W X 304 mm D
KNEEBRACES:	215 mm W X 190 mm D

6. THE STRUCTURAL SYSTEM SHALL BE ADEQUATELY BRACED BY THE CONTRACTOR DURING ERECTION.


7. THE ROOF PLANK DECKING SHALL BE TONGUE AND GROOVE 38mm THICK S-P-F COMMERCIAL GRADE, INSTALLED IN A CONTROLLED RANDOM PATTERN. FOR THE ROOF PLANK DECKING COATING REQUIREMENTS, REFER TO THE ARCHITECTURAL DRAWINGS AND SPECIFICATIONS.

8. ALL WOOD FRAMING CONNECTORS SUCH AS STEEL BRACKETS, SEATS, ANCHORS, AND THRU-BOLTS, SHALL BE DETAILED ON THE SHOP DRAWINGS, AND SHALL HAVE A GALVANIZED FINISH. FOR ADDITIONAL COATING REQUIREMENTS REFER TO THE ARCHITECTURAL DRAWINGS AND SPECIFICATIONS.

FOR THE GLULAM FINISH REQUIREMENTS, REFER TO THE ARCHITECTURAL SPECIFICATIONS.

DRAWING NO.		DRAWING NAME	
REFERENCE DRAWINGS			
1	2018-08-16	ISSUED FOR TENDER	JA
NO.	DATE	DESCRIPTION	Drawn By/ Approved / Dessine par / Approuve
REVISIONS			
A	A Detail Number		A Numero de Detail
B	B Sheet Number		B Sur feuille Numero
LINEAR DIMENSIONS IN MILLIMETERS		Dimensions lineaires en millimetres	
Canada			
PARKS CANADA			
Type of Record / Type d'enregistrement			
Project title / Titre du projet			
CYPRUS LAKE - HEAD OF TRAILS RENEWAL			
Drawing title / Titre du Dessin			
STRUCTURAL - TIMBER FRAME CANOPY LAYOUT AND DETAILS			
Plot Scale / Echelle			
1 : 75			
Drawn by/ Dessin par		Date	
JA		2018-06-25	
Field Recording by/ Relevé - Temoin par		Date	
MM		N/A	
Approved by/ Approuve par		Date	
AW		2018-07-06	
Checked by/ Verifie par		Date	
MM		2018-07-06	
Project No./No. du projet	Asset No.	Sheet No./ Feuille No.	
60576731		S5	
Drawing Re No./No. du Dessin			

- GENERAL NOTES:**
- PERFORM ALL WORK IN ACCORDANCE WITH ALL APPLICABLE CODES, STANDARDS AND BULLETINS, ETC., LATEST EDITIONS, AND TO THE LOCAL AUTHORITIES REQUIREMENTS.
  - THE DRAWINGS SHALL BE READ IN CONJUNCTION WITH THE SPECIFICATIONS AND THE DOCUMENTS PERTAINING TO THE WORK OF OTHER TRADES.
  - OBTAIN EXACT DIMENSIONS FROM SITE MEASUREMENTS. DO NOT SCALE THESE DRAWINGS.
  - CHECK AND VERIFY THE LOCATIONS OF ALL PIPES, DUCTS, AND EQUIPMENT WITH THE WORK OF OTHER TRADES TO PREVENT INTERFERENCE. REMOVAL AND RELOCATION OF ANY SUCH WORK INTERFERING WITH THE WORK OF OTHER TRADES IS THE RESPONSIBILITY OF THE MECHANICAL TRADES, UNLESS OTHERWISE APPROVED IN WRITING.
  - ALL PLUMBING FIXTURES AND DRAINS SHALL BE TRAPPED AND VENTED IN ACCORDANCE WITH THE NATIONAL BUILDING CODE.
  - PROVIDE ONE 75mm DIA. VENT THROUGH ROOF. REFER TO ARCHITECTURAL DRAWING FOR LOCATION.
  - PARKS CANADA SHALL PROVIDE MAIN SHUT-OFF VALVES ON-SITE FOR SEASONAL DRAINING OF WATER DISTRIBUTION NETWORK.

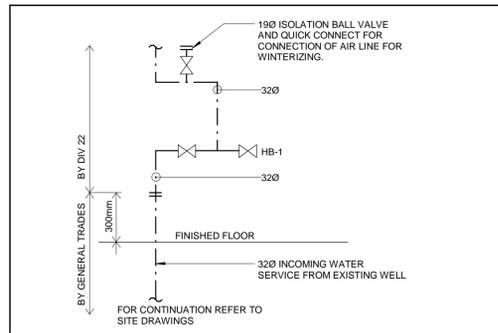

**1** SCHEMATIC - INCOMING WATER SERVICE  
N.T.S.

**LEGEND - PIPING**

REFER	DESCRIPTION
---	DOMESTIC COLD WATER PIPING
-v-	VENT PIPING
---	SANITARY PIPING ABOVE FLOOR
---	SANITARY PIPING BELOW FLOOR
+	TEE
+	ELBOW - 90°
+	ELBOW - 45°
+	WYE
+	REDUCER / INCREASER
+	UNION
+	FLANGE
+	CAPPED PIPE
FD	FLOOR DRAIN
FFD	FUNNEL FLOOR DRAIN
CO	CLEAN OUT (IN FLOOR)
CO	CLEAN OUT (IN LINE OR STACK)
o	PIPE DOWN
o	PIPE UP
o-o	PIPE TEE
+	ISOLATION VALVE
+	STRAINER
+	DRAIN COCK
+	HOSE BIB C/W VACUUM BREAKER
WH	WALL HYDRANT
PH	POST HYDRANT
BWV	BACK WATER VALVE
VTR	VENT THROUGH ROOF
FEX	PORTABLE FIRE EXTINGUISHER (WALL HUNG / SURFACE MOUNTED)
FEC	PORTABLE FIRE EXTINGUISHER IN CABINET

**LEGEND - HVAC**

REFER	DESCRIPTION
---	NEW DUCT WORK
---	SIDEWALL GRILLE
---	RETURN/EXHAUST GRILLE
---	FULL RADIUS DUCT CONNECTION
---	TAP-IN DUCT CONNECTION
---	ROUND DUCT CONNECTION
---	TURNING VANES
BD	BALANCING DAMPER
VD	VOLUME DAMPER
SP	SPLITTER DAMPER
UC	UNDERCUT
CAP	CAP

**LEGEND - SYMBOL TAG**

SYMBOL	DESCRIPTION	EQUIPMENT TAG
LPS	AIR FLOW	DIFFUSER, GRILLE, AND LOUVRE TAG

**FAN SCHEDULE**

TAG	LOCATION	FUNCTION	MANUFACTURER	MODEL	FAN TYPE	MAXIMUM CAPACITY		STATIC PRESSURE		FAN RPM	NOMINAL MOTOR POWER		MAX. BHP	POWER	SOUND DATA	CONTROLLED BY	REMARKS
						LPS	CFM	Pa	IN WC		W	HP					
EF-1 & EF-2	MECHANICAL ROOM	SANITARY EXHAUST	GREENHECK	SQ-90-D	INLINE CENTRIFUGAL FAN DIRECT DRIVE	155	330	107	0.43	1465	75	1/10	0.06	1151/60	6.7 SONES	FAN TIMER CONTROL PANEL	C/W UNIT MOUNTED SPEED CONTROLLER AND DISCONNECT SWITCH

**GRILLE SCHEDULE**

TAG	MANUFACTURER	MODEL	APPLICATION	SIZE		AIR FLOW		MAXIMUM NC RANGE	REMARKS
				MM	INS	LPS	CFM		
DG1	KRUEGER	9700A - H - 16x8 - 304	DOOR GRILLE	400 x 200	16 x 8	33 TO 46	70 TO 100	15	STAINLESS STEEL 304 DOOR GRILLE WITH 25mm BLADE SPACING, C/W STAINLESS STEEL 304 AUXILIARY FRAME
E1	KRUEGER	S85 - H - 6x6 - F22 - NONE - 00 - 01 - 00 - 44	SIDEWALL GRILLE	150 x 150	6 x 6	23 TO 33	50 TO 70	22	STEEL RETURN AIR GRILLE WITH 35° FIXED HORIZONTAL FRONT BLADES, 12mm BLADE SPACING, STEEL OPPOSED BLADE DAMPER AND BRITISH WHITE FINISH. PROVIDE SRAC325 SQUARE TO ROUND ADAPTER WITH DIMENSIONS 150mm X 150mm (6"X6") TO 150mm (6") DIA. FOR EACH GRILLE.

**LOUVRE SCHEDULE**

TAG	MANUFACTURER	MODEL	APPLICATION	SIZE (W x H)		AIR FLOW		FREE AREA	PRESSURE DROP		REMARKS
				MM	INS	LPS	CFM		%	Pa	
L1	GREENHECK	SED-501	EXHAUST LOUVRE	300 x 500	20 x 12	155	330	38	25	0.100	5" (125mm) DEEP DRAINABLE HEAD AND BLADE WITH FLANGED FRAME, C/W INSECT SCREEN

**PLUMBING FIXTURE CONNECTION SCHEDULE**

TAG	FIXTURE NAME	SANITARY		VENT		DCWS		REMARKS
		MM	INS	MM	INS	MM	INS	
W-1	BARRIER-FREE FLUSH TANK WATERCLOSET	75	3	38	1.5	13	0.5	
W-2	FLUSH TANK WATERCLOSET	75	3	38	1.5	13	0.5	
L-1	BARRIER-FREE WALL MOUNTED LAVATORY	38	1.5	38	1.5	13	0.5	
L-2	WALL MOUNTED LAVATORY	38	1.5	38	1.5	13	0.5	
S-1	FLOOR MOUNTED MOP SINK	75	3	38	1.5	13	0.5	
FD	FLOOR DRAIN	75	3	38	1.5	-	-	COMPLETE WITH AIR TRAP SEAL GUARD
TD-1	TRENCH DRAIN	75	3	38	1.5	-	-	COMPLETE WITH AIR TRAP SEAL GUARD
TD-2	TRENCH DRAIN	75	3	38	1.5	-	-	COMPLETE WITH AIR TRAP SEAL GUARD
BF-1	EXTERIOR WALL MOUNTED BOTTLE FILLING STATION	38	1.5	38*	1.5*	13	0.5	* AIR ADMITTANCE VALVE
WH-1	WALL HYDRANT	-	-	-	-	19	0.75	COMPLETE WITH VACUUM BREAKER
HB-1	INDOOR HOSE BIBB	-	-	-	-	19	0.75	COMPLETE WITH VACUUM BREAKER

DRAWING NO. DRAWING NAME

REFERENCE DRAWINGS

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1	2018-08-16	ISSUED FOR TENDER	JA	BJ

REVISIONS

A	A Detail Number	A Numero de Detail
B	B Sheet Number	B Sur feuille Numero

LINEAR DIMENSIONS IN MILLIMETERS Dimensions lineaires en millimetres



**Canada**

PARKS CANADA

Type of Record / Type d'enregistrement

Project title / Titre du projet  
**CYPRUS LAKE - HEAD OF TRAILS RENEWAL**

Drawing title / Titre du Dessin  
**MECHANICAL - LEGEND, GENERAL NOTES, SCHEMATICS AND SCHEDULES**

Plot Scale / Echelle  
As indicated

Drawn by/ Dessin par  
JA Date  
2018-07-25

Field Recording by/ Relevé- Temoin par  
Date


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BJ Date  
2018-07-25

Checked by/ Verifie par  
BG Date  
2018-07-25


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Asset No.


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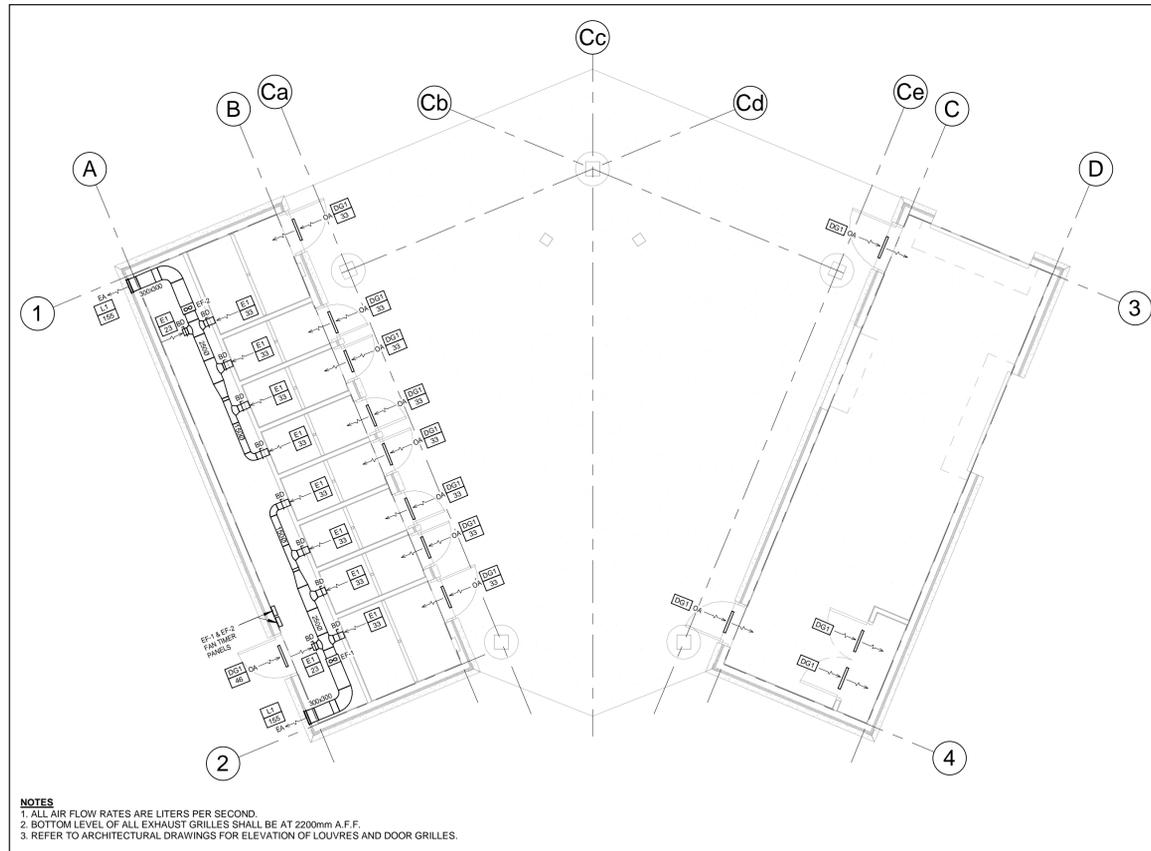
1 FOUNDATION PLAN - PLUMBING  
A6 M2 1:75

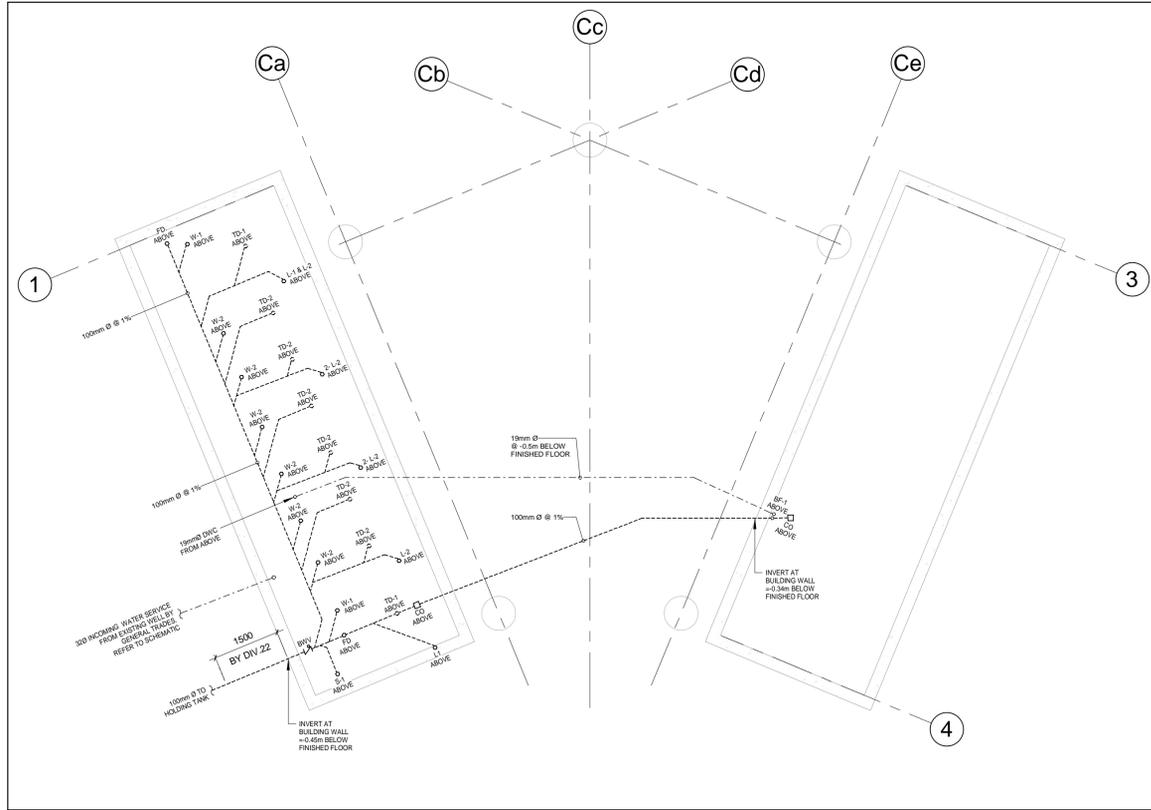


2 GROUND FLOOR PLAN - SANITARY AND VENTING LAYOUT  
A6 M2 1:75

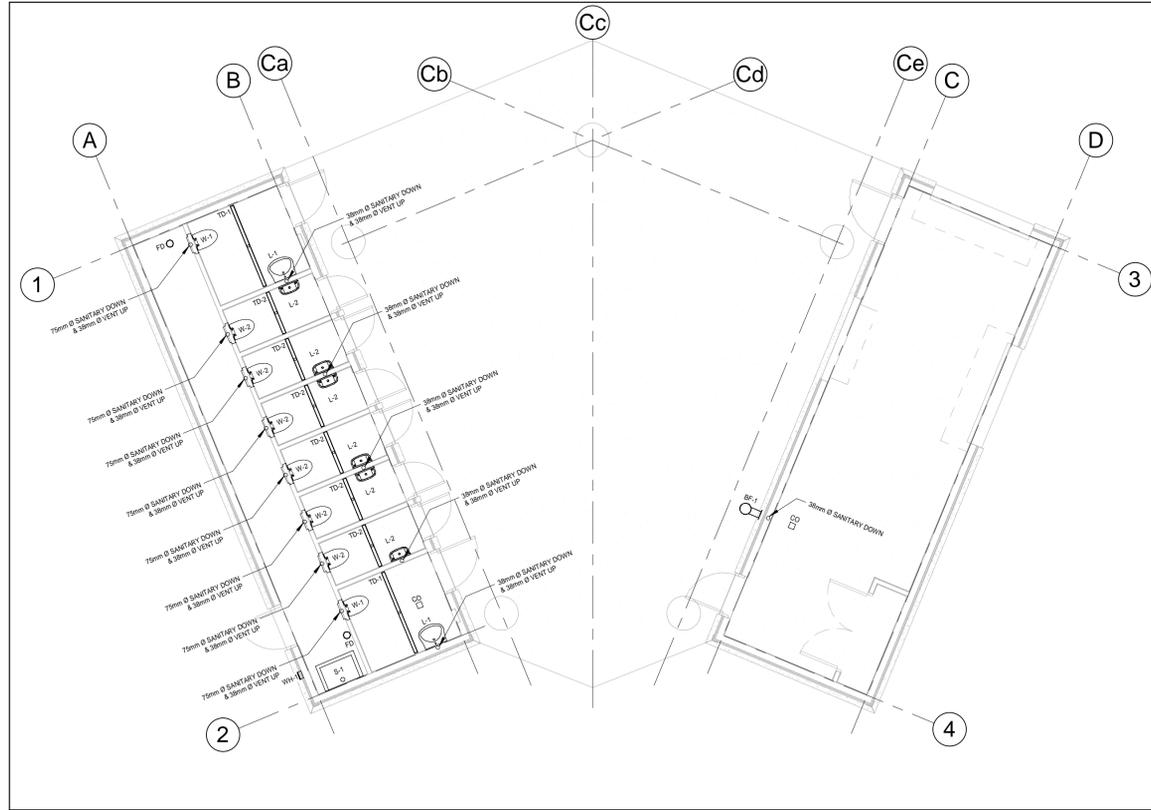

3 GROUND FLOOR PLAN - POTABLE WATER  
A6 M2 1:75

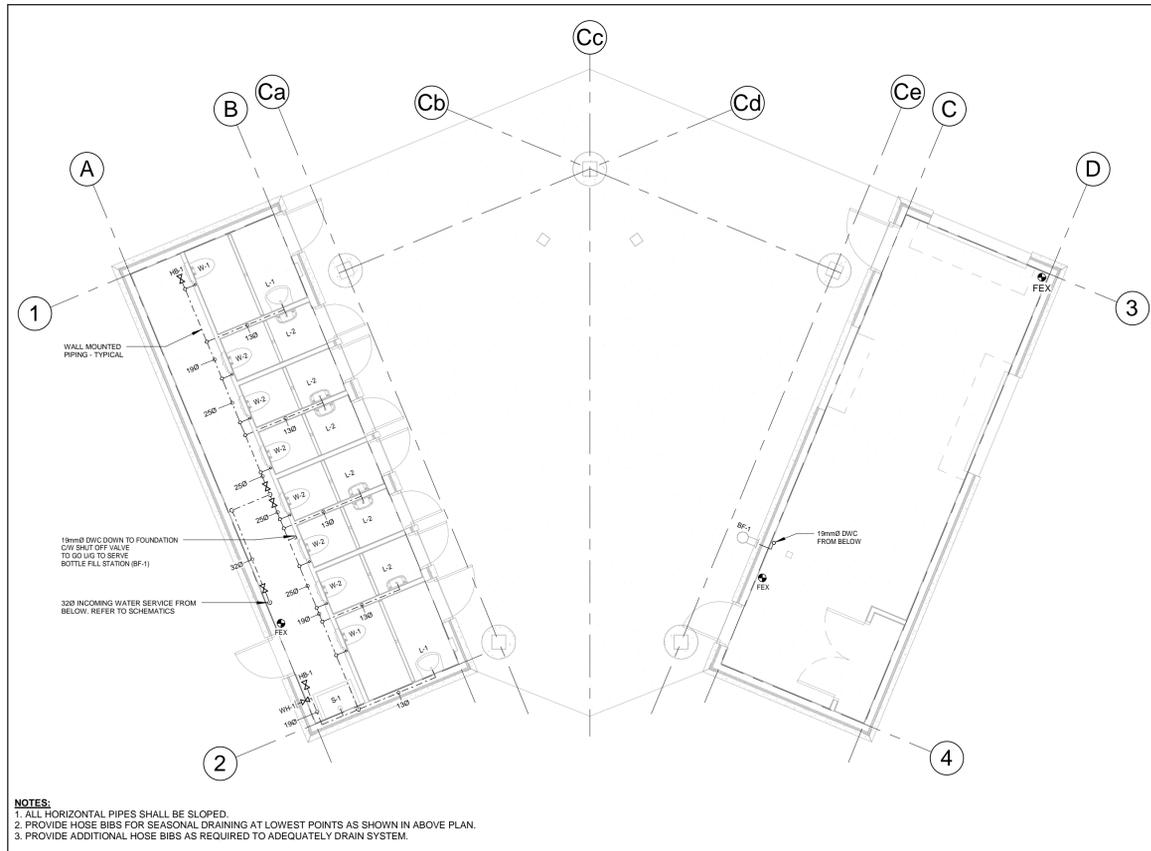

4 GROUND FLOOR PLAN - VENTILATION  
A6 M2 1:75

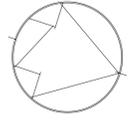

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**CYPRUS LAKE -  
HEAD OF TRAILS  
RENEWAL**

Drawing title / Titre du Dessin  
**MECHANICAL -  
PLUMBING & DRAINAGE  
AND HVAC PLANS**

Plot Scale / Echelle  
1 : 75

Drawn by/ Dessin par      Date  
JA      2018-07-25

Field Recording by/  
Releve- Terrain par      Date

Approved by/ Approuvé par      Date  
BJ      2018-07-25

Checked by/ Verifie par      Date  
BG      2018-07-25

Project No./No. du projet	Asset No.	Sheet No./ Feuille No.
60576731		M2
Drawing Re No./No. du Dessin		

**ELECTRICAL ABBREVIATIONS**

<b>A</b>	AC AFF AFG A.AMP ASM AUTO AUX AWG	ALTERNATING CURRENT ABOVE FINISHED FLOOR ABOVE FINISHED GRADE AMPERE AMBIENT SENSING MICROPHONE AUTOMATIC AUXILIARY AMERICAN WIRE GAUGE	<b>M</b>	MTG MTD	MOUNTING MOUNTED
<b>C</b>	C CB CU	CONDUIT CIRCUIT BREAKER COPPER	<b>N</b>	NC NO NTS	NORMALLY CLOSED NORMALLY OPEN OR NUMBER NOT TO SCALE
<b>D</b>	DC DN DO	DIRECT CURRENT DOWN DOOR OPENERS	<b>O</b>	OBC OESC OL	ONTARIO BUILDING CODE ONTARIO ELECTRICAL SAFETY CODE OVERLOAD
<b>E</b>	E E/R EC ELEC ELEV EXP	EXISTING DEVICE/EQUIPMENT TO REMAIN EXISTING DEVICE/EQUIPMENT TO BE RELOCATED OR REPLACED (AS NOTED) EMPTY CONDUIT ELECTRICAL ELEVATION EXPLOSION PROOF	<b>P</b>	P PH PR PVC	POLE PHASE PAIR POLYVINYL CHLORIDE
<b>F</b>	FU	FUSE	<b>Q</b>	QTY	QUANTITY
<b>G</b>	G,GRD GFI GFCI GRS	GROUND GROUND FAULT INTERRUPTING GROUND FAULT CIRCUIT INTERRUPTER GALVANIZED RIGID STEEL	<b>R</b>	R REC	EXISTING DEVICES/EQUIPMENT TO BE REMOVED RECEPTACLE
<b>H</b>	HH HDG HT HTR HZ	HAND HOLE HOT DIPPED GALVANIZED HEIGHT HEATER HERTZ	<b>S</b>	ST,STEEL SN SW	STAINLESS STEEL SOLID NEUTRAL SWITCH
<b>I</b>	INST	INSTANTANEOUS	<b>T</b>	TL TVSS TW TYP	TWIST LOCK TRANSIENT VOLTAGE SURGE SUPPRESSOR TWISTED TYPICAL
<b>L</b>	LP	LIGHTING PANEL	<b>U</b>	UG ULC	UNDERGROUND UNDERWRITERS LABORATORIES OF CANADA
			<b>V</b>	V	VOLTS
			<b>W</b>	W WG WP W.I.P.	WIRE WIRE GUARD WEATHER PROOF WORK IN PROGRESS

**ELECTRICAL LEGEND**

SYMBOL	DESCRIPTION	SYMBOL	DESCRIPTION
	PANELS, FLUSH OR SURFACE MOUNTED. 'A' DENOTES PANEL NAME.		WALL MOUNTED EMERGENCY LIGHTING SINGLE REMOTE HEAD CONNECTED TO EMERGENCY BATTERY UNIT AS INDICATED.
	120V-1P CONNECTION TO EQUIPMENT AS NOTED C/W DISCONNECT SWITCH		WALL MOUNTED EMERGENCY LIGHTING DOUBLE REMOTE HEADS CONNECTED TO EMERGENCY BATTERY UNIT AS INDICATED.
	DIRECT CONNECTION TO EQUIPMENT		COMBINATION EMERGENCY LIGHTING (TWIN HEAD) AND EXIT SIGN
	DISCONNECT SWITCH		CEILING MOUNTED EXIT LIGHT SIGN. ARROWS DENOTE DIRECTION
	MANUAL STARTER		WALL MOUNTED EXIT LIGHT SIGN. ARROWS DENOTE DIRECTION
	COMBINATION MAG		120V, 15AMP SINGLE POLE TOGGLE SWITCH (3 INDICATES 3-WAY, 4 INDICATES 4 WAY, 20 INDICATES 20 AMP).
	1-PHASE MOTOR CONNECTION		SINGLE POLE EXHAUST FAN SWITCH WITH RED PILOT LIGHT
	3-PHASE MOTOR CONNECTION		15A, 125V, DUPLEX RECEPTACLE (CSA 5-15R)
	PUSHBUTTON		20A, 125V, DUPLEX RECEPTACLE (CSA 5-15R)
	EQUIPMENT OR DEVICE AS NOTED		15A, 125V, GROUND FAULT INTERRUPTING DUPLEX RECEPTACLE. (CSA 5-15R)
	FUSE		15A, 125V, DUPLEX RECEPTACLE, SPLIT CIRCUIT (CSA 5-15R)
	DISCONNECT SWITCH		15A, 125V, QUAD RECEPTACLE (2X CSA 5-15R)
	CIRCUIT BREAKER		WALL MOUNTED SINGLE RECEPTACLE. AMPS, VOLTS AND CSA CONFIGURATION AS NOTED.
	TRANSFORMER		TELEPHONE OUTLET. PROVIDE 21mmC (3/4" C) FROM WALL OUTLET TO ACCESSIBLE CEILING SPACE UNLESS OTHERWISE NOTED.
	EQUIPMENT TAG NO. MOUNTED ON WALL/FLOOR		DATA OUTLET. PROVIDE 21mm C (3/4" C) FROM WALL OUTLET TO ACCESSIBLE CEILING SPACE UNLESS OTHERWISE NOTED.
	EQUIPMENT TAG NO. MOUNTED ON CEILING		TELEPHONE OUTLET. PROVIDE 21mmC (3/4" C) FROM WALL OUTLET TO ACCESSIBLE CEILING SPACE UNLESS OTHERWISE NOTED.
	NOTE TAGS		GROUND BONDING POINT TO STEEL STRUCTURE, REBAR, PIPE, ETC.
	DETAIL No.3 ON DRAWING E03		GROUNDING CONNECTION (TYPE AS SHOWN OR NOTED)
	CEILING SUSPENDED LED FIXTURE. 'A' DENOTES TYPE, REFER TO SCHEDULE.		GROUND BAR
	LED WALL PACK. 'A' DENOTES TYPE, REFER TO SCHEDULE.		UNDERGROUND CONDUIT/ELECTRODE OR GROUND PLATE
	WALL MOUNTED DIGITAL LIGHTING SWITCH AND OCCUPANCY SENSOR		POTENTIAL TRANSFORMER
	CORNER MOUNT DIGITAL OCCUPANCY SENSOR		CURRENT TRANSFORMER
	CEILING MOUNTED DIGITAL OCCUPANCY SENSOR		JUNCTION BOX, NEMA 4X PVC COATED HDG STEEL, C/W BRACKET ACCESSORIES
	DAYLIGHT SENSOR (DIGITAL LIGHT MANAGEMENT)		SOLAR PANEL 300W-24VDC, C/W STAINLESS STEEL FASTENERS AND ENGINEERED SUPPORT FRAME STRUCTURE FOR POLE MOUNT.
	DIGITAL LIGHT MANAGEMENT - ROOM CONTROLLER (RC), NUMBER INDICATES QUANTITY OF ENCLOSED RELAY CIRCUITS.		SEALED GEL BATTERY, 24V - 120 Ah
	DIGITAL LIGHT MANAGEMENT - ISOLATED RELAY INTERFACE (IR), ONE CHANGE-OVER DRY RELAY CONTACT		

**GENERAL NOTES:**

- PERFORM ALL WORK IN ACCORDANCE WITH THE LATEST EDITION OF ALL APPLICABLE CODES, STANDARDS AND BULLETINS AND TO THE LOCAL AUTHORITIES REQUIREMENTS.
- INFORMATION REPRESENTED ON THESE DRAWINGS IS FROM VISUAL FIELD REVIEW. AECOM AND ITS REPRESENTATIVES ARE NOT RESPONSIBLE FOR ANY DISCREPANCIES AND/OR ERRORS. THE CONTRACTOR SHALL VERIFY THE SCOPE OF WORK PRIOR TO PROCEEDING.
- THE DRAWINGS SHALL BE READ IN CONJUNCTION WITH THE SPECIFICATIONS AND THE DOCUMENTS PERTAINING TO THE WORK OF OTHER TRADES.
- OBTAIN EXACT DIMENSIONS FROM SITE MEASUREMENTS. DO NOT SCALE THESE DRAWINGS.
- PENETRATIONS TO EITHER FIRE AND/OR SMOKE BARRIERS SHALL BE SLEEVED AND SEALED AGAINST THE PASSAGE OF FLAME AND/OR SMOKE WITH A SUITABLE NON-COMBUSTIBLE MATERIAL EQUAL TO THE CONSTRUCTION PENETRATED.
- CHECK AND VERIFY THE LOCATIONS OF ALL PANELBOARDS, DISCONNECTS, RECEPTACLES, CONDUITS AND EQUIPMENT WITH THE WORK OF OTHER TRADES TO PREVENT INTERFERENCE. REMOVAL AND RELOCATION OF ANY SUCH WORK INTERFERING WITH THE WORK OF OTHER TRADES IS THE RESPONSIBILITY OF THE ELECTRICAL TRADE(S), UNLESS OTHERWISE APPROVED IN WRITING.
- PROVIDE ACCESS DOORS AS REQUIRED FOR ALL CONCEALED SERVICEABLE COMPONENTS LOCATED ABOVE, BEHIND OR BELOW INACCESSIBLE CONSTRUCTION.
- RESTORE ALL SURFACES TO PRE-CONSTRUCTION STATE OR AS SHOWN ON LANDSCAPE SITE PLANS, FOLLOWING TRENCHING AND UNDERGROUND DUCT WORK.

DRAWING NO. DRAWING NAME

**REFERENCE DRAWINGS**

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**CYPRUS LAKE -  
HEAD OF TRAILS  
RENEWAL**

Drawing title / Titre du Dessin

**ELECTRICAL LEGEND  
AND GENERAL NOTES**

Plot Scale / Echelle

AS INDICATED

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JA Date  
2018- 07- 25


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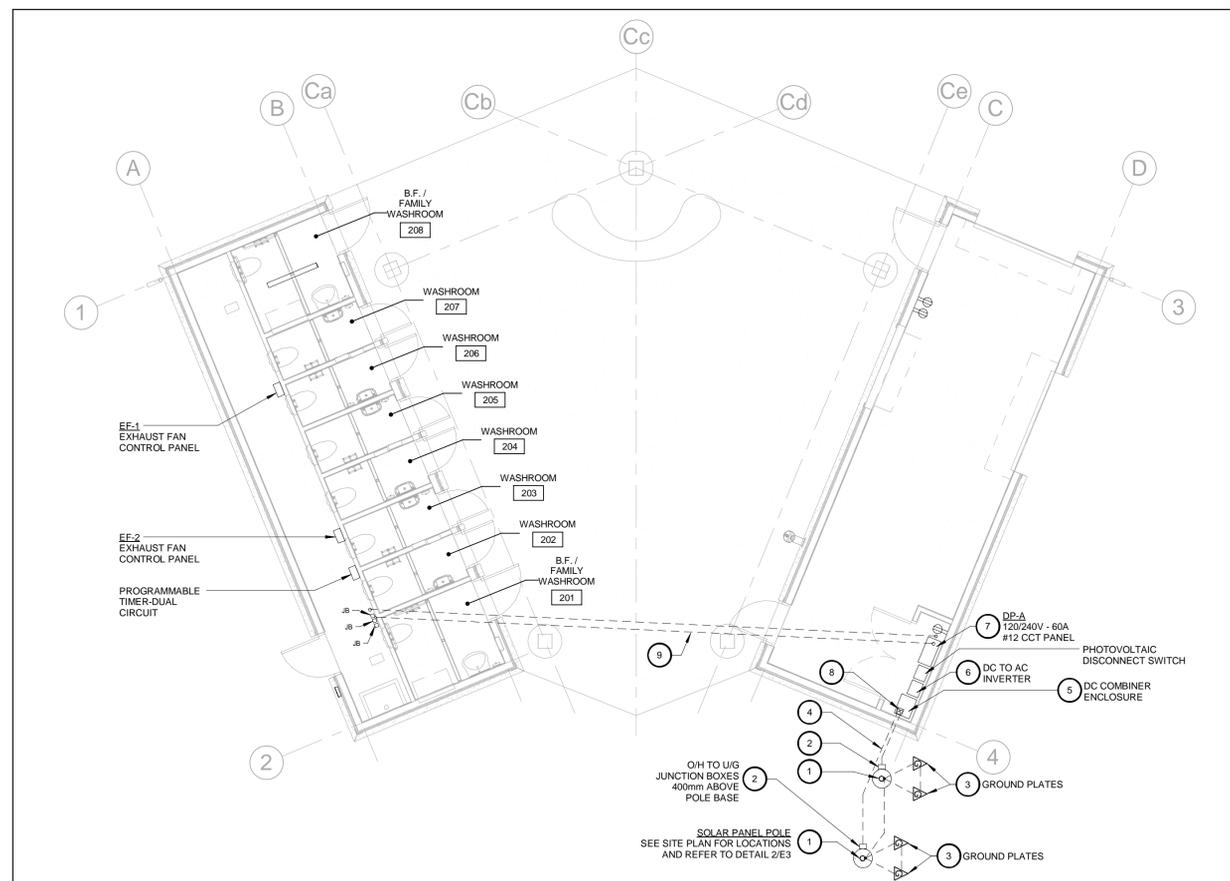
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1 LIGHTING PLAN  
1:75

**LIGHTING NOTES:**


- 1 SUPPLY AND INSTALL CEILING SUSPENDED LIGHTING FIXTURES PER SCHEDULE. COMPLETE WITH WIREGUARDS, HANGER SUPPORTS AND AIRCRAFT SAFETY CABLES.
- 2 SUPPLY AND INSTALL LED WALLPACK COMPLETE WITH WALL ENCASED DEVICE BOX.
- 3 ALL INDOOR LIGHTING FIXTURES SHALL HAVE 0-10V CAPABLE DIMMABLE DRIVERS.
- 4 SUPPLY AND INSTALL LIGHTING FIXTURE POWER CIRCUITING 2C#12+GND - AC90. CABLE SUPPORTING MEANS AND OVERALL INSTALLATION TO MEET OESC.
- 5 SUPPLY AND INSTALL LIGHTING FIXTURE DIMMING CIRCUITING 2C#14+GND-AC90. CABLE SUPPORTING MEANS AND OVERALL INSTALLATION TO MEET OESC.
- 6 LIGHTING CONTROL SYSTEM TO BE HUBBELL LIGHTING, WITH DAYLIGHTING CONTROLLED PROPORTIONAL DIMMING AND OCCUPANCY SENSOR BASED OPERATION. PROVIDE HUBBELL LIGHTING CONTROLS SHOP DRAWINGS DEMONSTRATING SYSTEM PERFORMANCE.
- 7 SUPPLY AND INSTALL FT-6 RATED OR ARMOURD CAT.5 CABLING AND RJ45 ADAPTORS FOR LIGHTING CONTROL INTERCONNECTIONS TO ROOM CONTROLLERS. CABLE SUPPORTING MEANS AND OVERALL INSTALLATION TO MEET OESC.
- 8 SUPPLY AND INSTALL OUTDOOR RATED OCCUPANCY AND DAYLIGHT SENSOR COMBO UNIT HUBBELL CAT.# WSP-LWG-SM-UNV-BK C/W LOW MOUNT OUTDOOR LENSE, HALF AISLE COVERAGE OPTION. SENSOR TO BE SOFFIT MOUNTED.
- 9 PROVIDE DAYLIGHT SENSOR HUBBELL CAT.# NXDS WITH RJ45 ADAPTER AND DAISY-CHAINED NETWORK WIRING TO ROOM CONTROLLERS 1 TO 4.
- 10 PROVIDE DAYLIGHT SENSOR HUBBELL CAT.# NXDS.



2 POWER PLAN  
1:75

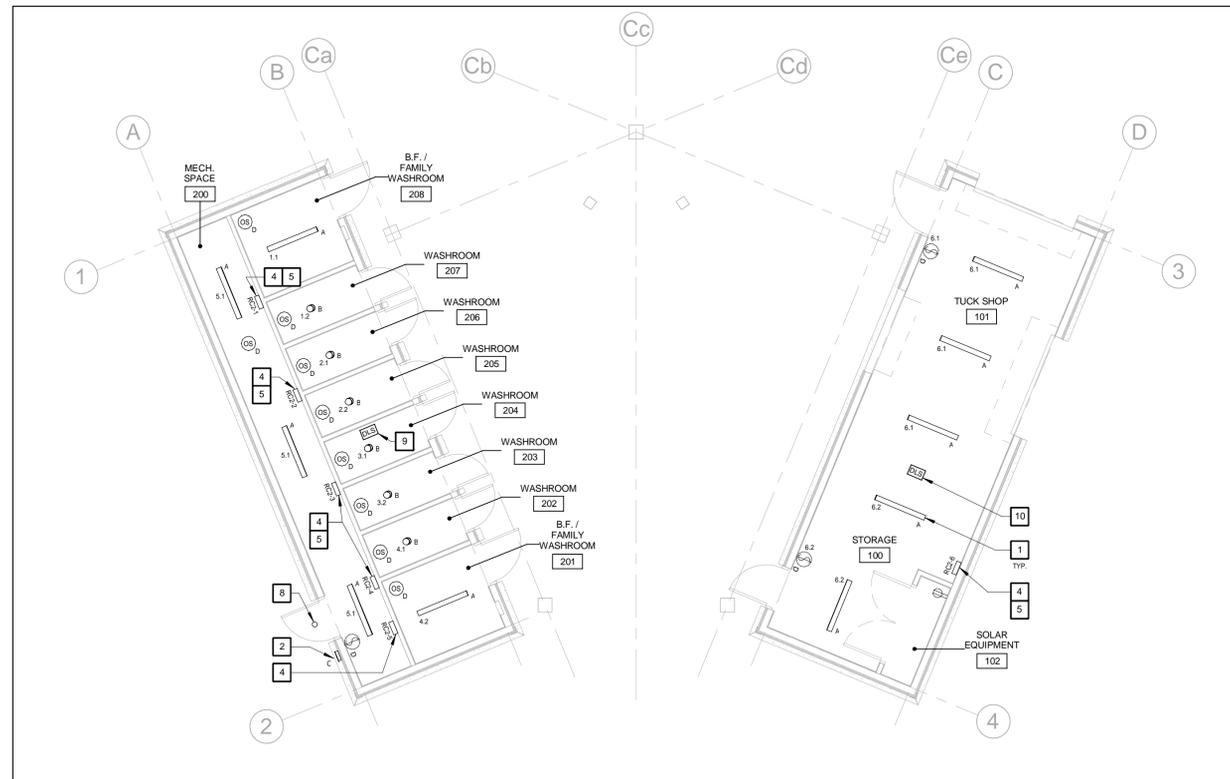**POWER NOTES:**

- 1 SOLAR PANEL POLE SHALL BE INSTALLED MAX. 50 METERS AWAY FROM BATTERY ENCLOSURES WITH PANEL FACING SOUTH. COORDINATE POLE LOCATION PER EXISTING SITE CONDITIONS. REFER TO SHOP DRAWINGS AND POLE INSTALLATION STRUCTURAL REQUIREMENTS AS DETAILED ON STRUCTURAL CONTRACT DRAWINGS.
- 2 SUPPLY AND INSTALL POLE BASE JUNCTION BOX FOR OVERHEAD TO UNDERGROUND TRANSITION OF THE SOLAR PANEL DC WIRING. JUNCTION BOX TO BE EEMAC4X PVC COATED HOT DIPPED GALVANIZED STEEL TYPE WITH VANDAL PROOF FASTENERS.
- 3 SUPPLY AND INSTALL SERVICE GROUND PER OESC. TWO (2) COPPER CLAD GROUND PLATES 315MM X 250MM /3MM AT 3 METERS INTERVAL BELOW GRADE IN DIRECT CONTACT WITH SOIL INTERCONNECTED WITH #4AWG BARE COPPER GROUNDING CONDUCTOR. PROVIDE AC AND DC SYSTEM GROUNDING AND BONDING WIRING AS DETAILED ON SINGLE LINE DIAGRAM.
- 4 PHOTOVOLTAIC DC SYSTEM POWER WIRING IN U/G DUCT BANK. AC AND DC SYSTEM GROUNDING DIRECT BURIED INSTALLED IN COMMON TRENCH.
- 5 REFER TO SHOP DRAWINGS FOR DC COMBINER ENCLOSURE INSTALLATION AND INTERCONNECTION REQUIREMENTS. SUPPLY ALL MANUFACTURER ACCESSORIES.
- 6 REFER TO SHOP DRAWINGS FOR DC TO AC INVERTER INSTALLATION AND INTERCONNECTION REQUIREMENTS. SUPPLY ALL MANUFACTURER ACCESSORIES.
- 7 REFER TO PANEL SCHEDULES.
- 8 CONDUIT STUB-UPS FOR INCOMER SOLAR POWER SERVICES. PROVIDE FLEX CONDUIT EXTENSIONS UP TO COMBINER ENCLOSURE (BOTTOM CONNECTION).
- 9 WASHROOM BUILDING POWER IN U/G DUCT BANK (THREE CIRCUITS: LIGHTING AND FAN POWER). THREE (3) RUNS OF 2C#12 RW190 + GND IN 35mm PVC CONDUIT. PROVIDE EMPTY 35mm PVC SPARE CONDUIT WITH PULL WIRE. CAP SPARE CONDUIT TERMINATIONS.

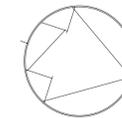

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**CYPRUS LAKE -  
HEAD OF TRAILS  
RENEWAL**

Drawing title / Titre du Dessin  
**ELECTRICAL POWER  
AND LIGHTING PLAN**

Plot Scale / Echelle

As indicated

Drawn by/ Dessin par  
JA Date  
2018- 07- 25

Field Recording by/  
Releve- Terrain par Date

Approved by/ Approuve par  
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2018- 07- 25

Project No./No. du projet Asset No. Sheet No./  
60576731 Feuille No.

Drawing Re No./No. du Dessin **E2**

SOLAR POWER DEMAND ASSESSMENT											
Panel DP-A	Room ID.	Description/Cat.#	Manuf.	Fixt. Watt	Volt	Qty.	Watt/Circuit	VA/Circuit	Runtime in h	Energy in Wh	Energy in VAh
CCT.# 1	SW BLD. LIGHTING	LXEN 435 XW RFA ED U SSL	Hubbell	18	120vac	5	90	112.5	6	540	575
		LF45L-DM1-NXE-11L-35K-8-IP65-CL-B6	Hubbell	12.7	120vac	6	76.2	95.25	7	533	666.8
CCT.# 2	NW BLD. LIGHTING	LXEN 435 XW RFA ED U SSL	Hubbell	18	120vac	5	90	112.5	6	540	675
		CY1 3K7 14 UNV XXX F. FPP PCU SF	Hubbell	15	120vac	1	15	18.75	12	180	225
CCT.# 3	EXHAUST FAN EF-1	SQ-90-D HIGH EFFICIENCY FAN	N/A	75	120vac	1	75	93.75	3.6	270	337.5
CCT.# 4	EXHAUST FAN EF-2	SQ-90-D HIGH EFFICIENCY FAN	N/A	75	120vac	1	75	93.75	3.6	270	337.5
CCT.# 5	REC. CCT.1- POS MACHINE CHARGER	MAX 50W BATTERY CHARGER	N/A	50	120vac	1	50	62.5	12	600	750
CCT.# 6	REC. CCT.2- LAPTOP CHARGER	MAX 70W BATTERY CHARGER	N/A	70	120vac	1	70	87.5	8	560	700
N/A	SOLAR INVERTER CONEXT SW	INTERNAL LOSSES	Schneider	-	-	-	35	43.75	24	840	1050
							<b>576.2</b>	<b>720.25</b>		<b>4333</b>	

LIGHTING FIXTURE SCHEDULE								
TPYE	MANUFACTURER	MODEL	DESCRIPTION	INPUT WATTS	VOLT	LAMP	MOUNTING	CAT.#
A	HUBBELL	LXEN SERIES	LED STRIP 2200 LUMEN	18	120	LED	CEILING SUSPENDED 3.2 AFF	LXEN 435 XW RFA ED U SSL
B	HUBBELL	LF45L SERIES	LED DOWNLIGHT 1100 LUMEN	12.7	120	LED	CEILING RECESSED 3.2 AFF	LF45L-DM1-NXE-11L-35K-8-XX-IP65-CL-B6
C	HUBBELL	CY1 SERIES	LED WALL PACK 1500 LUMEN	15	120	LED	WALL MOUNT 3.2 AFF	CY1-15 3K7 14 UNV DBF FPP SF








Panel	DP-A	NEW	EXISTING	MOUNTING	SURFACE	FLUSH
VOLTAGE:	240/120V			ENCLOSURE:	EEMAC 1	
PHASE:	1 PHASE, 3 WIRE			TYPE:	MAIN LUGS	MAIN CIRCUIT BREAKER
MAINS:	60 AMP			CB RATING:	2P 20A 10KA	
LOCATION:	MECH/ELEC. RM			INT. RATING:	10 KA RMS SYM	

Description	VA	Breaker	Breaker	VA	Description
SW BLD. LIGHTING	238	15A	1	15A	SERVICE RECEPTACLE (IMMEDIATE USE ONLY)
EXHAUST FAN EF-1	84	15A	3	15A	NW BLD. LIGHTING + WALLPACK
REC. CCT.1- POS MACHINE CHARGER	63	15A	5	15A	REC. CCT.2- LAPTOP CHARGER
SPARE (Note 1)	-	15A	7	15A	EXHAUST FAN EF-2
SPARE (Note 1)	-	15A	5	15A	SPARE (Note 1)
SPARE (Note 1)	-	15A	11	15A	SPARE (Note 1)

PHASE A TOTAL (VA)	359	CONNECTED LOAD (VA)	679.00
PHASE B TOTAL (VA)	320	DEMAND LOAD (VA)	475.30
		DEMAND CURRENT (A)	3.96



DRAWING NO. DRAWING NAME

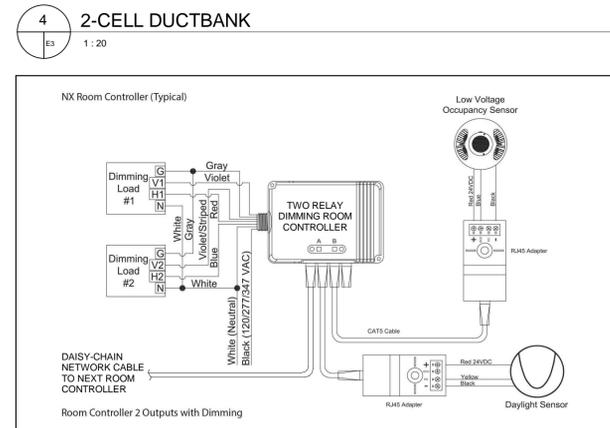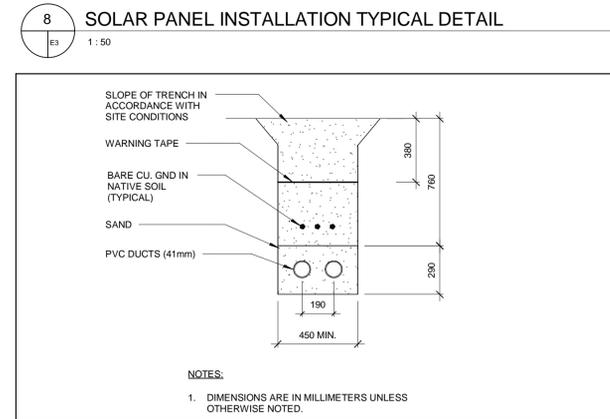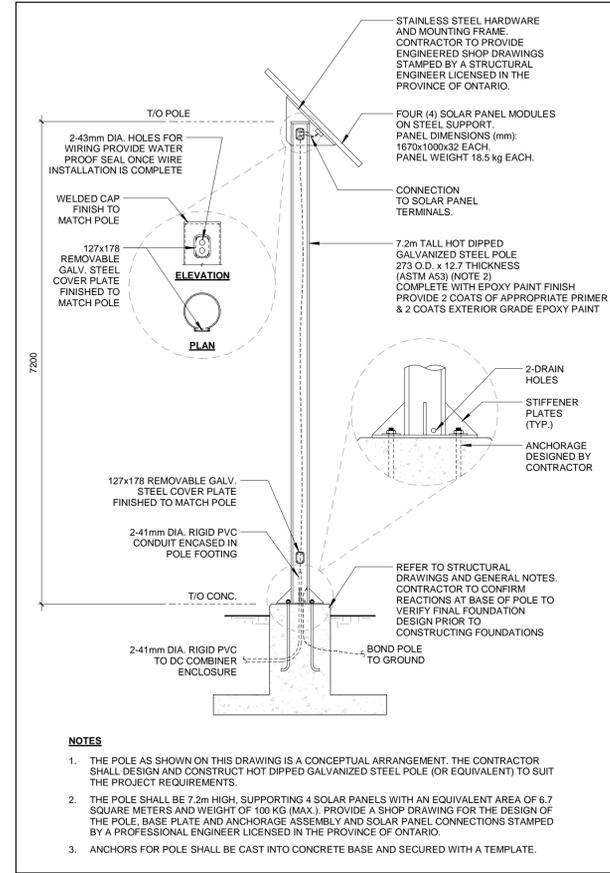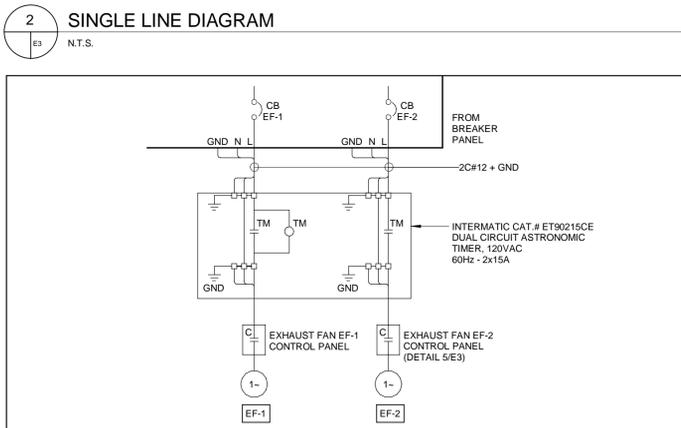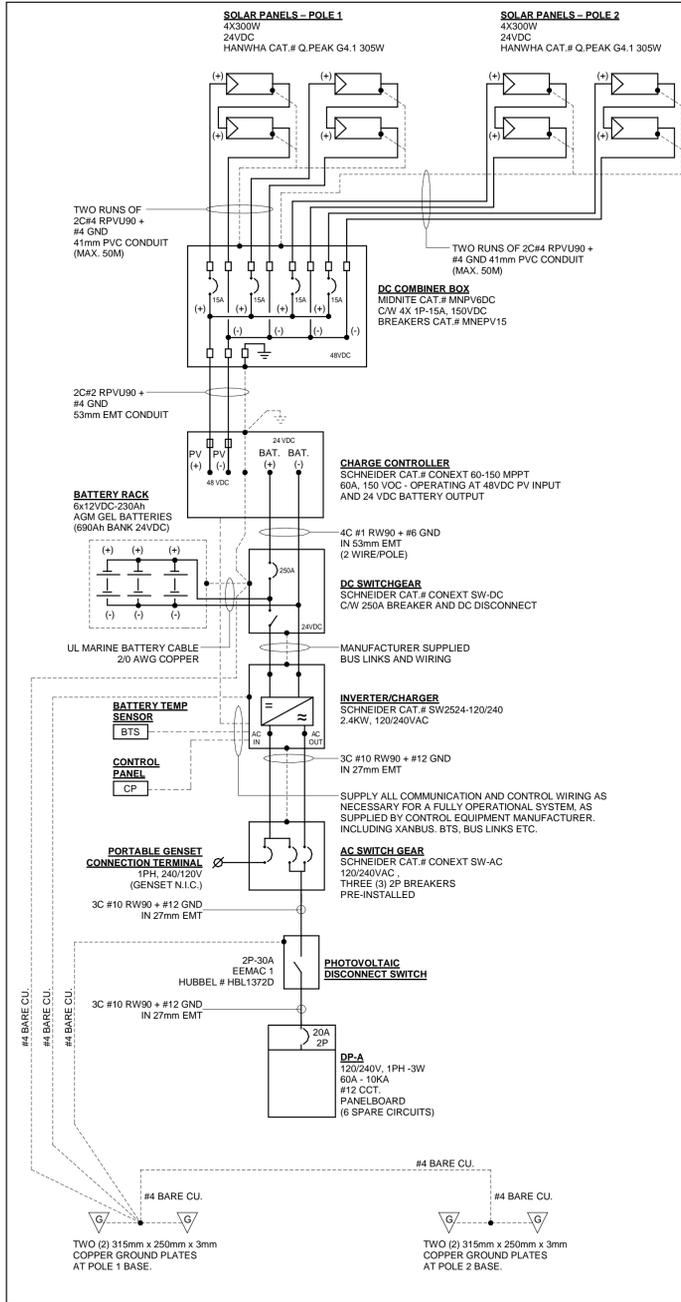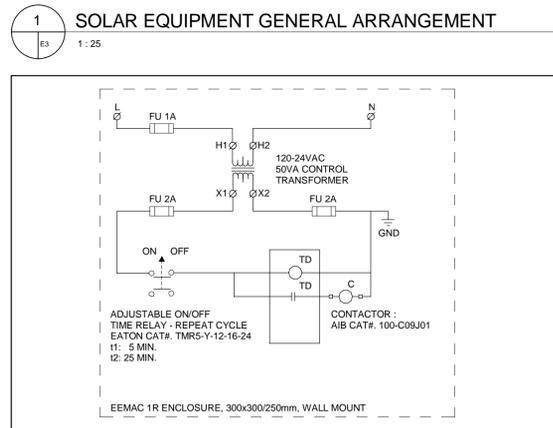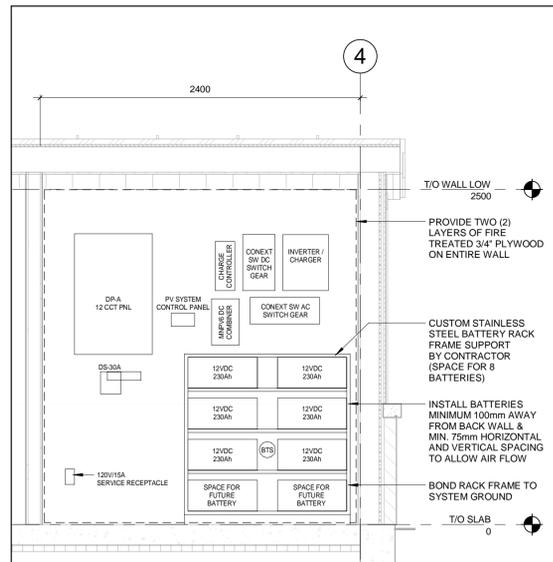REFERENCE DRAWINGS

NO.	DATE	DESCRIPTION	Drawn by/ Dessine par	Approved/ Approuve
1	2018-08-16	ISSUED FOR TENDER	JA	RP

REVISIONS

A	B	A Detail Number	A Numero de Detail
		B Sheet Number	B Sur feuille Numero

LINEAR DIMENSIONS IN MILLIMETERS Dimensions lineaires en millimetres

Parcs Canada Parks Canada

# Canada

PARKS CANADA

Type of Record / Type d'enregistrement

Project title / Titre du projet  
**CYPRUS LAKE - HEAD OF TRAILS RENEWAL**

Drawing title / Titre du Dessin  
**ELECTRICAL DETAILS & SCHEDULES**

Plot Scale / Echelle  
As indicated

Drawn by/ Dessin par	Date
JA	2018-07-25

Field Recording by/ Relevé- Terrain par	Date

Approved by/ Approuve par	Date
RP	2018-07-25

Checked by/ Verifie par	Date
MB	2018-07-25

Project No./No. du projet	Asset No.	Sheet No./ Feuille No.
60576731		<b>E3</b>

Drawing Re No./No. du Dessin