



LOCATION PLAN

N.T.S.

TUNNEL MOUNTAIN VILLAGE 1


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1	2018.05.23	ISSUED FOR TENDER	SS	DF	TM

Rev.	Date	Description	Drawn Dessiné	Designed Conçu	Approved Approuvé
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Consultant's Stamp
Sceau de l'expert-conseil

Eng. Stamp
Sceau de l'ingénieur

McElhanney Consulting Services Ltd.
PERMIT NUMBER: P 6383
The Association of Professional Engineers, Geologists and Geophysicists of Alberta

PROFESSIONAL ENGINEER ALBERTA
ANGUST 18 2018
PERMIT NUMBER: P243

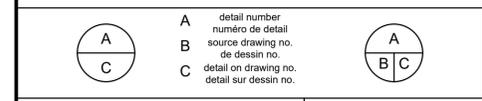Client

Parks Canada Agency
Western and Northern Region

L'Agence Parcs Canada
Ouest et Nord du Canada

Consultant's Name
Nom de l'expert-conseil

McElhanney
McElhanney Consulting Services Ltd.

Project Title
Titre du projet

TUNNEL MOUNTAIN VILLAGE 1

BANFF, AB
BANFF NATIONAL PARK

Drawing Title
Titre du dessin

LOCATION PLAN & INDEX


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2511-00954-00		C-001
Drawing Reference No. / No. de référence du dessin		

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LEGEND	
PROPOSED WATER MAIN & VALVE	1 C-304, 2 C-304, 4 C-304, 1 C-305
PROPOSED FIRE HYDRANT	6 C-304
PROPOSED DRAIN WELL OR AIR RELEASE STRUCTURE	2 C-305, 4 C-305, 5 C-305
EXISTING WATER MAIN & VALVE	

- NOTES**
- CONTRACTOR TO VERIFY THE ALIGNMENT AND INVERT OF THE EXISTING WATER SERVICE ENTERING THE LOOP WASHROOMS, VILLAGE 1 KIOSK AND RV DUMP STATION AND NOTIFY ENGINEER OF ANY CONFLICTS OR DISCREPANCIES. CONNECTION TO THE EXISTING SANITARY AND WATER SERVICES ARE TO BE MADE 0.5m OUTSIDE THE WASHROOM/KIOSK BUILDING FOOTPRINT.
 - ALL WATER STANDPIPES TO BE BLUE AND HAVE 0.5 INCH HOSE BIBS (THREADED) AS PER DETAIL 3 ON DRAWING C-305.
 - ALL 1.5" THREADED HYDRANTS TO BE RED AND HAVE 1.5 INCH REGULAR SIZE NOZZLE CONNECTION AS PER DETAIL 6 ON DRAWING C-305.
 - ALL HYDRANTS TO BE INSTALLED AS PER DETAIL 6 ON DRAWING C-304.

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1	2018.05.23	ISSUED FOR TENDER	SS	DF	TM

<p>Consultant's Stamp Sceau de l'expert-conseil</p> <p>McElhanney Consulting Services Ltd. PERMIT NUMBER: P 6383 The Association of Professional Engineers, Geologists and Geophysicists of Alberta</p>	<p>Eng. Stamp Sceau de l'ingénieur</p> <p>PROFESSIONAL ENGINEER August 9, 2018 PERMIT NUMBER: P243</p>
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Client

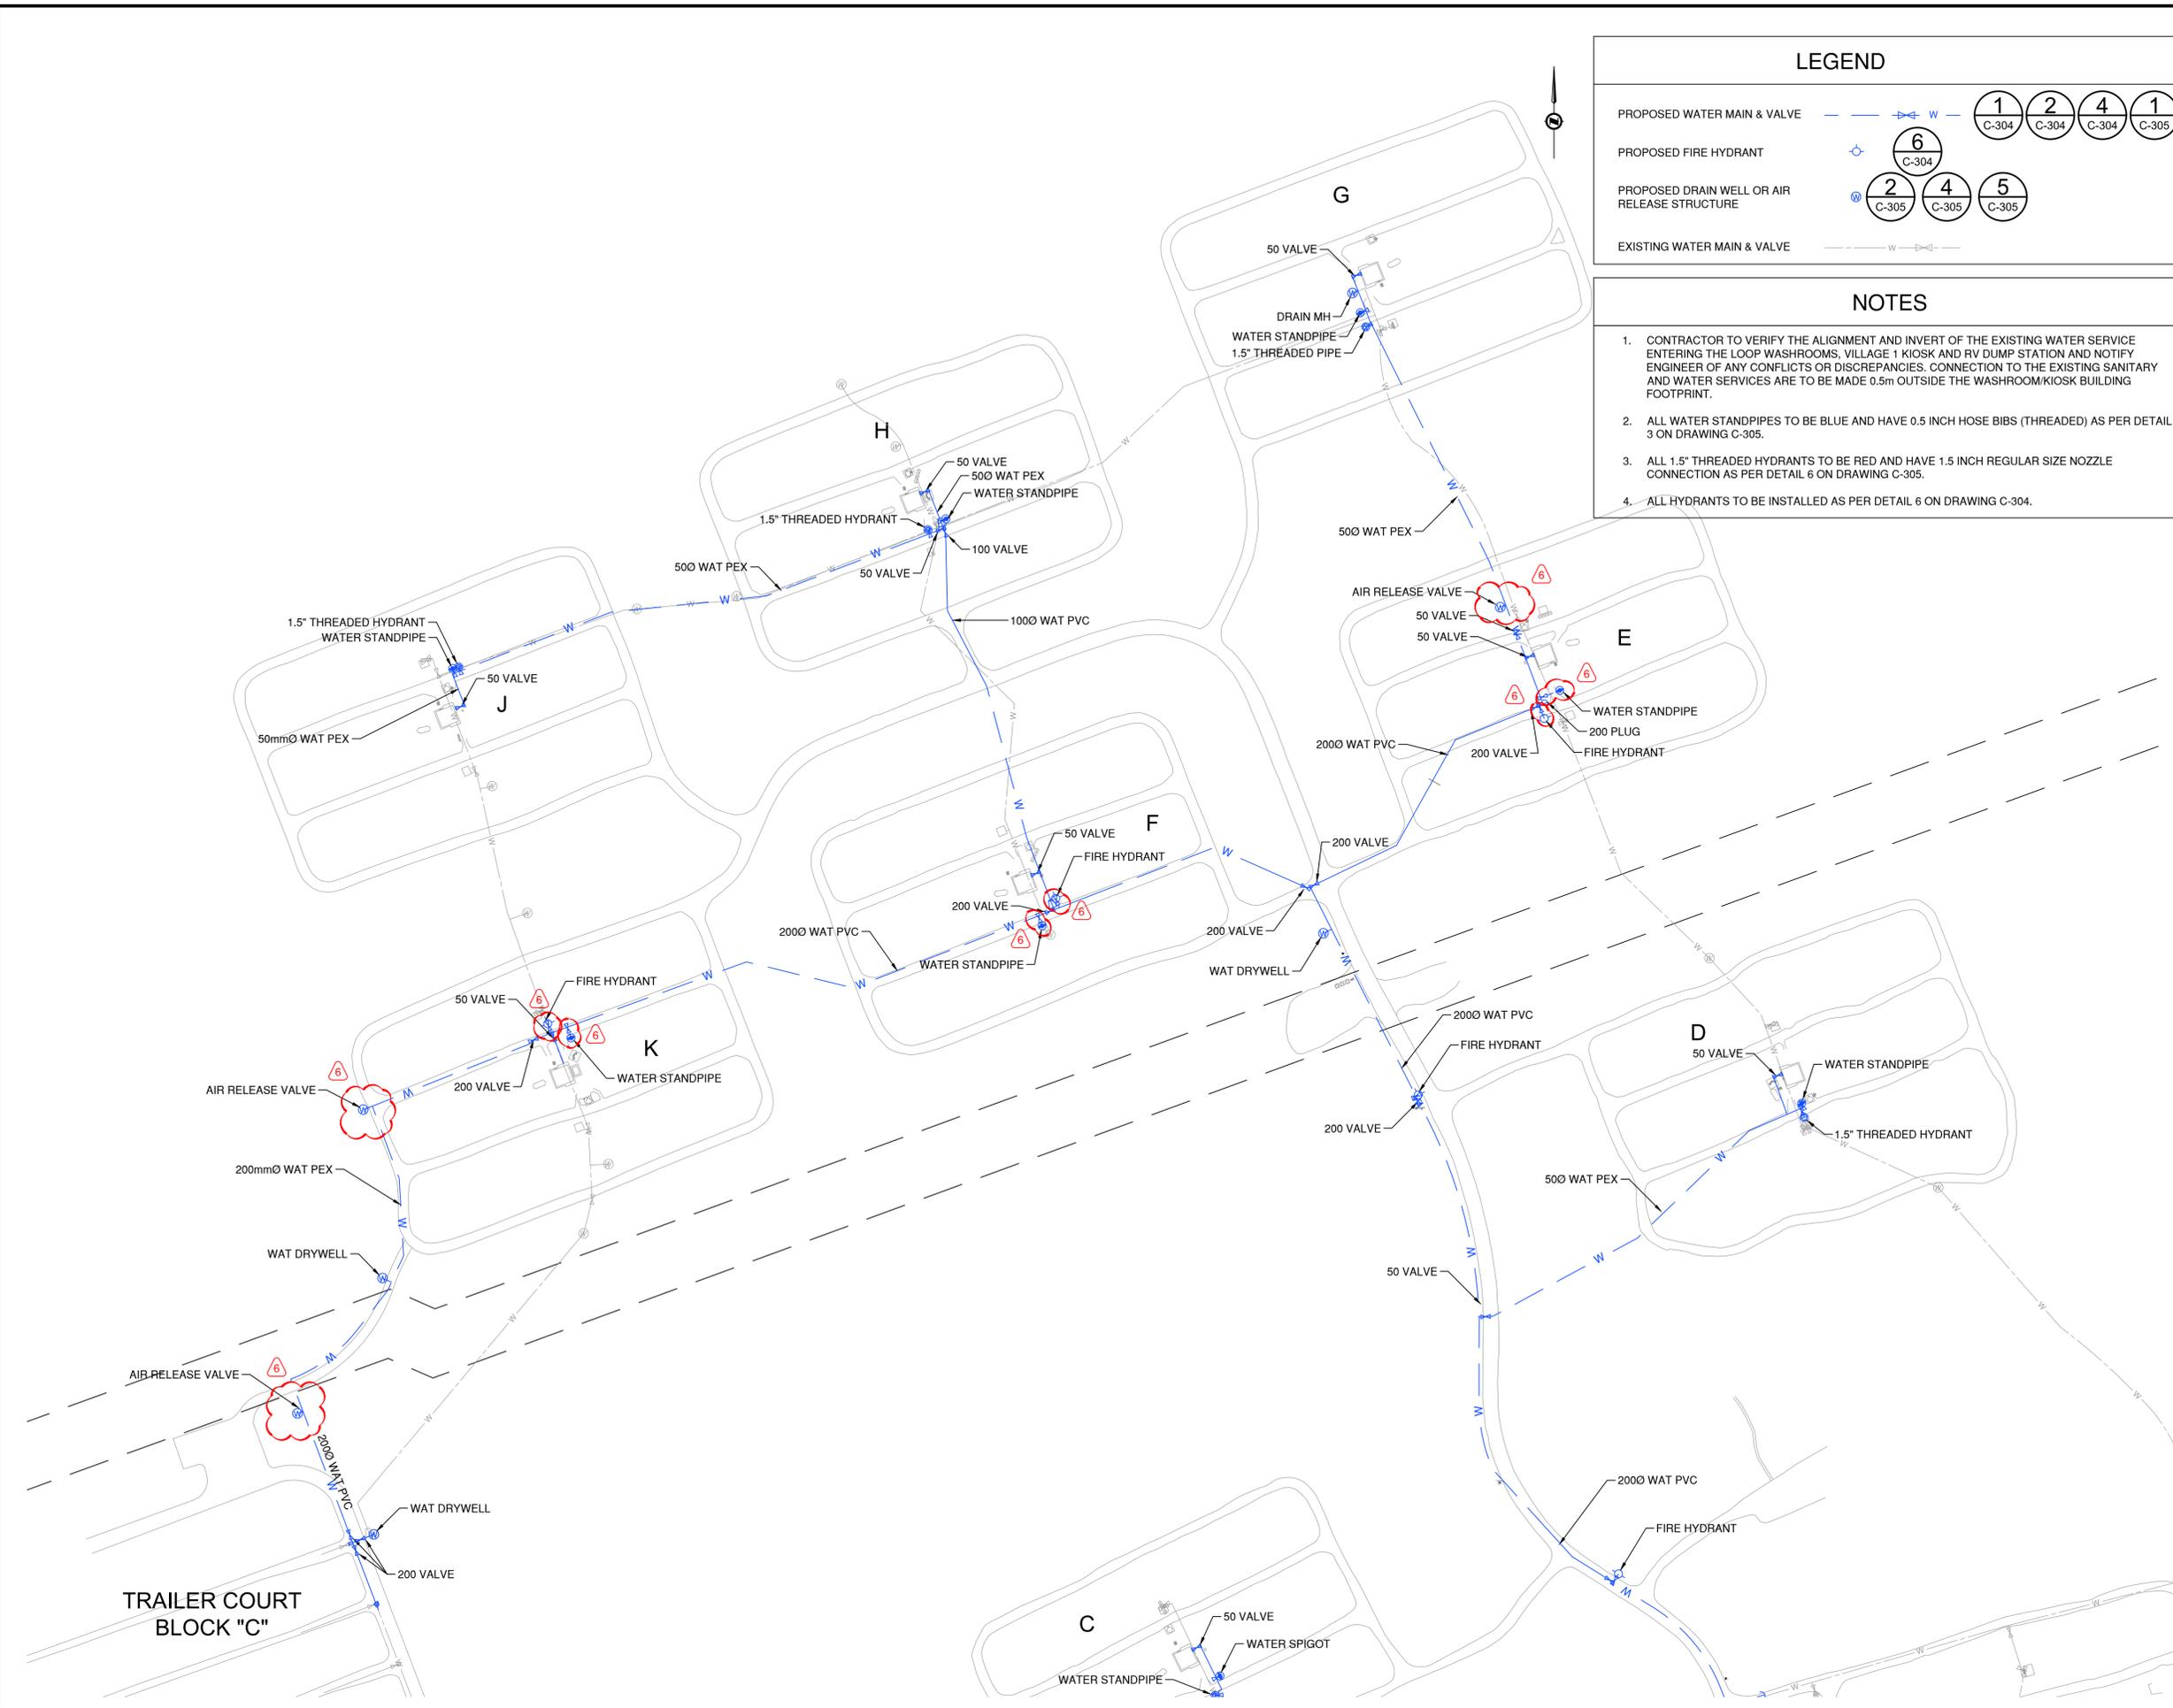Parks Canada Agency Western and Northern Region	L'Agence Parcs Canada Ouest et Nord du Canada
--	--

Consultant's Name
Nom de l'expert-conseil

McElhanney
McElhanney Consulting Services Ltd.

Project Title
Titre du projet

TUNNEL MOUNTAIN VILLAGE 1

BANFF, AB
BANFF NATIONAL PARK

Drawing Title
Titre du dessin


PROPOSED WATER LAYOUT PLAN SHEET 1 OF 2

Surveyed by / Arpenté par	Drawn by / Dessiné par	Date
	SS	2018.03.26
Designed by / Conçu par	Reviewed by / Révisé par	Scale / Echelle
DF	TM	1:1500

Parks Canada Project Manager / Administrateur de Projets Parcs Canada

Client Acceptance / Acceptation du client	Approved by / Approuvé par
<p>Project No. / No. du projet</p> <p>2511-00954-0</p>	<p>Asset No. / No. du-bien</p> <p></p>
<p>Drawing Reference No. / No. de référence du dessin</p> <p>C-111</p>	

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LEGEND

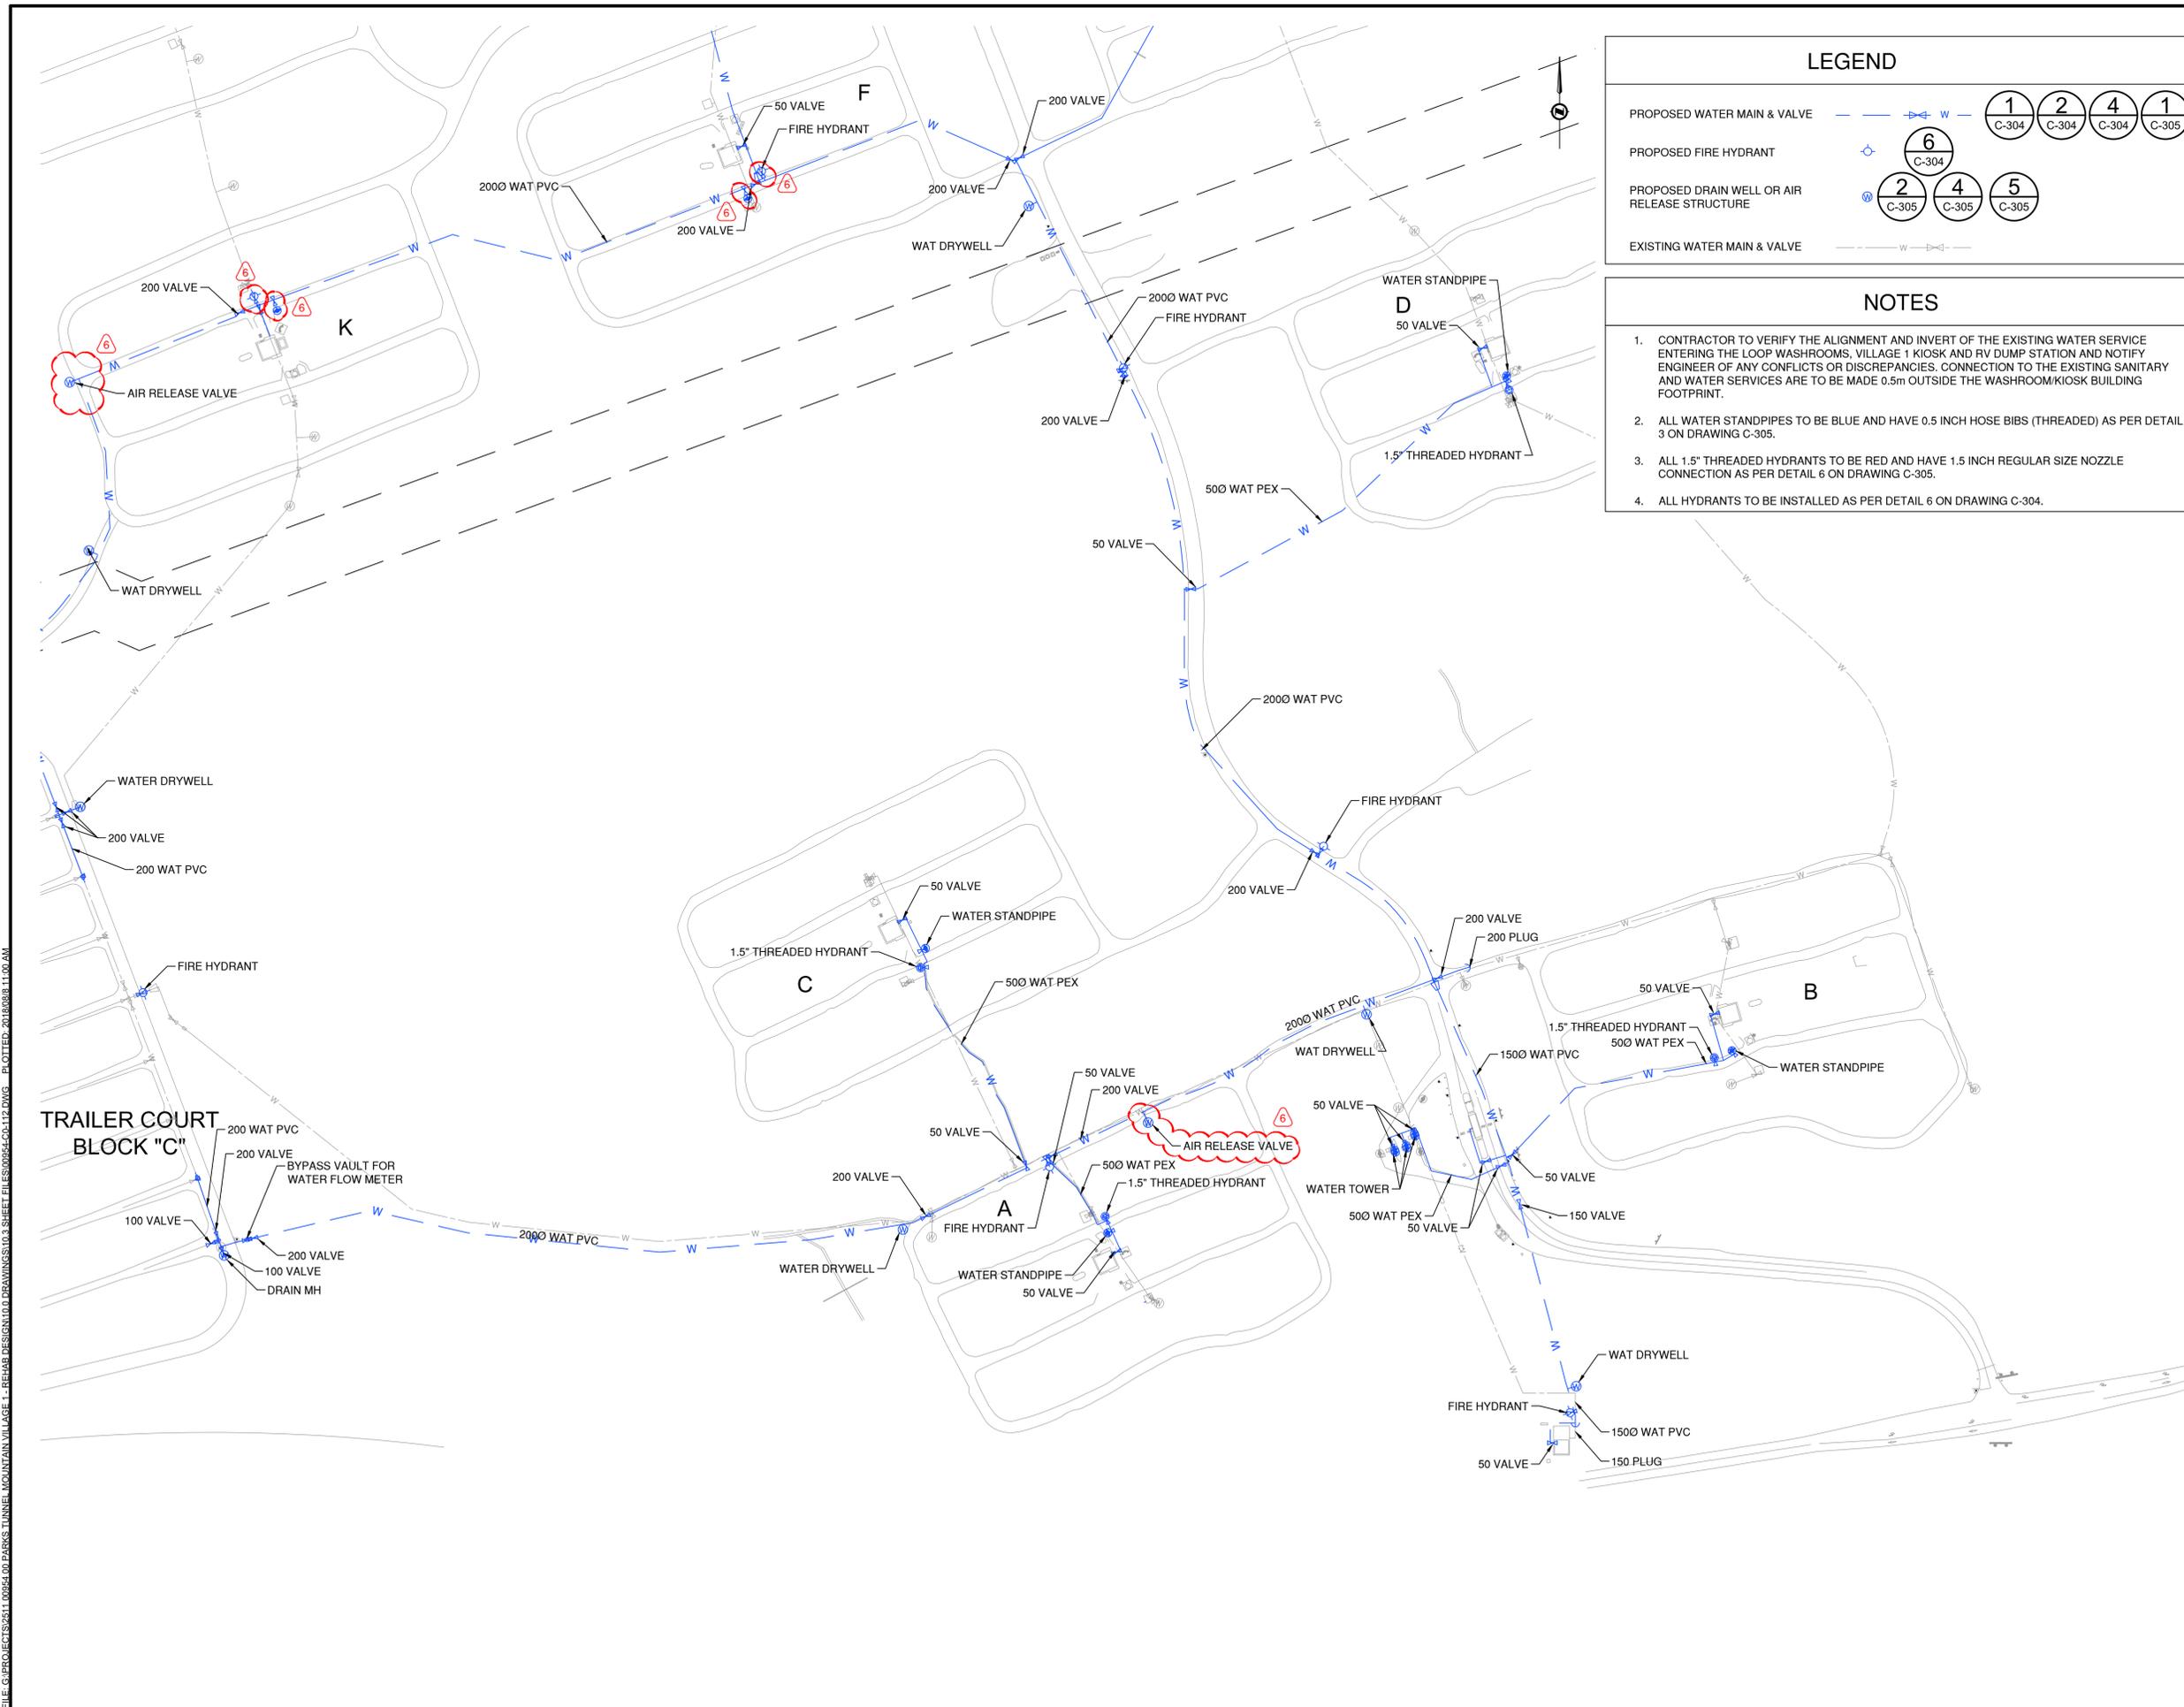PROPOSED WATER MAIN & VALVE

PROPOSED FIRE HYDRANT

PROPOSED DRAIN WELL OR AIR RELEASE STRUCTURE

EXISTING WATER MAIN & VALVE

- ### NOTES
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 - ALL WATER STANDPIPES TO BE BLUE AND HAVE 0.5 INCH HOSE BIBS (THREADED) AS PER DETAIL 3 ON DRAWING C-305.
 - ALL 1.5" THREADED HYDRANTS TO BE RED AND HAVE 1.5 INCH REGULAR SIZE NOZZLE CONNECTION AS PER DETAIL 6 ON DRAWING C-305.
 - ALL HYDRANTS TO BE INSTALLED AS PER DETAIL 6 ON DRAWING C-304.

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A B C	detail number numéro de détail source drawing no. de dessin no. detail on drawing no. détail sur dessin no.	A B C
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Client

Parks Canada Agency Western and Northern Region	L'Agence Parcs Canada Ouest et Nord du Canada
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Consultant's Name
Nom de l'expert-conseil

McElhanney
McElhanney Consulting Services Ltd.

Project Title
Titre du projet

TUNNEL MOUNTAIN VILLAGE 1

BANFF, AB
BANFF NATIONAL PARK

Drawing Title
Titre du dessin

PROPOSED WATER LAYOUT PLAN SHEET 2 OF 2


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Parks Canada Project Manager / Administrateur de Projets Parcs Canada

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2511-00954-0		C-112
Drawing Reference No. / No. de référence du dessin		

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LEGEND	
PROPOSED GAS	
PROPOSED GAS VALVE	
EXISTING PROPANE TANK	

NOTES	
1.	SEE PLAN PROFILE FOR GAS CONNECTION TO BACK OF BUILDING (TYP).
2.	SEE DRAWING C-118 FOR EXISTING PROPANE TANK SALVAGING.
3.	SEE DETAIL ON C-302 FOR RISER AND VALVE ASSEMBLY.

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Client 	L'Agence Parcs Canada Ouest et Nord du Canada
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Consultant's Name Nom de l'expert-conseil
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Project Title Titre du projet TUNNEL MOUNTAIN VILLAGE 1 BANFF, AB BANFF NATIONAL PARK
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Drawing Title Titre du dessin PROPOSED GAS LAYOUT PLAN SHEET 1 OF 2
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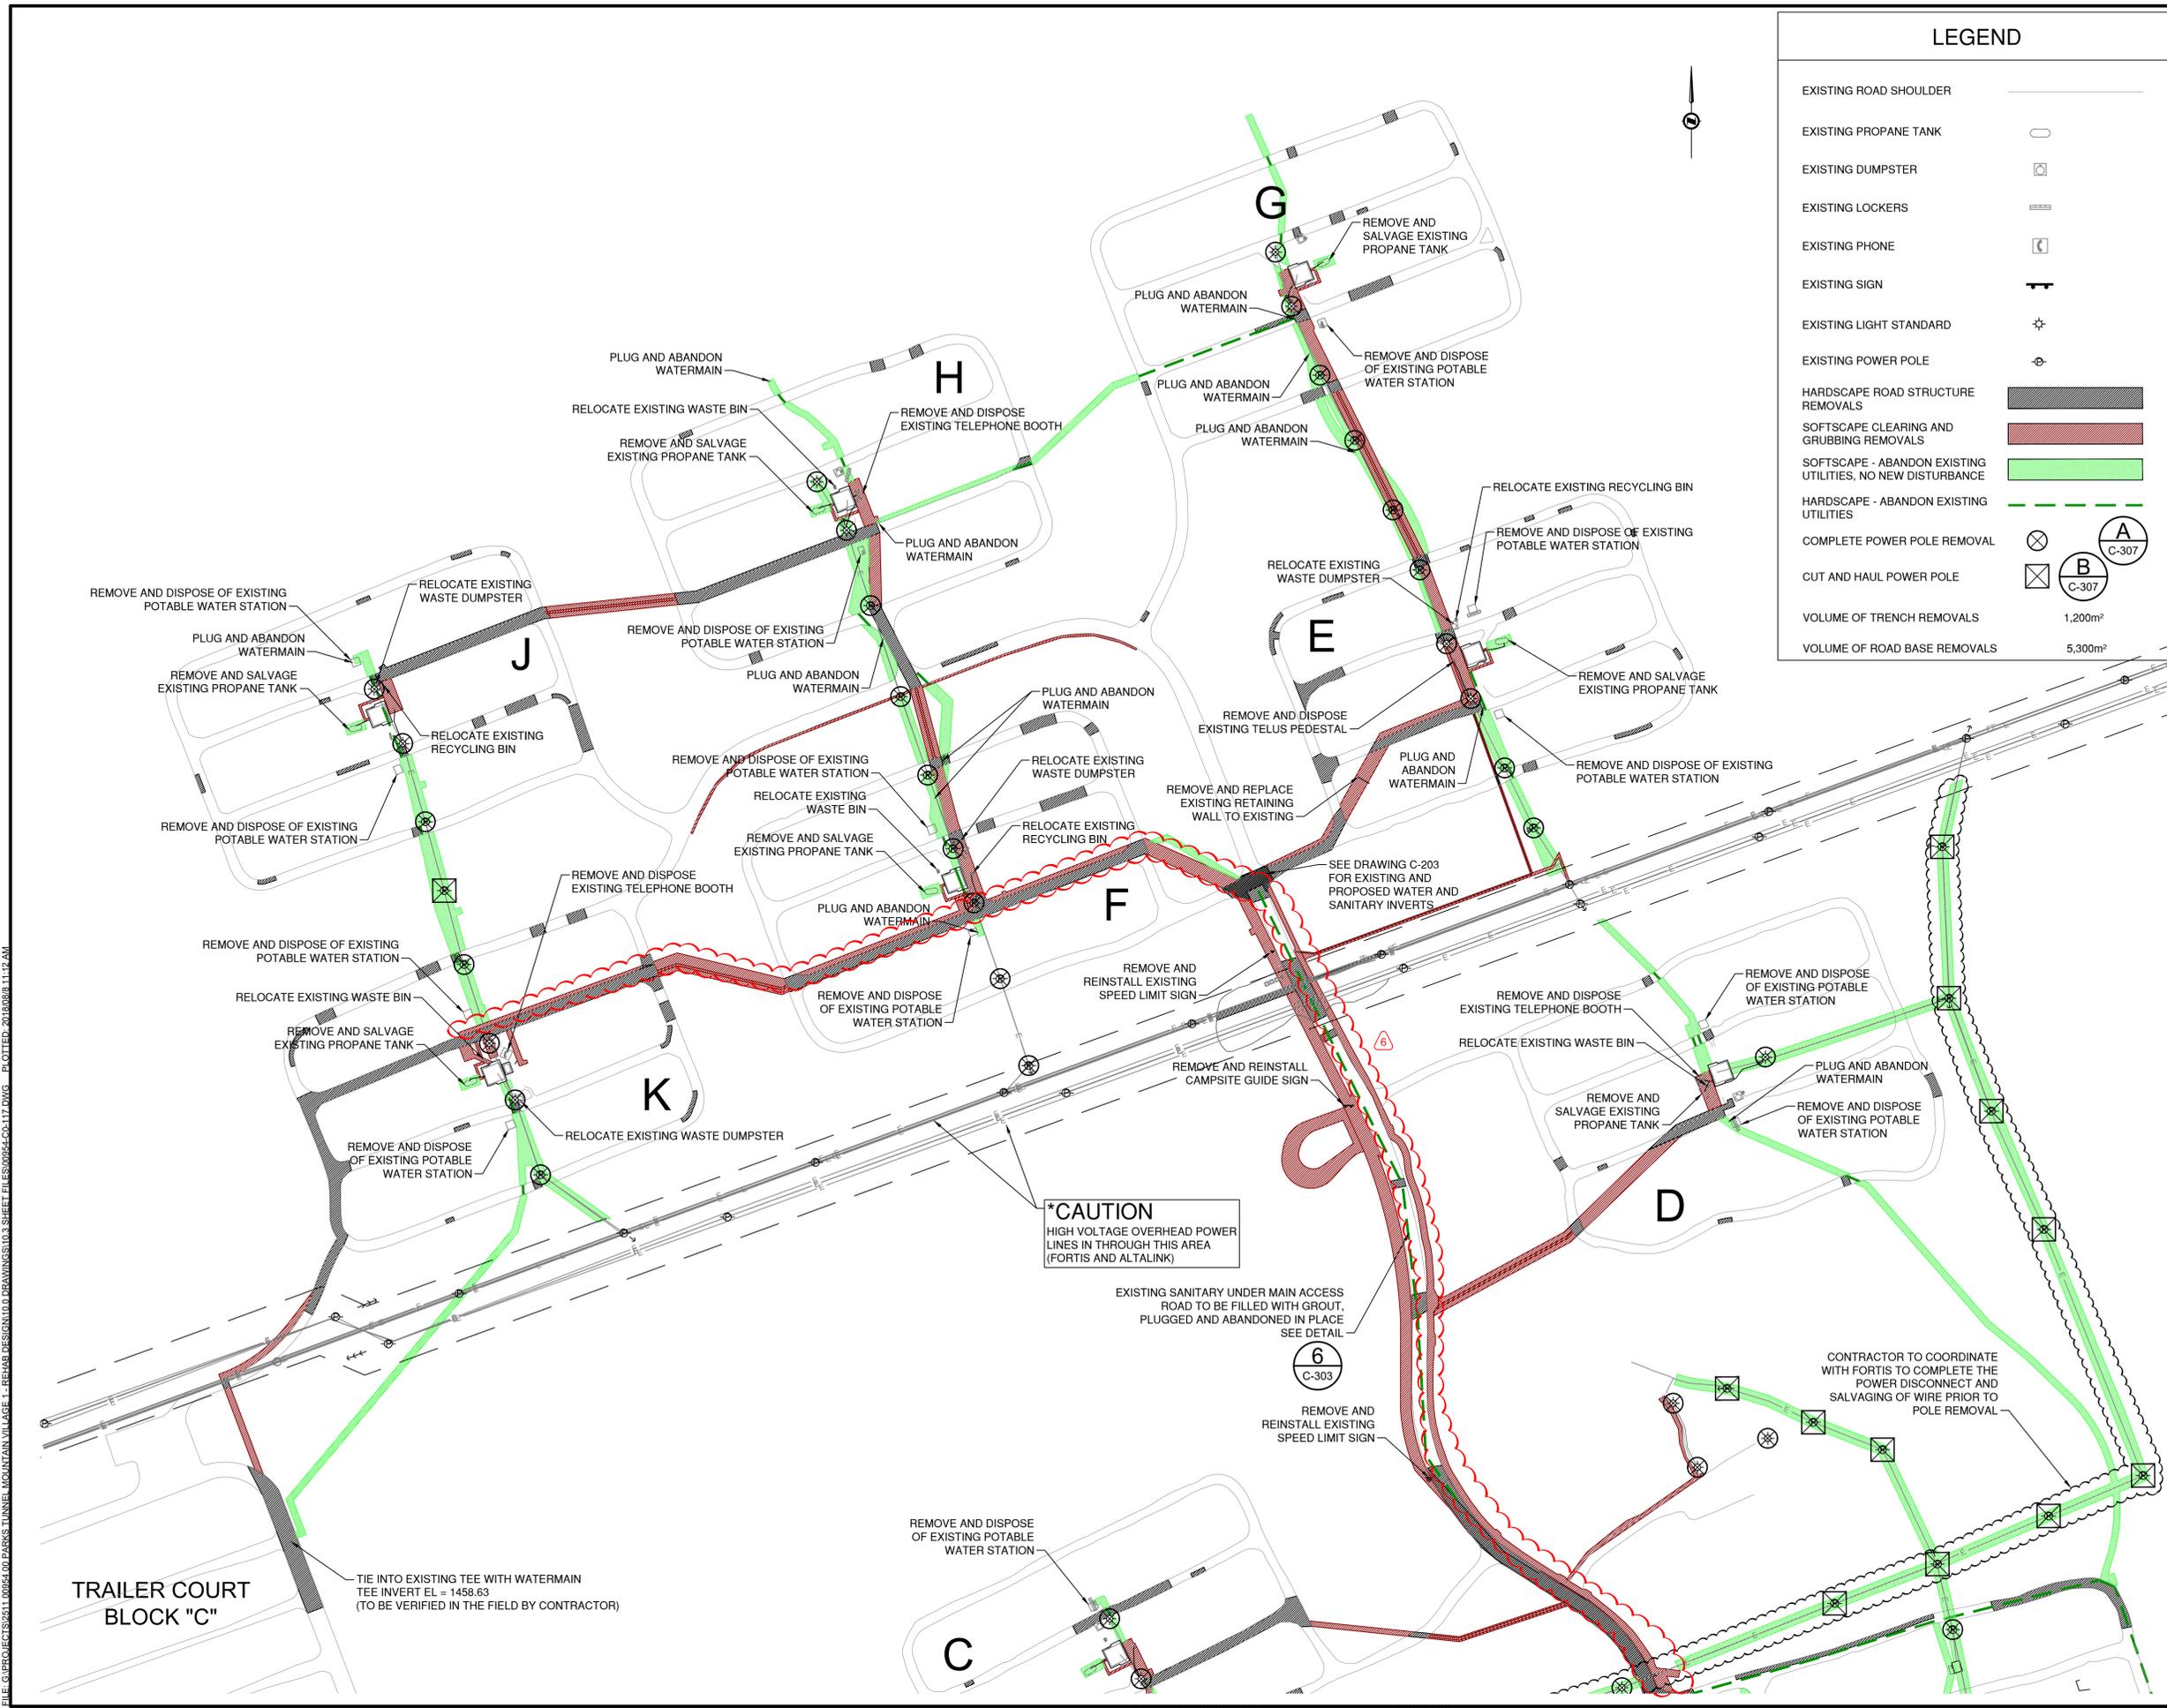
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Drawing Reference No. / No. de référence du dessin		
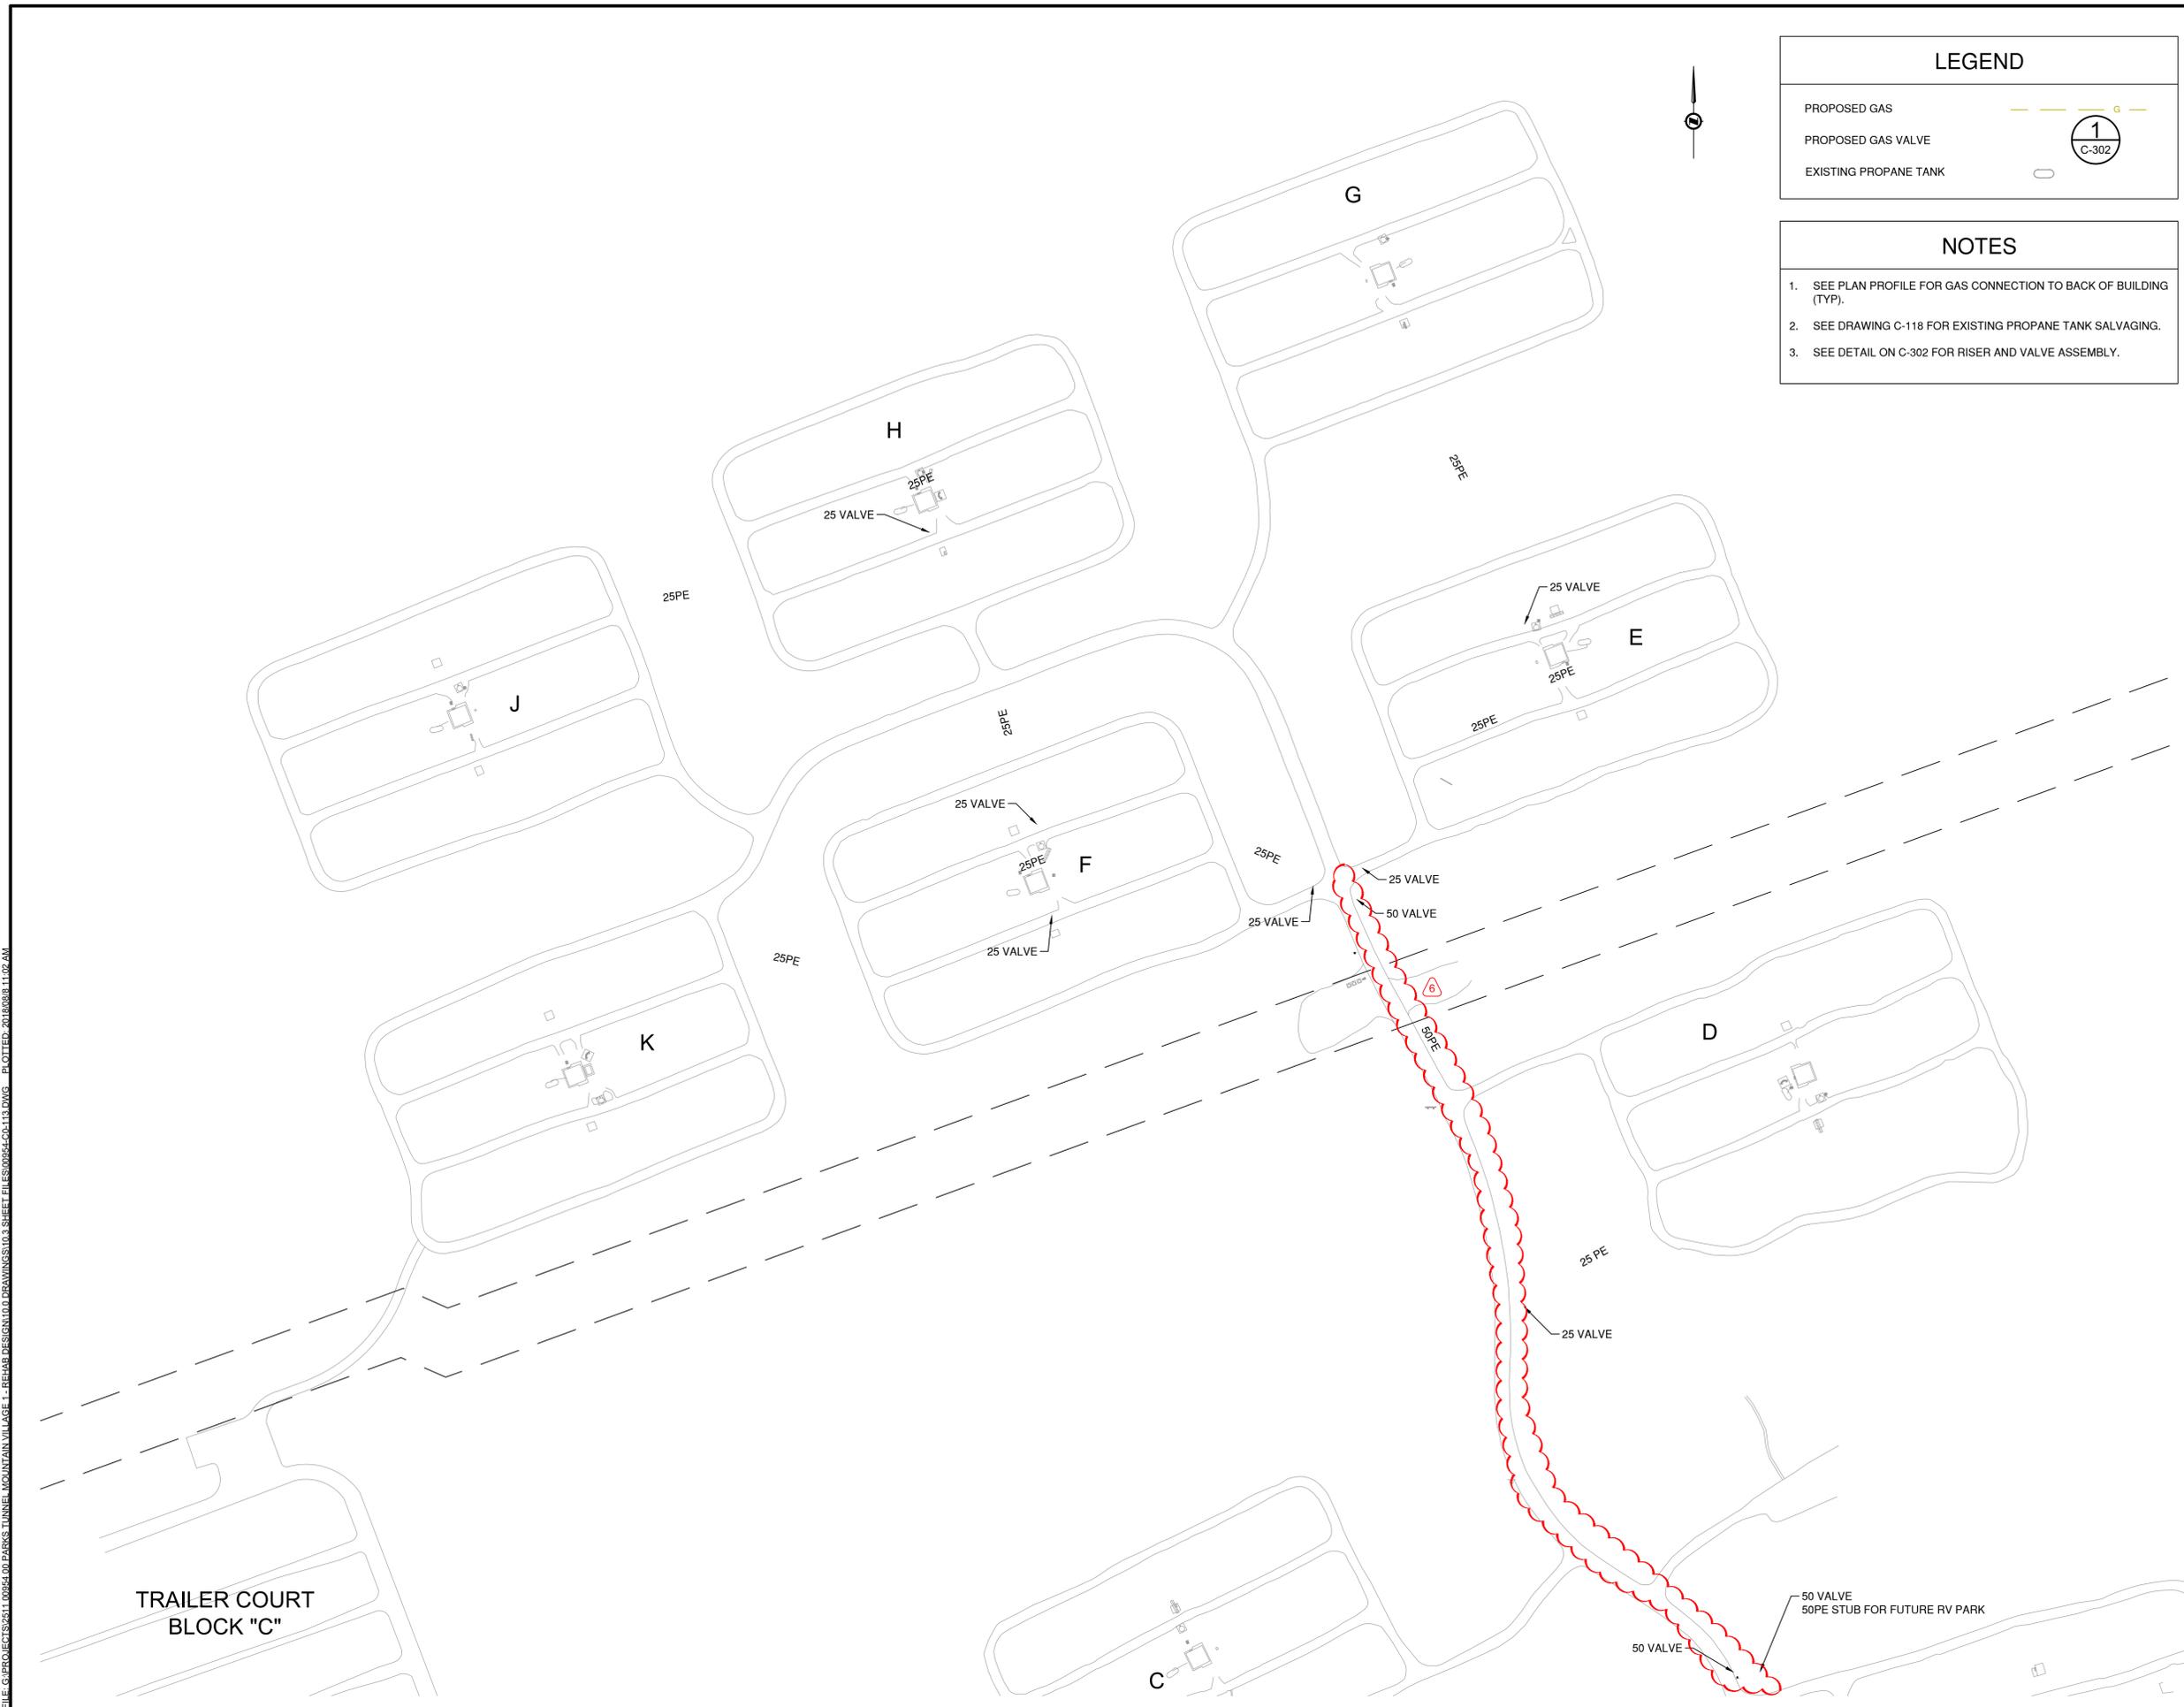
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LEGEND

EXISTING ROAD SHOULDER	
EXISTING PROPANE TANK	
EXISTING DUMPSTER	
EXISTING LOCKERS	
EXISTING PHONE	
EXISTING SIGN	
EXISTING LIGHT STANDARD	
EXISTING POWER POLE	
HARDSCAPE ROAD STRUCTURE REMOVALS	
SOFTSCAPE CLEARING AND GRUBBING REMOVALS	
SOFTSCAPE - ABANDON EXISTING UTILITIES, NO NEW DISTURBANCE	
HARDSCAPE - ABANDON EXISTING UTILITIES	
COMPLETE POWER POLE REMOVAL	
CUT AND HAUL POWER POLE	
VOLUME OF TRENCH REMOVALS	1,200m ²
VOLUME OF ROAD BASE REMOVALS	5,300m ²

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	A detail number numéro de détail		B detail number numéro de détail
	C detail on drawing no. détail sur dessin no.		A/B/C detail on drawing no. détail sur dessin no.

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Sceau de l'expert-conseil

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PERMIT NUMBER: P 6383

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INGÉNIEUR

ANGUS... 2018
PERMIT NUMBER: P243

Client

Parks Canada Agency
Western and Northern Region

L'Agence Parcs Canada
Ouest et Nord du Canada

Consultant's Name
Nom de l'expert-conseil

McElhanney
McElhanney Consulting Services Ltd.

Project Title
Titre du projet

TUNNEL MOUNTAIN VILLAGE 1

BANFF, AB
BANFF NATIONAL PARK

Drawing Title
Titre du dessin

PROPOSED DEMOLITION AND REMOVALS PLAN SHEET 1 OF 2


Surveyed by / Arpenté par	Drawn by / Dessiné par	Date
	SS	2018.04.03
Designed by / Conçu par	Reviewed by / Révisé par	Scale / Echelle
DF	TM	1:1500

Parks Canada Project Manager / Administrateur de Projets Parcs Canada

Client Acceptance / Acceptation du client	Approved by / Approuvé par	
Project No. / No. du projet	Asset No. / No. du-bien	Sheet No. / No. de la feuille
2511-00954-0		C-117
Drawing Reference No. / No. de référence du dessin		

LEGEND

PREVIOUSLY DISTURBED AREA - EXISTING UTILITY ALIGNMENTS TO BE RE-DISTURBED WITH NEW UTILITIES		9,470m ²
BRAND NEW DISTURBED AREA TO STAY DISTURBED (PREVIOUSLY UNDISTURBED)		6,830m ²
PREVIOUSLY DISTURBED HARD SURFACE AREAS TO BE RE-DISTURBED AND RE-CONSTRUCTED		12,130m ²
UTILITIES TO BE ABANDONED IN SOFT AREAS AND NO NEW DISTURBANCE		16,705m ²
UTILITIES TO BE ABANDONED IN HARD SURFACE AREAS		

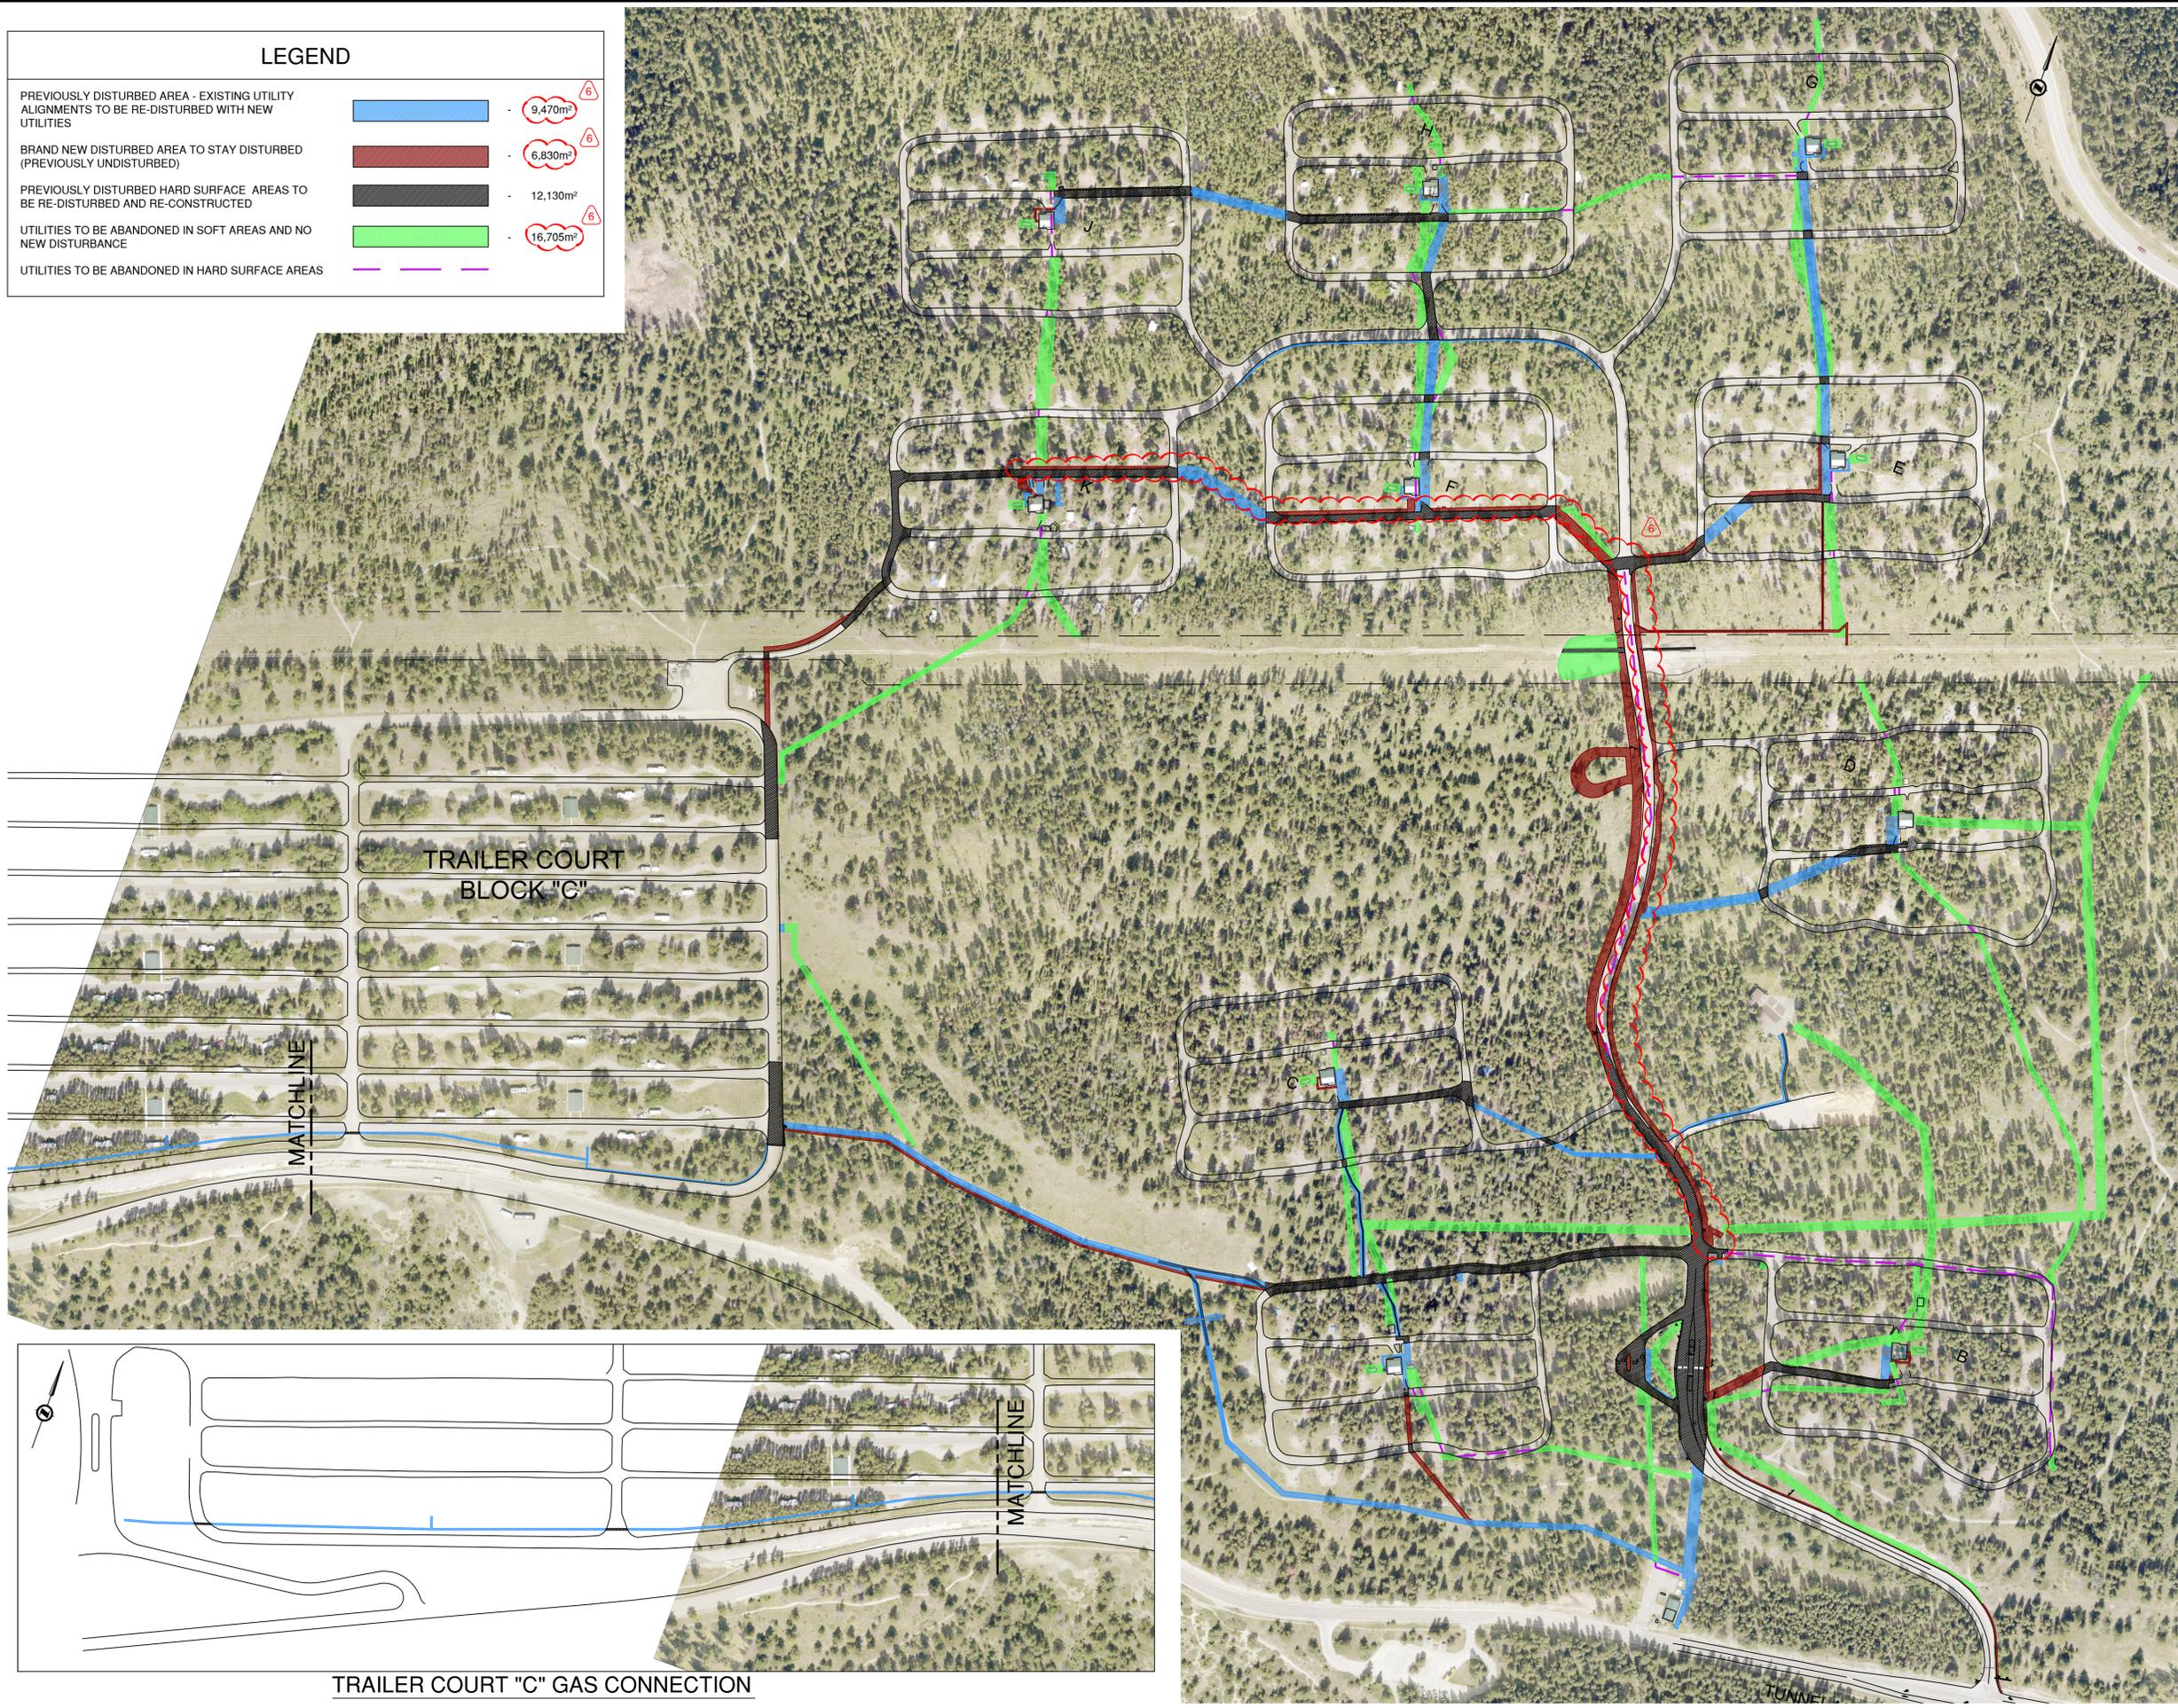


TRAILER COURT "C" GAS CONNECTION

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6	2018.08.08	ADDENDUM 1	SS	DF	TM
5	2018.07.20	RE ISSUED FOR TENDER - FINAL	SS	DF	TM
4	2018.07.03	RE ISSUED FOR TENDER - FINAL	SS	DF	TM
3	2018.06.22	RE ISSUED FOR TENDER - FINAL	SS	DF	TM
2	2018.06.11	ISSUED FOR TENDER - FINAL	SS	DF	TM
1	2018.05.23	ISSUED FOR TENDER	SS	DF	TM

Rev.	Date	Description	Drawn Dessiné	Designed Conçu	Approved Approuvé
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Consultant's Stamp
Sceau de l'expert-conseil

Eng. Stamp
Sceau de l'ingénieur

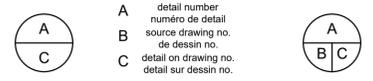PERMIT TO PRACTICE
McELHANNEY CONSULTING SERVICES LTD.
PERMIT NUMBER: P 6383

The Association of Professional Engineers,
Geologists and Geophysicists of Alberta

PROFESSIONAL ENGINEER
MONTREAL F. FOMER
AVGUST 19 2018
PERMIT NUMBER: P243

Client

Parks Canada Agency
Western and Northern Region

L'Agence Parcs Canada
Ouest et Nord
du Canada

Consultant's Name
Nom de l'expert-conseil

McElhanney
McElhanney Consulting Services Ltd.

Project Title
Titre du projet

TUNNEL MOUNTAIN VILLAGE 1

BANFF, AB
BANFF NATIONAL PARK

Drawing Title
Titre du dessin

PROPOSED UTILITY DISTURBANCE PLAN

Surveyed by / Arpenté par	Drawn by / Dessiné par	Date
	SS	2018.04.03
Designed by / Conçu par	Reviewed by / Révisé par	Scale / Echelle
DF	TM	1:1000

Parks Canada Project Manager / Administrateur de Projets Parcs Canada

Client Acceptance / Acceptation du client	Approved by / Approuvé par

Project No. / No. du projet	Asset No. / No. du-bien	Sheet No. / No. de la feuille
2511-00954-0		C-119
Drawing Reference No. / No. de référence du dessin		

FILE: G:\DEVELOPMENT\00954-00 PARKS TUNNEL MOUNTAIN VILLAGE - L'ÉTUDE DE CONCEPTION DES TRAVAUX\03 SHEET 119.DWG - PLOTTED: 20180811 11:24 AM




LEGEND

BALSAM POPLAR OR TREMBLING ASPEN WITH SHRUB PLANTINGS FOR SCREENING
SEE NOTE 1

GRASS RESTORATION PLANTING
SEE NOTE 2

SCREENING SHRUB CLUSTER LOCATION
SEE NOTE 6

- ### NOTES
- BALSAM POPLAR OR TREMBLING ASPEN TO BE PLANTED AT 2.0m SPACING IN ROUGH AND LOOSE SOIL WITH WOODY DEBRIS AT 100 m²/ha AND A MINIMUM 300mm ht IN A #1 POT AT TIME OF PLANTING. TOTAL TREES TO BE PLANTED IS 110 TREES.
 - SEED OVER MINIMUM 150mm DEPTH LIGHTLY COMPACTED TOPSOIL. SEED MIX AS PER SPECIFICATIONS.
 - RESTORATION PLANTING ZONE TYPE DETERMINED via AERIAL PHOTO. FINAL CONFIGURATION AND PLANTING TYPES TO BE CONFIRMED DURING CONSTRUCTION.
 - ALL PLANT MATERIAL TO BE TRUE TO FORM AND IN GOOD HEALTH AT TIME OF PLANTING.
 - REFER TO SPECIFICATIONS FOR TREE PLANTING INSTRUCTIONS.
 - SCREENING SHRUB CLUSTERS TO CONSIST OF 3 - 5 SHRUBS PER m² WITH A TOTAL OF 15 SHRUBS PER CLUSTER LOCATION. SHRUBS TO BE NATIVE VEGETATION WITH LOW FORAGE VALUE, EG. WOLF WILLOW, SHRUBBY CINQUEFOIL, BEBB'S WILLOW. PREFERABLY, TRANSPLANTING OF EXISTING EXCAVATED SHRUBS FROM UTILITY INSTALLATION TO NEW CLUSTERS SHOULD BE CONSIDERED IF POSSIBLE. PROPOSED LOCATIONS OF SHRUB CLUSTERS AS SHOWN ON THIS DRAWING MAY VARY AND WILL NEED TO BE CONFIRMED BY A PARKS CANADA REPRESENTATIVE BEFORE FINAL INSTALLATION.

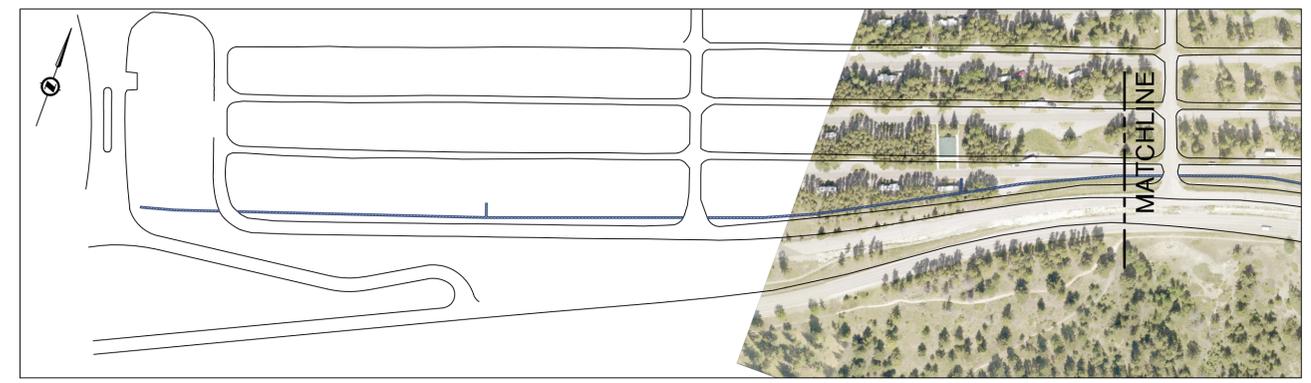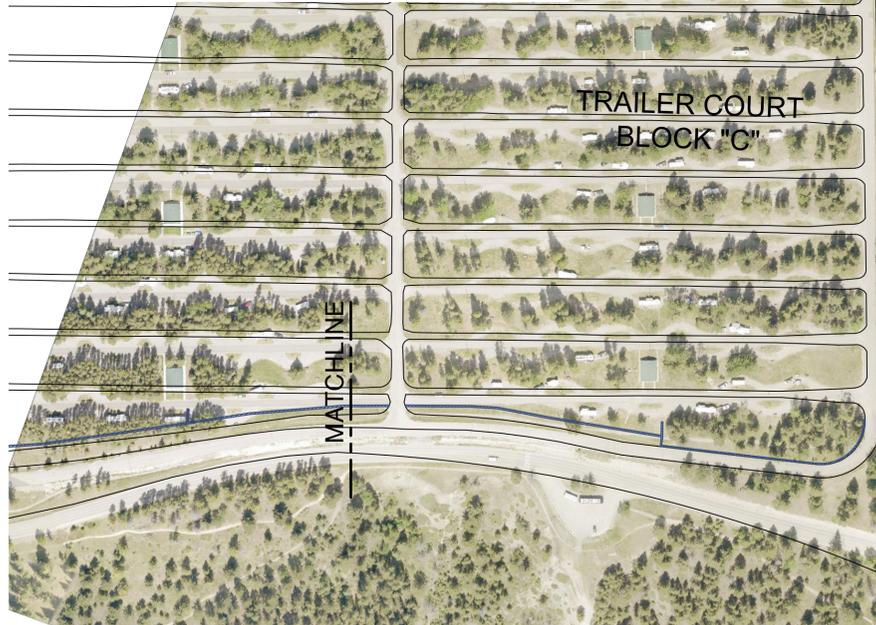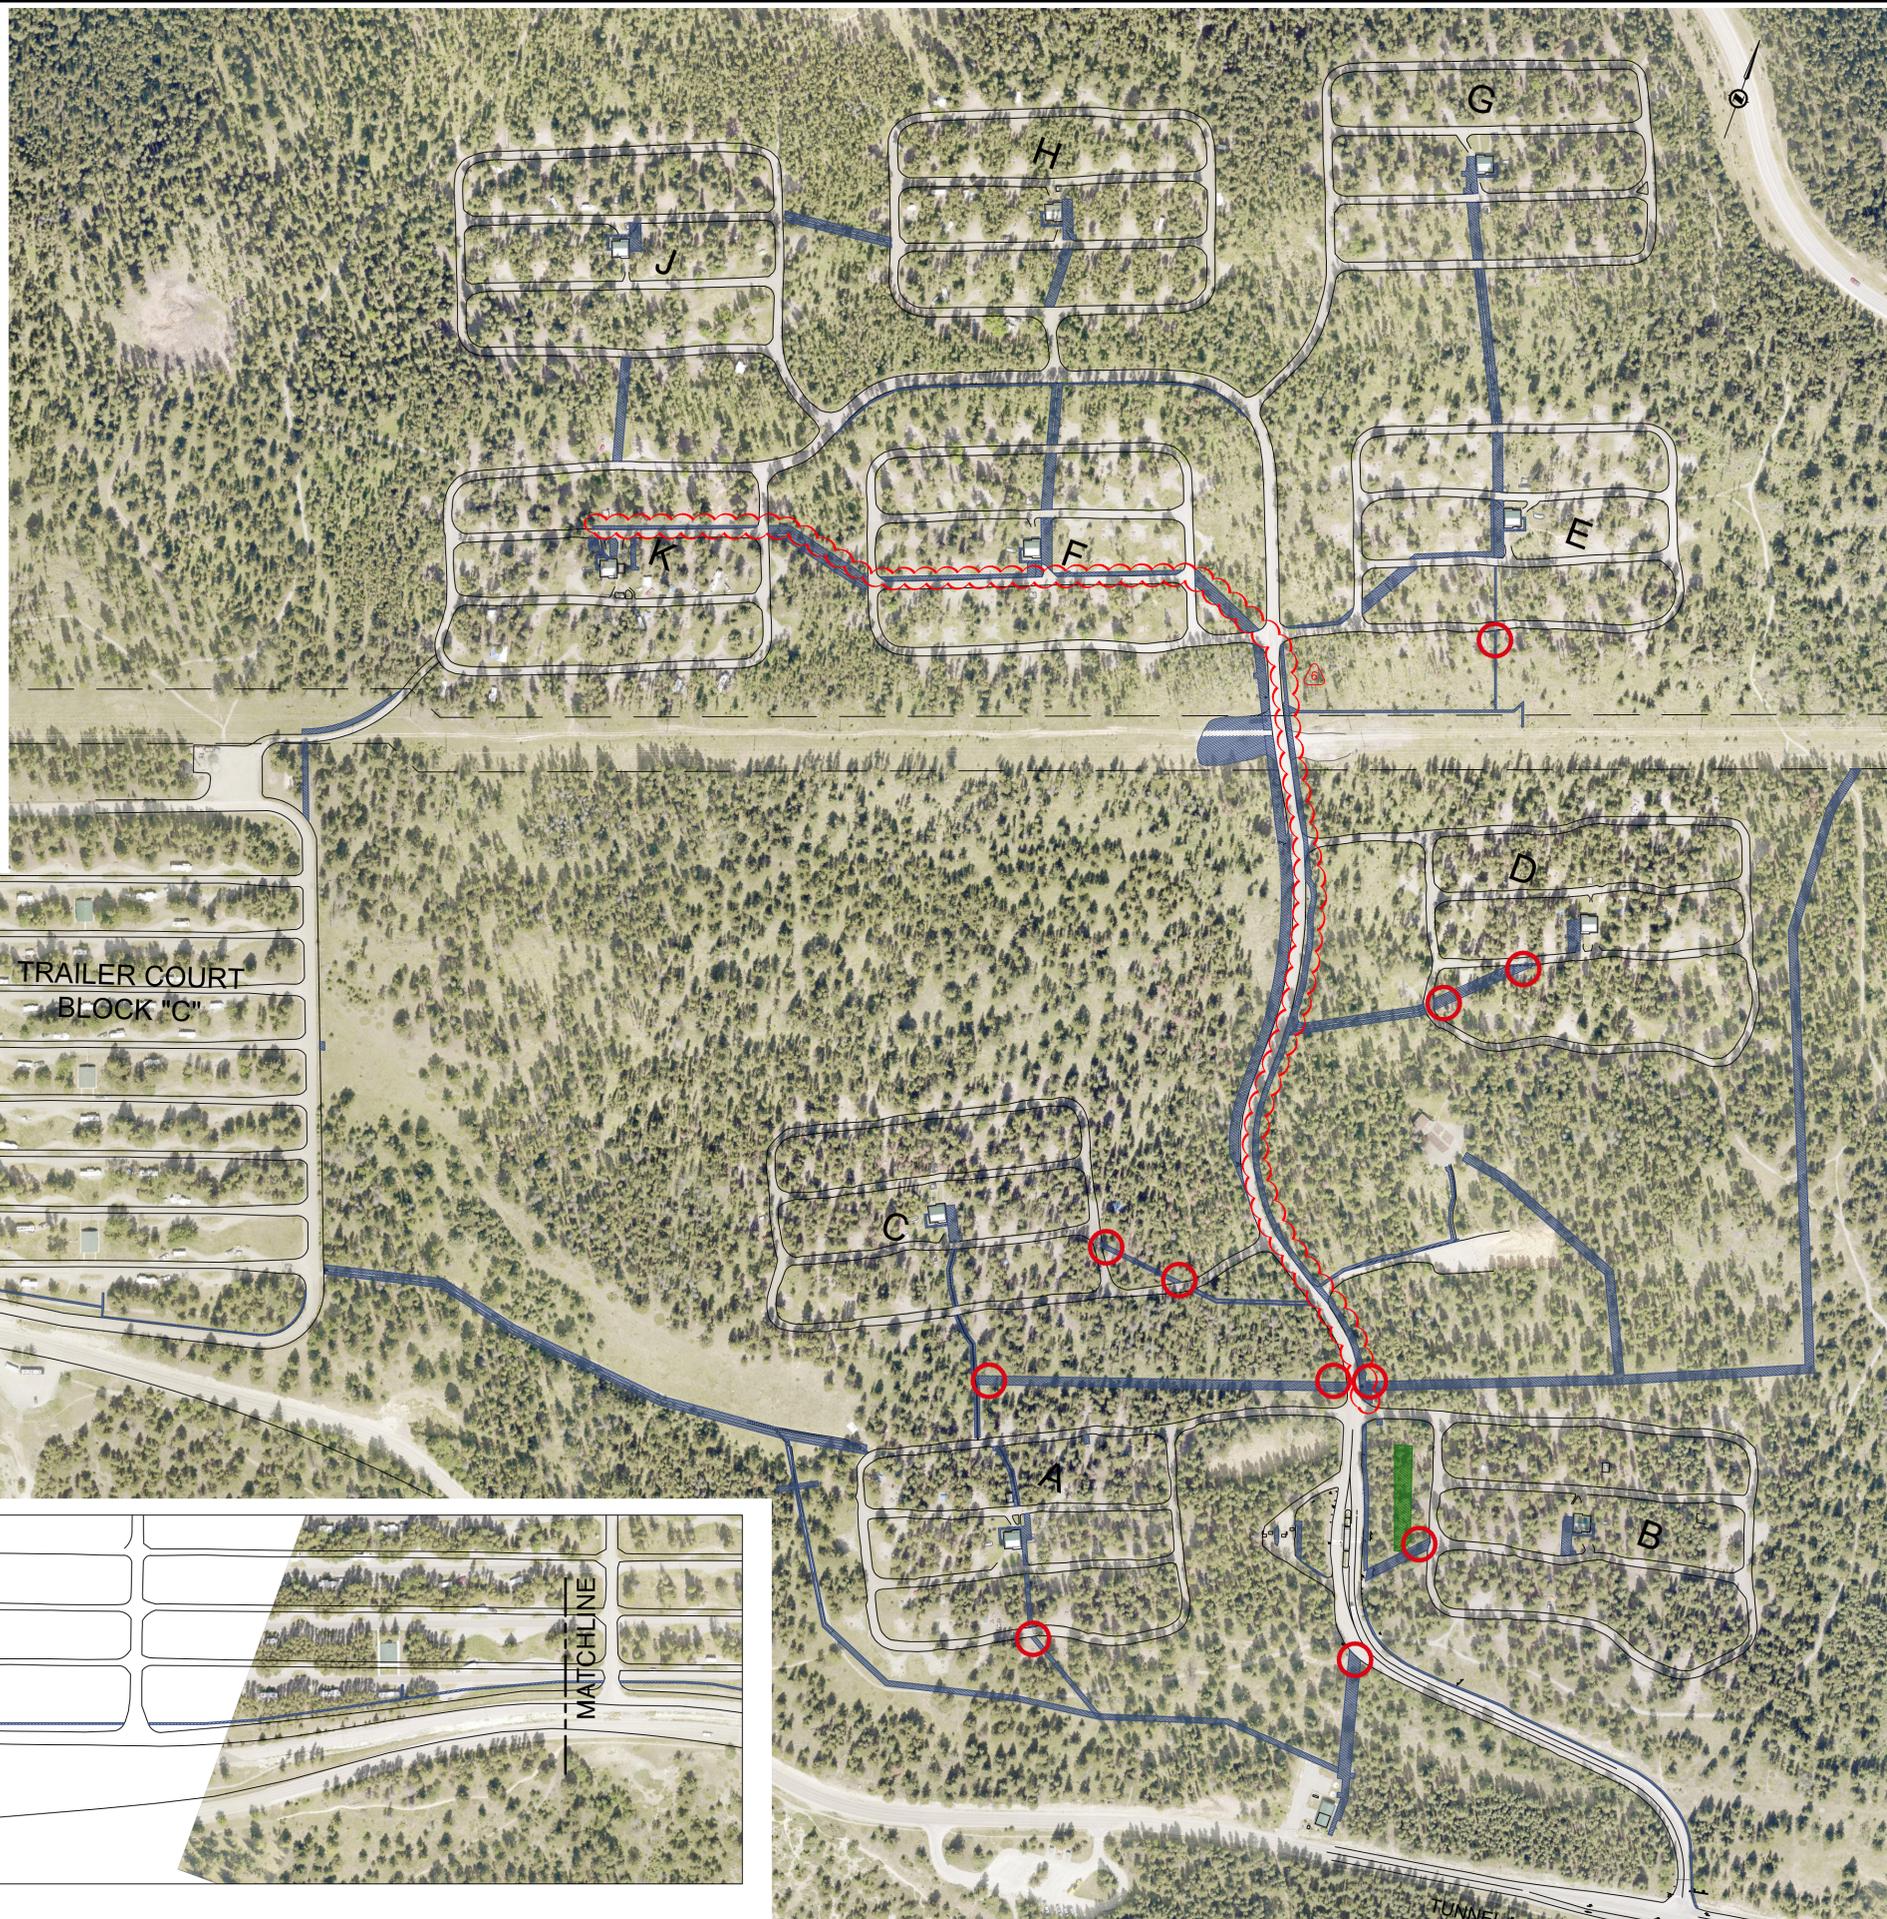

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Rev.	Date	Description	Drawn Dessiné	Designed Conçu	Approved Approuvé
5	2018.07.20	RE ISSUED FOR TENDER - FINAL	SS	DF	TM
4	2018.07.03	RE ISSUED FOR TENDER - FINAL	SS	DF	TM
3	2018.06.22	RE ISSUED FOR TENDER - FINAL	SS	DF	TM
2	2018.06.11	ISSUED FOR TENDER - FINAL	SS	DF	TM
1	2018.05.23	ISSUED FOR TENDER	SS	DF	TM

 A detail number numéro de détail	 B source drawing no. de dessin no.	 C detail on drawing no. détail sur dessin no.
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Sceau de l'expert-conseil

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 PERMIT NUMBER: P 6383
The Association of Professional Engineers,
Geologists and Geophysicists of Alberta

Eng. Stamp
 Sceau de l'ingénieur

 PERMIT NUMBER: P243

Client

 Parks Canada Agency Western and Northern Region	L'Agence Parcs Canada Ouest et Nord du Canada
---	---

Consultant's Name
Nom de l'expert-conseil

McElhanney
 McElhanney Consulting Services Ltd.

Project Title
Titre du projet

**TUNNEL MOUNTAIN
VILLAGE 1**

 BANFF, AB
 BANFF NATIONAL PARK

Drawing Title
Titre du dessin


**LANDSCAPE
RESTORATION PLAN**

Surveyed by / Arpenté par	Drawn by / Dessiné par	Date
Designed by / Conçu par	Reviewed by / Révisé par	Scale / Echelle
Parks Canada Project Manager / Administrateur de Projets Parcs Canada		
Client Acceptance / Acceptation du client	Approved by / Approuvé par	
Project No. / No. du projet	Asset No. / No. du-bien	Sheet No. / No. de la feuille
2511-00954-0		C-125
Drawing Reference No. / No. de référence du dessin		

FILE: G:\000\051541_00954_00 PARKS TUNNEL MOUNTAIN VILLAGE 1 - RESTORATION DESIGN\10 DRAWINGS\103 SHEET 11ES00954-00-025.DWG - PLOTTED: 20180818 11:28 AM




- NOTES:**
1. CONDUIT ROUTING AND JUNCTION BOX LOCATIONS ARE REPRESENTATIVE OF INTENT AND MAY BE ADJUSTED TO SUIT SITE CONDITION
 2. FORTIS METER FOR WASHROOM BUILDING 'G' TO BE MOUNTED OUTSIDE OF WASHROOM BUILDING 'E', ADJACENT TO WASHROOM BUILDING 'E' METER.
 3. FORTIS METER FOR WASHROOM BUILDING 'H' & 'J' TO BE MOUNTED OUTSIDE OF WASHROOM BUILDING 'F', ADJACENT TO WASHROOM BUILDING 'F' METER.
 4. HIGH VOLTAGE PULL BOXES ARE TO BE AS PER FORTIS STANDARDS (755-0557)
 5. PROVIDE PULL BOXES FOR TELUS LINE AS PER TELUS STANDARDS AND TELUS DESIGN.
 6. ALL HIGH VOLTAGE WORK AND SECONDARY WORK, UP TO INCLUDING METER(S), TO BE PERFORMED AND INSTALLED TO FORTIS STANDARDS.
 - 6.1. INSTALLATION CONTRACTOR MUST BE PRE APPROVED BY FORTIS.
 - 6.2. FINAL INSTALLATION DETAILS FOR HIGH VOLTAGE WORK TO BE AS PER FORTIS DRAWINGS. REFER TO FORTIS DRAWINGS FOR HIGH VOLTAGE TRENCH, PULL BOX, TRANSFORMER PAD & GROUNDING DETAILS.
 7. TRANSFORMER PADS TO BE PRECAST CONCRETE PAD FOR SINGLE PHASE MINI - PADMOUNT TRANSFORMER UP TO 167kVA, SEE FORTIS ALBERTA DRAWING 755-0505.
 8. DE-ENERGIZING OF EXISTING PRIMARY OVERHEAD POWER (FORTIS) TO BE COORDINATED WITH FORTIS PRIOR TO ANY REMOVAL.

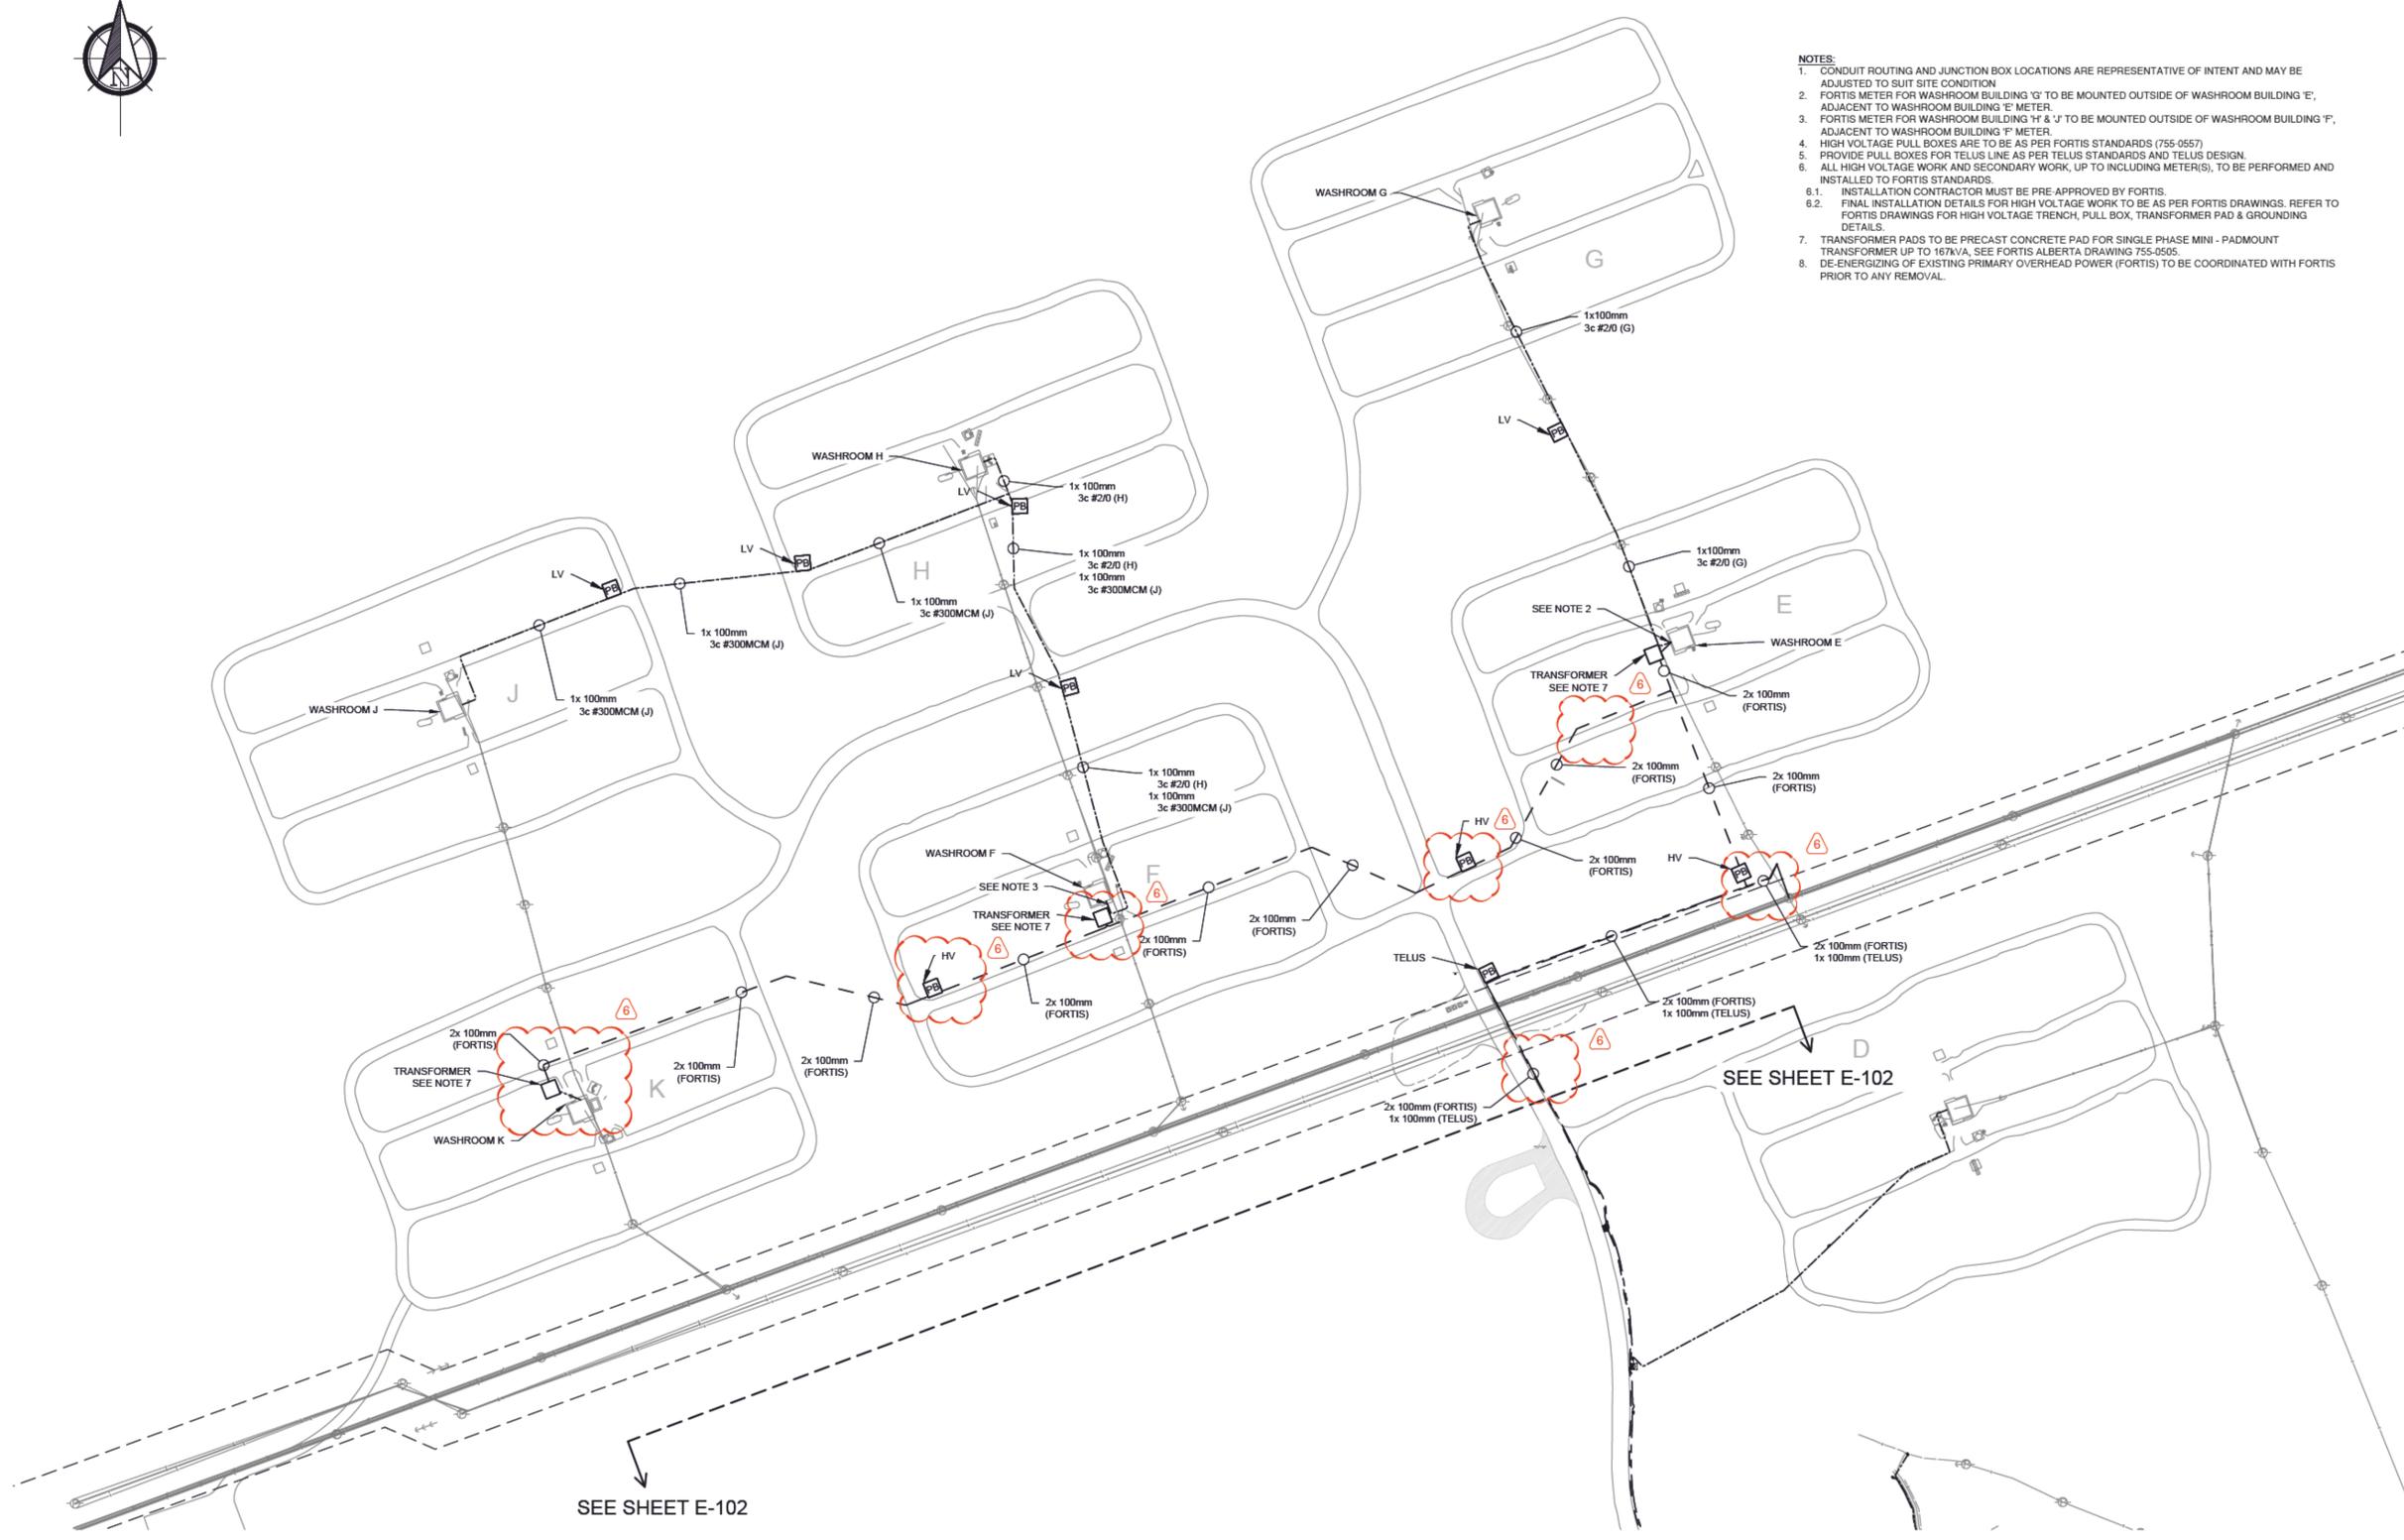

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Rev.	Date	Description	Drawn Dessiné	Designed Conçu	Approved Approuvé
6	2018.08.08	ADDENDUM 1	EH	TI	LL
5	2018.07.20	RE-ISSUED FOR TENDER - FINAL	EH	TI	LL
4	2018.07.03	RE-ISSUED FOR TENDER - FINAL	TI	TI	LL
3	2018.06.22	RE-ISSUED FOR TENDER - FINAL	TI	TI	LL
2	2018.06.11	ISSUED FOR TENDER - FINAL	RG	TI	LL
1	2018.06.07	ISSUED FOR TENDER	RG	TI	LL



Consultant's Stamp
Sceau de l'expert-conseil

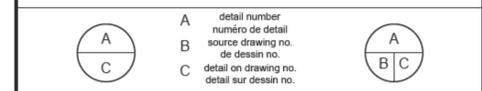Eng. Stamp
Sceau de l'ingénieur

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McELHANNEY CONSULTING SERVICES LTD.
PERMIT NUMBER: P 6383
The Association of Professional Engineers,
Geologists and Geophysicists of Alberta

2018-08-08

Client

Parks Canada Agency
Western and Northern Region

L'Agence Parcs Canada
Ouest et Nord du Canada

Consultant's Name
Nom de l'expert-conseil

McElhanney
McElhanney Consulting Services Ltd.

Project Title
Titre du projet

TUNNEL MOUNTAIN VILLAGE 1

BANFF, AB
BANFF NATIONAL PARK

Drawing Title
Titre du dessin

POWER AND COMMUNICATIONS LAYOUT PLAN SHEET 1 OF 2

Surveyed by / Arpenté par	Drawn by / Dessiné par	Date
	EH/ TI	2018.08.08
Designed by / Conçu par	Reviewed by / Révisé par	Scale / Échelle
TI	LL	1:1500


Parks Canada Project Manager / Administrateur de Projets Parcs Canada

Client Acceptance / Acceptation du client	Approved by / Approuvé par

Project No. / No. du projet	Asset No. / No. du bien	Sheet No. / No. de la feuille
2511-00954-00		E-101

Drawing Reference No. / No. de référence du dessin

FILE: H:\2018\08\08\TUNNEL MOUNTAIN VILLAGE\100 DRAWINGS\103 SHEET E-101\103-001-001.DWG PLOTTED: 2018.08.10 10:38 AM

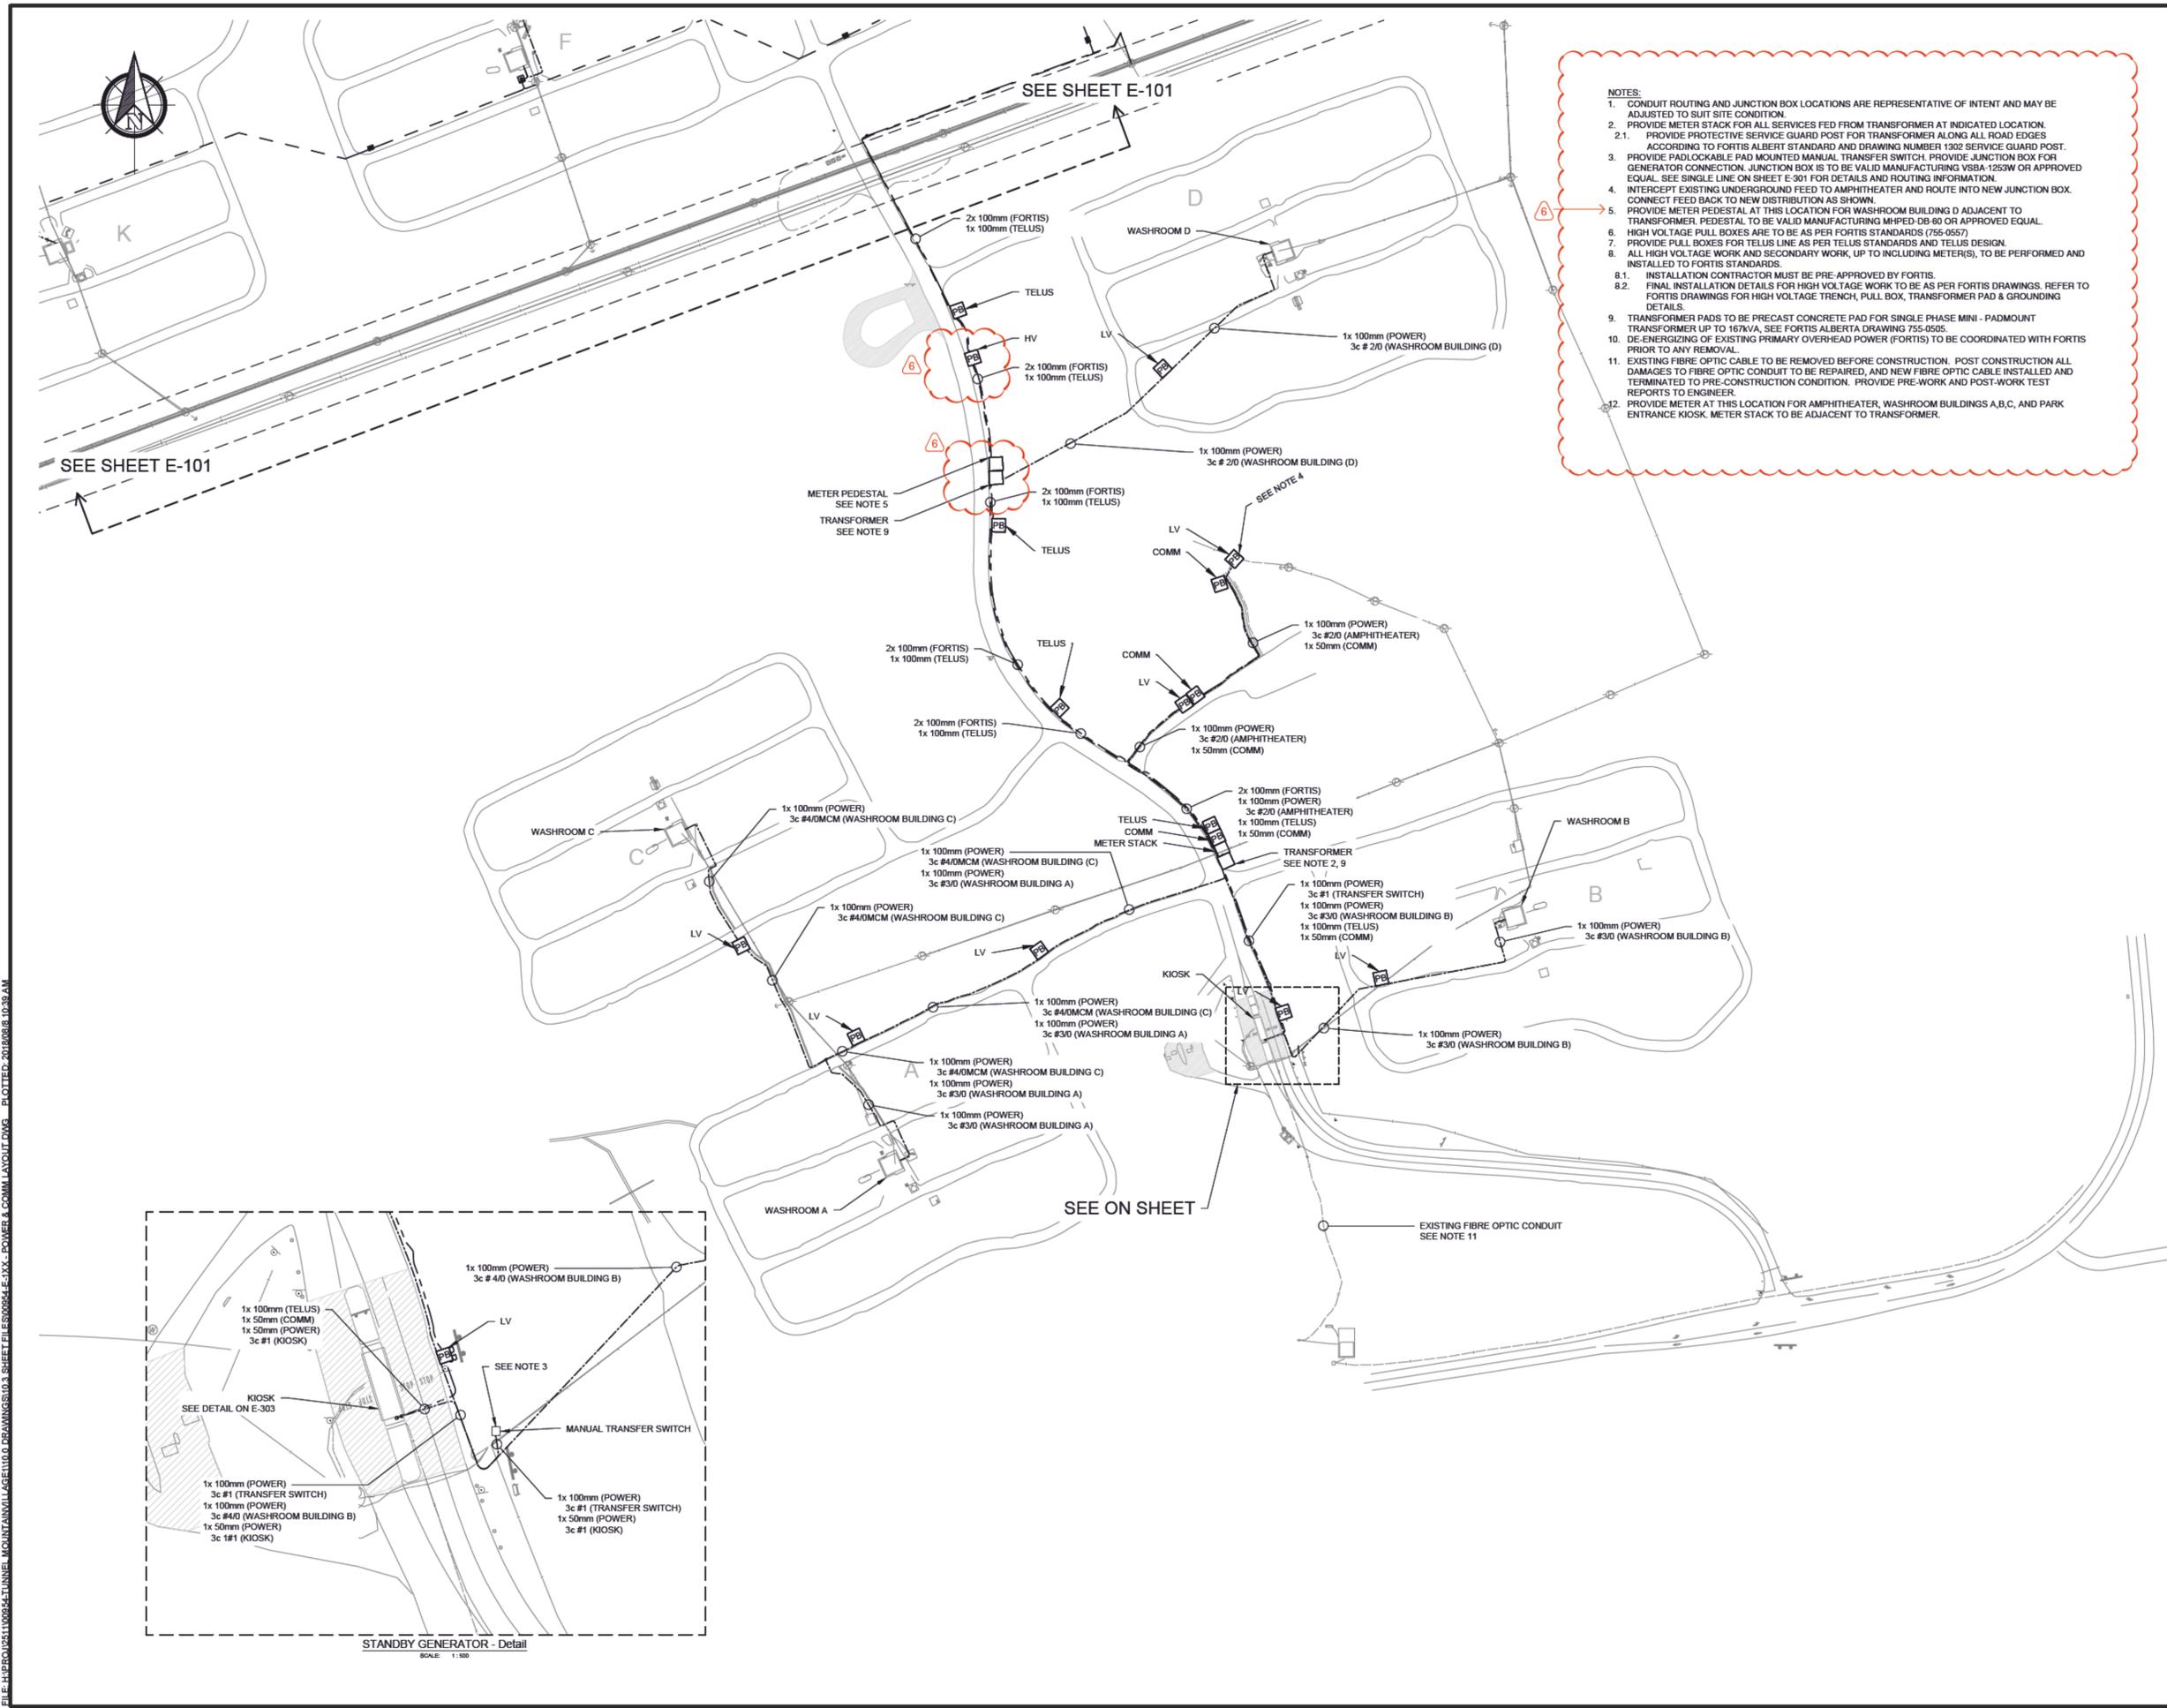

- NOTES:**
- CONDUIT ROUTING AND JUNCTION BOX LOCATIONS ARE REPRESENTATIVE OF INTENT AND MAY BE ADJUSTED TO SUIT SITE CONDITION.
 - PROVIDE METER STACK FOR ALL SERVICES FED FROM TRANSFORMER AT INDICATED LOCATION.
 - PROVIDE PROTECTIVE SERVICE GUARD POST FOR TRANSFORMER ALONG ALL ROAD EDGES ACCORDING TO FORTIS ALBERTA STANDARD AND DRAWING NUMBER 1902 SERVICE GUARD POST.
 - PROVIDE PADLOCKABLE PAD MOUNTED MANUAL TRANSFER SWITCH. PROVIDE JUNCTION BOX FOR GENERATOR CONNECTION. JUNCTION BOX IS TO BE VALID MANUFACTURING VSBA-1253W OR APPROVED EQUAL. SEE SINGLE LINE ON SHEET E-301 FOR DETAILS AND ROUTING INFORMATION.
 - INTERCEPT EXISTING UNDERGROUND FEED TO AMPHITHEATER AND ROUTE INTO NEW JUNCTION BOX. CONNECT FEED BACK TO NEW DISTRIBUTION AS SHOWN.
 - PROVIDE METER PEDESTAL AT THIS LOCATION FOR WASHROOM BUILDING D ADJACENT TO TRANSFORMER. PEDESTAL TO BE VALID MANUFACTURING MH-PED-D8-80 OR APPROVED EQUAL.
 - HIGH VOLTAGE PULL BOXES ARE TO BE AS PER FORTIS STANDARDS (755-0557).
 - PROVIDE PULL BOXES FOR TELUS LINE AS PER TELUS STANDARDS AND TELUS DESIGN.
 - ALL HIGH VOLTAGE WORK AND SECONDARY WORK, UP TO INCLUDING METER(S), TO BE PERFORMED AND INSTALLED TO FORTIS STANDARDS.
 - INSTALLATION CONTRACTOR MUST BE PRE-APPROVED BY FORTIS.
 - FINAL INSTALLATION DETAILS FOR HIGH VOLTAGE WORK TO BE AS PER FORTIS DRAWINGS. REFER TO FORTIS DRAWINGS FOR HIGH VOLTAGE TRENCH, PULL BOX, TRANSFORMER PAD & GROUNDING DETAILS.
 - TRANSFORMER PADS TO BE PRECAST CONCRETE PAD FOR SINGLE PHASE MINI - PADMOUNT TRANSFORMER UP TO 167kVA, SEE FORTIS ALBERTA DRAWING 755-0505.
 - DE-ENERGIZING OF EXISTING PRIMARY OVERHEAD POWER (FORTIS) TO BE COORDINATED WITH FORTIS PRIOR TO ANY REMOVAL.
 - EXISTING FIBRE OPTIC CABLE TO BE REMOVED BEFORE CONSTRUCTION. POST CONSTRUCTION ALL DAMAGES TO FIBRE OPTIC CONDUIT TO BE REPAIRED, AND NEW FIBRE OPTIC CABLE INSTALLED AND TERMINATED TO PRE-CONSTRUCTION CONDITION. PROVIDE PRE-WORK AND POST-WORK TEST REPORTS TO ENGINEER.
 - PROVIDE METER AT THIS LOCATION FOR AMPHITHEATER, WASHROOM BUILDINGS A,B,C, AND PARK ENTRANCE KIOSK. METER STACK TO BE ADJACENT TO TRANSFORMER.

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6	2018.08.08	ADDENDUM 1	EH	TI	LL
5	2018.07.20	RE-ISSUED FOR TENDER - FINAL	EH	TI	LL
4	2018.07.03	RE-ISSUED FOR TENDER - FINAL	TI	TI	LL
3	2018.06.22	RE-ISSUED FOR TENDER - FINAL	TI	TI	LL
2	2018.06.11	ISSUED FOR TENDER - FINAL	RG	TI	LL
1	2018.06.07	ISSUED FOR TENDER	RG	TI	LL

 	A detail number B numéro de detail C source drawing no. de dessin no. detail on drawing no. detail sur dessin no.	
Consultant's Stamp Sceau de l'expert-conseil		Eng. Stamp Sceau de l'ingénieur
 PERMIT TO PRACTICE McElhanney Consulting Services Ltd. PERMIT NUMBER: P 6383 <small>The Association of Professional Engineers, Geologists and Geophysicists of Alberta</small>		 2018-08-08

Client

	Parks Canada Agency Western and Northern Region	L'Agence Parcs Canada Ouest et Nord du Canada
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Consultant's Name
Nom de l'expert-conseil

McElhanney
 McElhanney Consulting Services Ltd.

Project Title
Titre du projet

TUNNEL MOUNTAIN VILLAGE 1

BANFF, AB
BANFF NATIONAL PARK

Drawing Title
Titre du dessin

POWER AND COMMUNICATIONS LAYOUT PLAN SHEET 2 OF 2

Surveyed by / Arpenté par	Drawn by / Dessiné par	Date
	EH/ TI	2018.08.08
Designed by / Conçu par	Reviewed by / Révisé par	Scale / Échelle
TI	LL	1:1500


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Client Acceptance / Acceptation du client		Approved by / Approuvé par
Parks Canada Responsible Officer / Agente Responsable Parcs Canada		Parks Canada Project Manager / Administrateur de Projets Parcs Canada
Project No. / No. du projet	Asset No. / No. du bien	Sheet No. / No. de la feuille
2511-00954-00		E-102
Drawing Reference No. / No. de référence du dessin		

FILE: H:\2018\08\08\TUNNEL MOUNTAIN VILLAGE 1\100 DRAWINGS\103 SHEET FILES\00954-E-102.dwg PLOTTED: 2018.08.15 10:38 AM Paper Size: ANSI D (22 x 34")



- NOTES:**
1. CONDUIT ROUTING AND JUNCTION BOX LOCATIONS ARE REPRESENTATIVE OF INTENT AND MAY BE ADJUSTED TO SUIT SITE CONDITION.
 2. INDICATED POLES ARE TO HAVE DEDICATED 15A, 120V RECEPTACLES PROVIDED. REFER TO ELEVATION DETAIL ON SHEET E-302. TIME CLOCK CONTROLLED; SEE DETAIL ON SHEET E-301.
 3. LIGHTING AND RECEPTACLES TO BE FED FROM WASHROOM F PANEL. PROVIDE CIRCUITING AS REQUIRED.
 4. RECEPTACLES ARE TO BE DEDICATED CIRCUITS.

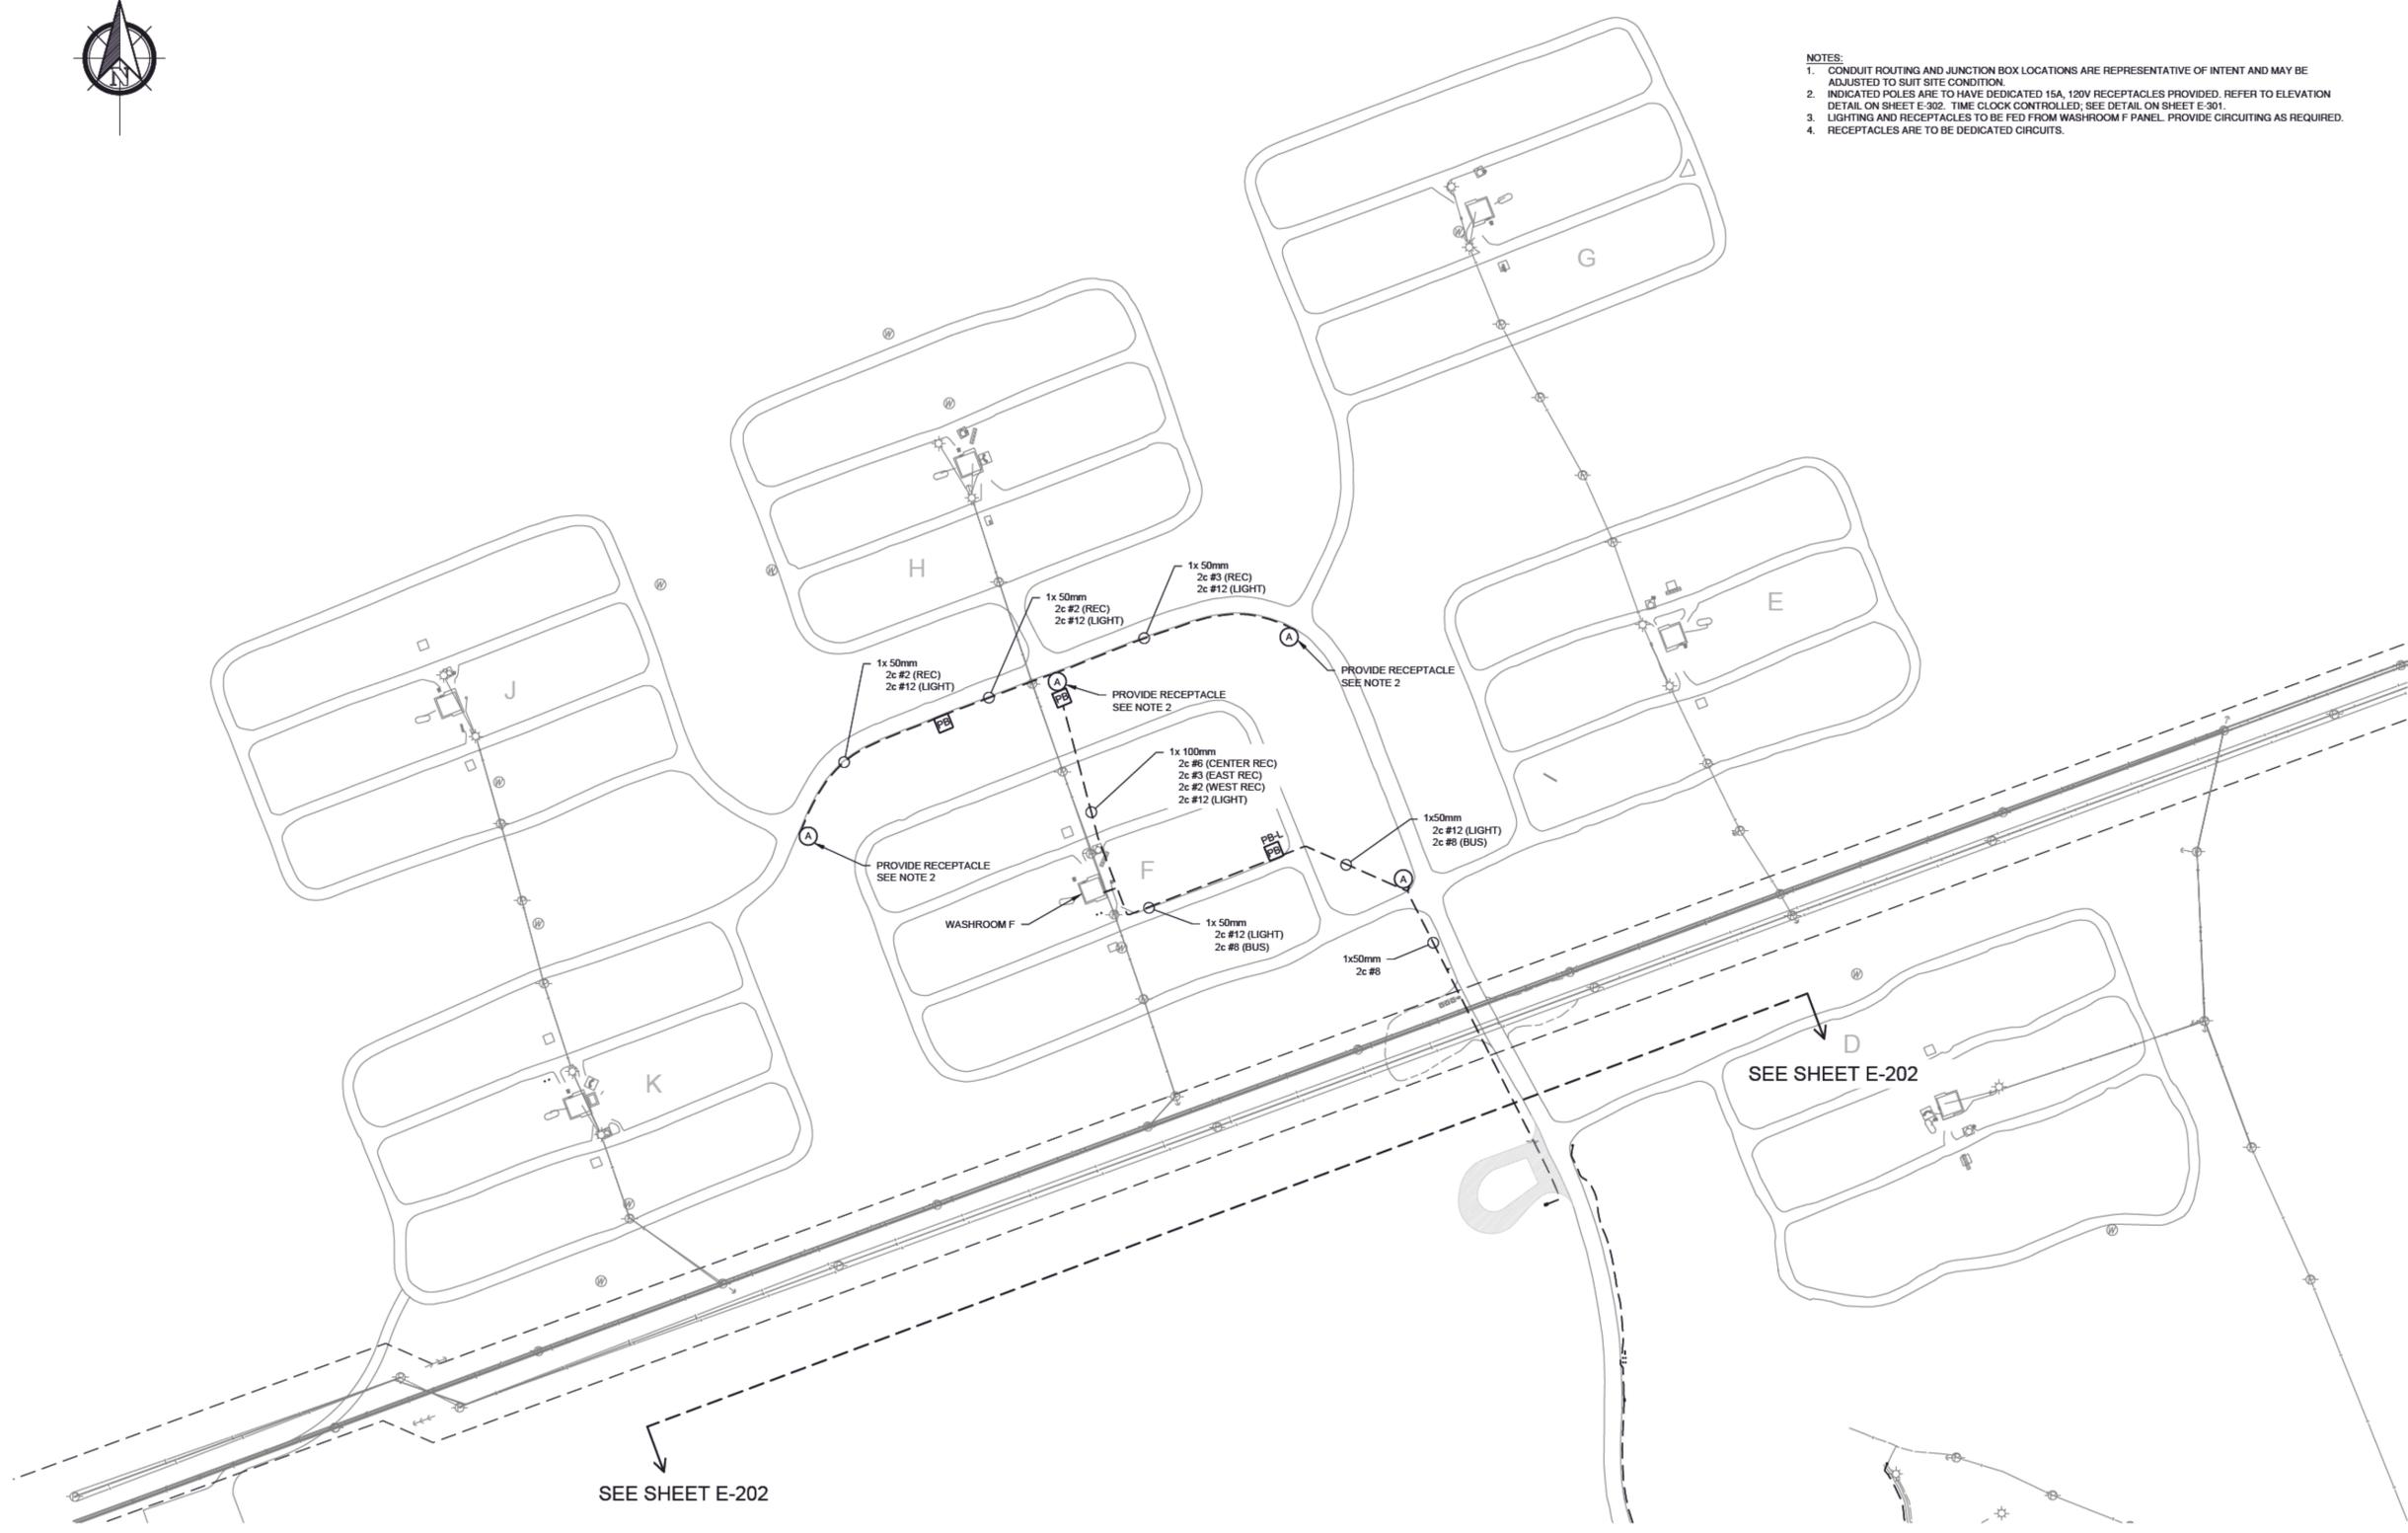

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2	2018.06.11	ISSUED FOR TENDER - FINAL	RG	TI	LL
1	2018.06.07	ISSUED FOR TENDER	RG	TI	LL

A B C	detail number numéro de detail source drawing no. de dessin no. detail on drawing no. detail sur dessin no.	A B C
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Consultant's Stamp Sceau de l'expert-conseil 	Eng. Stamp Sceau de l'ingénieur
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Client

Parks Canada Agency Western and Northern Region	L'Agence Parcs Canada Ouest et Nord du Canada
---	---

Consultant's Name
Nom de l'expert-conseil

McElhanney
McElhanney Consulting Services Ltd.

Project Title
Titre du projet

TUNNEL MOUNTAIN VILLAGE 1

BANFF, AB
BANFF NATIONAL PARK

Drawing Title
Titre du dessin

STREET LIGHTING LAYOUT PLAN SHEET 1 OF 3

Surveyed by / Arpenté par	Drawn by / Dessiné par	Date
	EH/TI	2018.08.08
Designed by / Conçu par	Reviewed by / Révisé par	Scale / Échelle
TI	LL	1:1500


Parks Canada Project Manager / Administrateur de Projets Parcs Canada

Client Acceptance / Acceptation du client

Approved by / Approuvé par

Project No. / No. du projet	Asset No. / No. du bien	Sheet No. / No. de la feuille
2511-00954-00		E-201
Drawing Reference No. / No. de référence du dessin		

FILE: H:\2018\08\08\TUNNEL MOUNTAIN VILLAGE 1\00 DRAWINGS\03 SHEET FILES\00954-E-201- STREET LIGHTING LAYOUT.DWG PLOTTED: 20180808 10:59 AM

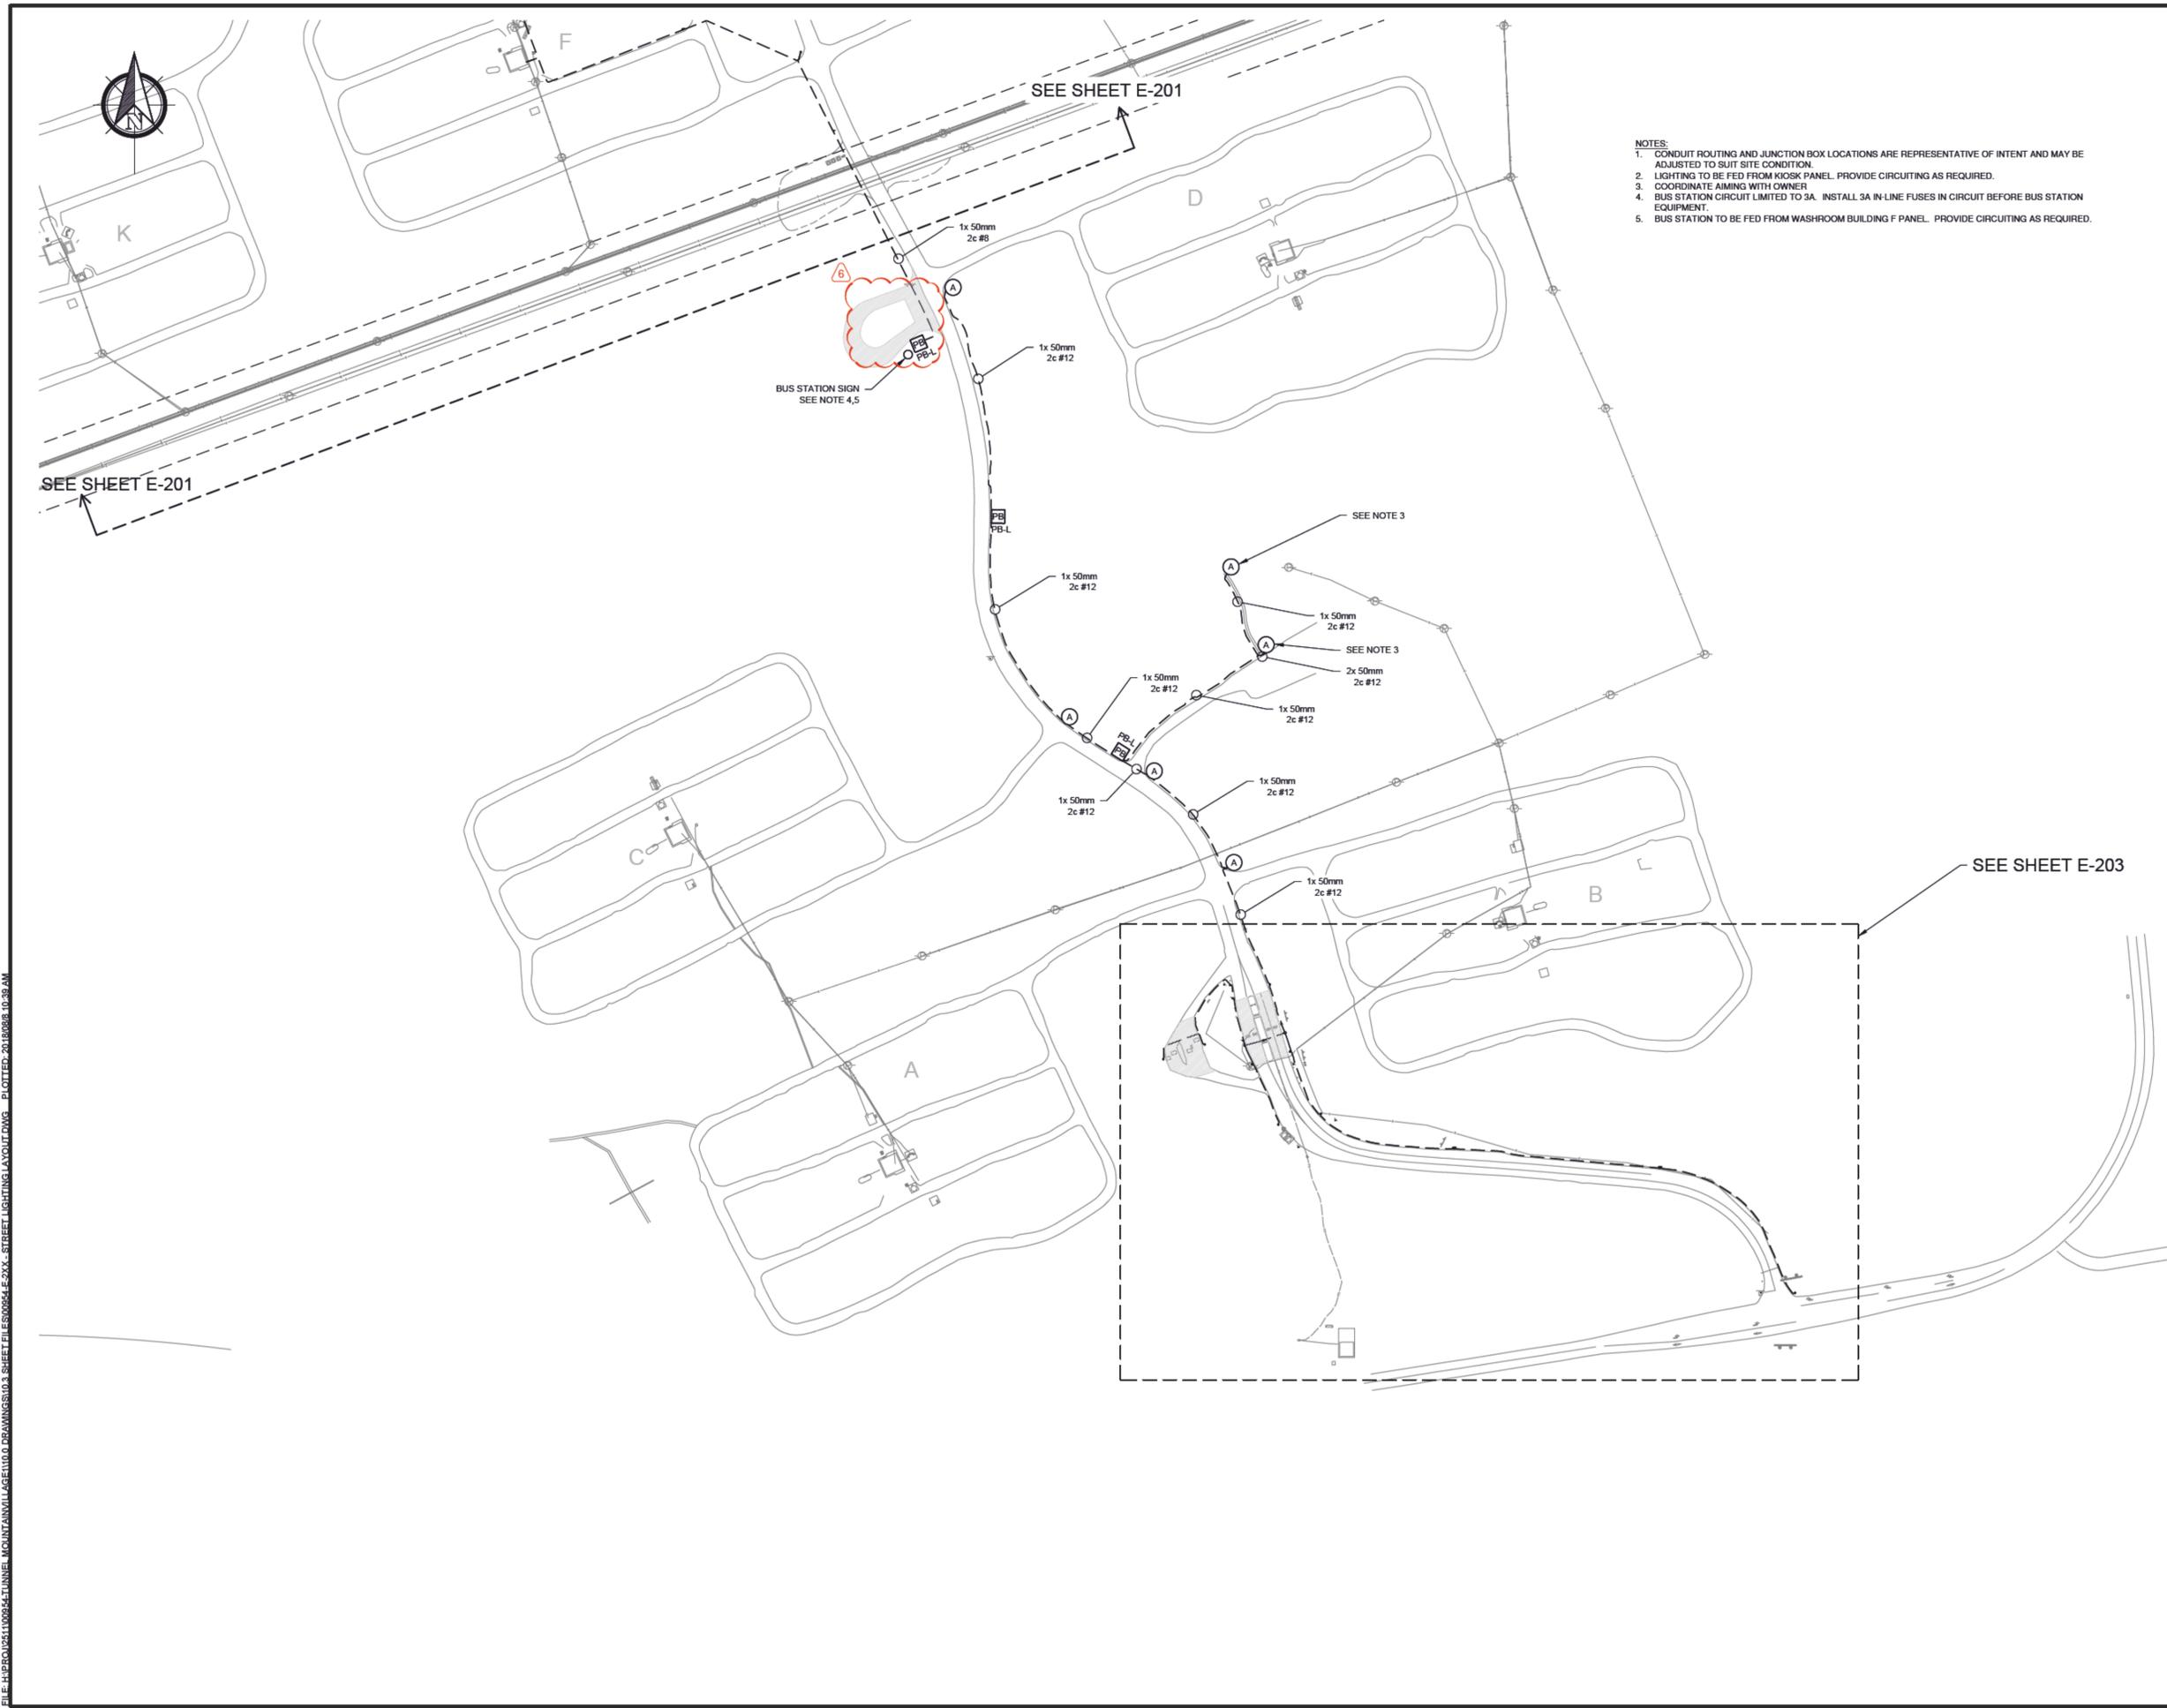


- NOTES:**
1. CONDUIT ROUTING AND JUNCTION BOX LOCATIONS ARE REPRESENTATIVE OF INTENT AND MAY BE ADJUSTED TO SUIT SITE CONDITION.
 2. LIGHTING TO BE FED FROM KIOSK PANEL. PROVIDE CIRCUITING AS REQUIRED.
 3. COORDINATE AIMING WITH OWNER.
 4. BUS STATION CIRCUIT LIMITED TO 3A. INSTALL 3A IN-LINE FUSES IN CIRCUIT BEFORE BUS STATION EQUIPMENT.
 5. BUS STATION TO BE FED FROM WASHROOM BUILDING F PANEL. PROVIDE CIRCUITING AS REQUIRED.

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6	2018.08.08	ADDENDUM 1	EH	TI	LL
5	2018.07.20	RE-ISSUED FOR TENDER - FINAL	EH	TI	LL
4	2018.07.03	RE-ISSUED FOR TENDER - FINAL	TI	TI	LL
3	2018.06.22	RE-ISSUED FOR TENDER - FINAL	TI	TI	LL
2	2018.06.11	ISSUED FOR TENDER - FINAL	RG	TI	LL
1	2018.06.07	ISSUED FOR TENDER	RG	TI	LL

Rev.	Date	Description	Drawn Dessiné	Designed Conçu	Approved Approuvé
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Consultant's Stamp
Sceau de l'expert-conseil

Eng. Stamp
Sceau de l'ingénieur

PERMIT TO PRACTICE
McELHANNEY CONSULTING SERVICES LTD.
PERMIT NUMBER: P 6383
The Association of Professional Engineers,
Geologists and Geophysicists of Alberta

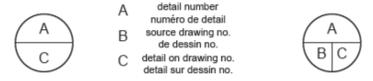PROFESSIONAL ENGINEER
ALBERTA
2018-08-08

Client

Parks Canada Agency
Western and Northern Region

L'Agence Parcs Canada
Ouest et Nord du Canada

Consultant's Name
Nom de l'expert-conseil

McElhanney
McElhanney Consulting Services Ltd.

Project Title
Titre du projet

TUNNEL MOUNTAIN VILLAGE 1

BANFF, AB
BANFF NATIONAL PARK

Drawing Title
Titre du dessin

STREET LIGHTING LAYOUT PLAN SHEET 2 OF 3

Surveyed by / Arpenté par	Drawn by / Dessiné par	Date
	EH/TI	2018.08.08
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Parks Canada Project Manager / Administrateur de Projets Parcs Canada

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Parks Canada Responsible Officer / Agent Responsable Parcs Canada		Parks Canada Project Manager / Administrateur de Projets Parcs Canada
Project No. / No. du projet	Asset No. / No. du bien	Sheet No. / No. de la feuille
2511-00954-00		E-202
Drawing Reference No. / No. de référence du dessin		


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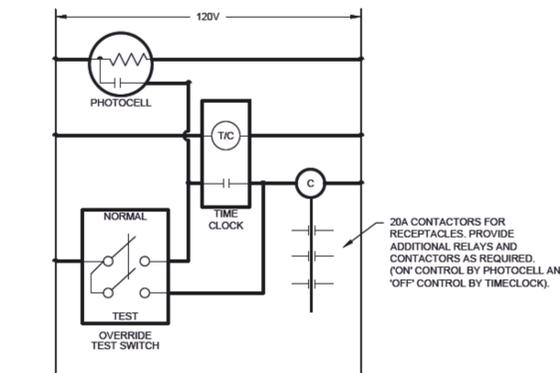
LUMINAIRE SCHEDULE				
TYPE	DESCRIPTION	LAMPING	MOUNTING	REMARKS
A	DECORATIVE POST TOP AREA LIGHT WITH INTEGRAL PHOTOCELL	LED 6,500 lm 3000 K	POLE 8m AFG	PHILIPS TR10-80W48LED3K-G2-LE3F-240- HS-PH8-BKTX
PC	PHOTOCELL			
TC	TIMECLOCK			
DS	DAYLIGHT SENSOR			

SYMBOL SCHEDULE		
SYMBOL	DESCRIPTION	NOTES
	BREAKER	
	FUSED CUTOUT (SERVICE AUTHORITY)	
	METER - LETTER DENOTES TYPE	
	TRANSFORMER	
	TRANSFER SWITCH	
	PANEL - MAIN BREAKER AS INDICATED	
	GENERATOR	
	GROUND	
	CONDUCTOR/FEEDER INFORMATION	
	LUMINAIRE OF TYPE 'A' REFER TO LUMINAIRE SCHEDULE FOR DETAILS	
	PULL BOX	
PC	PHOTOCELL	




PROPOSED SINGLE LINE DIAGRAM
SCALE: NOT TO SCALE

- SINGLE LINE NOTES:**
- ALL CONDUCTORS ARE BASED ON VOLTAGE DROP CALCULATIONS BASED ON ESTIMATED DISTANCES. FINAL DISTANCES ARE TO BE CONFIRMED BY CONTRACTOR AND CONFIRMED WITH ENGINEER.
 - ALL CONDUCTORS SHOWN ARE COPPER UNLESS OTHERWISE NOTED.
 - ALUMINUM CONDUCTORS MAY BE USED FOR WIRE SIZES GREATER THAN #6, WITH ENGINEER APPROVAL.
 - MANUAL TRANSFER SWITCH. REFER TO DRAWING E-102.
 - GENERATOR NOT IN CONTRACT.
 - ALL HIGH VOLTAGE WORK AND UP TO INCLUDING METER(S) TO BE PERFORMED AND INSTALLED TO FORTIS STANDARDS, AND CONTRACTOR MUST BE PRE-APPROVED BY FORTIS.

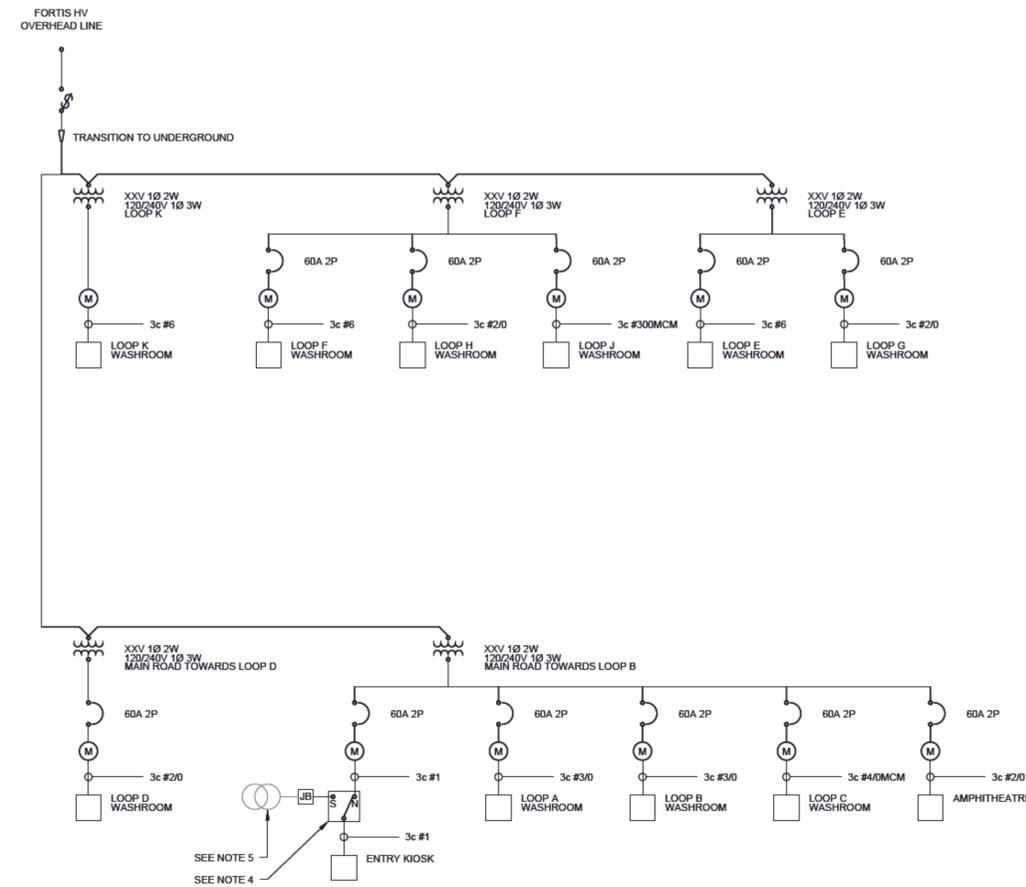

POLE MOUNT RECEPTACLE CONTROL WIRING SCHEMATIC
SCALE: NTS

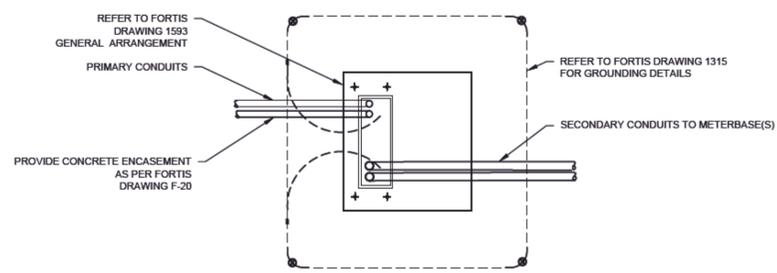

TRANSFORMER PAD - INSTALLATION DETAILS
SCALE: NTS

- TRANSFORMER PAD NOTES:**
- PVC CONDUIT SHALL BE CONCRETE CAPPED
 - UNLESS OTHERWISE SPECIFIED, ALL DIMENSIONS ARE IN MILLIMETERS
 - ENSURE 0.5m OF EXCESS GROUND WIRE ABOVE PAD
 - TRANSFORMER ALIGNMENT NEEDS TO BE CONFIRMED WITH FORTIS INSPECTOR.
 - TRANSFORMER PAD IS TO BE PRE-CAST 1219 X 1016 mm.

Rev.	Date	Description	Drawn Dessiné	Designed Conçu	Approved Approuvé
6	2018.08.08	ADDENDUM 1		EH	TI
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3	2018.06.22	RE-ISSUED FOR TENDER - FINAL		TI	TI
2	2018.06.11	ISSUED FOR TENDER - FINAL		RG	TI
1	2018.06.07	ISSUED FOR TENDER		RG	TI

Consultant's Stamp
 Sceau de l'expert-conseil

 PERMIT NUMBER: P 6383
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Eng. Stamp
 Sceau de l'ingénieur

Client

Parks Canada Agency
 Western and Northern Region

L'Agence Parcs Canada
 Ouest et Nord du Canada

Consultant's Name
Nom de l'expert-conseil

McElhanney
 McElhanney Consulting Services Ltd.

Project Title
Titre du projet

TUNNEL MOUNTAIN VILLAGE 1

BANFF, AB
BANFF NATIONAL PARK

Drawing Title
Titre du dessin

ELECTRICAL SCHEDULES AND DETAILS SHEET 1 OF 3

Surveyed by / Arpenté par	Drawn by / Dessiné par	Date
	EH/TI	2018.08.08
Designed by / Conçu par	Reviewed by / Revisé par	Scale / Échelle
TI	LL	NOT TO SCALE

Parks Canada Project Manager / Administrateur de Projets Parcs Canada

Client Acceptance / Acceptation du client


Approved by / Approuvé par

Project No. / No. du projet	Asset No. / No. du bien	Sheet No. / No. de la feuille
2511-00954-00		E-301

Drawing Reference No. / No. de référence du dessin


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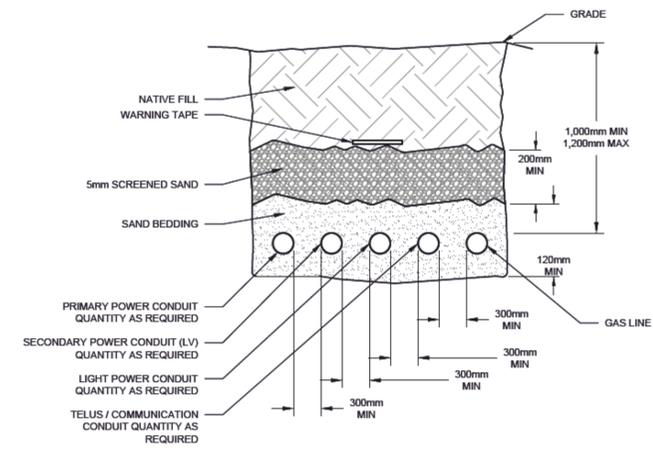
EXTERIOR LIGHT FIXTURE MOUNTING DETAIL
SCALE: NTS

- POLE ELEVATION NOTES:**
1. PROVIDE RECEPTACLE ON POLES INDICATED IN LAYOUT DRAWING.
 - 1.1. BACKBOX TO BE DIECAST ALUMINUM, POWDER COATED BLACK TO MATCH POLE.
 - 1.2. IN-USE WEATHERPROOF COVER TO BE EATON WIUMV-1X OR APPROVED EQUAL. COVER TO BE PAINTED BLACK TO MATCH POLE. COVER TO BE LOCKABLE.
 - 1.3. RECEPTACLE TO BE 15A GFCI DUPLEX.
 - 1.4. MOUNT RECEPTACLE 450mm FROM TOP OF BASE (900mm ABOVE FINISHED GRADE)
 2. PROVIDE BASE EXTENSION WIREWAY AS REQUIRED FOR INCOMING CONDUIT TERMINATION, AND TRANSITION TO POLE WIRING.

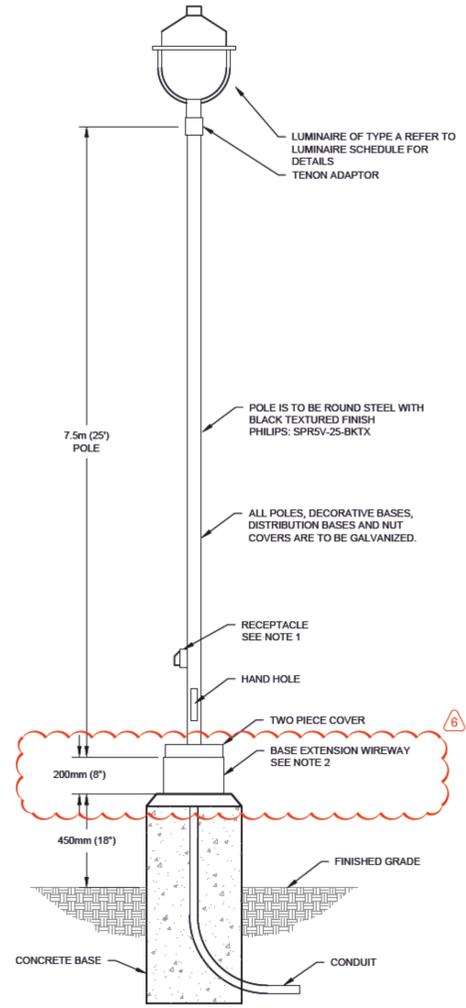


CONCRETE PEDESTAL (LARGE)
SCALE: NTS

- PEDESTAL BASE NOTES:**
1. CONCRETE TO BE 20MPA 6-8% AIR, 19mm (3/4") MAX. AGGREGATE
 2. PROVIDE 32mm (1.25") CHAMFER ON ALL EXPOSED CONCRETE EDGES
 3. ALLOW CONCRETE TO POOL OUT BELOW BOTTOM OF SONOTUBE TO REDUCE POSSIBILITY OF FROST HEAVING.
 4. EDGE OF ALL LAMP BASES TO BE 1m FROM EDGE OF ROAD TO ALLOW FOR SNOW CLEARING OPERATION

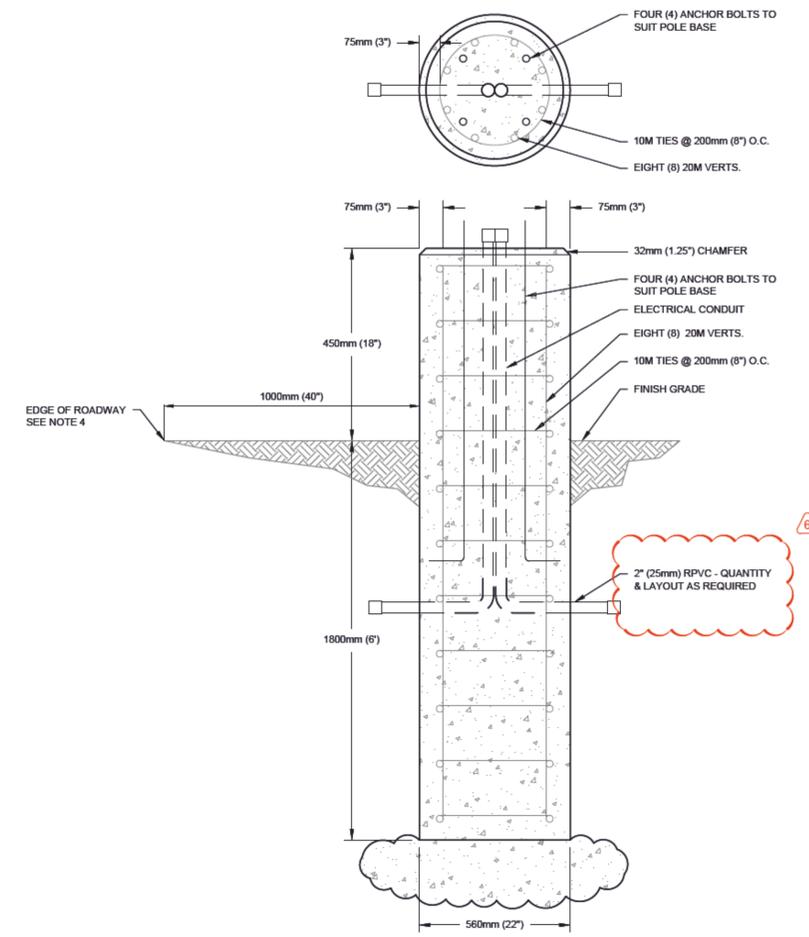


TYPICAL ELECTRICAL TRENCH DETAIL
SCALE: NTS

- TRENCH DETAIL NOTES:**
1. ALL ELECTRICAL CONDUITS ARE TO MAINTAIN CLEARANCES FROM OTHER UTILITIES AS FOLLOWS:
 - 1.1. SEWER / SANITARY - 2500mm (MIN)
 - 1.2. WATER - 1000mm (MIN)
 - 1.3. GAS - 300mm (MIN)
 - 1.4. EDGE OF ROADWAY 500mm (MIN)
 2. TRENCH DETAIL IS REPRESENTATIVE OF INTENT FOR ELECTRICAL REQUIREMENTS. EXACT TRENCH CONFIGURATION MAY BE ADJUSTED TO SUIT SITE CONDITIONS AND OTHER UTILITY REQUIREMENTS.

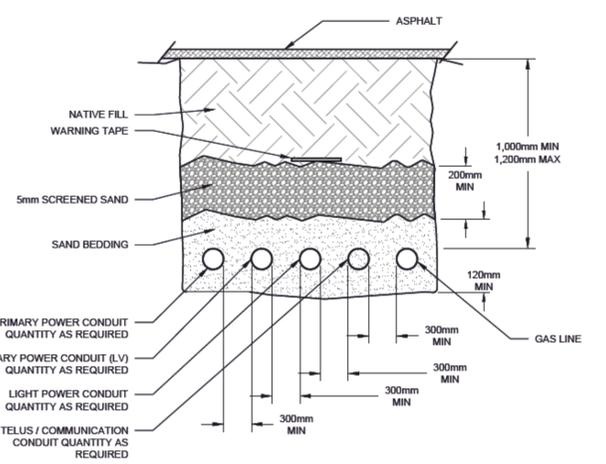

TYPICAL ELECTRICAL TRENCH DETAIL (ROAD CROSSING)
SCALE: NTS

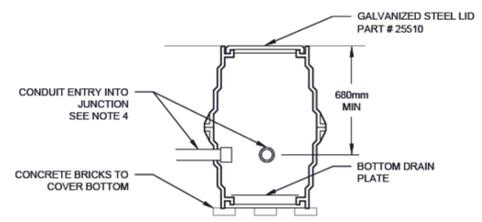

- JUNCTION BOX NOTES:**
1. TWO RECTANGULAR JUNCTION BOXES INSTALLED WITH ONE INVERTED UNDER THE OTHER.
 2. PROVIDE BONDING FOR STEEL LID.
 3. JUNCTION BOX IS TO BE WEST COAST ENGINEERING 25100 OR APPROVED EQUAL.
 4. CONDUIT IS TO BE RUN AT A DEPTH OF 900mm AND HAVE A GENTLE RISE UP FOR ENTRY INTO JUNCTION BOX.
 5. PULL BOX DETAIL TYPICAL FOR ALL LOW VOLTAGE AND COMMUNICATIONS PULL BOXES IN LAYOUT DRAWINGS.
 6. JUNCTION BOX PB-L TO BE WEST COAST ENGINEERING 25020 WITH LID 25400 OR APPROVED EQUAL.

PULL BOX DETAIL
SCALE: NTS

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6	2018.08.08	ADDENDUM 1		EH	TI LL
5	2018.07.20	RE-ISSUED FOR TENDER - FINAL		EH	TI LL
4	2018.07.03	RE-ISSUED FOR TENDER - FINAL		TI	TI LL
3	2018.06.22	RE-ISSUED FOR TENDER - FINAL		TI	TI LL
2	2018.06.11	ISSUED FOR TENDER - FINAL		RG	TI LL
1	2018.06.07	ISSUED FOR TENDER		RG	TI LL

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Eng. Stamp: 2018-08-08

Client: Parks Canada Agency Western and Northern Region / L'Agence Parcs Canada Ouest et Nord du Canada

Consultant's Name: McElhanney Consulting Services Ltd.

Project Title: TUNNEL MOUNTAIN VILLAGE 1
BANFF, AB
BANFF NATIONAL PARK

ELECTRICAL SCHEDULES AND DETAILS SHEET 2 OF 3

Surveyed by / Arpenté par	Drawn by / Dessiné par	Date
	EH/TI	2018.08.08
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Client Acceptance / Acceptation du client: Approved by / Approuvé par

Project No. / No. du projet	Asset No. / No. du bien	Sheet No. / No. de la feuille
2511-00954-00		E-302

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4	2018.07.03	RE-ISSUED FOR TENDER - FINAL	TI	TI	LL
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2	2018.06.11	ISSUED FOR TENDER - FINAL	RG	TI	LL
1	2018.06.07	ISSUED FOR TENDER	RG	TI	LL

Rev.	Date	Description	Drawn Dessiné	Designed Conçu	Approved Approuvé
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<p>A detail number numéro de détail</p> <p>B source drawing no. de dessin no.</p> <p>C detail on drawing no. détail sur dessin no.</p>		

<p>Consultant's Stamp Sceau de l'expert-conseil</p> <div style="border: 1px solid black; padding: 5px; text-align: center;"> <p>PERMIT TO PRACTICE McElhanney Consulting Services Ltd. PERMIT NUMBER: P 6383</p> <p><small>The Association of Professional Engineers, Geologists and Geophysicists of Alberta</small></p> </div>	<p>Eng. Stamp Sceau de l'ingénieur</p> <div style="text-align: center;">  <p>2018-08-08</p> </div>
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Client

 <p>Parks Canada Agency Western and Northern Region</p>	<p>L'Agence Parcs Canada Ouest et Nord du Canada</p>
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Consultant's Name
Nom de l'expert-conseil



McElhanney
McElhanney Consulting Services Ltd.

Project Title
Titre du projet

**TUNNEL MOUNTAIN
VILLAGE 1**

BANFF, AB
BANFF NATIONAL PARK

Drawing Title
Titre du dessin

**ELECTRICAL SCHEDULES
AND DETAILS
SHEET 3 OF 3**

Surveyed by / Arpenté par	Drawn by / Dessiné par	Date
	EH/TI	2018.08.08
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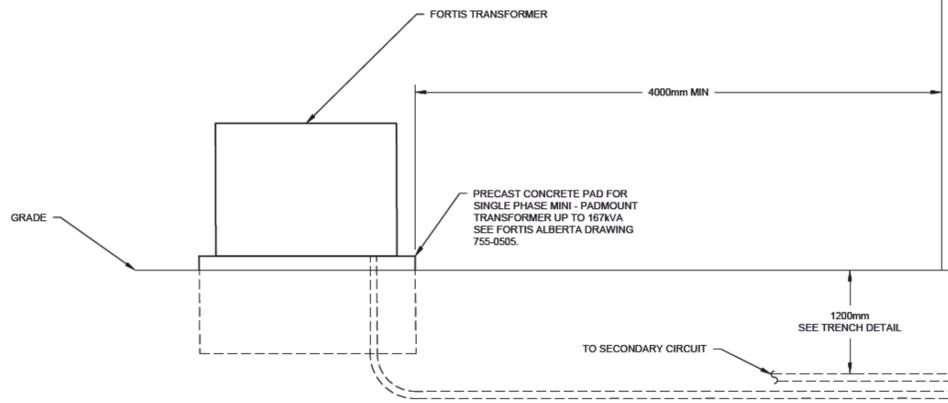
Parks Canada Responsible Officer / Agente Responsable Parcs Canada Parks Canada Project Manager / Administrateur de Projets Parcs Canada

Project No. / No. du projet	Asset No. / No. du bien	Sheet No. No. de la feuille
2511-00954-00		E-303

Drawing Reference No. / No. de référence du dessin


PANEL WASHROOM						
NOTE	DESCRIPTION	BKR	CIRCUIT	BKR	DESCRIPTION	NOTE
			01			
			02			
			03			
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REMARKS:
-EXISTING WIRING TO BE RE-ROUTED TO NEW PANEL AND RE-CIRCUITED FROM NEW PANEL.




- WASHROOM BUILDING ELEVATION NOTES:**
1. QUANTITY OF METERS TO BE AS PER LAYOUT DRAWINGS.
 2. EXISTING SERVICE MAST TO REMAIN FOR FUTURE USE.
 3. EXISTING ELECTRICAL PANEL TO BE REPLACED WITH A NEW 300CT PANEL WITH NEW 60A MAIN BREAKER.
 4. NEW SERVICE TO PENETRATE THROUGH WALL ABOVE DOOR, AND TO RUN ALONG THE CEILING INTO THE SERVICE ROOM WITH THE BREAKER PANEL. SEAL ALL PENETRATIONS.
 5. PROVIDE PRECAST PAD AND GROUNDING. INSTALLATION IN ACCORDANCE WITH FORTIS ALBERTA STANDARD.

TYPICAL WASHROOM BUILDING (ELEVATION)
SCALE: NTS

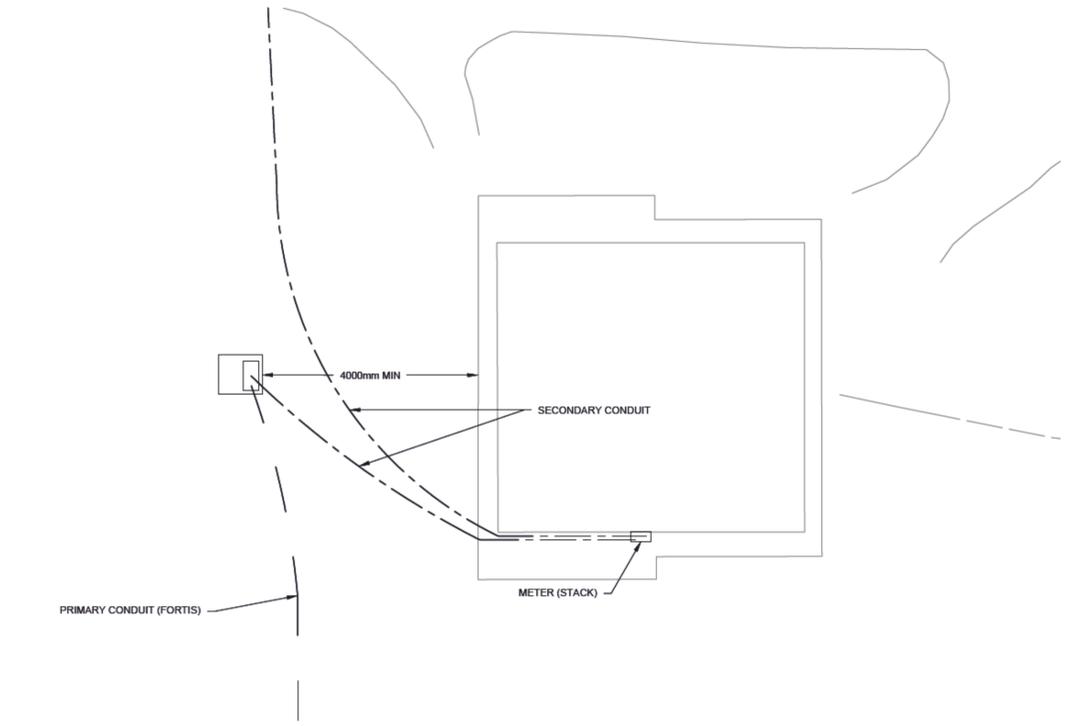

- WASHROOM BUILDING NOTES:**
1. EXACT LOCATION OF METER STACK TO BE CONFIRMED ON-SITE WITH PARKS CANADA REPRESENTATIVE AND FORTIS ALBERTA.

TYPICAL WASHROOM BUILDING (SITE LAYOUT)
SCALE: NTS

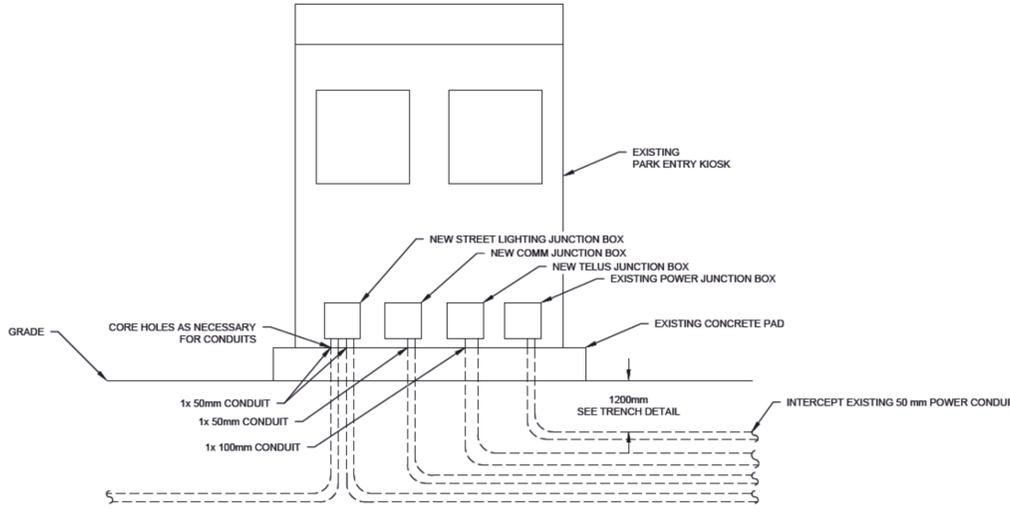

- KIOSK BUILDING NOTES:**
- 1.

PARK ENTRY KIOSK BUILDING (ELEVATION)
SCALE: NTS

FILE: H:\PROJECTS\TUNNEL MOUNTAIN VILLAGE 1\00 DRAWINGS\03 SHEET FILES\00954-E-303-SCHEDULES & DETAILS.DWG PLOTTED: 20180808 10:58 AM



PLAN PROFILE NOTES:

GENERAL

- EXISTING WATERMAIN PROFILES NOT SHOWN ON PLAN PROFILE DRAWINGS DUE TO UNKNOWN INVERT ELEVATIONS. IT IS ASSUMED THAT THE EXISTING WATERMAIN IS AT ABOUT THE SAME ELEVATION SHOWN FOR THE PROPOSED WATERMAIN PROFILES.

PLAN PROFILE LEGEND:

GENERAL


C-212 PLAN PROFILE DRAWING NUMBER

EXISTING FEATURES

- EXISTING ASPHALT ROAD
- EXISTING PROPANE TANK
- EXISTING WASTE DUMPSTER
- EXISTING RECYCLING BIN
- EXISTING FOOD STORAGE LOCKERS
- EXISTING WOODEN PHONE BOOTH
- EXISTING SIGN
- EXISTING SINK
- EXISTING SANITARY MAIN AND MANHOLE
- EXISTING WATERMAIN, VALVE, SEE NOTE 1
- EXISTING WATER MANHOLE
- EXISTING WATER CHAMBER
- EXISTING LIGHT STANDARD
- EXISTING POWER POLE
- EXISTING SURVEYED DOUGLAS FIR TREE
- EXISTING OVERHEAD ELECTRICAL LINE
- EXISTING COMMUNICATION LINE
- EXISTING GAS LINE

PROPOSED INFRASTRUCTURE

- PROPOSED SANITARY MAIN AND MANHOLE - PLAN (1 C-303, 2 C-303)
- PROPOSED SANITARY MAIN AND MANHOLE - PROFILE
- PROPOSED STANDPIPE CATCH BASIN DRAIN (3 C-305)
- PROPOSED WATERMAIN AND VALVE - PLAN (1 C-304, 2 C-304, 4 C-304, 1 C-305)
- PROPOSED WATERMAIN - PROFILE
- PROPOSED WATER MANHOLE (2 C-305, 4 C-305, 5 C-305)
- PROPOSED FIRE HYDRANT (6 C-304)
- PROPOSED WATER STANDPIPE (3 C-305)
- PROPOSED 1.5" THREADED HYDRANT (6 C-305)
- PROPOSED ELECTRICAL LIGHTING
- PROPOSED ELECTRICAL MAIN
- PROPOSED ELECTRICAL SERVICE
- PROPOSED COMMUNICATIONS LINE
- PROPOSED TRANSFORMER
- PROPOSED JUNCTION BOX
- PROPOSED LIGHT POLE TYPE A
- PROPOSED LIGHT POLE TYPE B
- PROPOSED GAS LINE AND VALVE (1 C-302)

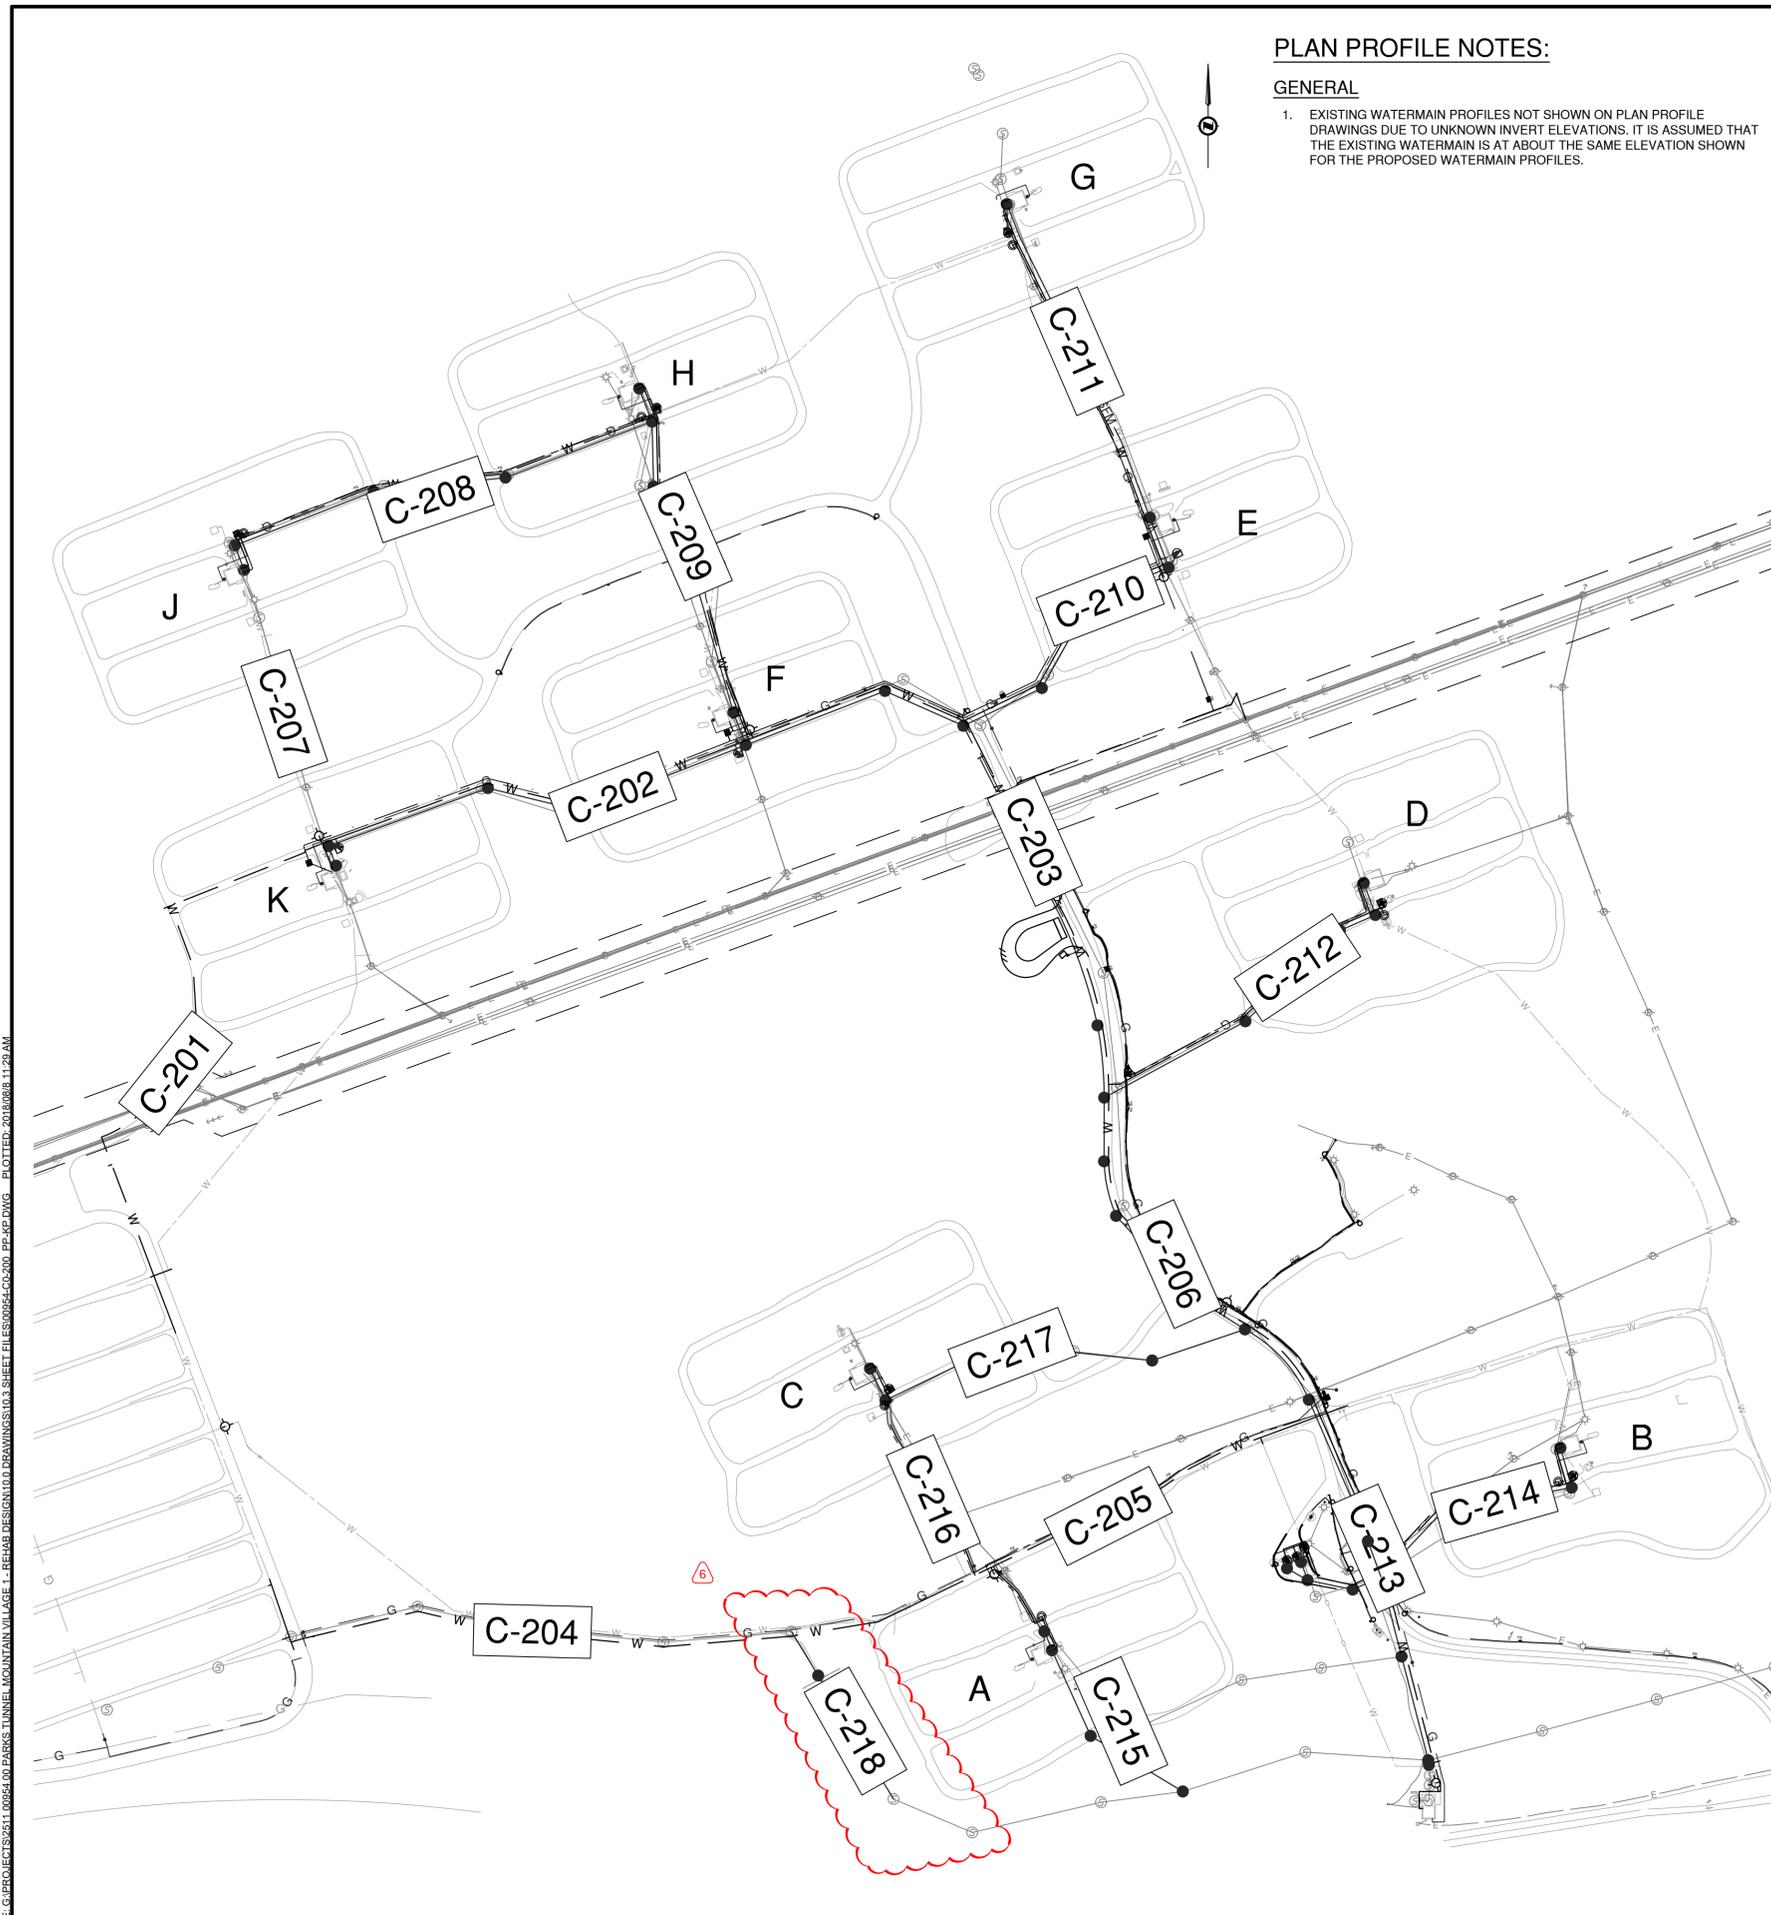

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Rev.	Date	Description	Drawn Dessiné	Designed Conçu	Approved Approuvé
6	2018.08.08	ADDENDUM 1	SS	DF	TM
5	2018.07.20	RE ISSUED FOR TENDER - FINAL	SS	DF	TM
4	2018.07.03	RE ISSUED FOR TENDER - FINAL	SS	DF	TM
3	2018.06.22	RE ISSUED FOR TENDER - FINAL	SS	DF	TM
2	2018.06.11	ISSUED FOR TENDER - FINAL	SS	DF	TM
1	2018.05.23	ISSUED FOR TENDER	SS	DF	TM

<p>detail number numéro de détail</p> <p>A</p> <p>source drawing no. de dessin no.</p> <p>B</p> <p>detail on drawing no. détail sur dessin no.</p> <p>C</p>	<p>detail number numéro de détail</p> <p>A</p> <p>source drawing no. de dessin no.</p> <p>B</p> <p>detail on drawing no. détail sur dessin no.</p> <p>C</p>
<p>Consultant's Stamp Sceau de l'expert-conseil</p> <p>PERMIT TO PRACTICE McELHANNEY CONSULTING SERVICES LTD. PERMIT NUMBER: P 6383</p> <p>The Association of Professional Engineers, Geologists and Geophysicists of Alberta</p>	<p>Eng. Stamp Sceau de l'ingénieur</p> <p>PROFESSIONAL ENGINEER ALBERTA ANGUSTINE 2018 PERMIT NUMBER: P243</p>

<p>Client</p> <p> Parks Canada Agency Western and Northern Region</p>	<p>L'Agence Parcs Canada Ouest et Nord du Canada</p>
---	--

Consultant's Name
Nom de l'expert-conseil

McElhanney
McElhanney Consulting Services Ltd.

Project Title
Titre du projet

TUNNEL MOUNTAIN VILLAGE 1

BANFF, AB
BANFF NATIONAL PARK

Drawing Title
Titre du dessin

PLAN PROFILE


KEY PLAN

Surveyed by / Arpenté par	Drawn by / Dessiné par	Date
	SS	2018.03.26
Designed by / Conçu par	Reviewed by / Révisé par	Scale / Echelle
DF	TM	1:2000


Parks Canada Project Manager / Administrateur de Projets Parcs Canada

Client Acceptance / Acceptation du client	Approved by / Approuvé par
Project No. / No. du projet	Asset No. / No. du bien
2511-00954-0	
Drawing Reference No. / No. de référence du dessin	
C-200	

FILE: G:\PROJETS\2511-00954-00 PARKS TUNNEL MOUNTAIN VILLAGE 1 - REVISIONS\DESIGN\03 SHEET 11 ES00954-0000 EP-30.DWG - PLOTTED: 2018/08/11 11:29 AM

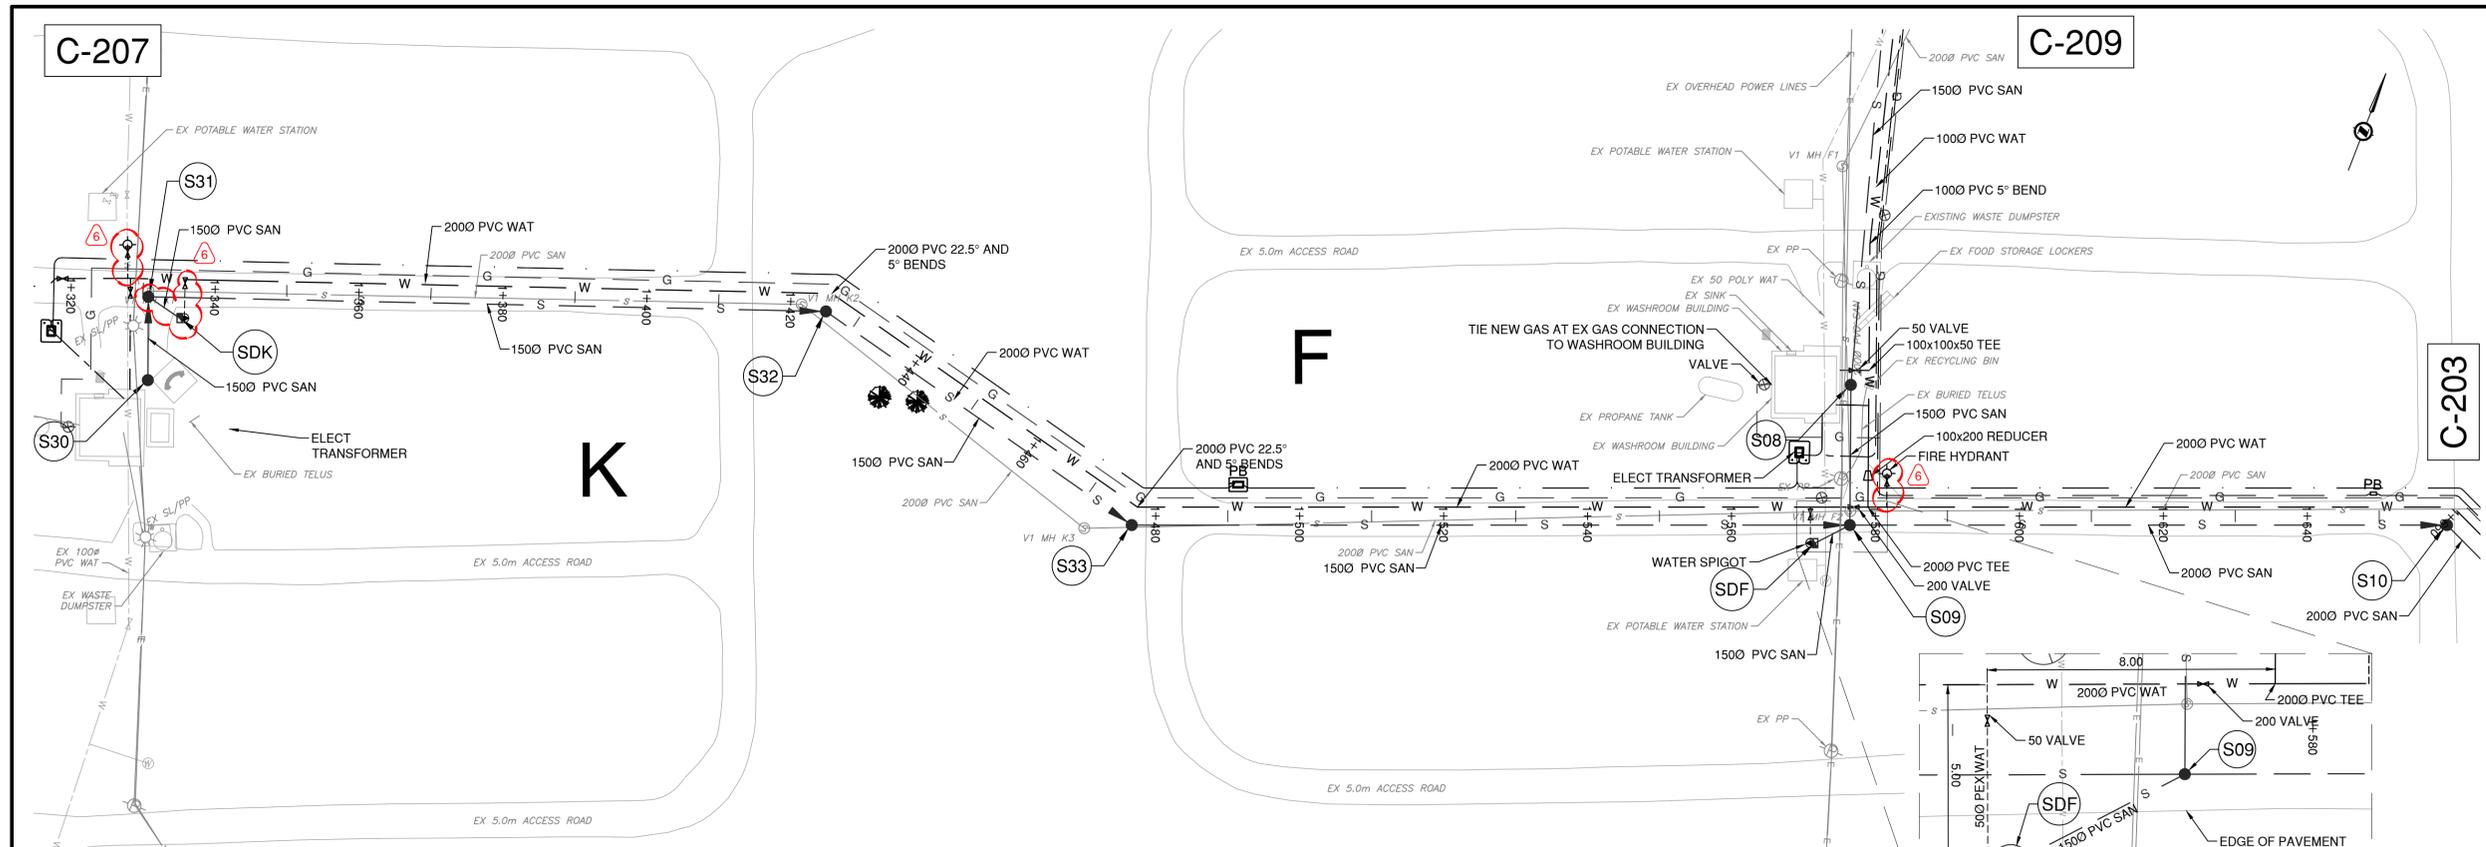

WATER SPIGOT CONNECTION DETAIL
SCALE 1:100

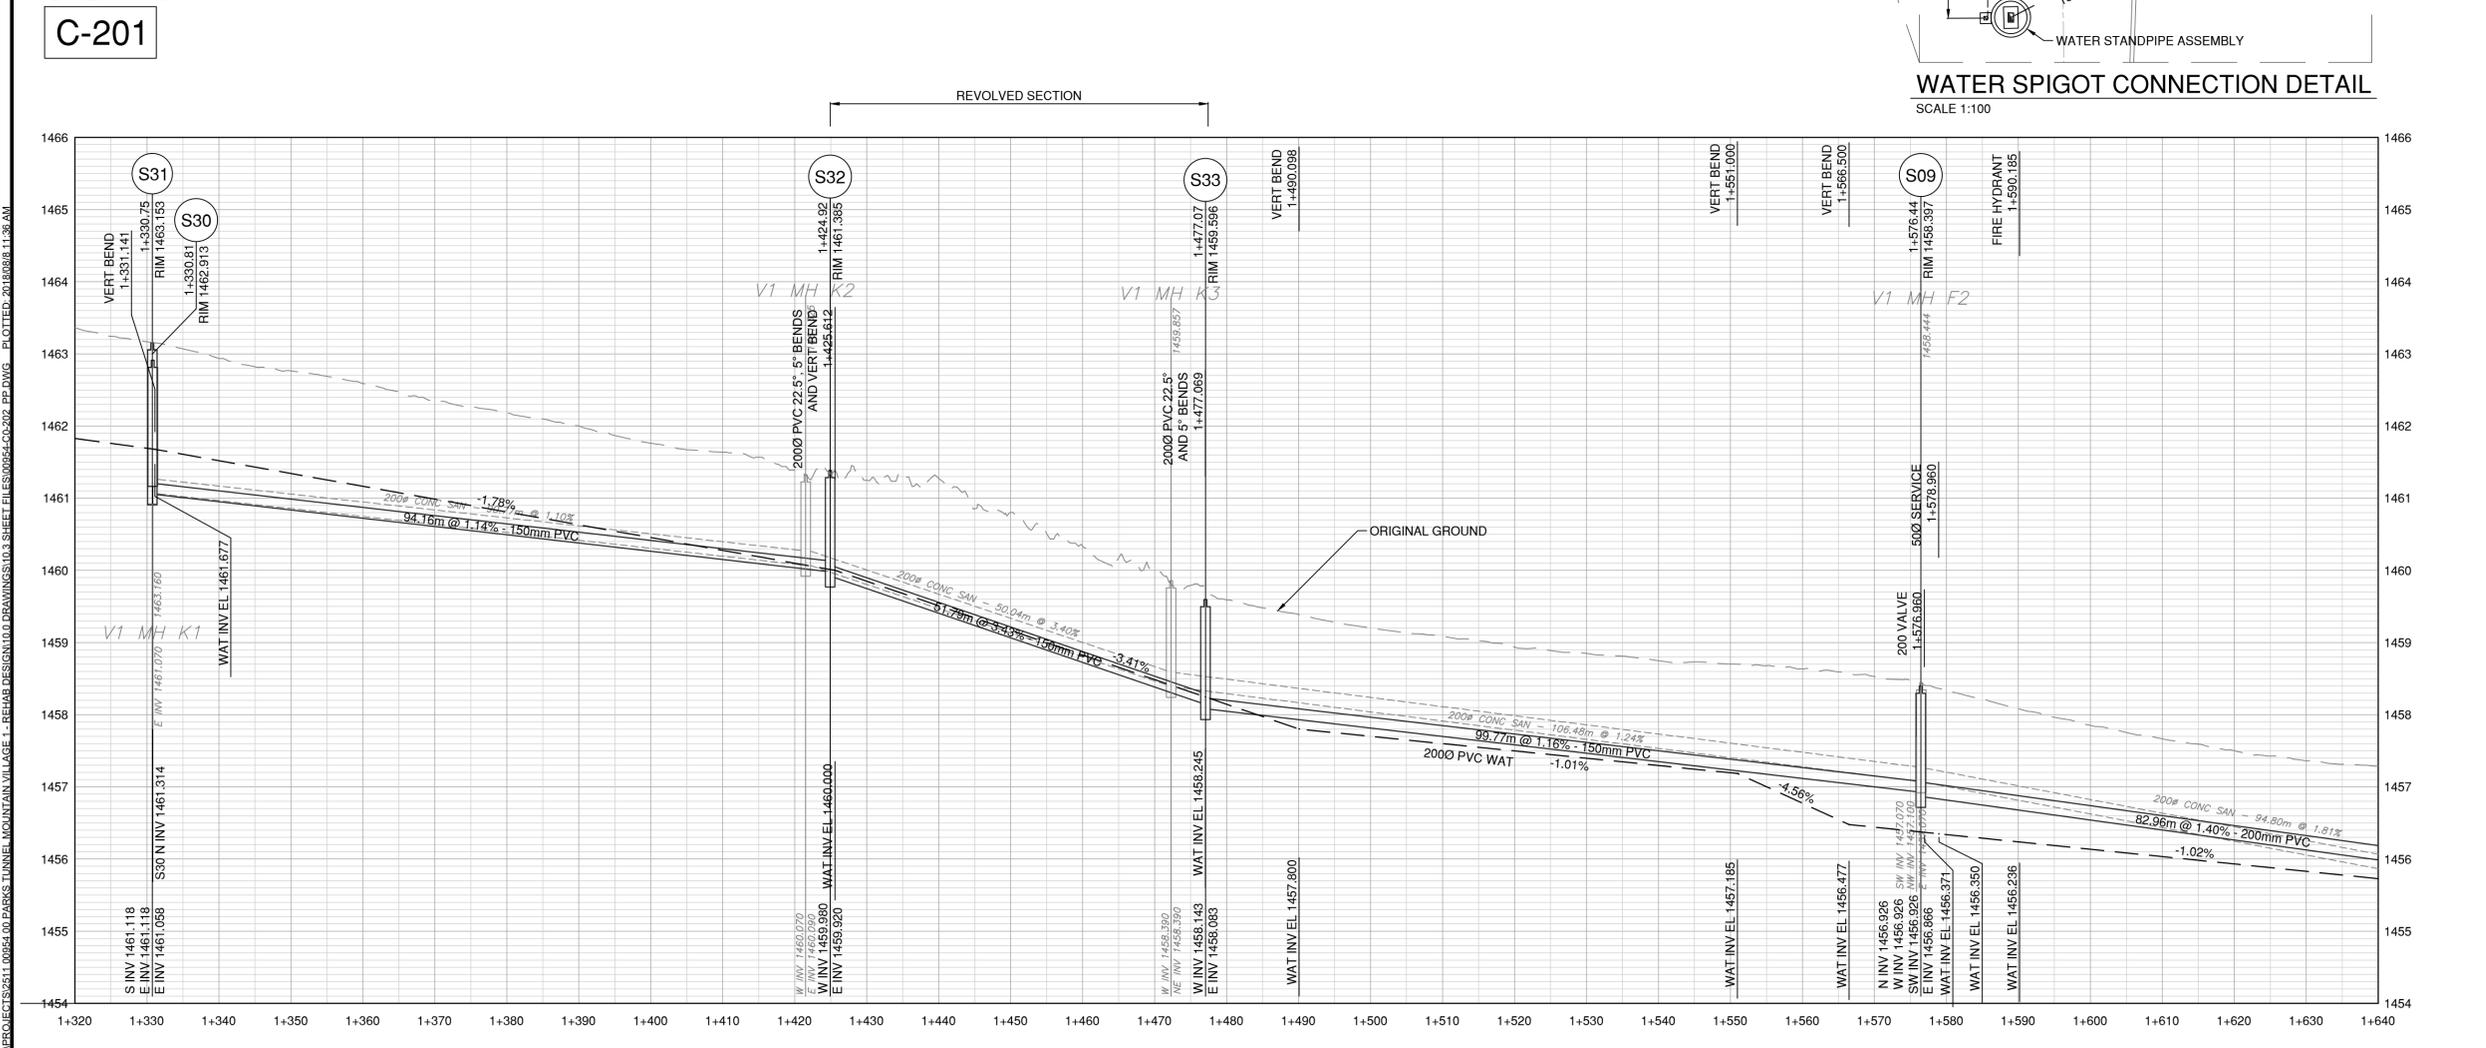


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Rev.	Date	Description	Drawn Dessiné	Designed Conçu	Approved Approuvé
6	2018.08.08	ADDENDUM 1	SS	DF	TM
5	2018.07.20	RE ISSUED FOR TENDER - FINAL	SS	DF	TM
4	2018.07.03	RE ISSUED FOR TENDER - FINAL	SS	DF	TM
3	2018.06.22	RE ISSUED FOR TENDER - FINAL	SS	DF	TM
2	2018.06.11	ISSUED FOR TENDER - FINAL	SS	DF	TM
1	2018.05.23	ISSUED FOR TENDER	SS	DF	TM

Rev.	Date	Description	Drawn Dessiné	Designed Conçu	Approved Approuvé
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3	2018.06.22	RE ISSUED FOR TENDER - FINAL	SS	DF	TM
2	2018.06.11	ISSUED FOR TENDER - FINAL	SS	DF	TM
1	2018.05.23	ISSUED FOR TENDER	SS	DF	TM



Consultant's Stamp
Sceau de l'expert-conseil

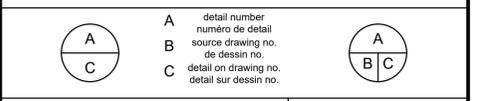Eng. Stamp
Sceau de l'ingénieur

PERMIT TO PRACTICE
McELHANNEY CONSULTING SERVICES LTD.
PERMIT NUMBER: P 6383

The Association of Professional Engineers,
Geologists and Geophysicists of Alberta

PROFESSIONAL ENGINEER
MONTREAL F. FORMER
August 9, 2018
PERMIT NUMBER: P243

Client

Parks Canada Agency
Western and Northern Region

L'Agence Parcs Canada
Ouest et Nord du Canada

Consultant's Name
Nom de l'expert-conseil

McElhanney
McElhanney Consulting Services Ltd.

Project Title
Titre du projet

TUNNEL MOUNTAIN VILLAGE 1

BANFF, AB
BANFF NATIONAL PARK

Drawing Title
Titre du dessin

**PLAN PROFILE
LOOP K TO LOOP F
STA 1+320 TO STA 1+640**


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	SS	2018.03.26
Designed by / Conçu par	Reviewed by / Révisé par	Scale / Echelle
DF	TM	H 1:500 V 1:50

Parks Canada Project Manager / Administrateur de Projets Parcs Canada

Client Acceptance / Acceptation du client

Approved by / Approuvé par

Project No. / No. du projet	Asset No. / No. du bien	Sheet No. / No. de la feuille
2511-00954-0		C-202

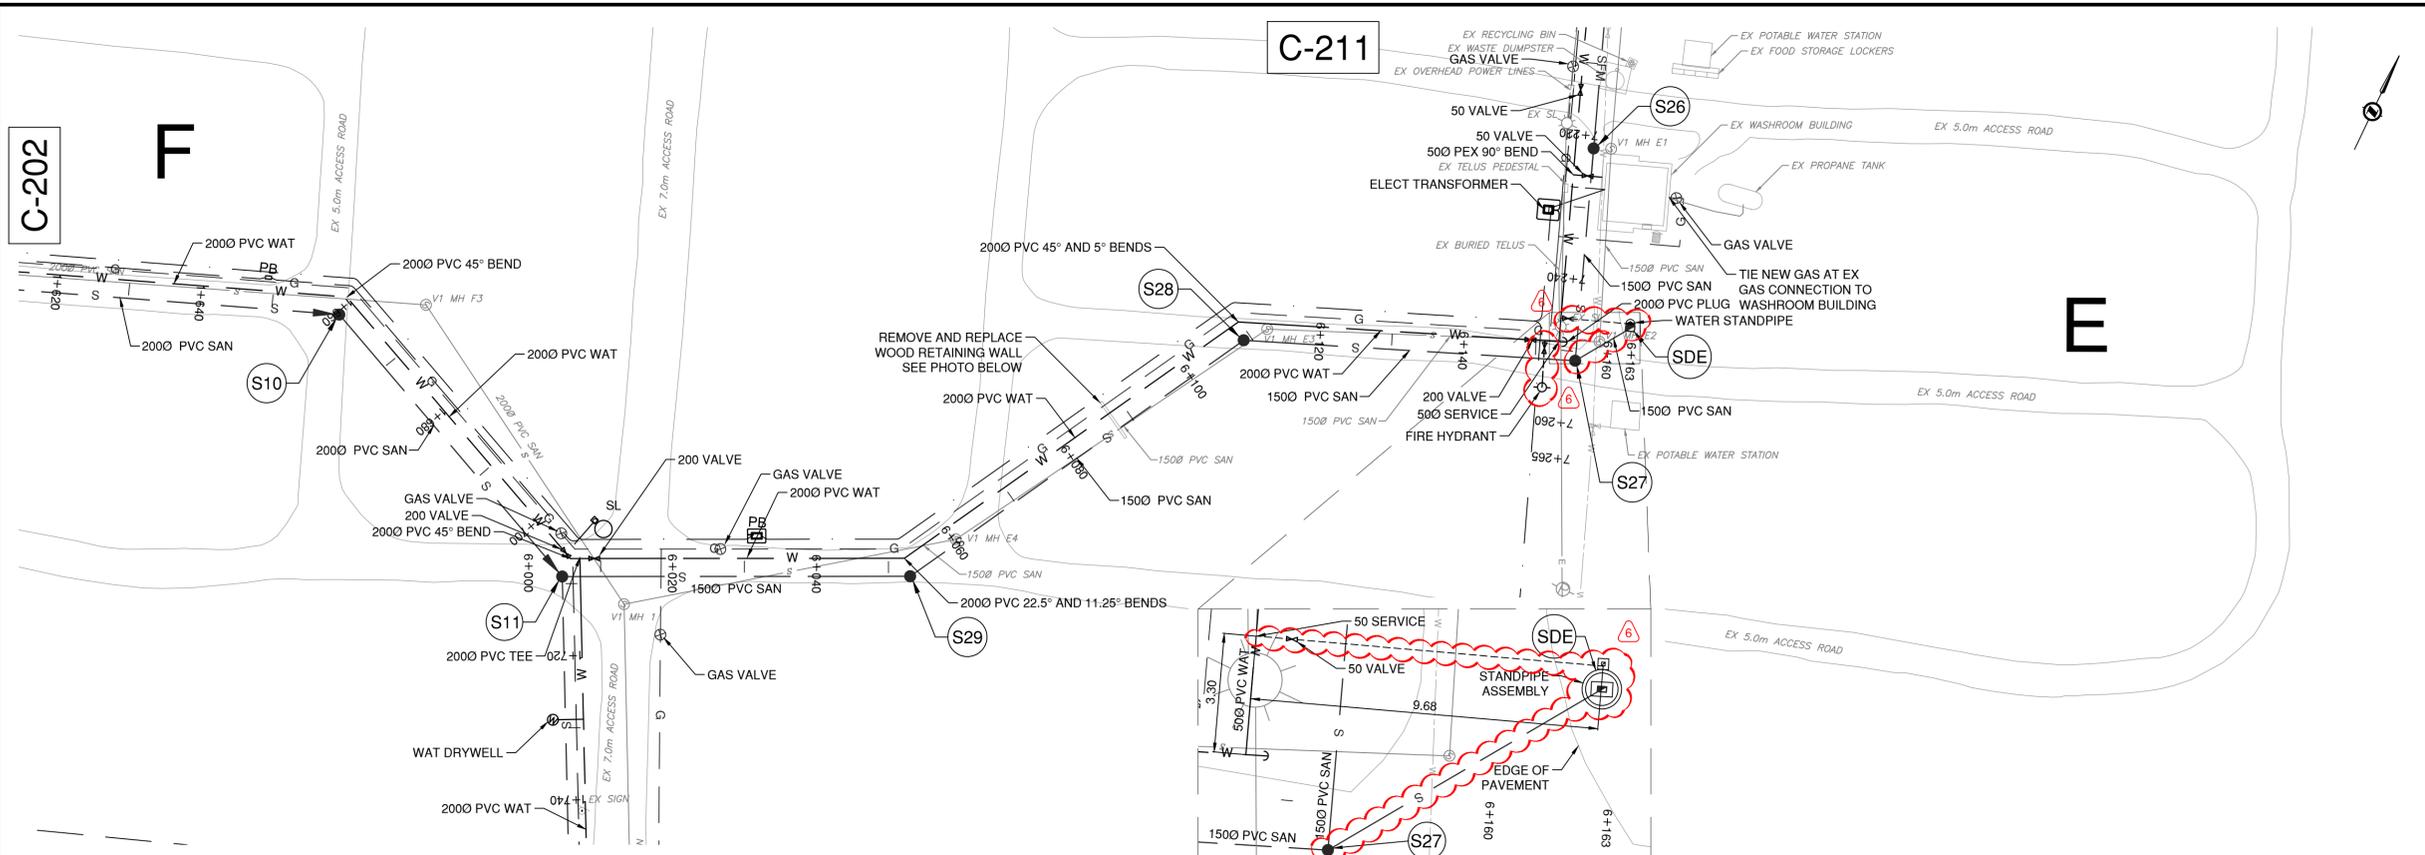

WATER SPIGOT CONNECTION DETAIL
SCALE 1:100


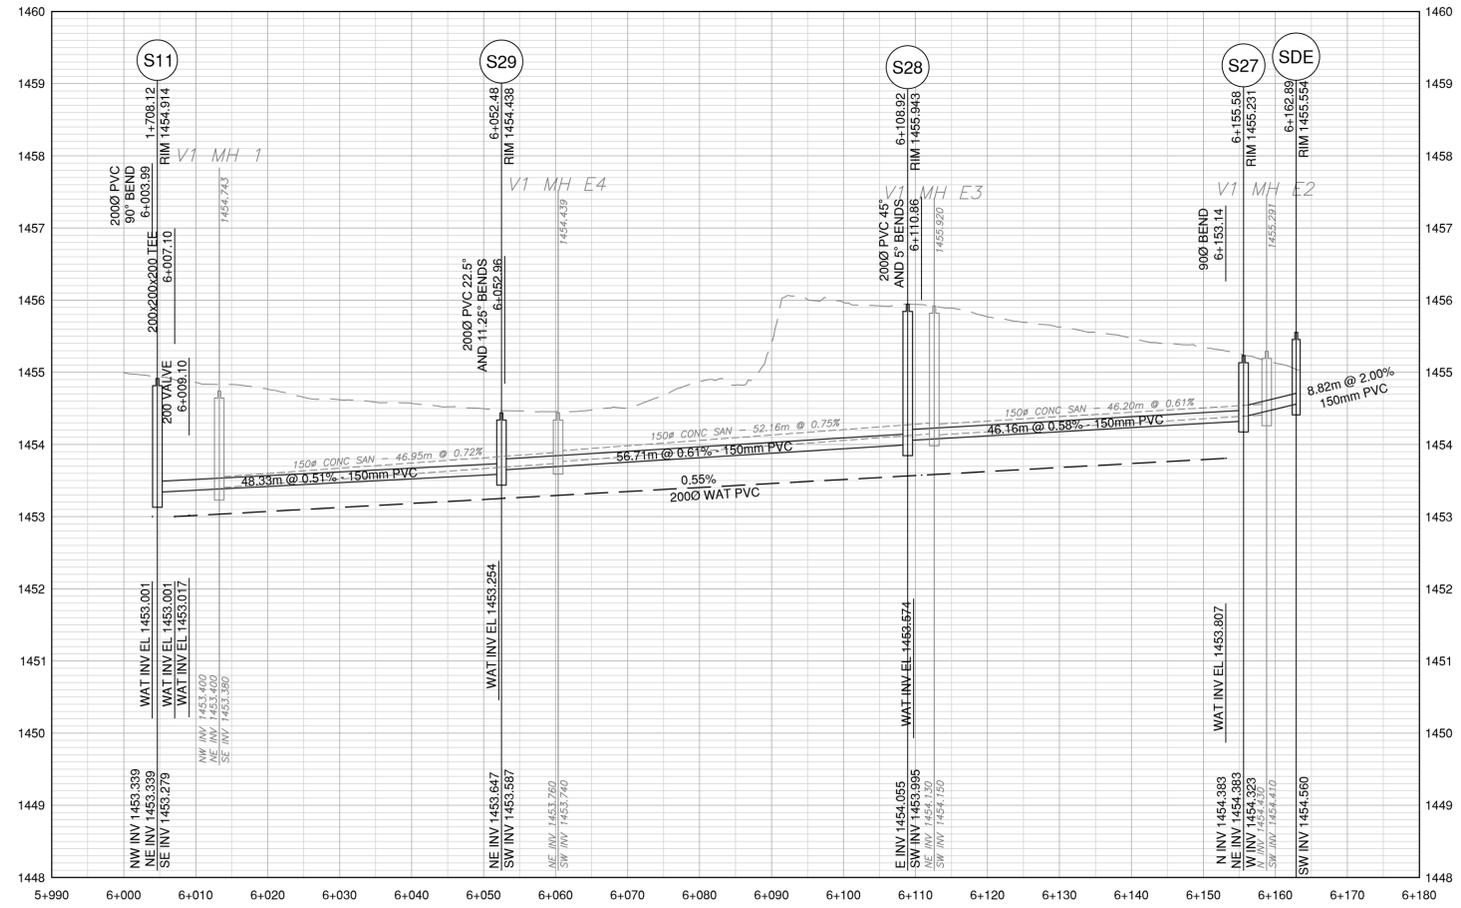


PHOTO - WOOD RETAINING WALL

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Rev.	Date	Description	Drawn Dessiné	Designed Conçu	Approved Approuvé
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1	2018.05.23	ISSUED FOR TENDER	SS	DF	TM

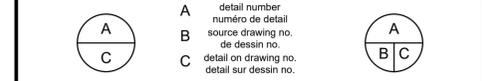

Consultant's Stamp
Sceau de l'expert-conseil

Eng. Stamp
Sceau de l'ingénieur

PERMIT TO PRACTICE
McELHANNEY CONSULTING SERVICES LTD.
PERMIT NUMBER: P 6383

The Association of Professional Engineers,
Geologists and Geophysicists of Alberta

PROFESSIONAL ENGINEER
ALBERTA
ANGUSTIN, 2018
PERMIT NUMBER: P243

Client

Parks Canada Agency
Western and Northern Region

L'Agence Parcs Canada
Ouest et Nord du Canada

Consultant's Name
Nom de l'expert-conseil

McElhanney
McElhanney Consulting Services Ltd.

Project Title
Titre du projet

TUNNEL MOUNTAIN VILLAGE 1

BANFF, AB
BANFF NATIONAL PARK

Drawing Title
Titre du dessin

PLAN PROFILE LOOP E TO MAIN STA 6+000 TO STA 6+200

Surveyed by / Arpenté par	Drawn by / Dessiné par	Date
	SS	2018.03.26
Designed by / Conçu par	Reviewed by / Révisé par	Scale / Echelle
DF	TM	H 1:500 V 1:50

Parks Canada Project Manager / Administrateur de Projets Parcs Canada

Client Acceptance / Acceptation du client

Approved by / Approuvé par

Project No. / No. du projet	Asset No. / No. du bien	Sheet No. / No. de la feuille
2511-00954-0		C-210

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Rev.	Date	Description	Drawn Dessiné	Designed Conçu	Approved Approuvé
6	2018.08.08	ADDENDUM 1	SS	DF	TM
5	2018.07.20	RE ISSUED FOR TENDER - FINAL	SS	DF	TM
4	2018.07.03	RE ISSUED FOR TENDER - FINAL	SS	DF	TM
3	2018.06.22	RE ISSUED FOR TENDER - FINAL	SS	DF	TM
2	2018.06.11	ISSUED FOR TENDER - FINAL	SS	DF	TM
1	2018.05.23	ISSUED FOR TENDER	SS	DF	TM

A	detail number	A
B	source drawing no.	B
C	detail on drawing no.	C

Consultant's Stamp
Sceau de l'expert-conseil

Eng. Stamp
Sceau de l'ingénieur

PERMIT TO PRACTICE
McELHANNEY CONSULTING SERVICES LTD.
PERMIT NUMBER: P 6383

The Association of Professional Engineers,
Geologists and Geophysicists of Alberta

ANGUST 9, 2018
PERMIT NUMBER: P243

Client

Parks Canada Agency
Western and
Northern Region

L'Agence Parcs Canada
Ouest et Nord
du Canada

Consultant's Name
Nom de l'expert-conseil

McElhanney
McElhanney Consulting Services Ltd.

Project Title
Titre du projet

**TUNNEL MOUNTAIN
VILLAGE 1**

BANFF, AB
BANFF NATIONAL PARK

Drawing Title
Titre du dessin


**PLAN PROFILE
LOOP G TO LOOP E
STA 7+000 TO STA 7+280**

Surveyed by / Arpenté par	Drawn by / Dessiné par	Date
DF	SS	2018.03.26
Designed by / Conçu par	Reviewed by / Révisé par	Scale / Echelle
DF	TM	H 1:500 V 1:50

Client Acceptance / Acceptation du client	Approved by / Approuvé par


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2511-00954-0		C-211

Drawing Reference No. / No. de référence du dessin

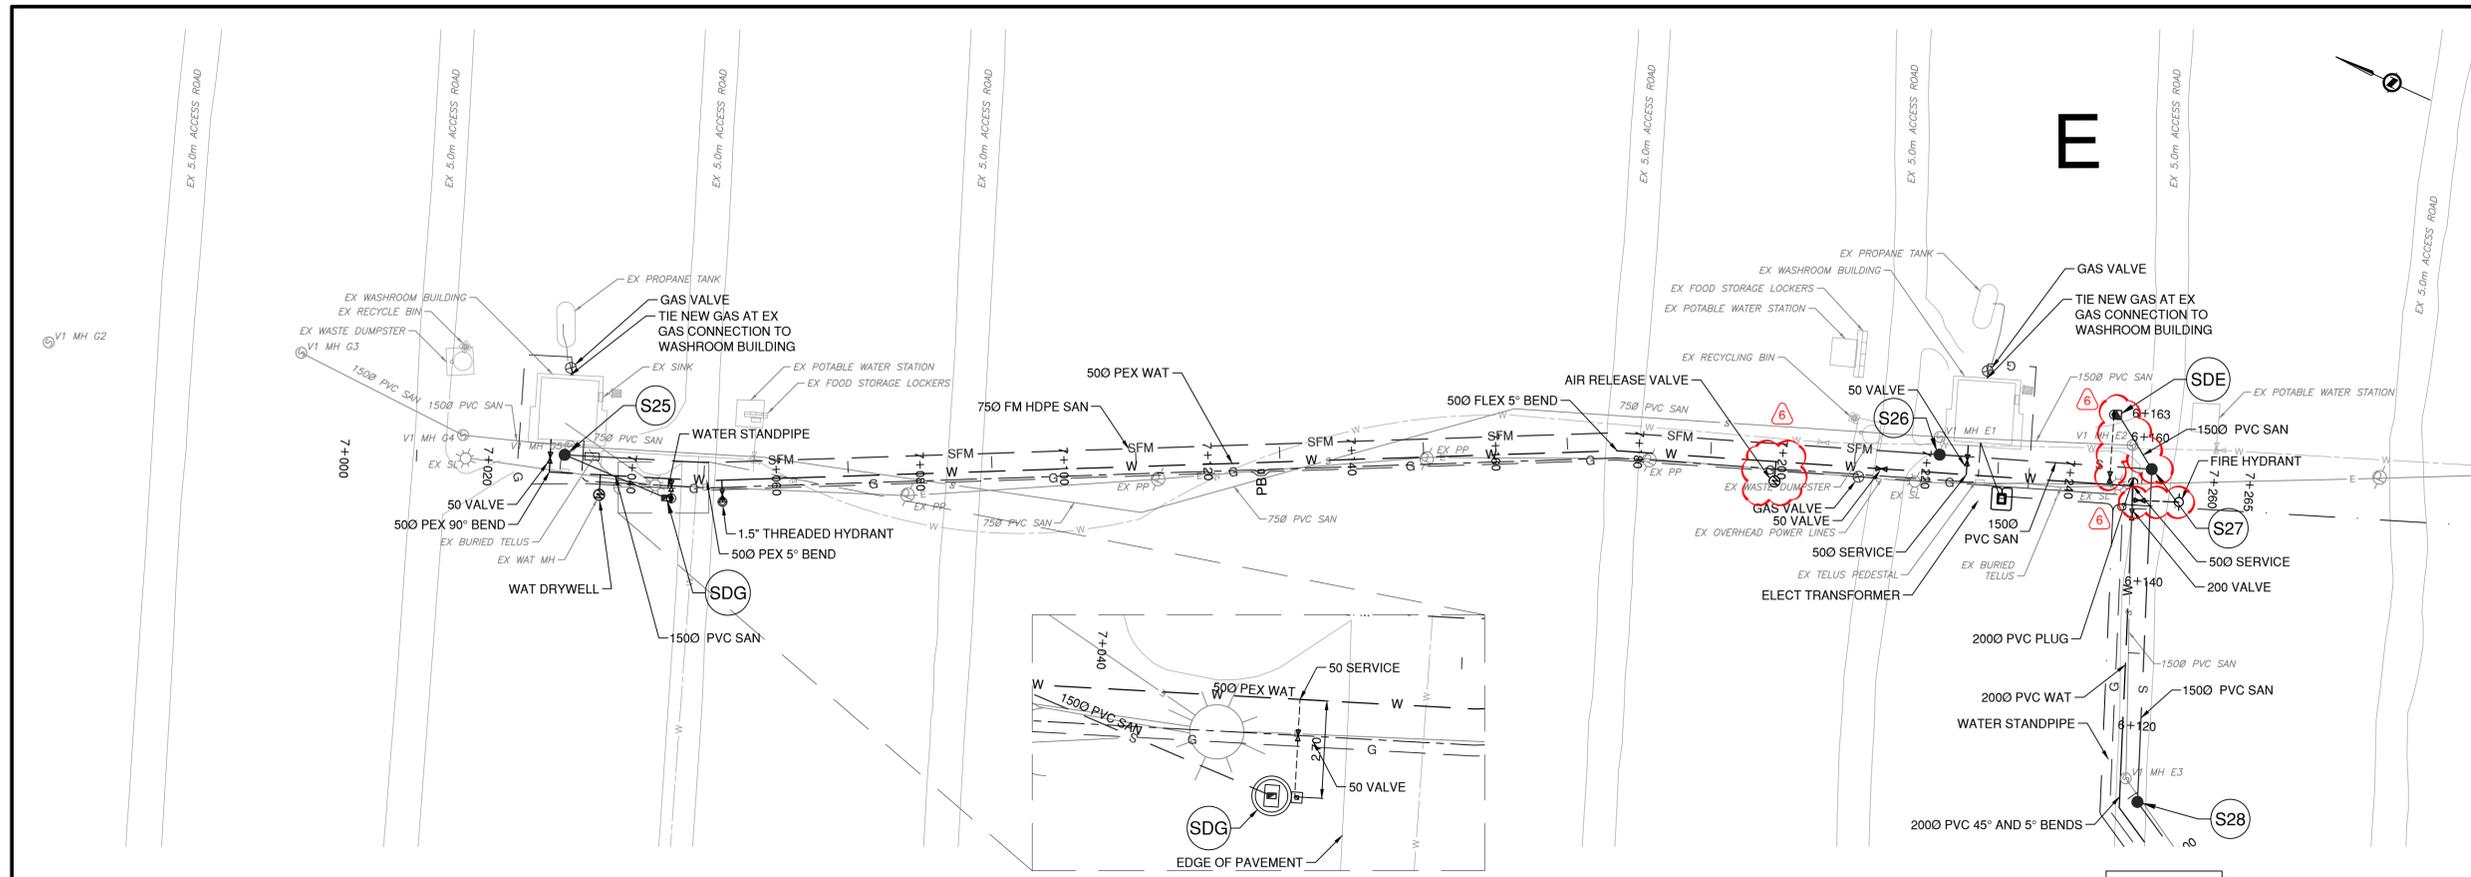


WATER SPIGOT CONNECTION DETAIL
SCALE 1:100

C-210

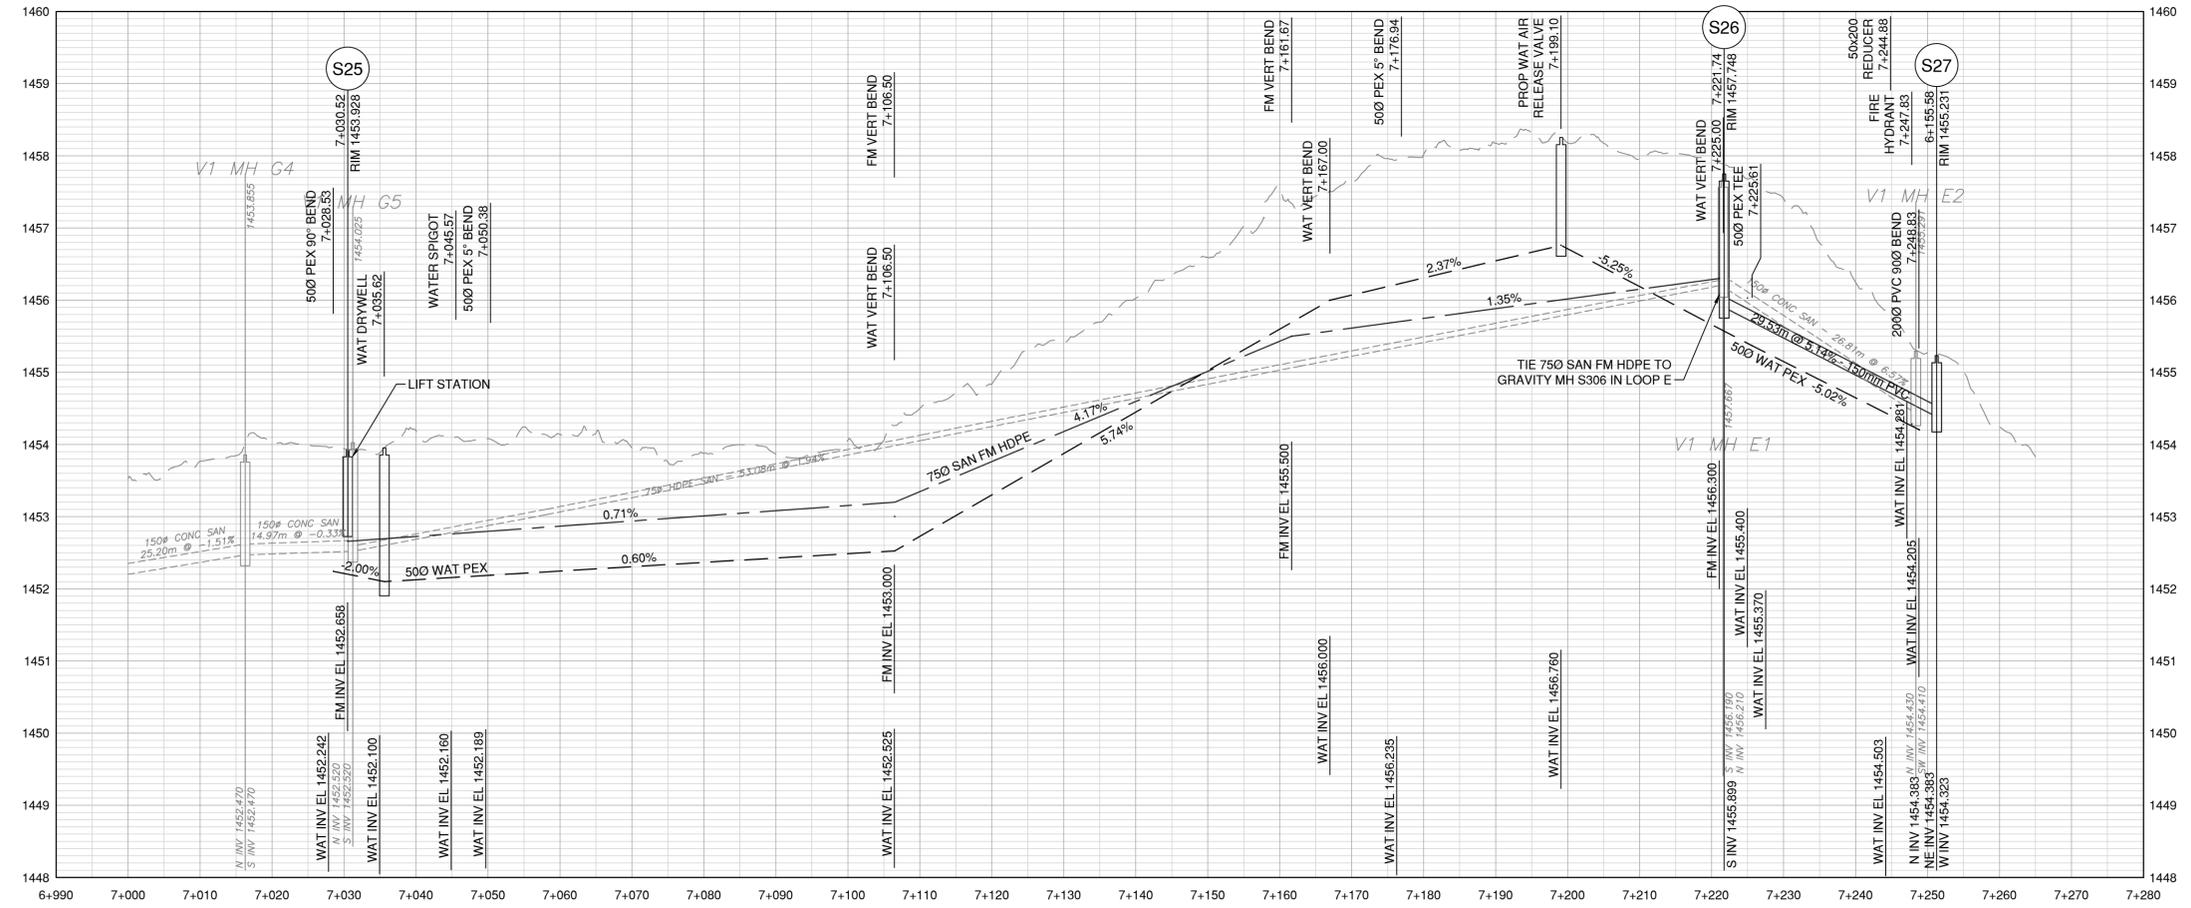

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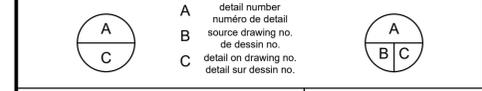

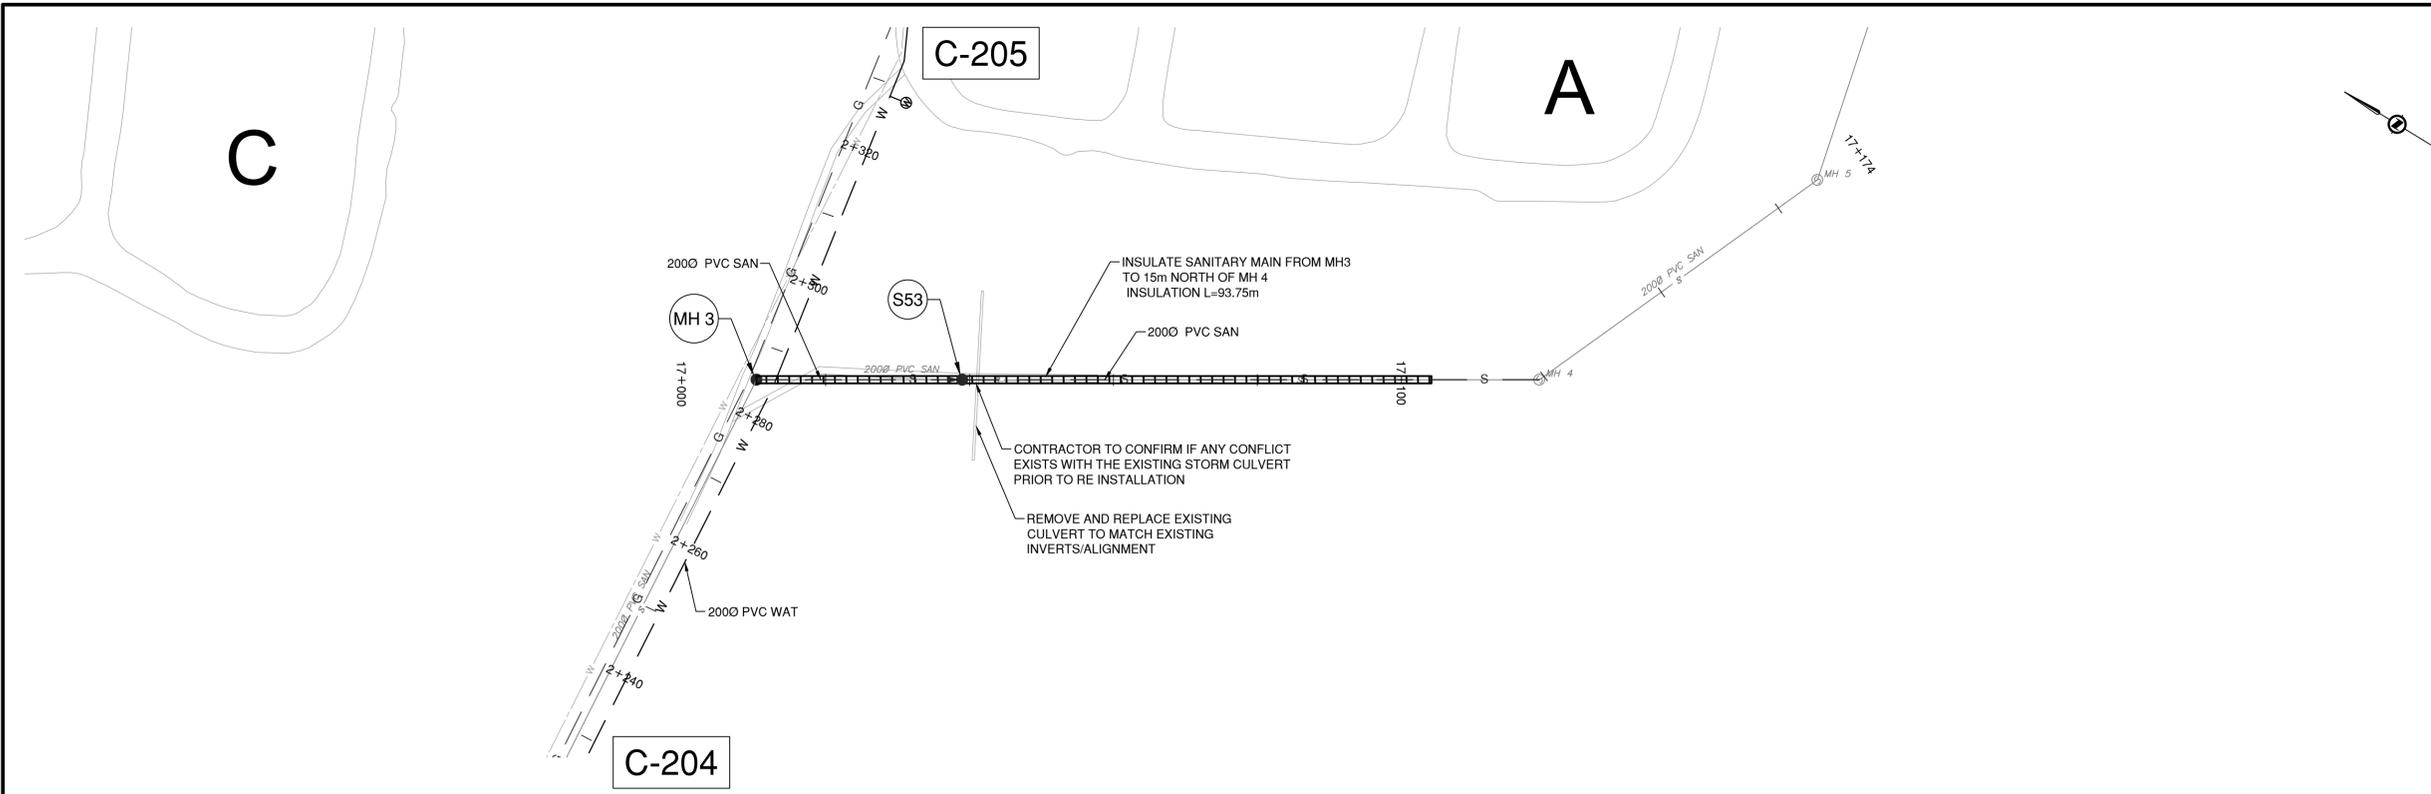
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1	2018.08.08	ADDENDUM 1	SS	DF	TM
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Rev.	Date	Description	Drawn Dessiné	Designed Conçu	Approved Approuvé
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Consultant's Stamp / Sceau de l'expert-conseil

PERMIT TO PRACTICE
McELHANNEY CONSULTING SERVICES LTD.
PERMIT NUMBER: P 6383

The Association of Professional Engineers, Geologists and Geophysicists of Alberta

Eng. Stamp / Sceau de l'ingénieur

PROFESSIONAL ENGINEER
ANGUSTIN F. FOMBERG
August 9, 2018
PERMIT NUMBER: P243

Client

Parks Canada Agency
Western and Northern Region

L'Agence Parcs Canada
Ouest et Nord du Canada

Consultant's Name / Nom de l'expert-conseil

McElhanney
McElhanney Consulting Services Ltd.

Project Title / Titre du projet

TUNNEL MOUNTAIN VILLAGE 1

BANFF, AB
BANFF NATIONAL PARK

Drawing Title / Titre du dessin

PLAN PROFILE
EXISTING MAIN REPLACEMENT
STA 17+000 TO STA 17+190


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Designed by / Conçu par	Reviewed by / Révisé par	Scale / Echelle
DF	TM	H 1:500 V 1:50

Parks Canada Project Manager / Administrateur de Projets Parcs Canada

Client Acceptance / Acceptation du client

Approved by / Approuvé par


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2511-00954-0		C-218

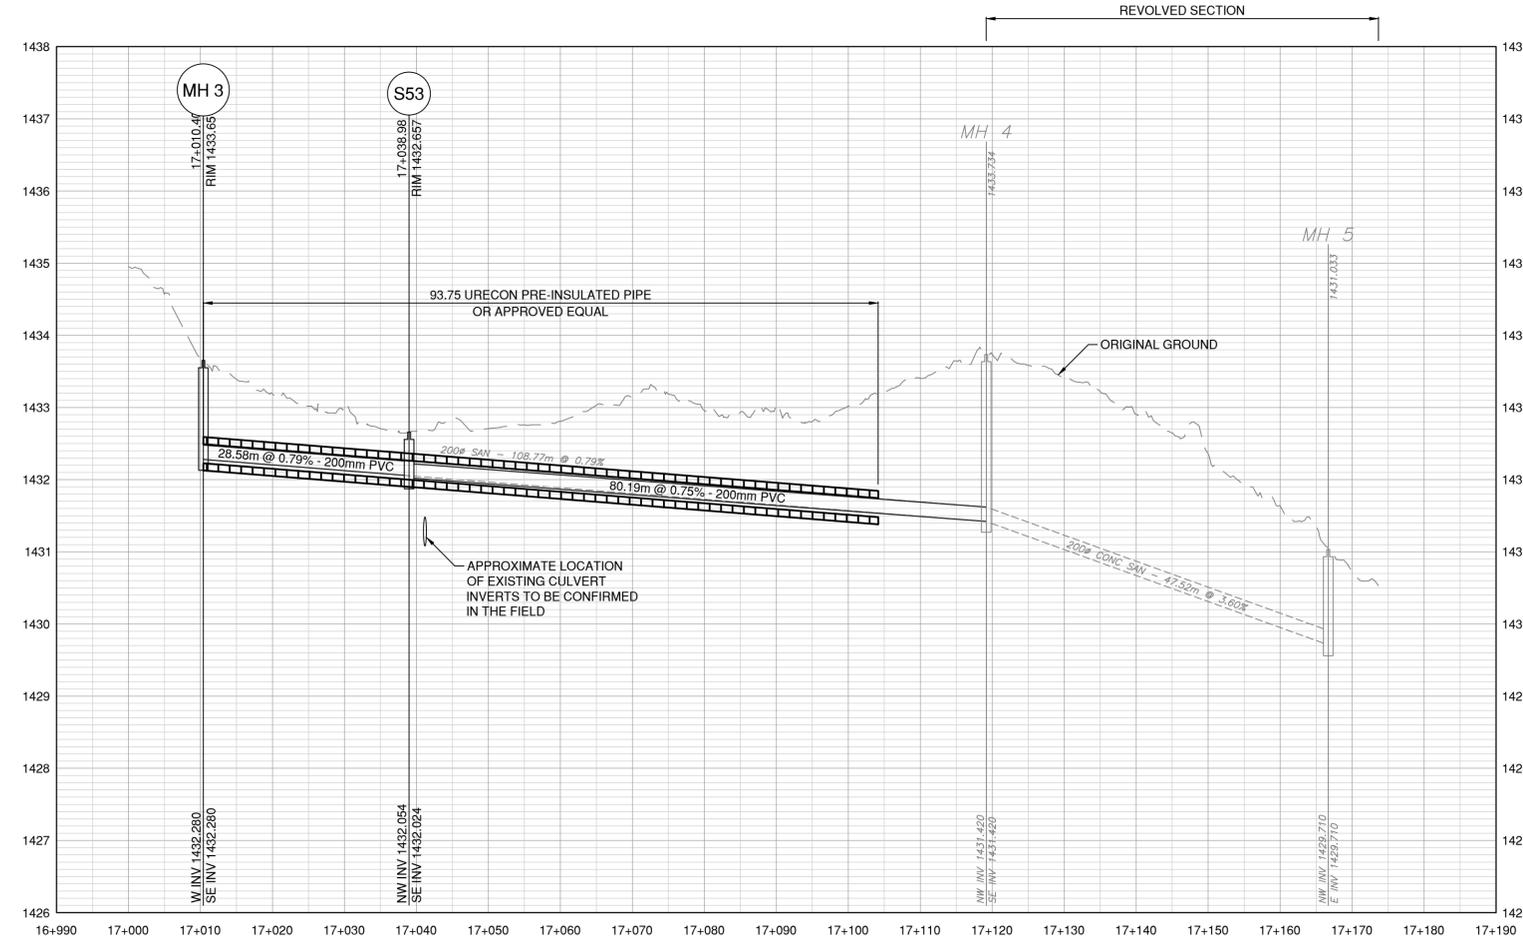


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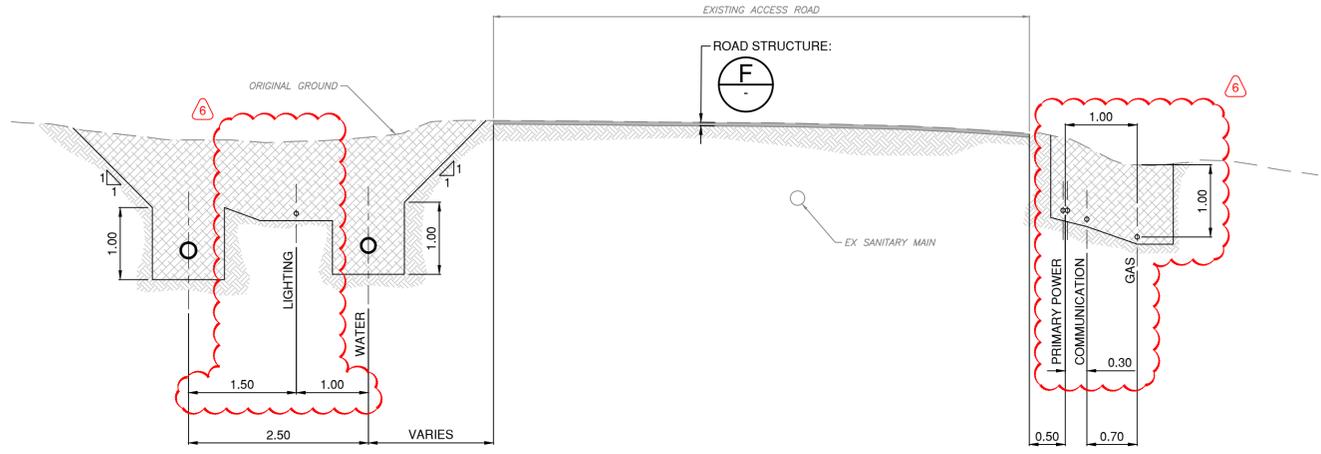
INFORMATION ON EXISTING UTILITIES MAY NOT BE COMPLETE OR ACCURATE. McELHANNEY, ITS EMPLOYEES AND DIRECTORS ARE NOT RESPONSIBLE NOR LIABLE FOR THE LOCATION OF ANY UNDERGROUND CONDUITS, PIPES, CABLES, OR OTHER FACILITIES WHETHER SHOWN OR OMITTED FROM THIS DRAWING. PRIOR TO CONSTRUCTION, CONTRACTOR SHALL EXPOSE LOCATIONS OF ALL EXISTING FACILITIES BY HAND DIGGING OR HYDROVAC AND ADVISE THE ENGINEER OF POTENTIAL CONFLICTS.




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C-116

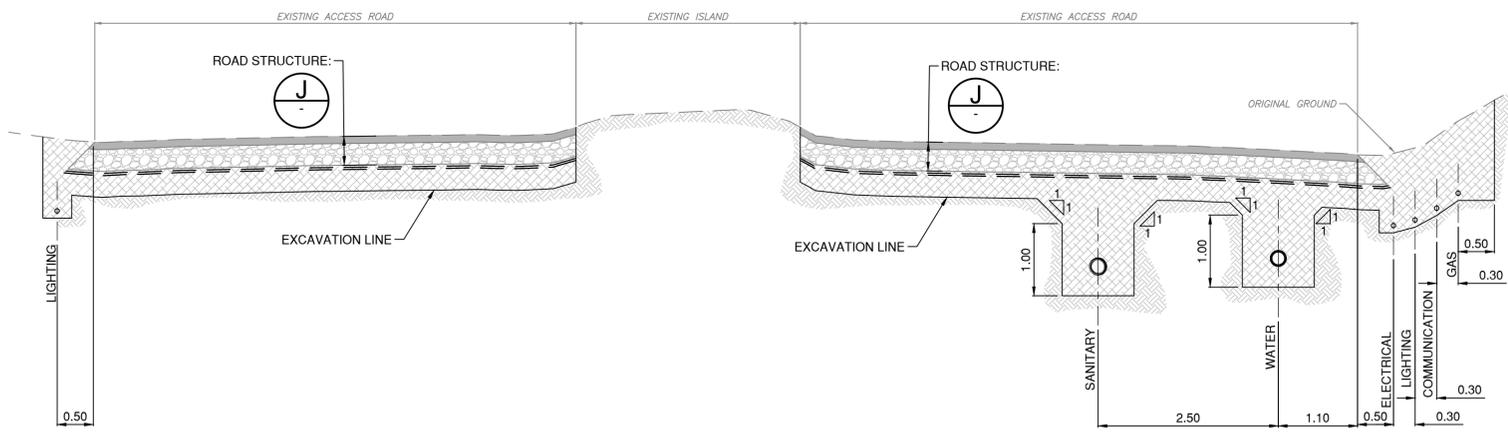


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C-115

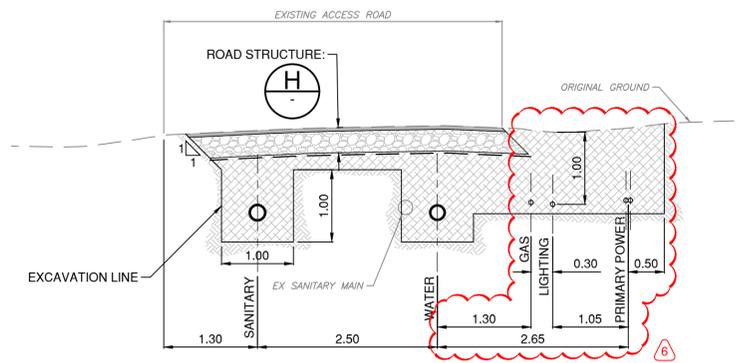


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C-115

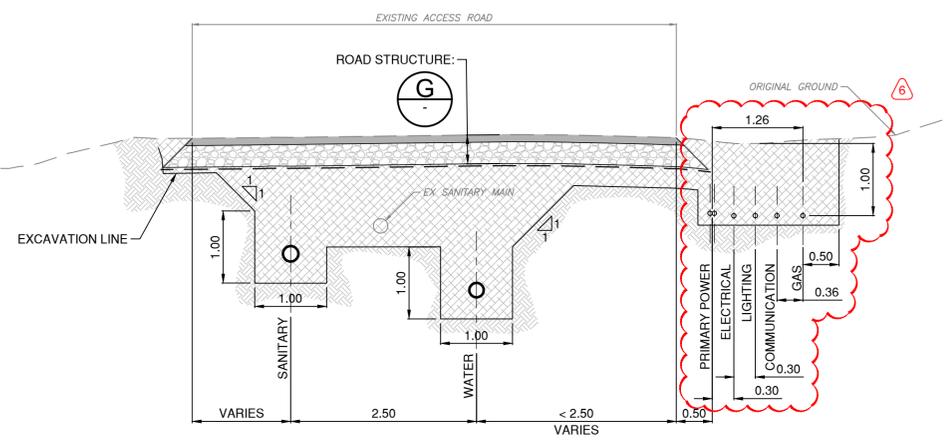


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C-115

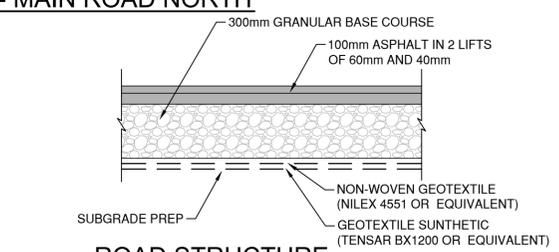


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C-120 SCALE 1:20

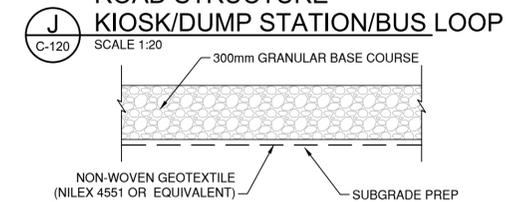


J ROAD STRUCTURE - KIOSK/DUMP STATION/BUS LOOP
C-120 SCALE 1:20

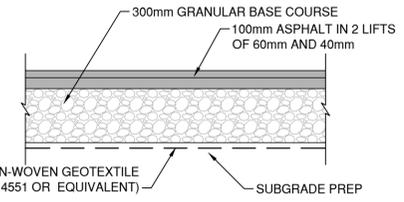


G ROAD STRUCTURE - MAIN ROAD
C-120 SCALE 1:20

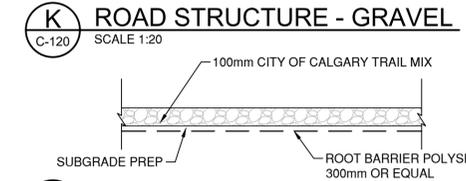


K ROAD STRUCTURE - GRAVEL
C-120 SCALE 1:20

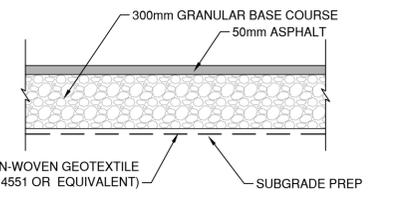

H ROAD STRUCTURE - LOOPS
C-120 SCALE 1:20

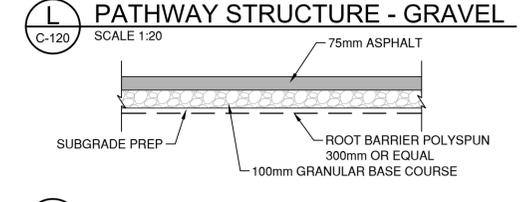

L PATHWAY STRUCTURE - GRAVEL
C-120 SCALE 1:20

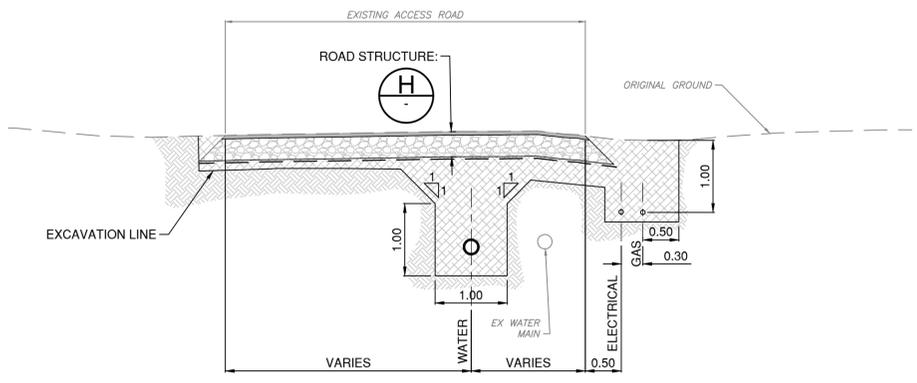

C TYPICAL SECTION - WATERMAIN
C-116

M PATHWAY STRUCTURE - PAVED
C-120 SCALE 1:20

Rev.	Date	Description	Drawn Dessiné	Designed Conçu	Approved Approuvé
6	2018.08.08	ADDENDUM 1	SS	DF	TM
5	2018.07.20	RE ISSUED FOR TENDER - FINAL	SS	DF	TM
4	2018.07.03	RE ISSUED FOR TENDER - FINAL	SS	DF	TM
3	2018.06.22	RE ISSUED FOR TENDER - FINAL	SS	DF	TM
2	2018.06.11	ISSUED FOR TENDER - FINAL	SS	DF	TM
1	2018.05.23	ISSUED FOR TENDER	SS	DF	TM

Consultant's Stamp
Sceau de l'expert-conseil

Eng. Stamp
Sceau de l'ingénieur

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PROFESSIONAL ENGINEER
ALBERTA
ANGUS, 2018
PERMIT NUMBER: P243

Client

Parks Canada Agency
Western and Northern Region

L'Agence Parcs Canada
Ouest et Nord du Canada

Consultant's Name
Nom de l'expert-conseil

McElhanney
McElhanney Consulting Services Ltd.

Project Title
Titre du projet

TUNNEL MOUNTAIN VILLAGE 1

BANFF, AB
BANFF NATIONAL PARK




Drawing Title
Titre du dessin

TYPICAL SECTIONS

Surveyed by / Arpenté par	Drawn by / Dessiné par	Date
	SS	
Designed by / Conçu par	Reviewed by / Révisé par	Scale / Echelle
DF	TM	
Parks Canada Project Manager / Administrateur de Projets Parcs Canada		
Client Acceptance / Acceptation du client	Approved by / Approuvé par	
Parks Canada Responsible Officer / Agente Responsable Projets Canada		
Project No. / No. du projet	Asset No. / No. du bien	Sheet No. / No. de la feuille
2511-00954-0		C-301
Drawing Reference No. / No. de référence du dessin		
NO		

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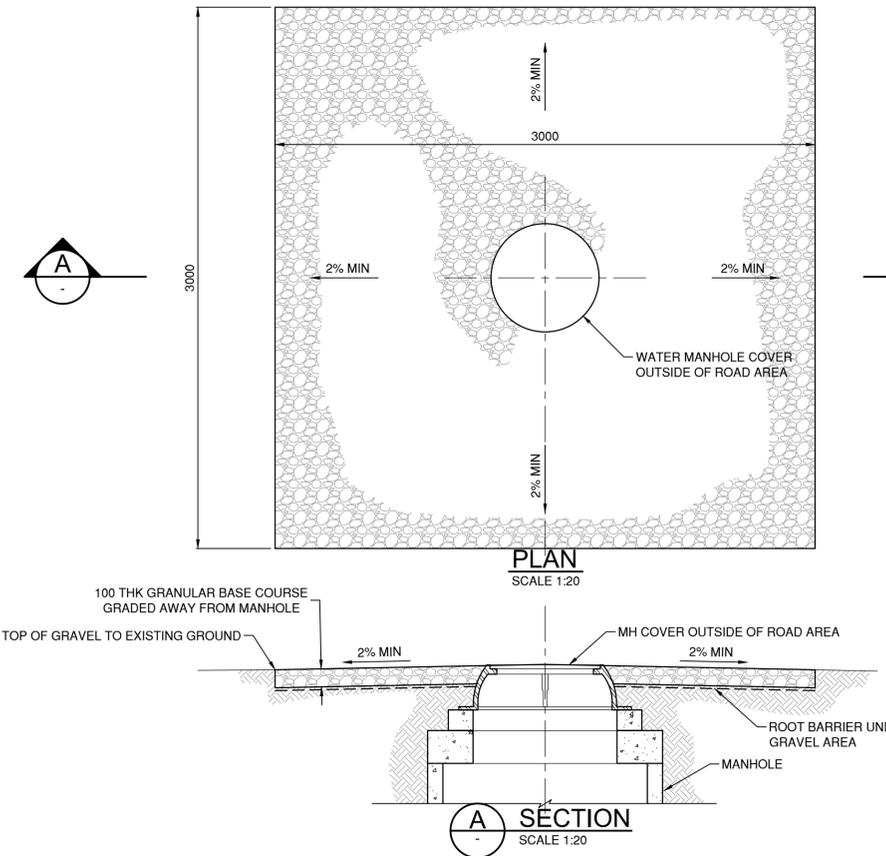
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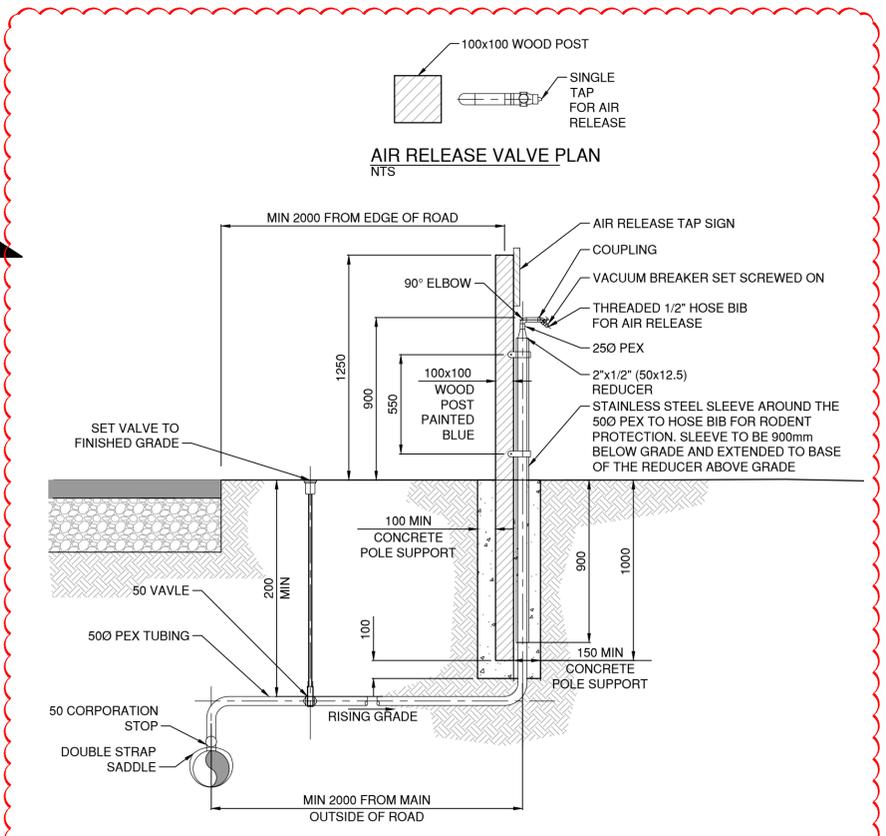
1 DETAIL - PIPE BEDDING
SCALE 1:20

2 DETAIL - WATER DRYWELL
SCALE 1:20

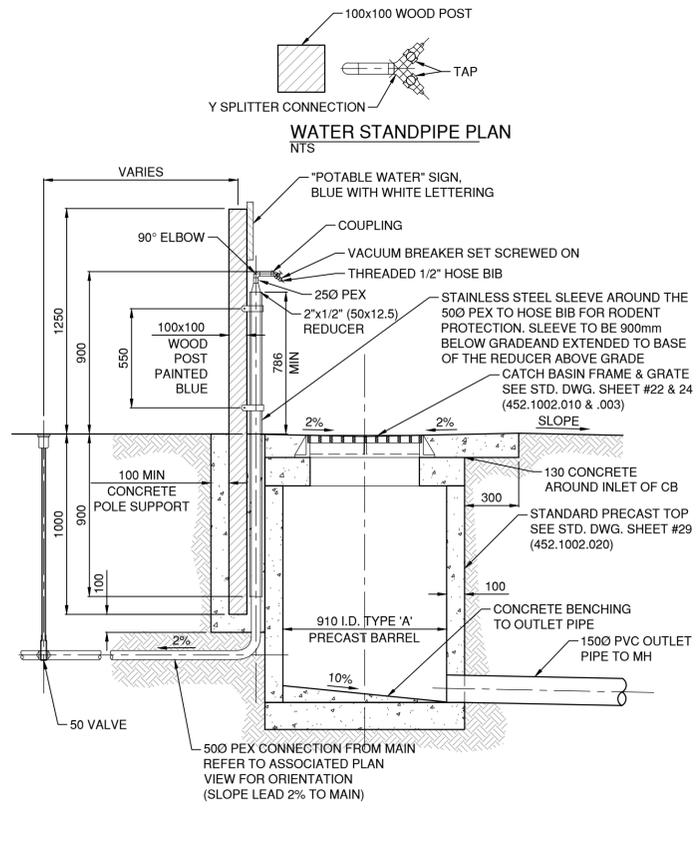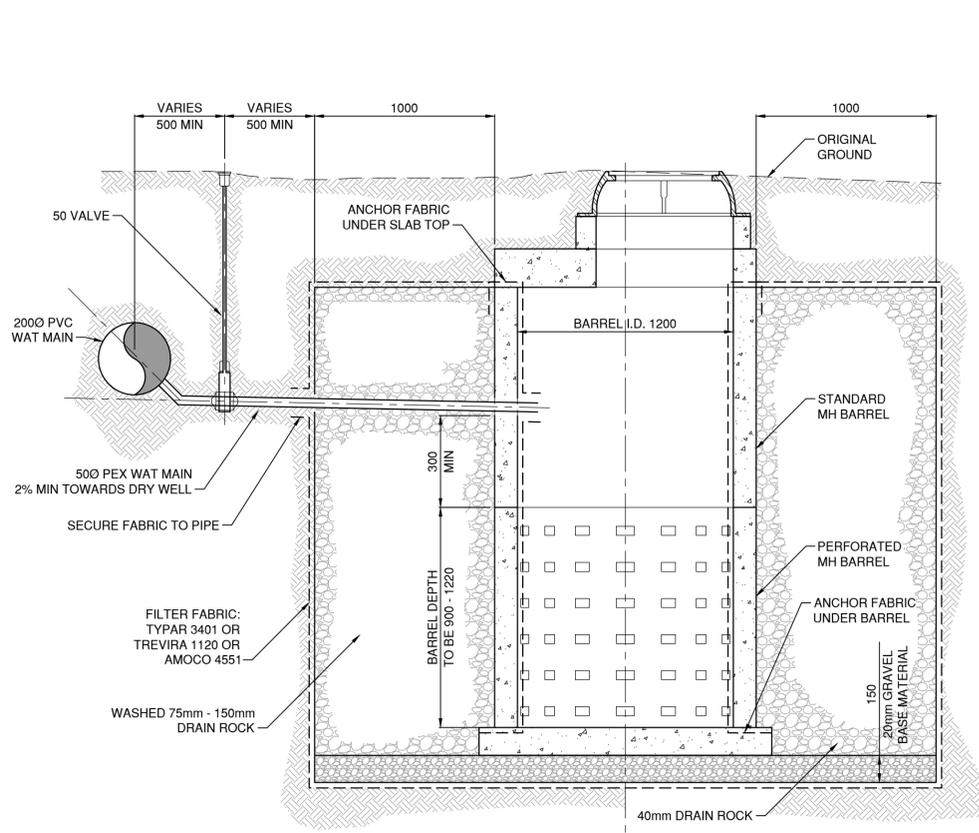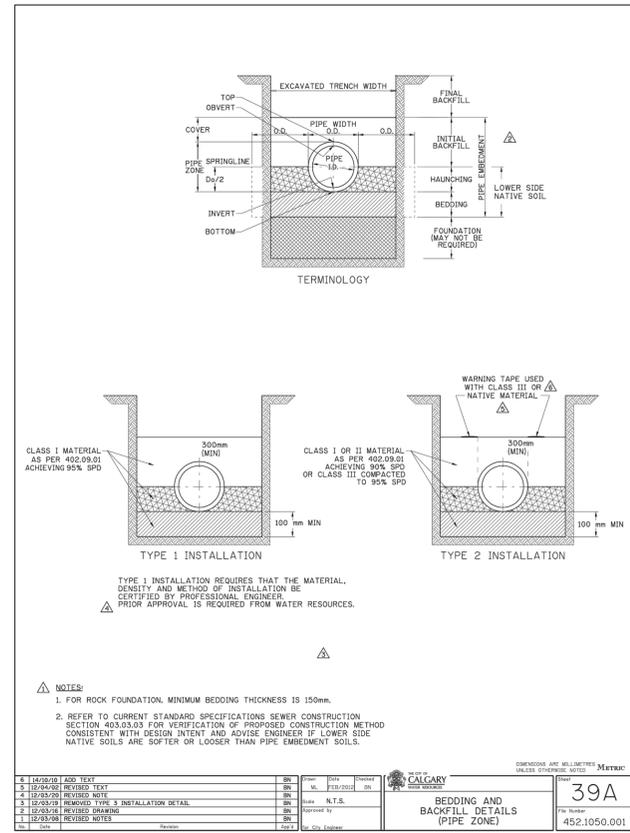
3 DETAIL - WATER STANDPIPE
SCALE 1:20



4 DETAIL - MANHOLE GRAVEL PAD
SCALE 1:20



5 DETAIL - AIR RELEASE VALVE
SCALE 1:20

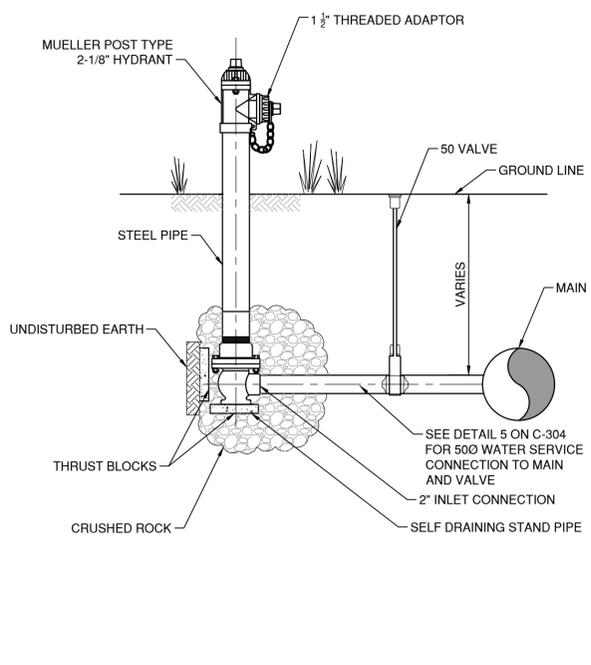

6 DETAIL - 1.5" THREADED HYDRANT
SCALE 1:20

Rev.	Date	Description	Drawn Dessiné	Designed Conçu	Approved Approuvé
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PERMIT NUMBER: P 6383

The Association of Professional Engineers, Geologists and Geophysicists of Alberta

AVGUST 9, 2018
PERMIT NUMBER: P243

Client

Parks Canada Agency
Western and Northern Region

L'Agence Parcs Canada
Ouest et Nord du Canada

Consultant's Name
Nom de l'expert-conseil

McElhanney
McElhanney Consulting Services Ltd.

Project Title
Titre du projet

TUNNEL MOUNTAIN VILLAGE 1

BANFF, AB
BANFF NATIONAL PARK

Drawing Title
Titre du dessin

WATER DETAILS SHEET 2 OF 2

Surveyed by / Arpenté par	Drawn by / Dessiné par	Date
DF	SS	
Designed by / Conçu par	Reviewed by / Révisé par	Scale / Echelle
DF	TM	

Parks Canada Project Manager / Administrateur de Projets Parcs Canada

Client Acceptance / Acceptation du client

Approved by / Approuvé par

Parks Canada Responsible Officer / Agente Responsable Projets Canada

Parks Canada Project Manager / Administrateur de Projets Parcs Canada

Project No. / No. du projet	Asset No. / No. du-bien	Sheet No. / No. de la feuille
2511-00954-0		C-305

Drawing Reference No. / No. de référence du dessin

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