



SYMBOL LEGEND	
	DUPLEX POWER RECEPTACLE (* INDICATES SWITCHING REQUIRED BY ASHRAE 90.1 2010)
	QUAD RECEPTACLE (* INDICATES SWITCHING REQUIRED BY ASHRAE 90.1 2010)
	POWER RECEPTACLE (CEILING)
	SINGLE POLE SWITCH
	LOW VOLTAGE DIMMING SWITCH
	WALL STRUCTURED WIRING OUTLET
	DIRECT CONNECTION
	SURVEILANCE CAMERA
	PANEL
	DAYLIGHT HARVESTING SENSOR
	WALL MOUNTED FIXTURE
	CEILING MOUNTED FIXTURE
	EXISTING FIRE ALARM PANEL
	LUMINAIRE ON EMERGENCY POWER CIRCUIT OR WITH BATTERY BACKUP AS INDICATED.
	2x4 LUMINAIRE
	600x600 LUMINAIRE
	4FT STRIP (SURFACE OR SUSPENDED - AS INDICATED)
	MOTOR AND DISCONNECT
	AV SPEAKER
	FIRE ALARM BELL
	PULL STATION
	CARD READER
	REQUEST TO EXIT SENSOR
	ELECTRIFIED DOOR HARDWARE
	DOOR POSITION SWITCH
	WALL EXIT, TYPE AS INDICATED
	OCCUPANCY SENSOR - WALL AND CEILING D: INDICATES WITH DAYLIGHT SENSOR
	INDICATES DEVICE IS ABOVE COUNTER
	LUMINAIRE TYPE TAG

DRAWING INDEX		
NO.	TITLE	REVISION
E01	ELECTRICAL DRAWING LIST & SYMBOL LEGEND	2
E02	ELECTRICAL DEMOLITION DRAWING	2
E03	NEW ELECTRICAL PLAN	2
E10	ELECTRICAL DETAILS	2

NOTES LEGEND:

VS 1. INDICATES THAT THE NOTE APPLIES TO THE ENTIRE DRAWING.

INDICATES THAT THE NOTE IS REFERENCED TO A SPECIFIC LOCATION ON THE DRAWING.

Revision/	Description/Description	Date/Date
2	ISSUED FOR TENDER	18JUN11
1	ISSUED FOR TENDER	16APR27

**FISHERIES & OCEANS
CANADA**

200-401 BARRARD STREET
VANCOUVER, BC V6C 3R2

Project title/Titre du projet

4160 MARINE DRIVE
WEST VANCOUVER, BC V7V 1H2

**PSEC CLASSROOM
ADDITION & RENOVATION**

Consultant Signature Only

Designed by/Concept par
DAVID CARTER


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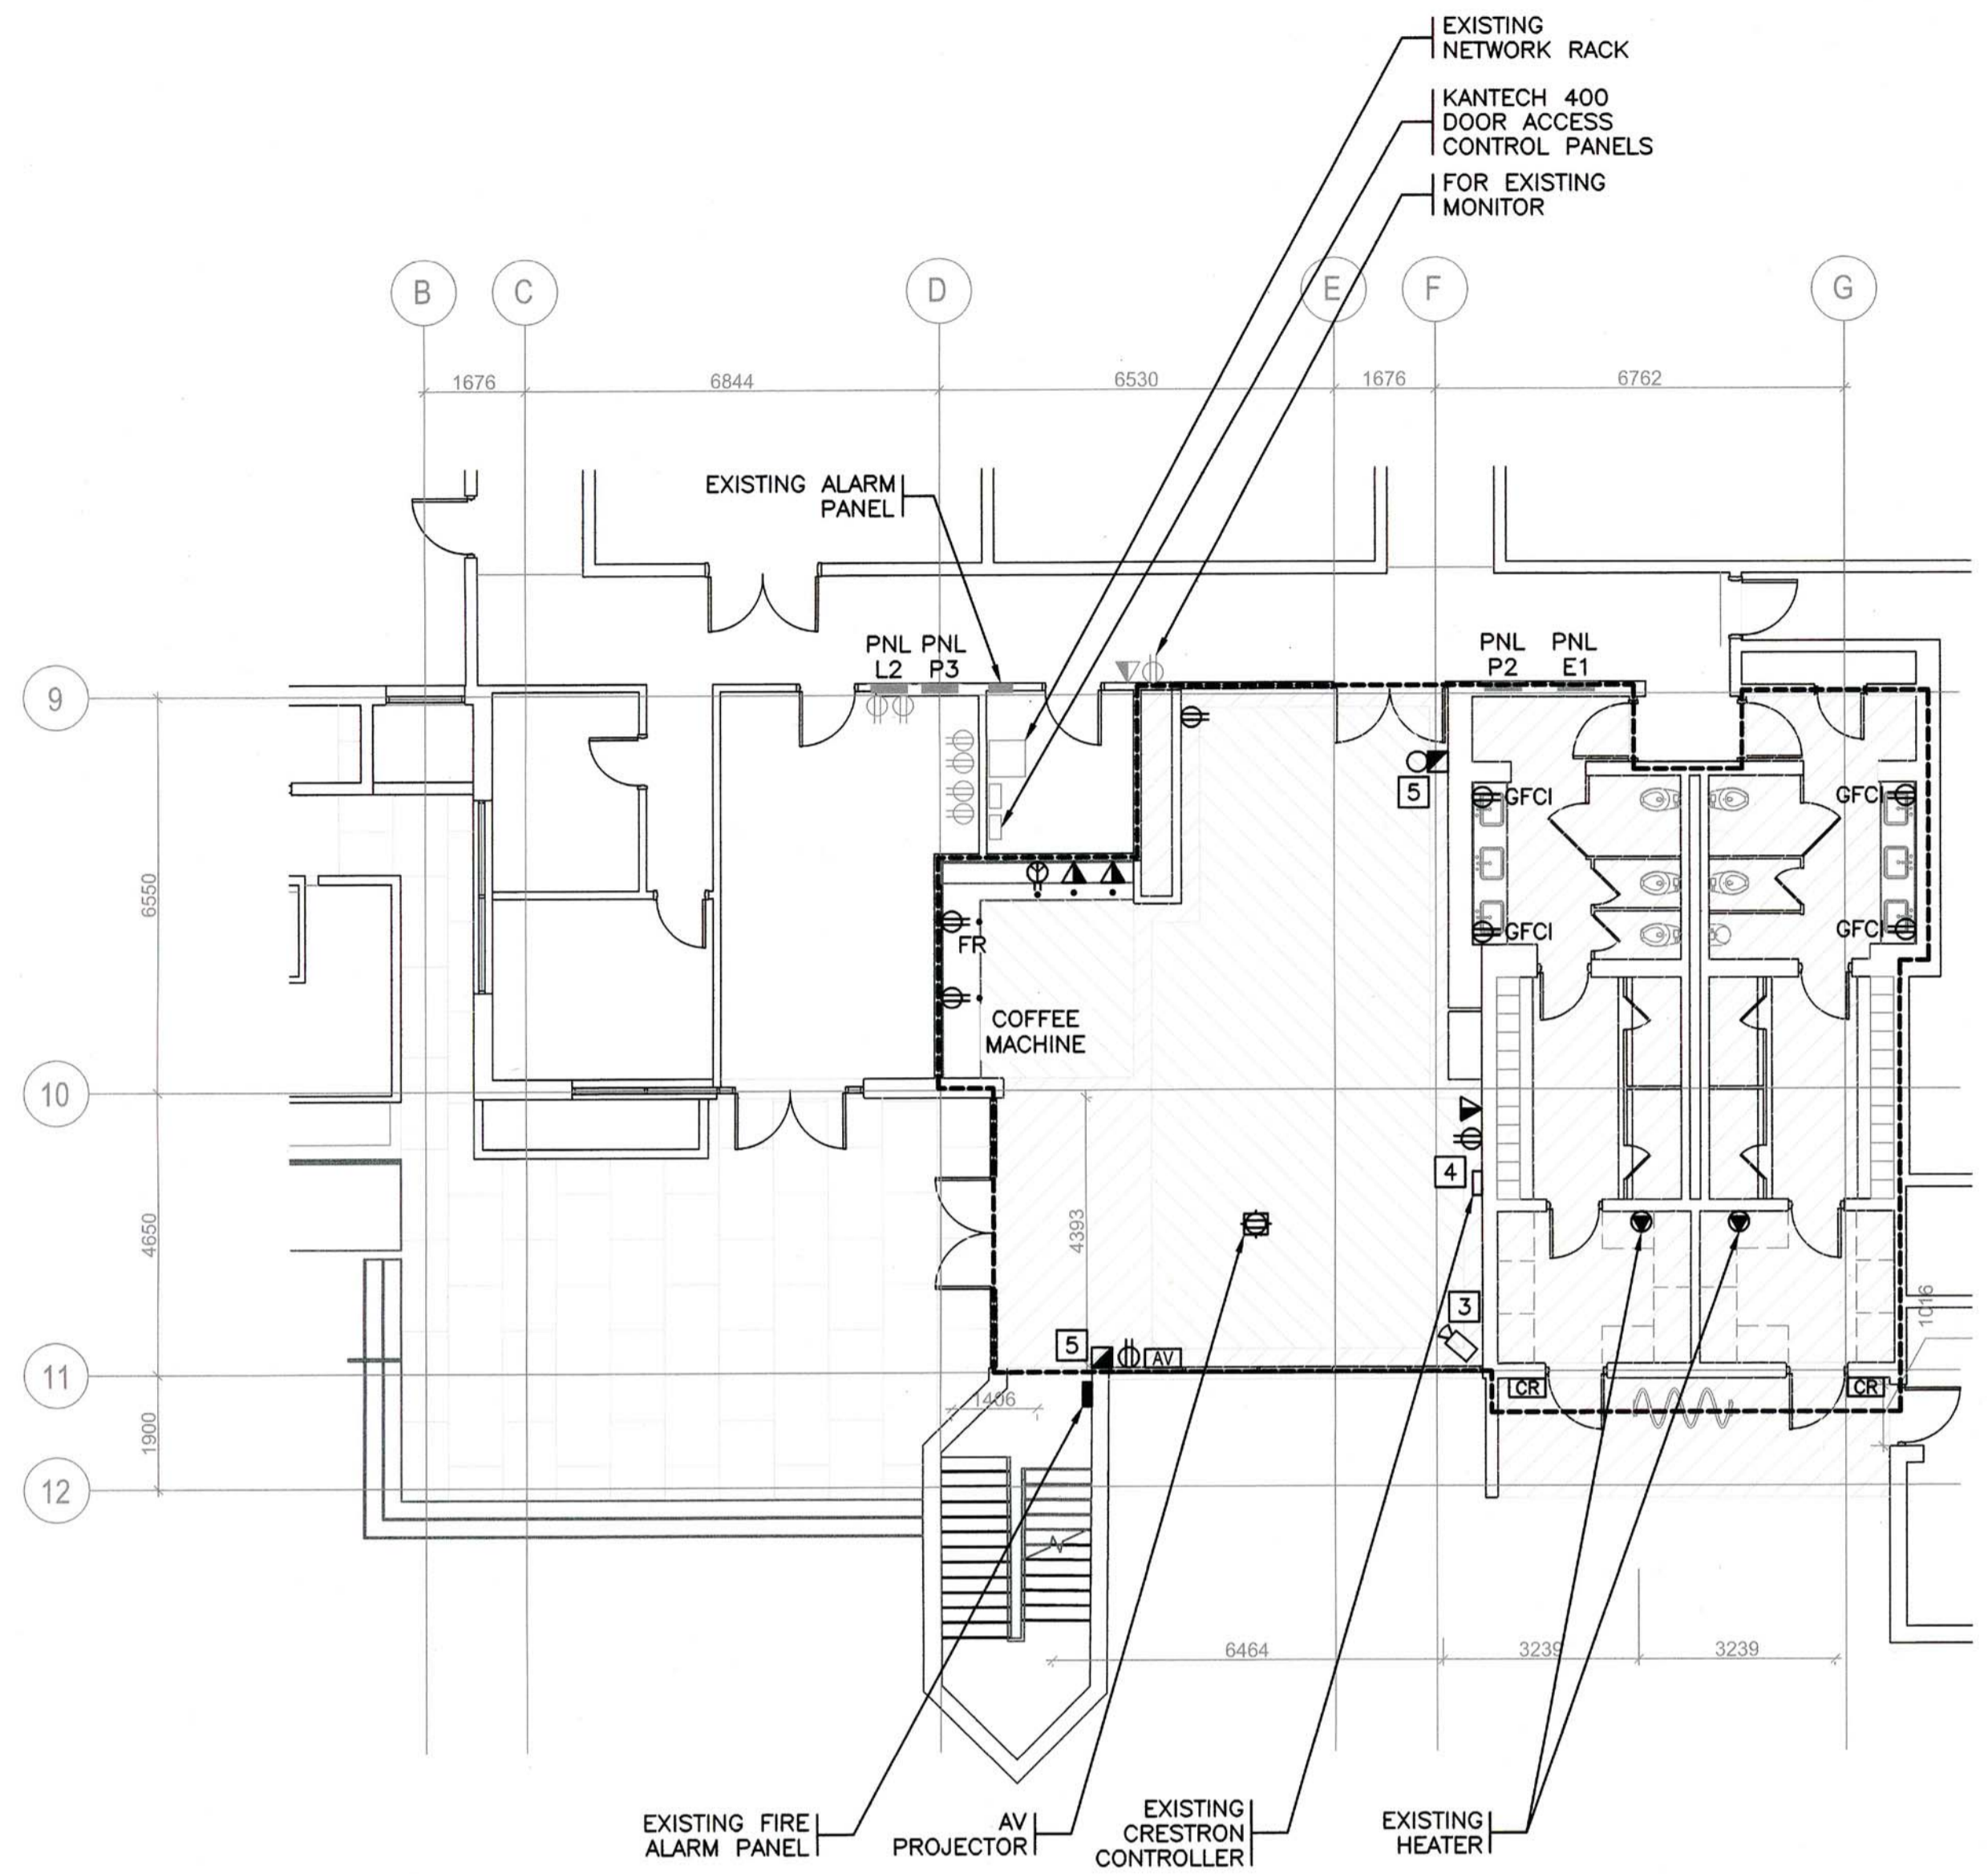
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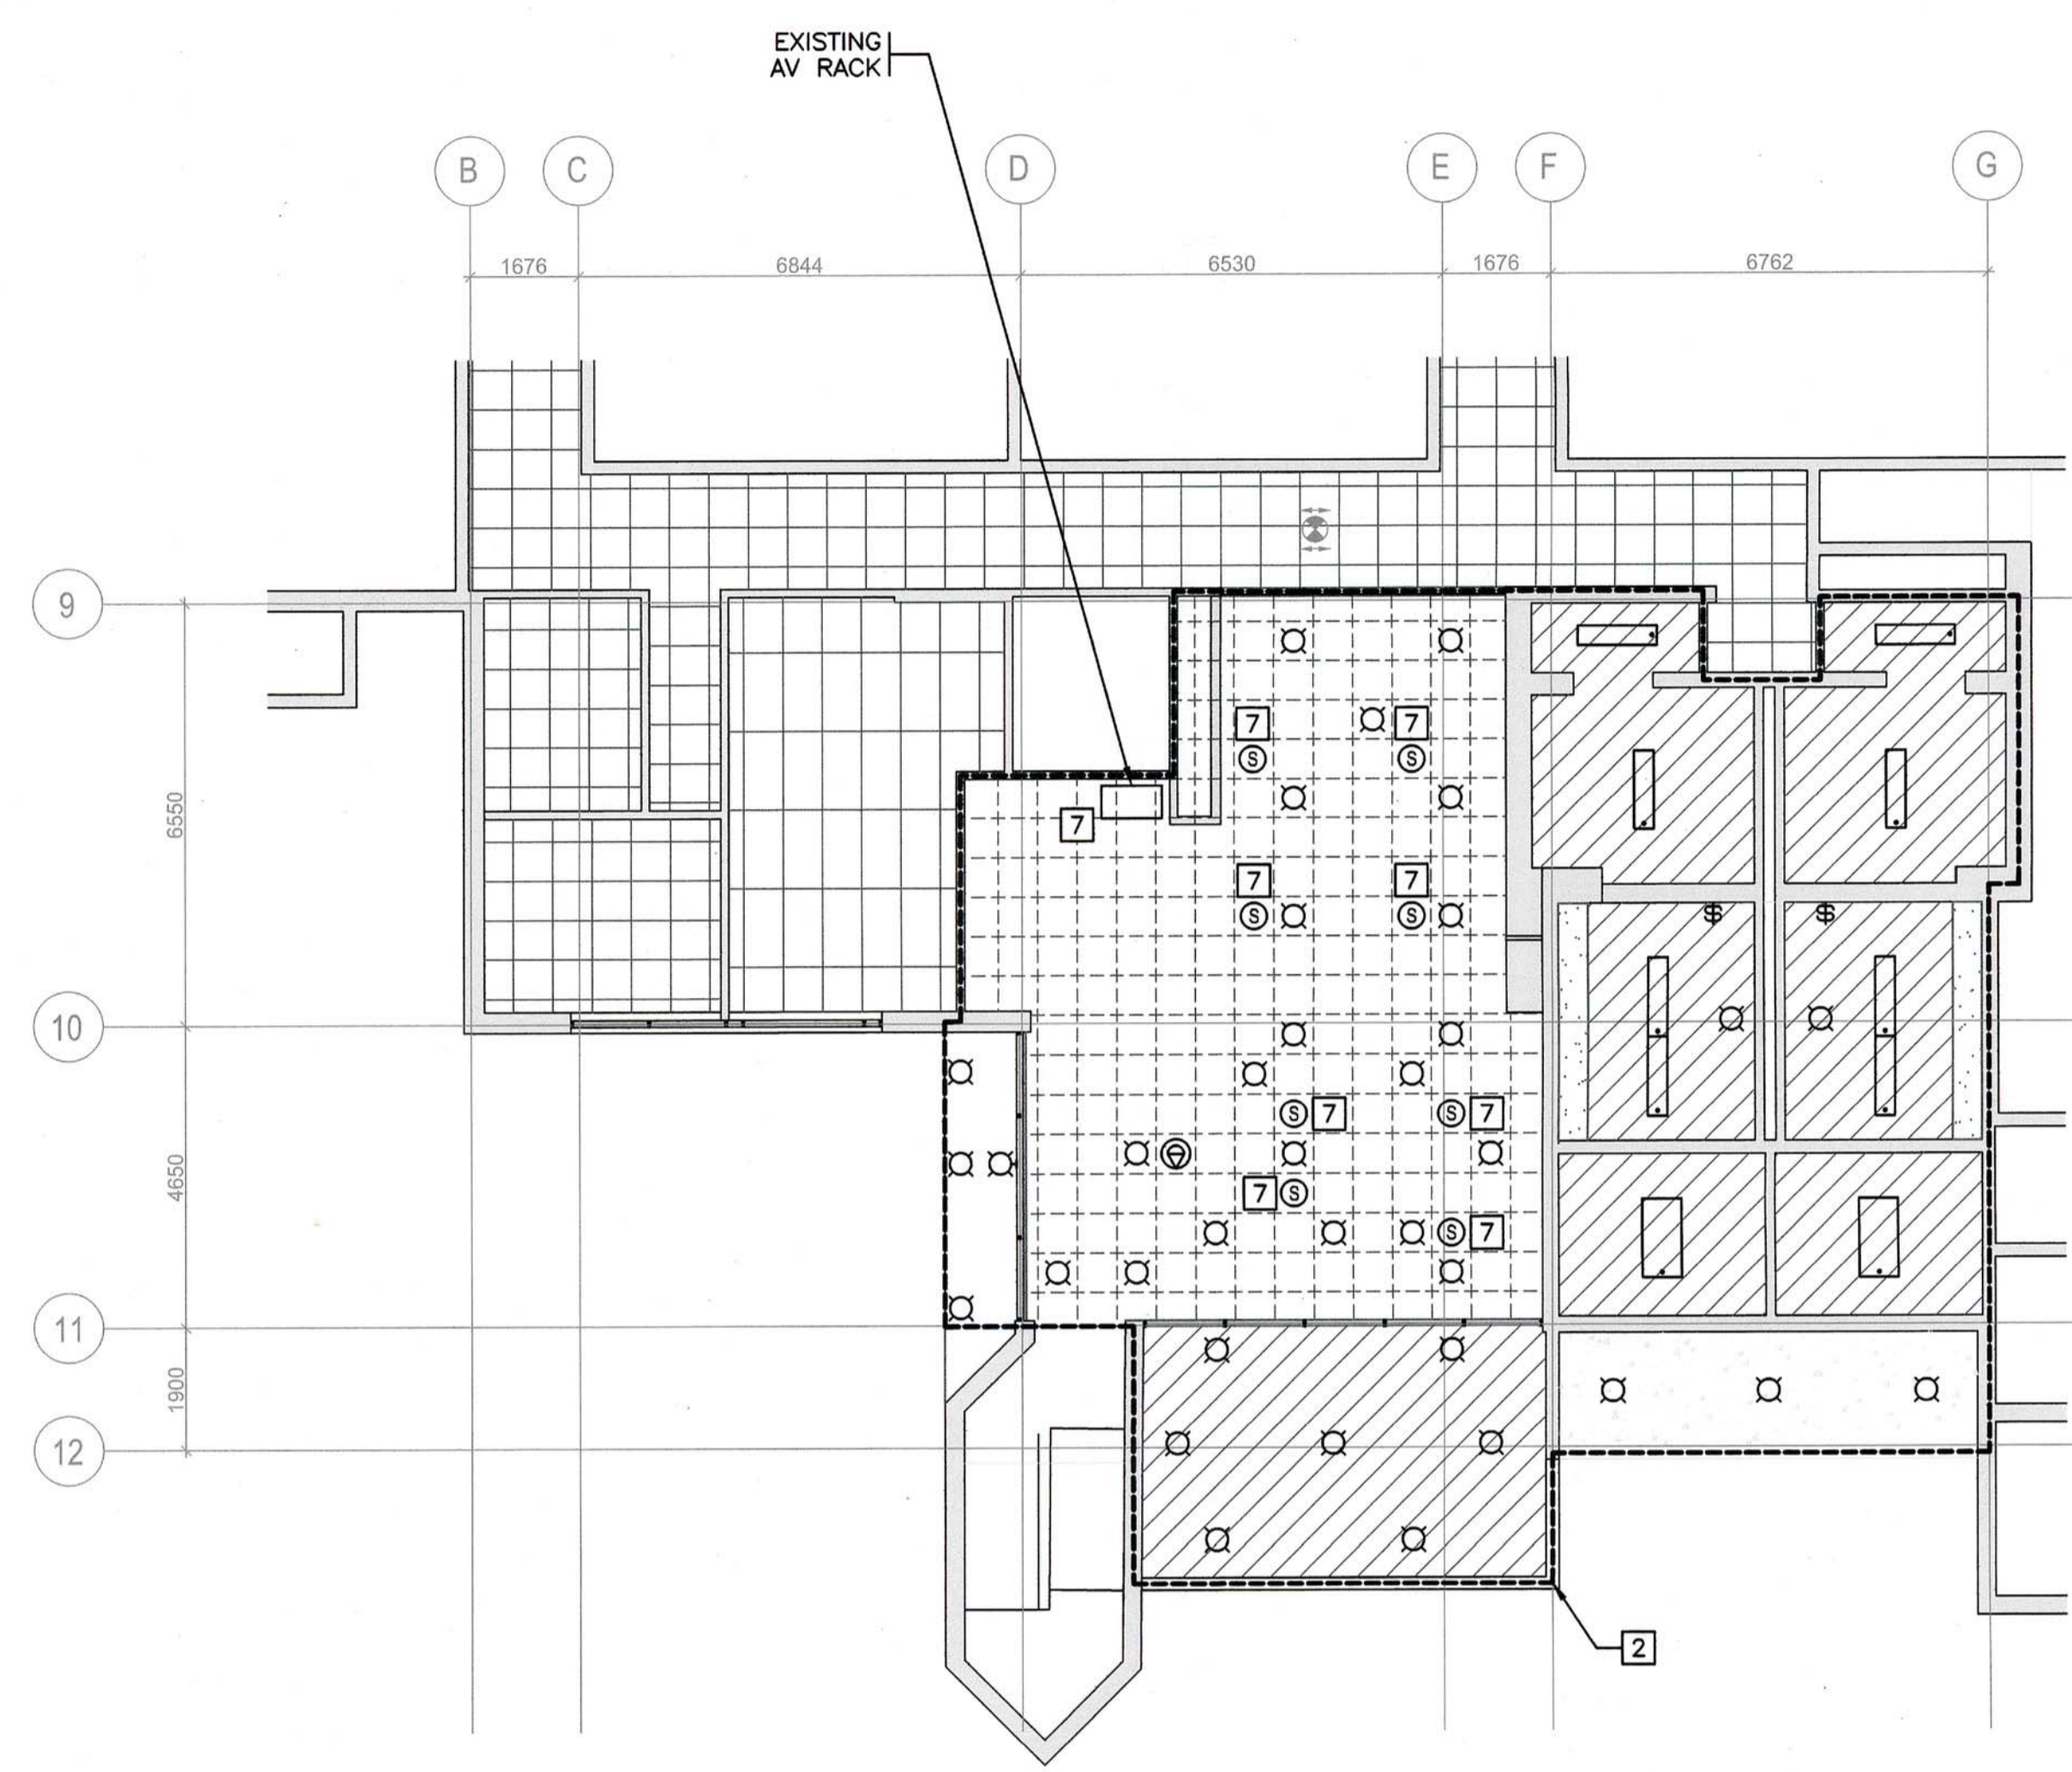
Drawing title/Titre du dessin

**ELECTRICAL DRAWING LIST
& SYMBOL LEGEND**





DETAIL 1 DEMO FLOOR PLAN
1:100

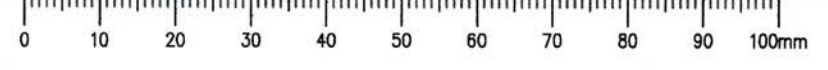

DETAIL 2 DEMO REFLECTED CEILING PLAN
1:100

NOTES:

1. DEVICES AS SHOWN ARE COMPILED FROM A NON-INTRUSIVE VISUAL FIELD REVIEW AND EXISTING RECORD DRAWINGS. AS SUCH THERE MAY BE SOME DISCREPANCIES IN THE QUANTITY OF DEVICES ON SITE. CONTRACTOR MUST CONFIRM EXACT QUANTITIES ON SITE PRIOR TO SUBMITTING TENDER BID.
2. CONTRACTOR TO ALLOW FOR DEMOLITION AND REMOVAL OF EXISTING DEVICES WITHIN THE AREA OF WORK:
 - 2.1. REMOVE ELECTRICAL WIRING AND CONDUIT BACK TO THE NEAREST ACTIVE JUNCTION BOX OR LOCAL ELECTRICAL PANEL AND MAKE SAFE.
 - 2.2. REMOVE TELECOM WIRING BACK TO THE LOCAL COMMUNICATIONS ROOM.
 - 2.3. DISCONNECT AND REMOVE EXISTING FIRE ALARM DEVICES AND PROVIDE WIRING, CONDUIT, AND ANY PARTIAL VERIFICATION TO REQUIREMENTS OF CAN/ULC S537 REQUIRED DURING THE DEMOLITION WORK TO ENSURE THAT THE FIRE ALARM SYSTEM OUTSIDE OF THE AREA OF RENOVATION CONTINUES TO BE FULLY FUNCTIONAL.
 - 2.4. REMOVE SECURITY DEVICES AND PROVIDE RECONFIGURATION TO TEMPORARILY SUSPEND TROUBLE AND/OR ALARM SIGNALS FROM THE AREA OF WORK.
3. REMOVE CAMERA AND RELOCATE AS PER NEW DRAWINGS.
4. REMOVE CRESTRON STATION AND RELOCATE AS PER NEW DRAWINGS.
5. REMOVE AND RELOCATE EXISTING FIRE ALARM DEVICE.
6. DEVICES SHOWN LIGHT ARE EXISTING TO REMAIN. DEVICES SHOWN DARK ARE NEW, MODIFIED, OR REMOVED.
7. RETAIN AND PROTECT THE EXISTING AV SPEAKERS AND AV RACK. REFER TO NEW FLOORPLAN FOR REVISED LOCATIONS OF DEVICES.

Revision/Revision	Description/Description	Date/Date
2	ISSUED FOR TENDER	18JUN11
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FISHERIES & OCEANS CANADA
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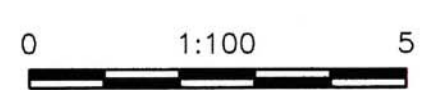
Project title/Titre du projet
**4160 MARINE DRIVE
WEST VANCOUVER, BC V7V 1H2**


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PBX/2018/03/16
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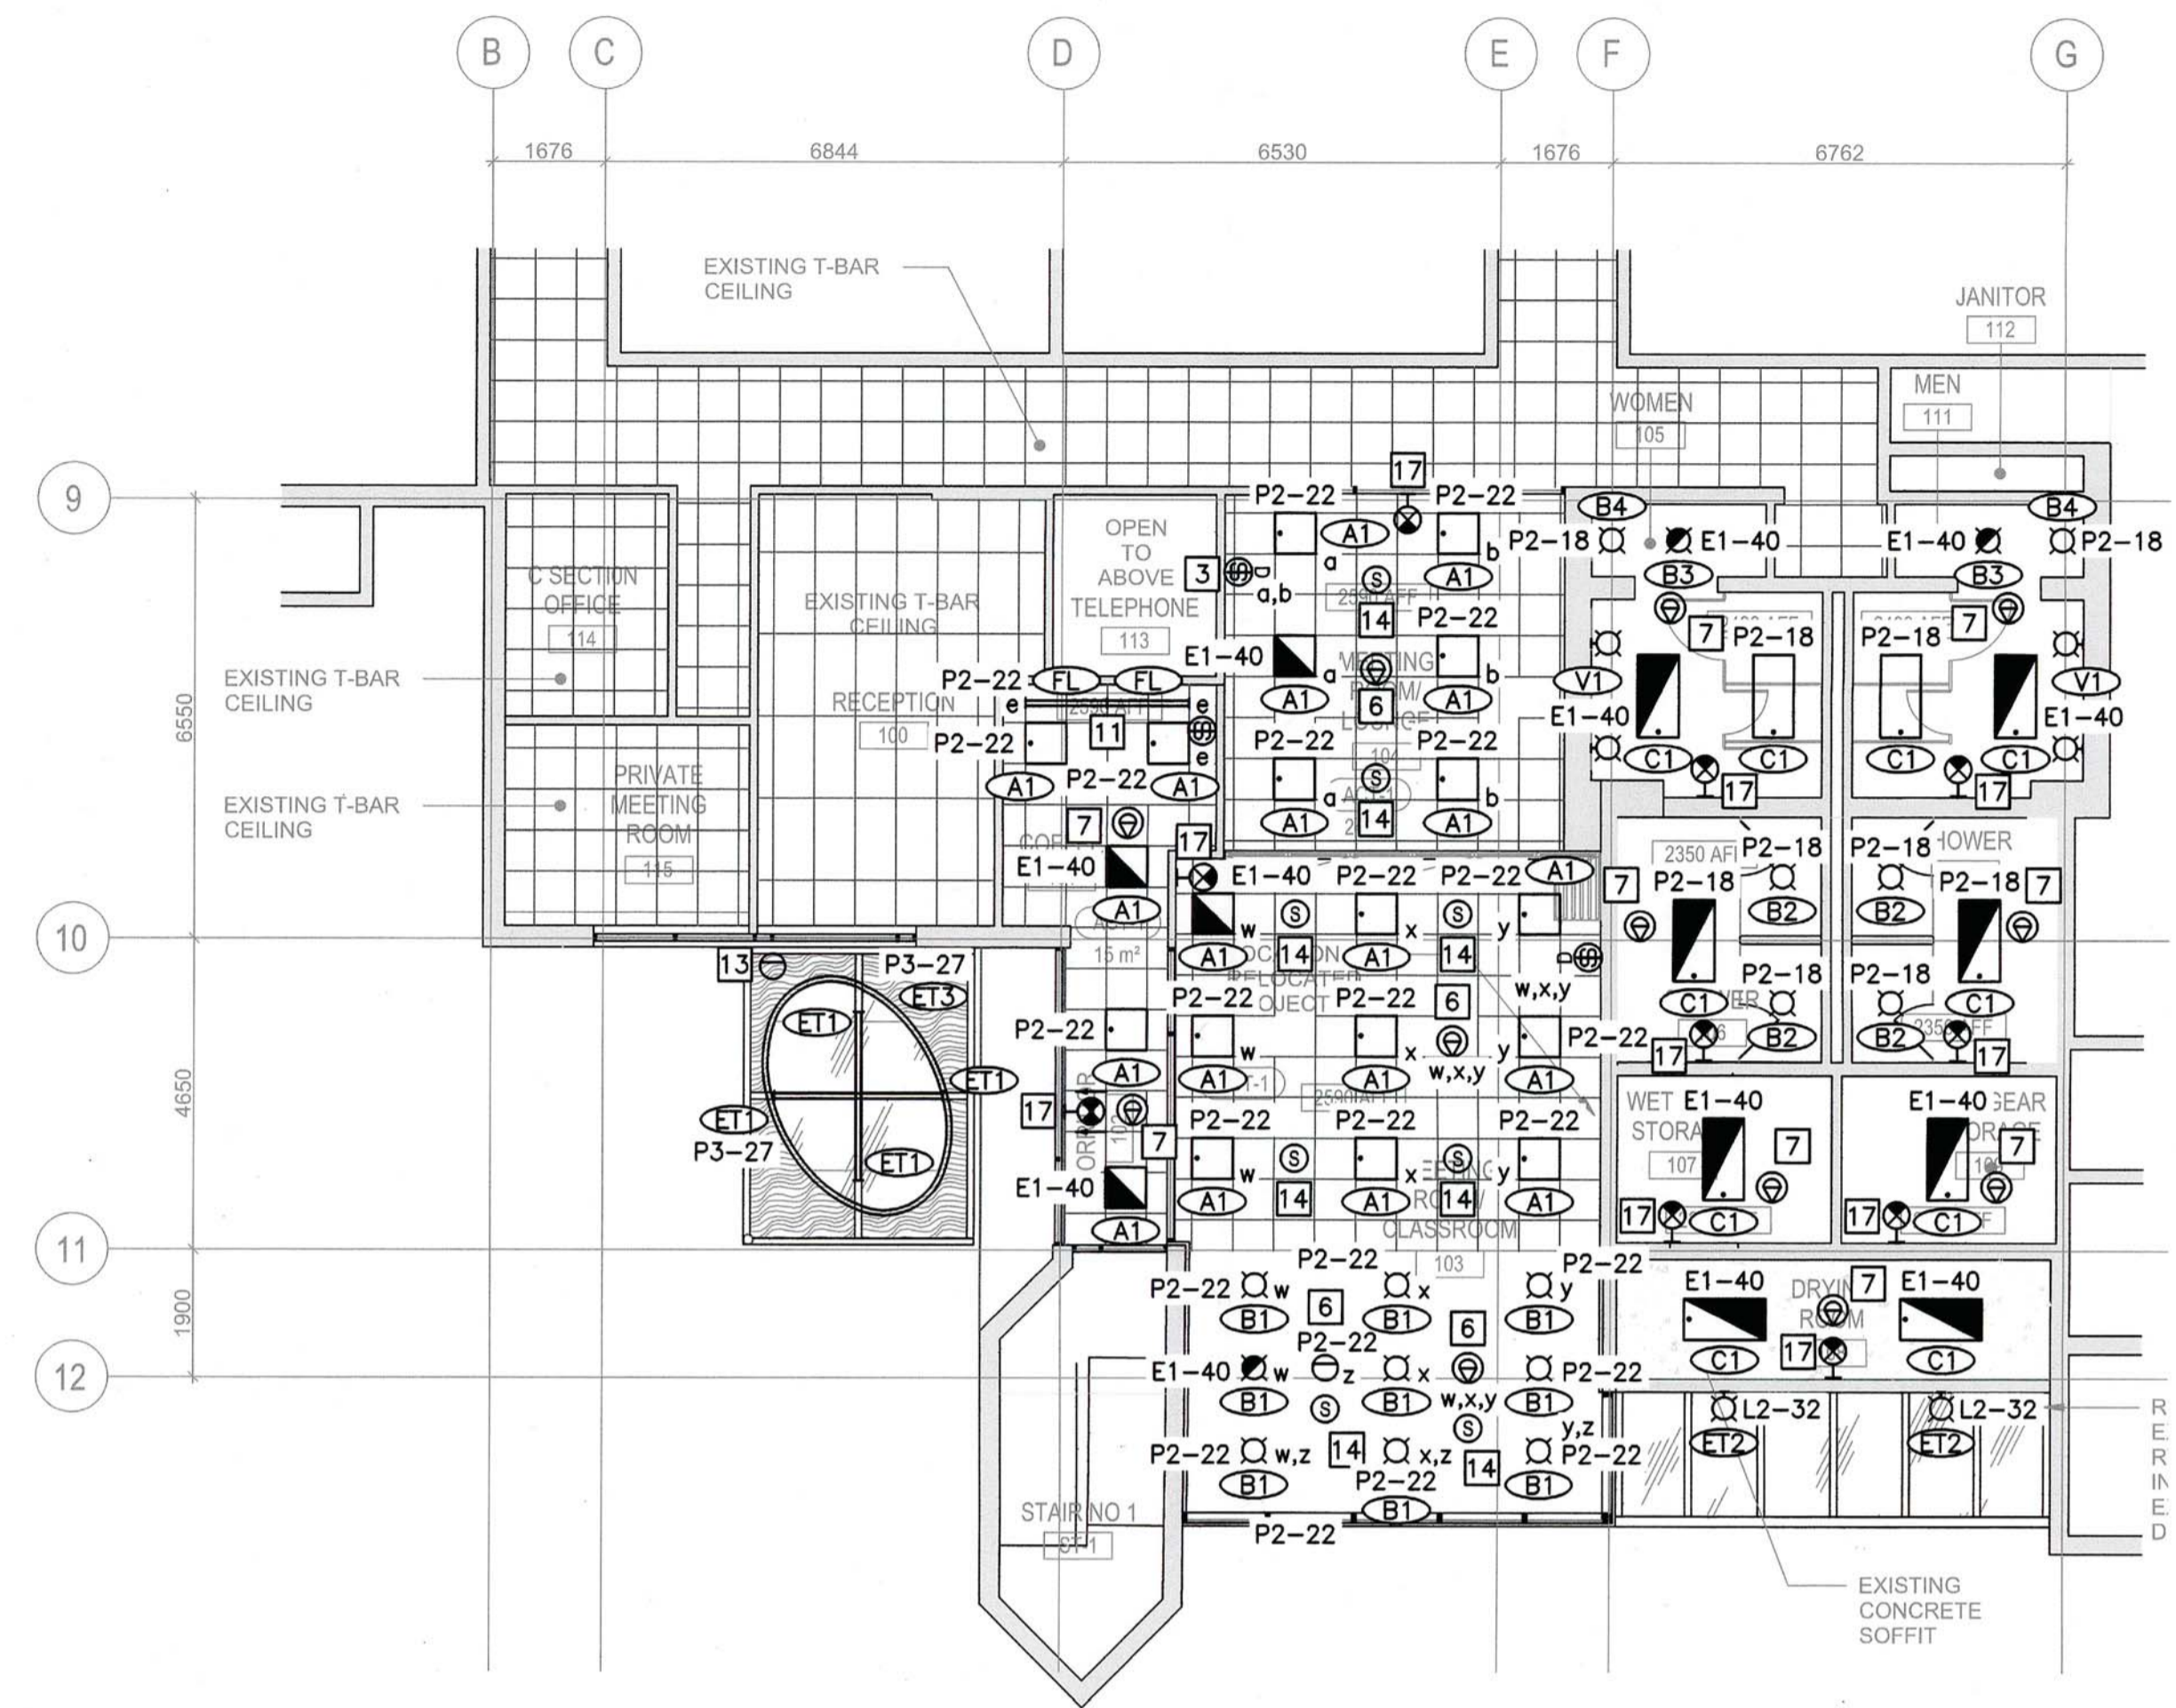
Drawing title/Titre du dessin
**ELECTRICAL DEMOLITION
DRAWING**

Project No./No. du projet O4A: 1802-002	Sheet/Fauille E02 OF XX	Revision no./La Révision no. 2
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DETAIL 1 FLOOR PLAN
 1:100



DETAIL 2 REFLECTED CEILING PLAN
 1:100

LUMINAIRE SCHEDULE						
TYPE	DESCRIPTION	LUMINAIRE DETAILS				
		MAKE AND MODEL	SOURCE	DRIVER/BALLAST	VOLTAGE	MOUNTING
A1	600x600 (2x2) FLUXPANEL LED RECESSED LUMINAIRE	PHILIPS LIGHTING 2FXP-38L-835-2-DS-120-DIM	LED 3500K 80+CRI	0-10V DIMMING	120	CEILING RECESSED
B1	150mm DIA RECESSED LED DOWNLIGHT	PHILIPS LIGHTOLIER C6-R-N C6L-15-8-35-M-Z10-120 C6-R-DL-CL-P	LED 3500K 80+CRI	0-10V DIMMING	120	CEILING RECESSED
B2	150mm DIA RECESSED LED SHOWER DOWNLIGHT WITH DEAD FRONT AND WET LOCATION IP65	PHILIPS LIGHTOLIER C6-R-N C6L-15-8-35-M-Z10-120 C6-R-SL-CL-P-C6RVPWH	LED 3500K 80+CRI	0-10V OFF/ON	120	CEILING RECESSED
B3	150mm DIA RECESSED LED DOWNLIGHT	PHILIPS LIGHTOLIER C6-R-N C6L-15-8-35-M-120 C6-R-DL-CL-P	LED 3500K 80+CRI	0-10V OFF/ON	120	CEILING RECESSED
B4	100mm DIA RECESSED ADJUSTABLE LED ACENT LUMINAIRE	PHILIPS LIGHTOLIER C4L-A-15-N-U C4L-15-A-35-8-SP C4L-A-CL-P	LED 3500K 80+CRI	0-10V OFF/ON	120	CEILING RECESSED
C1	600x1200 (2x4) RECESSED FLUXPANEL LED LUMINAIRE	PHILIPS LIGHTING 2FXP-43L-835-4-DS-120-DIM	LED 3500K 80+CRI	0-10V DIMMING/OFF/ON AS	120	CEILING RECESS MOUNTED IN T-BAR
ET1	1200mm LINEAR LED LUMINAIRE	SQI LED SQ1-L-4-135-0-02-C-X	LED 3500K	0-10V OFF/ON	120	SURFACE MOUNTED
ET2	LED WALL MOUNTED LUMINAIRE	LUMARK LIGHTING XTOR2B-W-BZ-PC2-347	LED 4000K	0-10V OFF/ON	347	WALL MOUNTED
ET3	FLEXIBLE EXTERIOR LED LUMINAIRE WITH FLAT TOP COMPLETE WITH MOUNTING ACCESSORY CHANNELS AND FITTINGS FOR INSTALLATION. PROVIDE COMPATIBLE TRANSFORMER DRIVER AND CONNECTIONS AS REQUIRED FOR A FULLY FUNCTIONAL INSTALLATION	SQI lighting NEON-P-FLT-WHT-3500K	LED 3500K	0-10V OFF/ON	120	SURFACE MOUNTED
EX	PICTOGRAM 'RUNNING MAN' EXIT SIGNAGE	LUMACELL LS SERIES	LED		120 / INTERNAL BATTERY	UNIVERSAL SURFACE MOUNTED
FL	RECESSED LED TAPE LIGHT	SQI lighting Flex-P-ULTRA-24VDC-W-3500K-85	LED	0-10V OFF/ON	DC	INSTALL UNDER-CABINET TRACK-LP1407-SIL-FF MOUNTING TRACK
V1	LINEAR 600mm VANITY LED LUMINAIRE	PRUDENTIAL LIGHTING HALF SNAP HSS-LED35-LO-3-SAL-YGW-SC-UNV-SUR-ND	LED 3500K	0-10V OFF/ON	120	SURFACE WALL MOUNTED

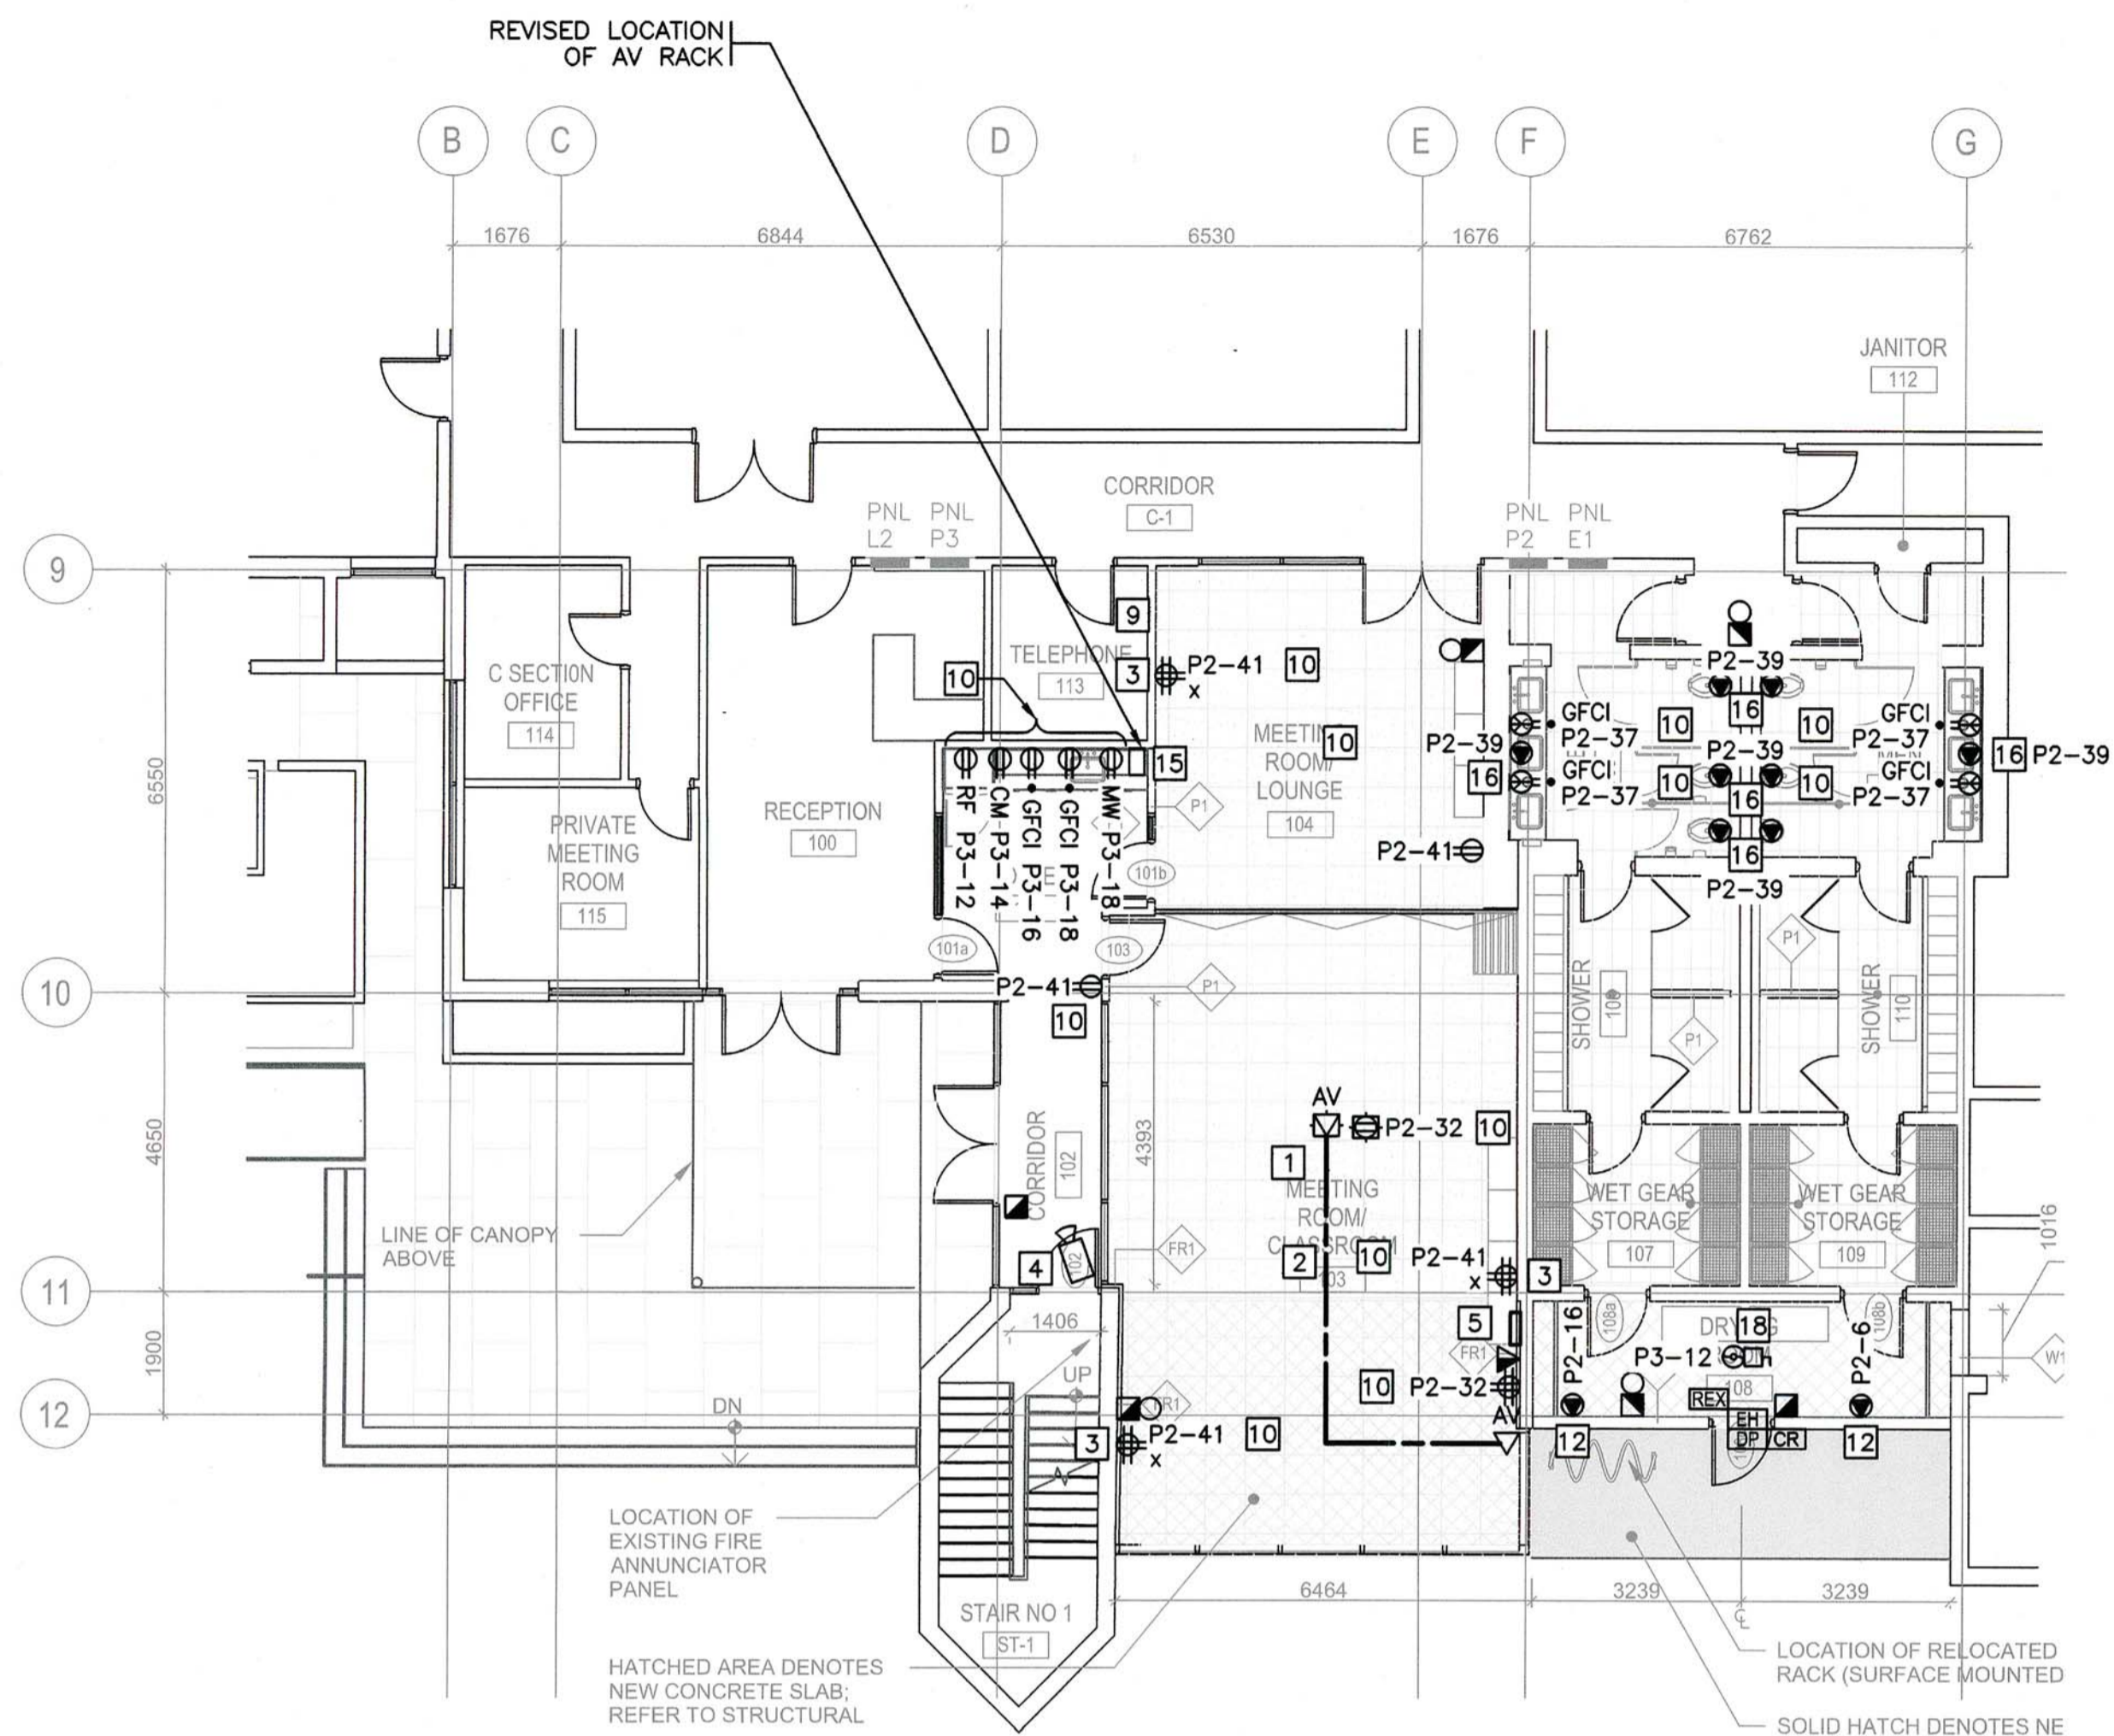NOTES:

- OUTLETS FOR NEW PROJECTOR LOCATION.
- PROVIDE NEW 53mm CONDUIT COMPLETE WITH BUSHING AND PULLSTRING FOR AV CABLING.
- PROVIDE LOCAL LOW VOLTAGE LIGHTING CONTROL SYSTEM RELAY MODULES FOR THE CONTROL OF THE RECEPTACLES WHERE INDICATED IN THE SPACE.
- PROVIDE NEW SECURITY PTZ CAMERA TO MATCH THE EXISTING FACILITY STANDARD. INTEGRATE THE NEW PTZ CAMERA INTO THE EXISTING FACILITY CONTROL AND PROVIDE CABLING, POWER SUPPLY, NVR, ENCODER AS REQUIRED FOR A FULLY FUNCTIONAL SYSTEM.
- RELOCATED CRESTRON CONTROLLER.
- LOW VOLTAGE DIMMING/OFF/ON CONTROL. LOCAL CONTROL SWITCH ZONES AS INDICATED BY LOWERCASE LETTERS. PROVIDE DUAL TECHNOLOGY OCCUPANCY AND DAYLIGHT HARVESTING SENSORS WITH CONTROL ZONES AS INDICATED
- LOW VOLTAGE OFF/ON CONTROL. PROVIDE DUAL TECHNOLOGY OCCUPANCY SENSORS WITH CONTROL ZONES AS INDICATED.
- DEVICES SHOWN LIGHT ARE EXISTING TO REMAIN. DEVICES SHOWN DARK ARE NEW, MODIFIED, OR REMOVED.
- PROVIDE NEW KANTECH 400 SECURITY ACCESS PANEL FOR NEW SECURITY DOOR.
- CONTRACTOR TO USE THE EXISTING SPACES/SPARE CIRCUITS IN PANELS E1, P2, OR P3. CONTRACTOR MAY RE-USE EXISTING CIRCUITS IN THE AREA MADE SPARE BY THE REMOVAL OF DEVICES DURING DEMOLITION. CONTRACTOR MUST CONFIRM ON SITE PRIOR TO RE-USE.
- CONTRACTOR TO COORDINATE EXACT ELEVATION AND INSTALLATION WITH ARCHITECT'S DRAWINGS. PROVIDE LENGTHS MEASURED ON SITE AS REQUIRED.
- CONNECTION FOR DIRECT DRY RACK. CONTRACTOR TO COORDINATE EXACT LOCATION WITH ARCHITECTURAL ELEVATIONS AND MANUFACTURER REQUIREMENTS.
- CONTRACTOR TO PROVIDE PHOTOCELL TO CONTROL 'ET1' LUMINAIRES.
- CONTRACTOR TO PROVIDE NEW CABLES AS REQUIRED FOR THE REVISED LOCATION OF THE EXISTING SPEAKERS AND THE AV RACK.
- CONTRACTOR TO UTILIZE THE EXISTING POWER CIRCUIT POWERING THE AV RACK AT IT'S OLD LOCATION AND RE-FEED FOR THE RELOCATED AV RACK.
- PROVIDE DIRECT 120V AC CONNECTION TO MECHANICAL TRANSFORMER FOR FLUSH VALVES/SINKS.
- CONNECT NEW EXIT SIGNS TO EXISTING EXIT SIGN CIRCUIT IN THE AREA. CONFIRM SUPPLY VOLTAGE PRIOR TO ORDERING.
- PROVIDE NEW MANUAL MOTOR STARTER SWITCH FOR FAN UNIT. COORDINATE EXACT LOCATION WITH ARCHITECT AND MECHANICAL CONTRACTOR.



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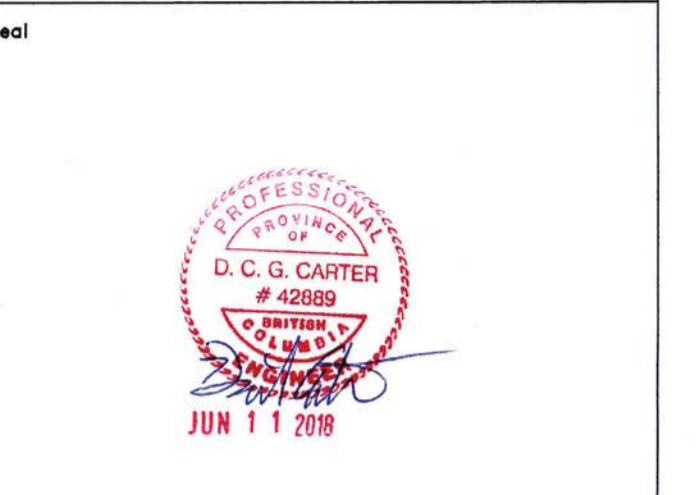
FISHERIES & OCEANS CANADA
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Project title/Titre du projet
**4160 MARINE DRIVE
 WEST VANCOUVER, BC V7V 1H2**

**PSEC CLASSROOM
 ADDITION & RENOVATION**

Consultant Signature Only
 Designed by/Conçep par
DAVID CARTER
 Drawn by/Dessiné par
 PBX2018/03/16
 PWGSC Project Manager/Administrateur de Projets TP50C
PWGSC-PROJECT_MANAGER
 Regional Manager, Architectural and Engineering Services,
 Gestionnaire Régionale, Services d'architectural et de gén. TP50C
PWGSC-REGIONAL_MANAGER

Drawing title/Titre du dessin
NEW ELECTRICAL PLAN
 Project No./No. du projet
04A: 1802-002
 Sheet/Feuille
E03
 OF XX
 Revision no./La Révision no.
2



DESCRIPTION	kW	BKR.	CIRCUIT NO.	BKR.	kW	DESCRIPTION
EXISTING CIRCUIT	-	15A	1-2	15A	-	EXISTING CIRCUIT
EXISTING CIRCUIT	-	15A	3-4	15A	-	EXISTING CIRCUIT
EXISTING CIRCUIT	-	15A	5-6	15A	-	EXISTING CIRCUIT
EXISTING CIRCUIT	-	15A	7-8			
EXISTING CIRCUIT	-	15A	9-10			
EXISTING CIRCUIT	-	15A	11-12			
EXISTING CIRCUIT	-	20A	13-14	20A	-	EXISTING CIRCUIT
EXISTING CIRCUIT	-	15A	15-16	20A	-	EXISTING CIRCUIT
EXISTING CIRCUIT	-	15A	17-18	2P	-	EXISTING CIRCUIT
EXISTING CIRCUIT	-	15A	19-20	40A	-	EXISTING CIRCUIT
EXISTING CIRCUIT	-	15A	21-22			
EXISTING CIRCUIT	-	15A	23-24	3P	-	EXISTING CIRCUIT
EXISTING CIRCUIT	-	15A	25-26	20A	-	EXISTING CIRCUIT
EXISTING CIRCUIT	-	15A	27-28	20A	-	EXISTING CIRCUIT
EXISTING CIRCUIT	-	15A	29-30	20A	-	EXISTING CIRCUIT
EXISTING CIRCUIT	-	15A	31-32	15A	-	EXISTING CIRCUIT
EXISTING CIRCUIT	-	15A	33-34	15A	-	EXISTING CIRCUIT
EXISTING CIRCUIT	-	15A	35-36	15A	-	EXISTING CIRCUIT
EXISTING CIRCUIT	-	15A	37-38	15A	-	EXISTING CIRCUIT
EXISTING CIRCUIT	-	15A	39-40	15A	-	EMERGENCY LIGHTING
EXISTING CIRCUIT	-	15A	41-42			SPACE
TOTAL						TOTAL

MAINS: ITE NLAB PANEL 100A
 MOUNTING: RECESSED
 MAIN BKR.: NONE
 VOLTS: 120/208V

DESCRIPTION	kW	BKR.	CIRCUIT NO.	BKR.	kW	DESCRIPTION
EXISTING CIRCUIT	-	15A	1-2	15A	-	EXISTING CIRCUIT
EXISTING CIRCUIT	-	15A	3-4	15A	-	EXIST. CIRCUIT GFCI BREAKER
EXISTING CIRCUIT	-	15A	5-6	15A	-	EXIST. CIRCUIT GFCI BREAKER
EXISTING CIRCUIT	-	15A	7-8	15A	-	EXIST. CIRCUIT GFCI BREAKER
EXISTING CIRCUIT	-	15A	9-10	15A	-	EXISTING CIRCUIT
EXISTING CIRCUIT	-	15A	11-12	30A	-	EXISTING CIRCUIT
EXISTING CIRCUIT	-	20A	13-14	2P	-	EXISTING CIRCUIT
EXISTING CIRCUIT	-	15A	15-16	15A	-	EXISTING CIRCUIT
EXISTING CIRCUIT	-	15A	17-18	15A	-	EXISTING CIRCUIT
EXISTING CIRCUIT	-	15A	19-20	15A	-	EXISTING CIRCUIT
EXISTING CIRCUIT	-	15A	21-22	15A	-	EXISTING CIRCUIT
EXISTING CIRCUIT	-	15A	23-24	15A	-	EXISTING CIRCUIT
SPACE			25-26	40A	-	EXIST. CIRCUIT BREAKER
SPACE			27-28			
SPACE			29-30	3P	-	
SPACE			31-32	15A	-	EXTERIOR LIGHTING
SPACE			33-34			SPACE
SPACE			35-36			SPACE
SPACE			37-38			SPACE
SPACE			39-40			SPACE
SPACE			41-42			SPACE
TOTAL						TOTAL

MAINS: SIEMENS ELECTRIC CDP 100A
 MOUNTING: RECESSED
 MAIN BKR.: NONE
 VOLTS: 347/600V


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EXISTING CIRCUIT	-	15A	1-2	15A	-	EXISTING CIRCUIT
EXISTING CIRCUIT	-	15A	3-4	15A	-	EXISTING CIRCUIT
EXISTING CIRCUIT	-	15A	5-6	15A	-	DRYING ROOM
EXISTING CIRCUIT	-	15A	7-8	15A	-	EXIST. CIRCUIT GFCI BREAKER
EXISTING CIRCUIT	-	15A	9-10	15A	-	EXIST. CIRCUIT GFCI BREAKER
EXIST. CIRCUIT GFCI BREAKER	-	30A	11-12	15A	-	EXIST. CIRCUIT GFCI BREAKER
EXIST. CIRCUIT GFCI BREAKER	-	2P	13-14	15A	-	EXIST. CIRCUIT GFCI BREAKER
EXIST. CIRCUIT GFCI BREAKER	-	15A	15-16	15A	-	DRYING ROOM
EXISTING CIRCUIT	-	15A	17-18	15A	-	WASHROOM LIGHTING
EXISTING CIRCUIT	-	15A	19-20	15A	-	EXIST. CIRCUIT GFCI BREAKER
EXISTING CIRCUIT	-	15A	21-22	15A	-	CLASSROOM LIGHTING
EXISTING CIRCUIT	-	15A	23-24	15A	-	EXIST. CIRCUIT GFCI BREAKER
EXISTING CIRCUIT	-	15A	25-26	15A	-	EXIST. CIRCUIT GFCI BREAKER
EXISTING CIRCUIT	-	15A	27-28	20A	-	EXISTING CIRCUIT
EXISTING CIRCUIT	-	15A	29-30	20A	-	EXISTING CIRCUIT
EXISTING CIRCUIT	-	15A	31-32	15A	-	AV RECEPTACLE
EXISTING CIRCUIT	-	15A	33-34	15A	-	EXISTING CIRCUIT
EXISTING CIRCUIT	-	15A	35-36	15A	-	EXISTING CIRCUIT
WASHROOM RECEPTACLE	-	20A	37-38	15A	-	EXISTING CIRCUIT
WASHROOM RECEPTACLE	-	20A	39-40	15A	-	EXISTING CIRCUIT
GENERAL RECEPTACLE	-	15A	41-42	15A	-	EXISTING CIRCUIT
TOTAL						TOTAL

MAINS: ITE NLAB PANEL 225A
 MOUNTING: RECESSED
 MAIN BKR.: NONE
 VOLTS: 120/208V


DETAIL 1 PANEL SCHEDULES
 N.T.S.

DESCRIPTION	kW	BKR.	CIRCUIT NO.	BKR.	kW	DESCRIPTION
EXISTING CIRCUIT	-	15A	1-2	15A	-	EXISTING CIRCUIT
EXISTING CIRCUIT	-	15A	3-4	15A	-	EXIST. CIRCUIT GFCI BREAKER
EXISTING CIRCUIT	-	15A	5-6	15A	-	EXIST. CIRCUIT GFCI BREAKER
EXISTING CIRCUIT	-	15A	7-8	15A	-	EXIST. CIRCUIT GFCI BREAKER
EXISTING CIRCUIT	-	15A	9-10	15A	-	EXISTING CIRCUIT
EXISTING CIRCUIT	-	15A	11-12	15A	-	EXHAUST FAN
EXISTING CIRCUIT	-	15A	13-14	15A	-	CAFE RECEPTACLE
EXISTING CIRCUIT	-	15A	15-16	15A	-	CAFE RECEPTACLE
EXISTING CIRCUIT	-	15A	17-18	15A	-	CAFE RECEPTACLE
EXISTING CIRCUIT	-	15A	19-20	15A	-	CAFE RECEPTACLE
EXISTING CIRCUIT	-	15A	21-22	15A	-	EXISTING CIRCUIT
EXISTING CIRCUIT	-	15A	23-24	15A	-	EXISTING CIRCUIT
EXISTING CIRCUIT	-	15A	25-26	20A	-	EXISTING CIRCUIT
EXISTING CIRCUIT	-	15A	27-28	15A	-	EXISTING CIRCUIT
EXISTING CIRCUIT	-	15A	29-30	15A	-	EXISTING CIRCUIT
EXISTING CIRCUIT	-	15A	31-32	15A	-	EXISTING CIRCUIT
EXISTING CIRCUIT	-	20A	33-34	15A	-	EXISTING CIRCUIT
EXISTING CIRCUIT	-	2P	35-36	15A	-	EXISTING CIRCUIT
EXISTING CIRCUIT	-	30A	37-38	20A	-	EXISTING CIRCUIT
EXISTING CIRCUIT	-	3P	39-40	15A	-	EXISTING CIRCUIT
EXISTING CIRCUIT	-		41-42	15A	-	EXISTING CIRCUIT
TOTAL						TOTAL

MAINS: ITE NLAB PANEL 225A
 MOUNTING: RECESSED
 MAIN BKR.: NONE
 VOLTS: 120/208V

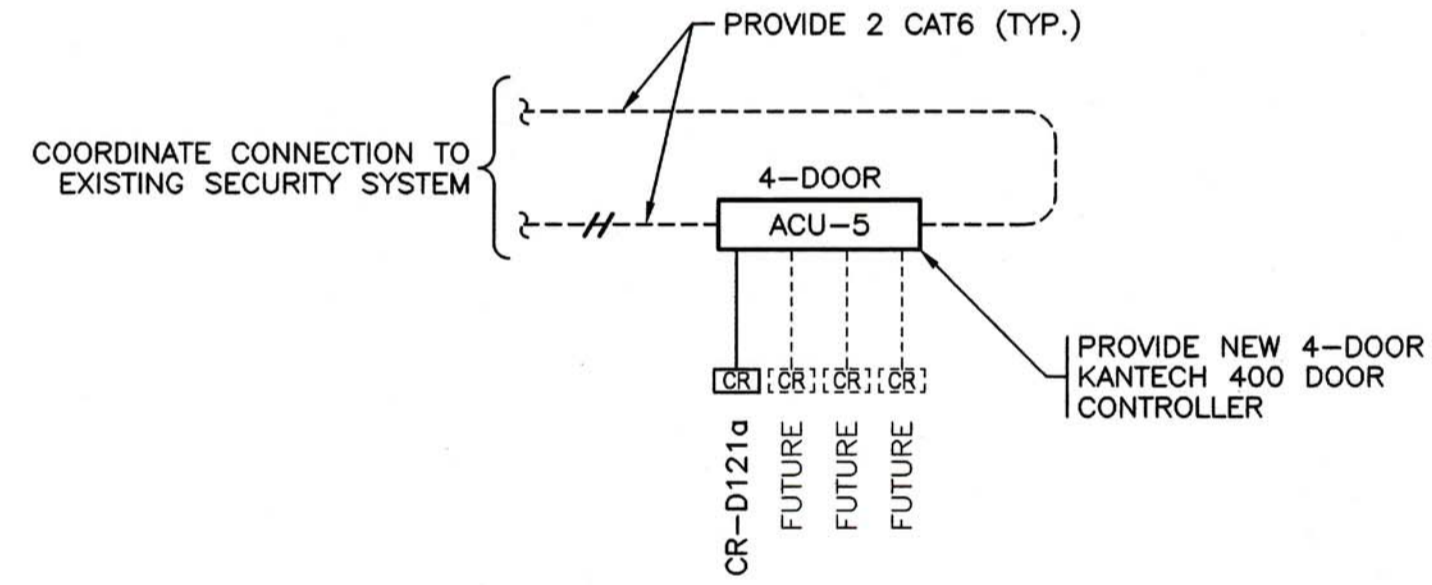


DETAIL 2 CARD ACCESS SECURITY SYSTEM
 N.T.S.

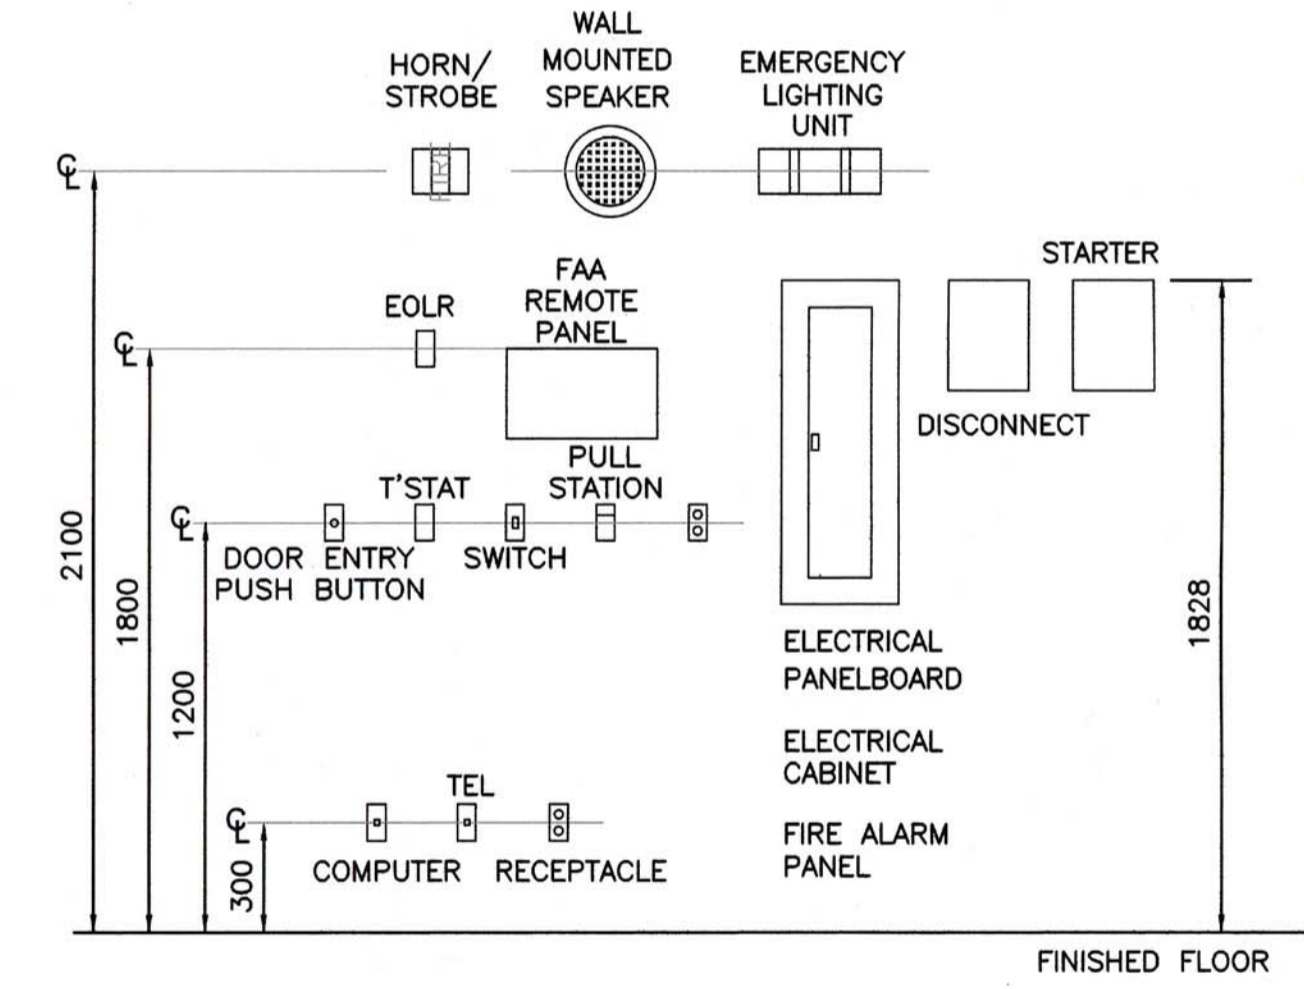

NOTES:
 1. MOUNTING HEIGHTS TO MATCH EXISTING, UNLESS EXISTING MOUNTING HEIGHTS ARE NOT COMPLIANT WITH CEC.

DETAIL 4 TYP. MOUNTING HEIGHTS
 N.T.S.

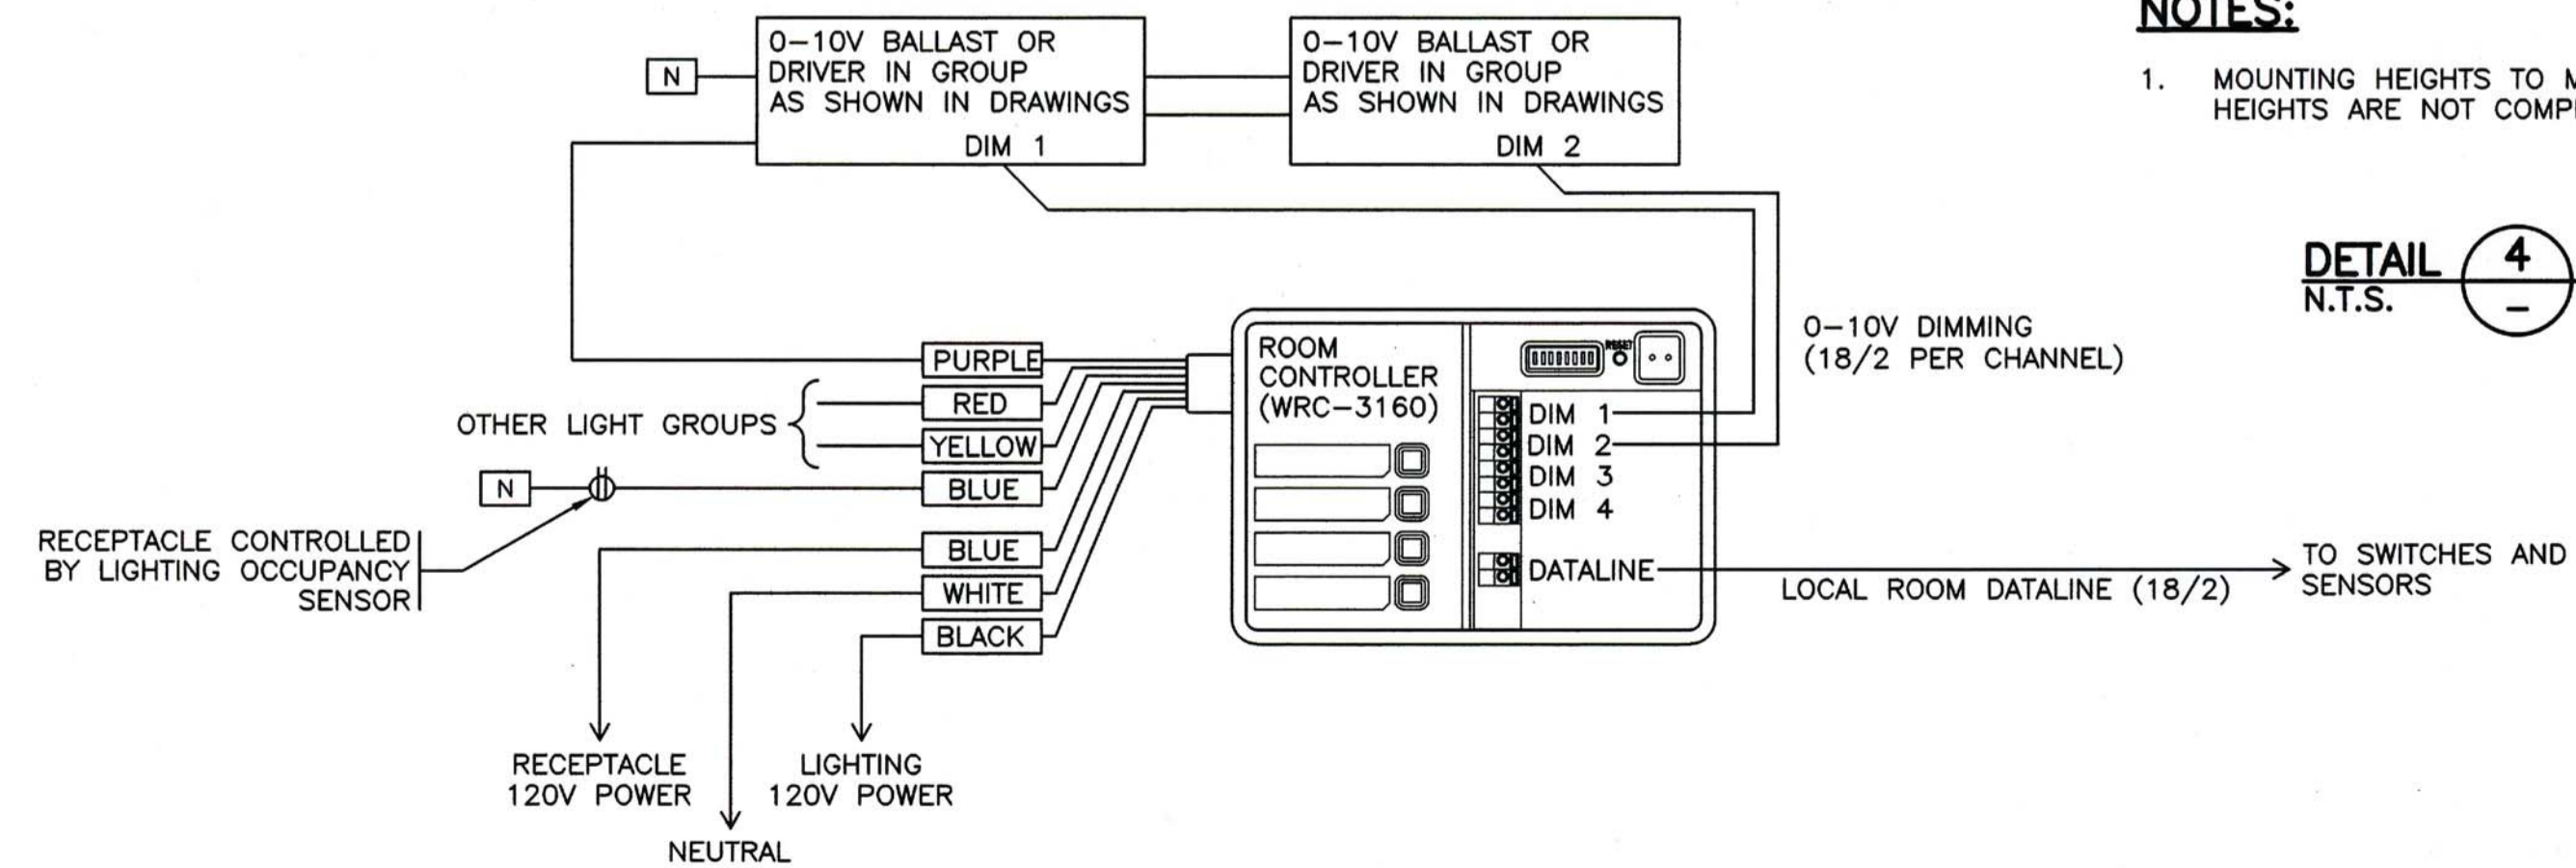

DETAIL 3 TYPICAL ROOM LIGHTING CONTROL MODULE
 N.T.S. (EXACT INTERCONNECTIONS WILL CHANGE BASED ON LOADS. REFER TO DRAWING)


- NOTES:**
- THE INDICATED EXISTING PANEL SPACE CONTAINS AN EXISTING BREAKER THAT APPEARS TO BE SWITCHED OFF AND MAY BE SPARE. CONTRACTOR TO CONFIRM ON BEFORE ROUGH-IN WORK COMMENCES AND MUST INFORM THE PROJECT TEAM IF THE ANTICIPATED SPARE CIRCUITS CAN NOT BE USED IN THE GROUPING SHOWN.
 - CONTRACTOR MUST PERFORM POWER AND CURRENT METERING INCLUDING KW, KVA AND AMPS BOTH 3 PHASE AND 1 PHASE. THE LOAD ON THE EXISTING PANELS FOR ONE WEEK AND PROVIDE THE PEAK DEMAND LOAD ON EACH PANEL MEASURED DURING THAT TIMEFRAME FOR REFERENCE BEFORE CONNECTING NEW LOADS. PROVIDE ENGINEER WITH SUMMARY REPORT OF RESULTS INCLUDING GRAPHS.

FISHERIES & OCEANS CANADA
 200-401 BURRARD STREET
 VANCOUVER, BC V6C 3R2

Project title/Titre du projet
4160 MARINE DRIVE
WEST VANCOUVER, BC V7V 1H2
PSEC CLASSROOM
ADDITION & RENOVATION

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Drawing title/Titre du dessin
ELECTRICAL DETAILS
 Project No./No. du projet
04A: 1802-002
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E10
 Revision no./La Révision no.
2
 OF XX

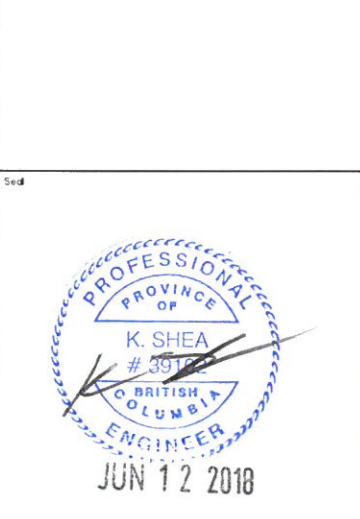

Reason / Révision	Description / Description	Date / Date

FISHERIES & OCEANS CANADA
200-401 BURRARD STREET
VANCOUVER, BC V6C 3R2

4160 MARINE DRIVE
WEST VANCOUVER, BC V7V 1H2

PSEC - CLASSROOM ADDITION & RENOVATION

Consultant Signature Box Only

Designed by/Concept par: **KS**

Drawn by/Dessiné par: **AT**

PWSC Project Manager/Administrateur de Projets: **TPSCC**


PWSC Regional Manager, Architectural and Engineering Services: **Gestioneur régional, services d'architecture et de génie, TPSCC**

SITE PLAN, GENERAL NOTES & SYMBOL SCHEDULES

Project No./No. du projet: **M0.01**

Sheet/feuille: **OF 6**

Revision no./no. de révision:

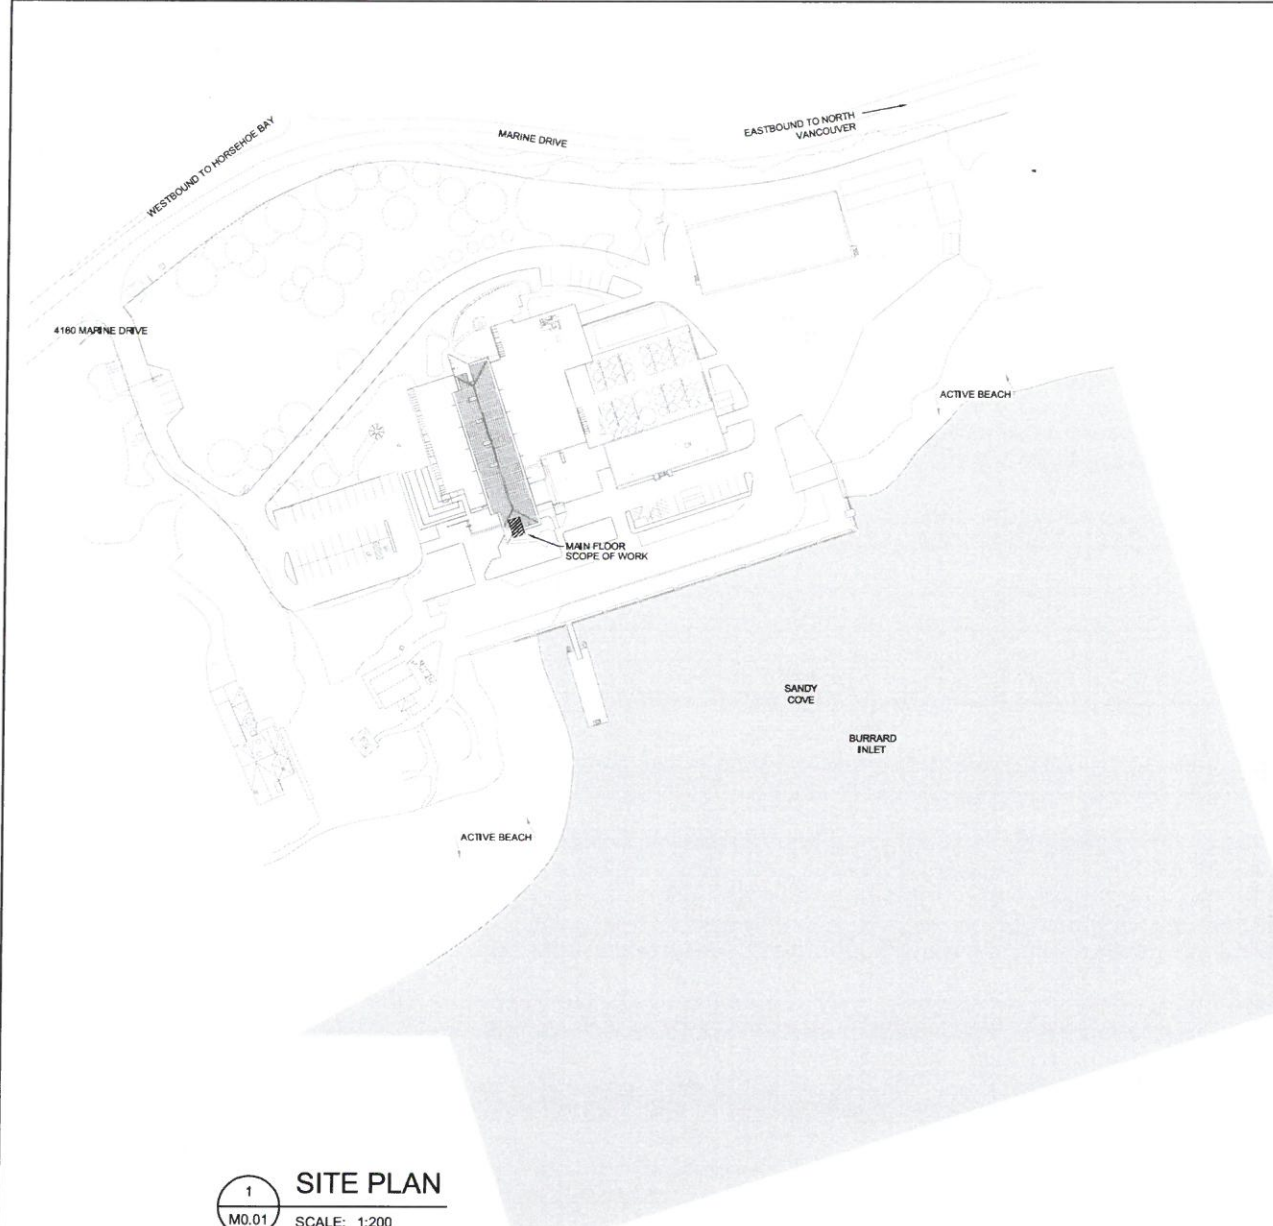

1 SITE PLAN
M0.01 SCALE: 1:200

SYMBOL SCHEDULE			SYSTEM MONITORING		
DEMOLITION	EXISTING	NEW	DEMOLITION	EXISTING	NEW
PIPING DOMESTIC COLD WATER (DCW) DOMESTIC HOT WATER (DHW) DOMESTIC HOT WATER REQRC. (DHWRC) SANITARY VENT SANITARY SEWER ABOVE GRADE SANITARY SEWER BELOW GRADE STORM SEWER ABOVE GRADE STORM SEWER BELOW GRADE RPE CLEAN-OUT RPE CLEAN-OUT TO GRADE HYDRONIC HEATING WATER SUPPLY HYDRONIC HEATING WATER RETURN CHILLED WATER SUPPLY CHILLED WATER RETURN CONDENSATE DRAIN			DUCTWORK SUPPLY OR OUTDOOR AIR DUCT UP SUPPLY OR OUTDOOR AIR DUCT DOWN RETURN AIR DUCT UP RETURN AIR DUCT DOWN EXHAUST AIR DUCT UP EXHAUST AIR DUCT DOWN TURNING VANES ACOUSTIC INSULATION BALANCING DAMPER (BD) BACKDRAFT DAMPER (BDD) MOTORIZED DAMPER (MD) DUCT OR PIPE CAP-OFF RETURN OR EXHAUST AIR GRILLE		
FITTINGS AND VALVES DIRECTION OF FLOW PIPE DROP PIPE RISE PIPE TEE UP PIPE TEE DOWN PIPE UNION ISOLATION VALVE (NORMALLY OPEN) ISOLATION VALVE (NORMALLY CLOSED) CHECK VALVE BALANCING VALVE AUTOMATIC AIR VENT (AAV) TEMPERATURE GAUGE PRESSURE GAUGE THERMOMETER PUMP			FIRE PROTECTION PENDANT SPRINKLER HEAD SIDEWALL SPRINKLER HEAD		
OUTLETS AND DRAINS HOSE BIB (HB) FLOOR DRAIN (FD) FUNNEL FLOOR DRAIN			EQUIPMENT TAGS GRILLE TYPE NECK / GRILLE SIZE AIR VOLUME (L/s) EQUIPMENT / FIXTURE TYPE GENERAL NOTE DRAWING REVISION DETAIL NUMBER DRAWING NUMBER SECTION NUMBER DRAWING NUMBER		

MECHANICAL ABBREVIATIONS	
AD AREA DRAIN	HWS HEATING WATER SUPPLY
AFF ABOVE FINISHED FLOOR	IN INCH
ARCH ARCHITECTURAL	INV INVERT
BDD BACKDRAFT DAMPER	JS JANITOR SINK
BTUH BRITISH THERMAL UNIT / HOUR	KW KILOWATT
CD CONTROL DAMPER	KS KITCHEN SINK
CFM CUBIC FEET PER MINUTE	LAV LAVATORY
CLG CEILING	LAT LEAVING AIR TEMPERATURE
CO CLEANOUT	LBS POUNDS
CONN CONNECTION	LWT LEAVING WATER TEMPERATURE
CW COMPLETE WITH	MAU MAKE-UP AIR UNIT
CONT CONTINUATION	MAX MAXIMUM
DB DRY BULB	MD MOTORIZED DAMPER
CTE CONNECT TO EXISTING	MECH MECHANICAL
DCW DOMESTIC COLD WATER	MIN MINIMUM
DDC DIRECT DIGITAL CONTROL	NC NOT IN CONTRACT
DEG DEGREE	NC NOISE CRITERION NORMALLY CLOSED
DHW DOMESTIC HOT WATER	NO NORMALLY OPEN
DIA DIAMETER	NTS NOT TO SCALE
DN DOWN	OIA OUTDOOR AIR
DWG DRAWING	PS POUNDS PER SQUARE INCH
EIA EXHAUST AIR	RA RETURN AIR
EAT ENTERING AIR TEMPERATURE	RF RETURN FAN
EF EXHAUST FAN	RM ROOM
EFF EFFICIENCY	RPM REVOLUTIONS PER MINUTE
ELEC ELECTRICAL	RWL RUN WATER LEADER
ENT ENTERING	S/A SUPPLY AIR
ESP EXTERNAL STATIC PRESSURE	SF SUPPLY FAN
EWI ENTERING WATER TEMPERATURE	SH SHOWER
EXH EXHAUST	SS STAINLESS STEEL
F FIRE MAIN	SP STATIC PRESSURE
FD FLOOR DRAIN	SPEC SPECIFICATION
FE FIRE EXTINGUISHER	T/A TRANSFER AIR
FLA FULL LOAD AMPS	TAD TRANSFER AIR DUCT
FLR FLOOR	THRU THROUGH
FRM FEET PER MINUTE	TYP TYPICAL
FT FEET/FOOT	UR URINAL
GAL GALLONS	V VENT
GPM GALLONS PER MINUTE	VFD VARIABLE FREQUENCY DRIVE
GWB GYPSUM WALL BOARD	WB WET BULB
HB HOSE BIB	WC WATER CLOSET
HWR HEATING WATER RETURN	

- MECHANICAL GENERAL NOTES**
- CONTRACTOR IS RESPONSIBLE FOR REVIEWING AND VERIFYING ACTUAL ON-SITE CONDITIONS PRIOR TO ANY WORK DONE.
 - CONTRACTOR TO INCLUDE AS A PART OF THE BID ALL COSTS ASSOCIATED WITH CUTTING AND PATCHING THAT IS REQUIRED TO INSTALL ALL NEW MECHANICAL SYSTEMS AS REQUIRED TO MEET THE SITE CONDITIONS AS SHOWN ON THE DRAWINGS. PATCHING SHALL MEET THE AESTHETIC CONDITIONS WHICH WAS THE CONDITION PRIOR TO ANY CUTTING BEING PERFORMED.
 - CONTRACTOR TO PROPERLY SEAL AND REPAIR ANY AND ALL DAMAGE THAT IS A RESULT OF REMOVAL OR DEMOLITION OF MECHANICAL EQUIPMENT. THIS INCLUDES BUT IS NOT LIMITED TO WALL, DOOR, CEILING, ETC.
 - THE EXISTING FACILITIES MECHANICAL SYSTEMS SHALL REMAIN OPERATIONAL DURING THE CONSTRUCTION AND RENOVATION PERIOD. CONTRACTOR TO COORDINATE CONSTRUCTION ACTIVITIES AND PHASING WITH OWNER TO MINIMIZE DISRUPTIONS TO OWNERS OPERATIONS AND ACCESS, AND TO ENSURE SAFETY OF THE USERS. PROVIDE ALL MEASURES REQUIRED TO PREVENT HAZARDS TO PEOPLE AND DAMAGE TO ITEMS REMAINING INCLUDING BUT NOT LIMITED TO DAMAGE FROM DUST AND HEAT.
 - THE MECHANICAL SYSTEM SHALL CONSIST OF ALL WORK SHOWN ON THE DRAWINGS, DIAGRAMS, SCHEMATICS AND AS DESCRIBED IN THE SPECIFICATIONS.
 - THE MECHANICAL PLANS ARE DIAGRAMMATIC IN NATURE AND DO NOT ATTEMPT TO SHOW ALL REQUIRED OFFSETS. REFER TO ARCHITECTURAL AND STRUCTURAL DRAWINGS FOR ADDITIONAL CONSTRUCTION DETAILS.
 - COORDINATE THE DRAWINGS WITH THE SPECIFICATIONS AND IN CASES WHERE CONFLICTS OCCUR THE MOST STRINGENT REQUIREMENT SHALL APPLY.
 - CONTRACTOR TO COORDINATE ALL MECHANICAL WORK WITH THAT OF OTHER TRADES TO ENSURE PROPER AND ADEQUATE INTERFACE WITH THE WORK OUTLINED FOR THIS PROJECT.
 - CONTRACTOR TO PROVIDE NEC (NATIONAL ELECTRICAL CODE) CLEARANCE HORIZONTAL AND VERTICAL REQUIREMENTS FOR ALL INSTALLED EQUIPMENT. OFFSET MECHANICAL WORK AS REQUIRED TO MEET THIS REQUIREMENT.
 - INSTALLING CONTRACTOR TO PROVIDE SEISMIC CALCULATIONS WITH A STRUCTURAL ENGINEERING STAMP AS REQUIRED BY THE BRITISH COLUMBIA PROVINCIAL BUILDING CODE.
 - PROVIDE CONCEALED DAMPER REGULATORS FOR ALL VOLUME DAMPERS OVER INACCESSIBLE CEILING AND SOFFITS. REFER TO ARCHITECTURAL DRAWINGS FOR CEILING TYPES.
 - CONTRACTOR TO ALLOW AND PROVIDE FOR METAL DUCTWORK TRANSITIONS BETWEEN ALL EQUIPMENT AND DUCT CONNECTIONS.
 - ALL EQUIPMENT CONNECTIONS TO DUCTWORK SHALL HAVE A MIN. OF 4 INCH OF REINFORCED CANVAS FLEXIBLE DUCTWORK FOR VIBRATION ISOLATION.

MECHANICAL DRAWING LIST		
DRAWINGS NO.	DESCRIPTION	SCALE
M0.01	SITE PLAN, GENERAL NOTES AND SYMBOL SCHEDULES	1:200
M0.02	MECHANICAL SCHEDULE	NOT TO SCALE
M1.01	FOUNDATION PLAN	1:100
M1.02	PLUMBING PLAN	1:100
M2.01	FIRE PROTECTION PLAN	1:100
M3.01	HVAC PLAN	1:100



PLUMBING FIXTURE SCHEDULE

WC-1 FLOOR MOUNTED WATER CLOSET

1) BOWL: AMERICAN STANDARD MADERA FLOWSE RIGHT HEIGHT ELONGATED MODEL 3461.001.020 WHITE FINISH, METEORUS CHINA, SIPHON JET FLUSH ACTION, NOMINAL DIMENSIONS: 356X718X419, 26 KG, OPERATES IN RANGE 4.2L TO 6 L, CW FLOOR FLANGE WITH ALL BRASS BOLTS AND WITH RUBBER GASKET

2) FLUSHOMETER: SLOAN ROYAL OPTIMA 111 ES-L2R9-CP EXPOSED FLUSHOMETER, 4.8 LPF FACTORY SET FLOW, INFRARED SENSOR, SENSOR LOCATED ABOVE TOILET, CW 102MM SQUARE ELECTRICAL BOX FOR MOUNTING SENSOR PLATE, CW EL-154 BOX MOUNTED HARDWARE TRANSFORMER

3) TOILET SEAT: CENTOCO 500STS.001 HEAVY DUTY FOR ELONGATED BOWL, OPEN FRONT, SOLID PLASTIC

WC-2 FLOOR MOUNTED WATER CLOSET (BARRIER FREE)

1) BOWL: AMERICAN STANDARD MADERA FLOWSE RIGHT HEIGHT ELONGATED MODEL 3461.001.020 WHITE FINISH, METEORUS CHINA, SIPHON JET FLUSH ACTION, NOMINAL DIMENSIONS: 356X718X419, 26 KG, OPERATES IN RANGE 4.2L TO 6 L, CW FLOOR FLANGE WITH ALL BRASS BOLTS AND WITH RUBBER GASKET

2) FLUSHOMETER: SLOAN ROYAL OPTIMA 111 ES-L2R9-CP EXPOSED FLUSHOMETER, 4.8 LPF FACTORY SET FLOW, INFRARED SENSOR, SENSOR LOCATED ABOVE TOILET, CW 102MM SQUARE ELECTRICAL BOX FOR MOUNTING SENSOR PLATE, CW EL-154 BOX MOUNTED HARDWARE TRANSFORMER

3) TOILET SEAT: CENTOCO 500STS.001 EXTRA HEAVY DUTY FOR ELONGATED BOWL, OPEN FRONT SOLID PLASTIC WITH COVER

UR-1 WALL MOUNTED URINAL

1) BOWL: TOTO UT105U URINAL WITH 34" TOP SPUD INLET, INTEGRAL TRAP, CW LOW PROFILE DOME STRAINER, WASHOUT FLUSH ACTION, METEORUS CHINA, TH3017 STAINLESS STEEL, URINAL DRAIN COVER

2) FLUSHOMETER: TEUTONIA 12PCP 0.125 GPF SLUSH VALVE, WASHOUT FLUSH ACTION

LAV-1 WALL MOUNTED LAVATORY

1) FAUCET: SLOAN BASYS EFX 100, SENSOR HANDWASHING FAUCET WITH BACKUP BATTERY, DOUBLE INFRARED SENSOR, 1.9 LPM, VAMCAL RESISTANT, CW EAF 37 TRANSFORMER
PROVIDE OPEN GRID DRAIN, CAST BRASS ONE PIECE TOP 17 GA TUBULAR 32 MM TAILPIECE, PROVIDE CHROME-PLATED FINISH P-TRAP, HEAVY CAST BRASS ADJUSTABLE BODY, WITH SLP NUT, 32 MM SIZE, WITH CLEANOUT, SHALLOW WALL FLANGE AND SEAMLESS TUBULAR WALL BLEND

SH-1 SHOWER

1) SHOWER TRIM: AMERICAN STANDARD T431.730.002 BOULEVARD THERMOSTATIC SHOWER TRIM METAL WALL PLATE POLISHED CHROME FINISH, 201 MM DIA TRIM FACE PLATE, TEMPERATURE CONTROL, SINGLE LEVER HANDLE, CW RS10 CERAMIC THERMOSTATIC IN WALL SHOWER ROUGH VALVE

2) SHOWERHEAD: AMERICAN STANDARD 1660.650.002 3 FUNCTION SHOWER HEAD, POLISHED CHROME FINISH 9.5 LPM MAX FLOW RATE CW 1660.740.002 WALL MOUNT SHOWER ARM, BRASS CONSTRUCTION, 140 MM LONG WITH 45 ANGLE, POLISHED CHROME FINISH

3) DRAIN: SHUTTER-KERD LINE DRAIN, BRUSHED STAINLESS STEEL, LINEAR FLOOR DRAIN CONSISTING OF A FORMED STAINLESS STEEL CHANNEL BODY AND GRATE ASSEMBLY THAT CAN BE SEAMLESSLY ADJUSTED OR STONE COVERING THICKNESS FROM 3 MM TO 25 MM, THE CHANNEL BODY FEATURES 57 WIDE, 50 MM NO HUB CENTRE DRAIN OUTLET AND 22 MM WIDE BONDING FLANGE LAMINATED WITH A COLLAR MADE OF SCHLUTER WATERPROOFING MEMBRANE, CHANNEL BODY MATERIAL IS SS AND LENGTH AT 1700MM, BRUSHED SS 304 GRATE WITH SQUARE PERFORATIONS AND LOCKING MECHANISM

FD-1 FLOOR DRAIN

1) WATTS #FD-100-C-FC EPOXY COATED CASTIRON 7"Ø FLOOR DRAIN WITH ANCHOR FLANGE, REVERSIBLE MEMBRANE CLAMP WITH PRIMARY AND SECONDARY WEEP HOLES, 1/4" THICK ADJUSTABLE NICKEL BRONZE STRAINER WITH SURFACE MEMBRANE CLAMP

KS-1 KITCHEN SINK

1) BASIN: FRAMME SINGLE COMPARTMENT UNDER MOUNT BASIN UC56808P-1, 18 GAUGE, TYPE 304 STAINLESS STEEL, UNDERCOATED TO REDUCE CONDENSATION AND RESONANCE, INCLUDES WASTE FITTING, CUTOUT TEMPLATE AND INSTALLATION HARDWARE

2) FAUCET: MOEN MODEL 7565E SERIES SINGLE HANDLE HIGH ARC PULLDOWN KITCHEN FAUCET, 5.7 LPM

DIFFUSERS AND GRILLES

EQUIPMENT TAG	DESCRIPTION/TYPE	MANUFACTURER	SERVICE	MODEL NUMBER	NOTES
SD-1	LINEAR SLOT DIFFUSER	EH PRICE	S/A	1500SDS1001/2/ZZ/B12	1,2,3,4,5
SD-2	SQUARE PLAQUE DIFFUSER	EH PRICE	S/A	1500SDS1001/2/ZZ/B12	1,2,3,4
L-1	EXHAUST FAN LOUVER	EH PRICE	E/A	DE439	6,7
DG-1	TRANSFER AIR DOOR GRILLE	EH PRICE	T/A	ATG1/C	6
R-1	RETURN AIR GRILLE	EH PRICE	R/A	530FLAB12	1,4

NOTES:

- PROVIDE DIFFUSERS AND GRILLES WITH BORDER STYLES THAT ARE COMPATIBLE WITH ADJACENT WALLS AND CEILING SYSTEMS. REFER TO ARCHITECTURAL DRAWINGS.
- NC LEVELS BASED ON OCTAVE BANDS 2-7 SOUND POWER LEVELS MINUS A ROOM ABSORPTION OF 10 DB, MEASURED PER ASHRAE 70-91.
- CONTRACTOR TO REFER TO MECHANICAL AND ARCHITECTURAL DETAILS FOR SUPPLY AND INSTALLATION OF LINEAR GRILLE.
- CONTRACTOR TO REFER TO ARCHITECTURAL, ELECTRICAL AND FIRE PROTECTION CEILING LAYOUTS WHEN INSTALLING DIFFUSERS AND GRILLES TO PREVENT CONFLICTION
- CW 1500SDS1001/2/150
- CUSTOM COLOUR OF PRODUCT TO BE SELECTED BY THE ARCHITECT DURING THE SHOP DRAWINGS SUBMITTAL PROCESS
- CW BRD & INLET SCREEN

FANS SCHEDULE

EQUIPMENT TAG	QTY	SERVICE	LOCATION	TYPE	MANUFACTURER	MODEL	AIR FLOW (LPS)	E. S. P. (PA)	FAN (RPM)	ELECTRICAL (V/PHC)	DRIVE TYPE	SOUND LEVEL (SONES)	WEIGHT (KG)	NOTES
EF-1	1	ELECTRICAL ROOM	ELECTRICAL ROOM	IN-LINE	GREENHECK	SQ-99V/G	150	65	1210	115/60/1	DIRECT	4.9	25.0	ALL

NOTES:

- CW VARI-GREEN MOTOR SPEED CONTROL ON EXHAUST FAN
- PROVIDE LOW VOLTAGE HUMIDISTAT
- CW FACTORY MOUNTED DISCONNECT

MECHANICAL MOTORLIST

EQUIP. TAG	EQUIPMENT DESCRIPTION	LOCATION	EQUIPMENT					DISCONNECT					STARTER					CONTROL					NOTES			
			SUPPLIED	H.P.	KW	MCA	FLA	VOLTAGE	PHASE	SUPPLIED	INSTALLED	WRED	LOCATION	TYPE	SUPPLIED	INSTALLED	WRED	LOCATION	TYPE	SUPPLIED	INSTALLED	WRED				
	PLUMBING FIXTURES																									
WC-1	FLUSH VALVE	WASHROOM	M					24	1																1	
WC-2	FLUSH VALVE	WASHROOM	M					24	1																	1
LAV-1	FAUCET	WASHROOM	M					24	1																	1
	FANS																									
EF-1	DRYER ROOM EXHAUST FAN	DRYER ROOM	M	FRAC				115	1	M	M	M	1	MAN	E	E	E	1	H	M	M	M				

SUPPLIER / INSTALL / WIRE CODES:

M * MECHANICAL
E * ELECTRICAL
G * GENERAL CONTRACTOR

STARTER CODES:
MAN * MANUAL STARTER
MAG * MAGNETIC STARTER WITH HOA SWITCH W/ AUX. CONTACTS
MRR * MOTOR RATED RELAY, 24 VAC COIL & MOTOR PROTECTION SWITCH
PCS * PACKAGED CONTROL SYSTEM
VSD * VARIABLE SPEED DRIVE
RVS * REDUCED VOLTAGE STARTER
WS * WALL SWITCH
CP * CONTROL PANEL

CONTROL DEVICE CODES:
BMS * BLDG MANAGEMENT SYSTEM
ES * END SWITCH
ET * LINE VOLTAGE T'STAT
FA * FIRE ALARM
FS * FLOW SWITCH
GS * GAS SENSOR
H * HUMIDITY SENSOR
I * INTERLOCK, SEE NOTES
LS * LEVEL SWITCH
PS * PRESSURE SWITCH
TC * TIME CLOCK
T * LOW VOLTAGE T'STAT OR SENSOR
TS * TAMPER SWITCH
VS * VARIABLE SPEED SWITCH
WS * WALL SWITCH
FAP * FIRE ALARM PANEL
INT * INTEGRAL CONTROL
PCS * PACKAGED CONTROL SYSTEM

LOCATION CODES:
1 * AT OR NEAR MOTOR
2 * MOTOR CONTROL CENTRE
3 * EQUIPMENT ROOM
4 * ELECTRICAL ROOM
5 * AS SHOWN ON DRAWINGS

MISCELLANEOUS CODES:
FFCP * FIRE FIGHTERS CONTROL PANEL

NOTES:

- ELECTRICAL TO PROVIDE 120 V TO TRANSFORMER

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FISHERIES & OCEANS CANADA
200-401 BURRARD STREET
VANCOUVER, BC V6C 3R2

4160 MARINE DRIVE
WEST VANCOUVER, BC V7V 1H2

PSEC - CLASSROOM ADDITION & RENOVATION

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Designed by/Concept par: **KS**

Drawn by/Dessiné par: **AT**

PWOSC Project Manager/Administrateur de Projets TPSCC

PWSC Regional Manager, Architectural and Engineering Services/ Gestionnaire régionale, Services d'architecture et de génie, TPSCC

Drawing No./Nbre du dessin

MECHANICAL SCHEDULE

Project No./No. du projet: **M0.02**
Sheet/Feuille: **OF 6**
Revision no./La Révision no.




PLUMBING RENOVATION NOTES:

1. CONNECT NEW PLUMBING FIXTURES SANITARY TO EXISTING SANITARY BRANCHES REFER TO RENOVATION DRAWING.
2. CONTRACTOR TO REUSE EXISTING CORES THROUGH SLAB WHERE POSSIBLE. IF NEW CORES ARE REQUIRED CONTRACTOR TO SCAN EXISTING SLAB AND RECEIVE APPROVAL OF LOCATIONS FROM DESIGN TEAM PRIOR STARTING WORK.
3. REMOVAL OF EX FLOOR DRAINS WILL NEED CONCRETE TO BE REMOVED AND PATCHED. CONTRACTOR TO ACCOUNT FOR ALL WORK DONE ON THE CONCRETE FOR REPLACING EX PLUMBING FIXTURES WITH NEW. CONTRACTOR TO PATCH FLOOR AND MAKE GOOD.


KEY NOTES:

- ① CONTRACTOR TO MATCH SLOPE TO EXISTING, REFER DETAIL 3M1.01

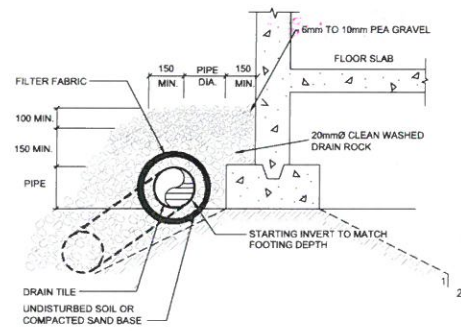


NOTE:
PEA GRAVEL AND DRAIN ROCK SHALL BE CARRIED OVER TO FOUNDATION WALL AND FOOTINGS WHERE DRAIN TILES ARE SHOWN.

③ PERIMETER DRAIN TILE DETAIL
SCALE: NOT TO SCALE

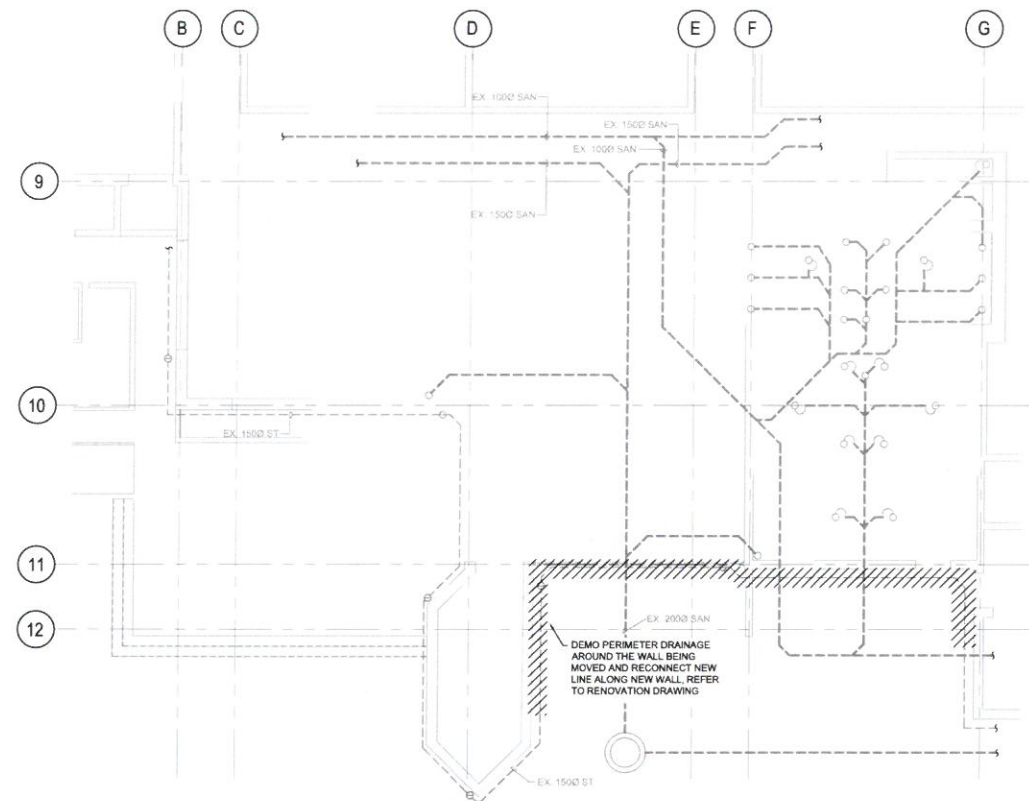

① FOUNDATION DEMOLITION PLAN
SCALE: 1:100

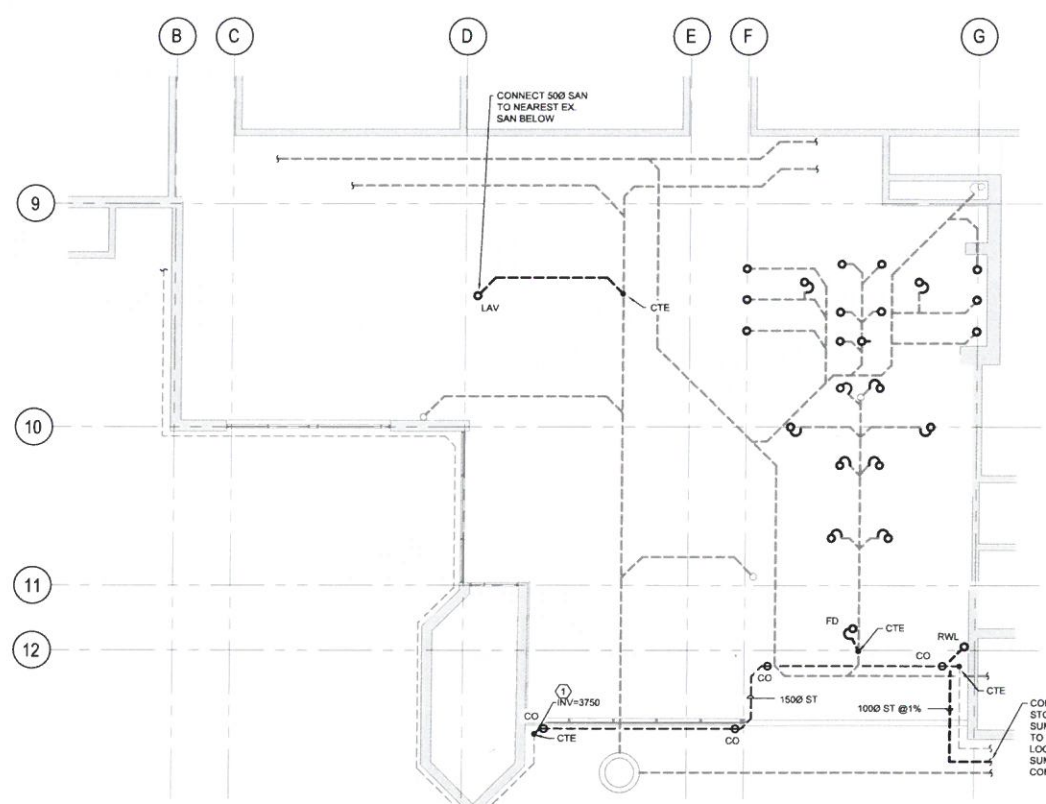

② FOUNDATION RENOVATION PLAN
SCALE: 1:100

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Revision/Revision	Description/Description	Date/Date

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FISHERIES & OCEANS CANADA
200-401 BURNARD STREET
VANCOUVER, BC V6C 3R2

Project title/Titre du projet
**4160 MARINE DRIVE
WEST VANCOUVER, BC V7V 1H2**
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ADDITION & RENOVATION**

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FWCSC Regional Manager, Architectural and Engineering Services/
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FOUNDATION PLAN

Project No./No. du projet	Sheet/feuille	Revision no./ Lo. Révision no.
	M1.01	
	OF 6	


PLUMBING DEMOLITION NOTES:

1. ALL PLUMBING FIXTURES IN SCOPE OF WORK TO BE REMOVED AND REPLACED WITH NEW. REFER TO PLUMBING FIXTURE SCHEDULE AND PLUMBING RENOVATION PLAN. CONTRACTOR TO CAP EX. DOW & DRYW LINES TO EACH FIXTURE FOR CONNECTING FUTURE PLUMBING FIXTURES DURING RENOVATION PHASE.


KEY NOTES:

① LAVATORY BASIN PROVIDED BY ARCHITECT. MECHANICAL CONTRACTOR IS RESPONSIBLE FOR MAKING ALL CONNECTIONS TO LAVATORY INCLUDING BUT NOT LIMITED TO FAUCET AND WASTE PIPING

② RELOCATED RWL TO RUN THROUGH CORNER OF DRYING ROOM AND TO BE CONNECTED TO NEW STORM LINE IN FOUNDATION. PIPE MATERIAL TO BE PVC.

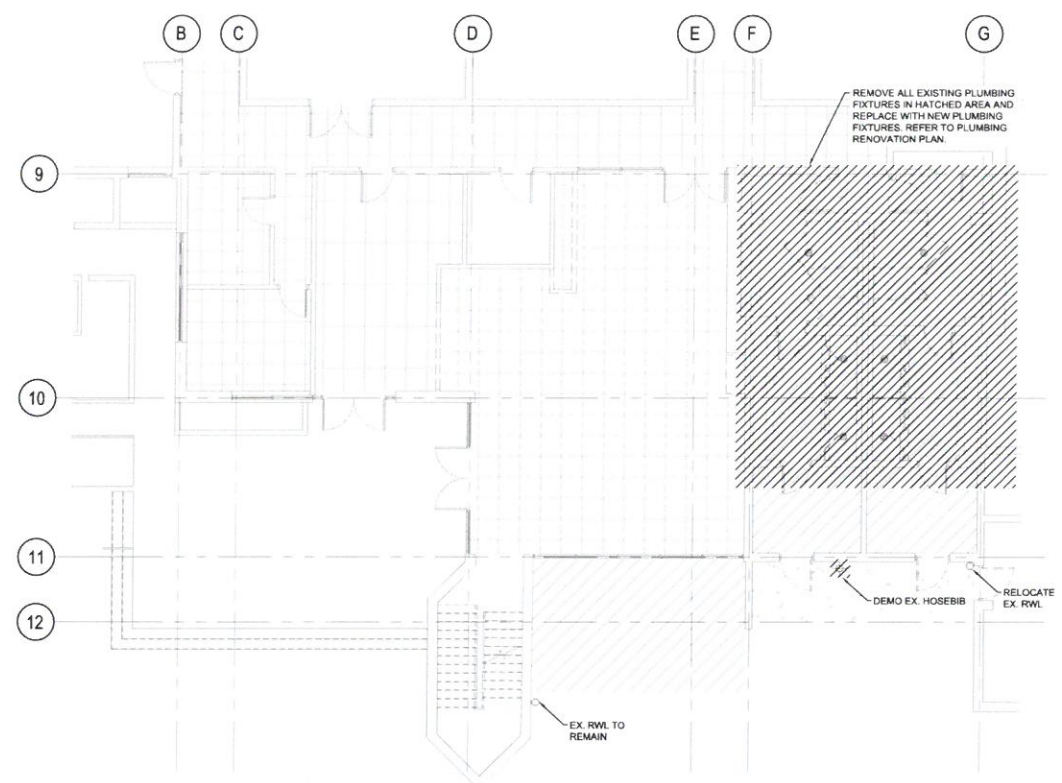

1 PLUMBING DEMOLITION PLAN
SCALE: 1:100

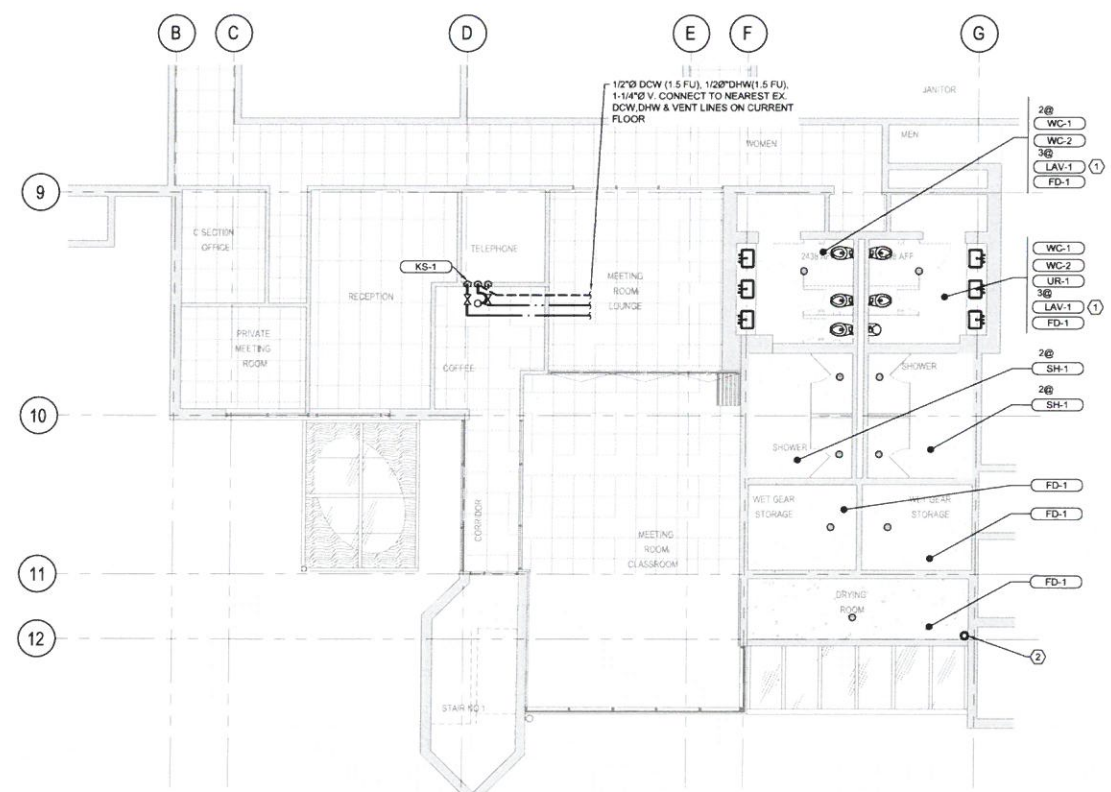

2 PLUMBING RENOVATION PLAN
SCALE: 1:100



Revision/Revision	Description/Description	Date/Date
ISSUED FOR TENDER		2018-06-12

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 VANCOUVER, BC V6C 3R2

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 Drawn by/Dessiné par **AT**
 PWSC Project Manager/Administrateur de Projets TPSCC
 TPSCC, Regional Manager, Architectural and Engineering Services/
 Gestionnaire régionale, Services d'architectural et de génie, TPSCC

PLUMBING PLAN


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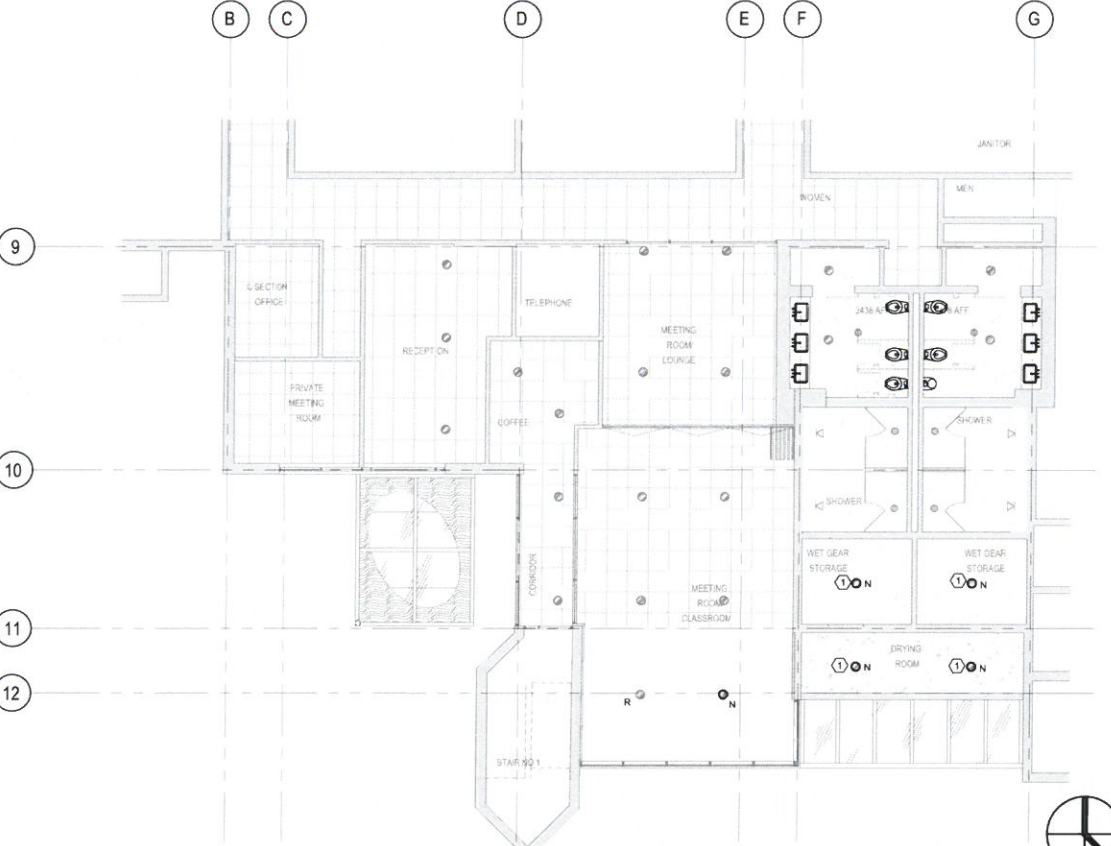
- FIRE PROTECTION GENERAL NOTES:**
- CONTRACTOR TO ENSURE PROVISIONS ARE MADE FOR OPERATING FIRE PROTECTION SYSTEM WHILE WORK IS BEING COMPLETED.
 - ALL NEW SPRINKLER HEADS AND RELOCATED SPRINKLER HEADS ARE TO SHOW NEW AND RELOCATED LOCATIONS ONLY. SPRINKLER CONTRACTOR TO PROVIDE ALL NEW SPRINKLER HEADS AND LAYOUT TO BE IN ACCORDANCE W/ NFPA 13. NEW SPRINKLER HEADS TO MATCH EXISTING UNLESS OTHERWISE INDICATED.
 - MODIFY SPRINKLER SYSTEM TO SUIT NEW LAYOUT AND TO ENSURE COMPLIANCE WITH CODE.
 - SPRINKLER ENGINEER TO COORDINATE NEW AND RELOCATED SPRINKLER HEAD LOCATIONS WITH HVAC, LIGHTING AND ARCHITECTURAL LAYOUT.
 - PROVIDE AND INSTALL FIRE EXTINGUISHERS TO MEET THE REQUIREMENTS OF NFPA 10 AND LOCAL FIRE COMMISSIONER.
 - ANY ADDITIONAL SPRINKLER HEADS THAT MAY BE REQUIRED TO COMPLETE FINAL DESIGN (NFPA 13 REQUIREMENTS) ARE CONSIDERED TO BE IN THE SCOPE OF WORK. ADDING OR REMOVING SPRINKLER HEADS ARE NOT CONSIDERED TO BE A CHANGE OF CONTRACT AMOUNT.
 - SYSTEM DESIGN TO LIGHT HAZARD OCCUPANCY, MAXIMUM SPRINKLER SPACING OF 225 SQ FT. PER SPRINKLER.
 - ALL SPRINKLER HEADS TO BE CENTRED ON THE CEILING TILES.

- KEY NOTES:**
- NEW SPRINKLER TO BE CORROSION RESISTANT

- SPRINKLER HEAD LEGEND**
- EXISTING PENDENT HEAD
 - R RELOCATED PENDENT HEAD
 - N NEW PENDENT HEAD TO MATCH EXISTING



1 FIRE PROTECTION DEMOLITION PLAN
SCALE: 1:100

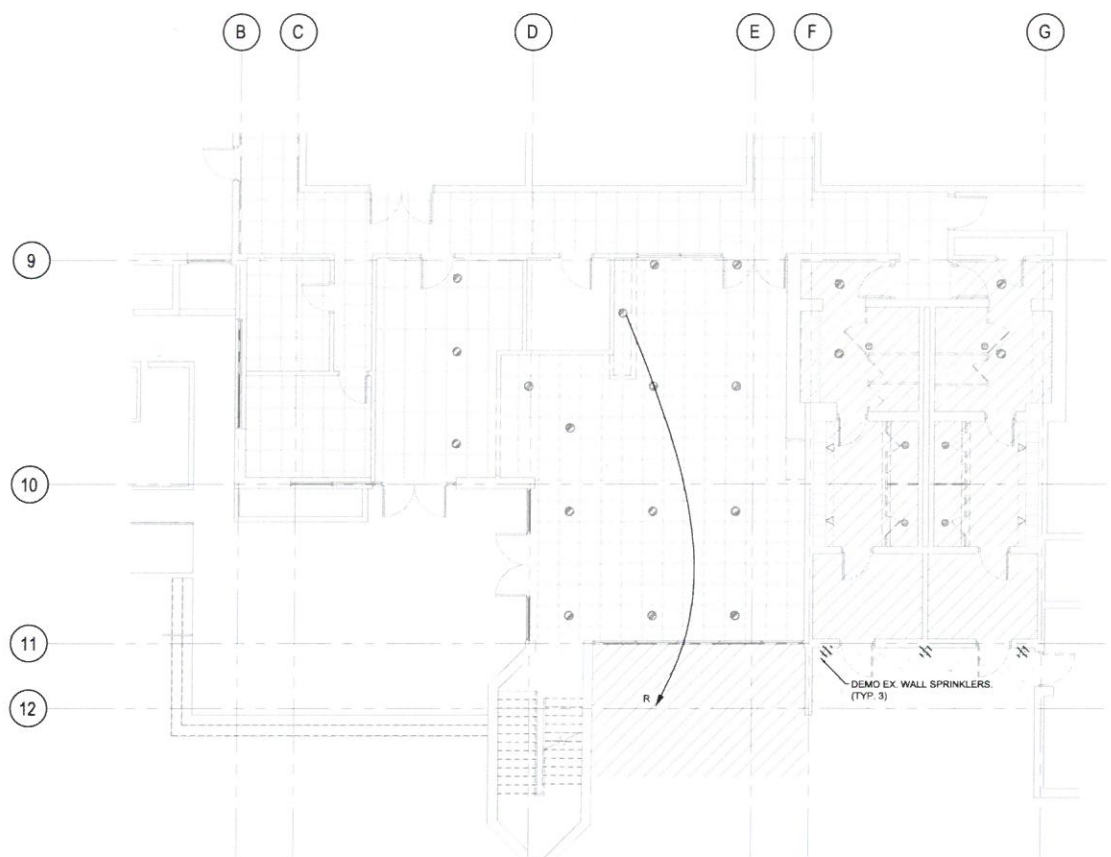

2 FIRE PROTECTION RENOVATION PLAN
SCALE: 1:100

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**PSEC - CLASSROOM
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 PWGSC Regional Manager, Architectural and Engineering Services/
 Gestionnaire régionale, Services d'architectural et de génie, TPSSC

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FIRE PROTECTION PLAN

Project No./No. du projet
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M2.01
 OF 6
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FISHERIES & OCEANS CANADA
200-401 BURRARD STREET
VANCOUVER, BC V6C 3R2

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HVAC PLAN


Project No./No. du projet	Sheet/feuille	Revision no./La Révision no.
	M3.01	
	OF 6	

GENERAL NOTES


- CONTRACTOR TO REMOVE EXISTING GRILLES BEFORE CEILING IS REMOVED IN SCOPE OF WORK AREA. CONTRACTOR TO THEN RE-USE AND PLACE THE EXISTING GRILLES IN NEW CEILING IN THE SCOPE OF WORK AREA AND RE-BALANCE.
- CONTRACTOR TO ALLOW FOR ANY NEW OR ADJUSTING OF EX. DUCTWORK TO EX. DIFFUSERS AND GRILLES.

KEY NOTES

- EX. THERMOSTAT CONNECTED TO EX. FCU-1 TO BE RELOCATED. REFER TO RENOVATION PLAN FOR THE NEW LOCATION.
- EX. 800X250 RETURN AIR GRILLE TO EX. FCU-1. CONTRACTOR TO REMOVE GRILLE PRIOR TO WHEN WORK IS DONE ON THE WALL AND PLACE THE EXISTING GRILLE ON CEILING DURING RENOVATION PHASE. PORTION OF DUCT TO BE DEMOLISHED UP TO CEILING SPACE.
- DUCT FROM SF-2 IN MECHANICAL ROOM LOCATED AT THE US OF SLAB ABOVE ALL OTHER DUCTWORK SHOWN AS HIDDEN FOR CLARITY.
- CONTRACTOR TO REMOVE ALL EXISTING GRILLES IN WASHROOM SPACE BEFORE CEILING IS REMOVED WITHIN THE WASHROOM. TO BE RE-USED IN THE NEW CEILING.
- CONTRACTOR TO ALLOW OFFSET OF EX. 300X250 DUCT TO ACCOMMODATE STRUCTURAL BRACE. REF. TO STRUCTURAL DRAWINGS. CONTRACTOR TO CONFIRM ONSITE IF OFFSET IS REQUIRED BASED ON SITE CONDITIONS.
- DURING RENOVATION PHASE CONTRACTOR TO CONNECT DUCT FROM CEILING TO THE EX. RELOCATED GRILLE.
- CONTRACTOR TO RE-USE AND PLACE THE EXISTING GRILLES IN NEW CEILING WITHIN THE WASHROOM SPACE.

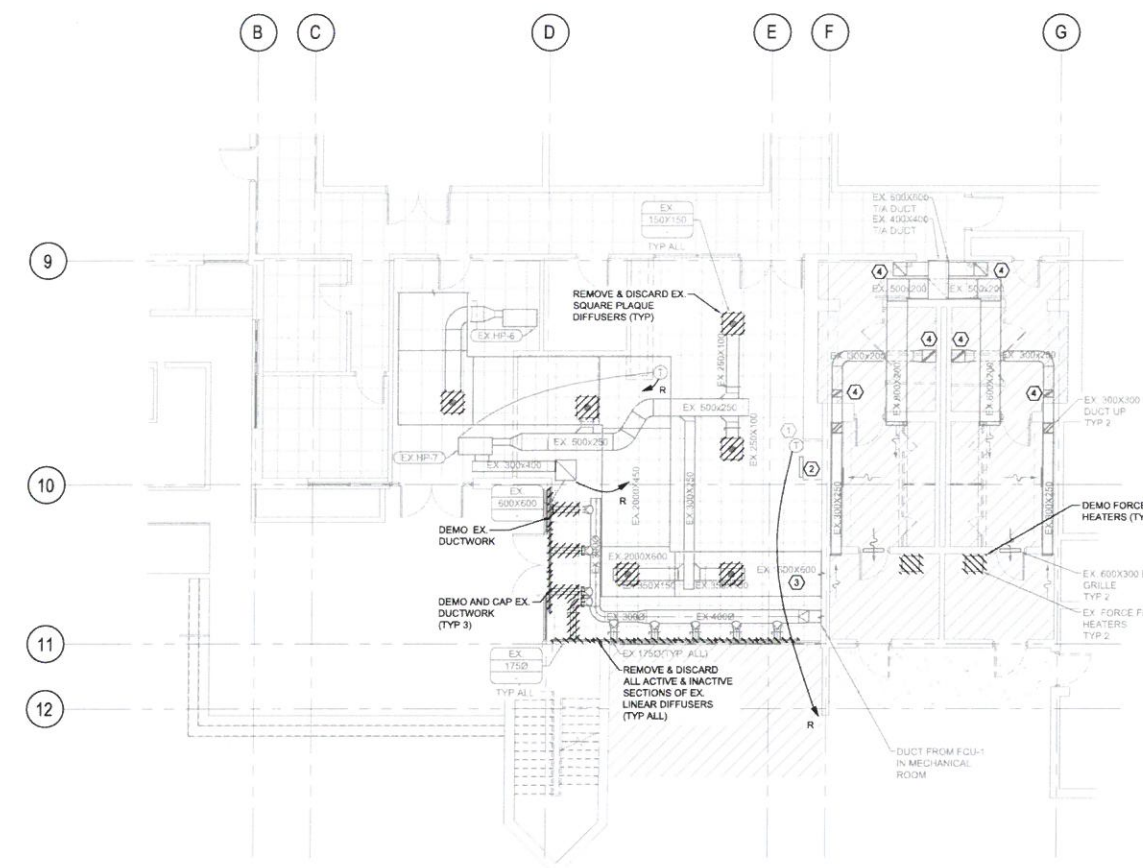


1 HVAC DEMOLITION PLAN
M3.01 SCALE: 1:100

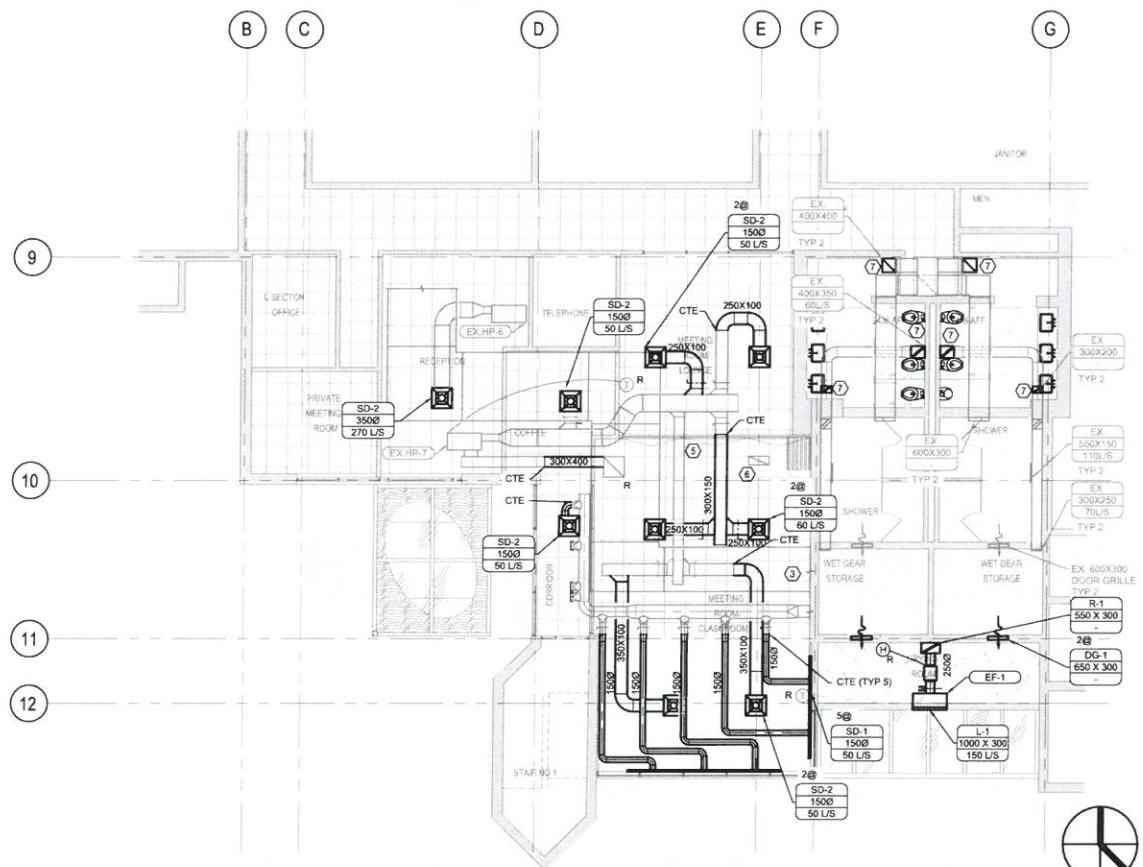

2 HVAC RENOVATION PLAN
M3.01 SCALE: 1:100



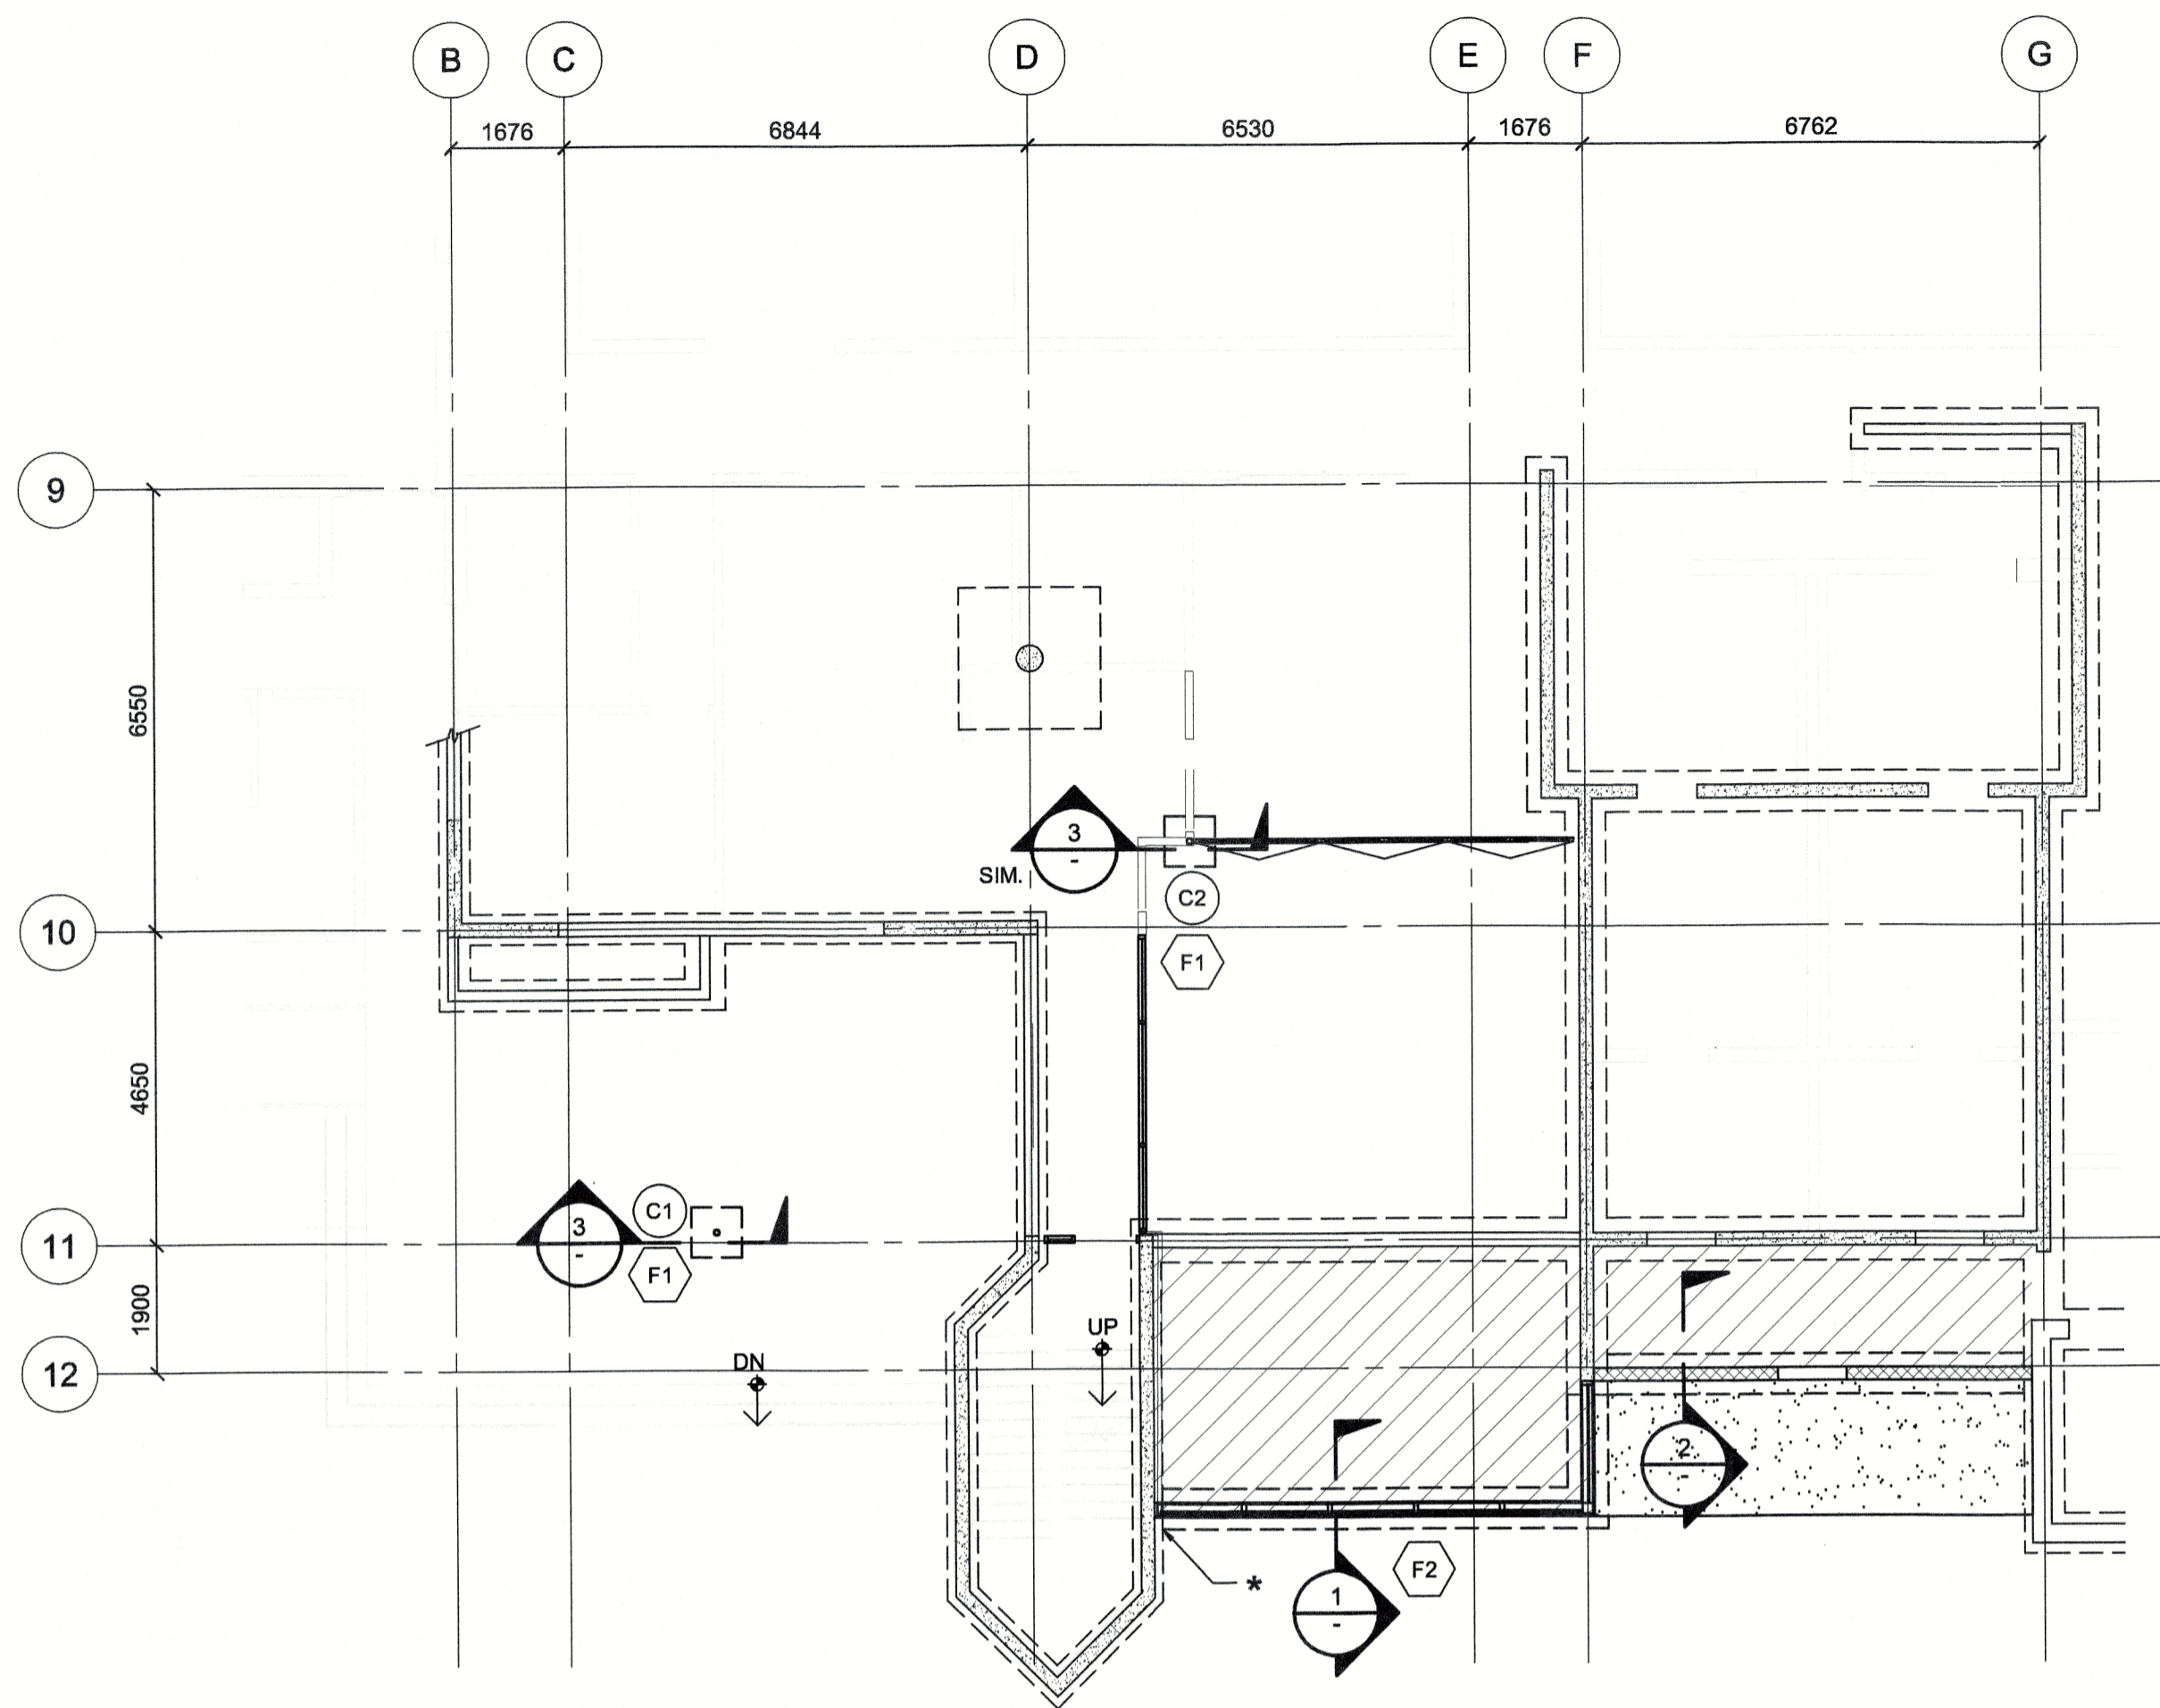

PARTIAL MAIN FLOOR & FOUNDATION PLAN

1:100

LEGEND:

- DENOTES NEW 125 THK. S.O.G. R/W 10M@300 E.W. ON 6 MIL POLY VAPOUR BARRIER ON 300 THK. COMPACTED CRUSHED GRAVEL FILL AS PER GEOTECH REPORT
- DENOTES NEW CMU WALL
- DENOTES NEW CONC. SIDEWALK AS PER ARCH. DWG.


* WHERE NEW FOOTING OR S.O.G. ABUT EXIST. FOOTING OR S.O.G., CLEAN EXIST. CONC. SURFACE FREE OF LAITANCE. SATURATE CONC. 24 HOURS PRIOR TO POUR. ENSURE CONC. IS SATURATED SURFACE DRY (SSD) BEFORE POURING. DRILL AND DOWEL REBAR USING HILTI RE500 V3 OR APPROVED ALTERNATIVE. EMBED 150mm. SPLICE BARS AS PER GENERAL NOTES.

COLUMN SCHEDULE


COLM. TYPE	COLUMN SIZE	BASE PLATE (THICKNESS x WIDTH x LENGTH)
C1	HSS102@x6.4 W/ HSS 89@x6.4 REVEAL AT ENDS	19x250x250 C/W HOLES FOR 4-16Ø x200 EMBED A307 ANCHOR BOLTS WITH STANDARD NUT & WASHERS PROVIDE 38 THK. NON-SHRINK GROUT. 38 TYP.
C2	HSS 89x89x6.4	19x250x250 C/W HOLES FOR 4-16Ø x200 EMBED A307 ANCHOR BOLTS WITH STANDARD NUT & WASHERS PROVIDE 38 THK. NON-SHRINK GROUT. 38 TYP.

FOOTING SCHEDULE


FTG. TYPE	FOOTING SIZE (LENGTH x WIDTH x DEPTH)	BOTTOM REINFORCING EACH WAY (U.N.O.)	REMARKS
F1	750 x 750 x 425 (ASSUMED)	4-15M U-BARS BOTT. 10M@300 TOP	SEE TYP. SECTION
F2	600 WIDE x 250 DEEP	3-15M LONG. BOTT.	SEE TYP. SECTION

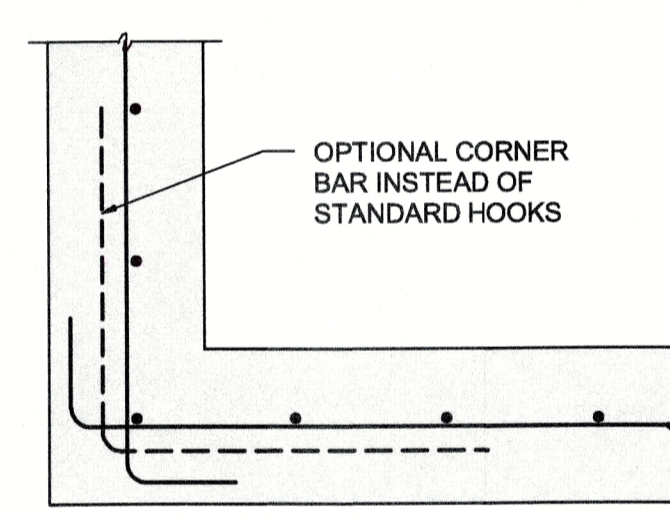


SINGLE CURTAIN
TYPICAL WALL INTERSECTION PLAN DETAILS
1:10

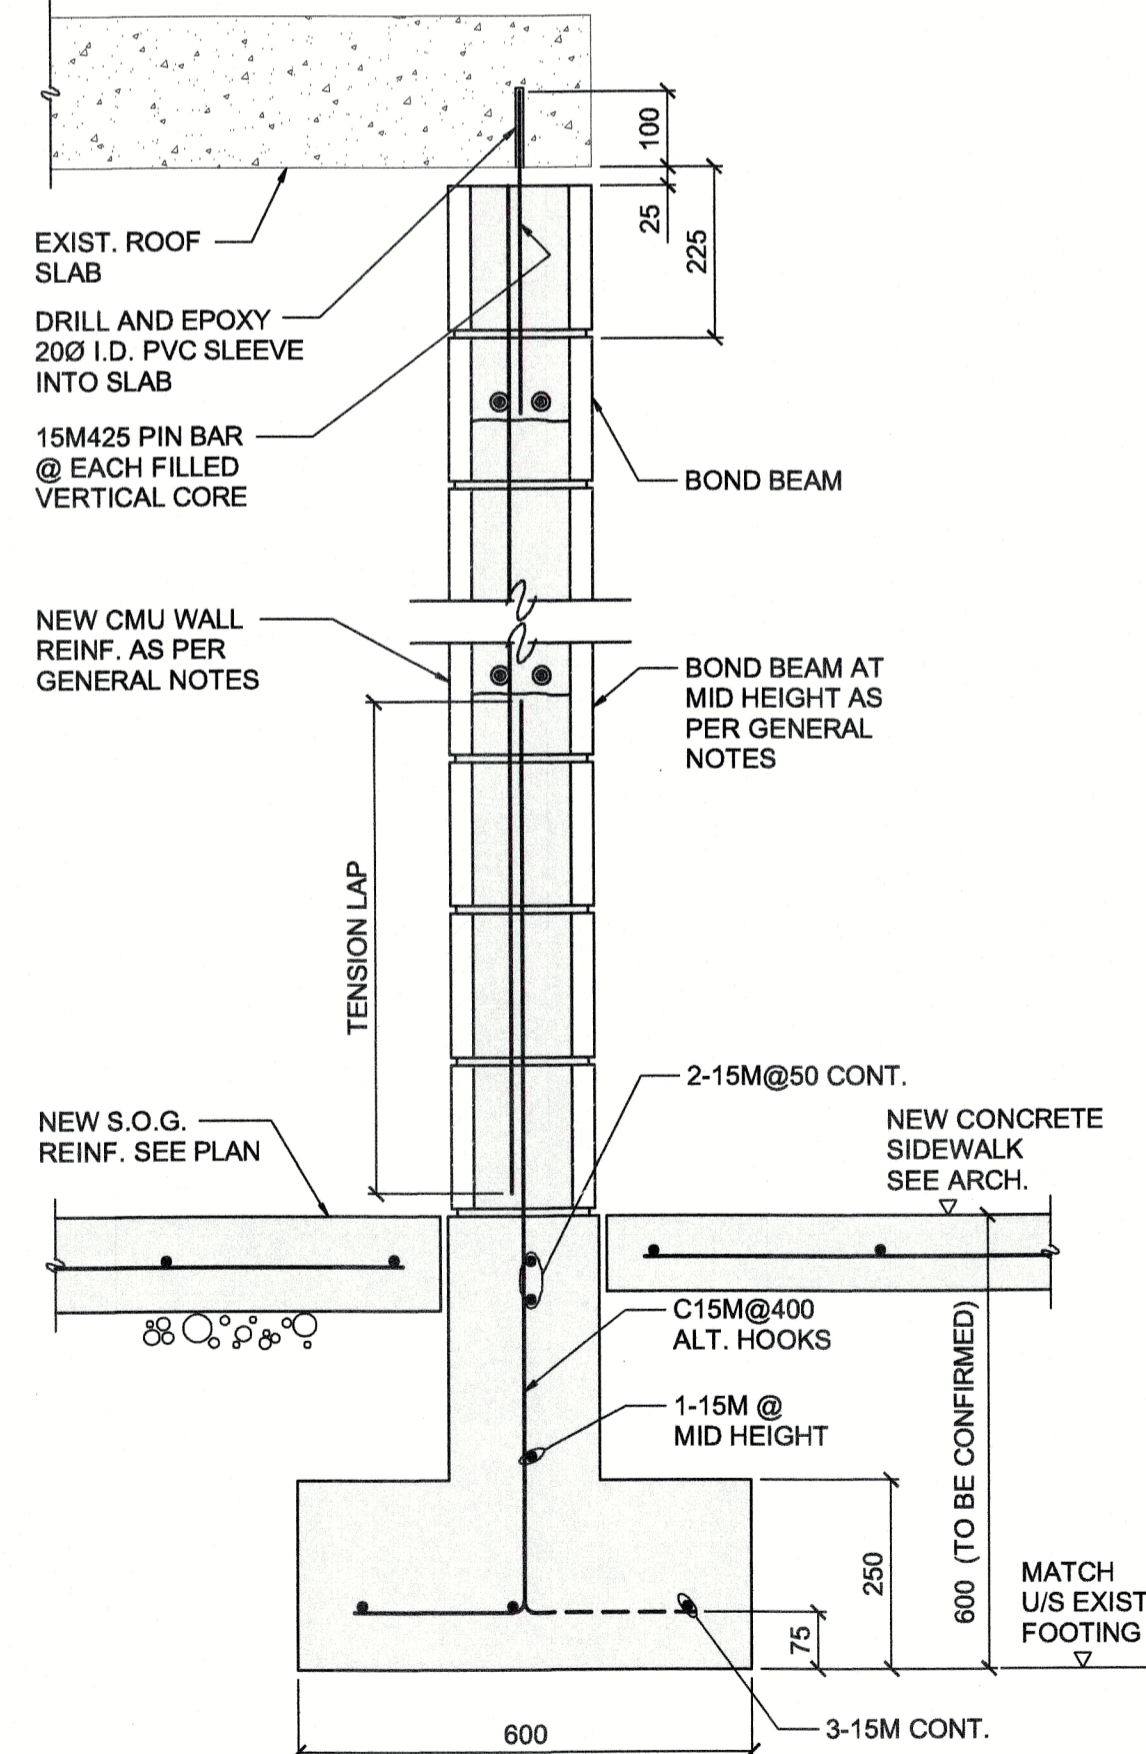

SECTION 2
1:10
GEOTECH TO CONFIRM BEARING CONDITIONS AND BACKFILL

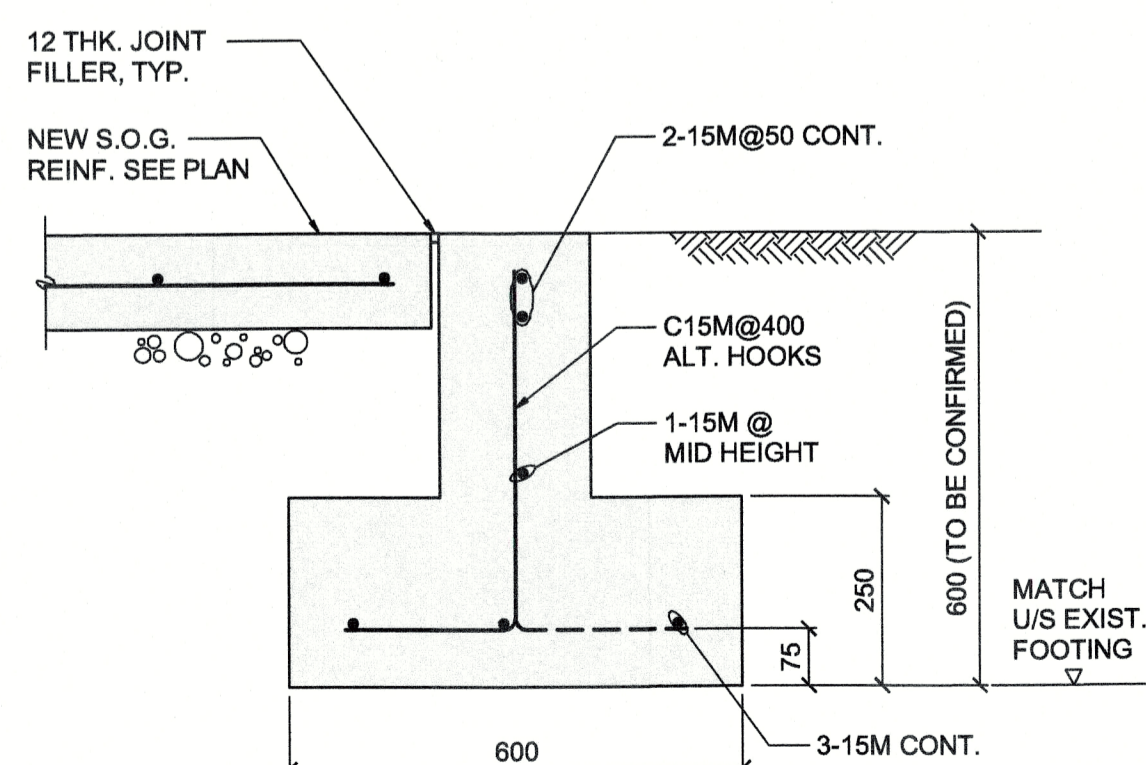

SECTION 1
1:10
GEOTECH TO CONFIRM BEARING CONDITIONS AND BACKFILL

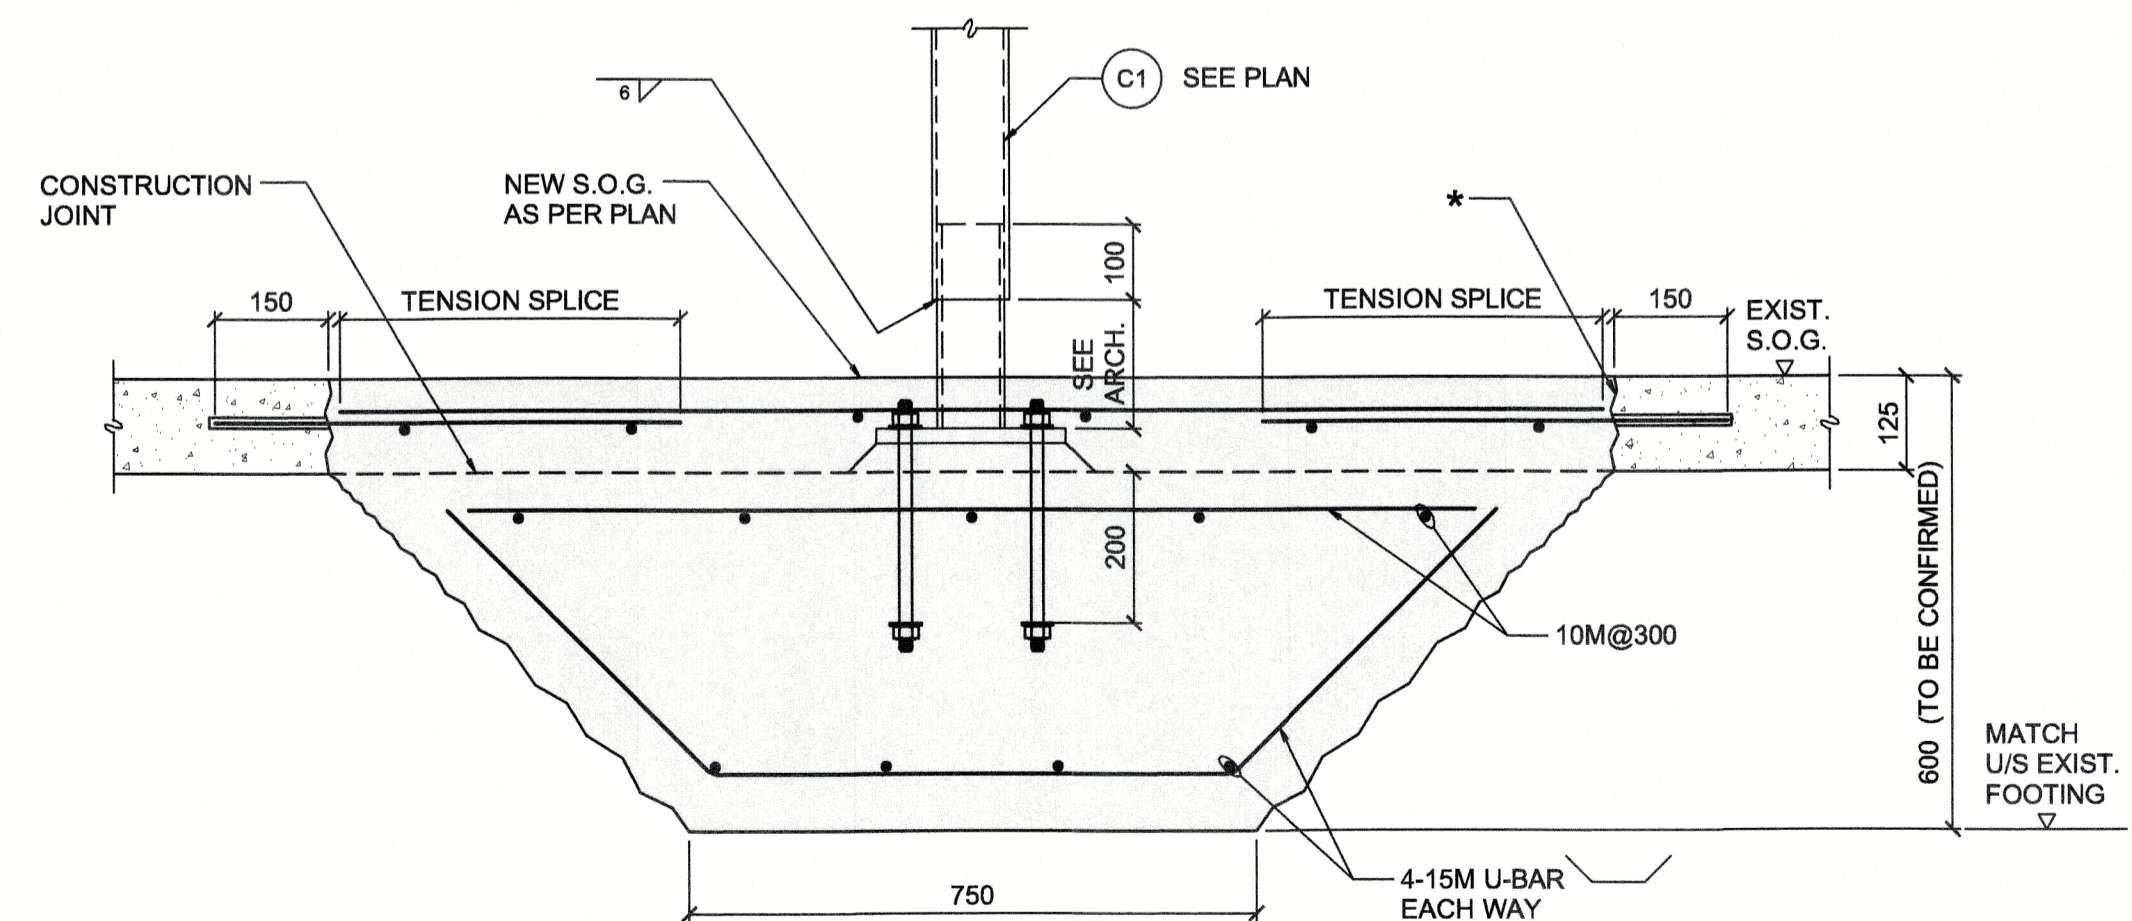

SECTION 3
1:10
GEOTECH TO CONFIRM BEARING CONDITIONS AND BACKFILL

Revision/Revisions	Description/Description	Date/Date
0	ISSUED FOR TENDER	2018/06/12

FISHERIES & OCEANS CANADA
200-401 BURRARD STREET VANCOUVER, BC V6C 3R2


Project title/Titre du projet
4160 MARINE DRIVE WEST VANCOUVER, BC V7V 1H2
PSEC CLASSROOM ADDITION & RENOVATION

Consultant Signature Only
Designed by/Concept par DM
Drawn by/Dessiné par CAD / APRIL 2018
PWGSC Project Manager/Administrateur de Projets TP5GC
Regional Manager, Architectural and Engineering Services
Gestionnaire régionale, Services d'architecture et de génie, TP5GC
Drawing title/Titre du dessin
PARTIAL MAIN FLOOR & FOUNDATION PLAN AND SECTIONS


Project No./No. du projet PK90237
Sheet/Feuille S201
Revision no./La Révision no. 0
OF XX

12797



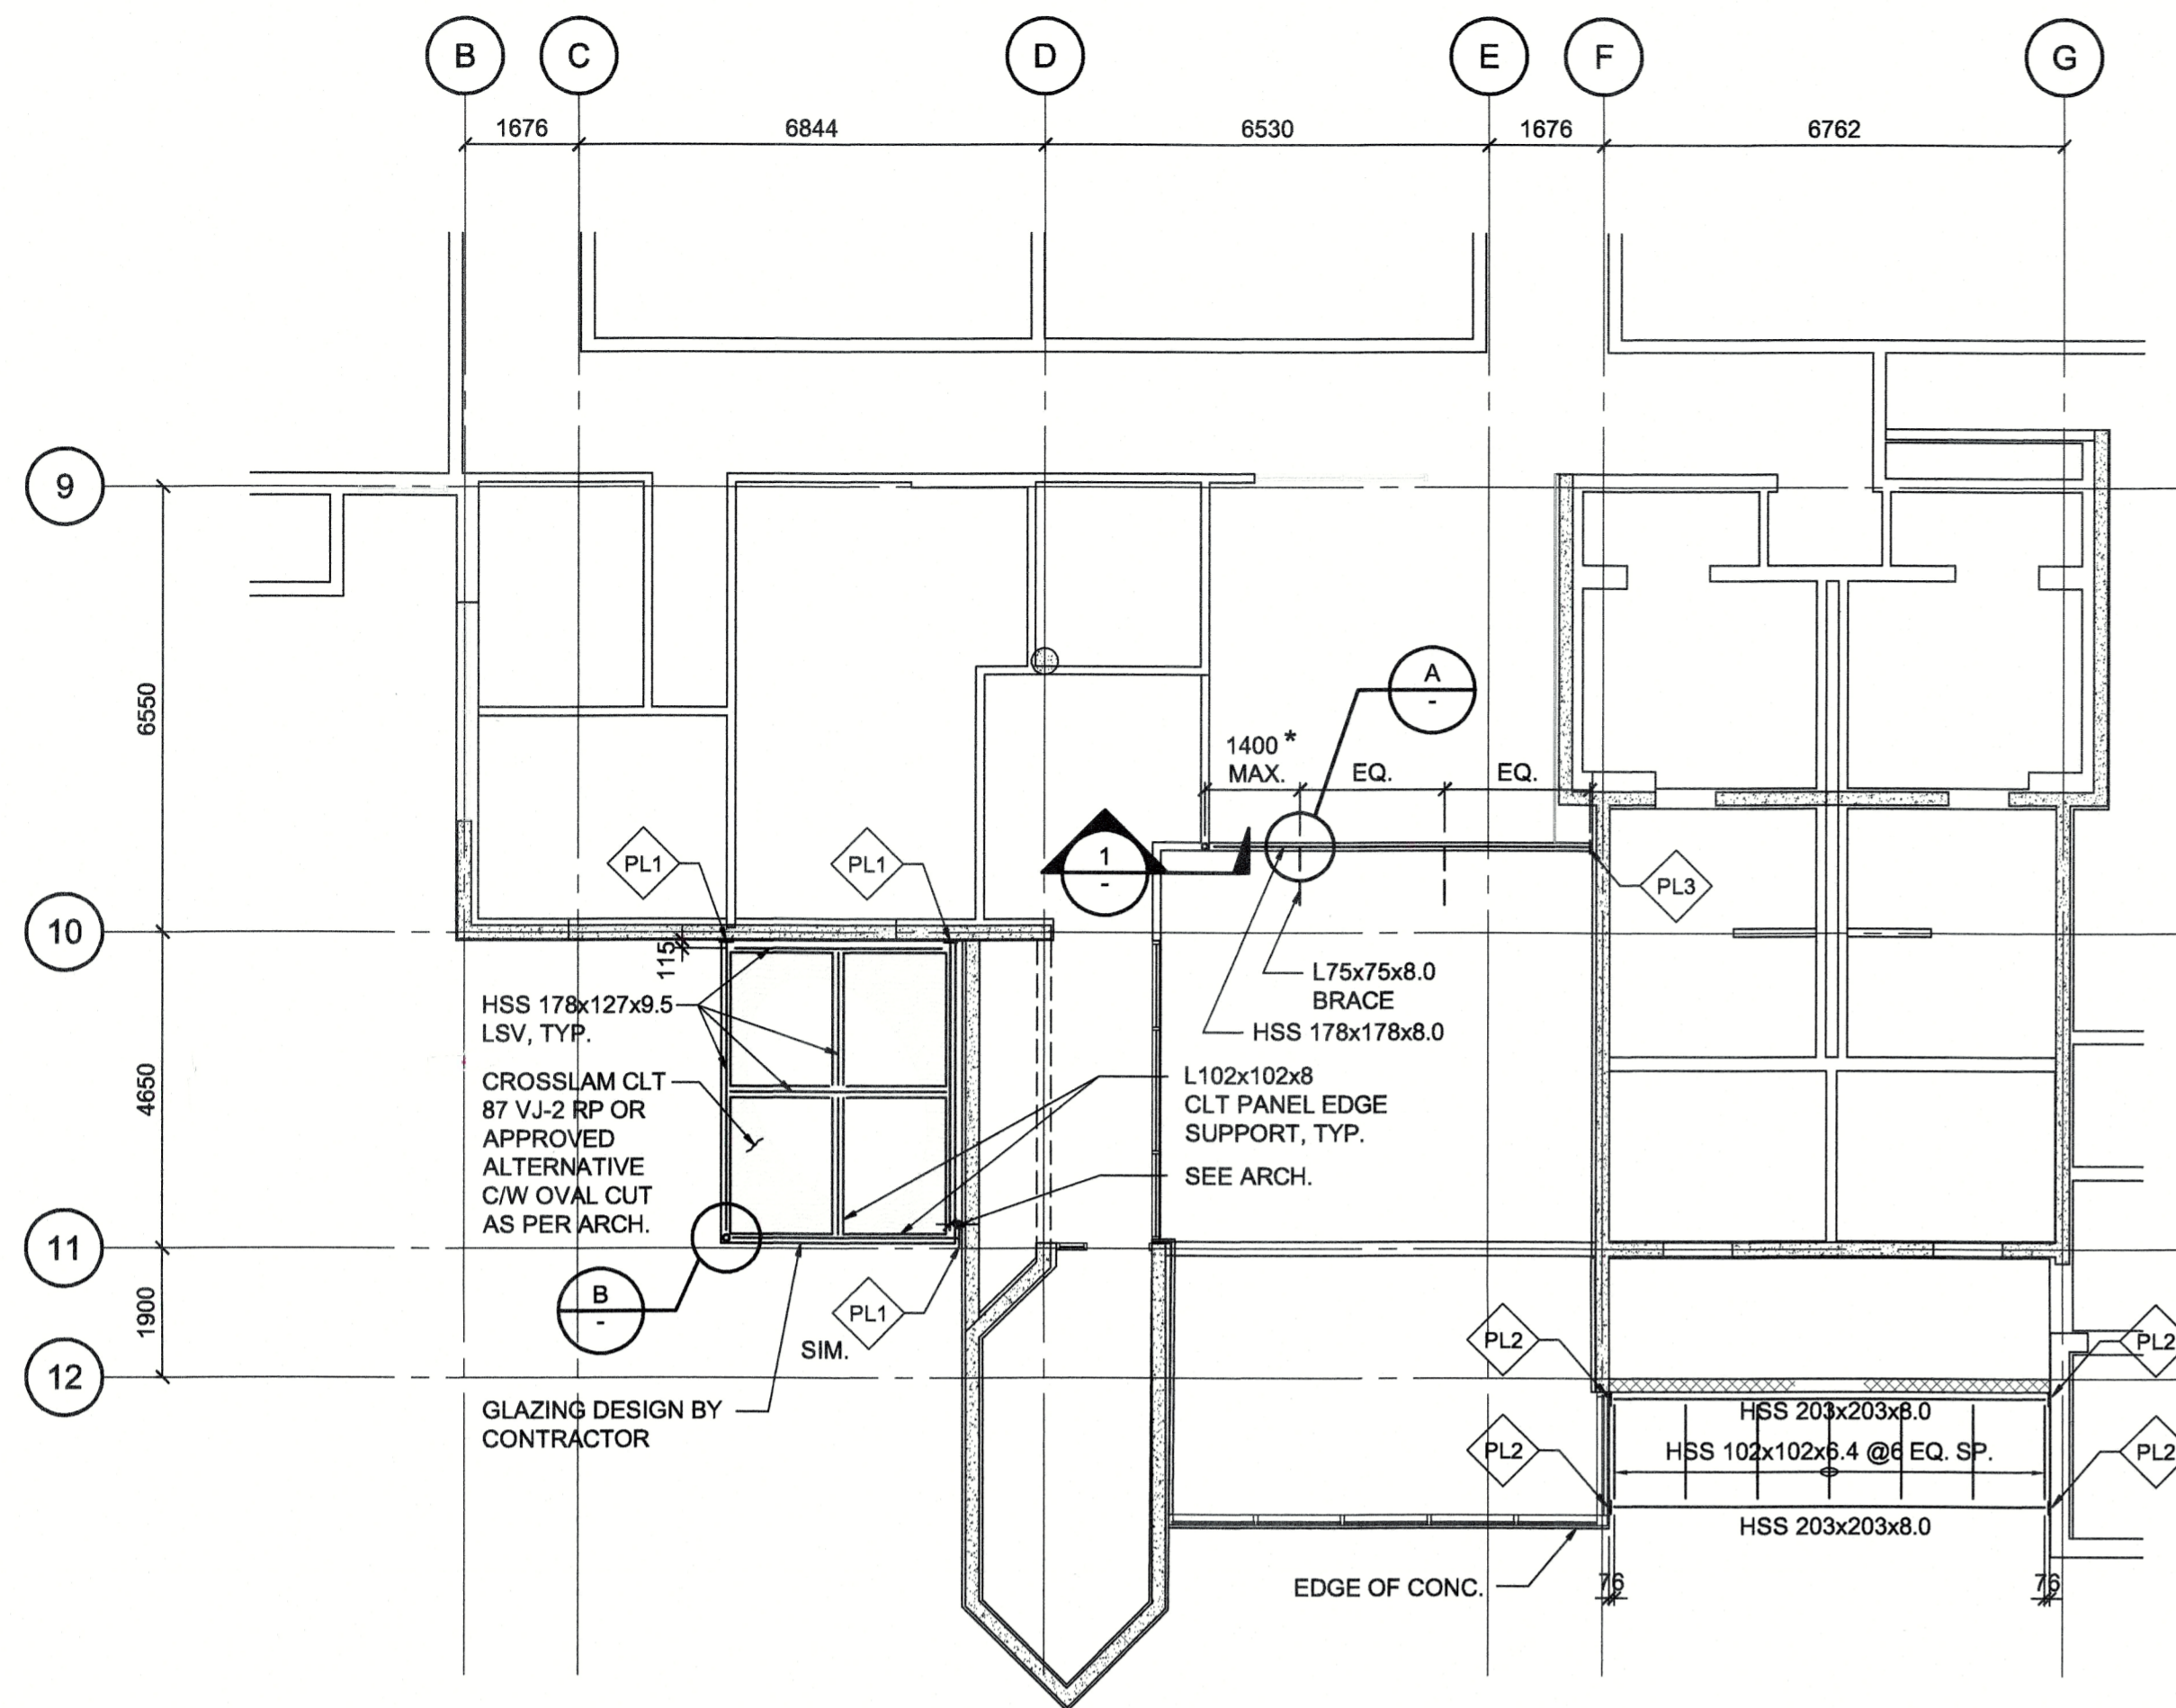

PARTIAL ROOF PLAN
1:100

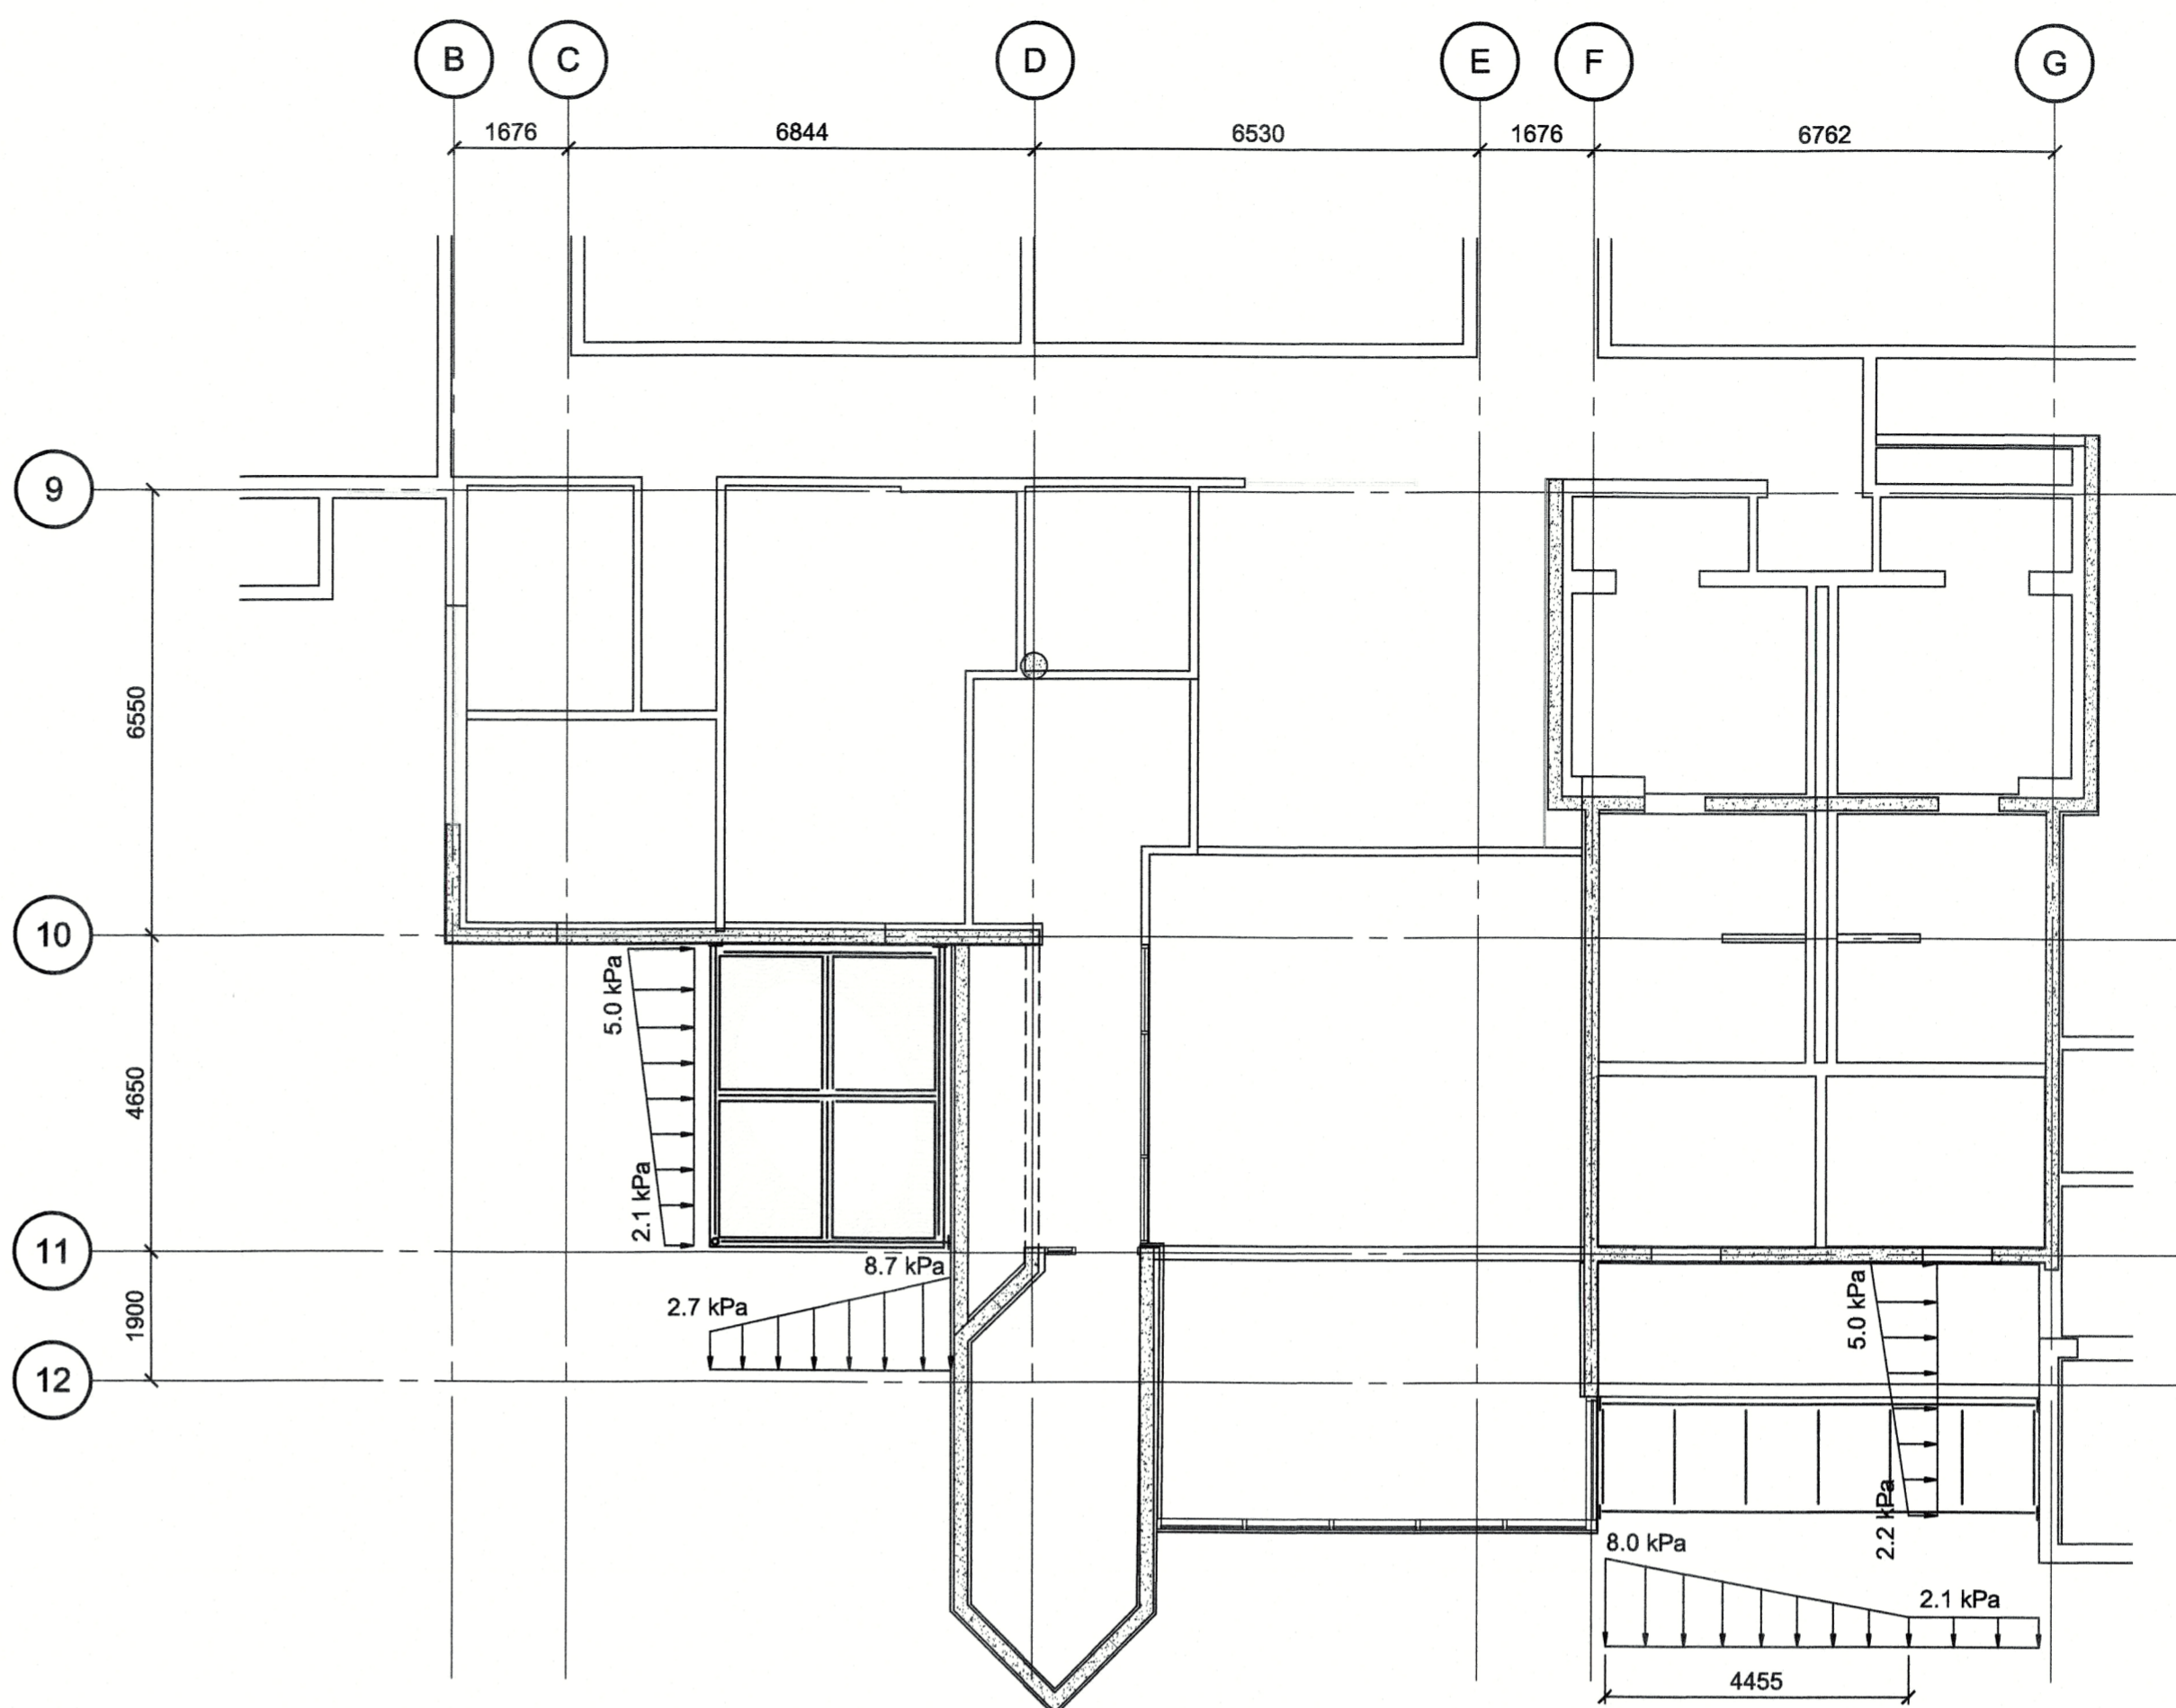


ROOF SNOW LOAD DIAGRAM
1:100


LEGEND:

- DENOTES NEW CONNECTION PLATE SEE DETAILS ON THIS DWG.
- DENOTES NEW CMU WALL BELOW


* FIELD LOCATE BRACE BETWEEN EXIST. DUCTS. NOTIFY DEPARTEMETAL REPRESENTATIVE IF DIMENSION GREATER THAN 1400

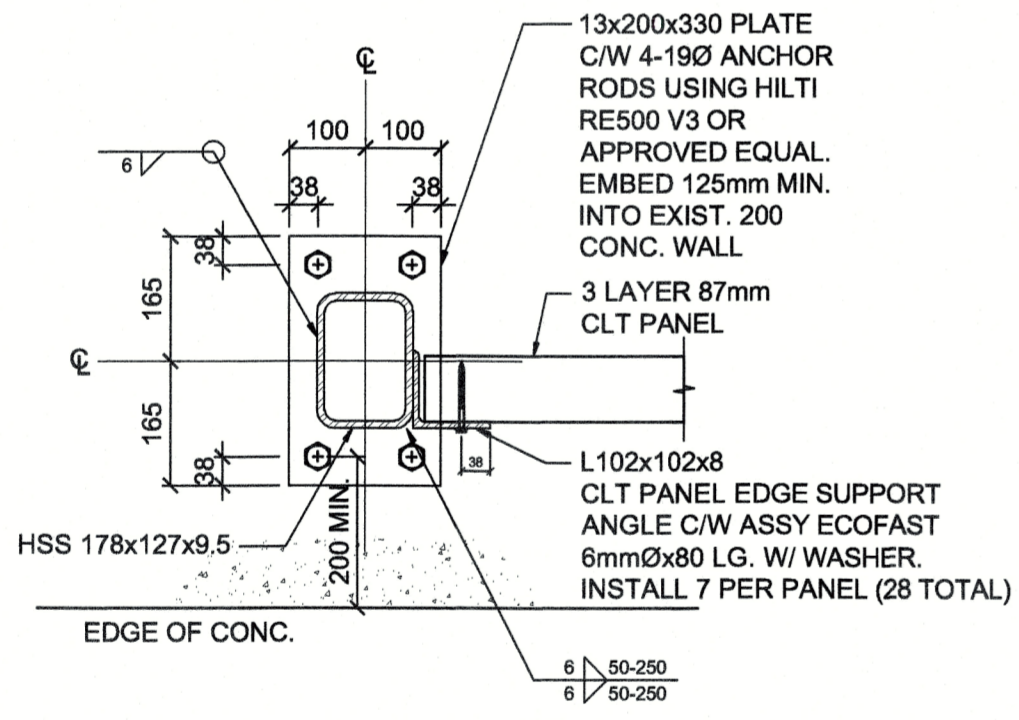


CONNECTION PLATE DETAIL FOR PL1
1:10

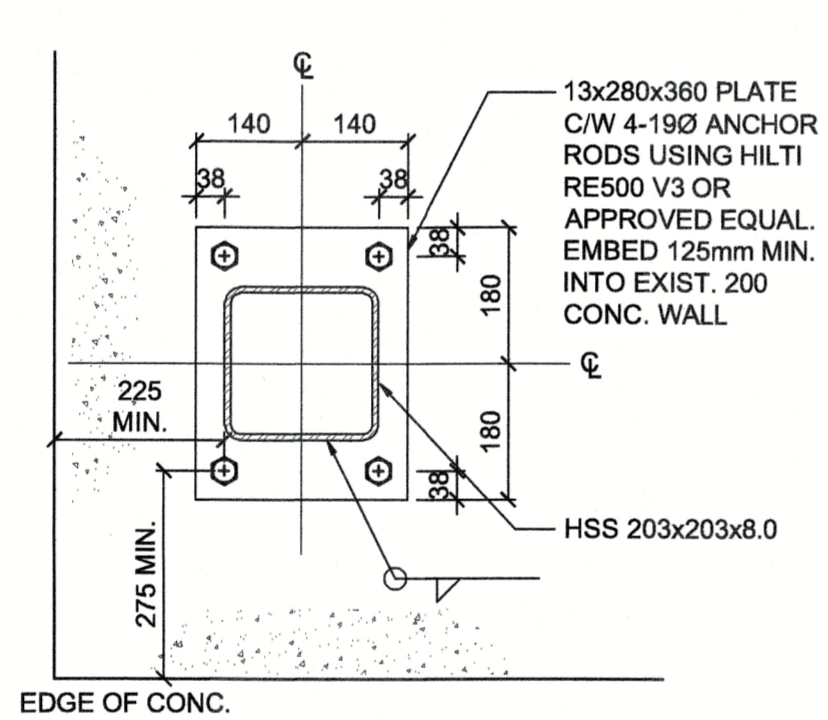


CONNECTION PLATE DETAIL FOR PL2
1:10

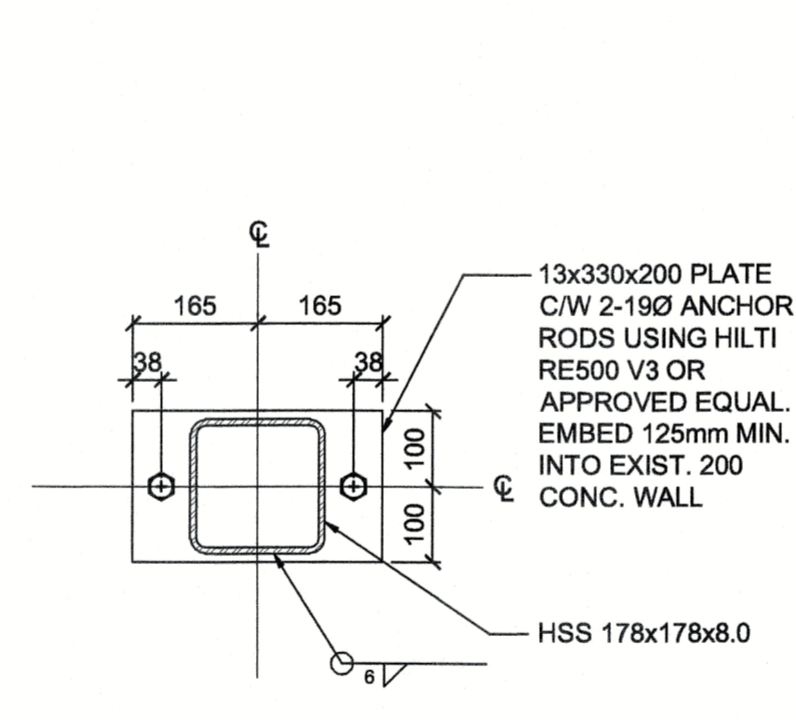


CONNECTION PLATE DETAIL FOR PL3
1:10

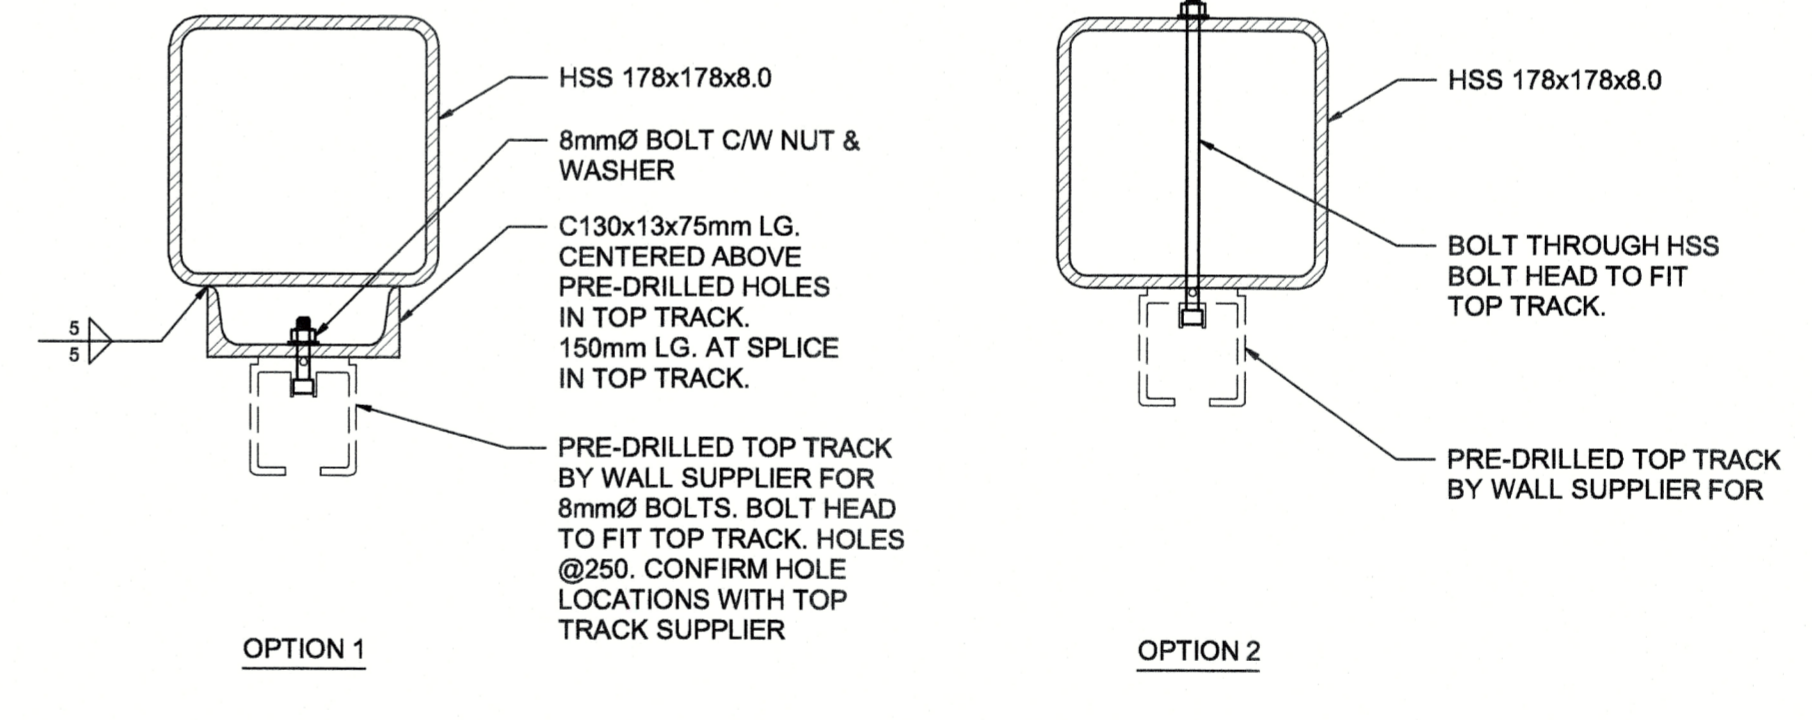


TYPICAL TOP TRACK CONNECTION TO HSS BEAM
1:5

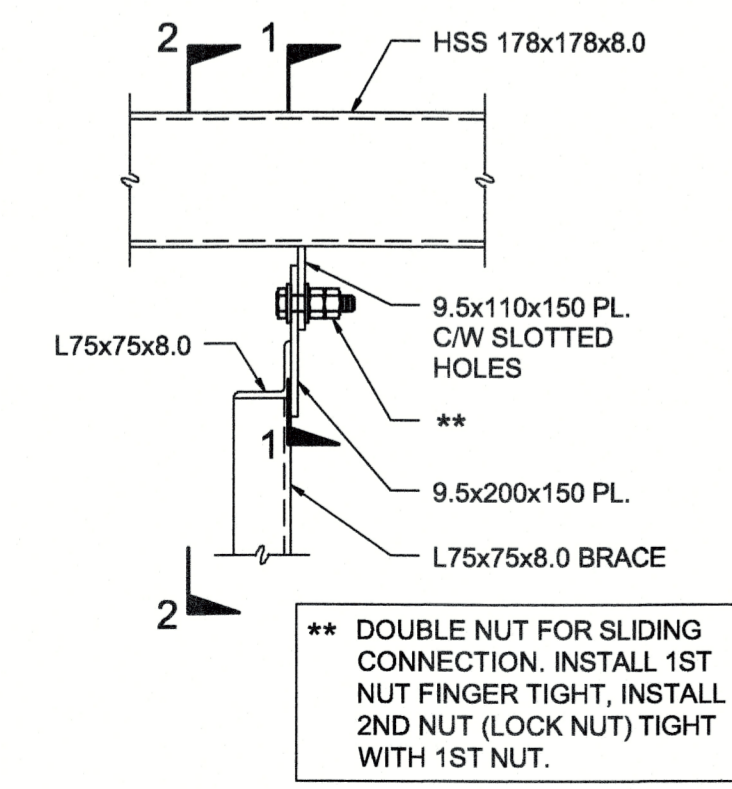


DETAIL A
1:10

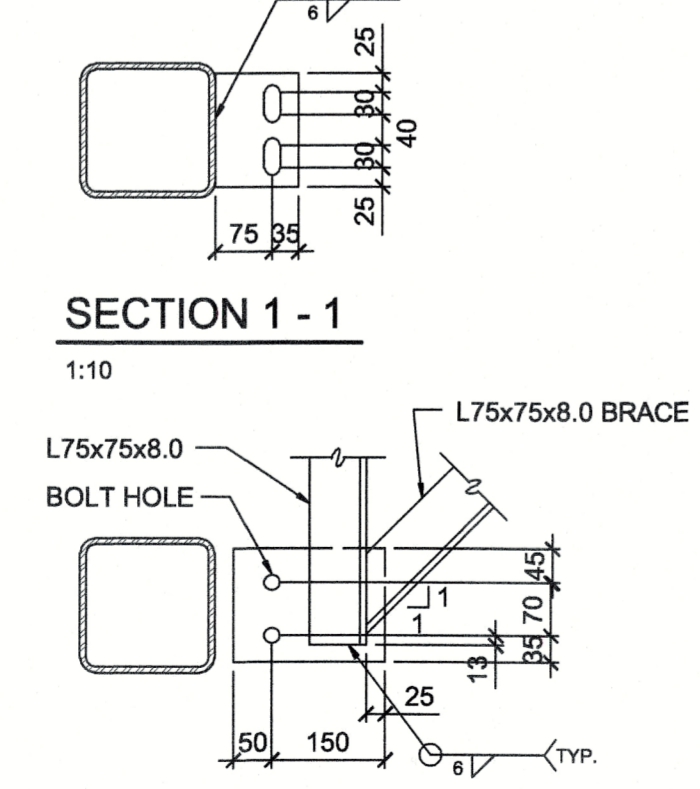


SECTION 1 - 1
1:10

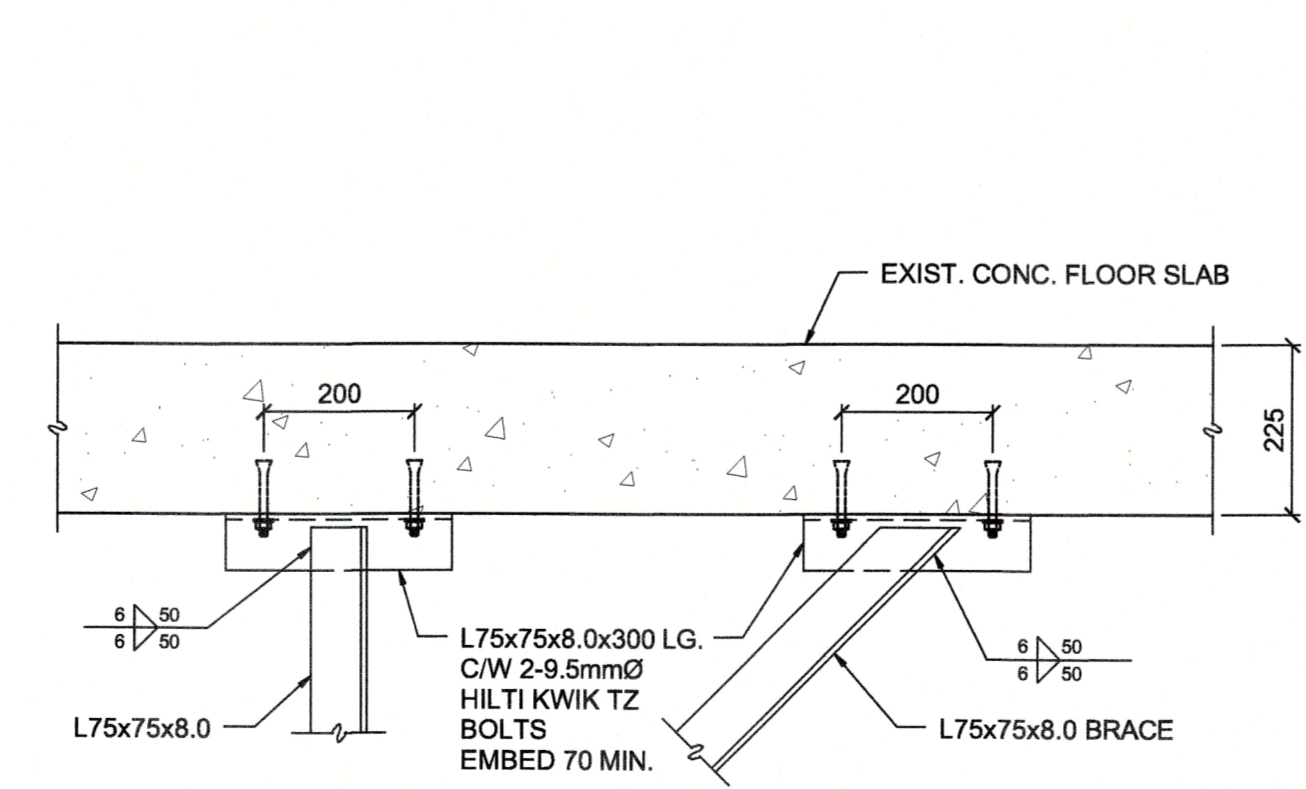


TYPICAL TOP CONNECTION DETAIL FOR BRACES
1:10

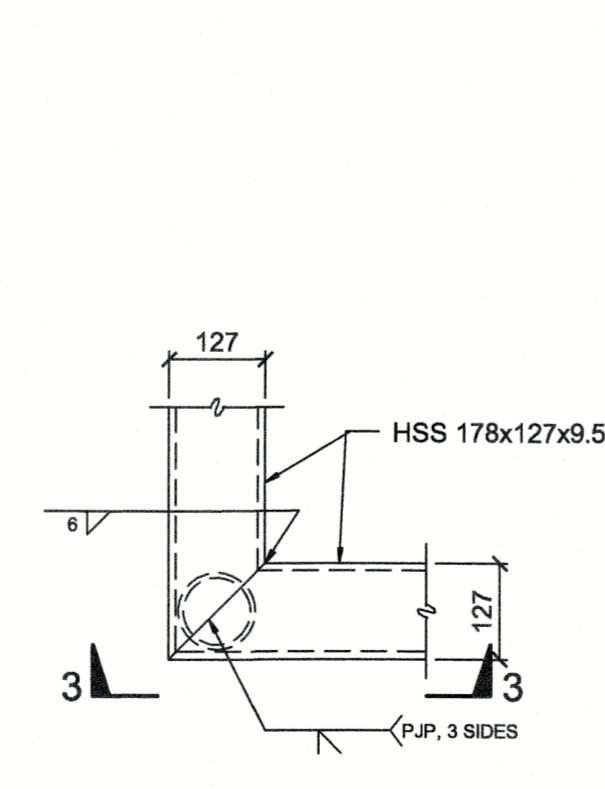

DETAIL B
1:10

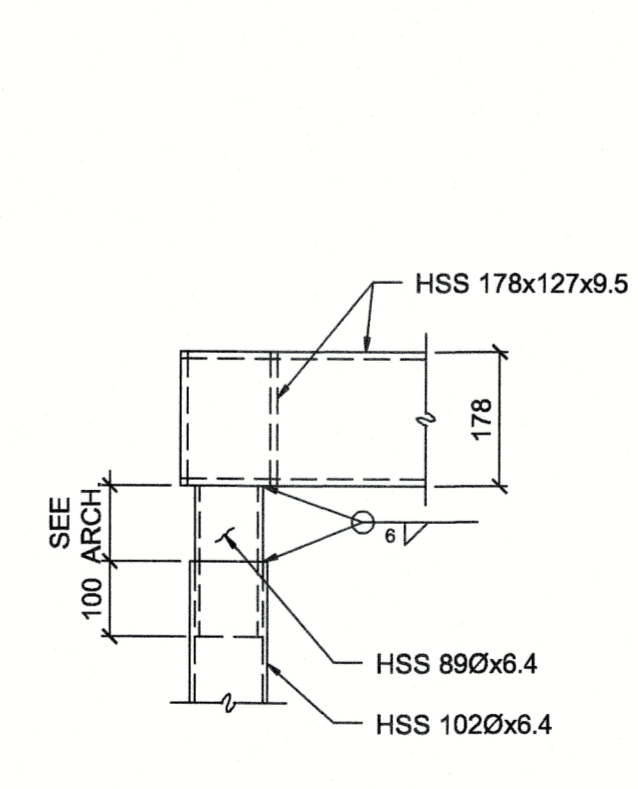

SECTION 3 - 3
1:10

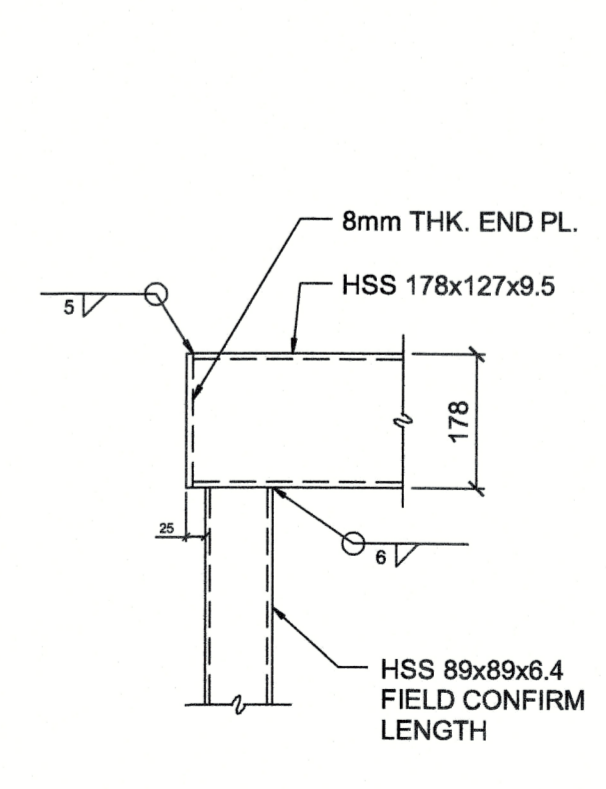

SECTION 1
1:10

5		
4		
3		
2		
1		2018/06/12
0	ISSUED FOR TENDER	2018/06/12

FISHERIES & OCEANS CANADA
 200-401 BURRARD STREET
 VANCOUVER, BC V6C 3R2

Project title/Titre du projet
**4160 MARINE DRIVE
 WEST VANCOUVER, BC V7V 1H2**
**PSEC CLASSROOM
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Consultant Signature Only
 Designed by/Concept par
 DM
 Drawn by/Designé par
 CAD / APRIL 2018
 PWGSC Project Manager/Administrateur de Projets TPSSC
 Regional Manager, Architectural and Engineering Services
 Gestionnaire régionale, Services d'architecture et de génie, TPSSC

Drawing title/Titre du dessin
**PARTIAL SECOND FLOOR PLAN
 AND SECTIONS**

Project No./No. du projet PK90237	Sheet/Feuille S202 OF XX	Revision no./La Révision no. 0
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