

NOTES:

1. DIMENSIONS IN MILLIMETRES / ELEVATIONS IN METRES UNLESS NOTED OTHERWISE.
2. BEDROCK PROFILE AND INFILL CONCRETE BASED ON EXISTING BACKGROUND DRAWINGS. (SEE REFERENCES ON C000)
3. RESTORATION OF DEMOLISHED RETAINING WALL SECTION TO MATCH ORIGINAL DIMENSIONS AND ELEVATIONS.

PRELIMINARY

NOT TO BE USED FOR CONSTRUCTION

No.	Description	Dwn By Des Par	Date
D	RE-ISSUED FOR TENDER	PJZ	18/08/27
C	ISSUED FOR TENDER	PJZ	18/07/31
B	ISSUED FOR 99% REVIEW	PJZ	18/07/05
A	ISSUED FOR 66% REVIEW	KJC	18/05/09

Revision / Révision

A	A Detail number No. du détail
B	B Location dwg. no. No. sur dessin

Project title / Titre du projet

TRENT-SEVERN WATERWAY
DAM AT LOCK 38
REPLACEMENT

Drawing title / Titre du dessin

CONCRETE DAM
SECTIONS

Drawn by / Dessiné par	Designed by / Conçu par
KJC	WSM

Approved by / Approuvé par	Drawing Date / Date du dessin
SB	MAY 2018


Project manager / Administrateur de projet

DAVE NESS


Contract No. / Numéro du contrat	Drawing No. / Dessine No.
EQ754-162649	S003

Project No. / Numéro du projet
R.076951.906


Sheet
Feuille 1 of 1

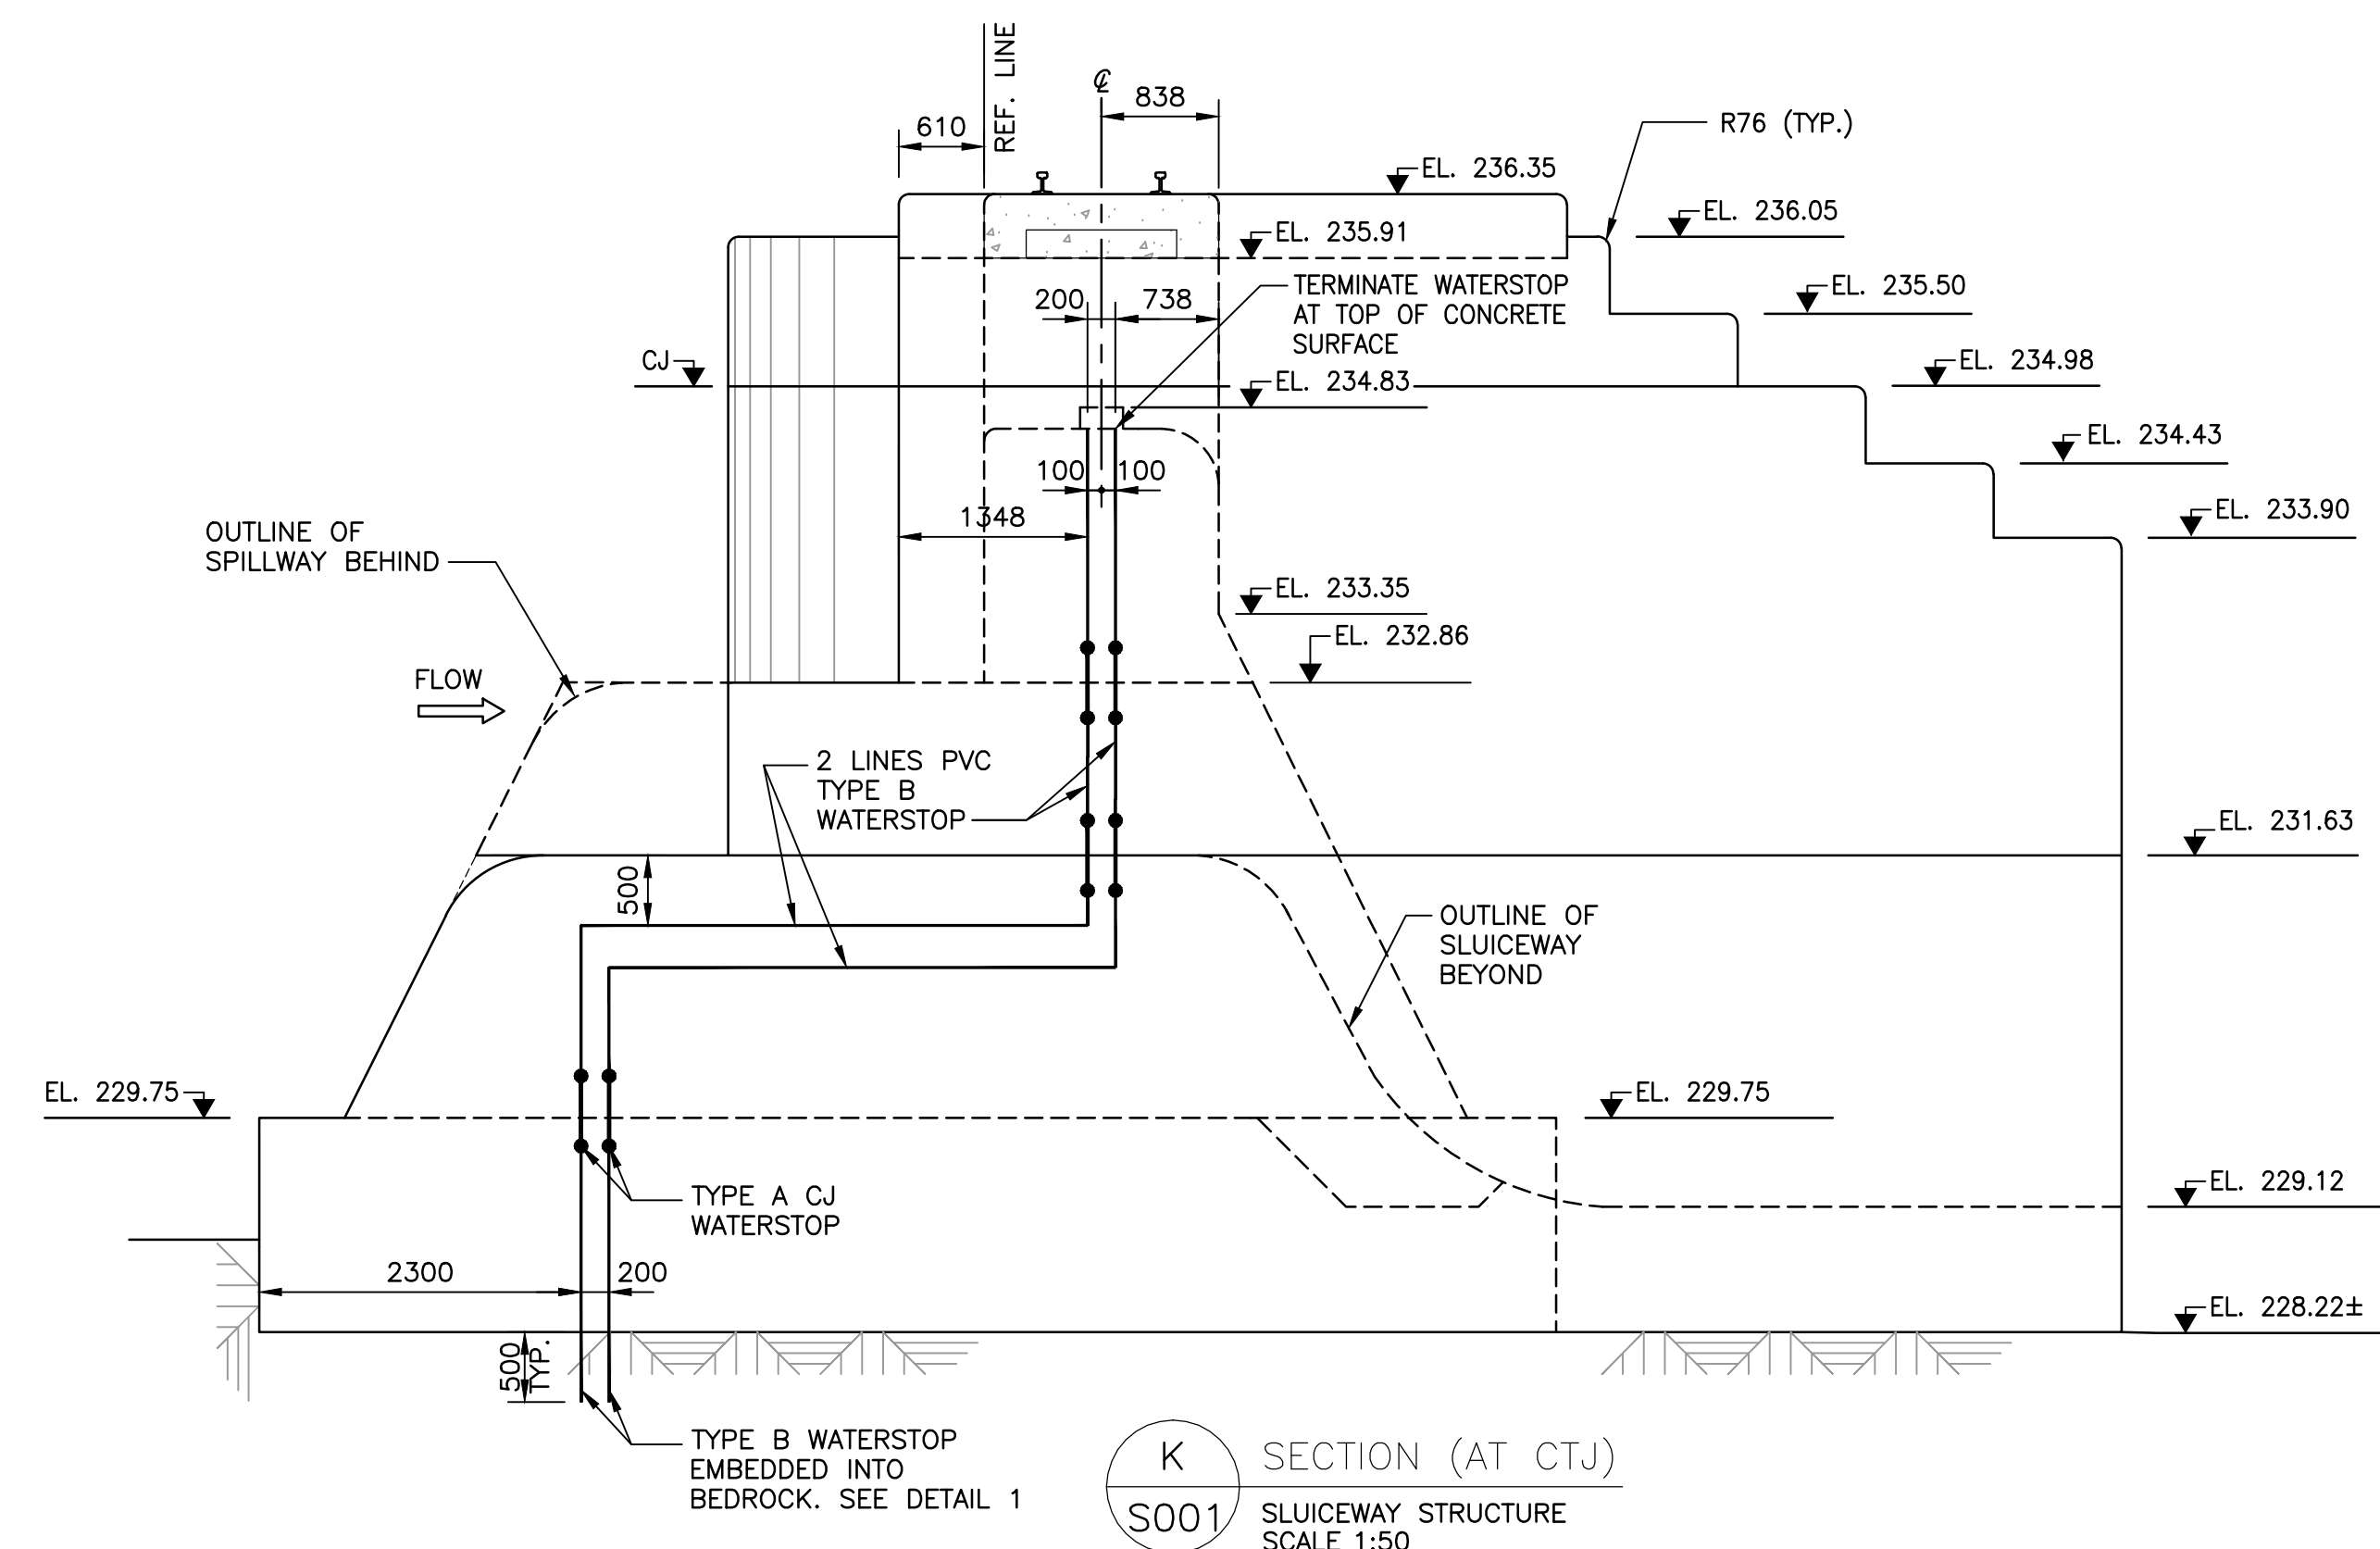


K SECTION (AT CTJ)
S001 SLUICWAY STRUCTURE
SCALE 1:50

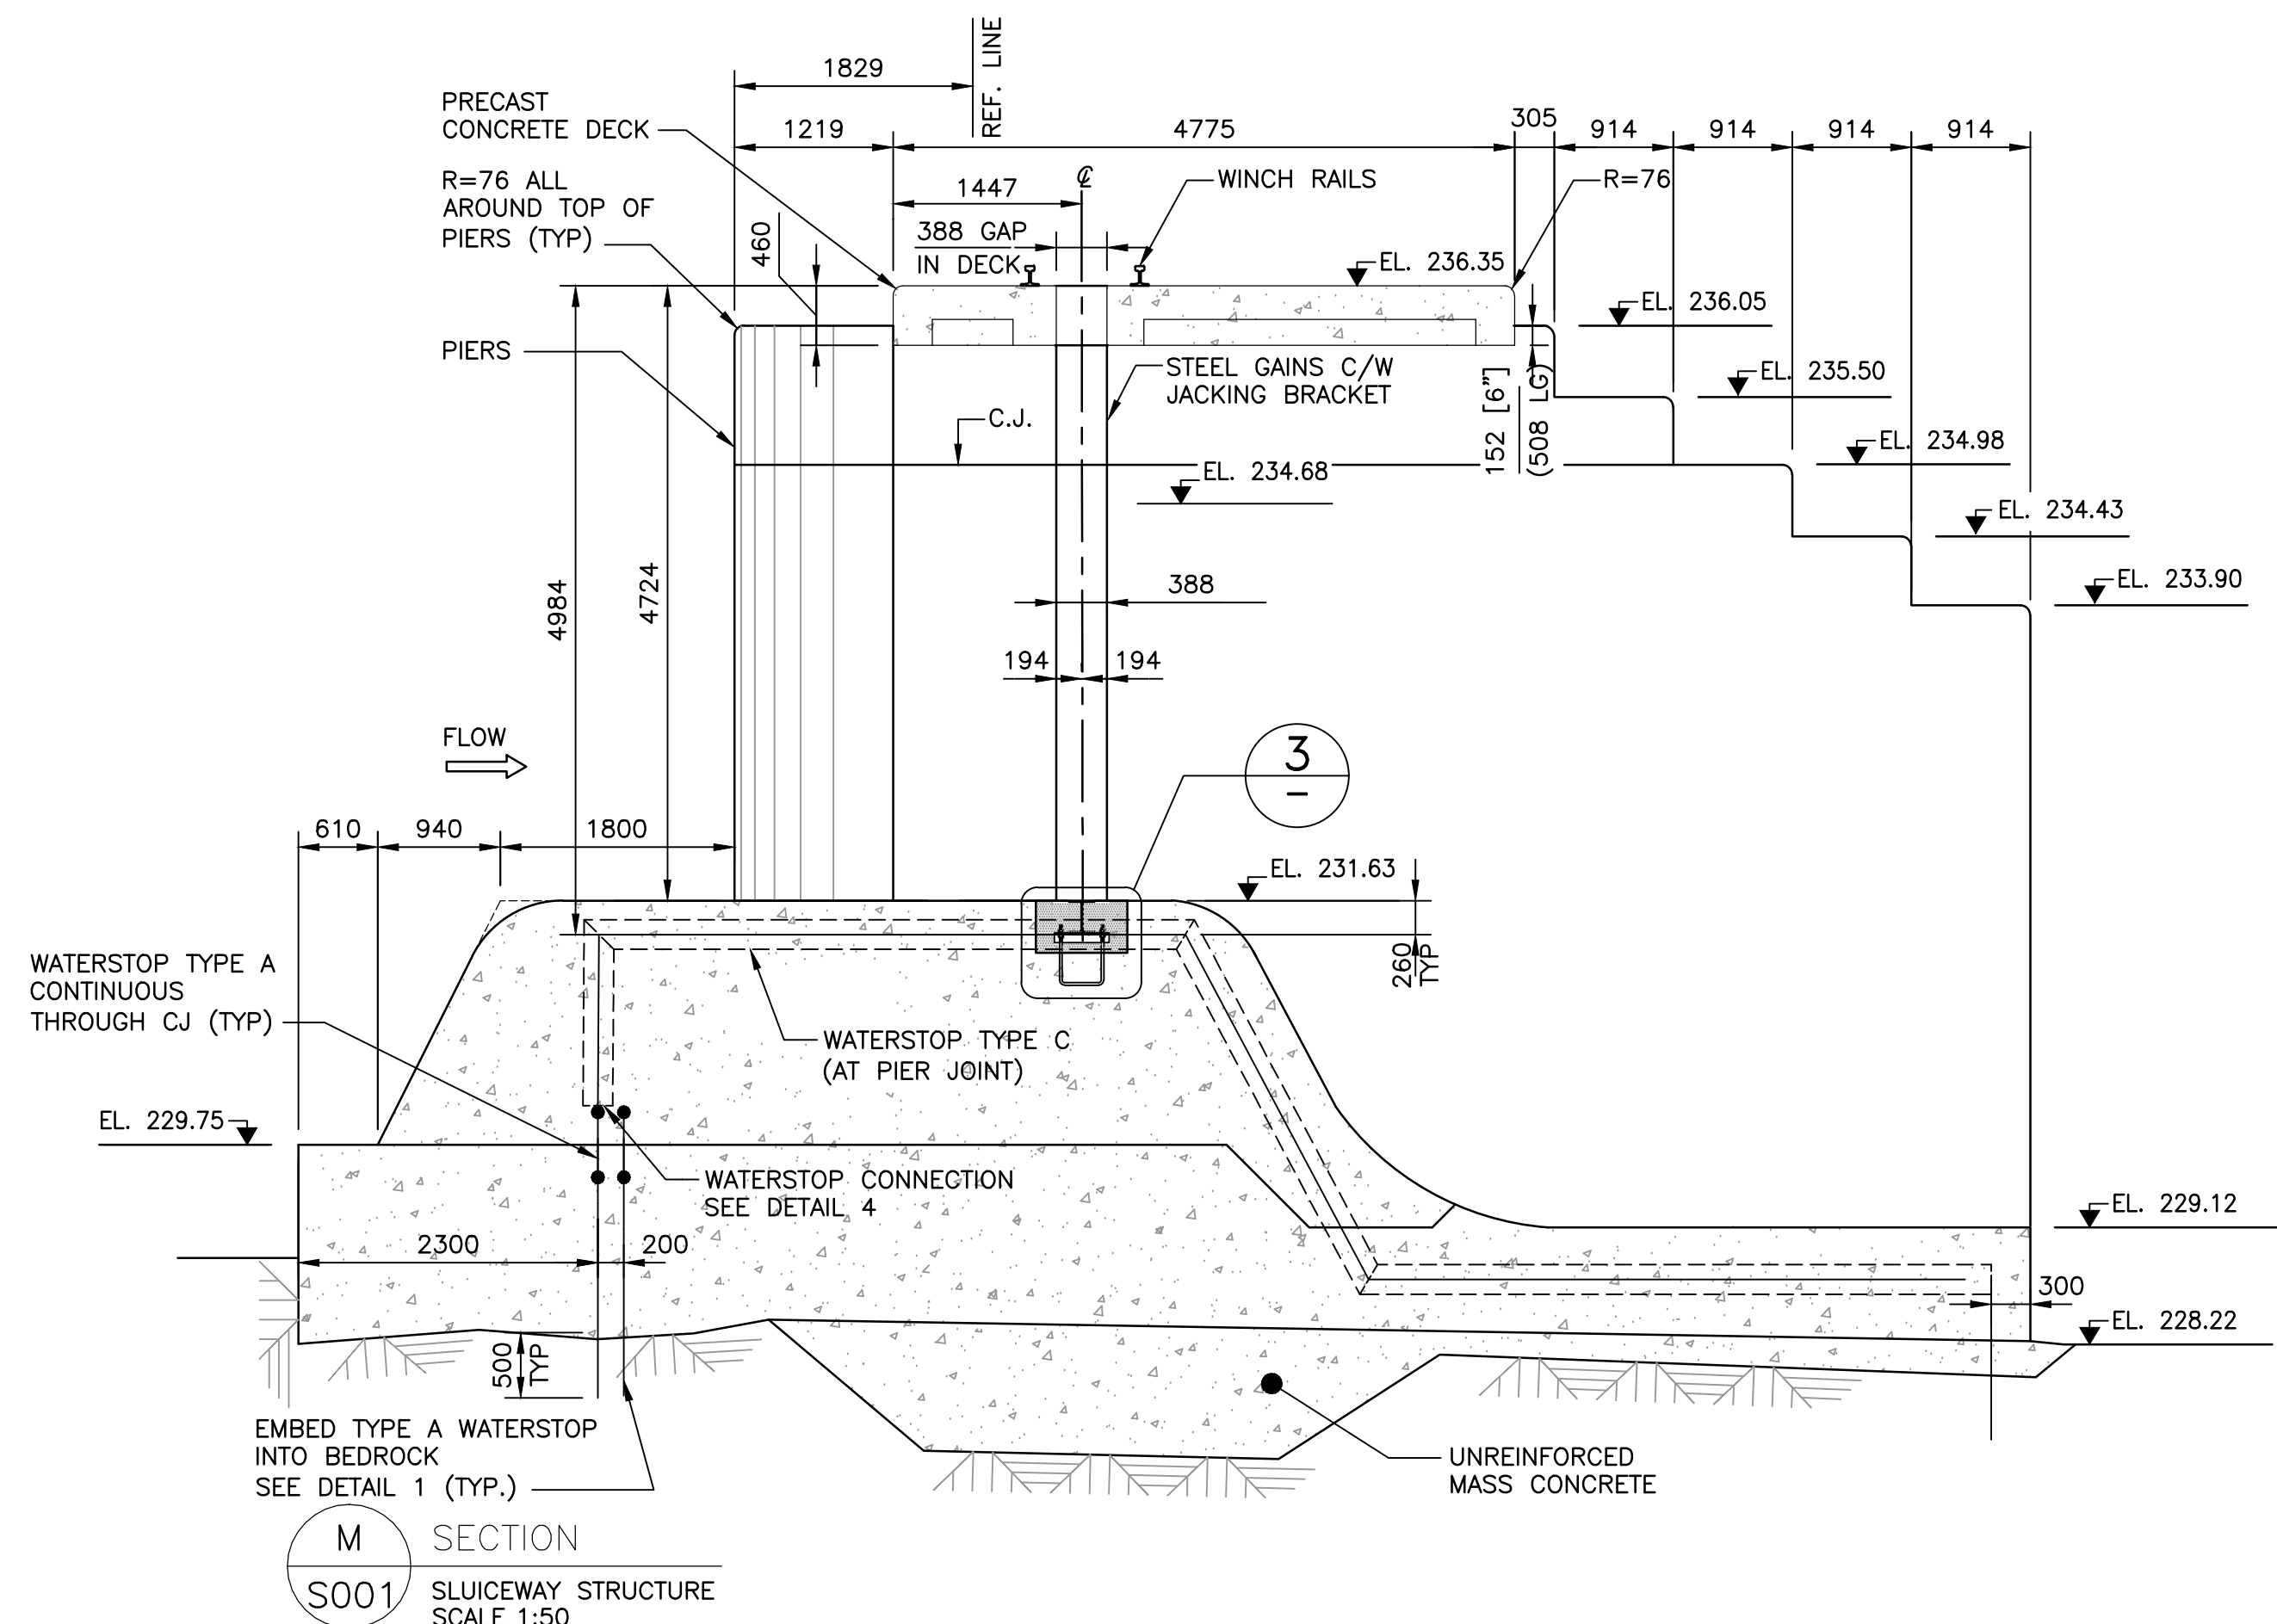


M SECTION
S001 SLUICWAY STRUCTURE
SCALE 1:50

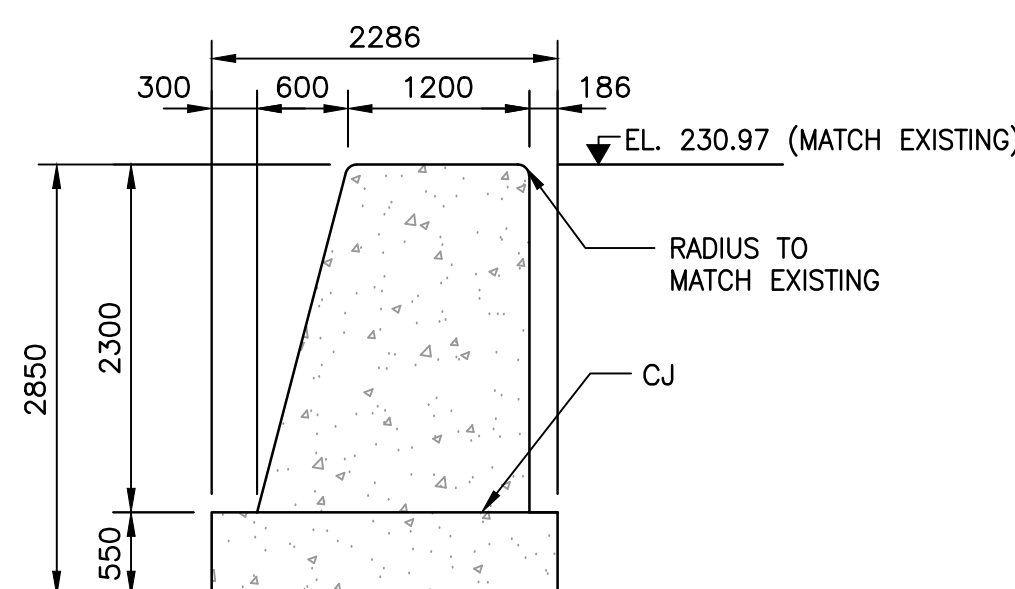


L SECTION
S001 RETAINING WALL
SCALE 1:50

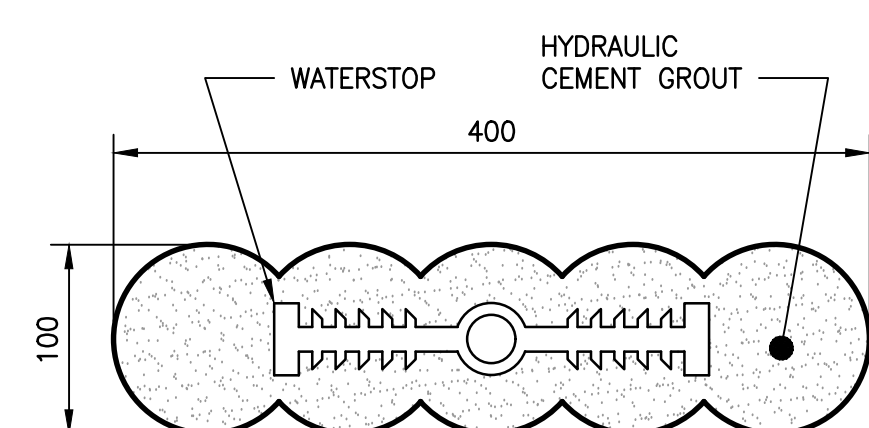


1 DETAIL
— EMBEDDED WATERSTOP
SCALE 1:4

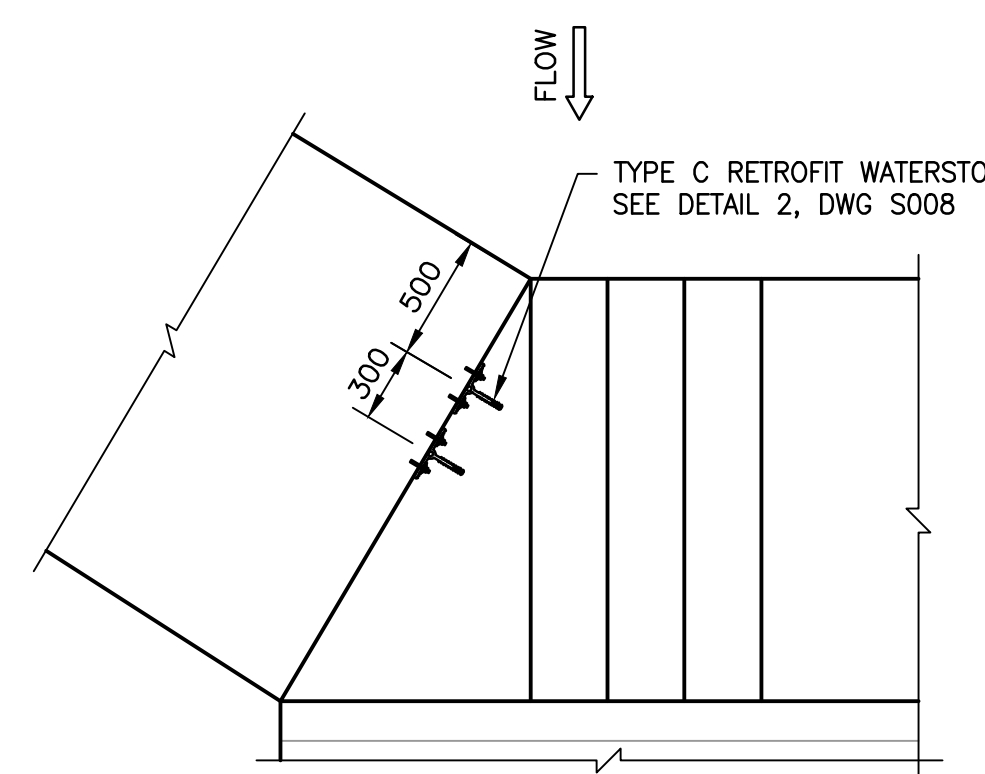


2 DETAIL
S002 SCALE 1:30

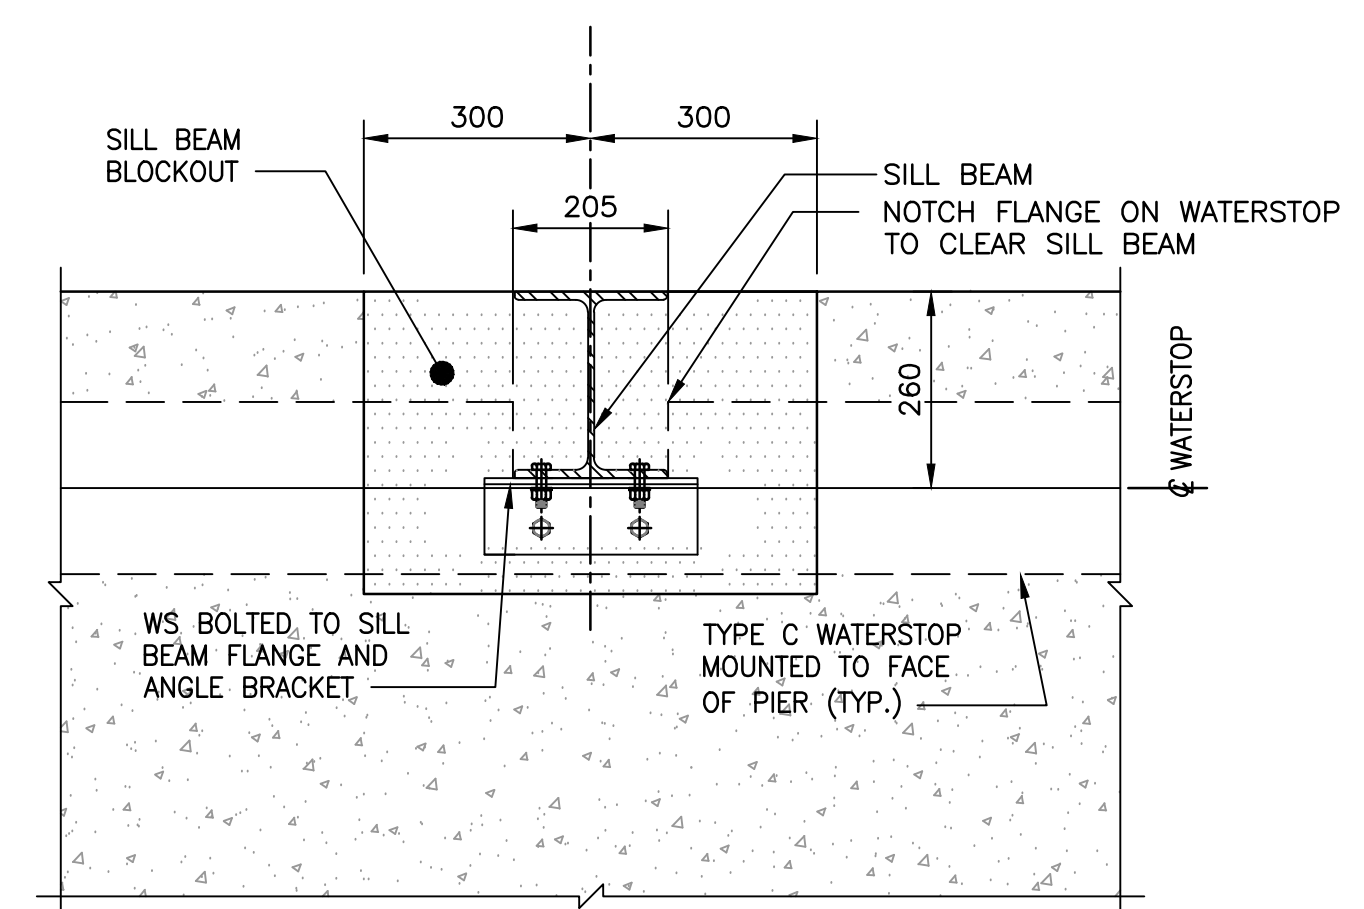

3 DETAIL
— WATERSTOP AT SILL BEAM POCKET
SCALE 1:10

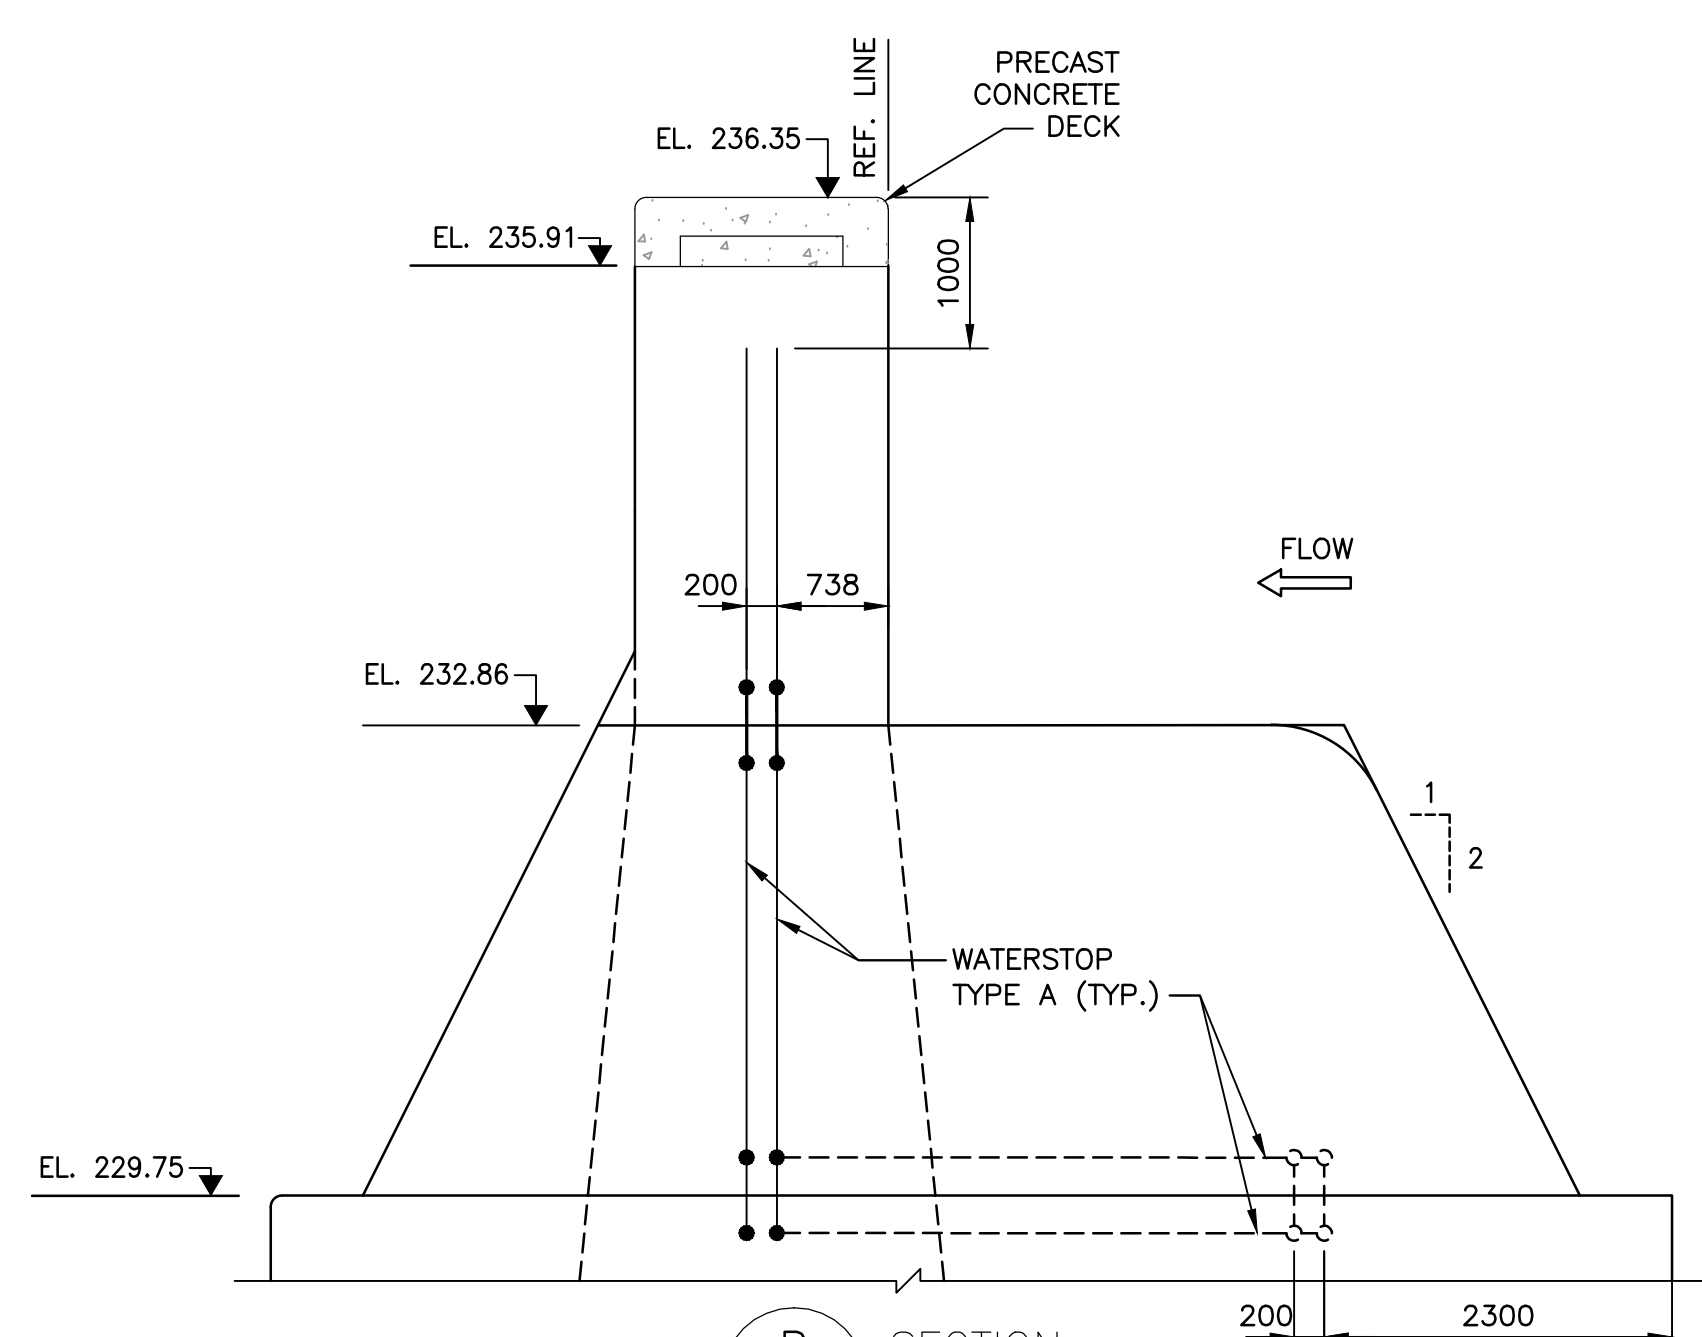

R SECTION
S001 AT CJ
SCALE 1:50

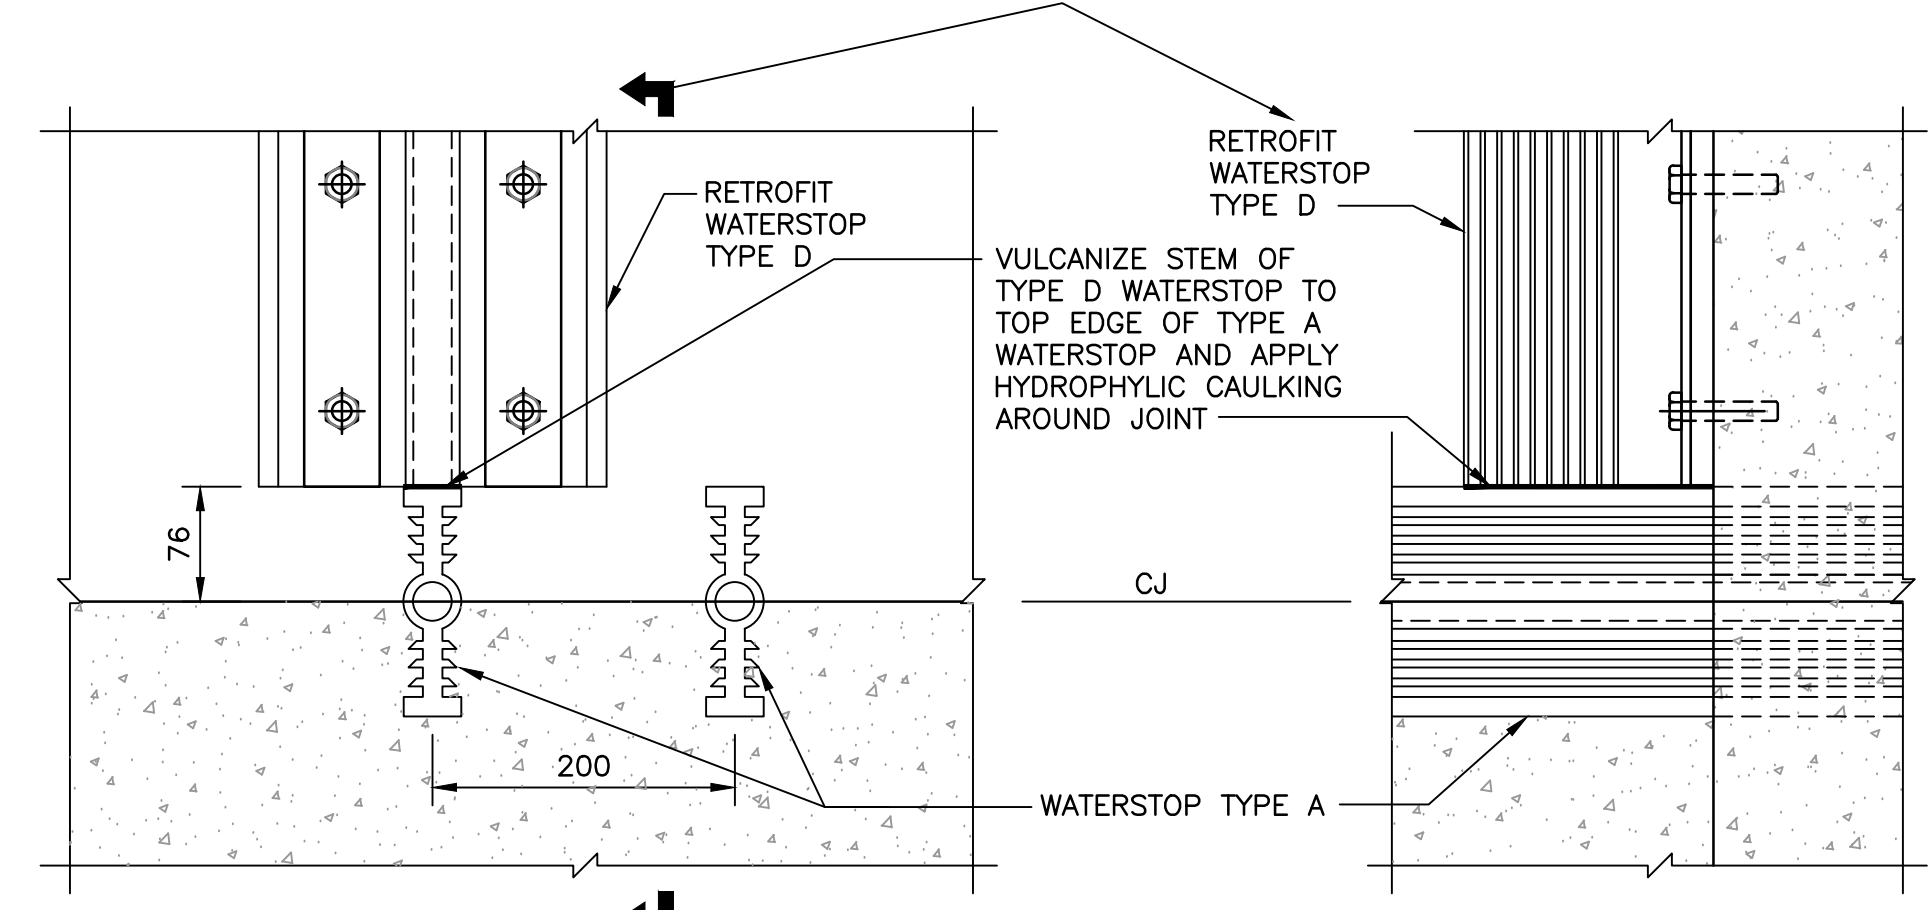

4 DETAIL
— WATERSTOP CONNECTION
SCALE 1:5