

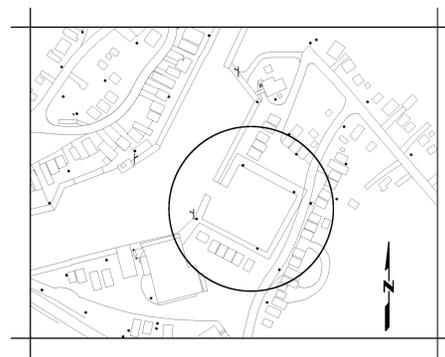
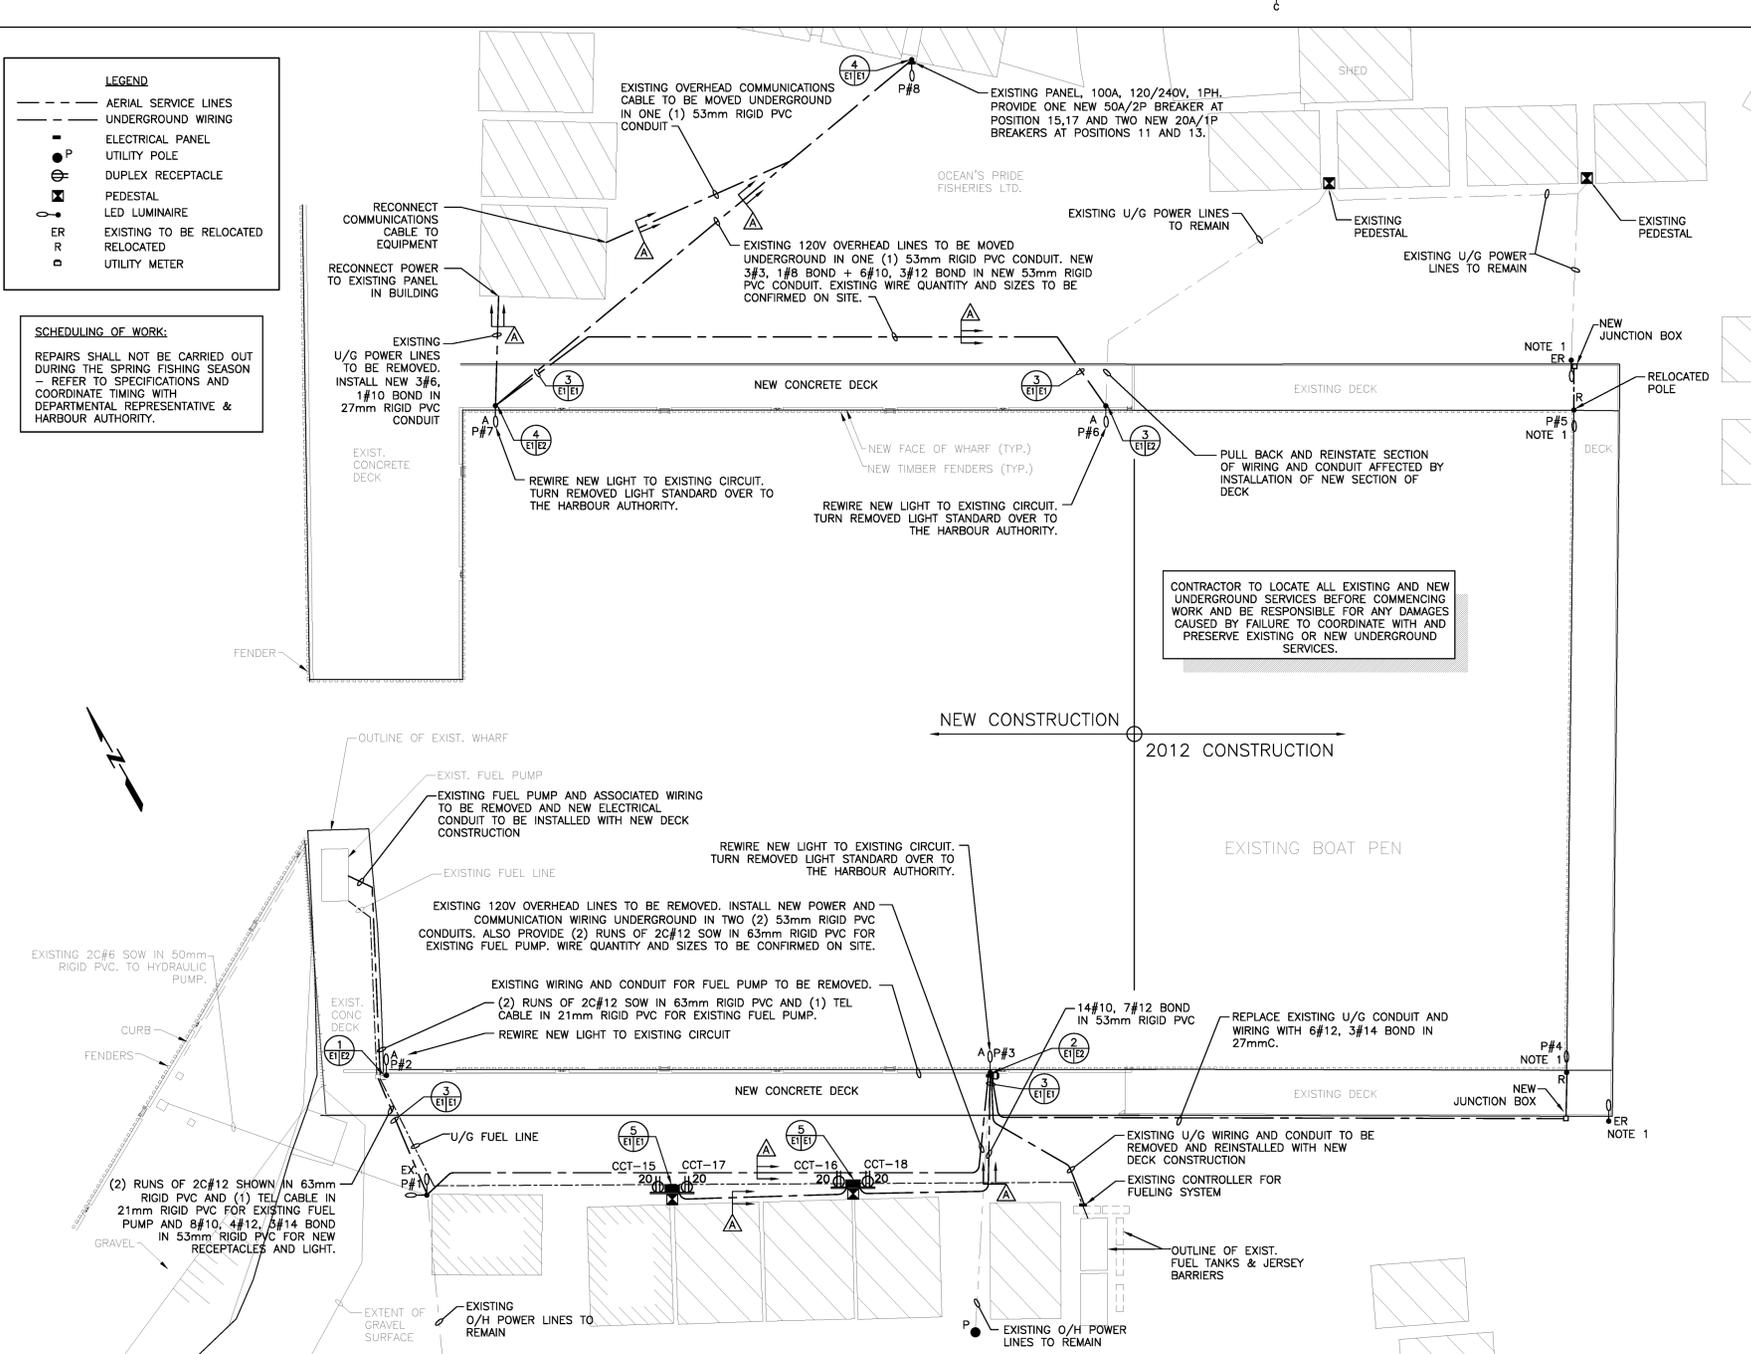



**SCHEDULING OF WORK:**  
 REPAIRS SHALL NOT BE CARRIED OUT DURING THE SPRING FISHING SEASON - REFER TO SPECIFICATIONS AND COORDINATE TIMING WITH DEPARTMENTAL REPRESENTATIVE & HARBOUR AUTHORITY.

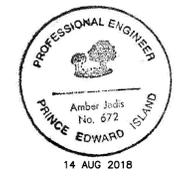



**NOTES:**  
 1. POLE TO BE REMOVED. REMOVE EXISTING LUMINAIRE AND TWO DUPLEX RECEPTACLES AND STORE IN SAFE LOCATION. INSTALL NEW 11m, CLASS 1, TREATED UTILITY POLE DURING THE CONSTRUCTION OF THE NEW DECK. REFER TO DRAWING M7 FOR MOUNTING DETAILS. REINSTALL LUMINAIRE AND RECEPTACLES ON NEW POLE. EXTEND WIRING AS REQUIRED. SPLICE EXISTING WIRING TO NEW WIRING IN NEW UNDERGROUND JUNCTION BOX.

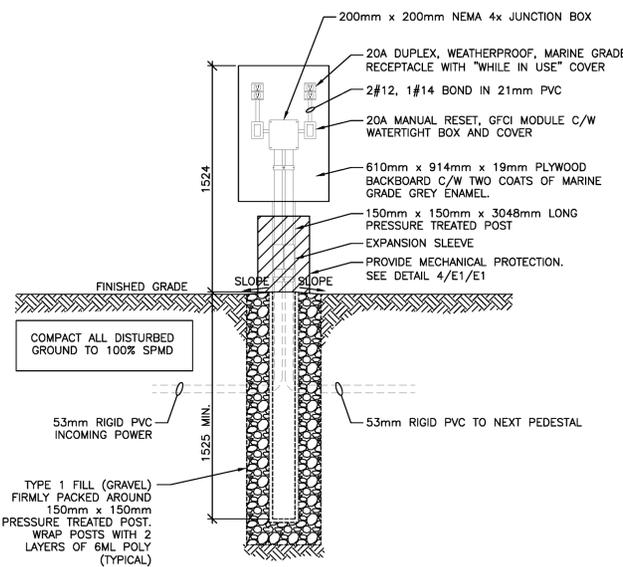

**ELECTRICAL SITE PLAN**  
 SCALE : 1:200

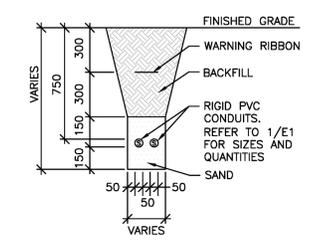

- DETAIL NOTES:**
- S = CONDUIT FOR POWER/COMMUNICATIONS QUANTITY AND SIZE AS INDICATED.
  - BACKFILLING OF TRENCH IN LAYERS NOT EXCEEDING 300mm (MECHANICALLY TAMPED).
  - USE NEW SOIL FREE FROM LARGE ROCKS OR DEBRIS FOR BACKFILL.
  - CONDUIT LOCATED UNDER ASPHALT IN AREAS SUBJECT TO RIGHT OF WAY VEHICULAR TRAFFIC TO BE INSTALLED AN ADDITIONAL 300mm BELOW WARNING RIBBON IN ACCORDANCE WITH CSA 22.1-12 ARTICLE 12-0012.
  - IF SITE CONDITIONS PROHIBIT TRENCH AS PER THIS DRAWING, ADVISE CONSULTANT.
  - CONTRACTOR TO PROVIDE A MINIMUM OF 48 HOURS WRITTEN NOTICE TO UTILITY CONSTRUCTION INSPECTOR PRIOR TO SCHEDULED BACKFILLING OF WORK. BACKFILLING NOT PERMITTED UNTIL APPROVED BY UTILITY.
  - 6mm DIA. NYLON ROPE INSTALLED IN ALL DUCTS.
  - ALL CONDUITS TO BE LABELED WITH WEATHER PROOF TAGS INDICATING THE DESTINATION OF THE CONDUITS.
  - AFTER TRENCHING IS COMPLETE, RETURN FINISHED GRADE TO SAME CONDITION OR BETTER.

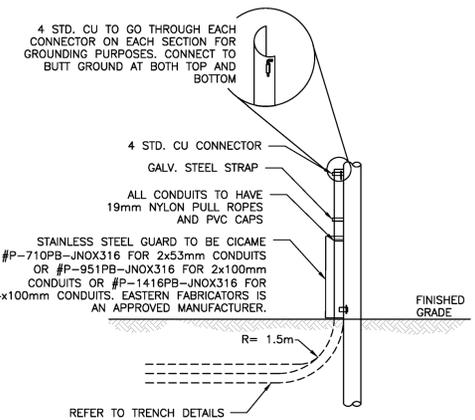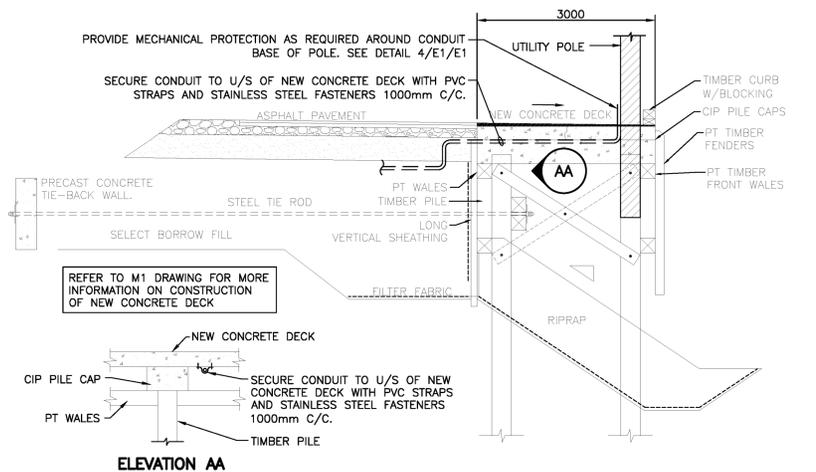

- DETAIL NOTES:**
- ALL MATERIALS TO BE PROVIDED BY THE CONTRACTOR.
  - CONTRACTOR TO PROVIDE A MINIMUM OF 24 HOURS WRITTEN NOTICE TO UTILITY CONSTRUCTION INSPECTOR FOR THE WORK AT POLE P#3 PRIOR TO SCHEDULED BACKFILLING OF WORKS. BACKFILLING NOT PERMITTED UNTIL APPROVED BY UTILITY.
  - LOCATION OF DUCTS AT BASE OF POLE TO BE SPECIFIED BY UTILITY.
  - KEEP CONDUITS 152mm APART ON POLE.
  - OVERLAP CABLE GUARD 50mm.
  - CONDUIT SHALL BE EFFECTIVELY SEALED TO PREVENT THE ENTRANCE OF WATER.
  - RIGID PVC SWEEPS ARE TO HAVE A RADIUS OF 1.5m AND TO BE USED ON THE USABLE AND THE SPARE CONDUITS.

0	ISSUED FOR TENDER	08/14 2018
revisions		date

project **RECONSTRUCTION BOAT PEN 414A & 414B NORTH LAKE HARBOUR KING'S CO. PEI** project

drawing **ELECTRICAL SITE PLAN & DETAILS** design

designed A.D.J., P.ENG	congru
date Aug. 2018	
drown M.E.M., C.E.T. A.E.M	designé
date Aug. 2018	
approved AUG	approuvé
date Aug. 2018	Soumission
Tender PWGSC Project Manager	Administrateur de projets TPSCG
project number	no. du projet
<b>R.094623.001</b>	
drawing no.	no. du dessin
<b>E1 OF 2</b>	