

GENERAL NOTES:


1. CONTRACTOR TO ASSESS WORK AREA IN ADVANCE WITH OWNER REPRESENTATIVE FOR COORDINATION OF RELATED DAILY WORK SCHEDULES, PARKING, BUILDING ACCESS, AND STORAGE OF EQUIPMENT.
2. ALL WORK TO BE IN ACCORDANCE WITH THE LATEST REQUIREMENTS OF: THE NATIONAL BUILDING CODE OF CANADA, LATEST EDITION; CANADIAN ELECTRICAL CODE, CURRENT EDITION; ANY OTHER AUTHORITIES HAVING JURISDICTION.
3. WORK SHALL BE SCHEDULED DURING NORMAL WORKING HOURS CONTRACTOR MAY WORK AFTER NORMAL WORKING HOURS AS COORDINATED BY OWNER REPRESENTATIVE.
4. CONTRACTOR SHALL BE RESPONSIBLE FOR CLEAN UP AND DISPOSALS OF WORK AREA ON A DAILY BASIS. AFTER EACH WORKING SHIFT BUILDING TO BE CLEANED AND FREE OF DEBRIS. BUILDING GARBAGE BINS ARE NOT TO BE USED.
5. ANY ELECTRICAL SYSTEM SHUTDOWN TO BE SCHEDULED AFTER NORMAL BUSINESS HOURS AND SHALL BE COORDINATED WITH OWNER REPRESENTATIVE. SUFFICIENT NOTICE SHALL BE GIVEN. 5 WORKING DAYS NOTICE IS REQUIRED FOR ANY DISRUPTION.
6. WORK TO BE CARRIED OUT IN CONSIDERATION OF CLIENT COMFORT AND OPERATIONS.
7. ALL WIRING TO BE INSTALLED IN CONDUIT AS INDICATED.
8. ACCESS TO FACILITY TO BE COORDINATED WITH OWNER REPRESENTATIVE.
9. LABEL ALL EQUIPMENT WITH LAMACOID TAGS ACCORDING TO PWGSC STANDARDS.
10. ALL EXISTING ELECTRICAL EQUIPMENT REMOVED TO BE TURNED OVER TO OWNER. IF OWNER REFUSES THEN CONTRACTOR TO REMOVE FROM SITE AND DISPOSE.

ELECTRICAL LEGEND

- ELECTRICAL PEDESTAL TO BE REMOVED. REMOVE WIRING AND CONDUIT BACK TO SOURCE. SEE PANEL SCHEDULE ON DRAWING E4 FOR WORKSCOPE OF ASSOCIATED CIRCUIT BREAKERS. SEE PEDESTAL NOTE 1 ON THIS DRAWING.
- LIGHT POLE TO REMAIN FOR REUSE IN NEW LAYOUT. EXISTING LIGHTING FIXTURES AND 15 AMP 120 VOLT RECEPTACLES (2 SUCH) TO BE REMOVED. REMOVE ALL ASSOCIATED WIRING AND CONDUIT BACK TO SOURCE. SEE PANEL SCHEDULE ON DRAWING E4 FOR WORKSCOPE OF ASSOCIATED CIRCUIT BREAKERS. SEE LIGHT POLE NOTE 1 ON THIS DRAWING.

- PEDESTAL NOTES:**
1. EXISTING PEDESTAL TO BE REMOVED. REMOVE ALL ASSOCIATED WIRING AND CONDUIT BACK TO SOURCE. SEE PANEL SCHEDULE ON DRAWING E4 FOR WORKSCOPE OF ASSOCIATED CIRCUIT BREAKERS.

- LIGHT POLE NOTES:**
1. EXISTING LIGHT POLE. EXISTING LIGHTING FIXTURES AND 15 AMP 120 VOLT RECEPTACLES (2 SUCH) TO BE REMOVED. REMOVE ALL ASSOCIATED WIRING AND CONDUIT BACK TO SOURCE. SEE PANEL SCHEDULE ON DRAWING E4 FOR WORKSCOPE OF ASSOCIATED CIRCUIT BREAKERS.

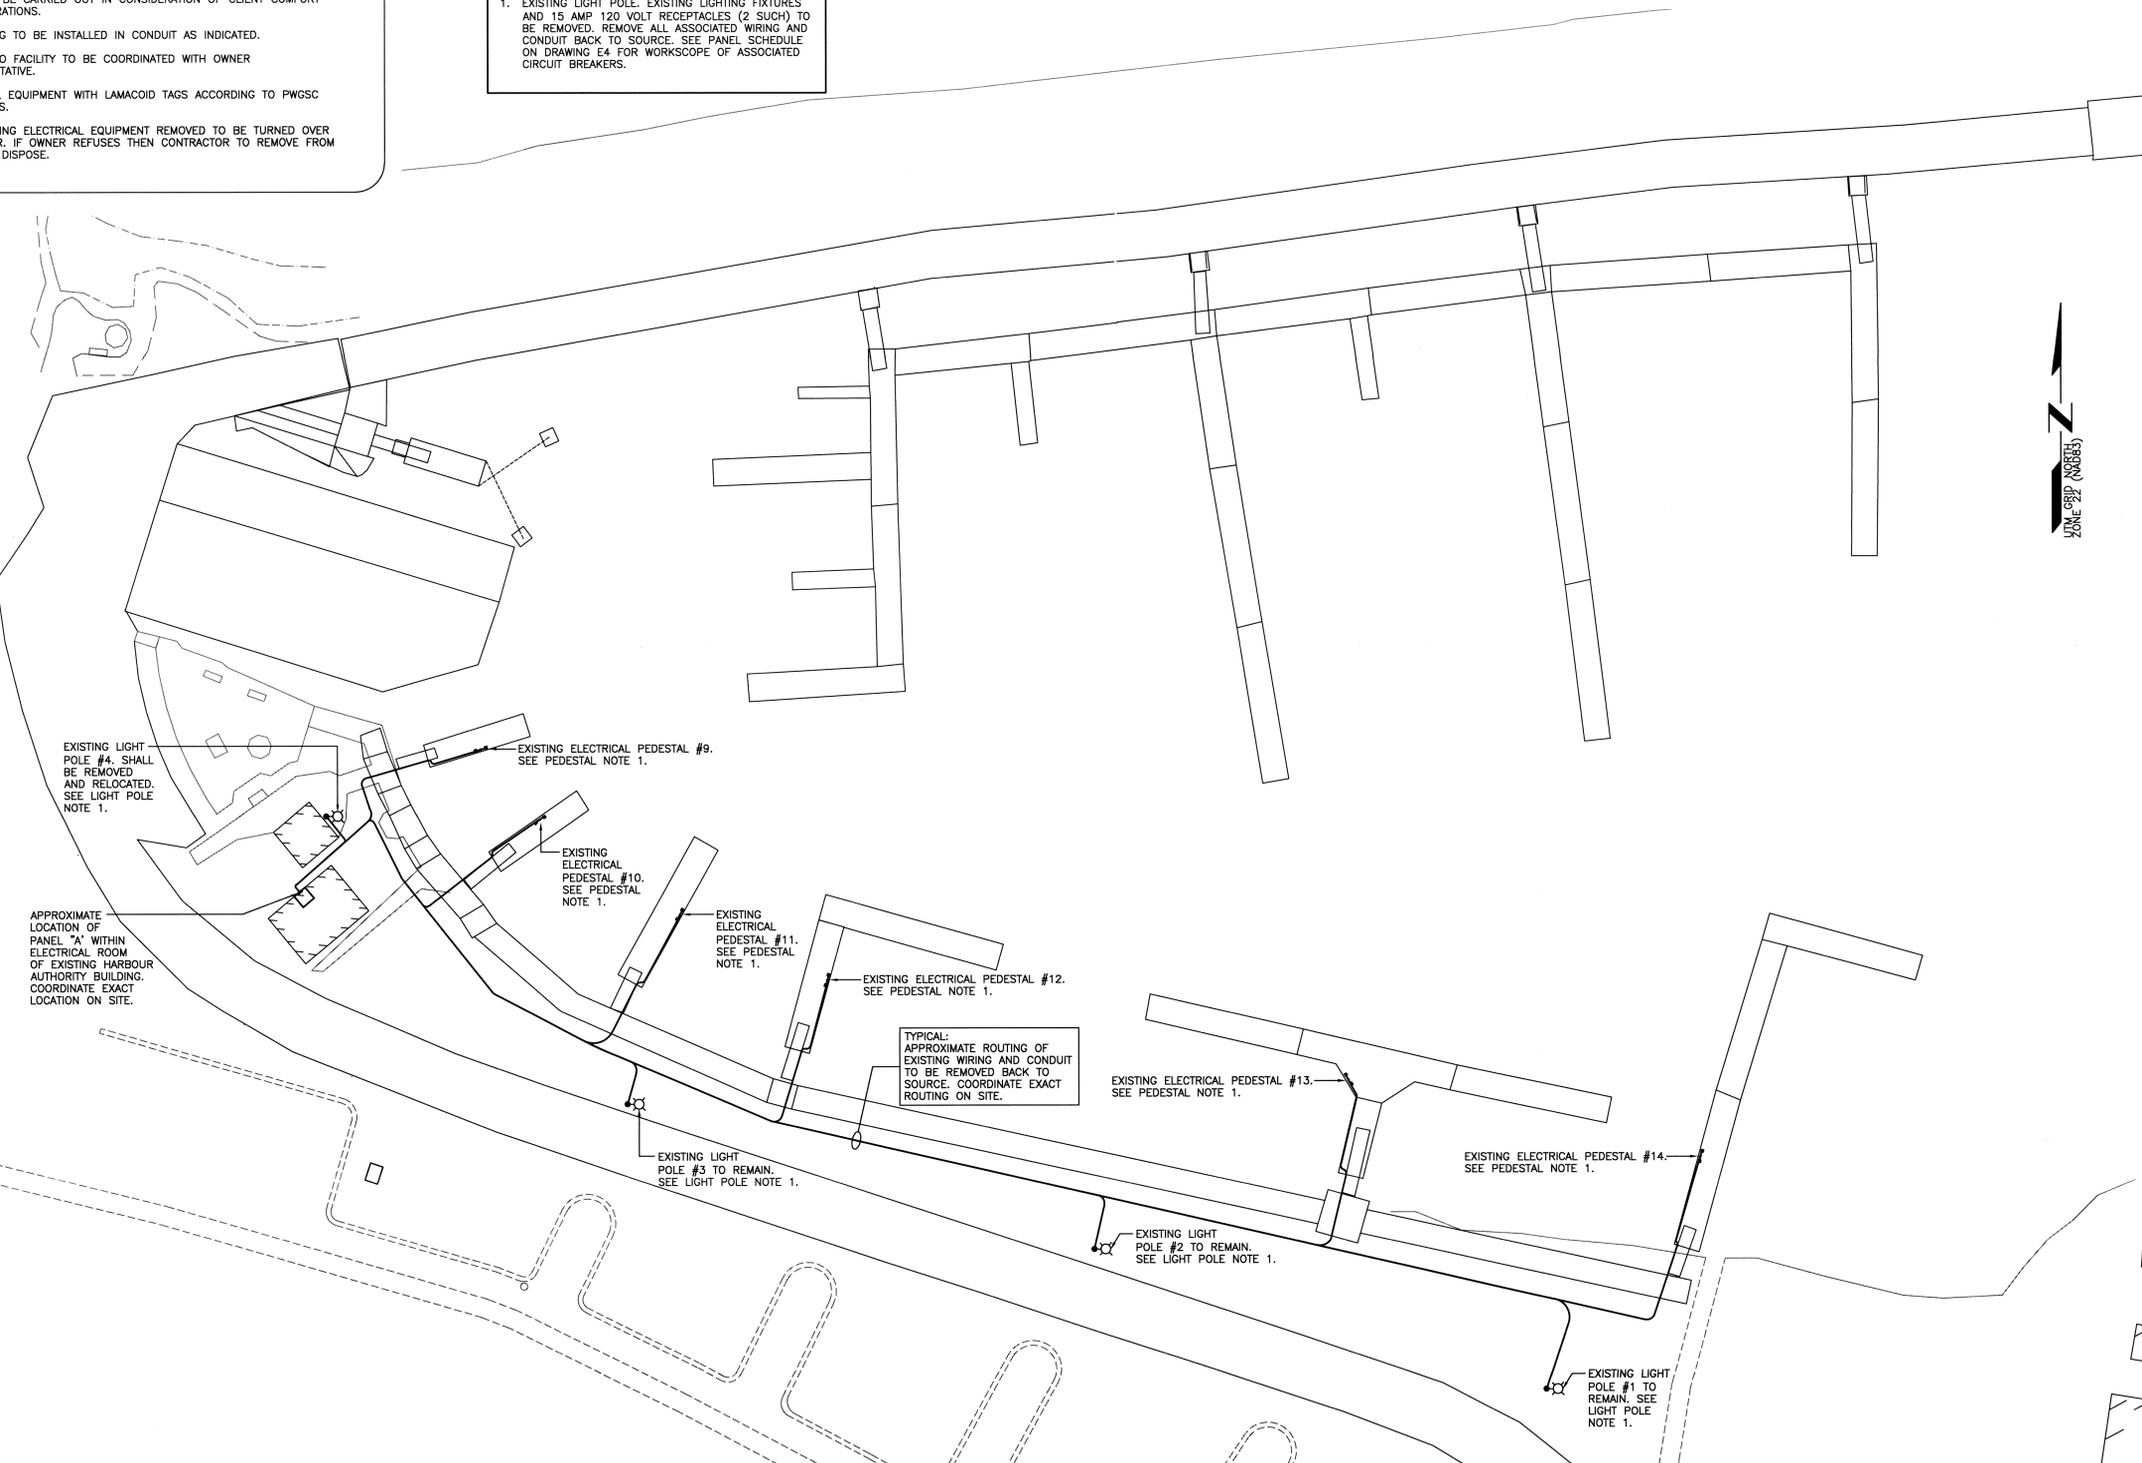

EXISTING LIGHT POLE #4. SHALL BE REMOVED AND RELOCATED. SEE LIGHT POLE NOTE 1.

EXISTING ELECTRICAL PEDESTAL #9. SEE PEDESTAL NOTE 1.

EXISTING ELECTRICAL PEDESTAL #10. SEE PEDESTAL NOTE 1.

EXISTING ELECTRICAL PEDESTAL #11. SEE PEDESTAL NOTE 1.

EXISTING ELECTRICAL PEDESTAL #12. SEE PEDESTAL NOTE 1.

TYPICAL: APPROXIMATE ROUTING OF EXISTING WIRING AND CONDUIT TO BE REMOVED BACK TO SOURCE. COORDINATE EXACT ROUTING ON SITE.

EXISTING ELECTRICAL PEDESTAL #13. SEE PEDESTAL NOTE 1.

EXISTING ELECTRICAL PEDESTAL #14. SEE PEDESTAL NOTE 1.

EXISTING LIGHT POLE #5 TO REMAIN. SEE LIGHT POLE NOTE 1.

EXISTING LIGHT POLE #2 TO REMAIN. SEE LIGHT POLE NOTE 1.

EXISTING LIGHT POLE #1 TO REMAIN. SEE LIGHT POLE NOTE 1.

APPROXIMATE LOCATION OF PANEL "A" WITHIN ELECTRICAL ROOM OF EXISTING HARBOUR AUTHORITY BUILDING. COORDINATE EXACT LOCATION ON SITE.

SITE PLAN - DEMOLITION

SCALE : 1:300



SMALL CRAFT HARBOURS



NOTES:

1. DO NOT SCALE FROM THIS DRAWING.
2. CONTRACTOR TO VERIFY ALL DIMENSIONS ON SITE BEFORE PROCEEDING WITH THIS WORK.
3. ALL WORK TO BE IN ACCORDANCE WITH THE LATEST REQUIREMENTS OF: THE NATIONAL BUILDING CODE OF CANADA, LATEST EDITION; CANADIAN ELECTRICAL CODE, CURRENT EDITION; ANY OTHER AUTHORITIES HAVING JURISDICTION.

PROVINCE OF NEWFOUNDLAND
PERMIT HOLDER
Class "A"
This Permit Allows
CROSSBIE ENGINEERING LIMITED
To practice Professional Engineering
in Newfoundland and Labrador
Permit No. as issued by PEG-16, 00123
which is valid for the year 2018.

STAMP



0	ISSUED FOR TENDER	12/07/18
A	ISSUED FOR REVIEW	16/03/19
revisions	date	

project project
MARGINAL WHARF RECONSTRUCTION
FOXTRAP, NL

drawing dessin
SITE PLAN - DEMOLITION

designed K.N. concu

date MAY 2018

drawn M.N. dessin

date MAY 2018

approved approve

Tender Paul Curran Soumission

DFO Project Manager

project number no. du projet

721924

drawing no. no. du dessin

E1