# CENTRE FOR AQUACULTURE & ENVIRONMENTAL RESEARCH NEW LABS

#### FEED LAB WALL - ASSEMBLIES

TYPICAL EXTERIOR WALL ASSEMBLY PREFAB EPS WALL PANEL METAL SKIN (PREFINISHED) R24 RIGID INSULATION 152mm THICK PANEL METAL SKIN (PREFINISHED) ALUMINIUM FRAME

**EXTERIOR WALL ASSEMBLY - FURRED OUT** (FRR 45 MINUTE) PREFAB EPS WALL PANEL METAL SKIN (PREFINISHED) R24 RIGID INSULATION 152mm THICK PANEL METAL SKIN (PREFINISHED) 12mm AIR SPACE

92mm STEEL STUD @400 O.C.

16mm TYPE X GWB

16mm TYPE X GWB

LAB SIDE

INTERIOR COOLER WALL PREFAB EPS WALL PANEL METAL SKIN (PREFINISHED)

> COOLER WALL AT SHELVES PREFAB EPS WALL PANEL METAL SKIN (PREFINISHED) R24 RIGID INSULATION 152mm THICK PANEL METAL SKIN (PREFINISHED) 92mm STEEL STUD @400 O.C.

METAL SKIN (PREFINISHED)

R24 RIGID INSULATION 152mm THICK PANEL

#### **RENOVATED LABS - WALL ASSEMBLIES**

EXISTING 200mm CONCRETE BLOCK WALL PAINT FINISH

INTERIOR PARTITION 13mm TYPE X GYPSUM WALL BOARD 13mm PLYWOOD 102mm STEEL STUD @400 O.C. 13mm PLYWOOD 13mm TYPE X GYPSUM WALL BOARD

INTERIOR PARTITION 13mm GYPSUM WALL BOARD - 2 LAYERS 13mm TYPE X GYPSUM WALL BOARD 102mm STEEL STUD @400 O.C 13mm GYPSUM WALL BOARD - 2 LAYERS 13mm TYPE X GYPSUM WALL BOARD

#### ROOF ASSEMBLIES

TYPICAL ROOF ASSEMBLY EPS ROOF PANEL: PREFIN. METAL SKIN, EPS INSULATION (R32 203mm), METAL SKIN

#### **FLOOR ASSEMBLIES**

TYPICAL FLOOR ASSEMBLY FLOORING - SEE SCHEDULE 8mm PLYWOOD FINISHED FLOOR UNDERLAYMENT 19mm EXTERIOR GRADE PLYWOOD OVERLAY R32 (203mm) INSULATED FLOOR PANEL GALVANIZED STEEL DECKING PEEL AND STICK ISOLATION MEMBRANE ALUMINUM FRAME - SEE STRUCT.

#### **GENERAL NOTES**

- DO NOT SCALE DRAWING.
- THE GENERAL CONTRACTOR SHALL VERIFY ALL DIMENSIONS DATUMS, AND LEVELS PRIOR TO COMMENCEMENT OF WORK. ALL ERRORS AND OMISSIONS TO BE REPORTED TO THE DEPARTMENTAL REPRESENTATIVE BEFORE PROCEEDING.
- VARIATIONS AND MODIFICATIONS TO WORK SHOWN ON THESE DRAWINGS SHALL NOT BE CARRIED OUT WITHOUT WRITTEN PERMISSION OF DEPARTMENTAL REPRESENTATIVE.
- ALL DIMENSIONS ARE TO GRIDLINES, FACE OF CONRETE, FACE OF STUDS OR CENTERLINE OF COLUMNS UNLESS NOTED OTHERWISE
- ALL DIMENSIONS ARE METRIC (mm) UNLESS NOTED OTHERWISE
- THESE DRAWINGS ARE TO BE READ IN CONJUNCTION WITH AND COORDINATED WITH THE SPECIFICATIONS AND THE DOCUMENTS OF THE OTHER DISCIPLINES THAT FORM THE FULL CONTRACT DOCUMENT PACKAGE. WHERE CONFLICT EXISTS BETWEEN DOCUMENTS, THESE ARE TO BE REPORTED TO THE DEPARTMENTAL REPRESENTATIVE BEFORE PROCEEDING.
- ENSURE COMPATABILITY OF METAL FASTENERS, SHEET METALS AND OTHER METAL ITEMS WITH EACH OTHER AND WITH PRESSURE TREATED WOOD. PROVIDE ISOLATION WHERE REQUIRED. ALWAYS ISOLATE P.T. WOOD FROM METALS.

SHEET NUMBER ASSEMBLY TYPE R-ROOF, F- FLOOR W- WALL, P-PARTITION

**GRID MARKER** 

LEGEND:

Part 3 NBC 2010 Reference

1.4.1.2[A], 3.2.1.1

1.4.1.2[A]

3.2.2.10

3.2.2.62

3.2.2.85

3.2.5.8

3.2.4

3.2.5.7

3.2.6

3.2.2.20-83

3.2.3.1-B

3.2.3.7

3.8

Listed Design No.

See Assemblies

or Description

☐ Addition 
☐ Renovation

□ New

N/A - 0 Hrs.

N/A - 0 Hrs. N/A - 0 Hrs.

⊠ No

 $\bowtie$  No

 $\bowtie$  No

□ No

 $\bowtie$  No

☐ Non-Combustible

☐ Non-Combustible

Design of Building

Non- Combustible Cladding

Entire Building

☐ Yes

Yes

☐ Yes

34.2 sq.m. manufacture / 4.6 sq.m/person = 7

18 sq.m. storage / 28 sq.m/person =

✓ Yes (Feed Lab)

☐ Combustible

(hours)

.75 Hours

1 New Modular Buildings - Aluminium frame with metal faced rigid insulation panels.

(000) DOOR NUMBER

WINDOW NUMBER

SECTION CUT DIRECTION MARKER



ROOM NAME ROOM NUMBER

FINISH TYPE | HEIGHT ABOVE FINISHED FLOOR

MILLWORK ELEVATIONS

### **ABBREVIATIONS:**

HORIZ.

INSUL.

MAT'L

MECH.

MEMB

MB

HORIZONTAL

MECHANICAL

MEMBRANE

MOISTURE BARRIER

MINIMUM OR MINUTES

INSULATION

MATERIAL

AB	AIR BARRIER	(N)	NEW
ACM	ASBESTOS CONTAINING MATERIAL	N.I.C.	NOT IN CONTRACT
ACT	ACOUSTIC CEILING TILE	N.T.S.	NOT TO SCALE
ALT.	ALTERNATE	O.C.	ON CENTER
ALUM.	ALUMINUM	OP.	OPERABLE
ANOD.	ANODIZED	PT.	PAINT
A.F.F.	ABOVE FINISH FLOOR	P.O.	POWER OPERATOR
BLDG.	BUILDING	P.T.	PRESSURE TREATED
CARP.	CARPET	RB	RUBBER BASE
CARP. T.	CARPET TILE	RCP	REFLECTED CEILING PLAN
C.C.	CENTER TO CENTER	RE & RE	REMOVE & RELOCATE / REINSTATE
C.O.	CLEAN OUT	RM.	ROOM
C.J.	CONTROL JOINT	SAM	SELF ADHESIVE MEMBRANE
C/W	COMPLETE WITH	SAN	SANITARY
CONC.	CONCRETE	SEP	SEPARATION
D.G.	DOUBLE GLAZED	SG	SHEET GOODS FLOORING
(E)	EXISTING	SIM.	SIMILAR
ELECT.	ELECTRICAL	SQ.	SQUARE
F.E.		S.S.	STAINLESS STEEL
F.E.C.	FIRE EXTINGUISHER CABINET	ST	STEEL
FIN.	FINISH	STRUCT.	STRUCTURAL
FNDT.	FOUNDATION	SV	SHEET VINYL
FRR	FIRE RESISTANCE RATING	TBD	
FTG	FOOTING	T.G.	TRIPPLE GLAZED
GWB	GYPSUM WALL BOARD	THLD.	THRESHOLD
GA	GAUGE	T.O.	TOP OF
G.I.	GALVANIZED	TYP.	TYPICAL
H.M.	HOLLOW METAL	U.G.	UNDER GROUND
HDWR	HARDWARE	U.N.O.	UNLESS NOTED OTHERWISE

UNDERSIDE

VERTICAL

WOOD

WITH OUT

VAPOUR BARRIER

VINYL COMPOSITE TILE

U/S

VERT.

VCT

WD.

W/O

### DRAWING LIST

#### **ARCHITECTURAL**

A0.00	COVER SHEET, LIST OF DRAWINGS
	LEGEND, ASSEMBLIES,
	ABBREVIATIONS, NOTES
A1.01	FEED LAB LOCAL SITE PLAN
A1.02	LABS 129A, 129C, 131 EXISTING BUILDING PLAN
A1.03	OVERALL SITE PLAN
A2.01	FEED LAB FLOOR PLANS
	FOUNDATION & FRAMING PLAN
A2.02	LABS 129A, 129C, 131 DEMO PLAN, NEW PLAN
A2.03	LABS 129A, 129C, 131 ROOF PLAN
A3.01	FEED LAB EXTERIOR ELEVATONS
A4.01	FEED LAB SECTION
A5.01	LABS 129A, 129C, 131 DETAILS
A6.01	FEED LAB DETAILS
A6.02	FEED LAB DETAILS
A6.03	FEED LAB DETAILS
A6.04	FEED LAB DETAILS
A6.05	FEED LAB RAMP DETAIL
A7.01	INTERIOR ELEVATIONS
A7.02	MILLWORK DETAILS
A8.01	DOOR, WINDOW, & FINISH SCHEDULES, EQUIPMENT

#### **STRUCTURAL**

S1.01	STRUCTURAL NOTES
S2.01	FOUNDATION PLAN, SECTIONS AND DETAILS
S2.02	FLOOR FRAMING PLAN, DETAILS AND SECTIONS

TO BE RELOCATED

#### STRUCTURAL (ALUMINUM FRAME ASSEMBLY)

SH1	STRUCTURAL ALUMINUM FRAME, 3D GENERAL
	ARRANGEMENT, GENERAL NOTES, DRAWING INDEX AND LEGENI
SH2	STRUCTURAL ALUMINUM FRAME, ROOF FRAMING PLAN AND
	ROOF FRAMING DETAIL
SH3	STRUCTURAL ALUMINUM FRAME, FLOOR FRAMING PLAN AND
	ROOF FRAMING PLAN
SH4	STRUCTURAL ALUMINUM FRAME, COLUMN PLAN AND DETAILS
SH5	STRUCTURAL ALUMINUM FRAME, COLUMN BASES PLAN AND
	CABLE BRACING GUSSET PLATE PLAN, SECTIONS AND DETAILS
SH6	STRUCTURAL ALUMINUM FRAME, HALF CROSS SECTIONS
SH7	STRUCTURAL ALUMINUM FRAME, KNEE BRACING AND ROOF
	BEAM CONNECTION DETAILS, SHEET 1 OF 2
SH8	STRUCTURAL ALUMINUM FRAME, KNEE BRACING AND ROOF
	BEAM CONNECTION DETAILS, SHEET 2 OF 2
SH9	STRUCTURAL ALUMINUM FRAME, ROOF FRAMING AND FLOOR
	FLOOR FRAMING, SECTIONS AND DETAILS
SH10	STRUCTURAL ALUMINUM FRAME, COLUMN BASE MK-C81,
	SECTIONS AND DETAILS
SH11	STRUCTURAL ALUMINUM FRAME, COLUMN BASE MK-C82 AND
	,

COLUMN BASE MK-C83, SECTIONS AND DETAILS

#### PRE-FAB FRAME DRAWINGS

PRE-FAB FRAME DRAWINGS - 12 PAGES

Α0

#### **INSULATED PANEL DRAWINGS**

TITLE BLOCK

PLAN VIEW

,	1 E/ 111 VIEV
A2	FLOOR PLAN
A3	ROOF PANELS
A4	ELEVATIONS
A5	DETAILS-GALVANIZED
A6	DETAILS-MELCHER GREEN
A7	DETAILS-WHITE
4-30-10-AR	PREFABRICATED BUILDING MODEL 24X24-S1 (BUILDING 'B') SLEEP
	QUARTERS STYLE '1' BUILDING CROSS SECTION AND INSULATED
	PANEL CONNECTION DETAILS
4-30-10-AR	PREFABRICATED BUILDING MODEL 24X24-S1 (BUILDING 'B') SLEEP
	QUARTERS STYLE '1' MISCELLANEOUS INSULATED PANEL
	CONNECTION DETAILS
4-30-10-AR	PREFABRICATED BUILDING MODEL 24X24-S1 (BUILDING 'B') SLEEP
	QUARTERS STYLE '1' DOOR SCHEDULE AND DETAILS
4-30-10-AR	PREFABRICATED BUILDING MODEL 24X24-S1 (BUILDING 'B') SLEEP
	QUARTERS STYLE '1' WINDOW SCHEDULE AND DETAILS, ROOM
	FINISHES SCHEDULE
A-15	FIELD CAMP BUILDING
	A3 A4 A5 A6 A7 4-30-10-AR 4-30-10-AR 4-30-10-AR

#### **MECHANICAL**


M0.01	SCHEDULES, LEGEND & DRAWING LIST
M1.01	PLUMBING - LABS 129A, 129C, 131 DEMO AND NEW PLANS
M1.02	PLUMBING - FEED LAB PLAN AND DETAILS
M2.01	MECHANICAL - LABS 129A, 129C, 131 DEMO AND NEW PLANS
M2.02	MECHANICAL - FEED LAB PLAN AND DETAILS

### **ELECTRICAL**

E1.0 EXTERIOR LAB & DETAILS E2.0 **INTERIOR LAB & DETAILS** 

#### <u>CIVIL</u>

C1.0 SITE PLAN AND SERVICING

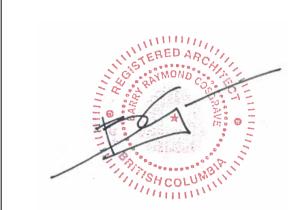

Public Works and
Government Services
Canada

REAL PROPERTY SERVICES Pacific Region SERVICES IMMOBILIERS Région de Pacifique

Services gouvernementaux

2	TENDER	2018-08-16
1	REVIEW	2018-07-24
Revision/ Revision	Description/Description	Date/Date

#### **FISHERIES AND OCEANS, REAL PROPERTY, SAFETY AND SECURITY**

VANCOUVER, BC **200-401 BURRARD ST.** 

**CENTER FOR AQUACULTURE & ENVIRONMENTAL** RESEARCH

#### **NEW & RENOVATED LABS**

4160 Marine Dr, West Vancouver

Designed by/Concept par

Consultant Signature Box Only

Drawn by/Dessine par

PWGSC Project Manager/Administrateur de Projets TPSGC

PWGSC, Regional Manager, Architectural and Engineering Services/ Gestionnaire régionale. Services d'architectural et de génie. TPSGC

PREETIPAL PAUL

Drawing title/Titre du dessin

COVER SHEET, LIST OF DRAWINGS. LEGEND, ASSEMBLIES, ABBREVIATIONS, **NOTES** 

-	A0.00
oject No./No. du projet	Sheet/ Feuille

Revision no./ La Révision

Name of Project: Feed Lab

Location: 4160 Marine Drive

Item 2010 National Building Code Data Matrix

Building Area (m²): 58.2 sq.m.

Number of Streets/Access Routes:

Major Occupancy(s): Feed Lab Group F - Division 3

Fire Resistance

Ratings (Hours)

Floors

Spatial Separation - South Exterior Wall - Acoustics Lab only:

or % of H/L Openings

Project Description: -

Number of Storeys:

Required Fire

Resistance Rating

Standpipe Required:

Fire Alarm Required:

Permitted Construction:

Actual Construction:

High Building:

Sprinkler System Proposed:


Water Service/Supply is Adequate:


21.5 sq.m | 1.8m | N/A | 10%


Occupant Load Based On:

Barrier-Free Design:

Separation of Occupancys:

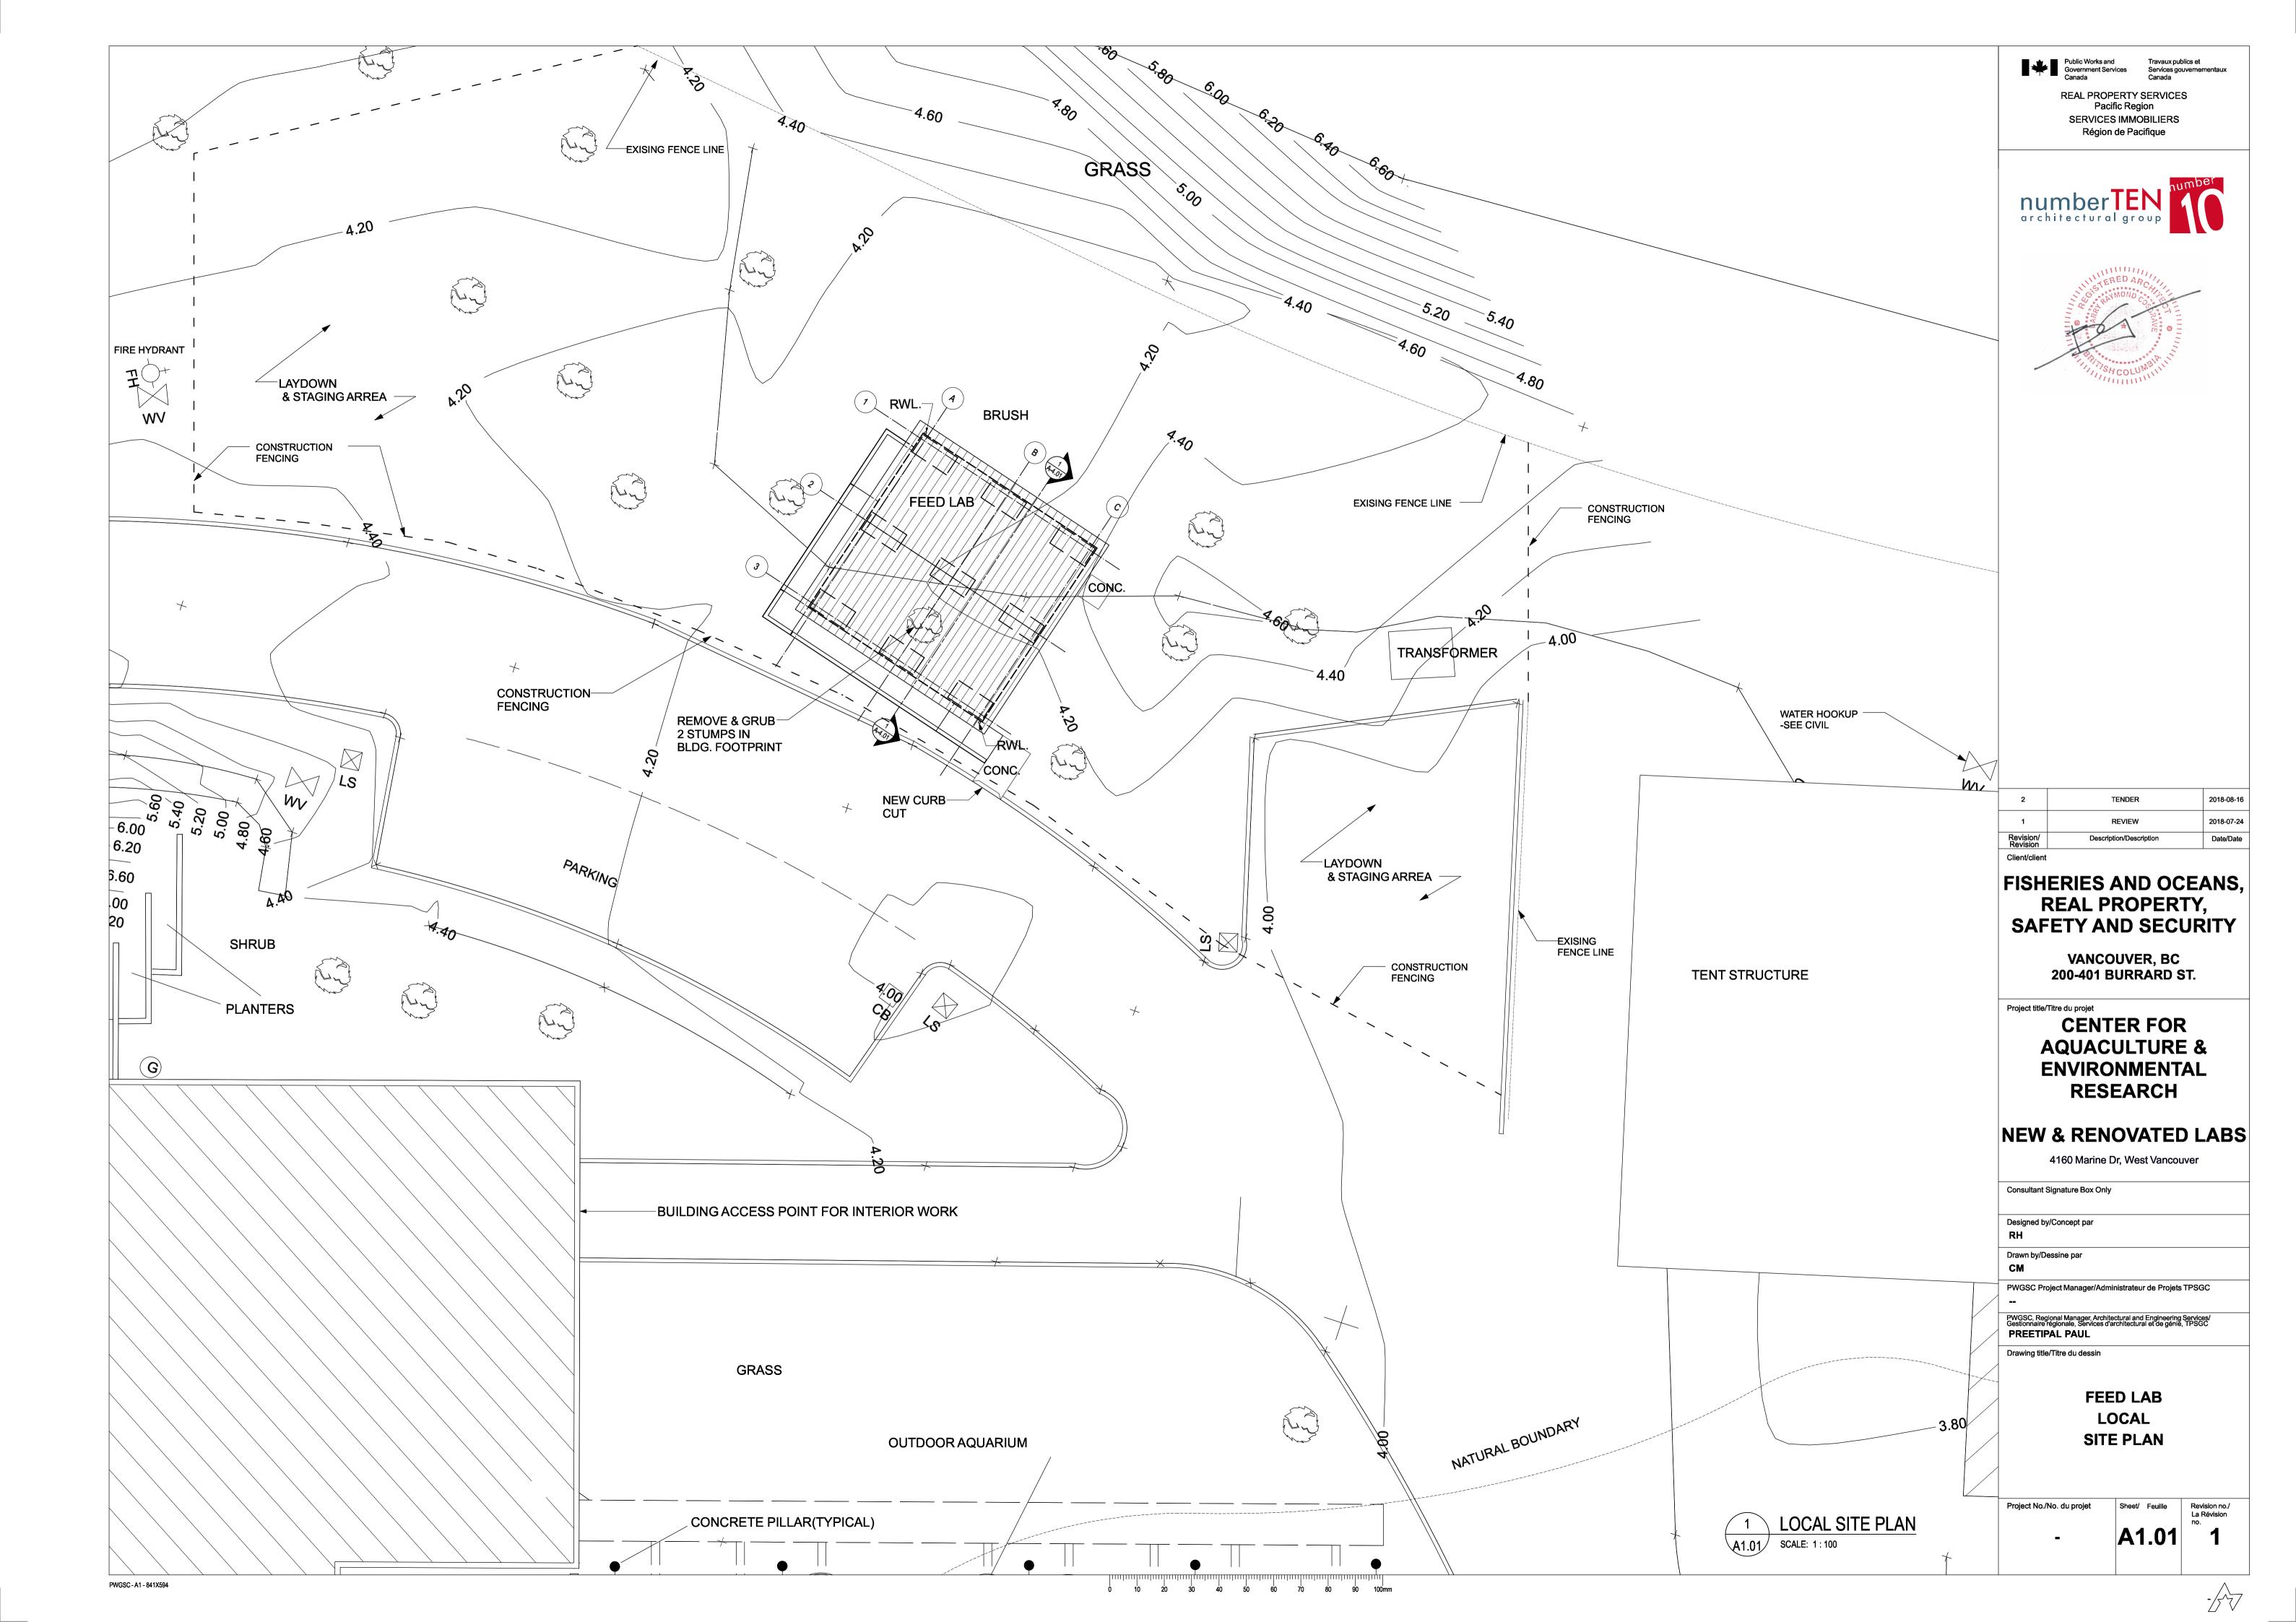

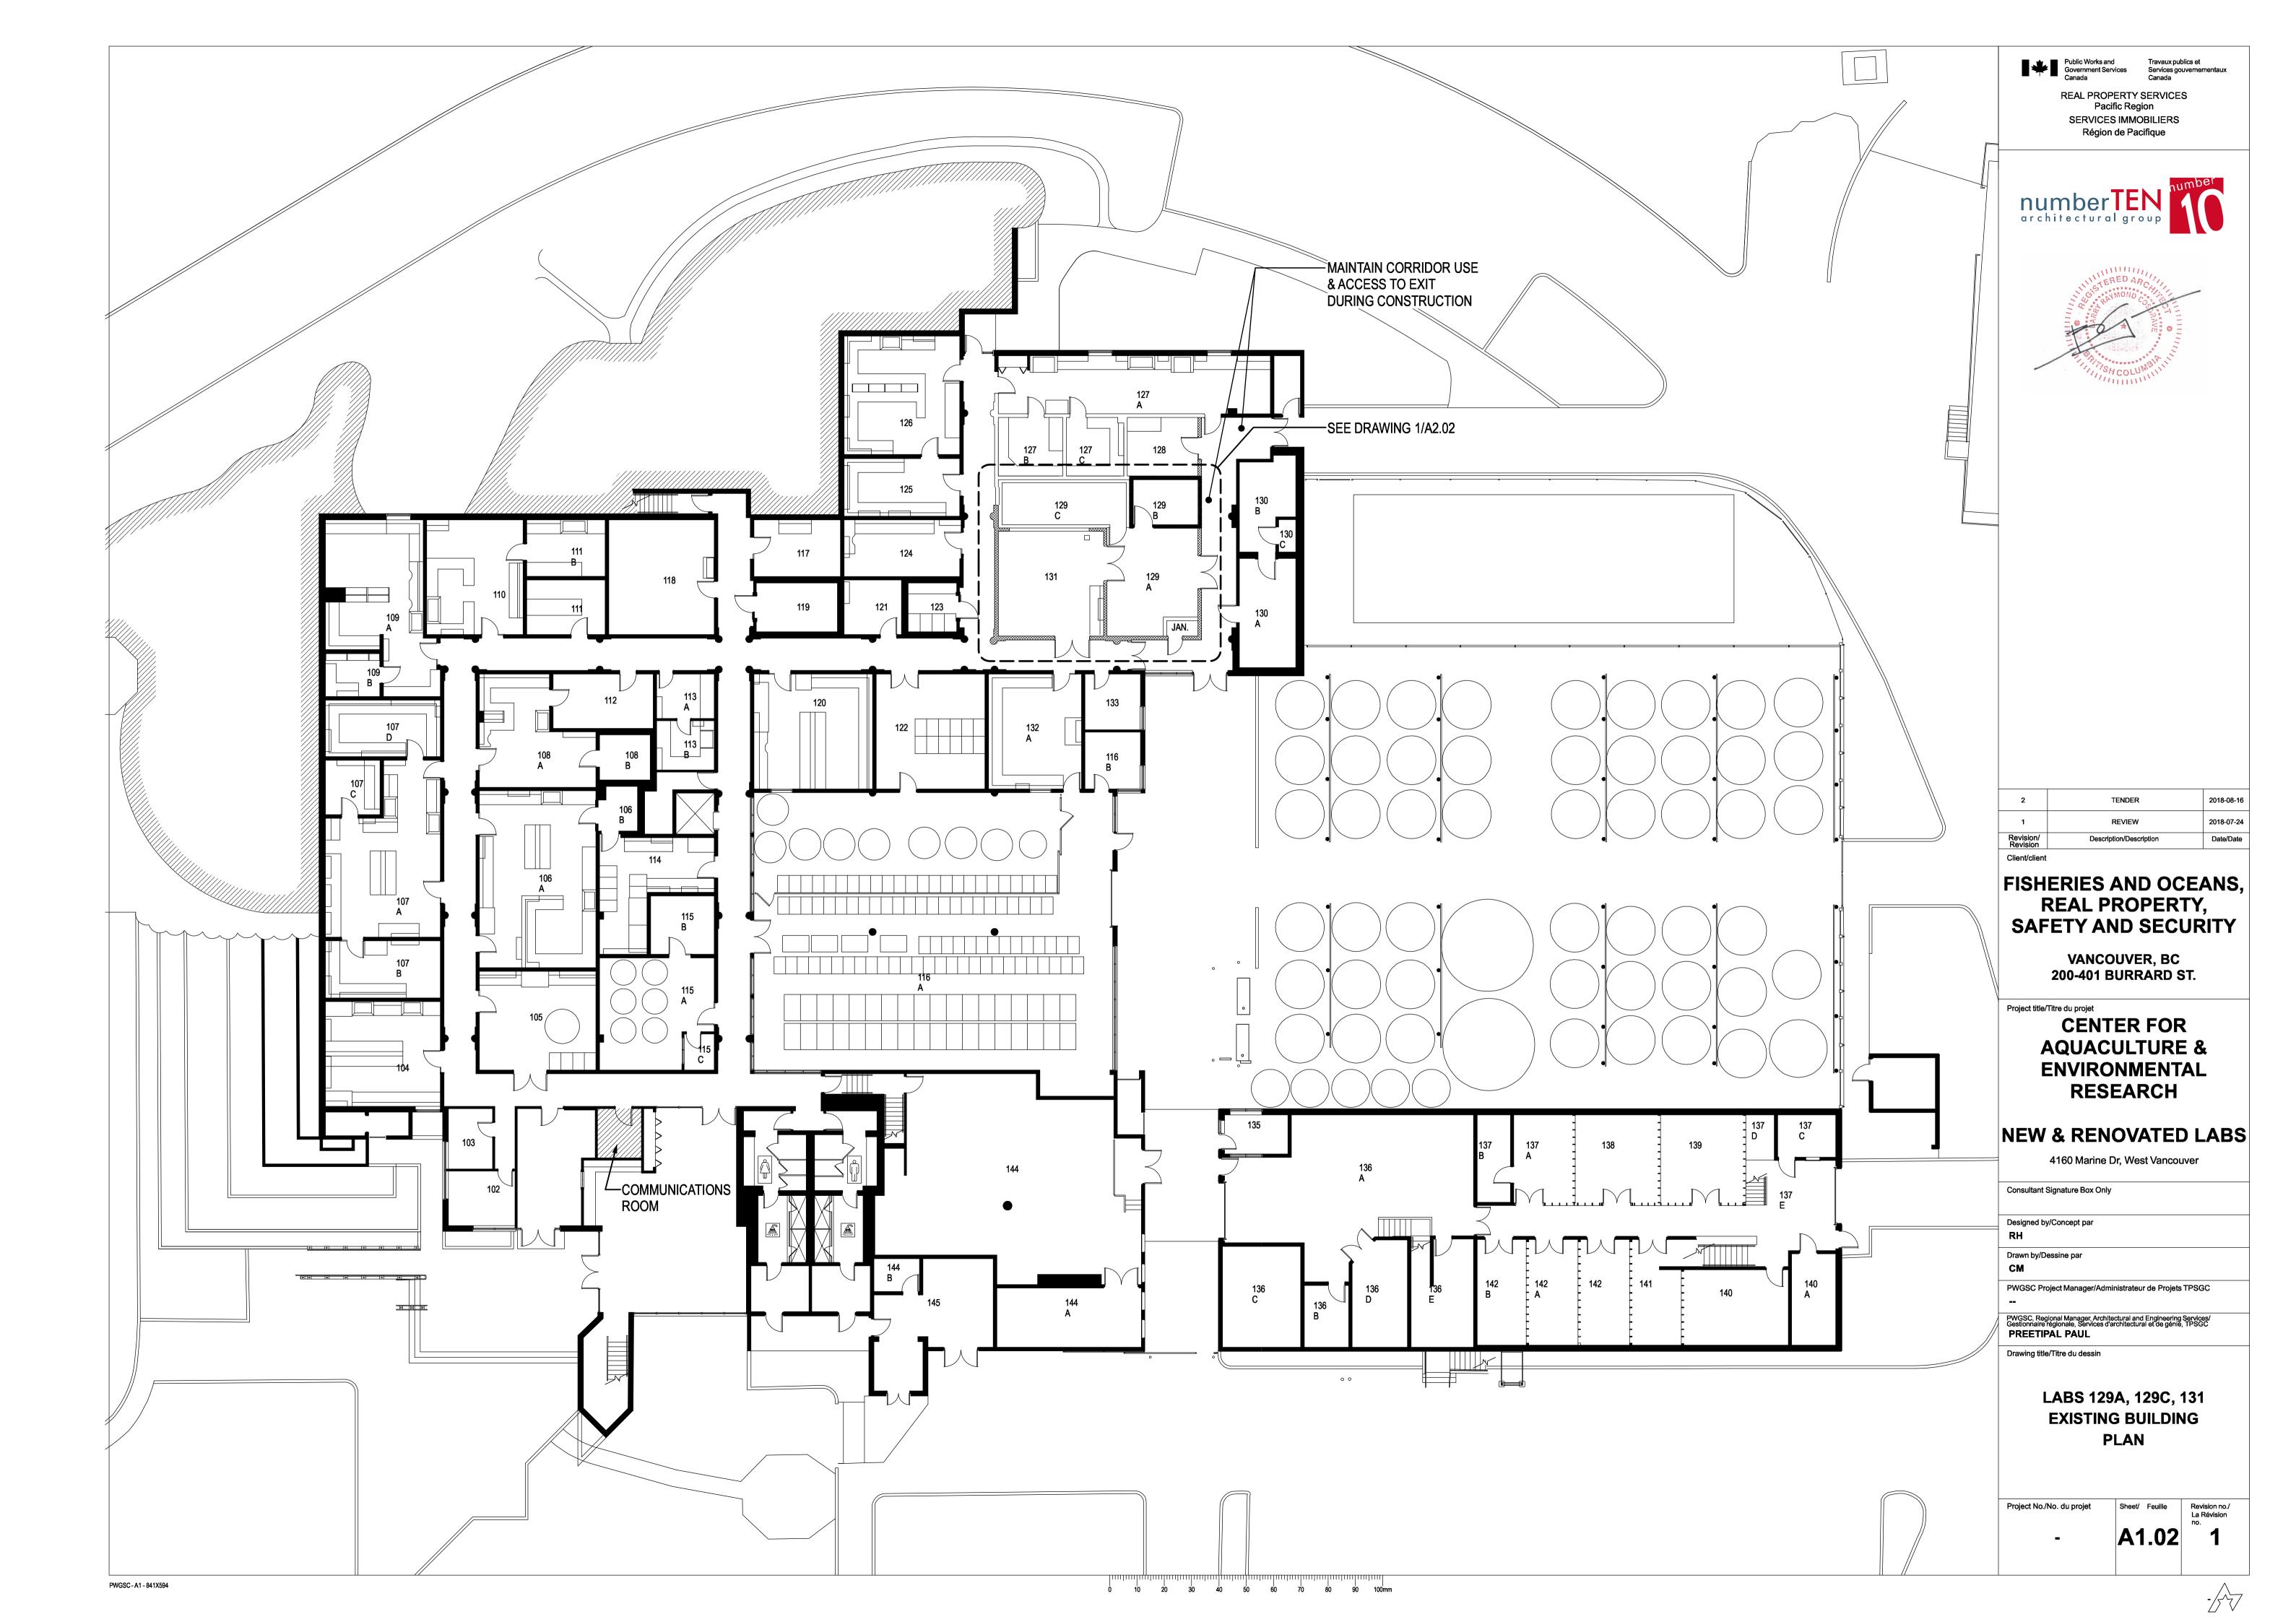

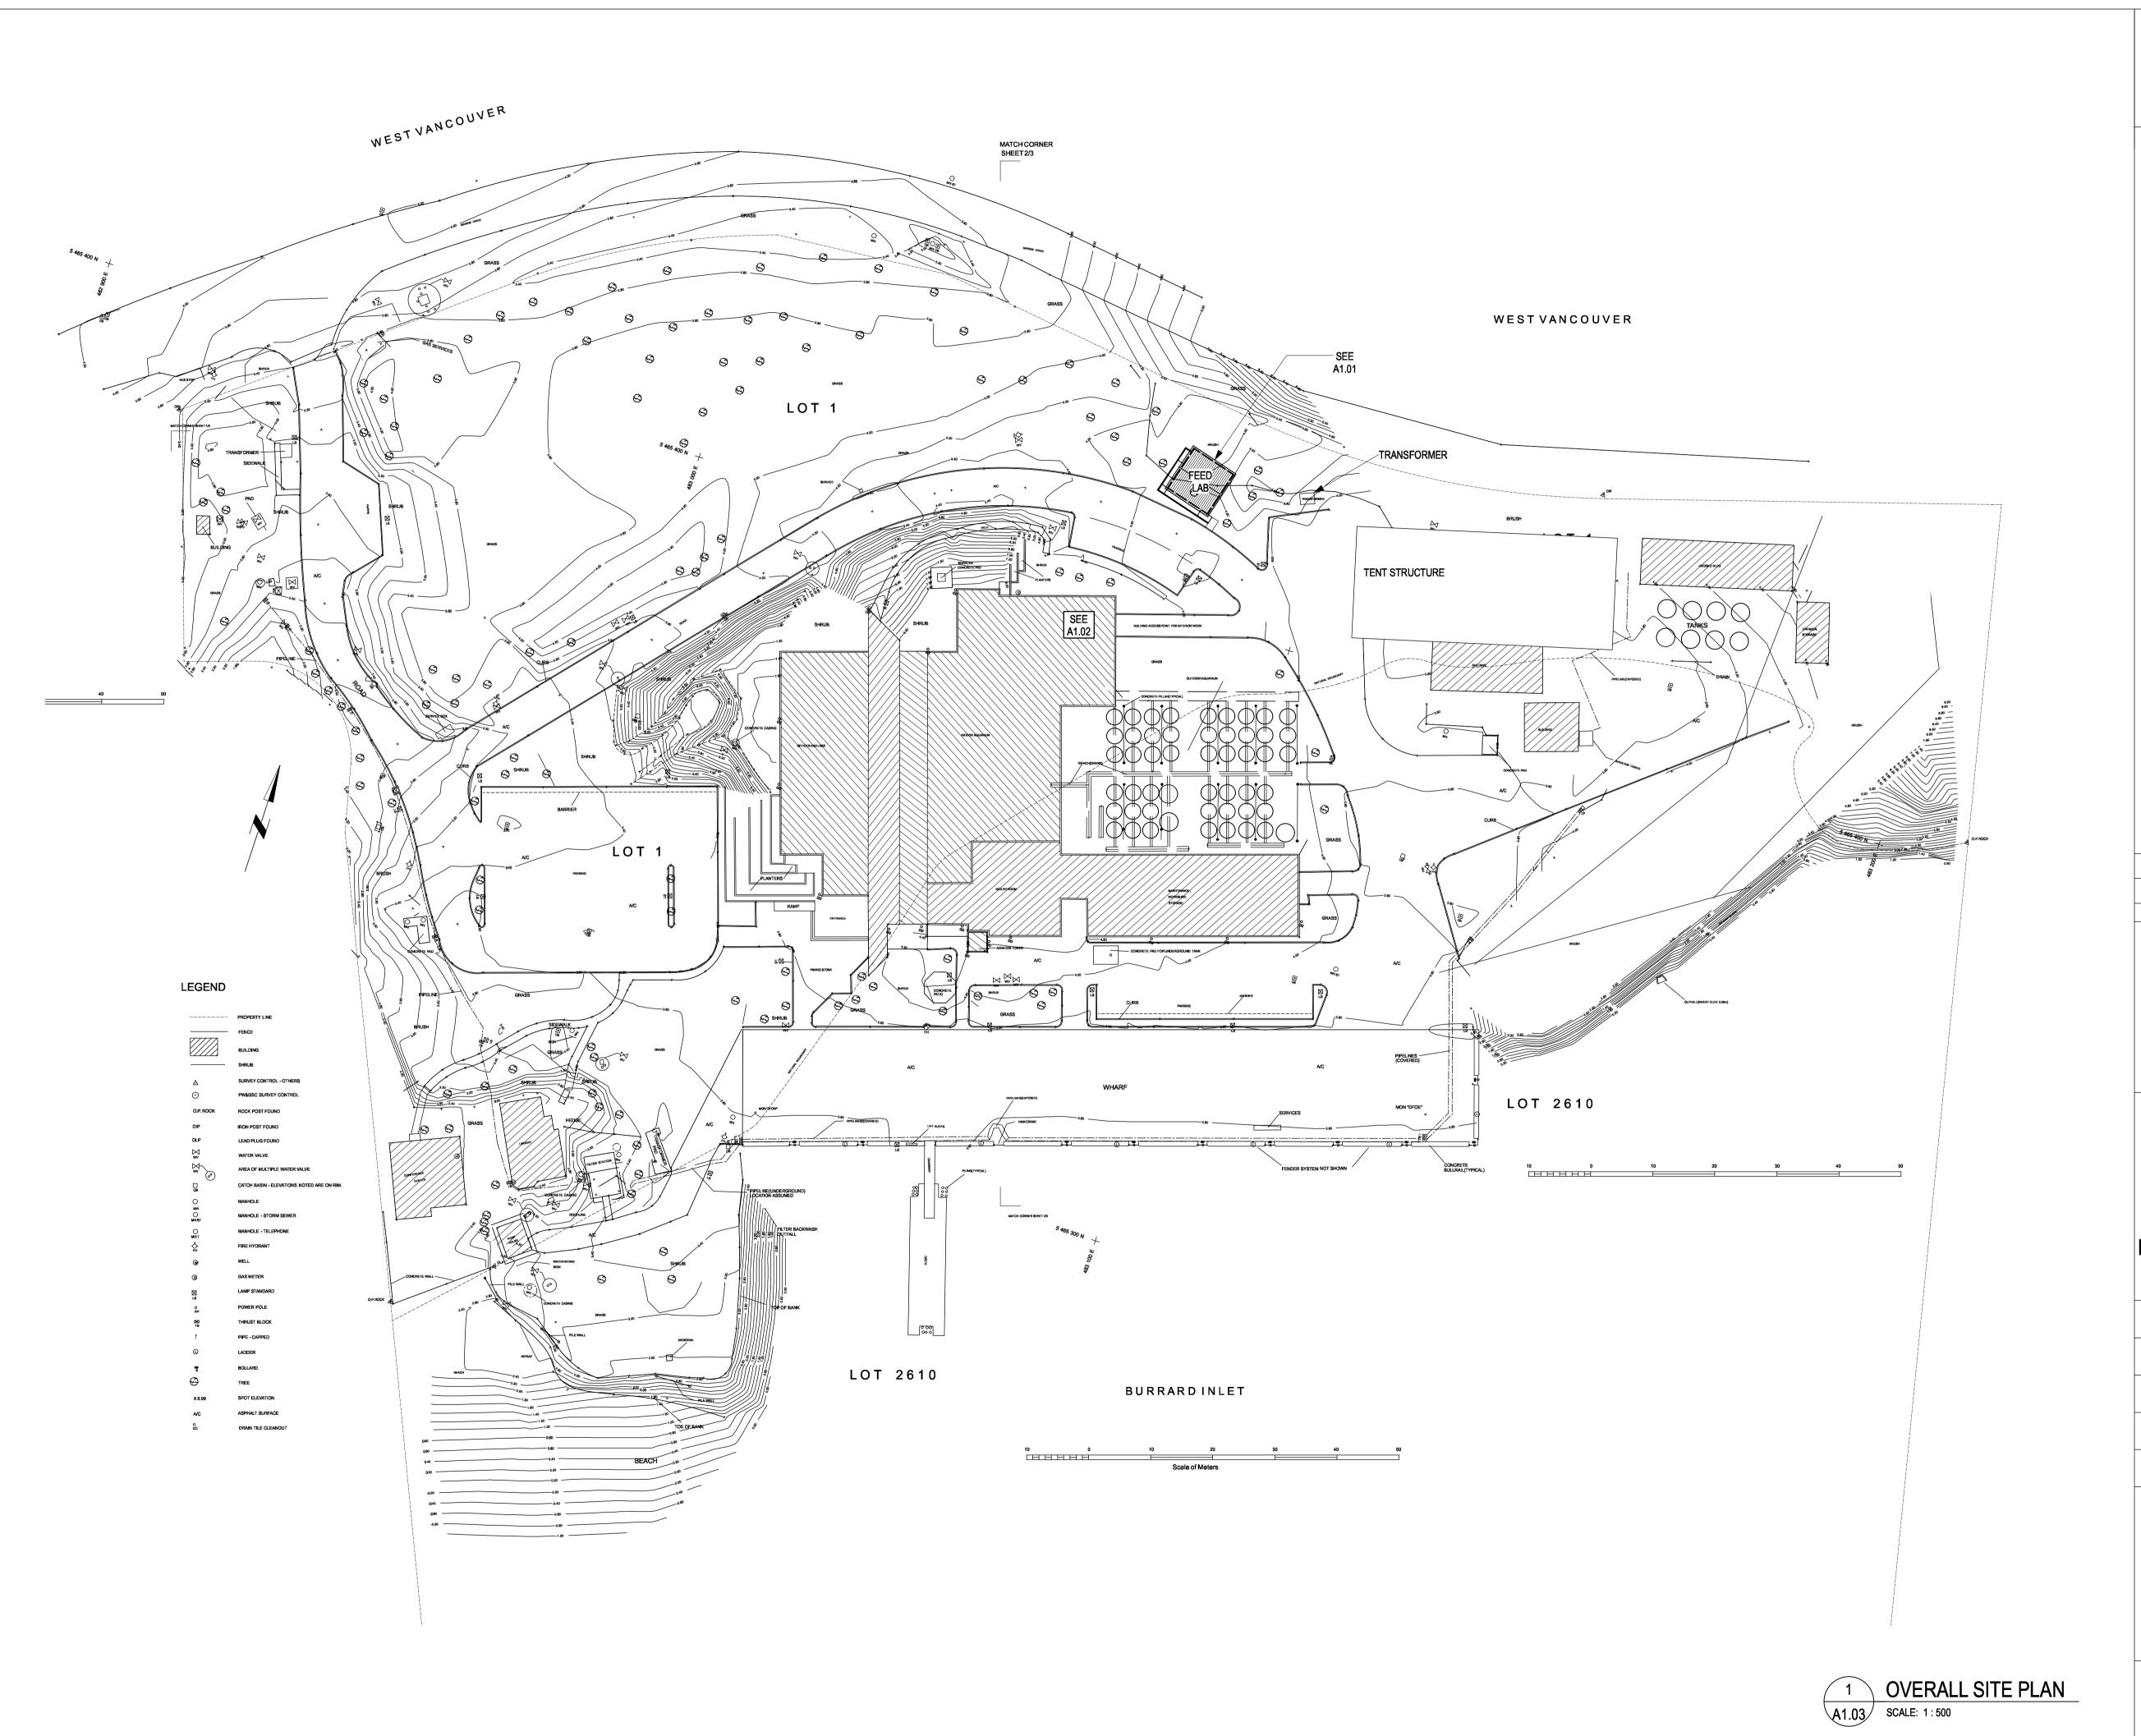


PWGSC - A1 - 841X594

Public Works and Travaux publics et Services gouvernementaux Canada Canada

REAL PROPERTY SERVICES
Pacific Region
SERVICES IMMOBILIERS Région de Pacifique



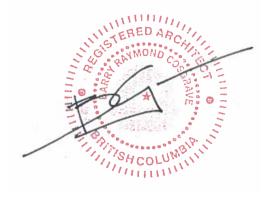

2	TENDER	2018-08-16
1	REVIEW	2018-07-24
Revision/ Revision	Description/Description	Date/Date
Client/elient		

#### FISHERIES AND OCEANS, **REAL PROPERTY,** SAFETY AND SECURITY

VANCOUVER, BC 200-401 BURRARD ST.

**CENTER FOR AQUACULTURE & ENVIRONMENTAL** RESEARCH

#### **NEW & RENOVATED LABS**

4160 Marine Dr, West Vancouver

Consultant Signature Box Only

Designed by/Concept par

Drawn by/Dessine par

PWGSC Project Manager/Administrateur de Projets TPSGC

PWGSC, Regional Manager, Architectural and Engineering Services/ Gestionnaire régionale, Services d'architectural et de génie, TPSGC PREETIPAL PAUL


Drawing title/Titre du dessin

**OVERALL** SITE PLAN

Project No./No. du projet

A1.03 1


0 10 20 30 40 50 60 70 80 90 100mm

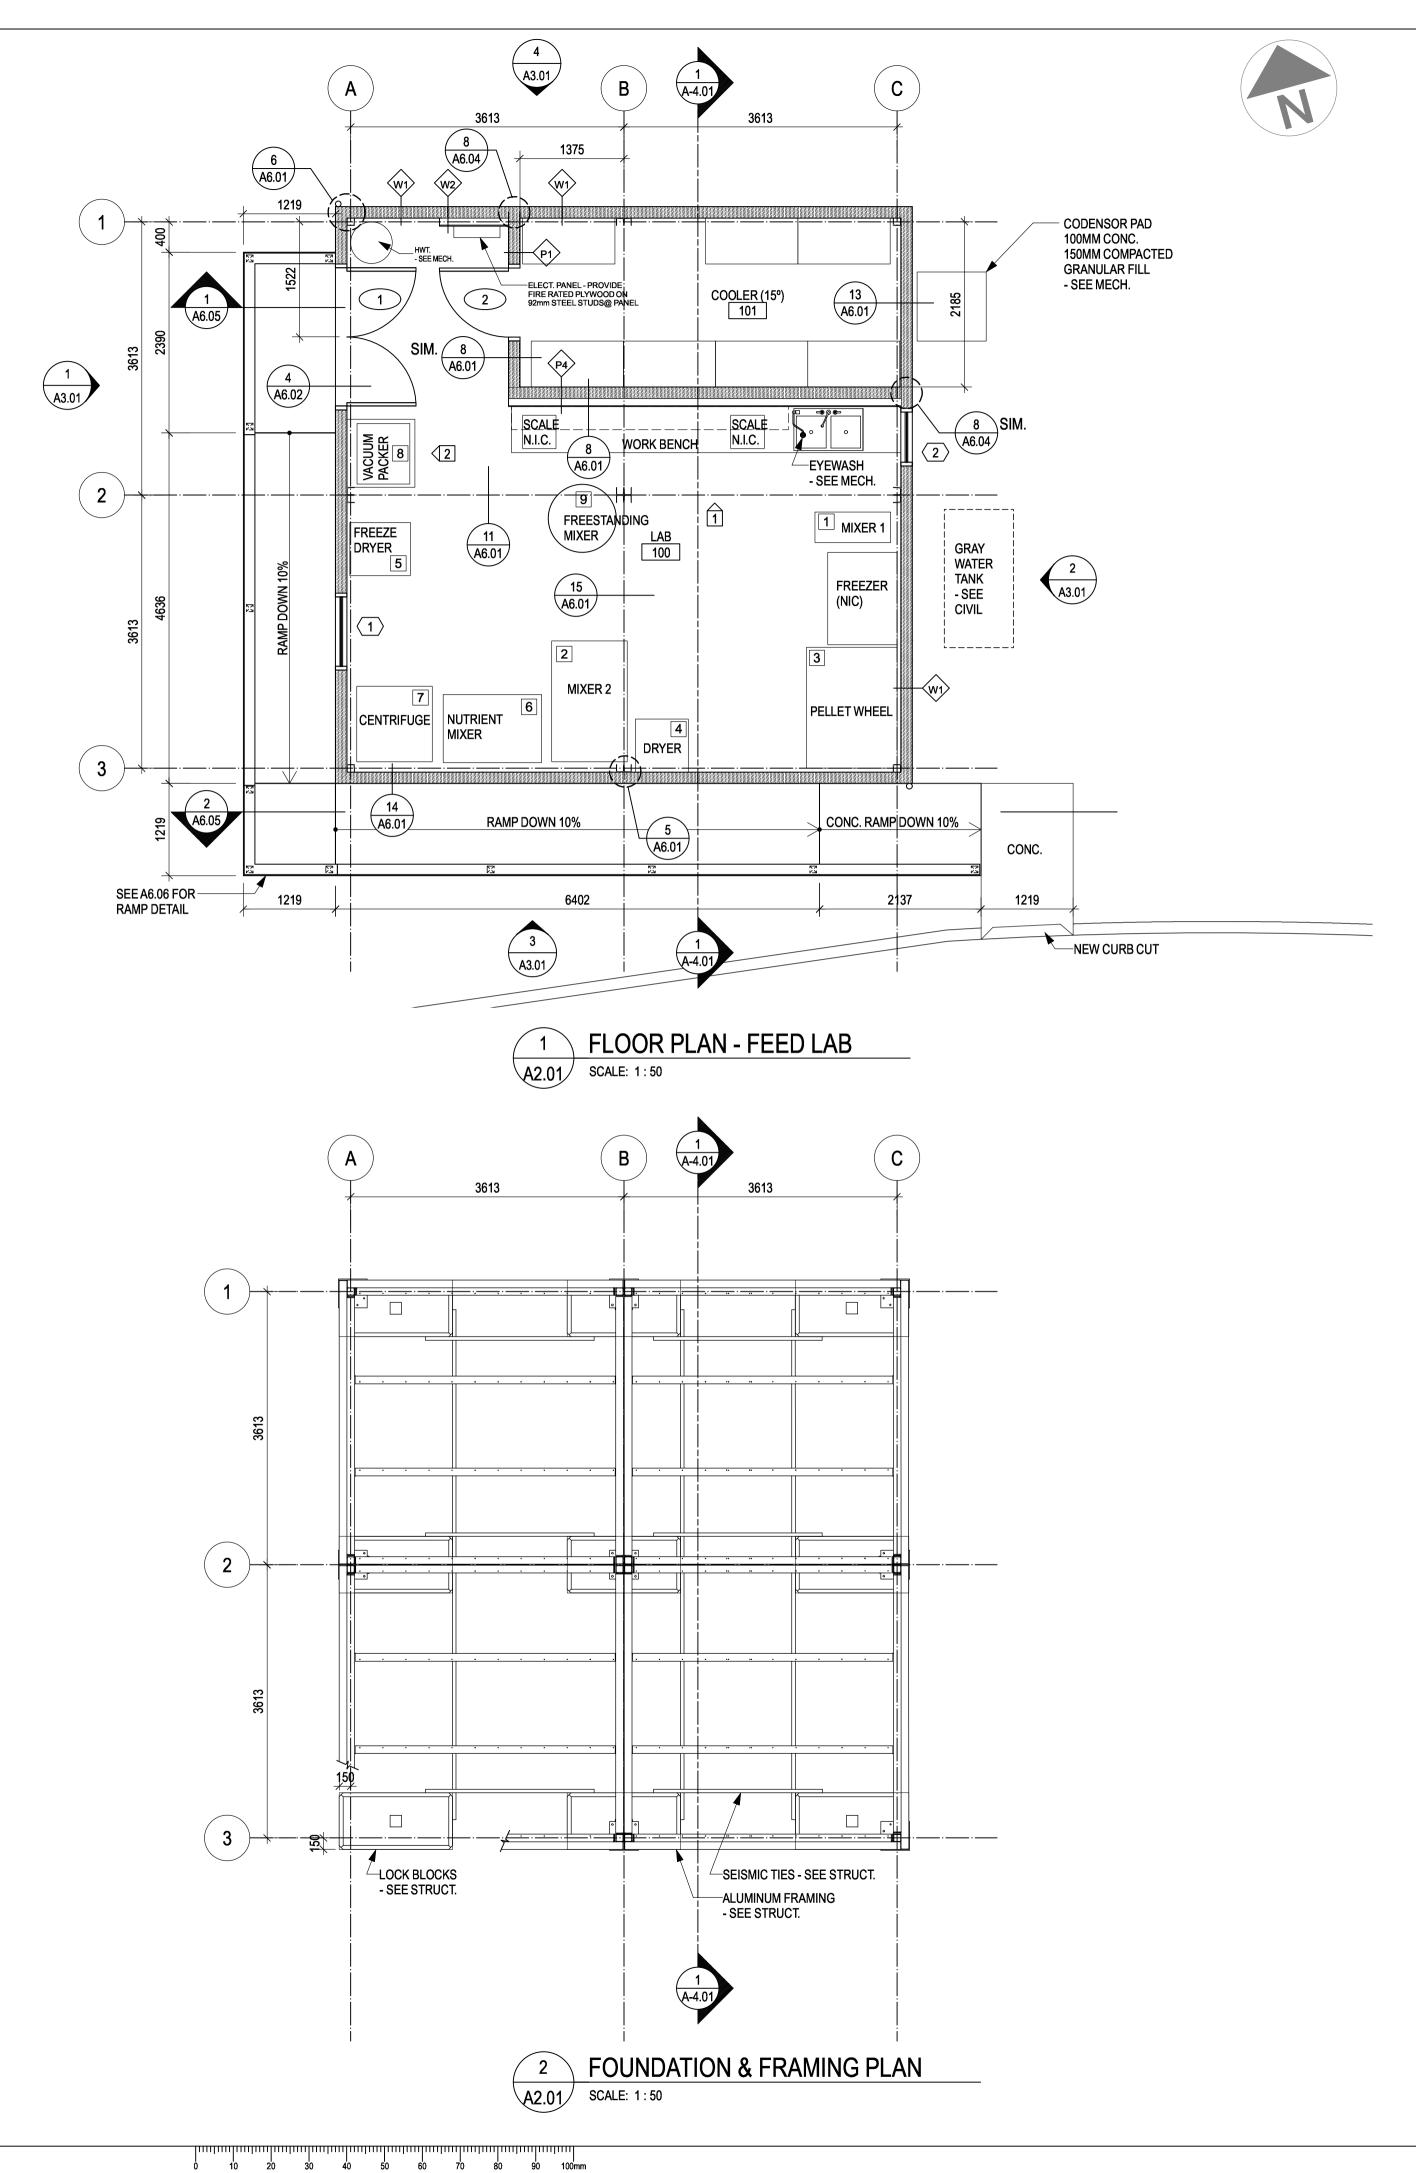


Public Works and Government Services Services gouvernementaux Canada

REAL PROPERTY SERVICES
Pacific Region
SERVICES IMMOBILIERS Région de Pacifique



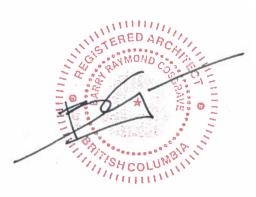

7 SEE A7.01 FOR ELEVATIONS

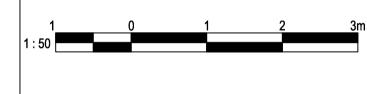

2	TENDER	2018-08-1
1	REVIEW	2018-07-2
Revision/ Revision	Description/Description	Date/Date

#### FISHERIES AND OCEANS, **REAL PROPERTY,** SAFETY AND SECURITY

**VANCOUVER, BC** 200-401 BURRARD ST.

**CENTER FOR AQUACULTURE & ENVIRONMENTAL RESEARCH** 

#### **NEW & RENOVATED LABS**

4160 Marine Dr, West Vancouver

Consultant Signature Box Only

Designed by/Concept par

Drawn by/Dessine par

PWGSC Project Manager/Administrateur de Projets TPSGC

PWGSC, Regional Manager, Architectural and Engineering Services/ Gestionnaire régionale, Services d'architectural et de génie, TPSGC PREETIPAL PAUL

Drawing title/Titre du dessin


**FEED LAB FLOOR PLANS FOUNDATION &** FRAMING PLAN


Project No./No. du projet

A2.01 1

DM5XXXXXX

PWGSC - A1 - 841X594

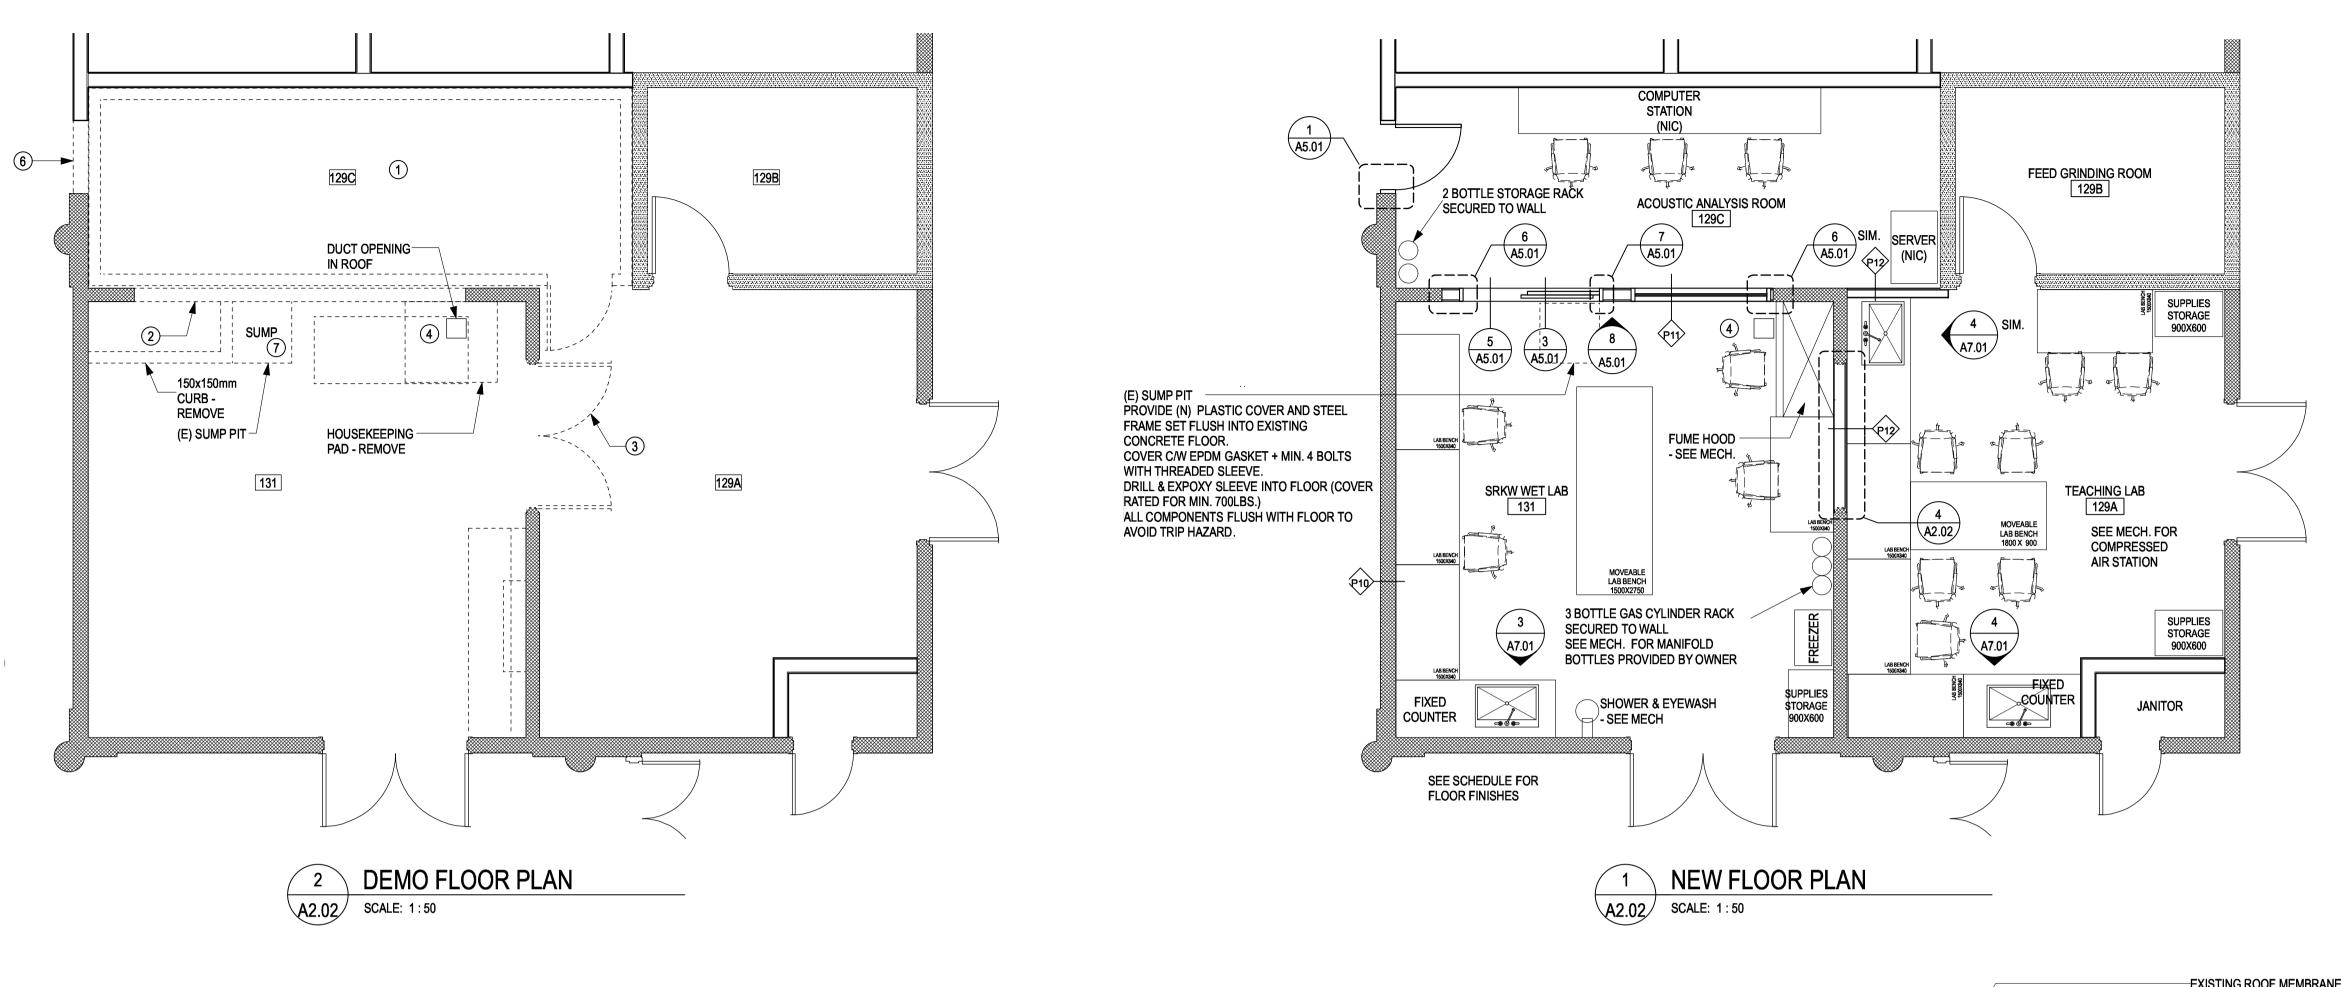

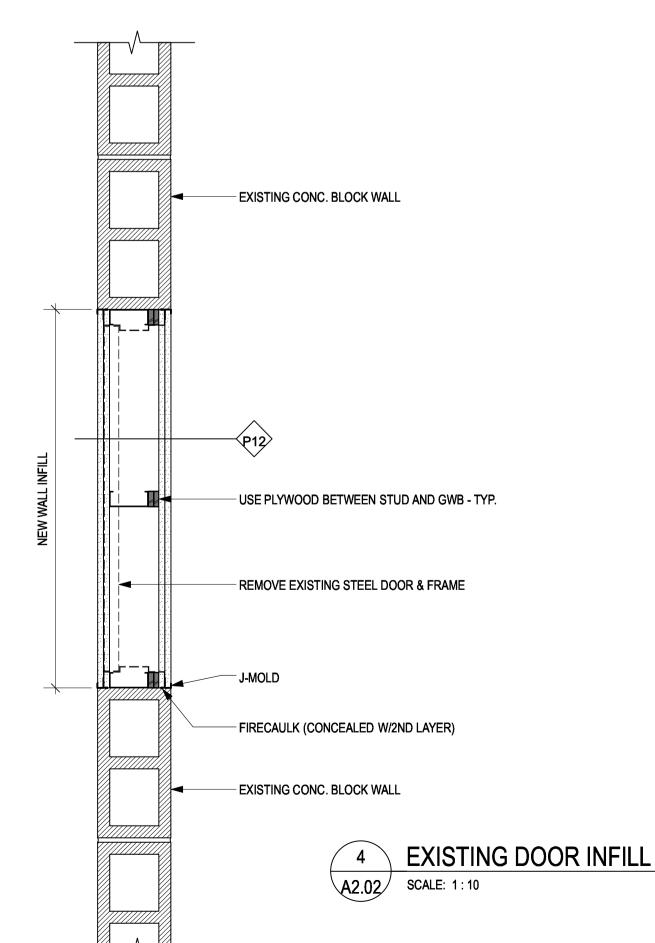



#### **DEMO NOTES**:

- 1 REMOVE (E) INSULATED FREESTANDING COOLER
- 2 REMOVE (E) CONC. BLOCK TO U/S OF CONC. SLAB CEILING (4050mm TALL)
- 3 REMOVE (E) STEEL DOORS & FRAME



- 5 REMOVED CONC. PADS & CURBS TO BE GROUND FLUSH W/(E) SLAB TO REMAIN PATCH CONC. FLOOR WHERE CHIPPED OR DAMAGED BY REMOVAL
- 6 PROVIDE OPENING IN GWB. FOR NEW DOOR. PROVIDE (N) HEADER AS REQUIRED.
- 7 DRAIN AND CLEAN SUMP PIT WHEN ALL CUTTING AND DUST PRODUCING WORK IS COMPLETE.

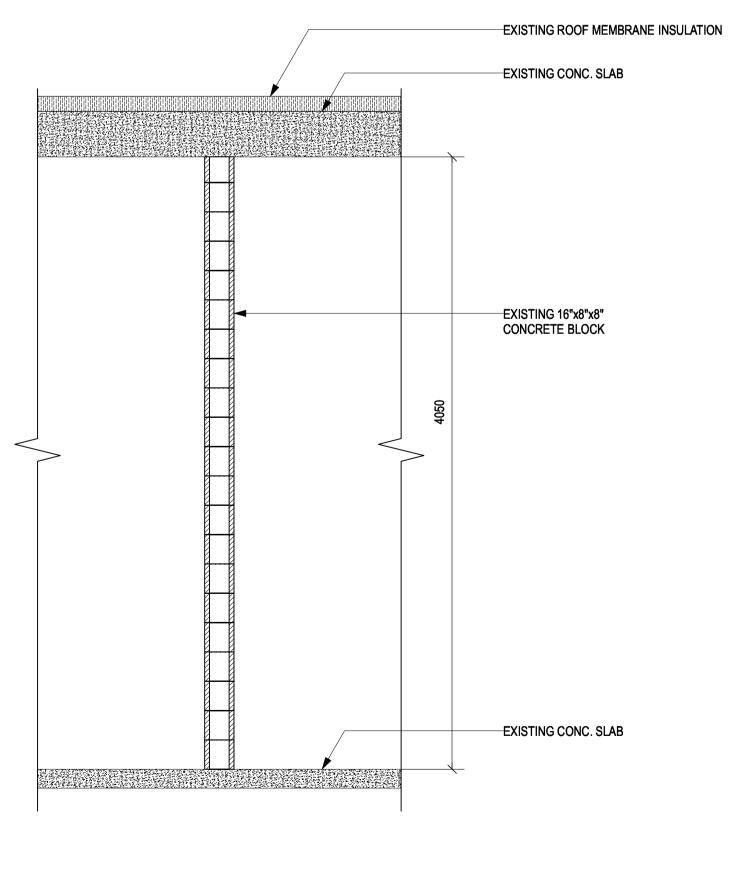

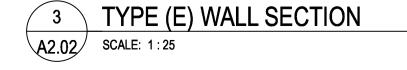


Public Works and Government Services Services gouvernementaux Canada

Public Works and Travaux publics et Services gouvernementaux Canada

REAL PROPERTY SERVICES
Pacific Region SERVICES IMMOBILIERS Région de Pacifique



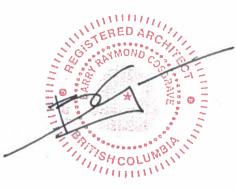

**GENERAL NOTES** 

• SEE MECH. FOR LOCATIONS OF COMPRESSED AIR ALL OUTLETS TO BE SURFACE MOUNT ON WALL ABOVE LAB BENCHES. MIN. 1020mm ABOVE FLOOR

• DRAIN AND CLEAN SUMP PIT WHEN ALL CUTTING AND DUST PRODUCING WORK IS COMPLETE.

2	TENDER	2018-08-16
1	REVIEW	2018-07-24
Revision/ Revision	Description/Description	Date/Date

#### FISHERIES AND OCEANS, **REAL PROPERTY, SAFETY AND SECURITY**

VANCOUVER, BC **200-401 BURRARD ST.** 

**CENTER FOR AQUACULTURE & ENVIRONMENTAL** RESEARCH

#### **NEW & RENOVATED LABS**

4160 Marine Dr, West Vancouver

Consultant Signature Box Only

Drawn by/Dessine par

Designed by/Concept par

PWGSC Project Manager/Administrateur de Projets TPSGC


PWGSC, Regional Manager, Architectural and Engineering Services/ Gestionnaire régionale, Services d'architectural et de génie, TPSGC PREETIPAL PAUL

Drawing title/Titre du dessin

LABS 129A, 129C, 131 **DEMO PLAN, NEW PLAN** 

Project No./No. du projet


A2.02

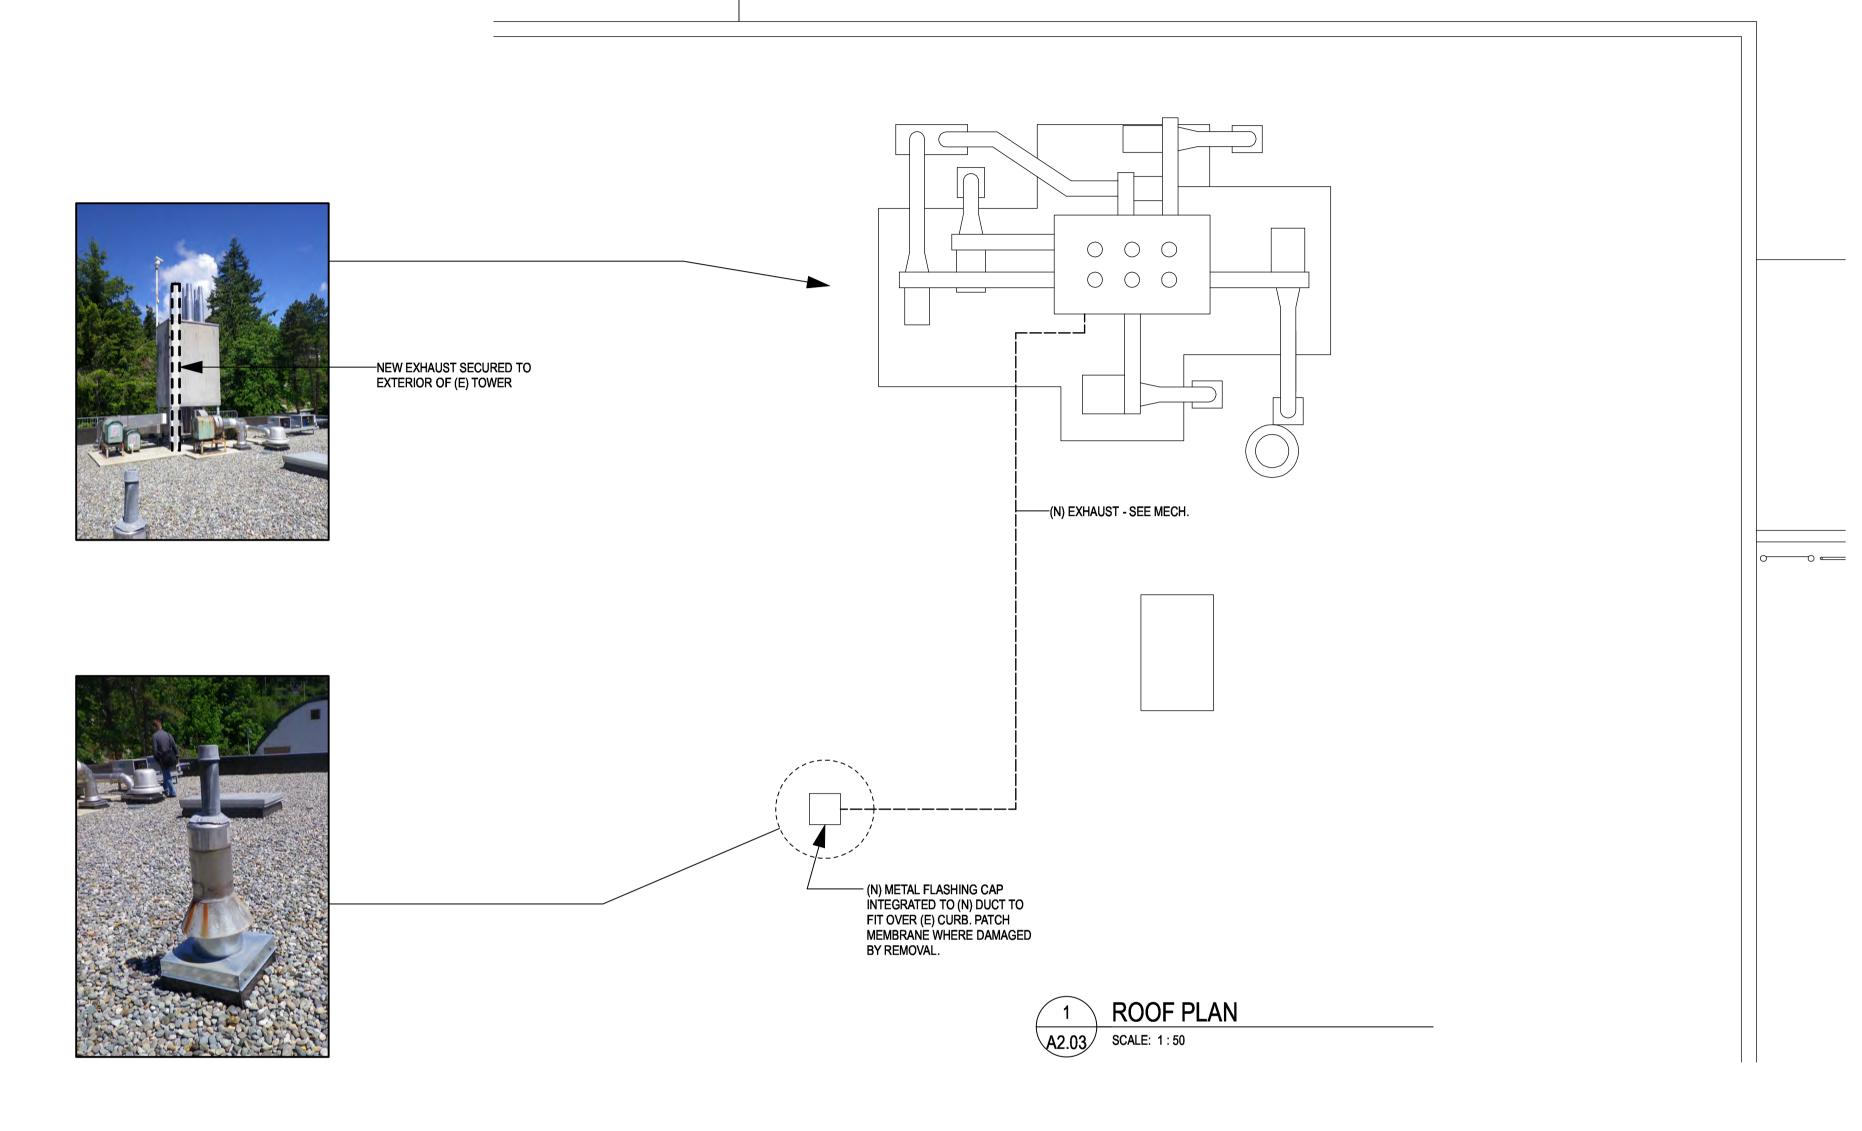

Public Works and Government Services Canada Travaux publics et Services gouvernementaux Canada

REAL PROPERTY SERVICES
Pacific Region
SERVICES IMMOBILIERS Région de Pacifique



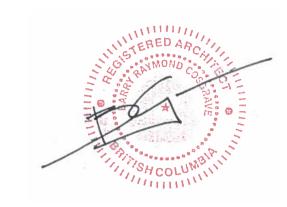

2	TENDER	2018-08-16
1	REVIEW	2018-07-24
Revision/ Revision	Description/Description	Date/Date

## FISHERIES AND OCEANS, REAL PROPERTY, SAFETY AND SECURITY

**VANCOUVER, BC** 200-401 BURRARD ST.

Client/client

**CENTER FOR AQUACULTURE & ENVIRONMENTAL** RESEARCH

#### **NEW & RENOVATED LABS**

4160 Marine Dr, West Vancouver

Consultant Signature Box Only

Designed by/Concept par

Drawn by/Dessine par

PWGSC Project Manager/Administrateur de Projets TPSGC

PWGSC, Regional Manager, Architectural and Engineering Services/ Gestionnaire régionale, Services d'architectural et de génie, TPSGC PREETIPAL PAUL


Drawing title/Titre du dessin


LABS 129A, 129C, 131 **ROOF PLAN** 


Project No./No. du projet


A2.03 1

PWGSC - A1 - 841X594

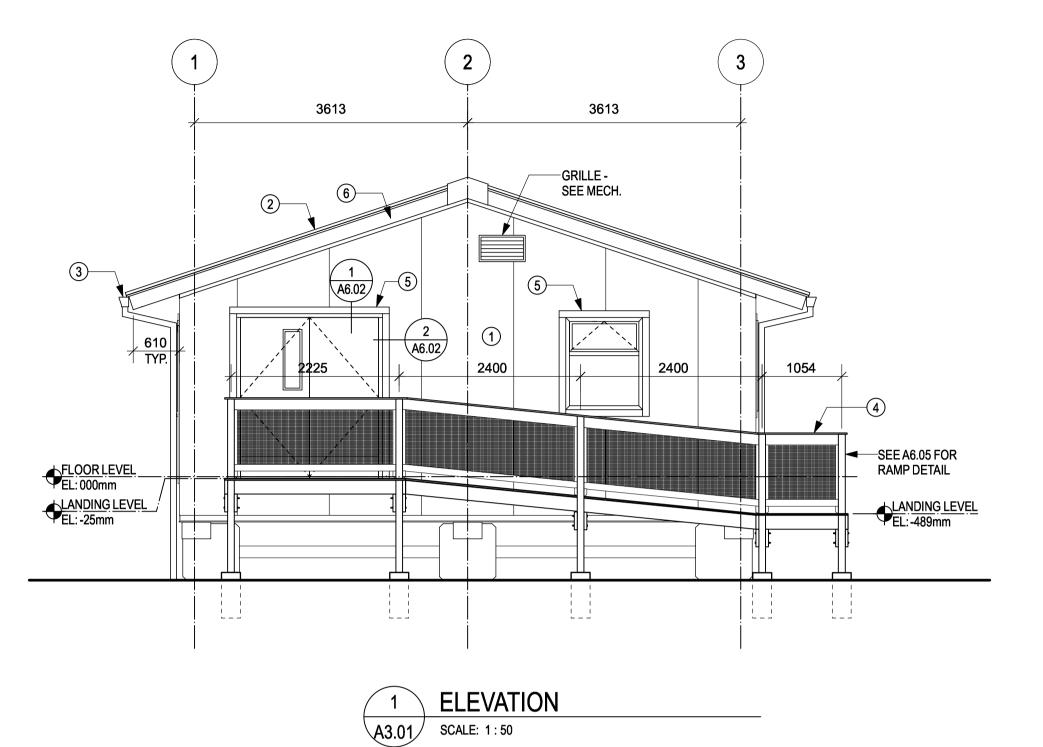

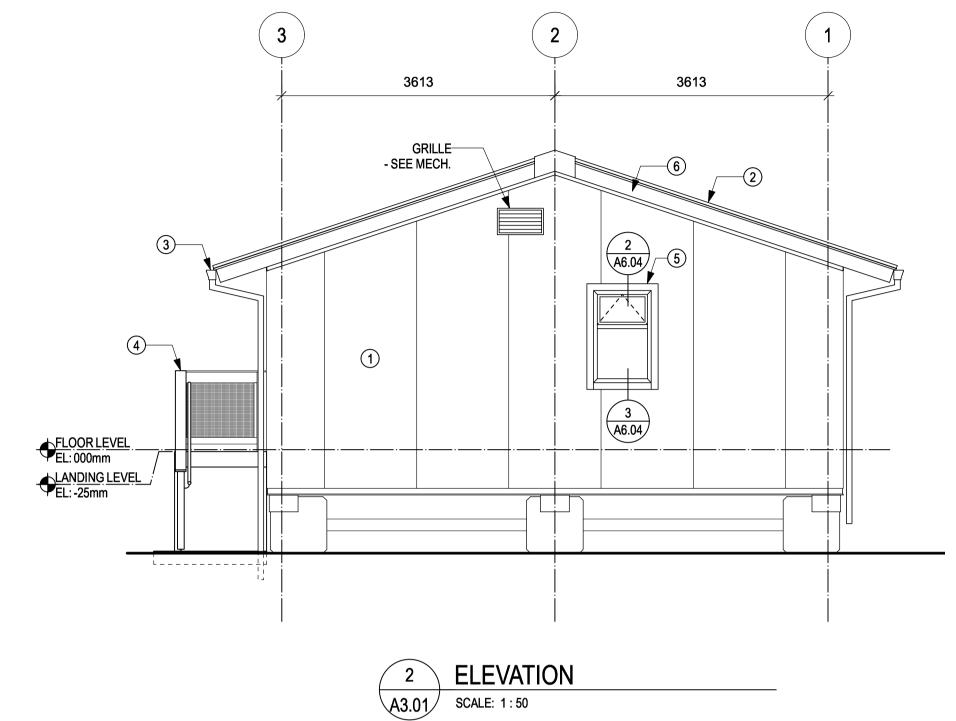


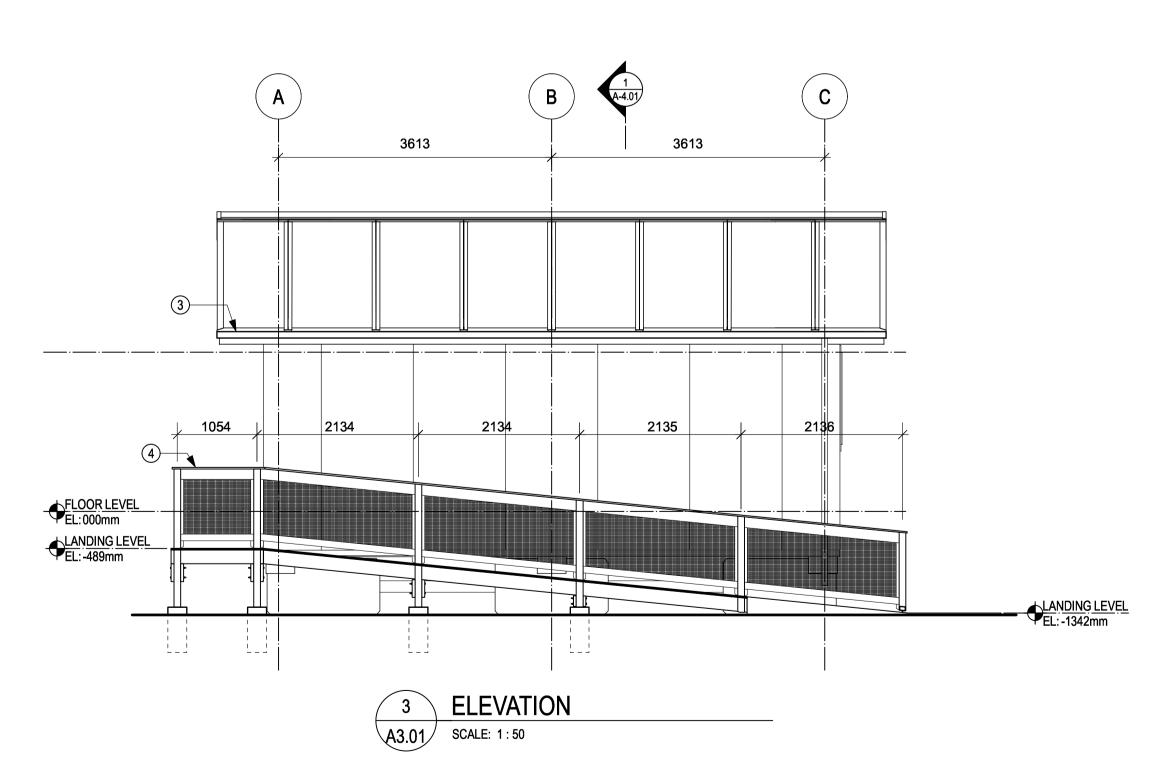

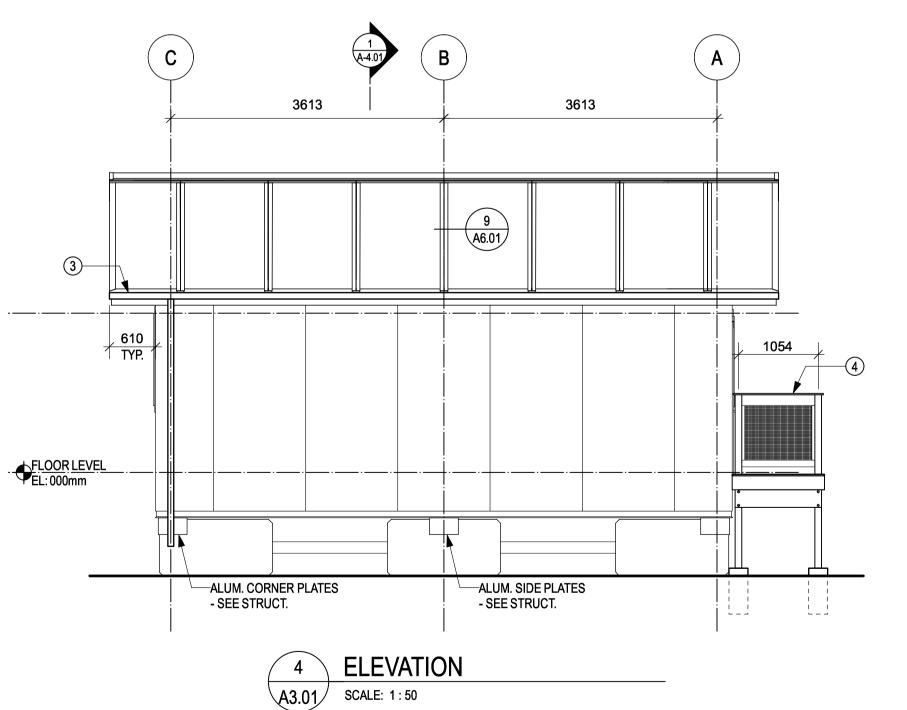


Public Works and Travaux publics et Services gouvernementaux Canada

REAL PROPERTY SERVICES
Pacific Region
SERVICES IMMOBILIERS Région de Pacifique

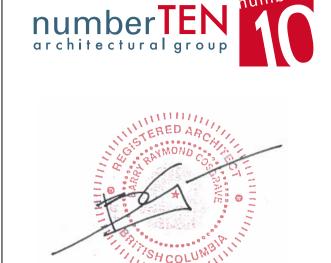

#### **KEY NOTES:**

- 1 EPS WALL PANEL
- 2 METAL ROOF
- 3 ALUMINUM GUTTER & DOWN SPOUT
- WOOD STAIRS & RAMP. GALV. RAILINGS. COMPOSITE CAP.
- 5 PREFINISHED GALVANIZED STEEL
  BATTEN FRAME. CONSULTANTS TO
  SELECT COLOUR FROM STANDARD
  RANGE
- 6 ALUM. FLASHING

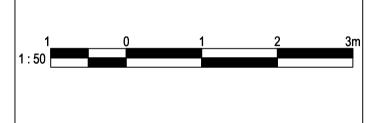

2	TENDER	2018-08-16
1	REVIEW	2018-07-24
Revision/ Revision	Description/Description	Date/Date
Client/client		

#### FISHERIES AND OCEANS, **REAL PROPERTY,** SAFETY AND SECURITY

**VANCOUVER, BC** 200-401 BURRARD ST.

**CENTER FOR AQUACULTURE & ENVIRONMENTAL RESEARCH** 

#### **NEW & RENOVATED LABS**

4160 Marine Dr, West Vancouver

Consultant Signature Box Only

Designed by/Concept par

Drawn by/Dessine par

PWGSC Project Manager/Administrateur de Projets TPSGC


PWGSC, Regional Manager, Architectural and Engineering Services/ Gestionnaire régionale, Services d'architectural et de génie, TPSGC PREETIPAL PAUL


Drawing title/Titre du dessin

**FEED LAB EXTERIOR ELEVATIONS** 

Project No./No. du projet


A3.01 1

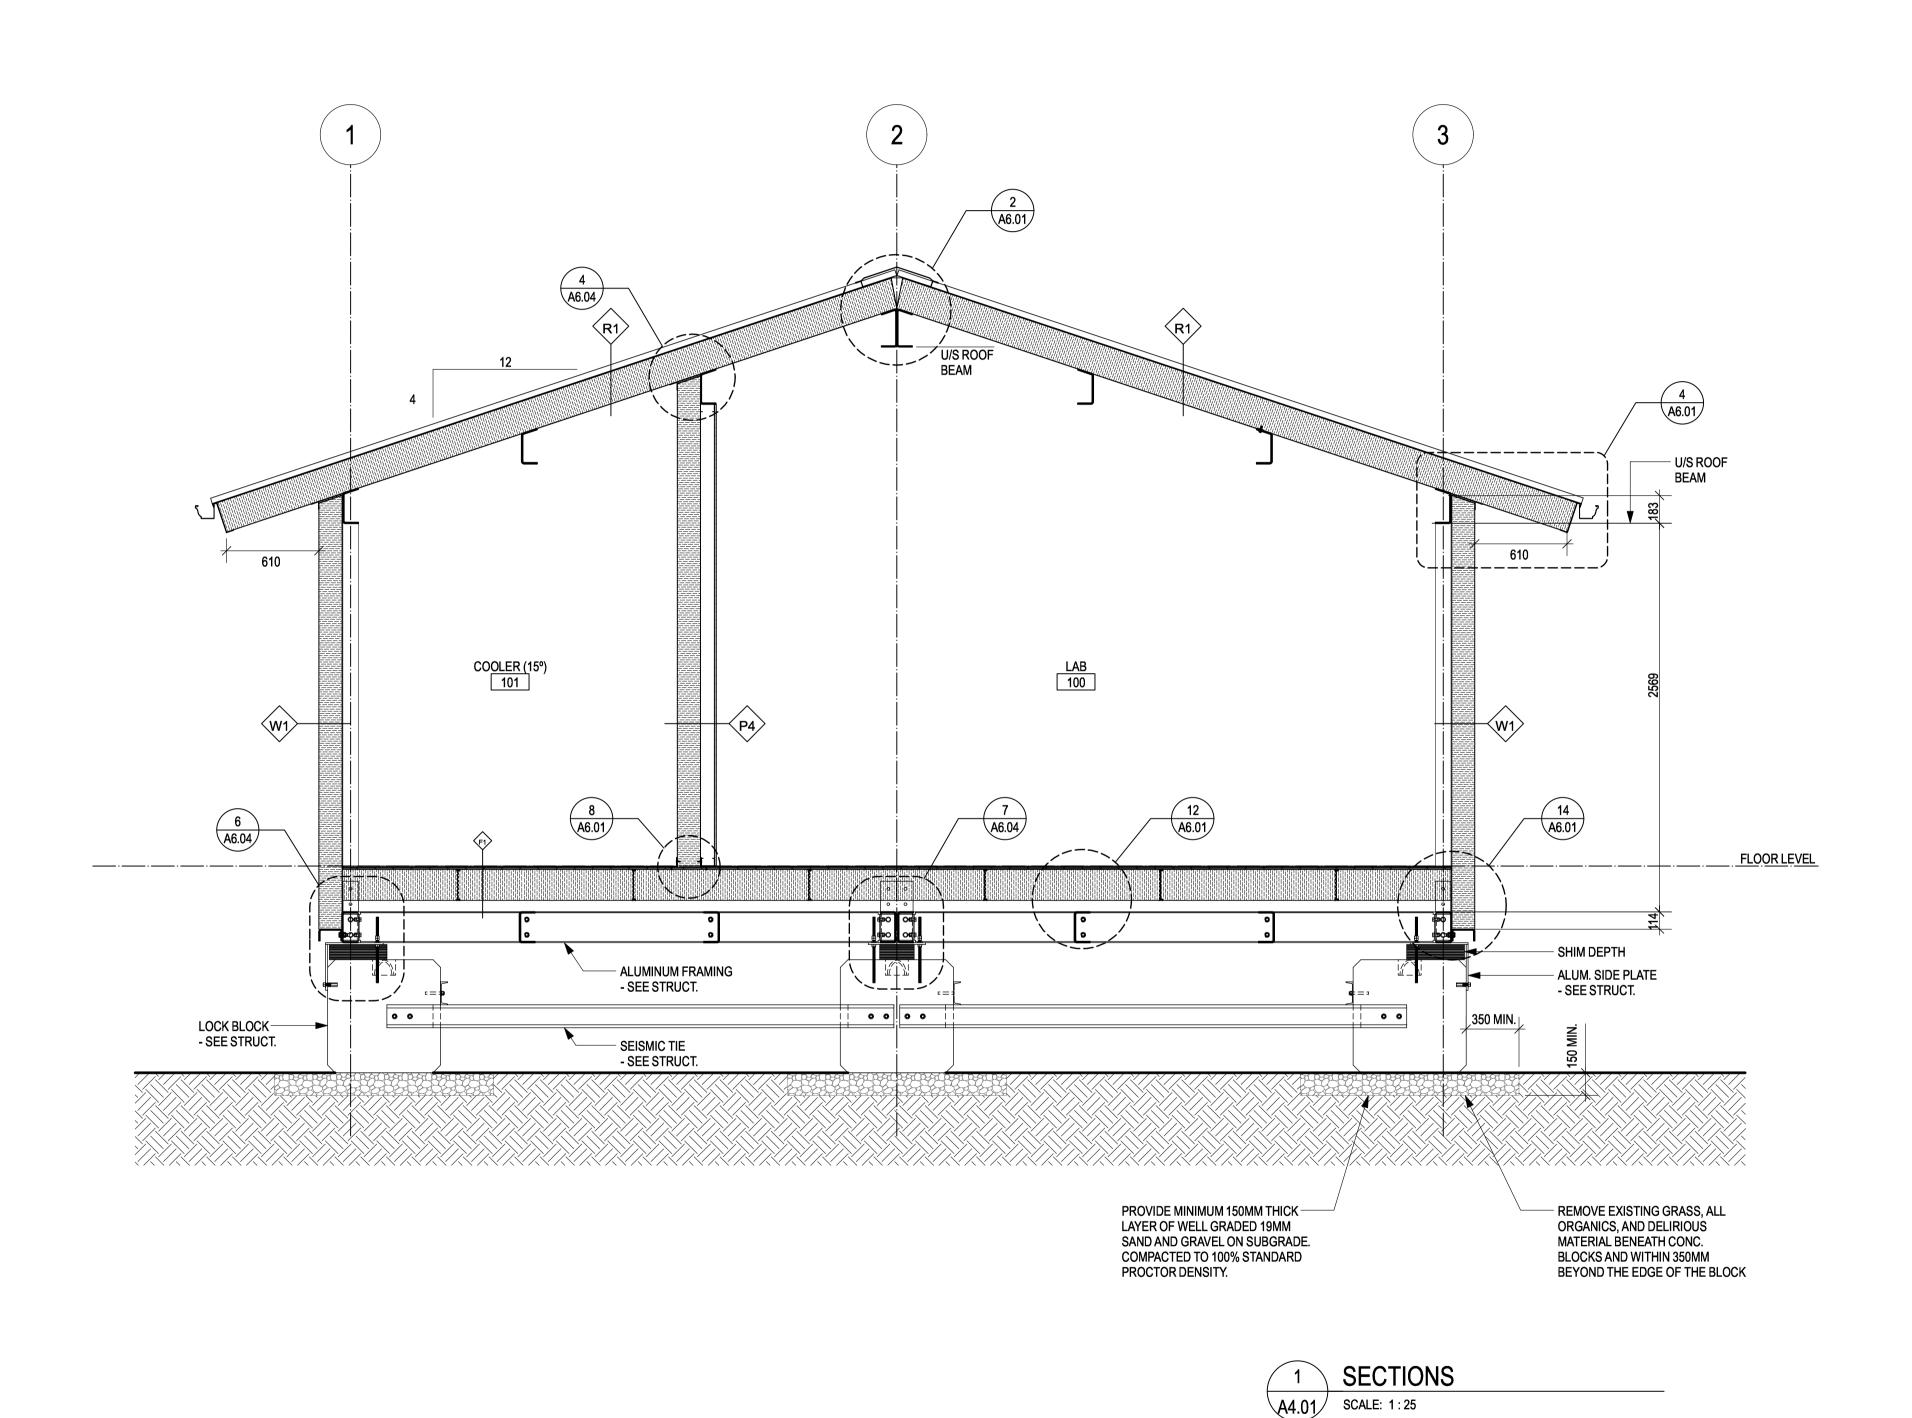


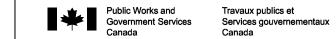

REAL PROPERTY SERVICES
Pacific Region
SERVICES IMMOBILIERS
Région de Pacifique



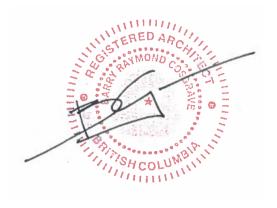

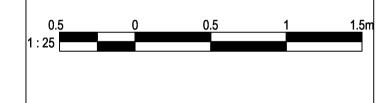

2	TENDER	2018-08-16
1	REVIEW	2018-07-24
Revision/ Revision	Description/Description	Date/Date
Client/client		

## FISHERIES AND OCEANS, REAL PROPERTY, SAFETY AND SECURITY

**VANCOUVER, BC** 200-401 BURRARD ST.

**CENTER FOR AQUACULTURE & ENVIRONMENTAL** RESEARCH

#### **NEW & RENOVATED LABS**

4160 Marine Dr, West Vancouver

Consultant Signature Box Only

Designed by/Concept par

Drawn by/Dessine par

PWGSC Project Manager/Administrateur de Projets TPSGC


PWGSC, Regional Manager, Architectural and Engineering Services/ Gestionnaire régionale, Services d'architectural et de génie, TPSGC PREETIPAL PAUL


Drawing title/Titre du dessin

**FEED LAB SECTION** 


Project No./No. du projet

A4.01 1

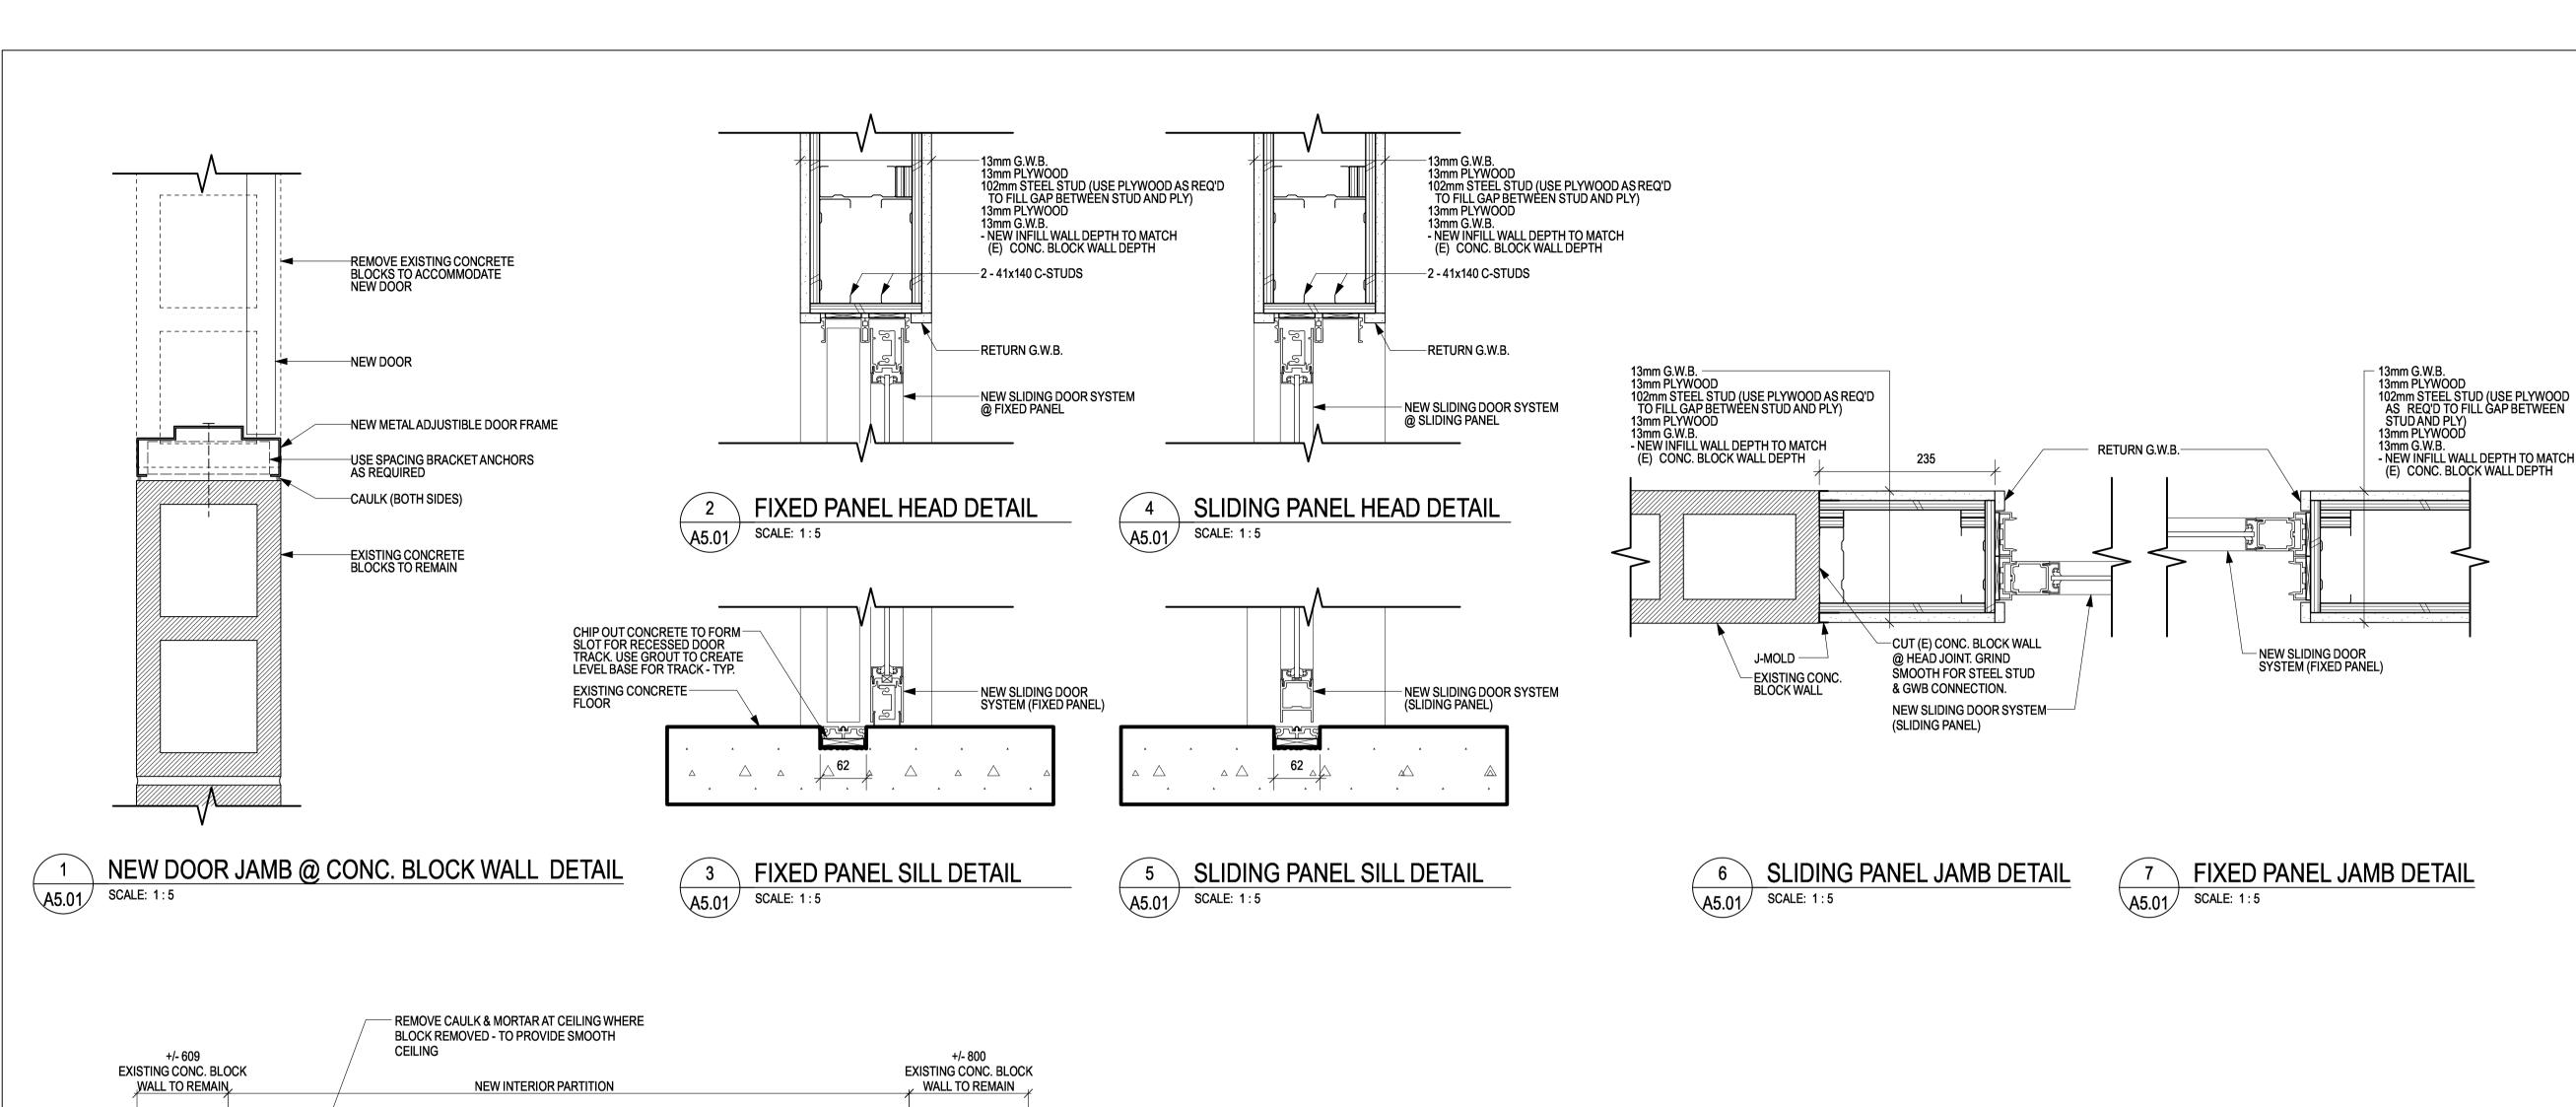

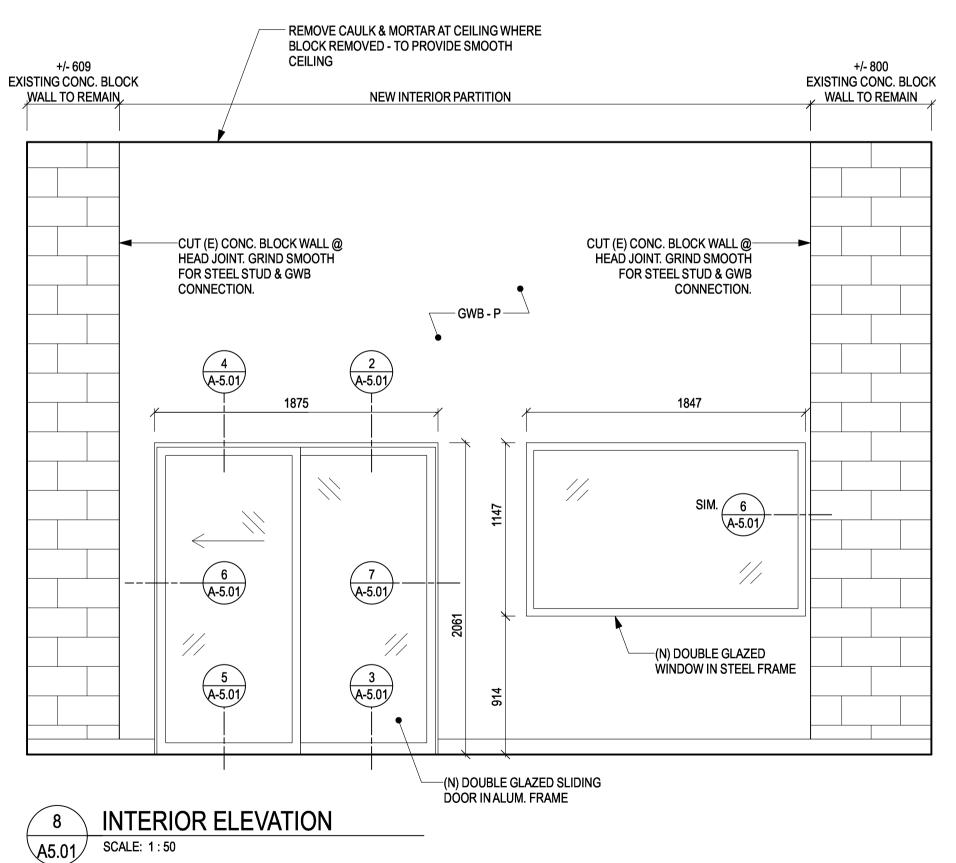

PWGSC - A1 - 841X594

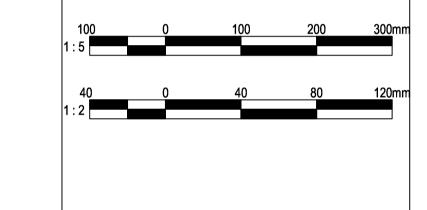

Public Works and Government Services Canada

REAL PROPERTY SERVICES Pacific Region SERVICES IMMOBILIERS

Région de Pacifique

Travaux publics et Services gouvernementaux

2	TENDER	2018-08-16
1	REVIEW	2018-07-24
Revision/ Revision	Description/Description	Date/Date
Client/clien	•	

#### **FISHERIES AND OCEANS, REAL PROPERTY, SAFETY AND SECURITY**

**VANCOUVER, BC 200-401 BURRARD ST.** 

**CENTER FOR AQUACULTURE & ENVIRONMENTAL** RESEARCH

#### **NEW & RENOVATED LABS**

4160 Marine Dr, West Vancouver

Consultant Signature Box Only Designed by/Concept par

Drawn by/Dessine par

PWGSC Project Manager/Administrateur de Projets TPSGC

PWGSC, Regional Manager, Architectural and Engineering Services/ Gestionnaire régionale, Services d'architectural et de génie, TPSGC PREETIPAL PAUL


Drawing title/Titre du dessin


LAB 129A, 129C, 131 **DETAILS** 


Project No./No. du projet

A5.01

0 10 20 30 40 50 60 70 80 90 100mm

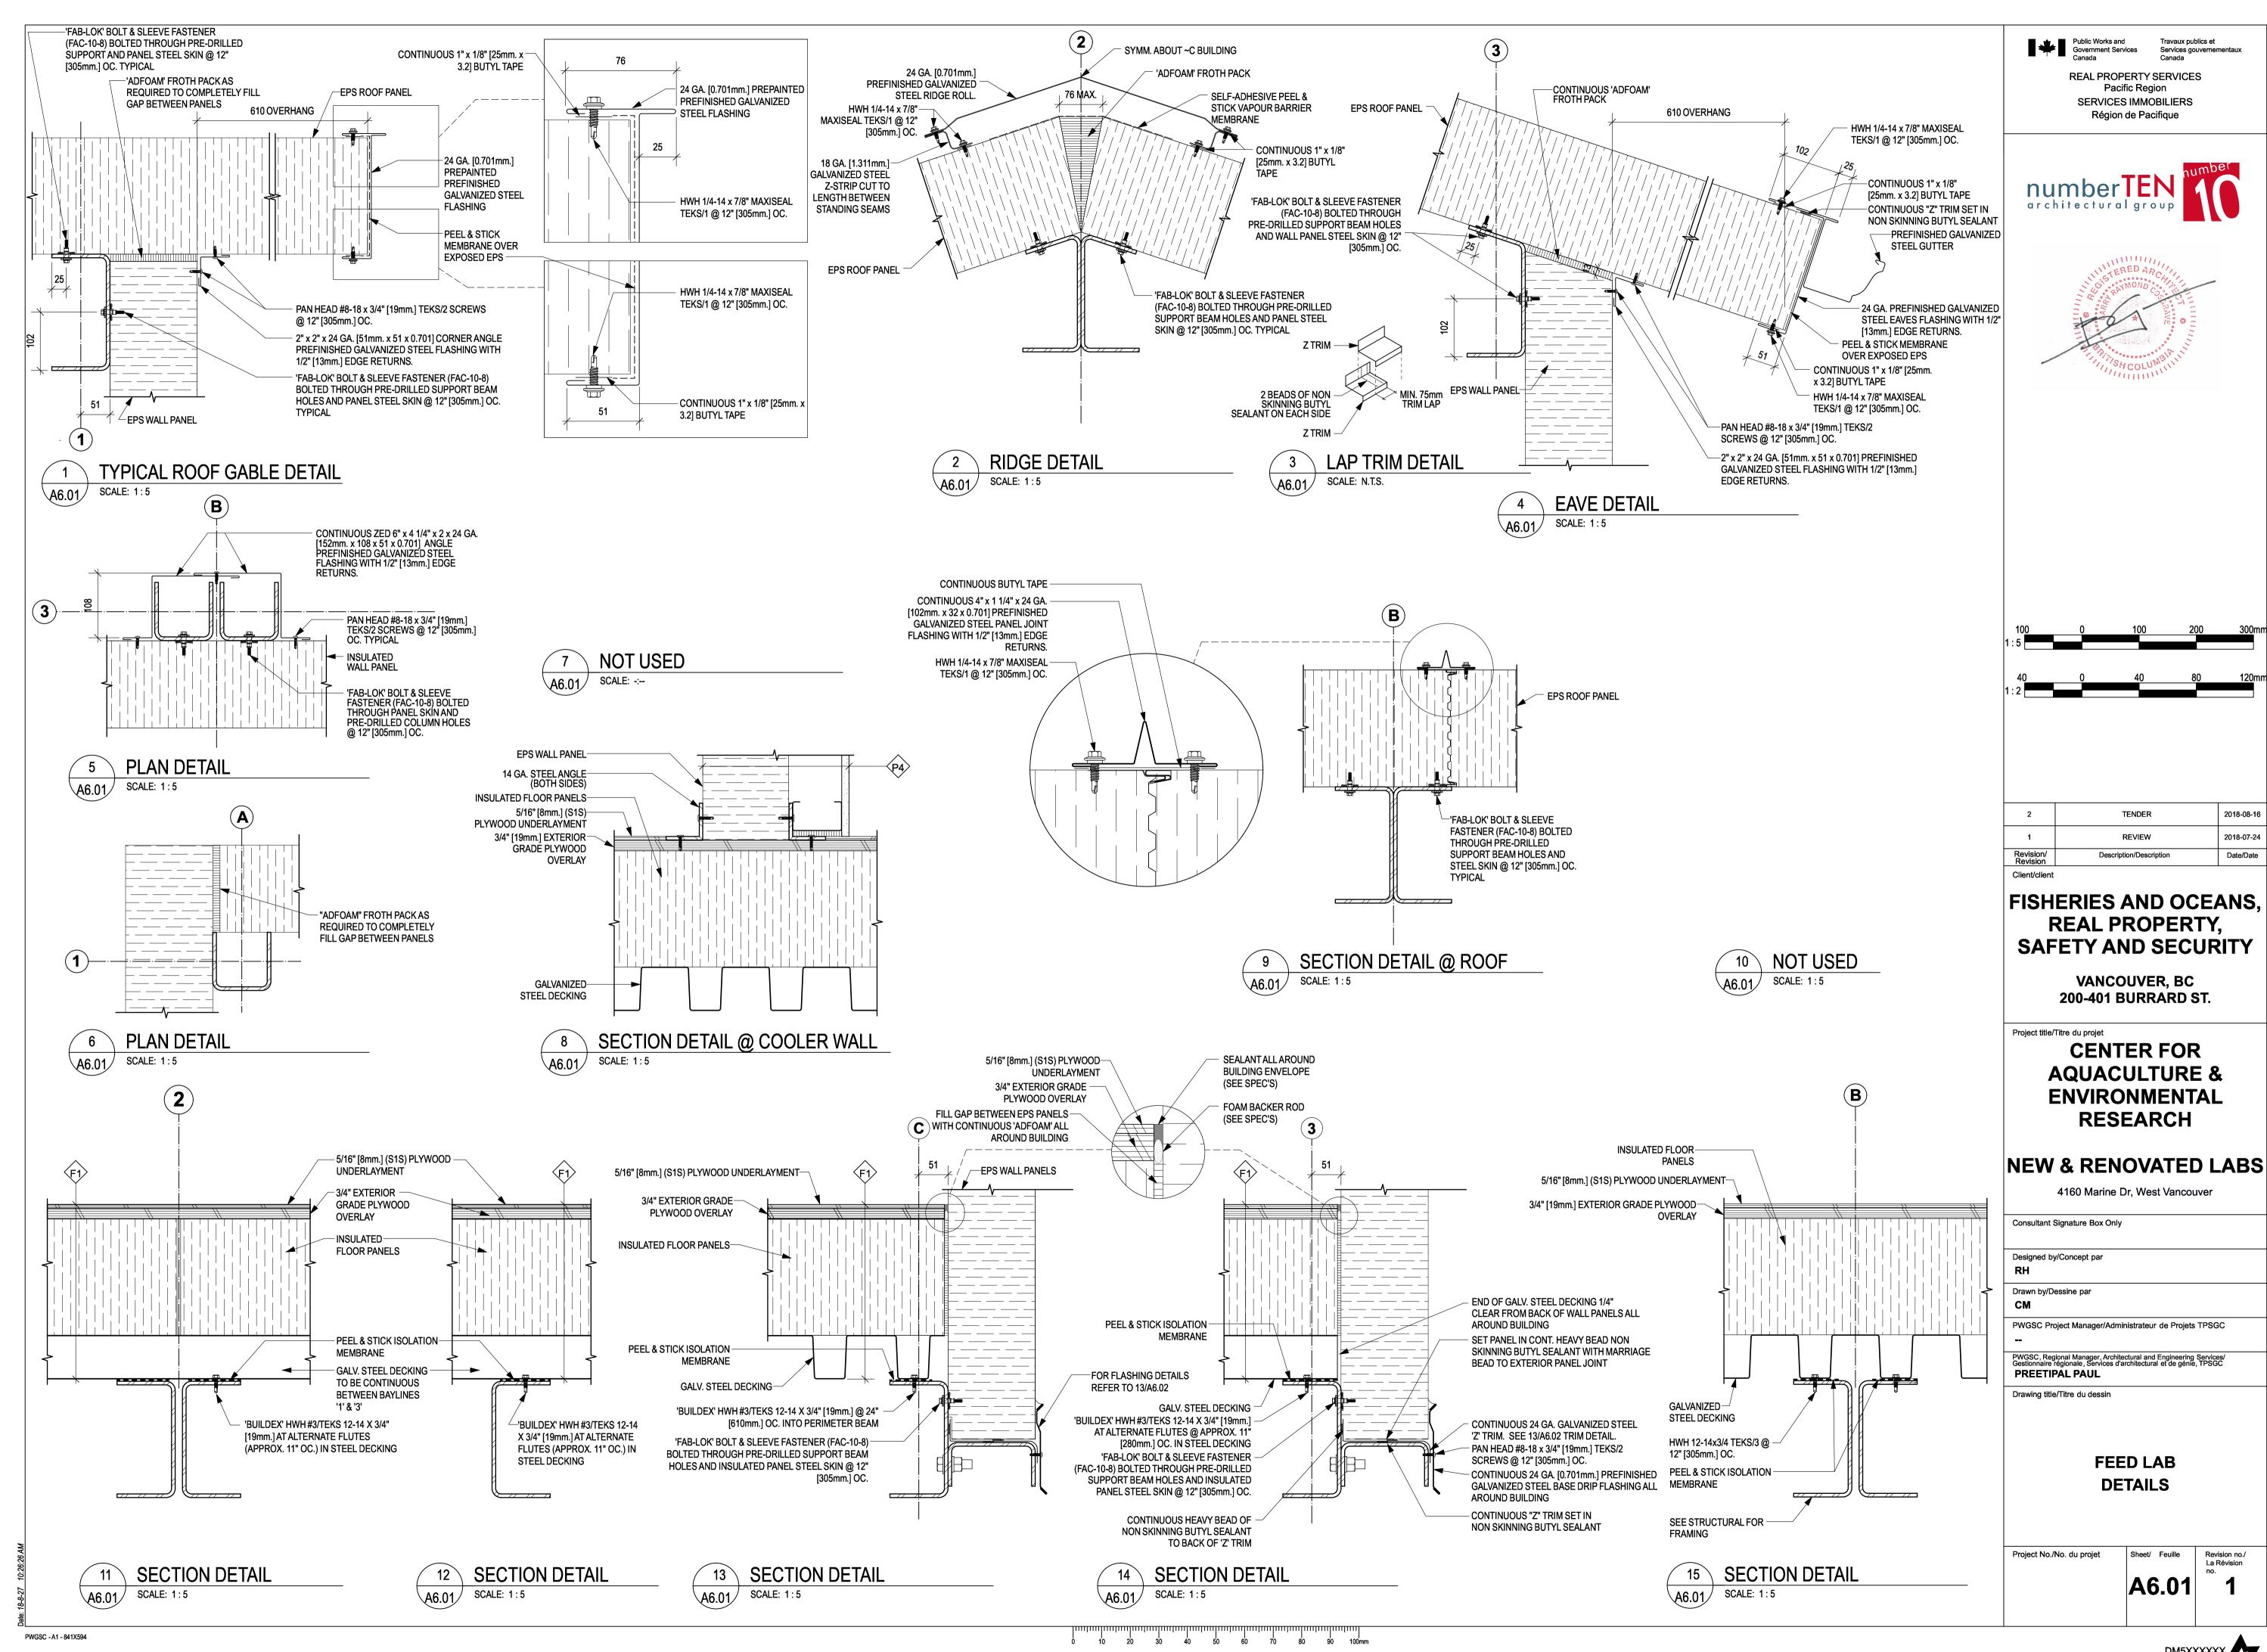

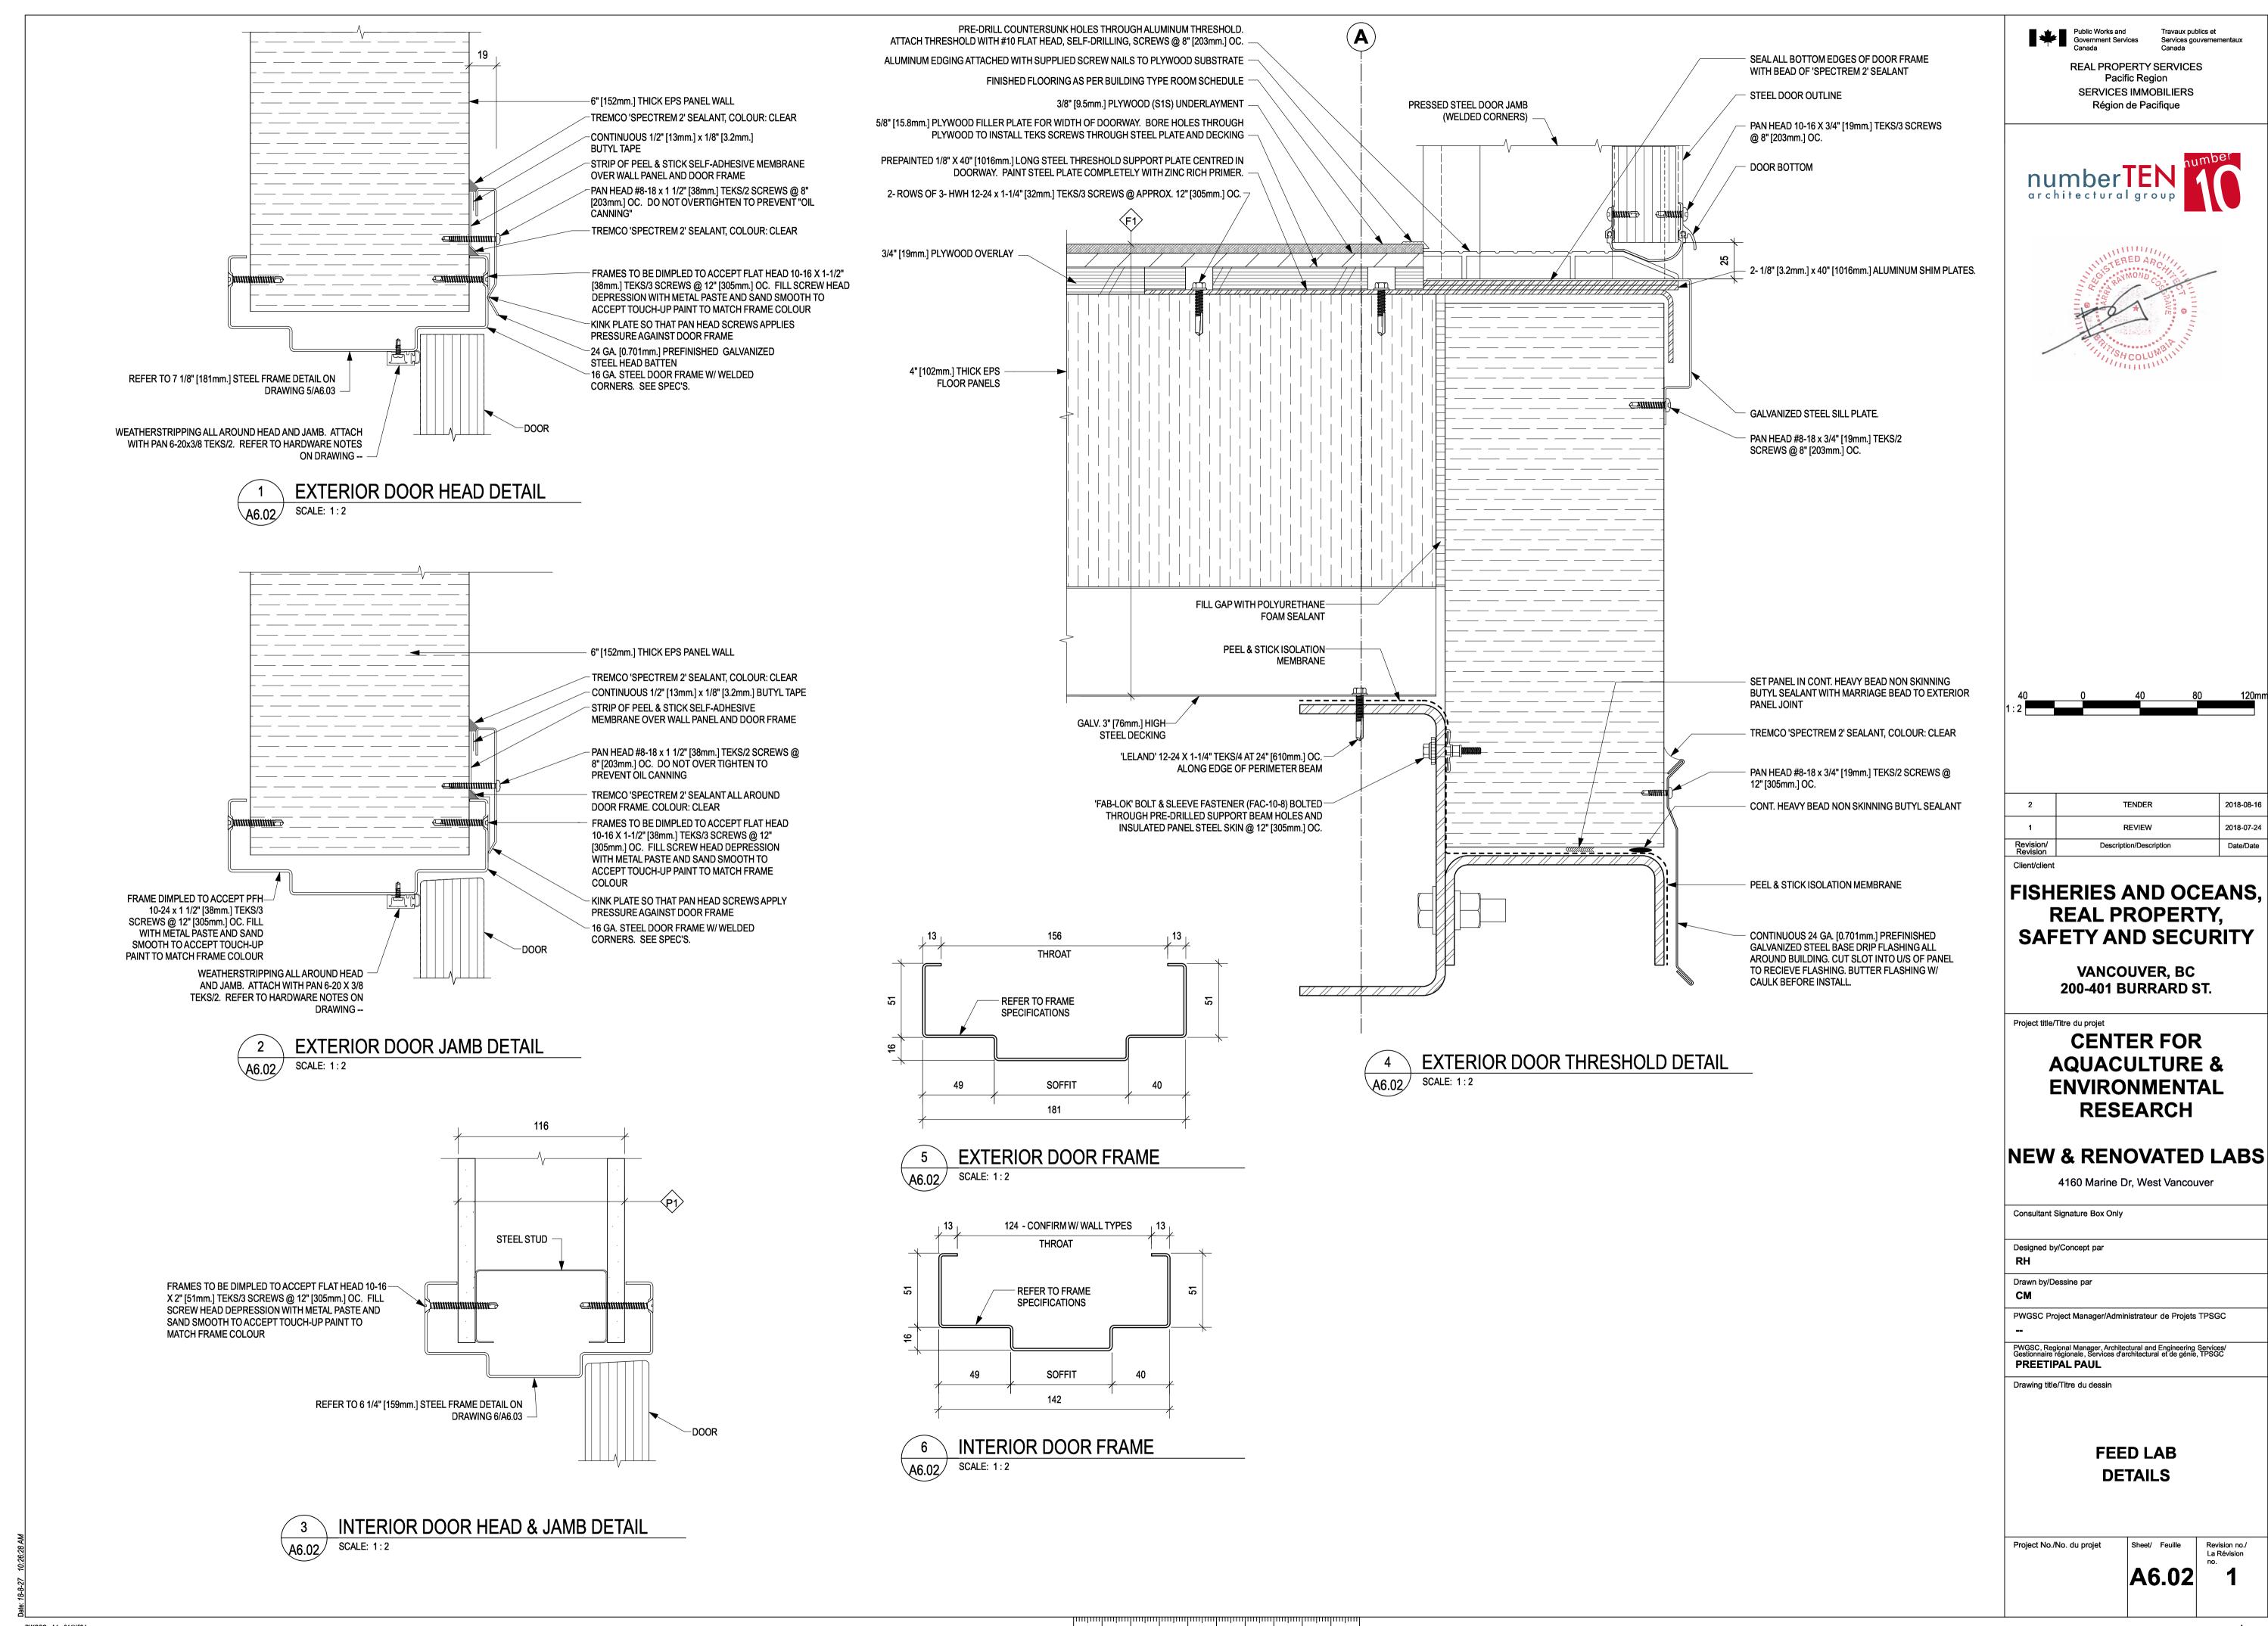

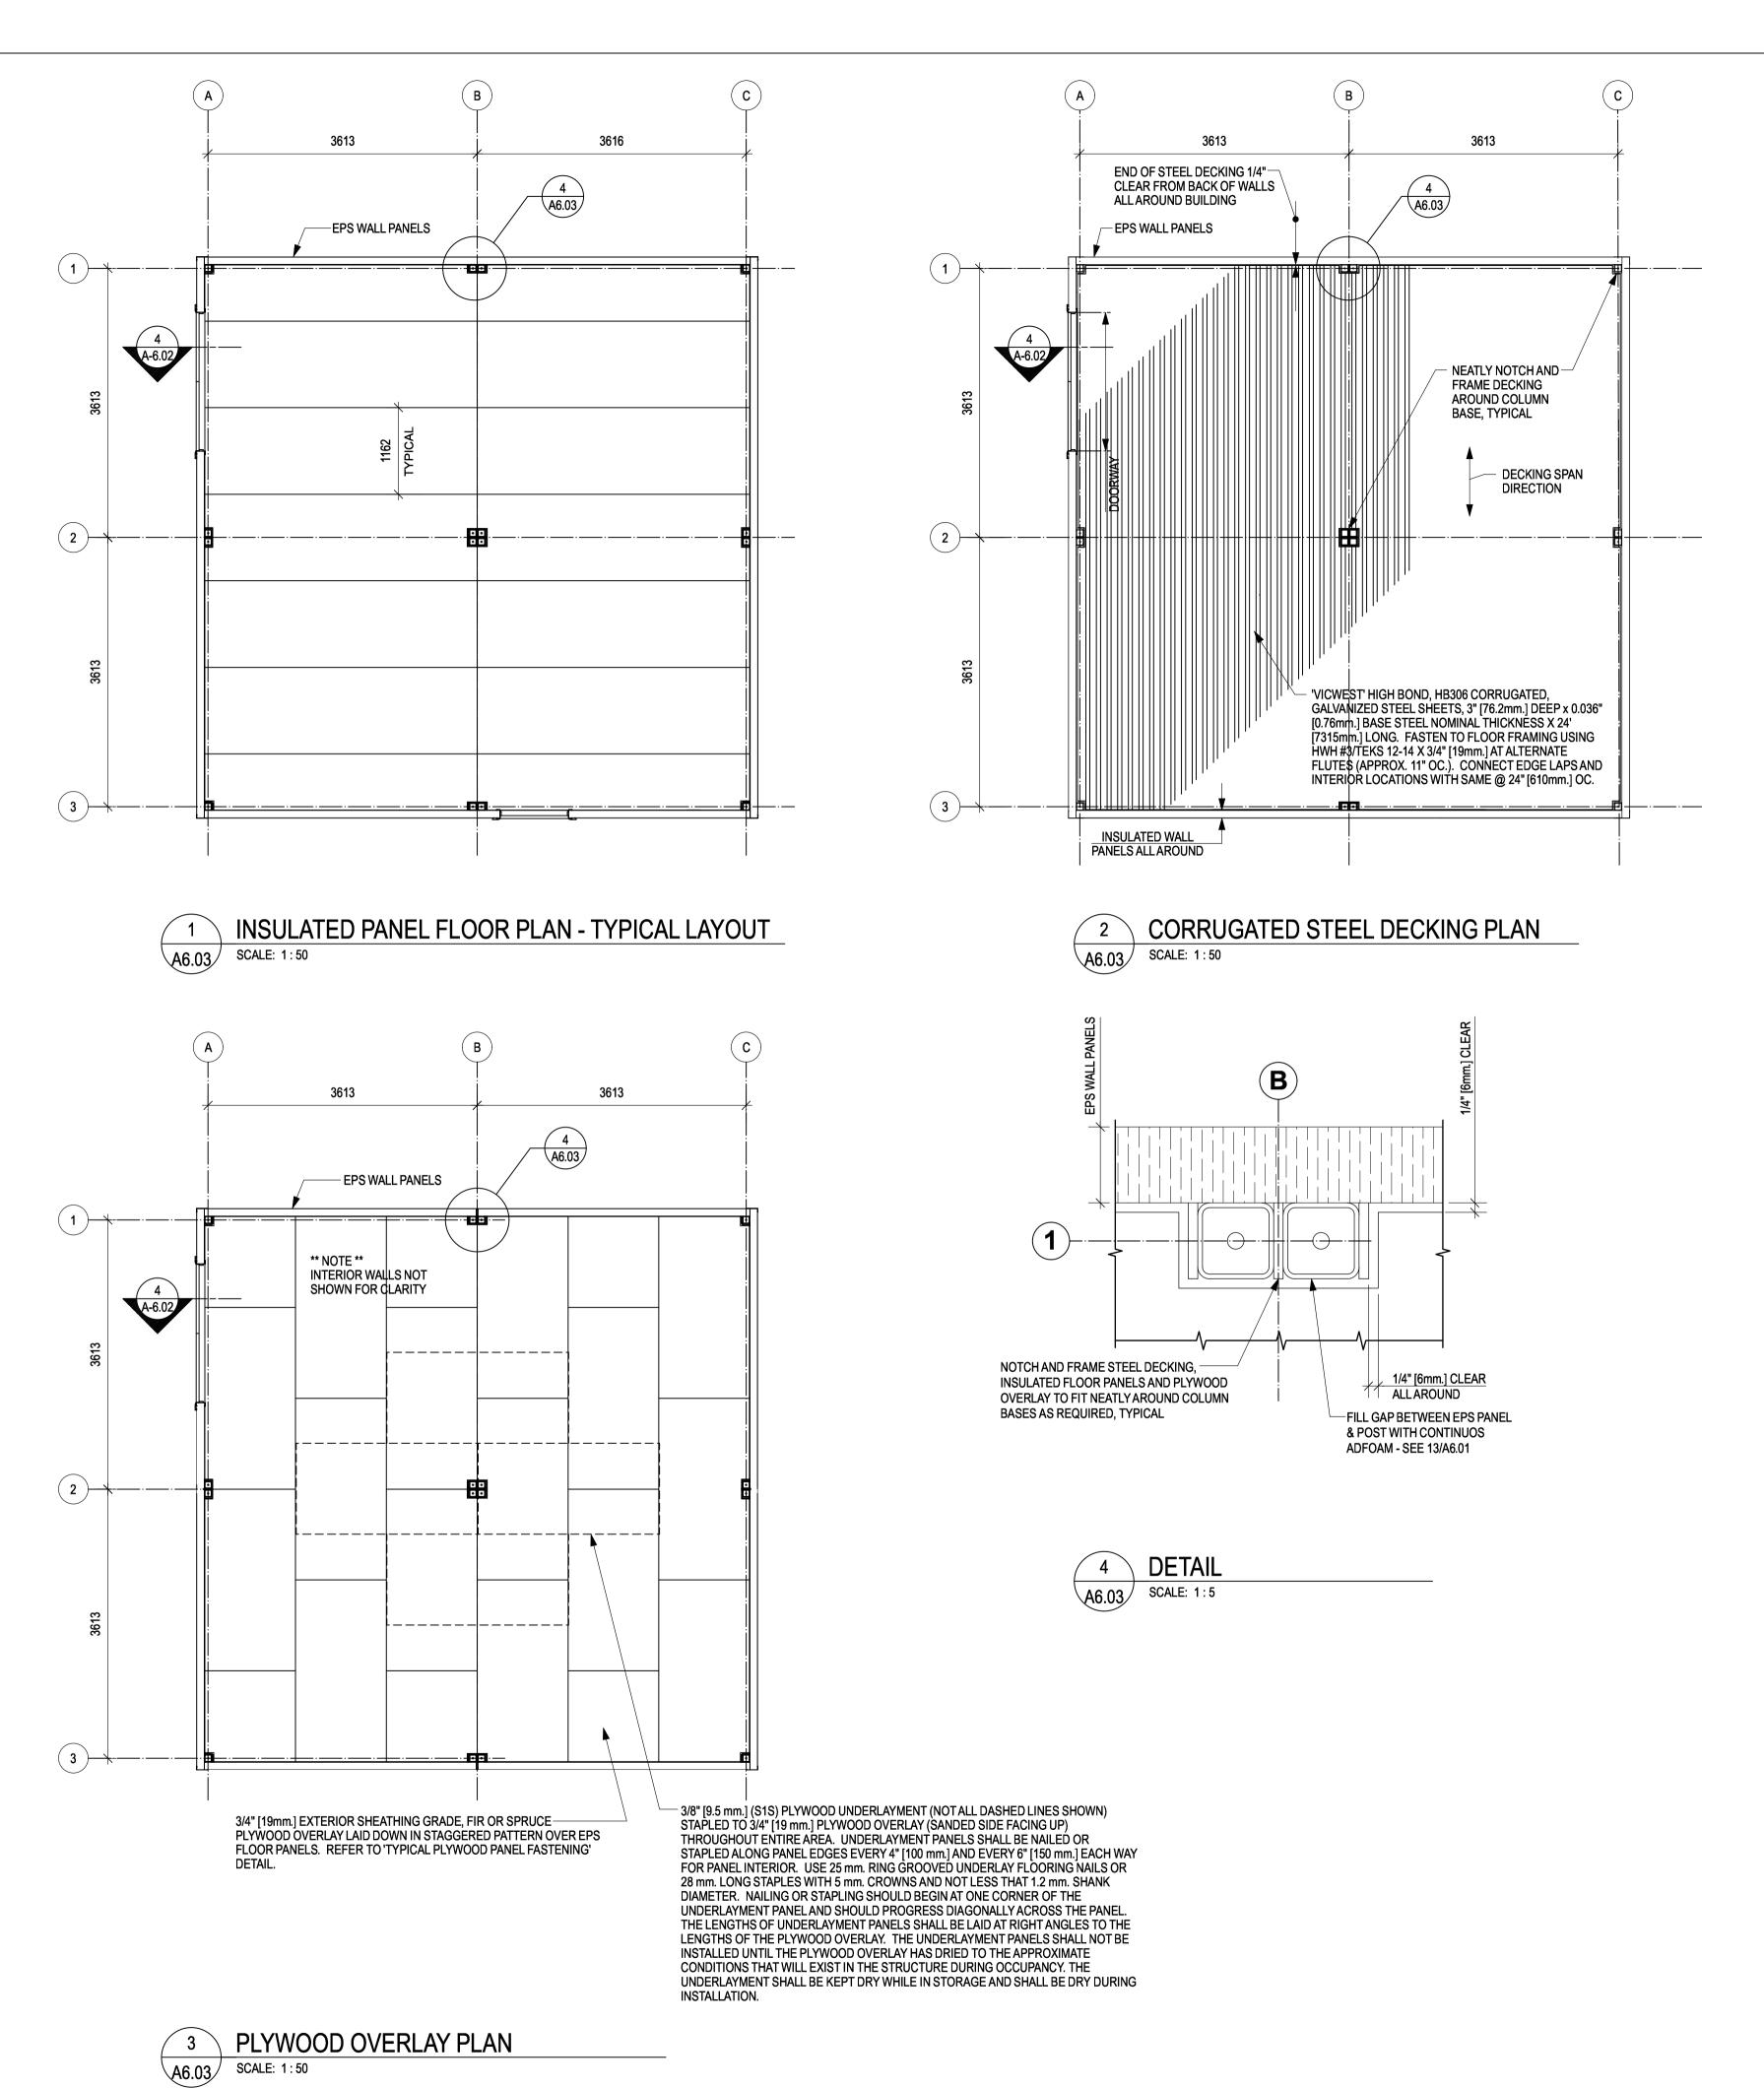


COURSE THREAD TYPE 'W', #6-9 x 1-5/8" [41mm.] #2 PHILLIPS DRIVE, BUGLE HEAD DRYWALL SCREWS WITH BLACK PHOSPHATE FINISH @ 8" [203mm.] EACH WAY. FASTEN SCREWS USING TORQUE LIMITING SCREW GUN TO SET SCREW HEADS 1/32" [0.8-1.0mm] BELOW PLYWOOD SURFACE. THE SCREW THREADS SHALL EXTEND THROUGH THE TOP 24 GA. STEEL SKIN OF EPS FLOOR PANEL.

5 TYPICAL PLYWOOD PANEL FASTENING


SCALE: 1:25

ota 3/4" [19mm.] EXTERIOR SHEATHING GRADE PLYWOOD SHEETS

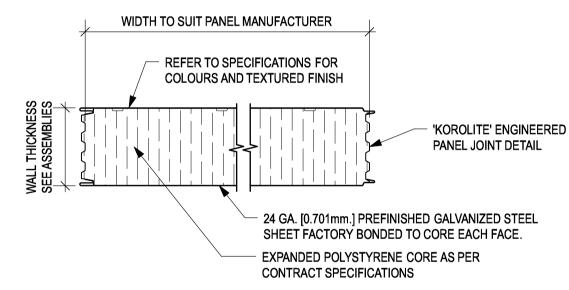

6 AND INTERIOR WALL PANEL

SCALE: 1:5

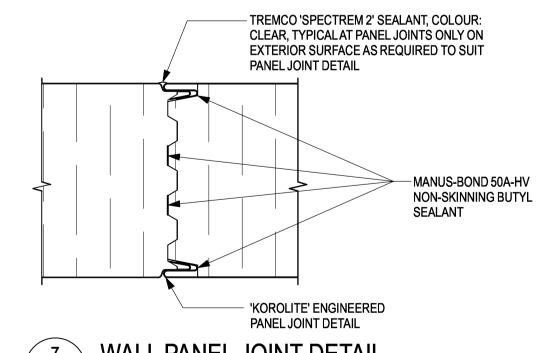


7 WALL PANEL JOINT DETAIL
A6.03 SCALE: 1:2


Public Works and Government Services Canada

Travaux publics et es Services gouvernementau Canada

REAL PROPERTY SERVICES
Pacific Region
SERVICES IMMOBILIERS
Région de Pacifique



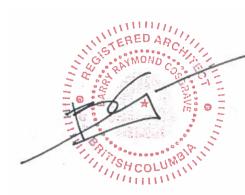

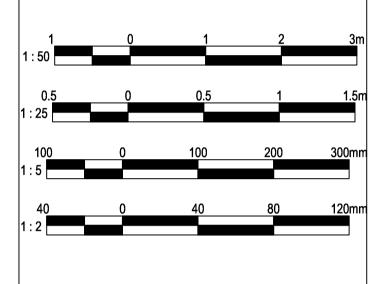

2	TENDER	2018-08-16
1	REVIEW	2018-07-24
Revision/ Revision	Description/Description	Date/Date
Client/client		

#### FISHERIES AND OCEANS, REAL PROPERTY, SAFETY AND SECURITY

VANCOUVER, BC 200-401 BURRARD ST.

Project title/Titre du proj

CENTER FOR AQUACULTURE & ENVIRONMENTAL RESEARCH

### NEW & RENOVATED LABS

4160 Marine Dr, West Vancouver

Consultant Signature Box Only

Designed by/Concept par

CM

PWGSC Project Manager/Administrateur de Projets TPSGC

PWGSC, Regional Manager, Architectural and Engineering Services/ Gestionnaire régionale, Services d'architectural et de génie, TPSGC

PREETIPAL PAUL


Drawing title/Titre du dessin


FEED LAB
DETAILS

Project No./No. du projet

Sheet/

Sheet/ Feuille Revision no./
La Révision no./
La Révision no./
1

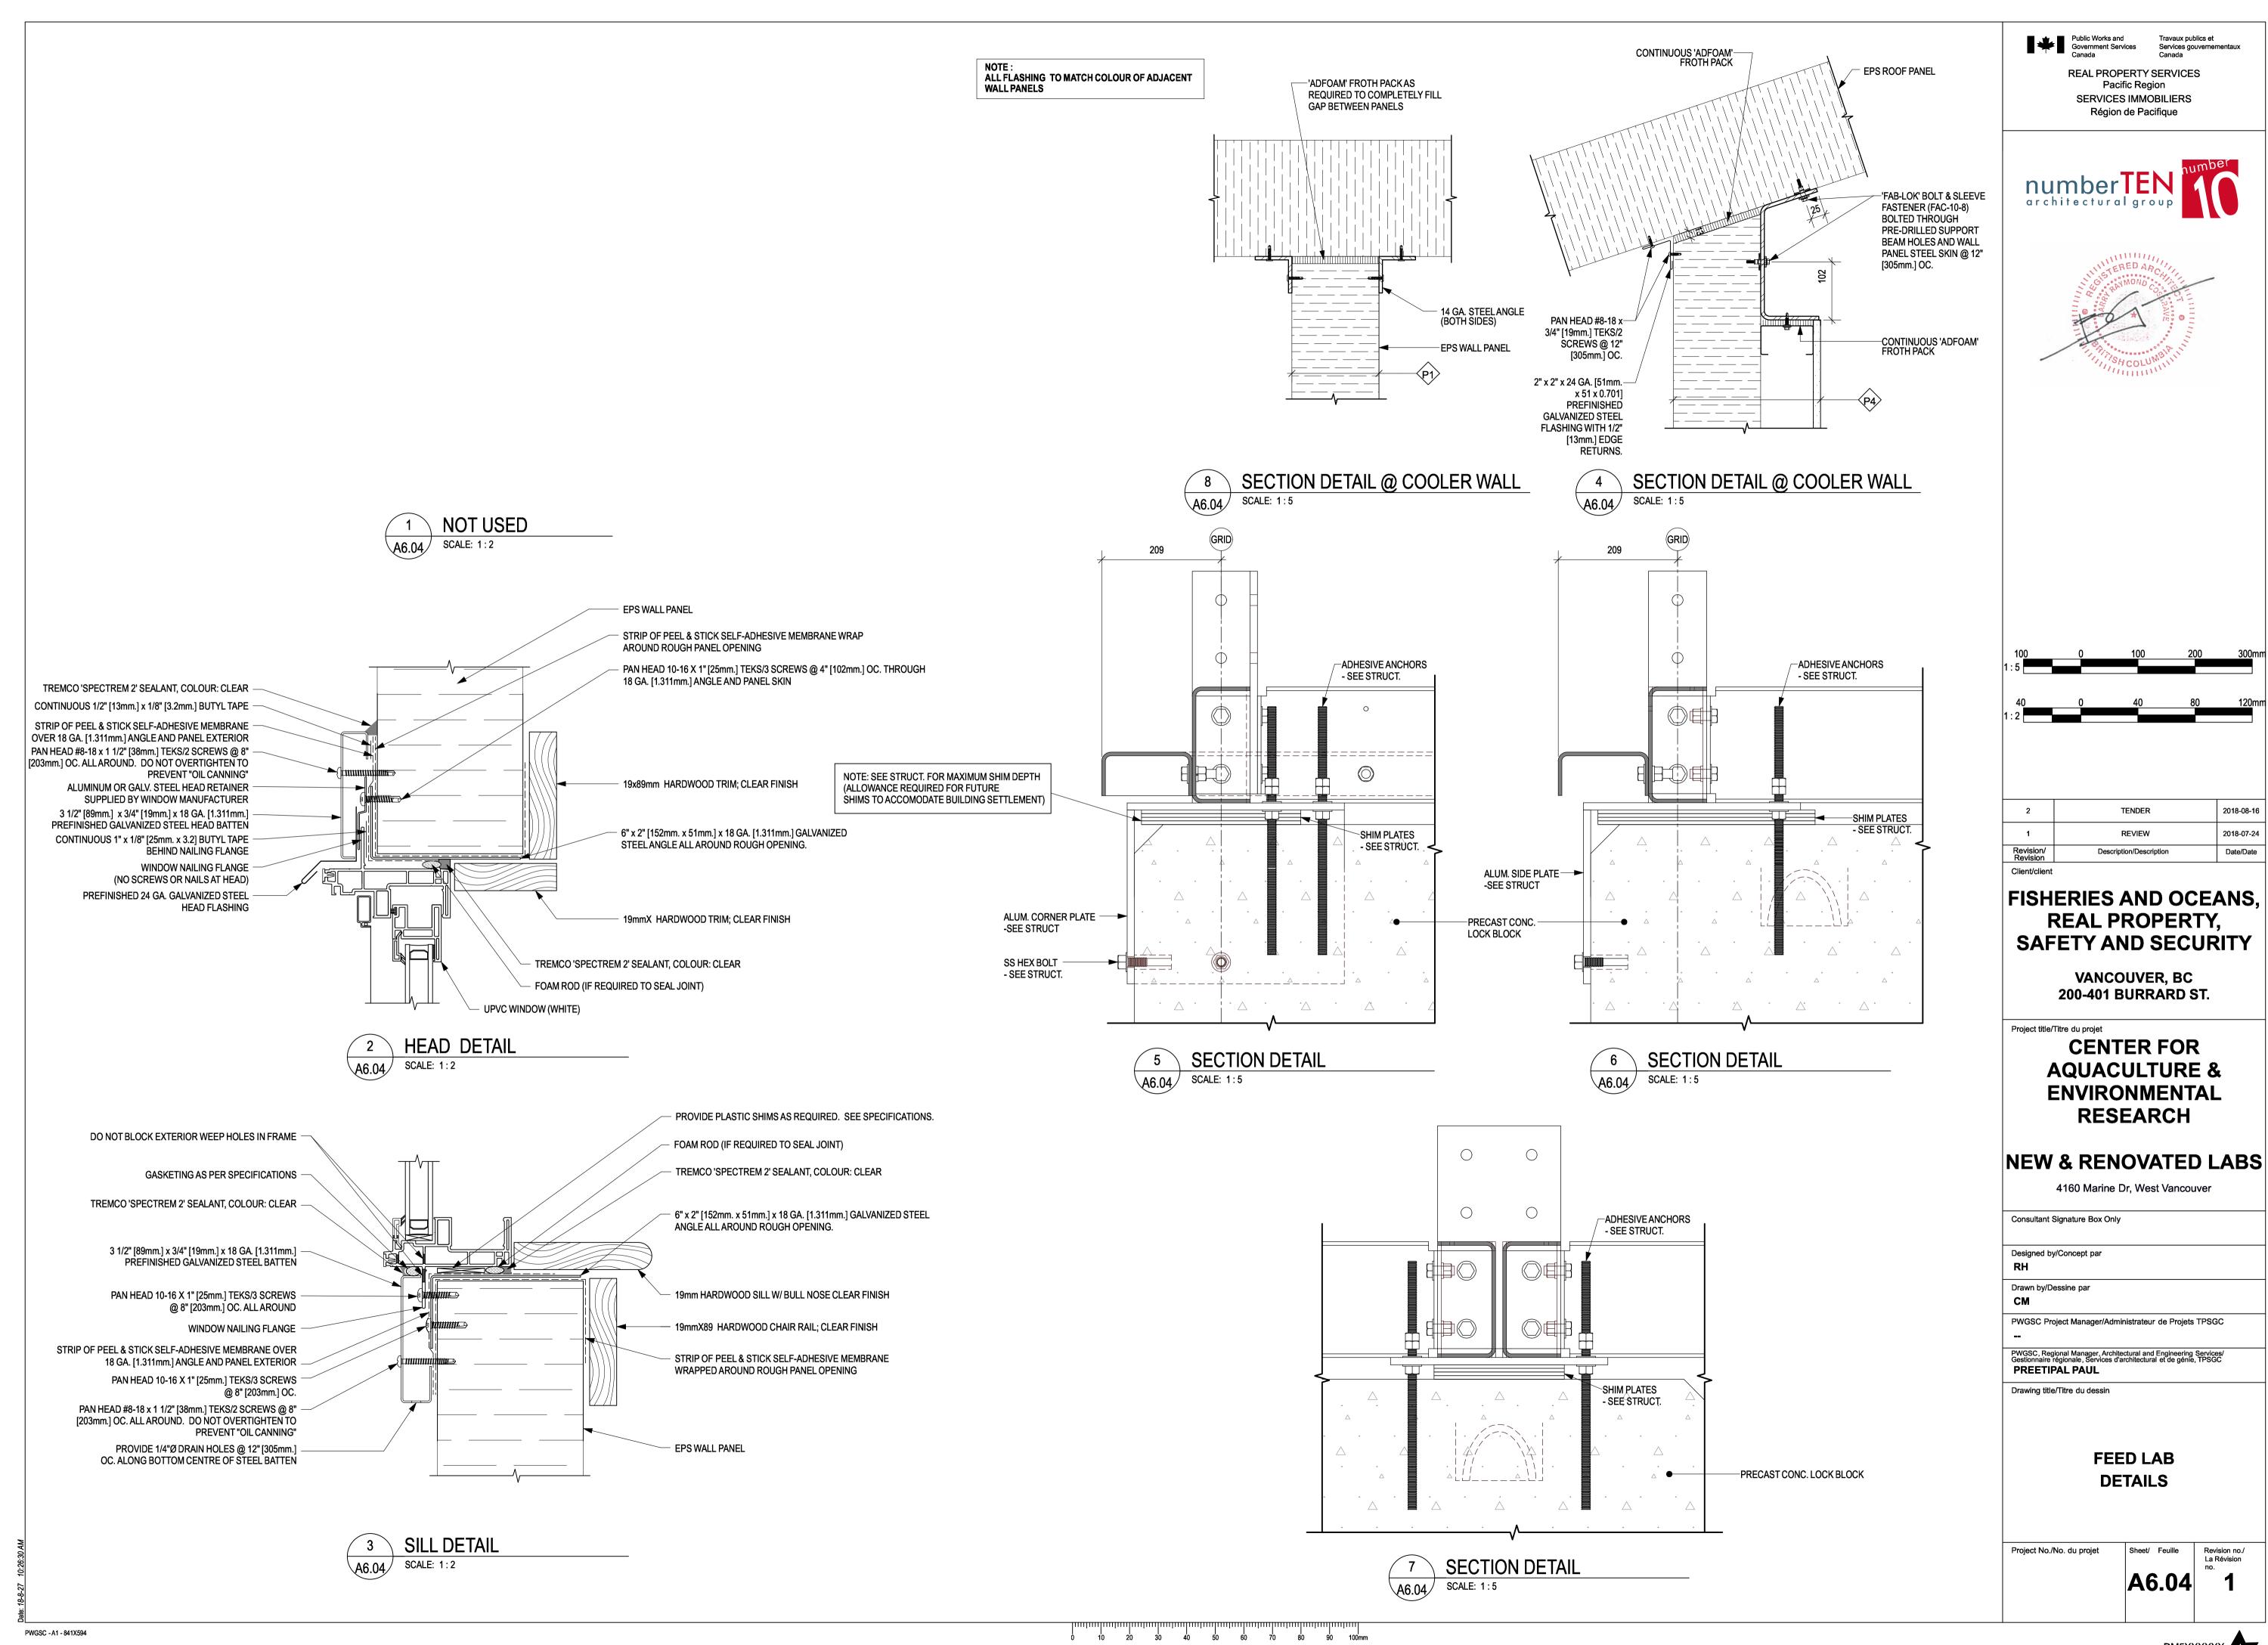


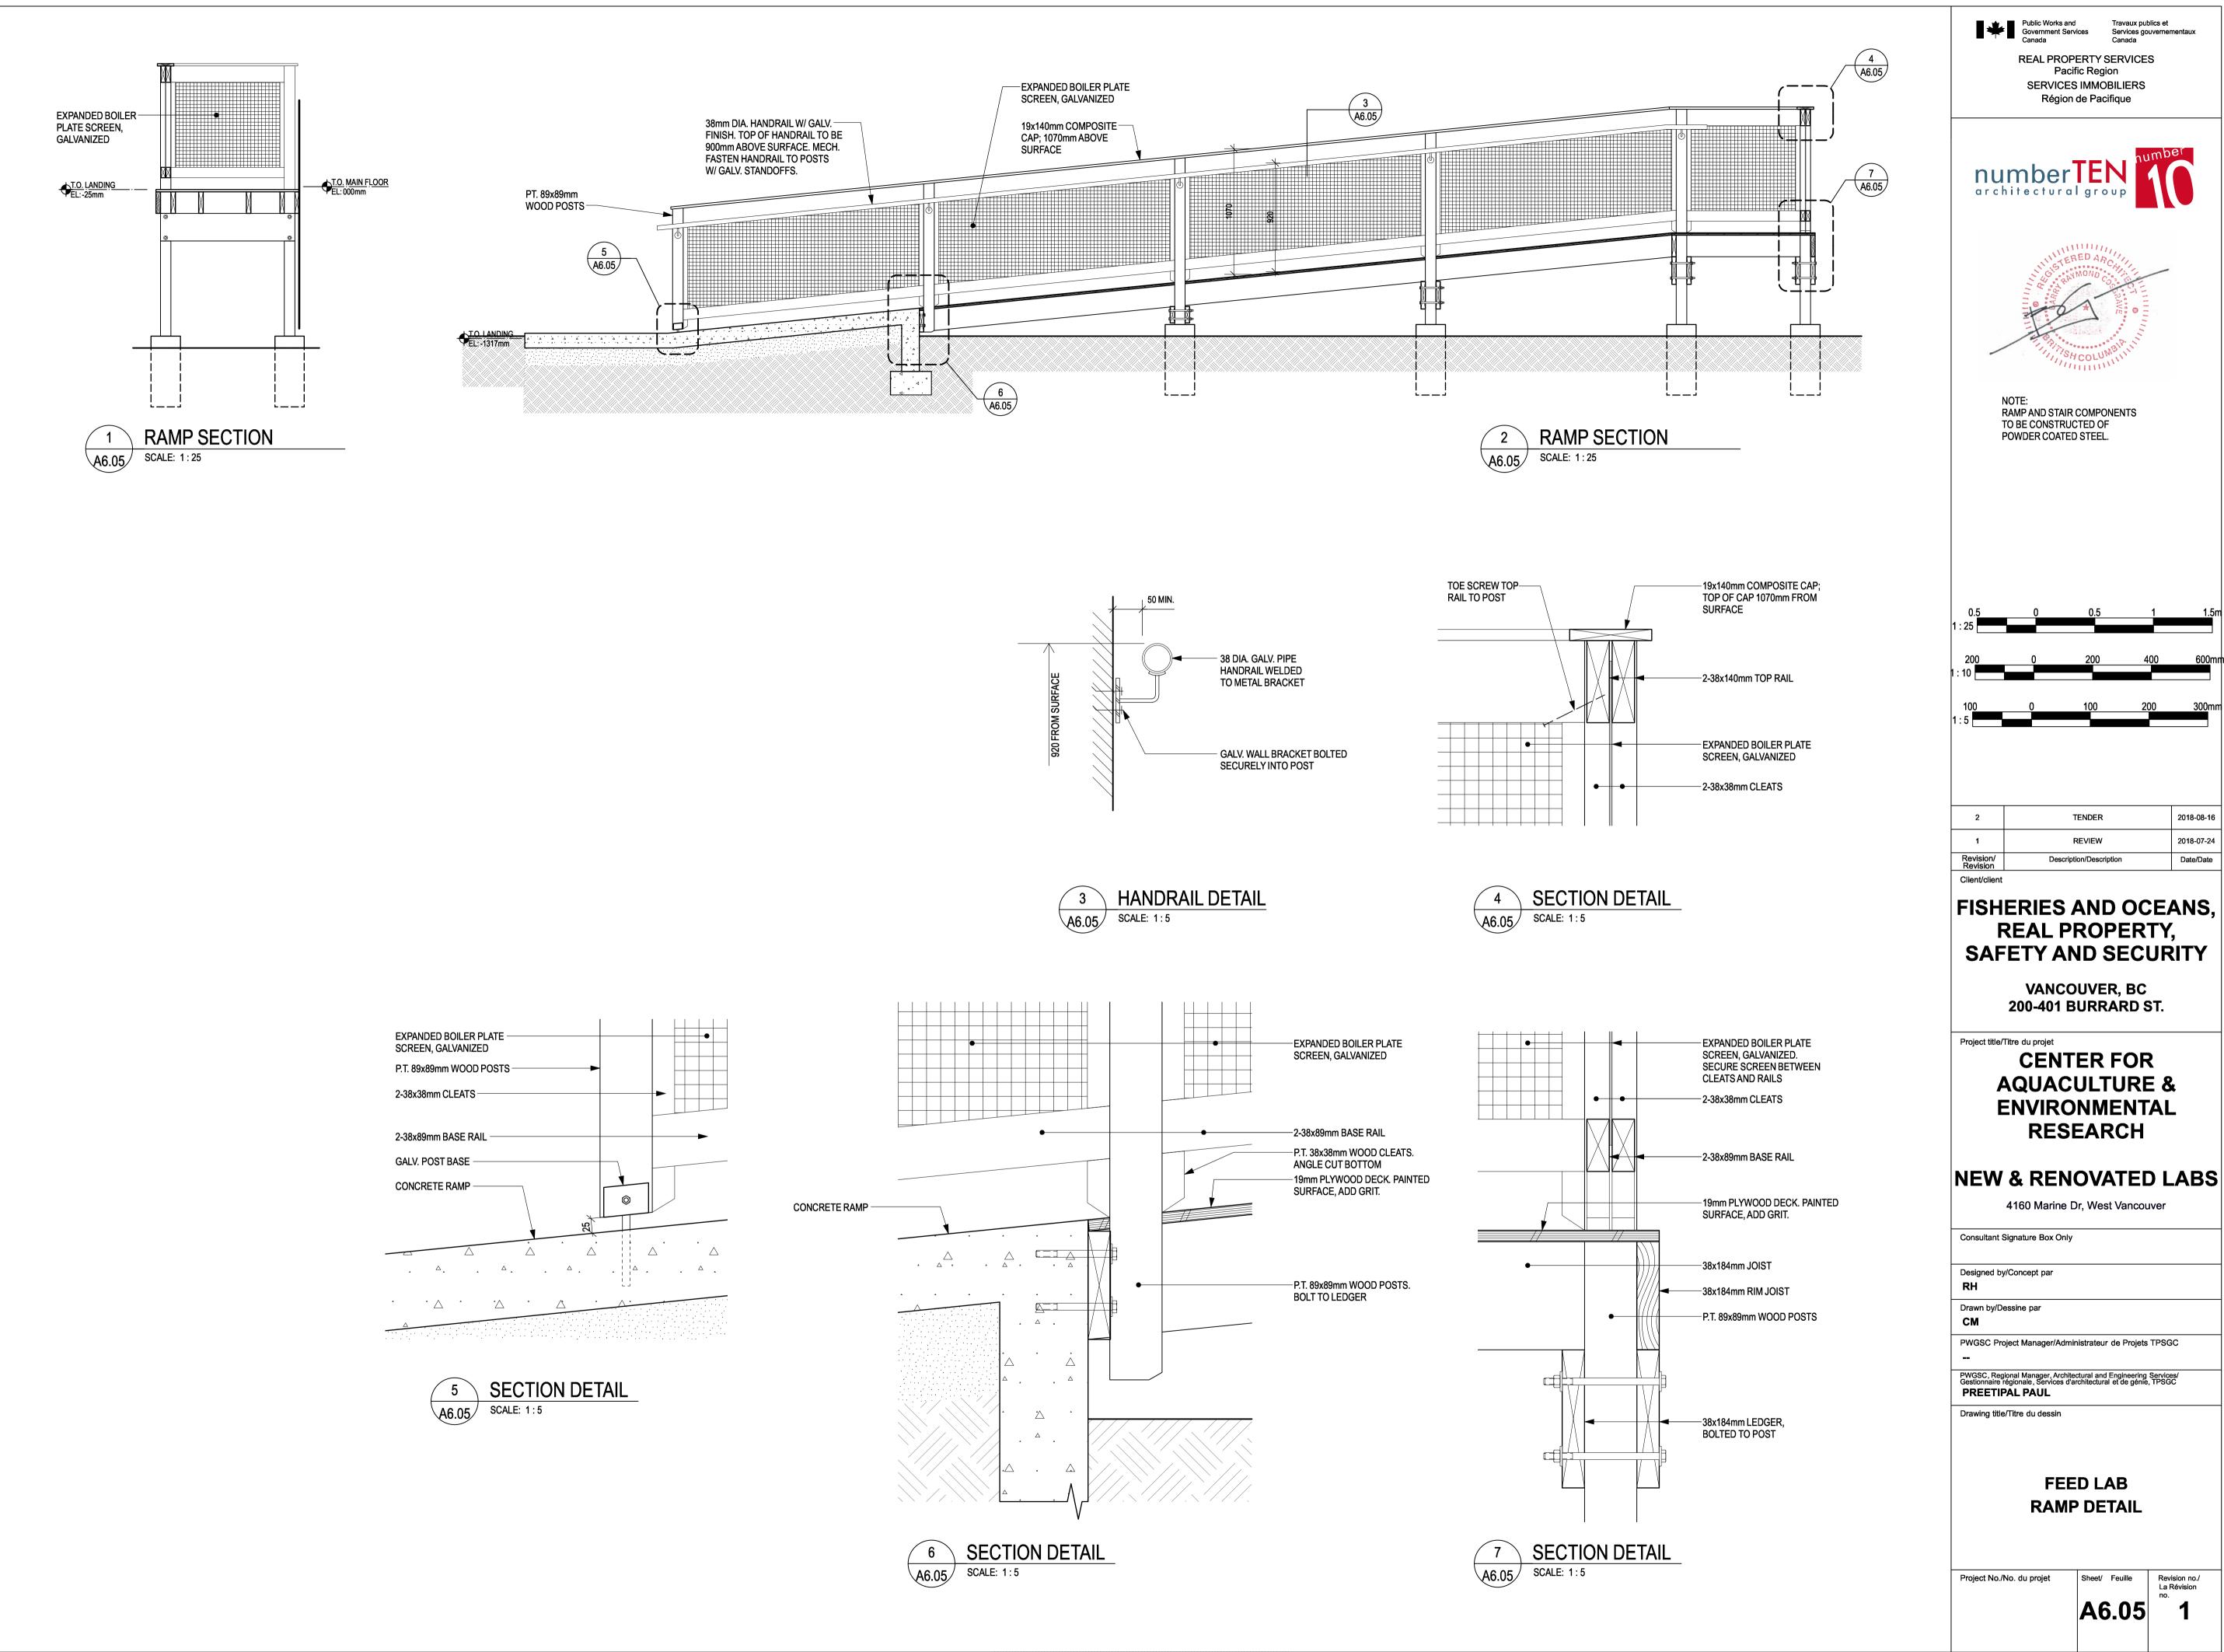


DM5XXXXXX


0 10 20 30 40 50 60 70 80 90 100mm


PWGSC - A1 - 841X594

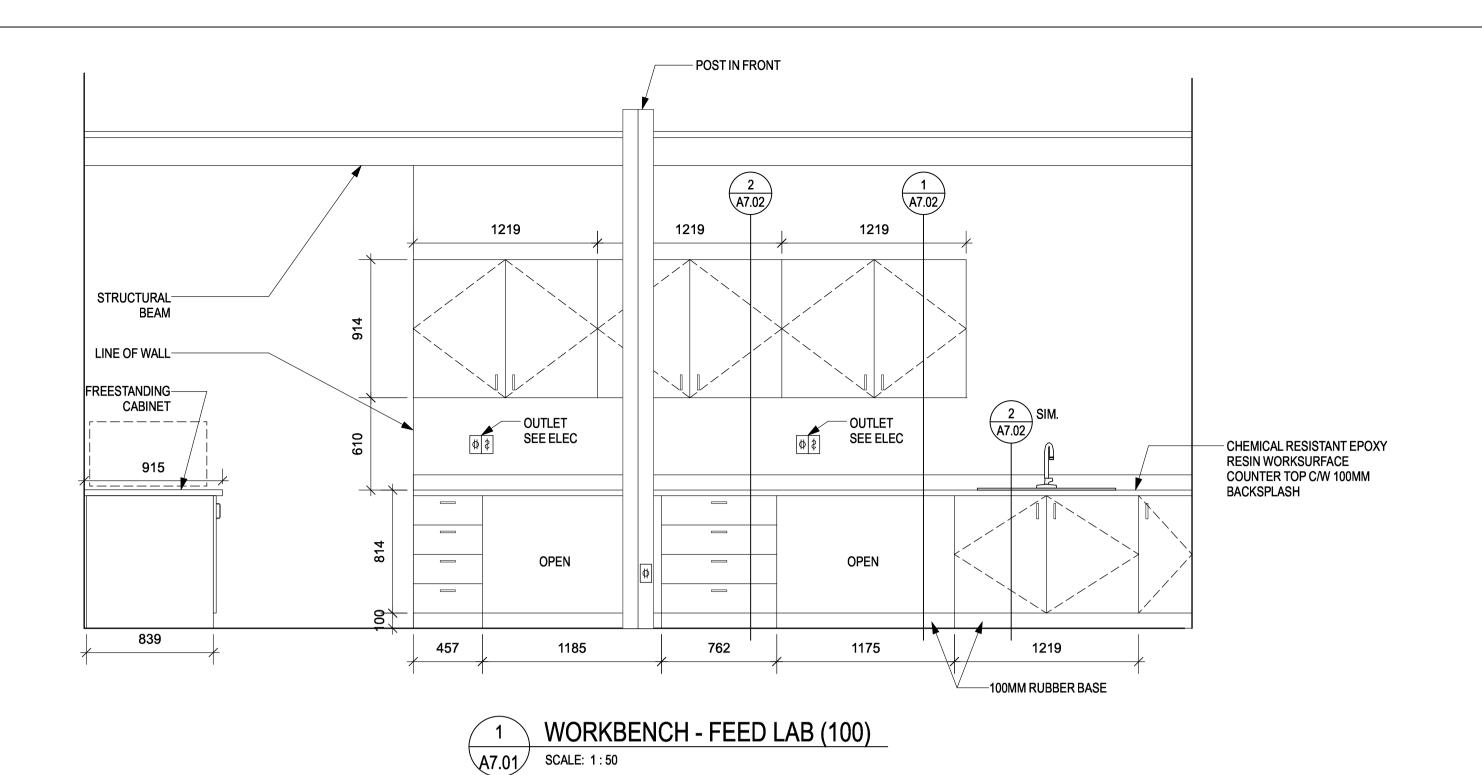


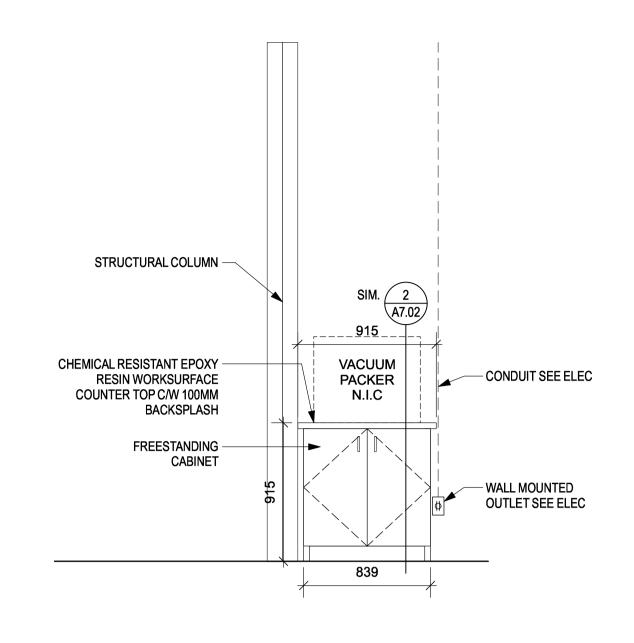

CABINET - FEED LAB (100)

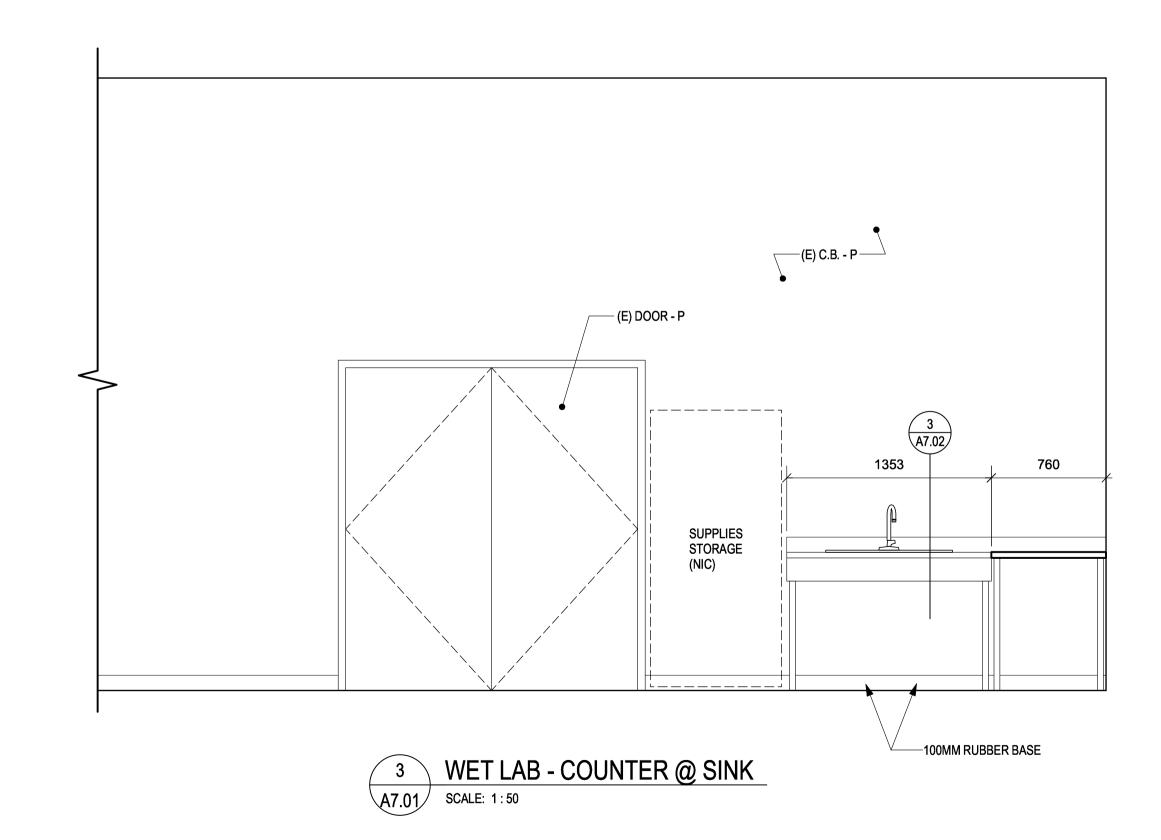

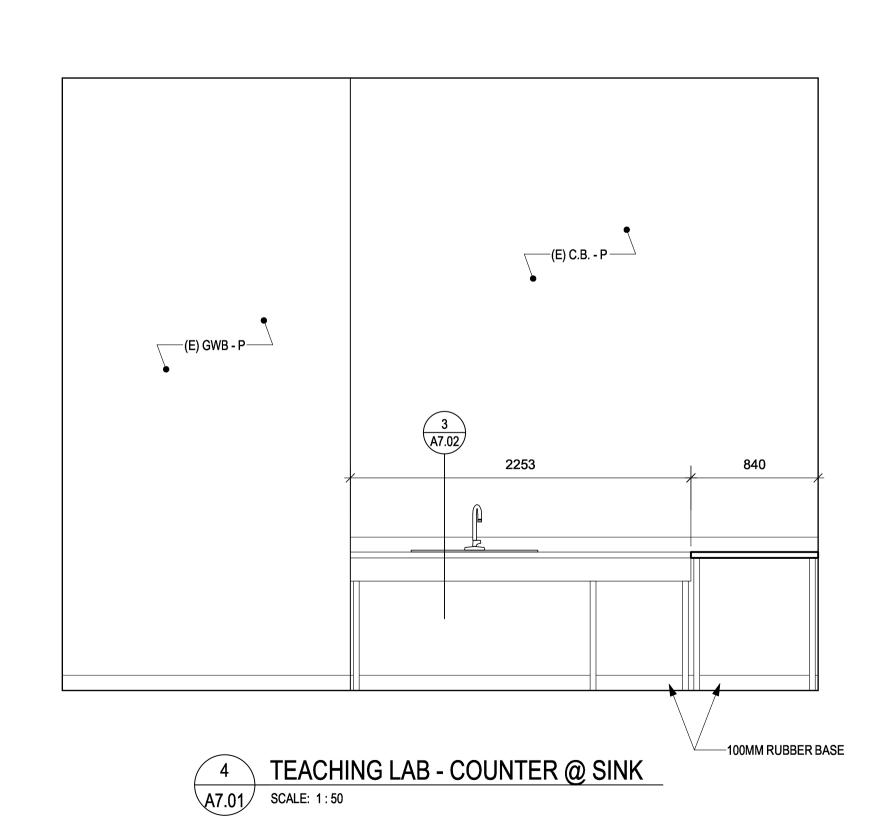

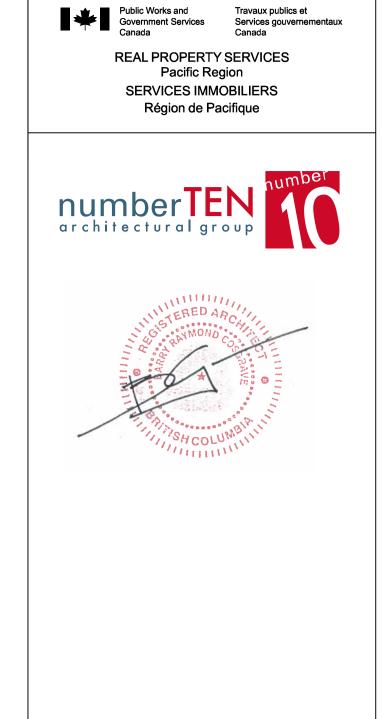

2	TENDER	2018-08-16
1	REVIEW	2018-07-24
Revision/ Revision	Description/Description	Date/Date

#### FISHERIES AND OCEANS, **REAL PROPERTY,** SAFETY AND SECURITY

**VANCOUVER, BC** 200-401 BURRARD ST.

Client/client

**CENTER FOR AQUACULTURE & ENVIRONMENTAL RESEARCH** 

#### **NEW & RENOVATED LABS**

4160 Marine Dr, West Vancouver

Consultant Signature Box Only

Designed by/Concept par

Drawn by/Dessine par

PWGSC Project Manager/Administrateur de Projets TPSGC

PWGSC, Regional Manager, Architectural and Engineering Services/ Gestionnaire régionale, Services d'architectural et de génie, TPSGC PREETIPAL PAUL


Drawing title/Titre du dessin


INTERIOR **ELEVATIONS** 


Project No./No. du projet

A7.01 1


0 10 20 30 40 50 60 70 80 90 100mm

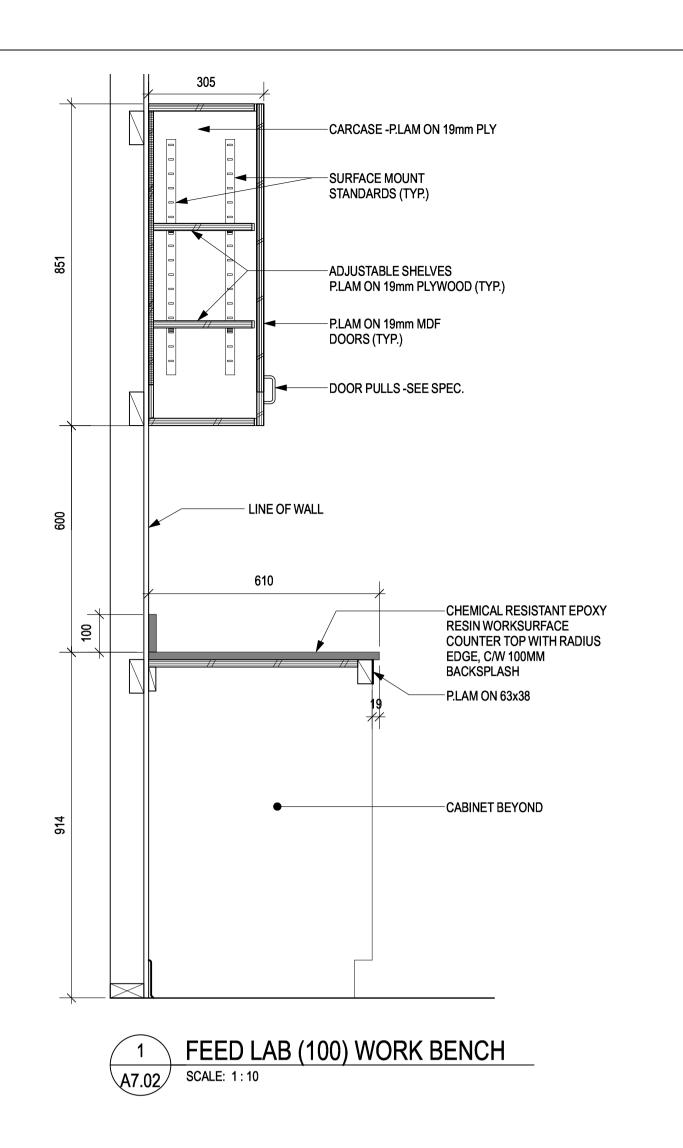

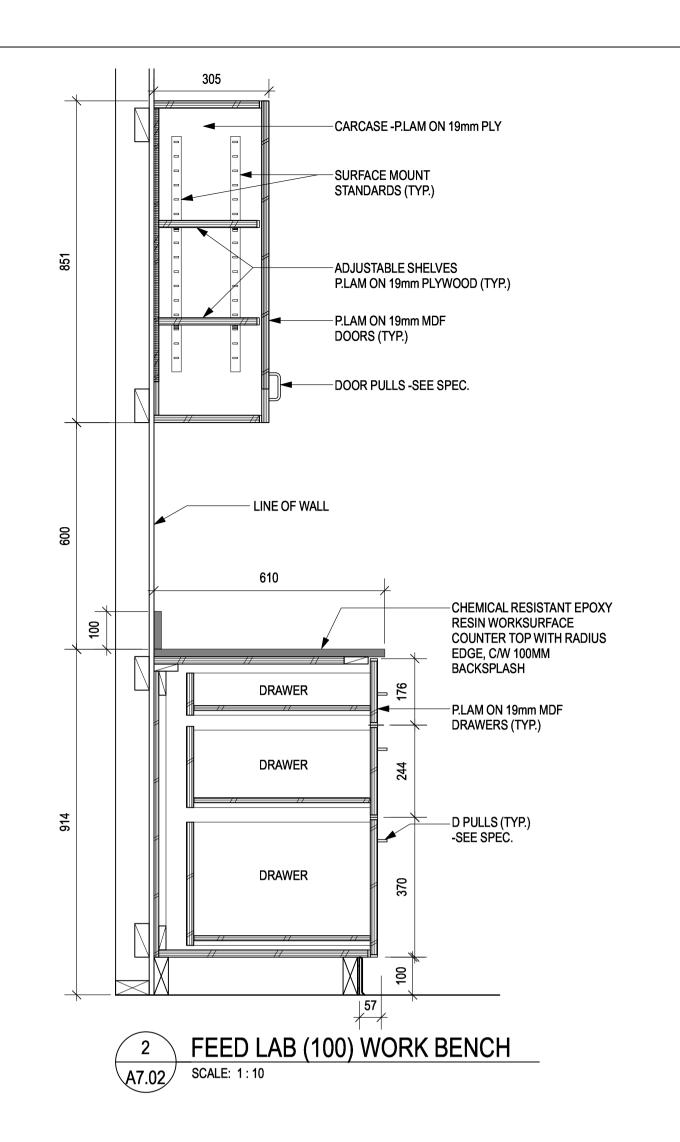

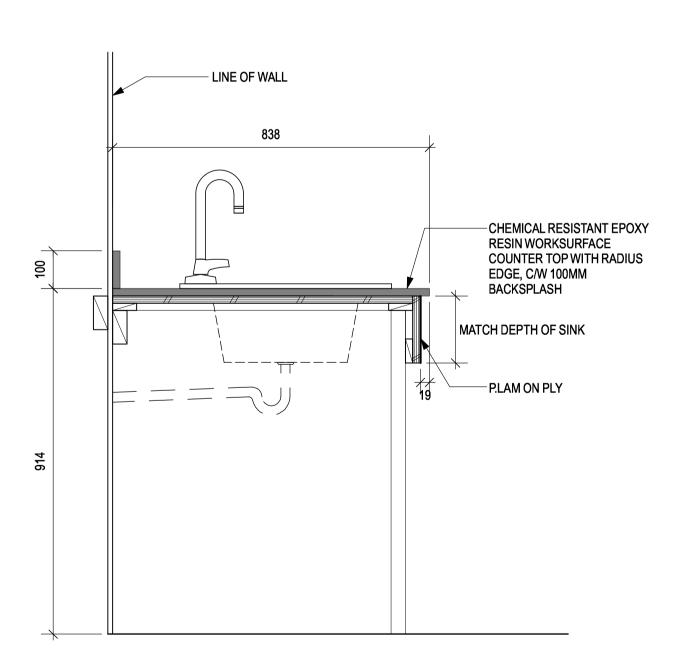

WET LAB FIXED COUNTER - RMS. 129A and 131 3 WET LAE A7.02 SCALE: 1:10

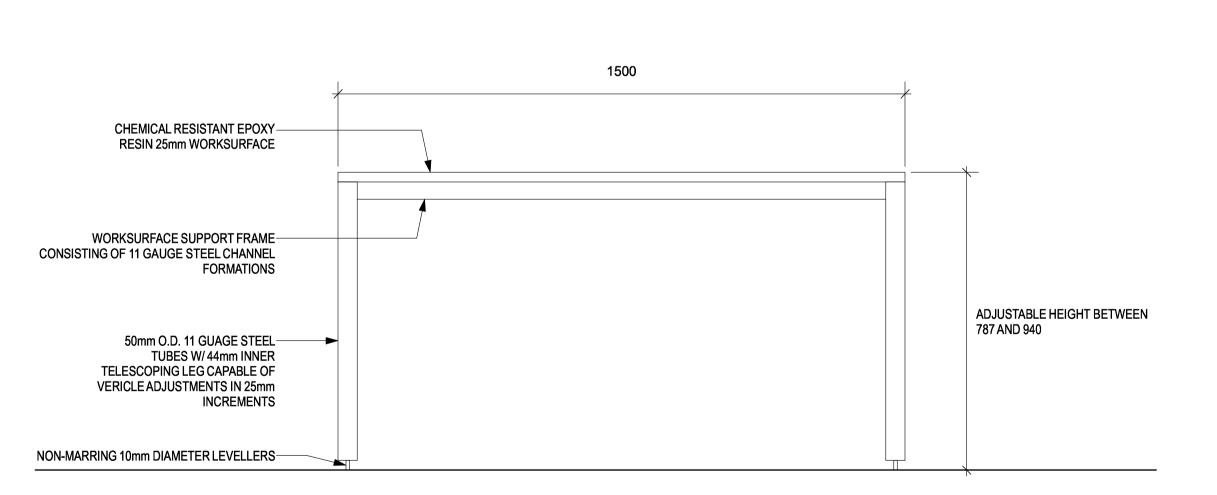


TYPICAL LAB BENCH - RMS. 129A and 131 A7.02 SCALE: 1:10

Public Works and Government Services Services gouvernementaux Canada

REAL PROPERTY SERVICES Pacific Region SERVICES IMMOBILIERS Région de Pacifique





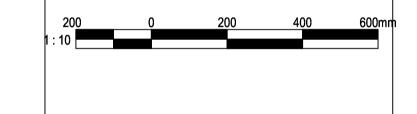

2	TENDER	2018-08-16
1	REVIEW	2018-07-24
Revision/ Revision	Description/Description	Date/Date
O!!		

#### FISHERIES AND OCEANS, **REAL PROPERTY,** SAFETY AND SECURITY

**VANCOUVER, BC 200-401 BURRARD ST.** 

**CENTER FOR AQUACULTURE & ENVIRONMENTAL RESEARCH** 

#### **NEW & RENOVATED LABS**

4160 Marine Dr, West Vancouver

Consultant Signature Box Only

Designed by/Concept par

Drawn by/Dessine par

PWGSC Project Manager/Administrateur de Projets TPSGC

PWGSC, Regional Manager, Architectural and Engineering Services/ Gestionnaire régionale, Services d'architectural et de génie, TPSGC PREETIPAL PAUL

Drawing title/Titre du dessin

**MILLWORK DETAILS** 

Project No./No. du projet

A7.02 1

















Public Works and Government Services Services gouvernementaux Canada

REAL PROPERTY SERVICES
Pacific Region SERVICES IMMOBILIERS Région de Pacifique

NOTE: 1 & 2 HARDWIRED. ELECTRICIAN TO REMOVE.

**EQUIPMENT TO BE RELOCATED** 

A8.01 SCALE: N.T.S.

DOO	DOOR SCHEDULE														
FEED	FEED LAB BUILDING														
OPENING DOOR							FRAME	FRAME							
NUM.	SIZE (W x H x THICK)	ROOM NAME	FRR	HDWR	TYPE	MAT'L	CORE	FINISH	COLOR	GLAZ.	MAT'L	TYPE	FINISH COLO	R GLAZ.	REMARKS
1	1828 x 2032 x 45	FEED LAB	_	1	D	MTL.	INSU.	PT		D.G. TEMP.	H.M.	В	PT		LOCK; CLOSER; KICK PLATE; THRESHOLD; WEATHER STRIPPING; SWEEP
2	914 x 2032 x 102	COOLER	_	2	С	MTL.	INSU.	P.F.			H.M.	Α	P.F.		GASKET; SELF RISING HINGES; SAFTEY RELEASE FASTENER - COOLER TYPE DOOR
INTERI	INTERIOR LAB														
3	914 x 2032 x 102	ACOUSTIC ANALYSIS ROOM	3/4 HR.	3	С	MTL.	_	P.T.			H.M.	Α	P.T.		
4	1875 x 2061 x 102	RM 131	_	_	E		_	_			_	_		_	

#### SCHEDULE ABBREVIATIONS:

WINDOW SCHEDULE

NUM. R.O. SIZE (W x H)

2 762x1219 mm

1016x1219 mm

3 | 1847x1147 mm | C | STEEL

FEED LAB BUILDING

INTERIOR LABS


INSULATED PRE-FINISHED **ARGON FILL** MAT'L MATERIAL PT. MIN. MTL NAT. OBS. T.B. T.G. MINUTES or MINIMUM THERMALLY BROKEN DOUBLE GLAZED METAL NATURAL TRIPLE GLAZED TEMPERED FIRE RESISTANCE RATING TEMP. WD. GLAZING (OR GLAZED) **OBSCURED** WOOD HOLLOW METAL HDWR HARDWARE

TYPE FRAME MAT'L


A VINYL

B VINYL

IISH	COLOUR	REMARKS	
ІОП	COLOUR	KEWAKKS	
	WHITE		
	WHITE		
	<u> </u>	<u> </u>	

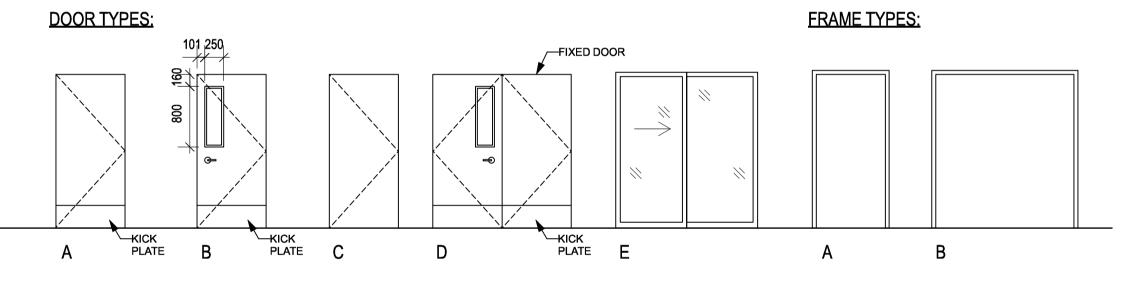

#### **EXTERIOR WINDOW TYPES:**

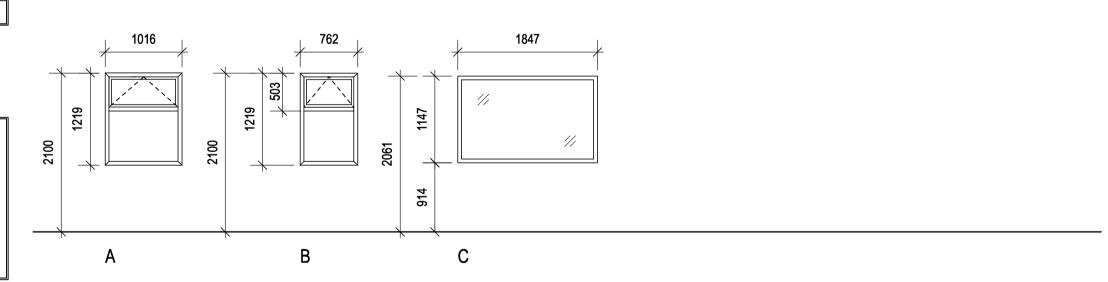

SL. SEALED T.B.D. TO BE DETERMINED TILE CERAMIC TILE ACOUSTIC CEILING TILE ANTI-STATIC NON-CONDUCTIVE, FIRE RETARDANT PAINT CARP. C.B. CARPET TILE OPERABLE CONCRETE BLOCK PAINTED VCT VINYL COMPOSITE TILE CONC GWB S.R. S.V. CONCRETE SHEET RUBBER W. COV. WALL COVERING GYPSUM WALL BOARD M.P. POLSIHED METAL PANEL - WHITE SHEET VINYL SAFETY FLOORING

GLAZING

PAINT T.B.D.

D.G.

D.G.

D.G.

FINIS	FINISH SCHEDULE																					
FEED L	FEED LAB BUILDING																					
	FLOOR BASE				CEILING			NORTH WALL			EAST WALL			SOUTH WALL			WESTWALL					
NUM.	ROOM NAME	FINISH	COLOUR	MATERIAL	SIZE	COLOUR	MATERIAL	FINISH	COLOUR	MATERIAL	FINISH	COLOUR	MATERIAL	FINISH	COLOUR	MATERIAL	FINISH	COLOUR	MATERIAL	FINISH	COLOUR	REMARKS
100	LAB	S.V.		RUBBER	100mm		M.P.	PRE-FINISHED	WHITE	GWB.	PAINT		M.P.	PRE-FINISHED	WHITE	M.P.	PRE-FINISHED	WHITE	M.P.	PRE-FINISHED	WHITE	
101	COOLER	S.V.		RUBBER	100mm		M.P.	PRE-FINISHED	WHITE	M.P.	PRE-FINISHED	WHITE	M.P.	PRE-FINISHED	WHITE	M.P.	PRE-FINISHED	WHITE	M.P.	PRE-FINISHED	WHITE	
INTERIO	R LAB																					
129A	TEACHING LAB	EPOXY		RUBBER	100mm		(E) CONC.	*PAINT	WHITE	GWB/CONC	PAINT	WHITE	C.B.	PAINT	WHITE	C.B.	PAINT	WHITE	C.B./GWB.	PAINT	WHITE	
131	SRKW WET LAB	EPOXY		RUBBER	100mm		(E) CONC.	*PAINT	WHITE	GWB/C.B.	PAINT	WHITE	GWB/C.B.	PAINT	WHITE	C.B.	PAINT	WHITE	C.B.	PAINT	WHITE	
129C	ACOUSTIC ANALYSIS ROOM	EPOXY		RUBBER	100mm		(E) CONC.	*PAINT	WHITE	GWB	PAINT	WHITE	CONC.	PAINT	WHITE	C.B./GWB	PAINT	WHITE	CONC./C.B.	PAINT	WHITE	

\*SPRAY PAINT APPLICATION NOTES: 1. PRIME & 2 COATES TO GWB. 1 COAT TO (E) CONC. BLOCK

PWGSC - A1 - 841X594

2. PAINT INTERIOR DOORS NEW & EXISTING - COLOUR T.B.D.

Revision Client/client		A
	ERIES AND OCE REAL PROPERTY	

TENDER

REVIEW

2018-08-16

2018-07-24

**VANCOUVER, BC 200-401 BURRARD ST.** 

**SAFETY AND SECURITY** 

**CENTER FOR AQUACULTURE & ENVIRONMENTAL** RESEARCH

#### **NEW & RENOVATED LABS**

4160 Marine Dr, West Vancouver

Consultant Signature Box Only

Designed by/Concept par

Drawn by/Dessine par

PWGSC Project Manager/Administrateur de Projets TPSGC

PWGSC, Regional Manager, Architectural and Engineering Services/ Gestionnaire régionale, Services d'architectural et de génie, TPSGC PREETIPAL PAUL

Drawing title/Titre du dessin

DOOR, WINDOW, & FINISH SCHEDULES, **EQUIPMENT TO BE RELOCATED** 

Project No./No. du projet

Revision no./ La Révision Sheet/ Feuille A8.01