

FOOTING SCHEDULE		
250 kPa BEARING CAPACITY		
MARK	SIZE	REINFORCING
F1	900 x 900 x 300 dp.	3 - 15M E.W. BOT.


PILASTER SCHEDULE		
MARK	SIZE	REINFORCING
P1	500 x 500	4-20M VERT. 10M TIES @ 300
P2	300 DIA SONOTUBE	4-15M VERT. 10M TIES @ 300

NOTES

- ELEVATION TOP OF INTERIOR SLAB ON GRADE TO BE 0.000m
- REFER TO DRAWING S-5 FOR TYPICAL DETAILS AND NOTES.


BEAM SCHEDULE	
MARK	SIZE
B1	2 - 38 x 235

JOIST SCHEDULE	
MARK	SIZE
J1	38 x 235 SPF No1/No2

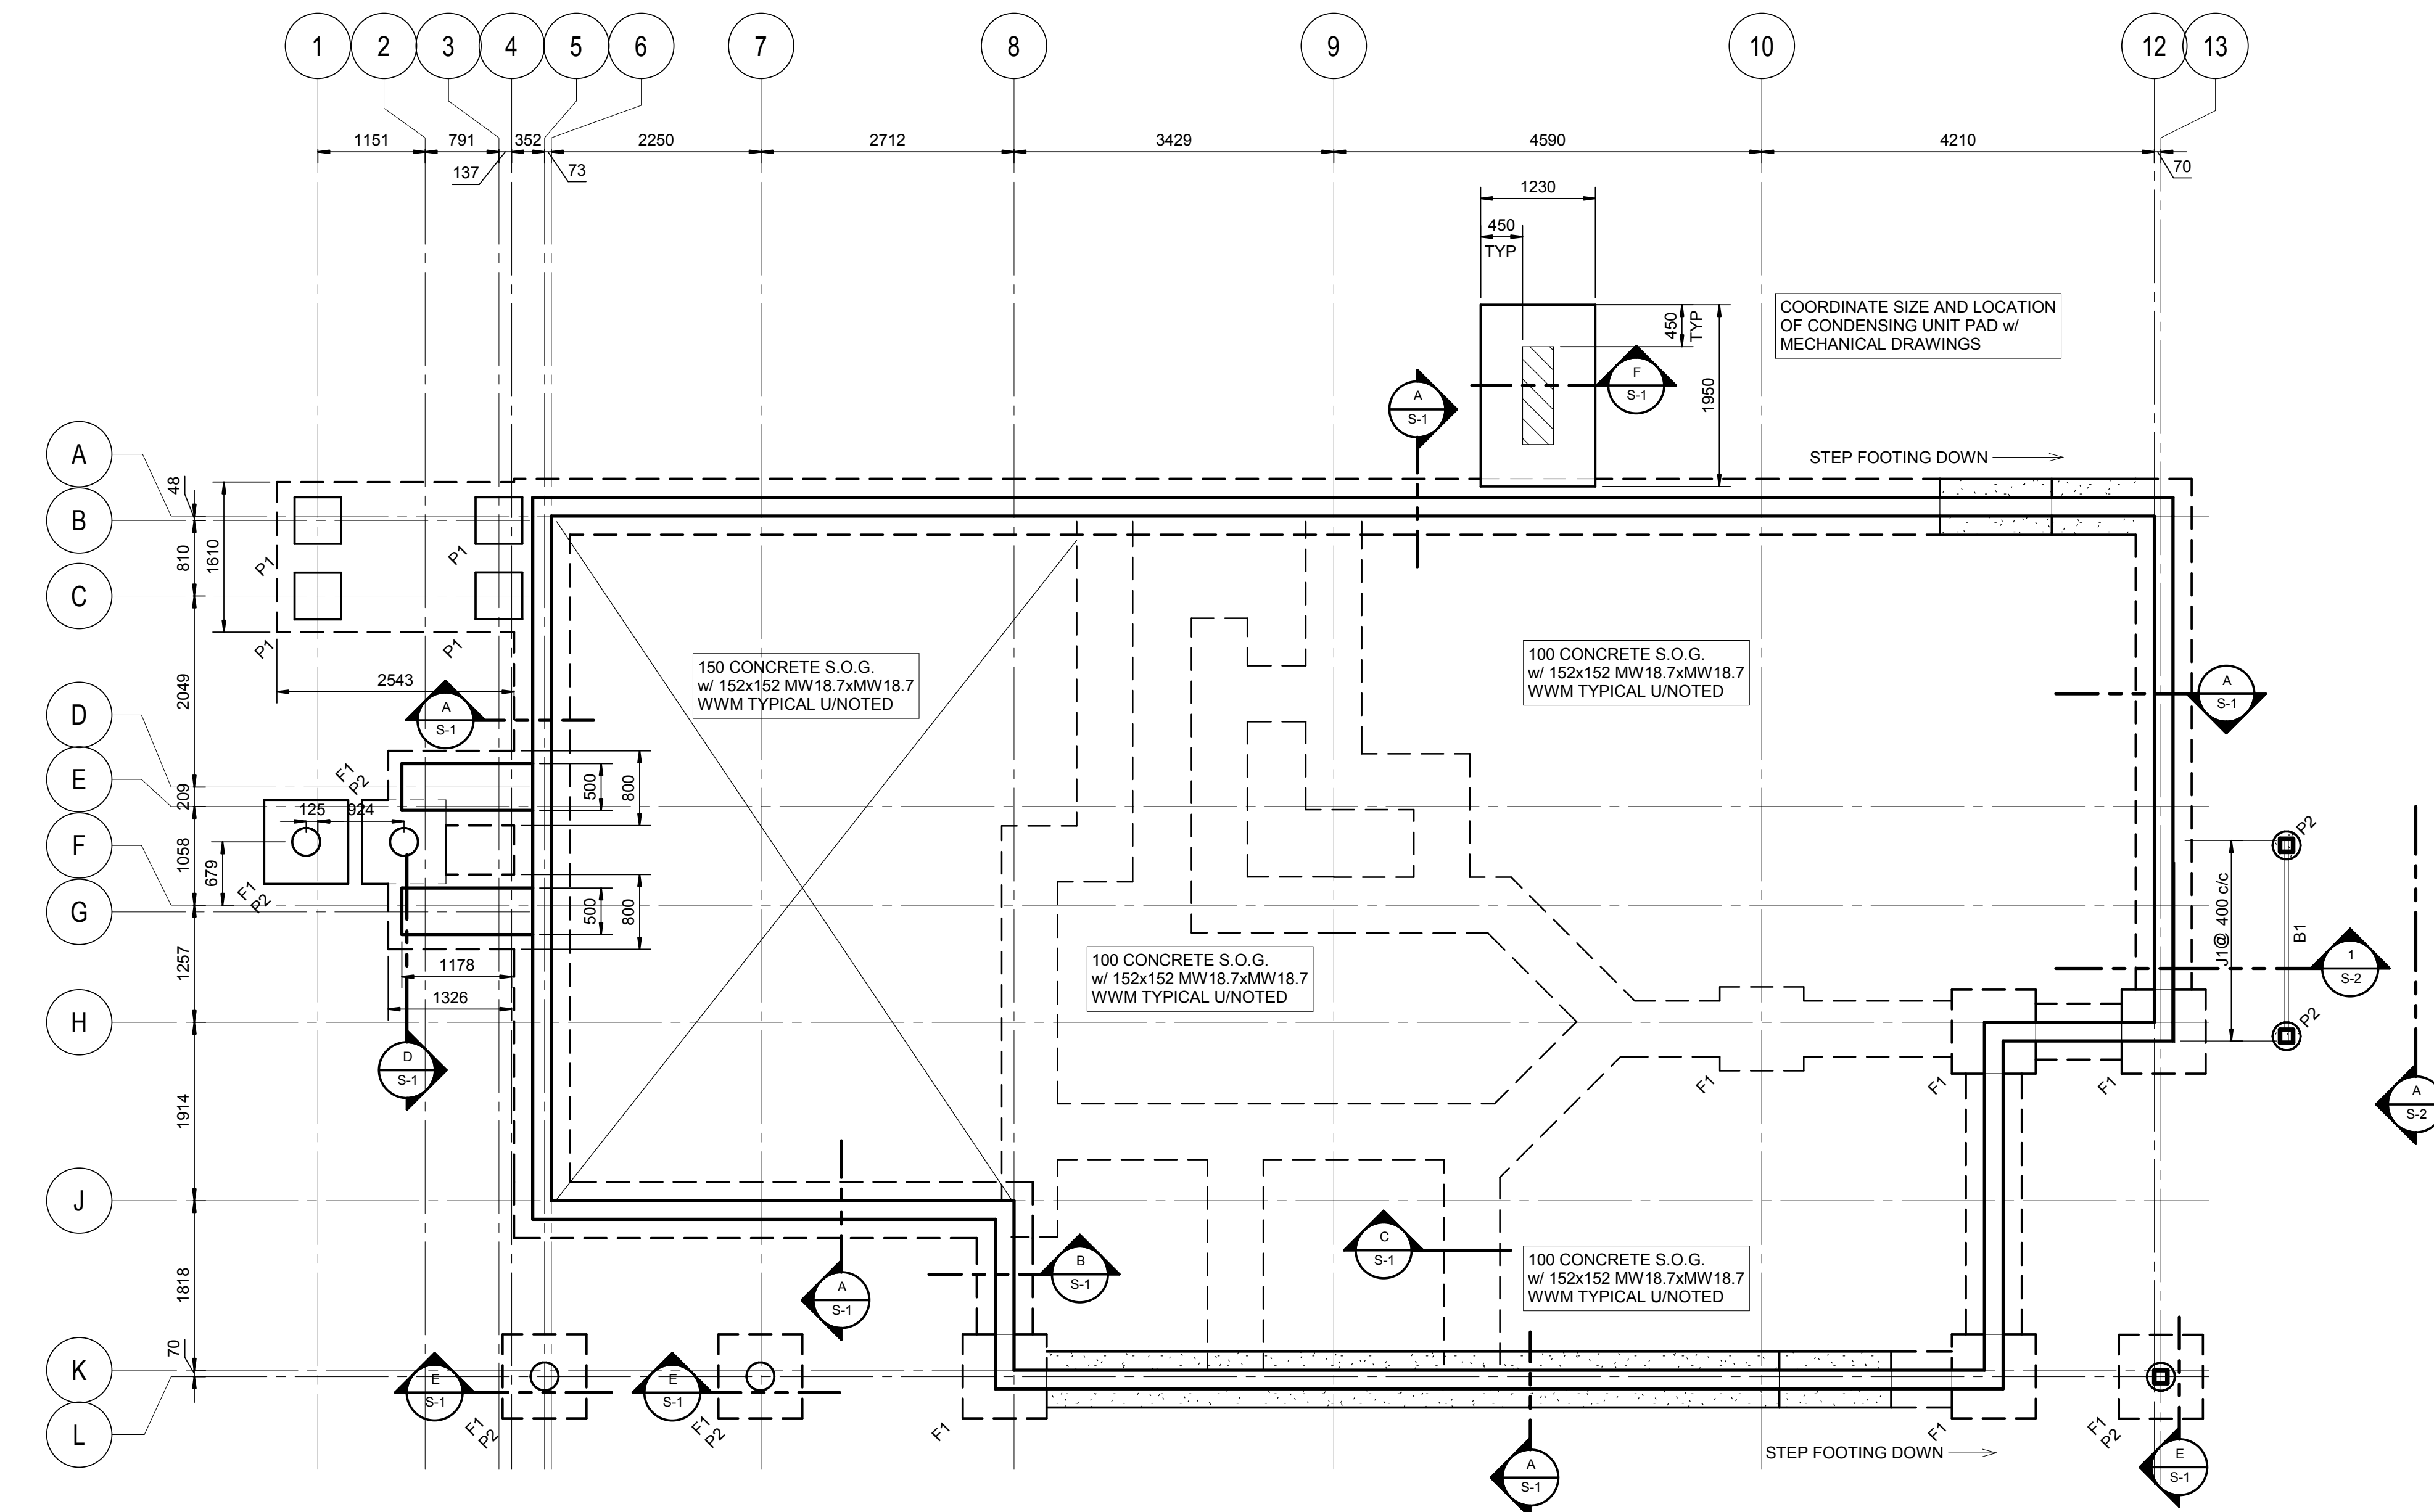


FOUNDATION PLAN

SCALE: 1:50

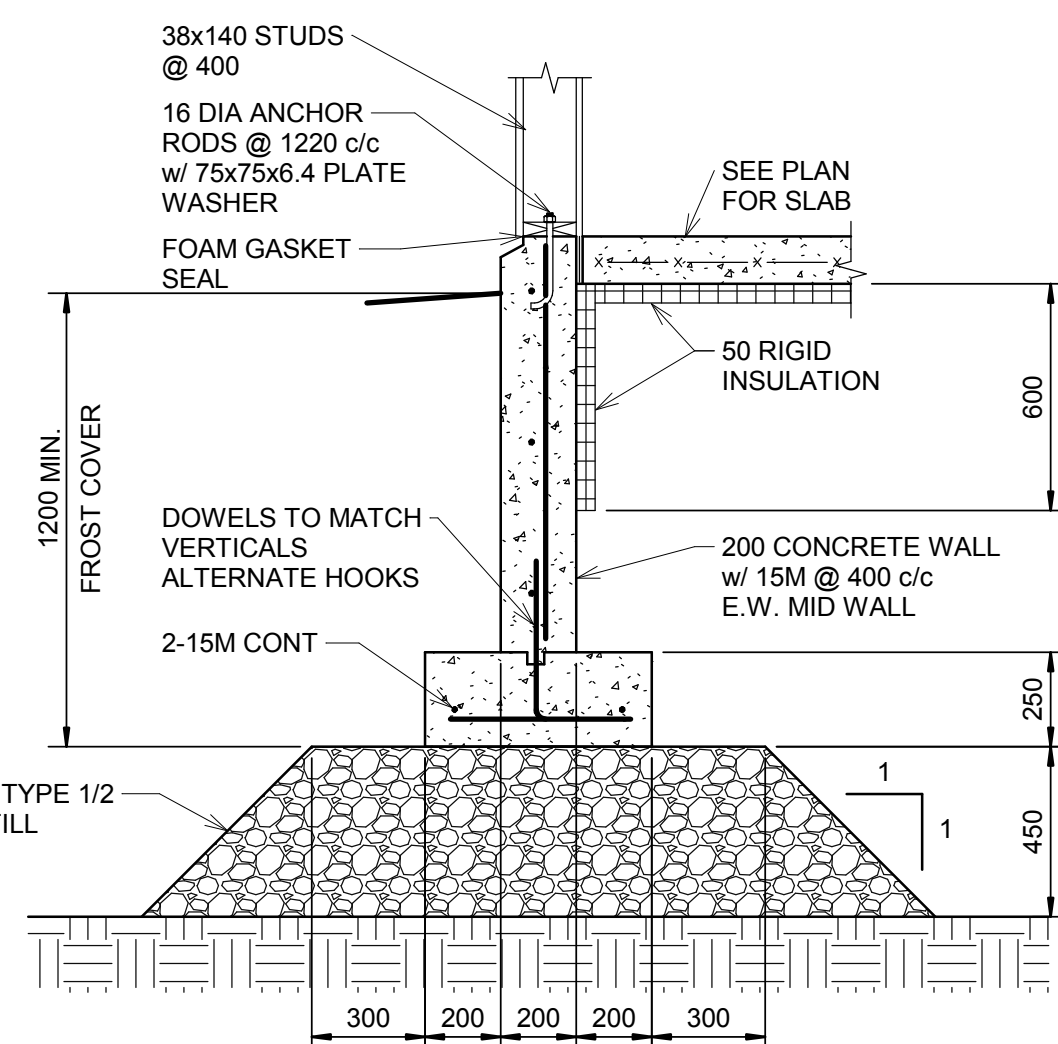


A SECTION S-1

SCALE: 1:20

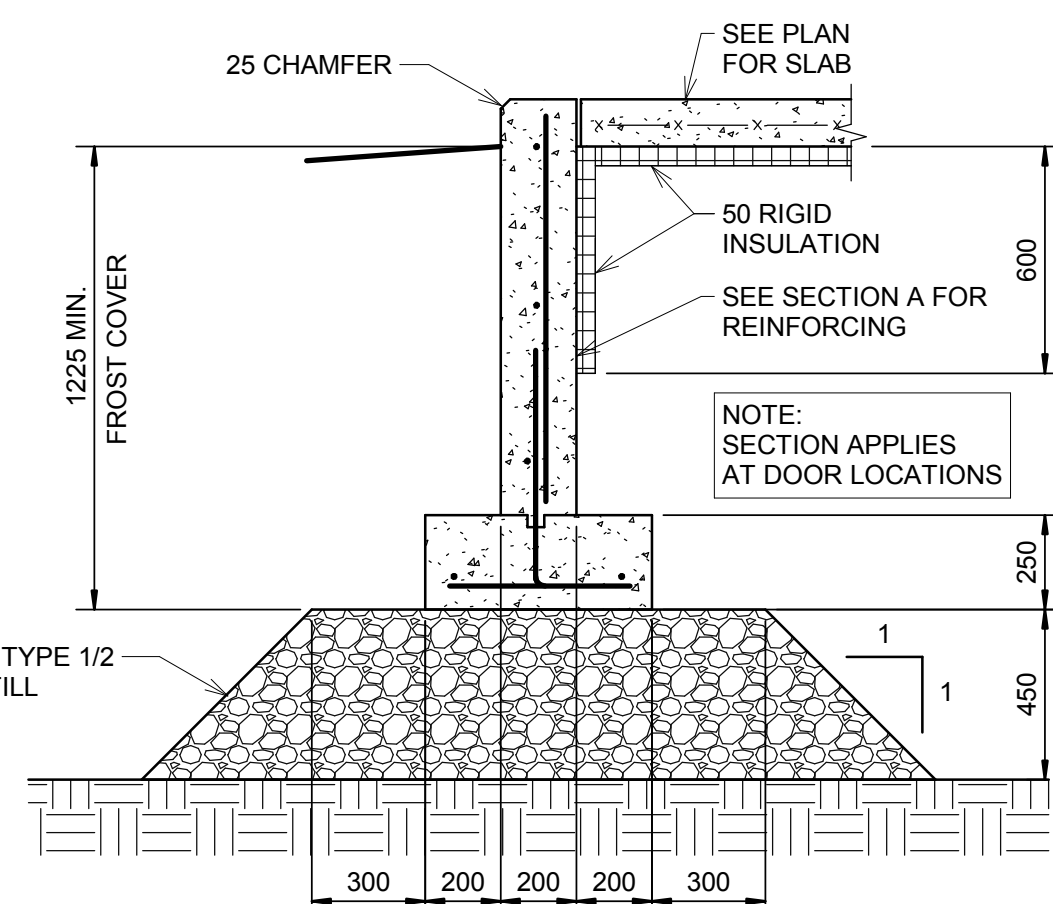


B SECTION S-1

SCALE: 1:20

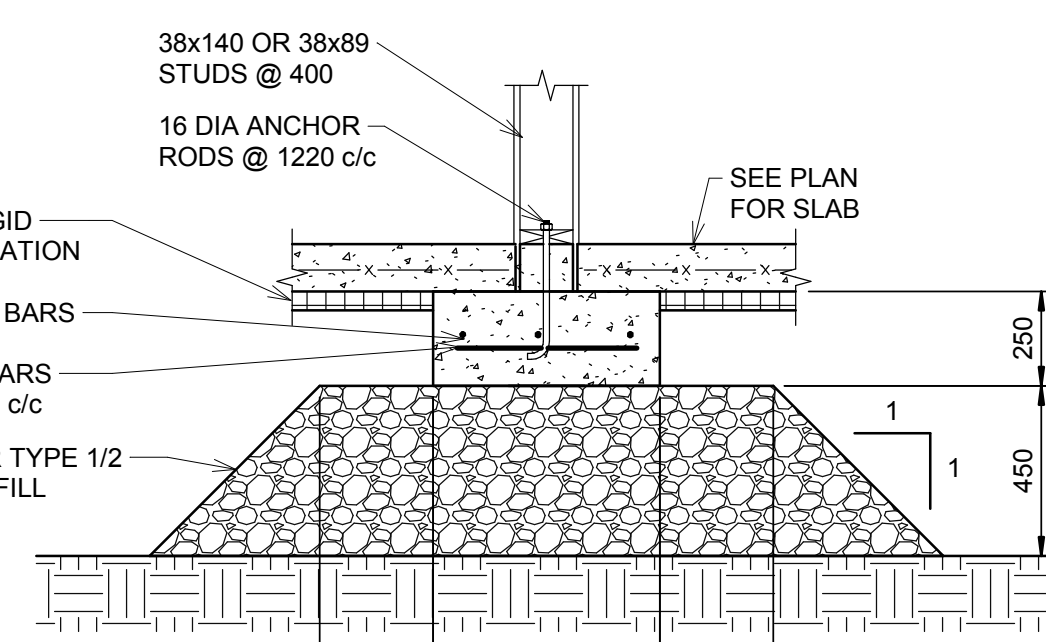


C SECTION S-1

SCALE: 1:20

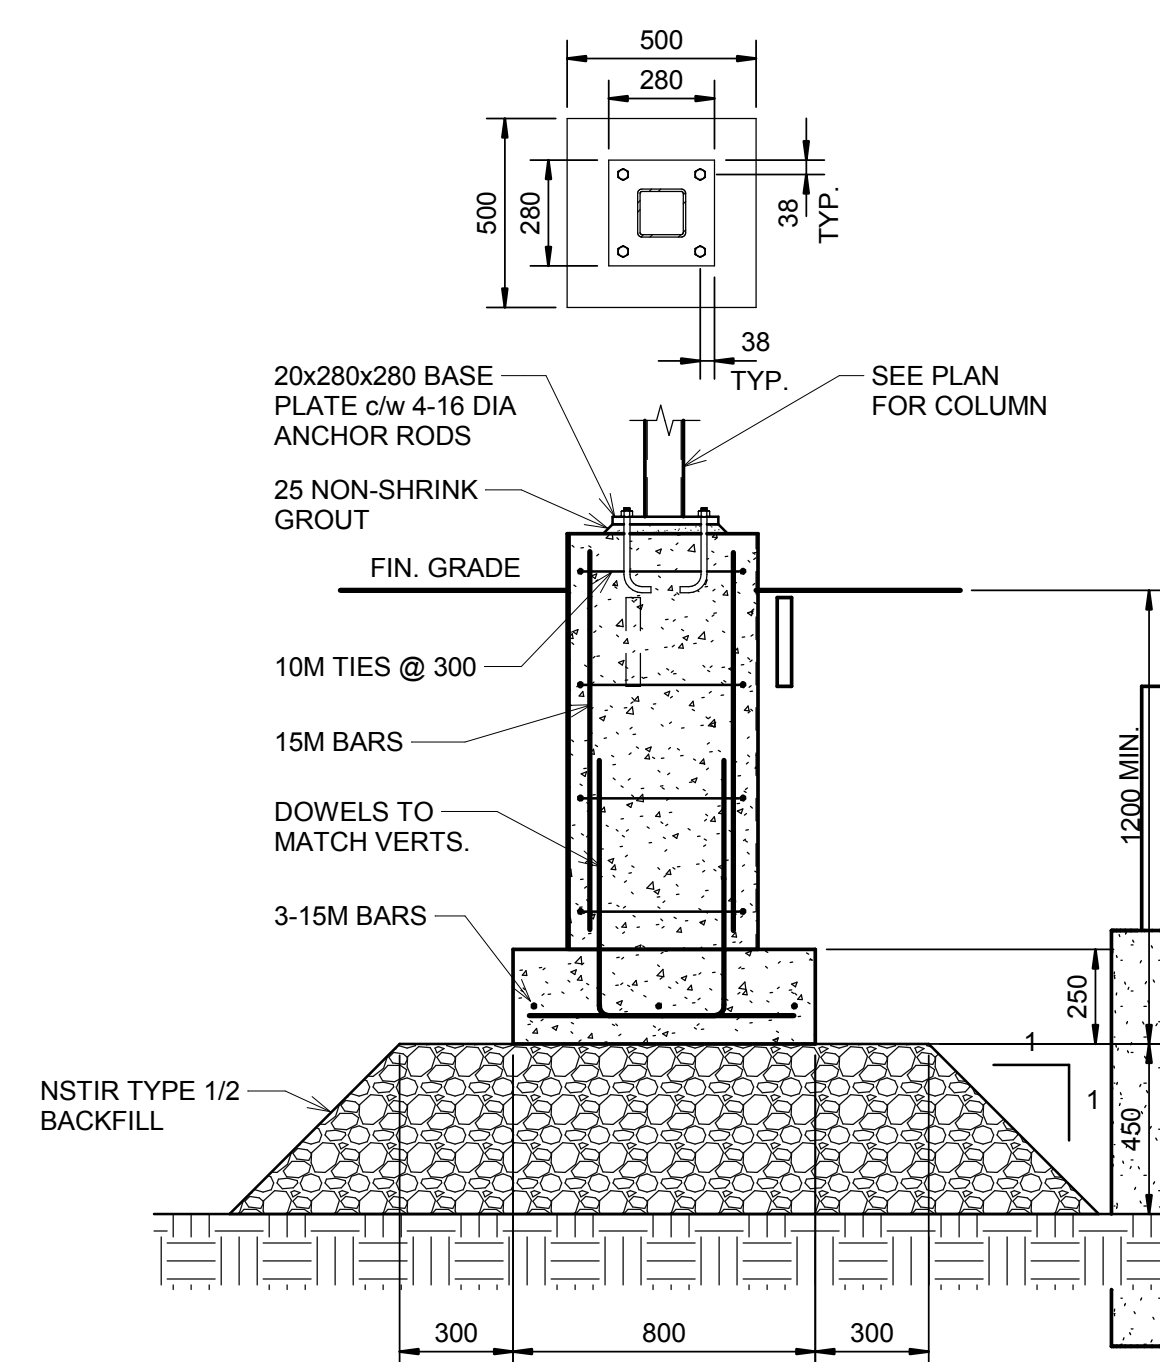


D SECTION S-1

SCALE: 1:20

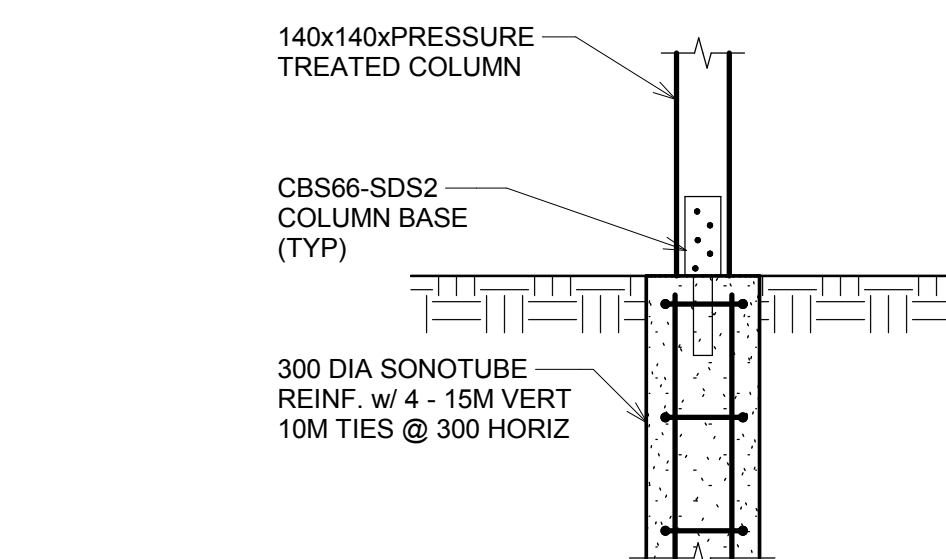


E SECTION S-1

SCALE: 1:20

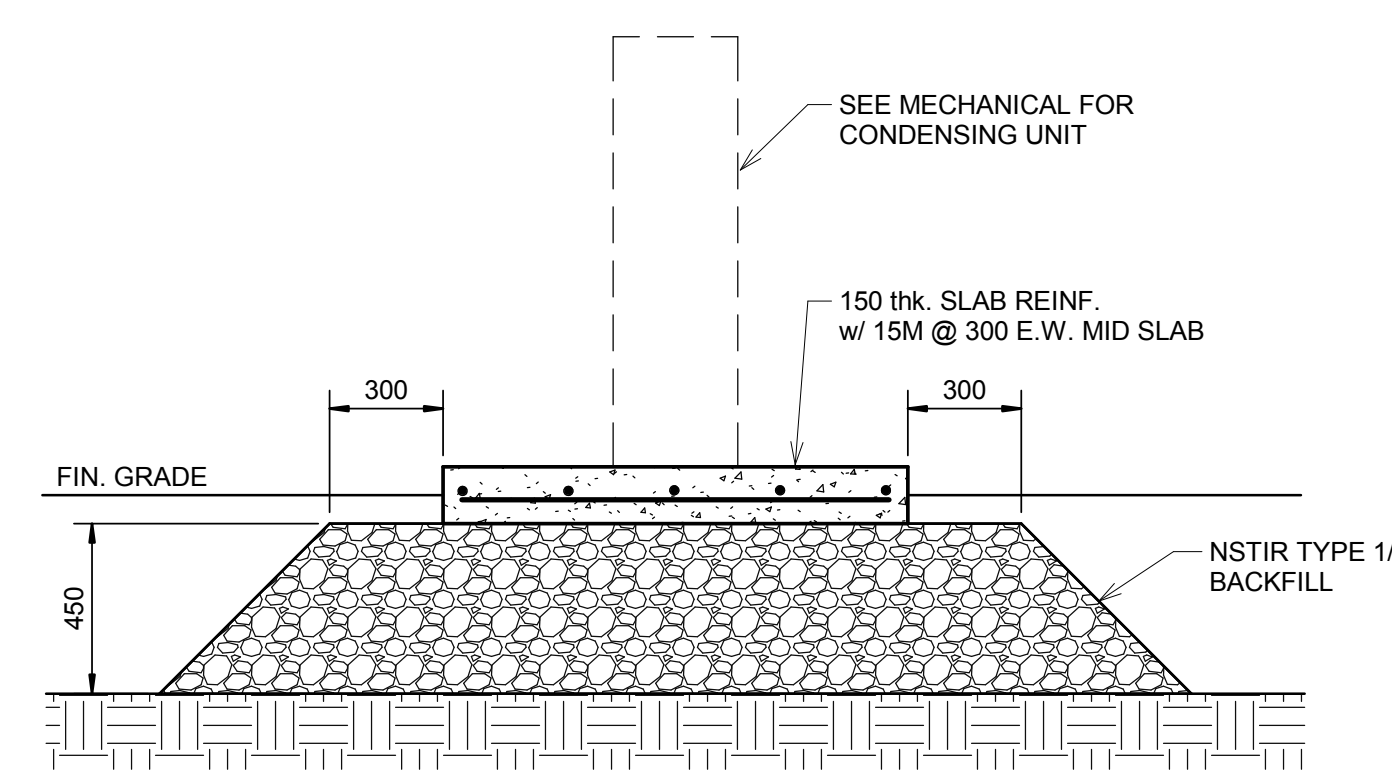

F SECTION S-1

SCALE: 1:20

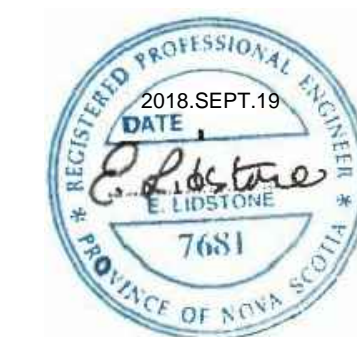

1	ISSUED FOR TENDER	2018.09.19
rev.		date

project BIO SEARCH & RESCUE
MARINE OPERATIONS
BUILDING

Dartmouth, Nova Scotia

drawing FOUNDATION PLAN
AND SECTIONS

designed E. LIDSTONE conçu

date 09/19/18

drawn R. LAJOIE dessiné

date 09/19/18

approved E. LIDSTONE approuvé

date 09/19/18

Tender Soumission

PWGSC Project Manager Administrateur de projets TPSCG

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drawing no. no. du dessin

S-1