
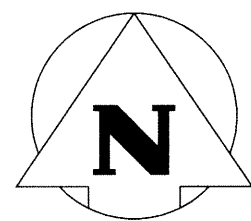


File Name: P:\Projects\2015\15-0006-010\Draw\Mech\15-0006-010_H05.dwg - Tab: H05 Plotted By: DPerocha 16/03/23 [Tue 10:03am]

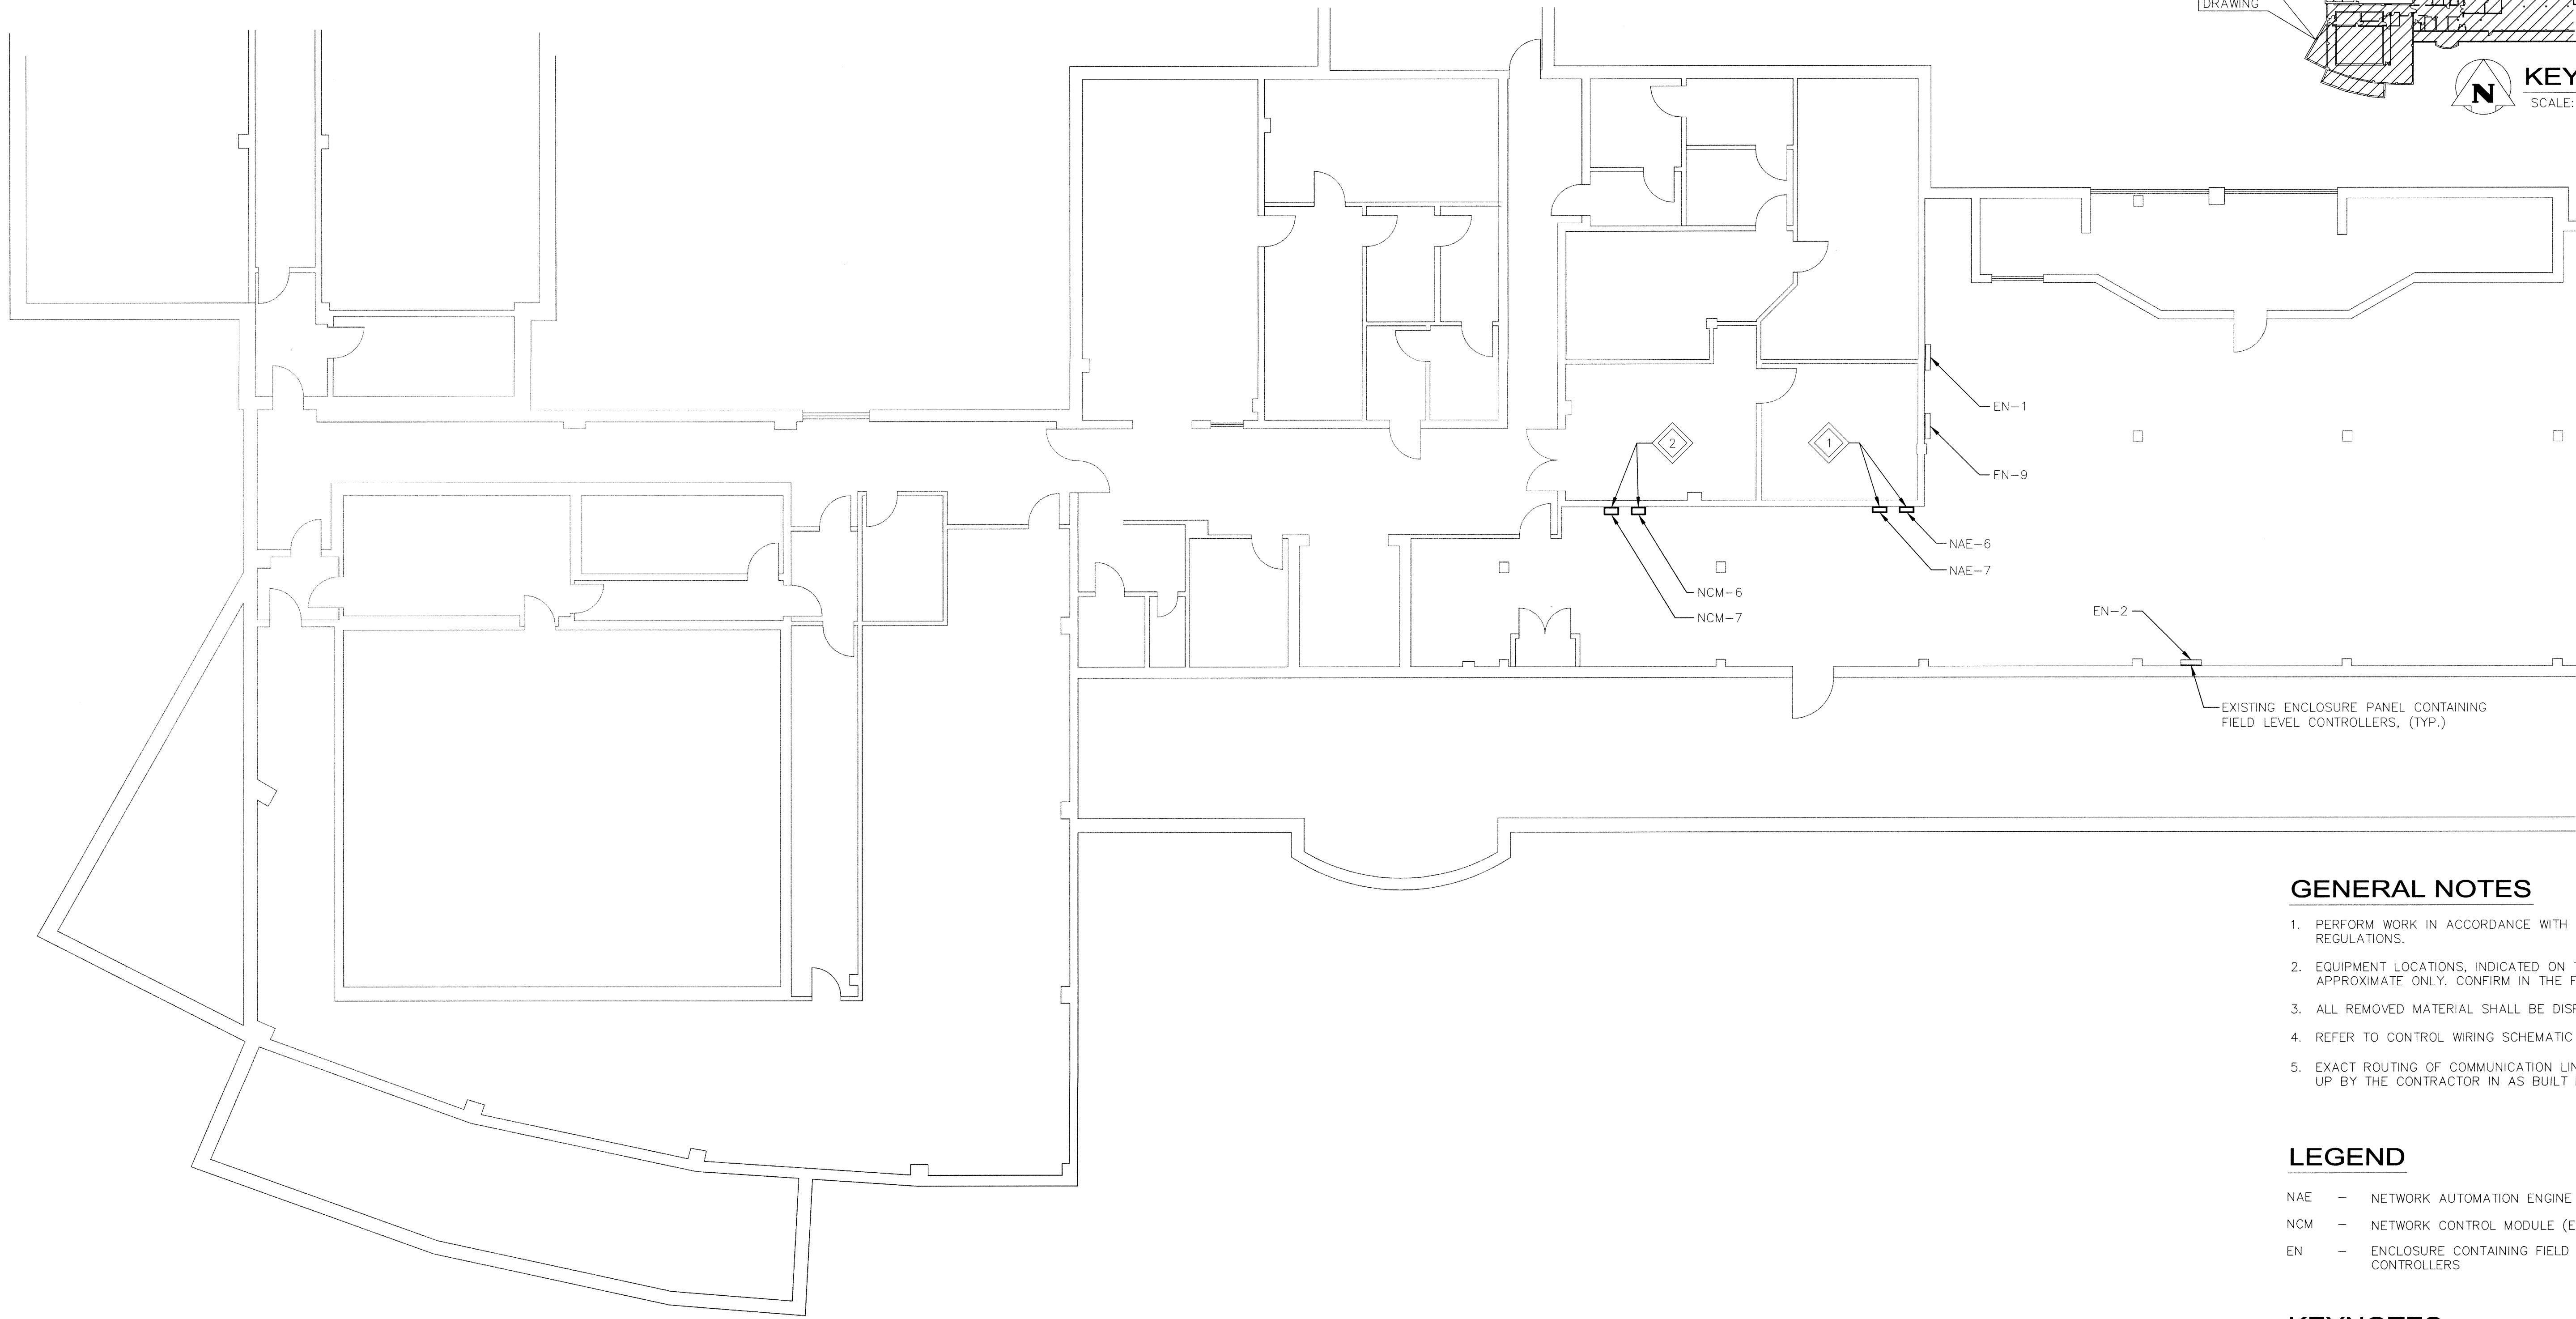

1

PARTIAL HEADER HOUSE 2nd FLOOR PLAN

2000 0 2000 4000 6000 8000
SCALE: 1:100mm (24"x36")

GENERAL NOTES

- PERFORM WORK IN ACCORDANCE WITH ALL APPLICABLE CODES AND REGULATIONS.
- EQUIPMENT LOCATIONS, INDICATED ON THE DRAWINGS IS APPROXIMATE ONLY. CONFIRM IN THE FIELD.
- ALL REMOVED MATERIAL SHALL BE DISPOSED OF OFF SITE.
- REFER TO CONTROL WIRING SCHEMATIC ON DRAWING H07.
- EXACT ROUTING OF COMMUNICATION LINES(CATS) TO BE MARKED UP BY THE CONTRACTOR IN AS BUILT DRAWINGS.


LEGEND

- NAE - NETWORK AUTOMATION ENGINE (NEW)
NCM - NETWORK CONTROL MODULE (EXISTING)
EN - ENCLOSURE CONTAINING FIELD LEVEL CONTROLLERS

KEYNOTES

- MOUNT NEW SUPERVISORY CONTROLLER (NAE-6 & 7) TO WALL. CONNECT TO EXISTING FIELD LEVEL DEVICES AND ADX SERVER.
- MAINTAIN EXISTING SUPERVISORY CONTROLLER (NCM-6 & 7) IN OPERATING CONDITION UNTIL NEW SYSTEM IS INSTALLED AND COMMISSIONED. REMOVE EXISTING CONTROLLER AND UNUSED CONTROL WIRING AND EQUIPMENT.

| | | | |
|--|--------------|-----------|--|
| Association of Professional Engineers & Geoscientists of Saskatchewan | | | |
| CERTIFICATE OF AUTHORIZATION | | | |
| KGS Group | | | |
| Number: 0620 | | | |
| Permission to Consult held by: | | | |
| Discipline | Sk. Reg. No. | Signature | |
| MECHANICAL | 357346 | | |

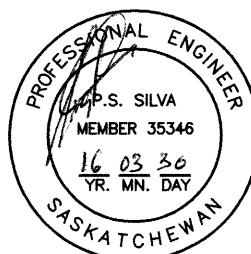

| Revision | Description | Date |
|----------|-------------------|------------|
| 0 | ISSUED FOR TENDER | 2016/03/30 |

Client: **AGRICULTURE AND
AGRI-FOOD CANADA**

Project: **SASKATOON, SK
107 SCIENCE PLACE**

**SASKATOON RESEARCH
CENTER BUILDING
AUTOMATION SYSTEM**

Designed by: **MAP** Conçu par:

Drawn by: **TJC/ESm** Dessiné par:

Approved by: **PAUL ADEKOGBE** Approuvé par:

Project Manager: **PAUL ADEKOGBE** Administrateur de Projets TPSG:

Drawing title: **MECHANICAL
HEADER HOUSE** Titre du dessin:

PARTIAL SECOND FLOOR PLAN

| Project no./No. du projet | Drawing no./No. du dessin | Revision no. |
|---------------------------|---------------------------|--------------|
| R.077058.001 | H05 OF 7 | 0 |