
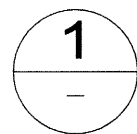
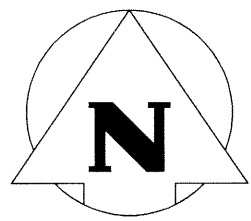



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#### ADMINISTRATION BASEMENT FLOOR PLAN

SCALE: 1:100mm (24"x36")

THIS  
DRAWING

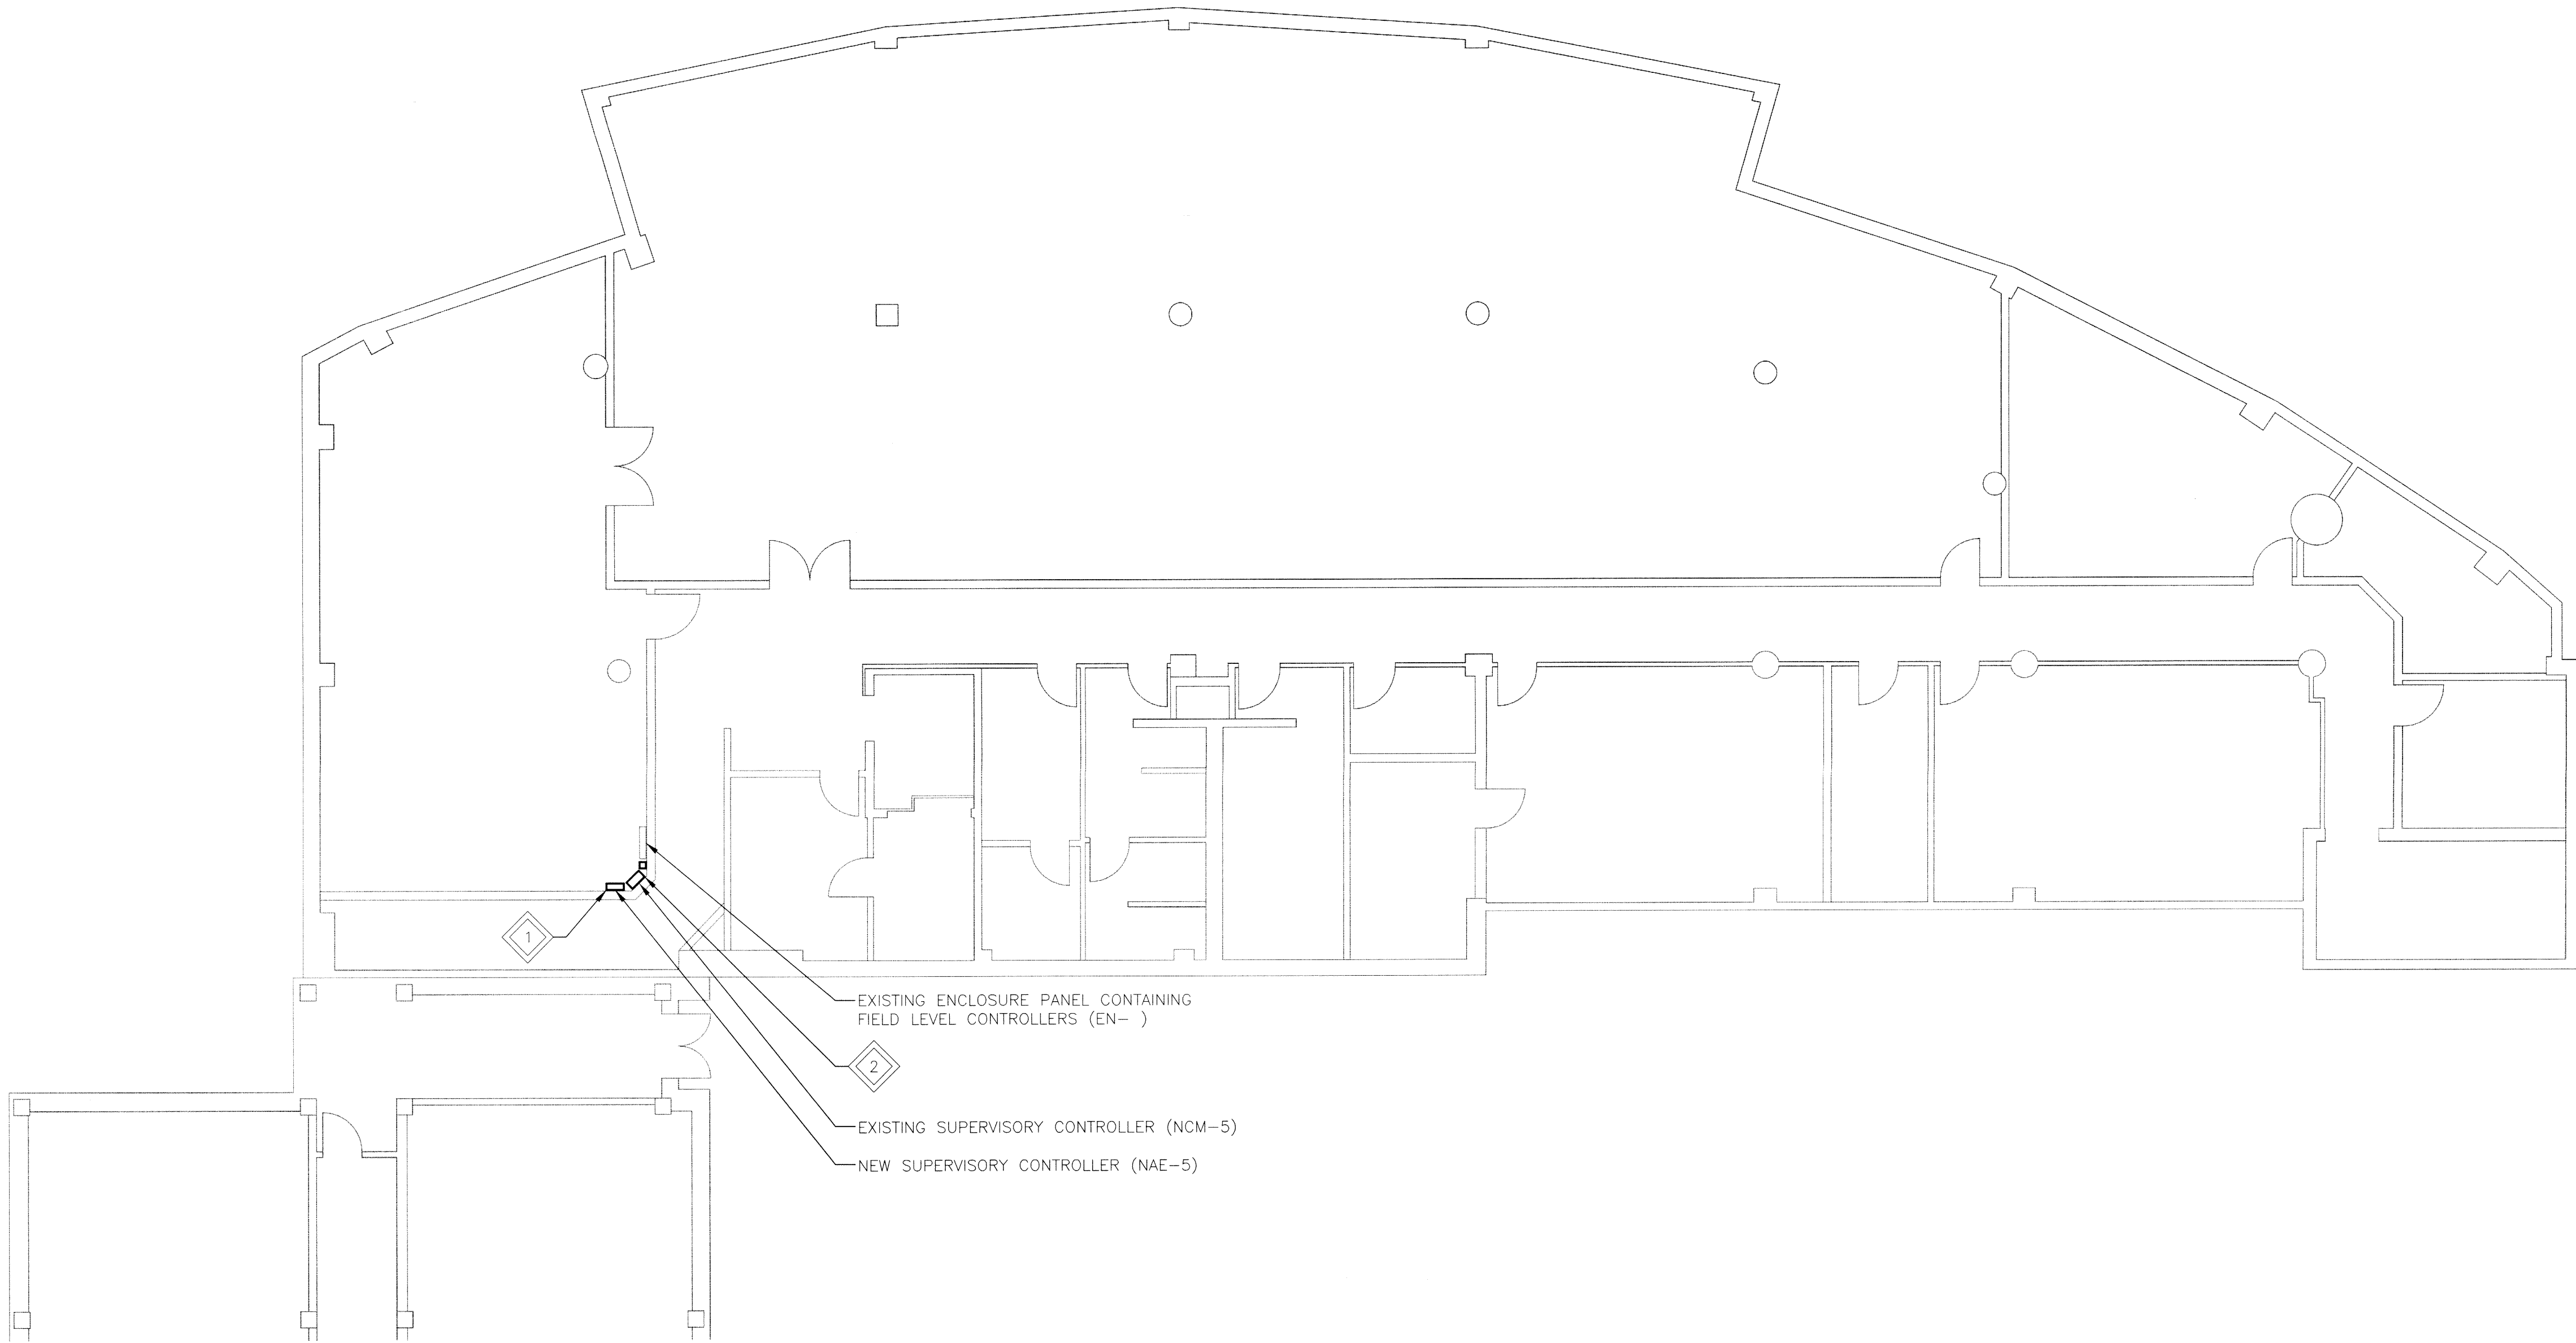

#### GENERAL NOTES

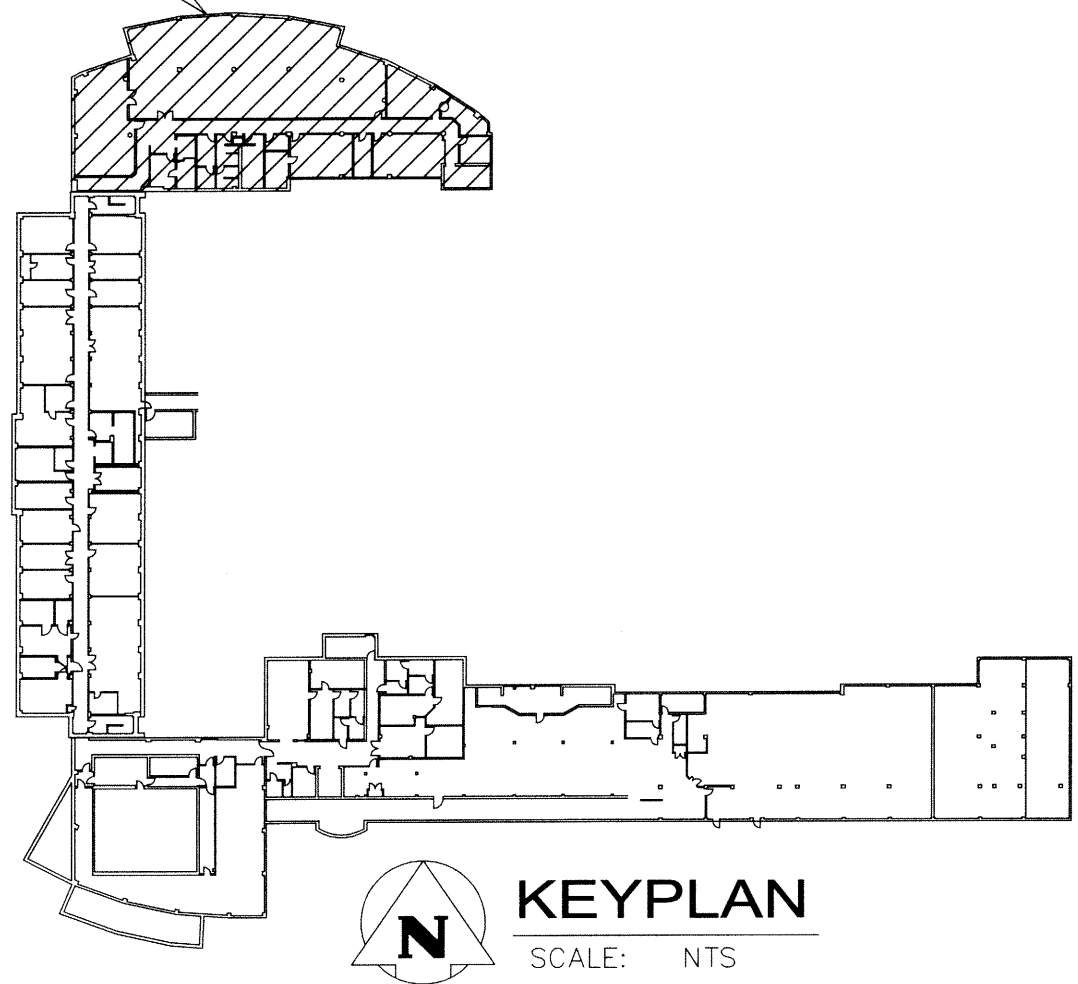1. PERFORM WORK IN ACCORDANCE WITH ALL APPLICABLE CODES AND REGULATIONS.
2. EQUIPMENT LOCATIONS, INDICATED ON THE DRAWINGS IS APPROXIMATE ONLY. CONFIRM IN THE FIELD.
3. ALL REMOVED MATERIAL SHALL BE DISPOSED OF OFF SITE.
4. REFER TO CONTROL WIRING SCHEMATIC ON DRAWING H07.
5. EXACT ROUTING OF COMMUNICATION LINES (CAT5) TO BE MARKED UP BY THE CONTRACTOR IN AS BUILT DRAWINGS.

#### LEGEND

- NAE -- NETWORK AUTOMATION ENGINE (NEW)  
NCM -- NETWORK CONTROL MODULE (EXISTING)  
EN -- ENCLOSURE CONTAINING FIELD LEVEL CONTROLLERS

#### KEYNOTES

- 1 MOUNT NEW SUPERVISORY CONTROLLER (NAE-5) TO WALL. CONNECT TO EXISTING FIELD LEVEL DEVICES AND ADX SERVER.
- 2 MAINTAIN EXISTING SUPERVISORY CONTROLLER (NCM-5) IN OPERATING CONDITION UNTIL NEW SYSTEM IS INSTALLED AND COMMISSIONED. REMOVE EXISTING CONTROLLER AND UNUSED CONTROL WIRING AND EQUIPMENT.

| Revision | Description       | Date       |
|----------|-------------------|------------|
| 0        | ISSUED FOR TENDER | 2016/03/30 |

Client client

#### AGRICULTURE AND AGRI-FOOD CANADA

Project Project  
**SASKATOON, SK  
107 SCIENCE PLACE**

#### SASKATOON RESEARCH CENTER BUILDING AUTOMATION SYSTEM

Designed by Conçu par

MAP

Drawn by Dessiné par

TJC/JFS

Approved by Approuvé par

PWSC Project Manager Administrateur de Projets TPSGC

PAUL ADEKOGBE

Drawing title Titre du dessin

#### MECHANICAL ADMINISTRATION BUILDING BASEMENT FLOOR PLAN

Project no./No. du projet Drawing no./No. du dessin Revision no.

R.077058.001 H01 0

OF 7

