




File Name: P:\Projects\2015\15-0006-010\Drawg\Mech\15-0006-010_H03.dwg — Tab: H03 Plotted By: DDerpche 16/03/29 [Tue 10:03am]

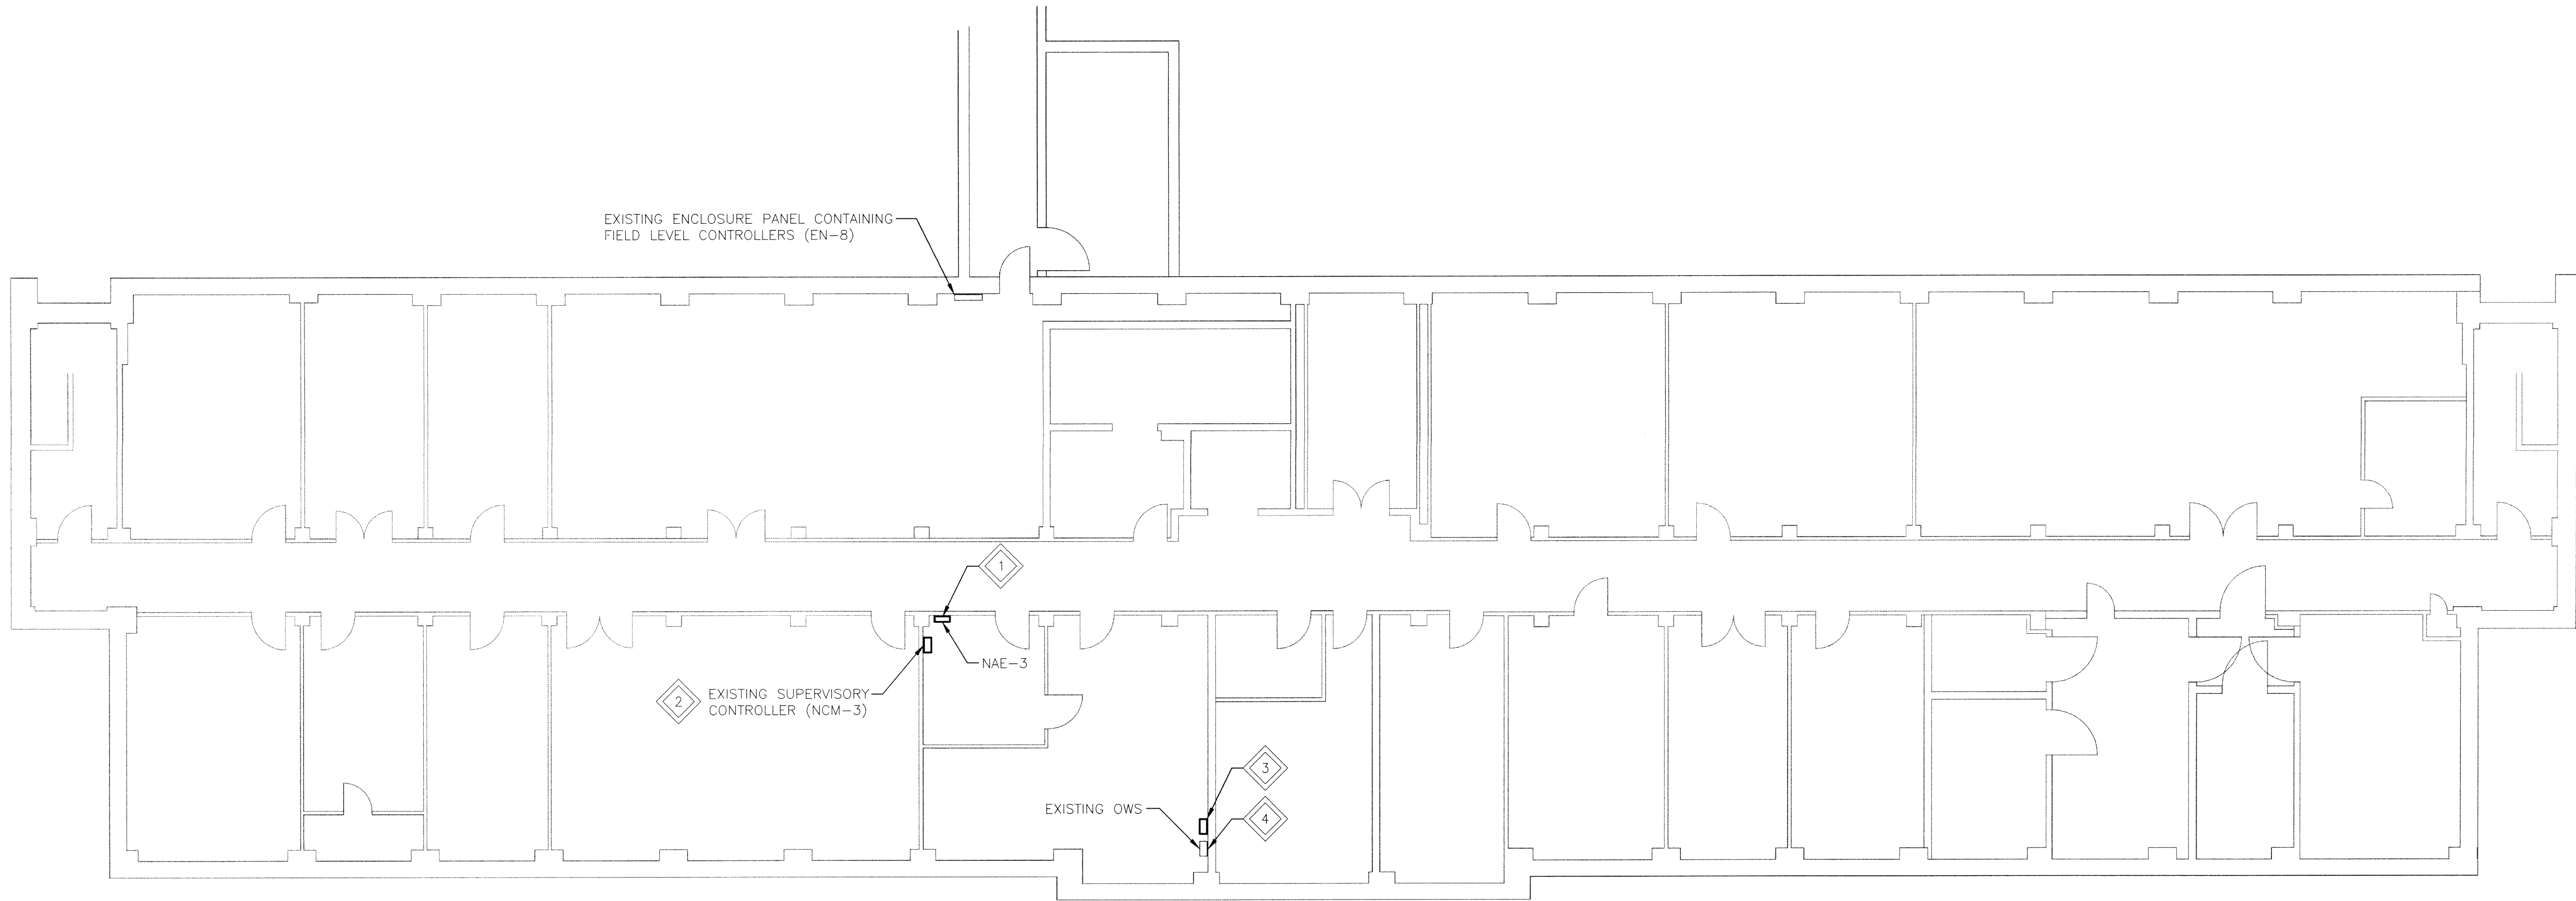

 **1** **LAB SUB-BASEMENT FLOOR PLAN**
2000 0 2000 4000 6000 8000
SCALE: 1:100mm (24"x36")

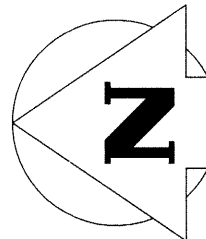

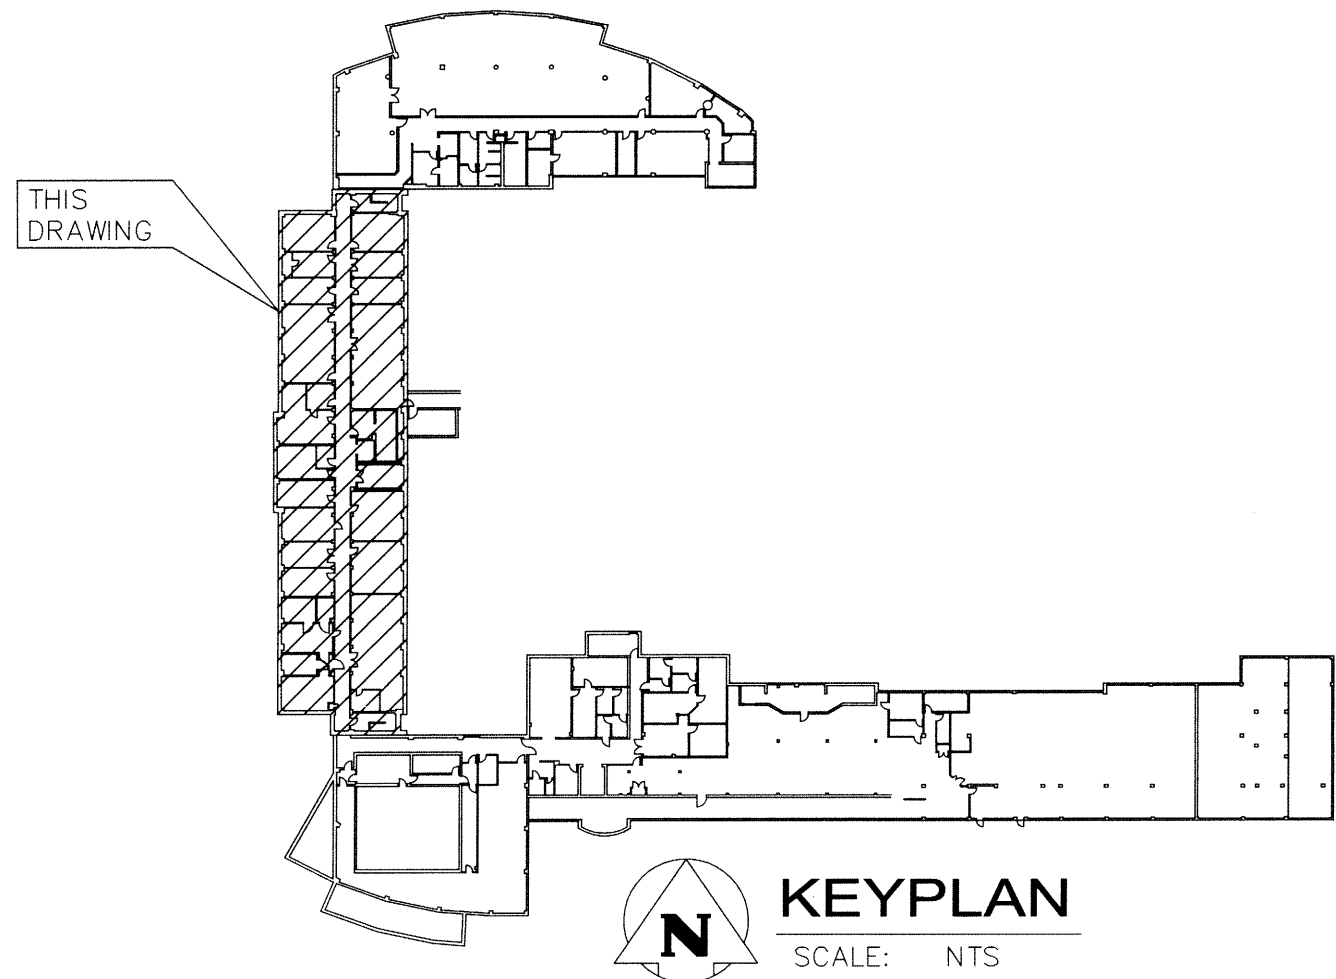



GENERAL NOTES

1. PERFORM WORK IN ACCORDANCE WITH ALL APPLICABLE CODES AND REGULATIONS.
2. EQUIPMENT LOCATIONS, INDICATED ON THE DRAWINGS IS APPROXIMATE ONLY. CONFIRM IN THE FIELD.
3. ALL REMOVED MATERIAL SHALL BE DISPOSED OF OFF SITE.
4. REFER TO CONTROL WIRING SCHEMATIC ON DRAWING H07.
5. EXACT ROUTING OF COMMUNICATION LINES (CAT5) TO BE MARKED UP BY THE CONTRACTOR IN AS BUILT DRAWINGS.

LEGEND

- NAE — NETWORK AUTOMATION ENGINE (NEW)
NCM — NETWORK CONTROL MODULE (EXISTING)
EN — ENCLOSURE CONTAINING FIELD LEVEL CONTROLLERS
OWS — OPERATOR WORKSTATION

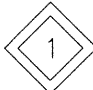
KEYNOTES

-  MOUNT NEW SUPERVISORY CONTROLLER (NAE-3) TO WALL. CONNECT TO EXISTING FIELD LEVEL DEVICES AND ADX SERVER.
-  MAINTAIN EXISTING SUPERVISORY CONTROLLER (NCM-3) IN OPERATING CONDITION UNTIL NEW SYSTEM IS INSTALLED AND COMMISSIONED. REMOVE EXISTING CONTROLLER AND UNUSED CONTROL WIRING AND EQUIPMENT.
-  PROVIDE NEW ADX SERVER. CONNECT TO NEW NAE SUPERVISORY CONTROLLERS.
-  MAINTAIN EXISTING OPERATOR WORKSTATION IN OPERATING CONDITION UNTIL NEW SYSTEM IS INSTALLED AND COMMISSIONED. REMOVE EXISTING WORKSTATION AND UNUSED WIRING AND EQUIPMENT.

Revision	Description	Date
0	ISSUED FOR TENDER	2016/02/10

Client client
AGRICULTURE AND AGRI-FOOD CANADA

Project Project
SASKATOON, SK
107 SCIENCE PLACE
SASKATOON RESEARCH CENTER BUILDING
ATOMATION SYSTEM

Designed by Conçu par
MAP
Drawn by Dessiné par
TJC/JFS
Approved by Approuvé par

PWGSC Project Manager Administrateur de Projets TPSGC
PAUL ADEKOGBE
Drawing title Titre du dessin
MECHANICAL
LABORATORY BUILDING
SUB-BASEMENT FLOOR PLAN

Project no./No. du projet	Drawing no./No. du dessin	Revision no.
R.077058.001	H03 OF 7	0

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