




3 EXISTING/DEMOLITION BARON MAGAZIN BUILDING SECTION
A-101 SCALE: 3/8" = 1'-0"

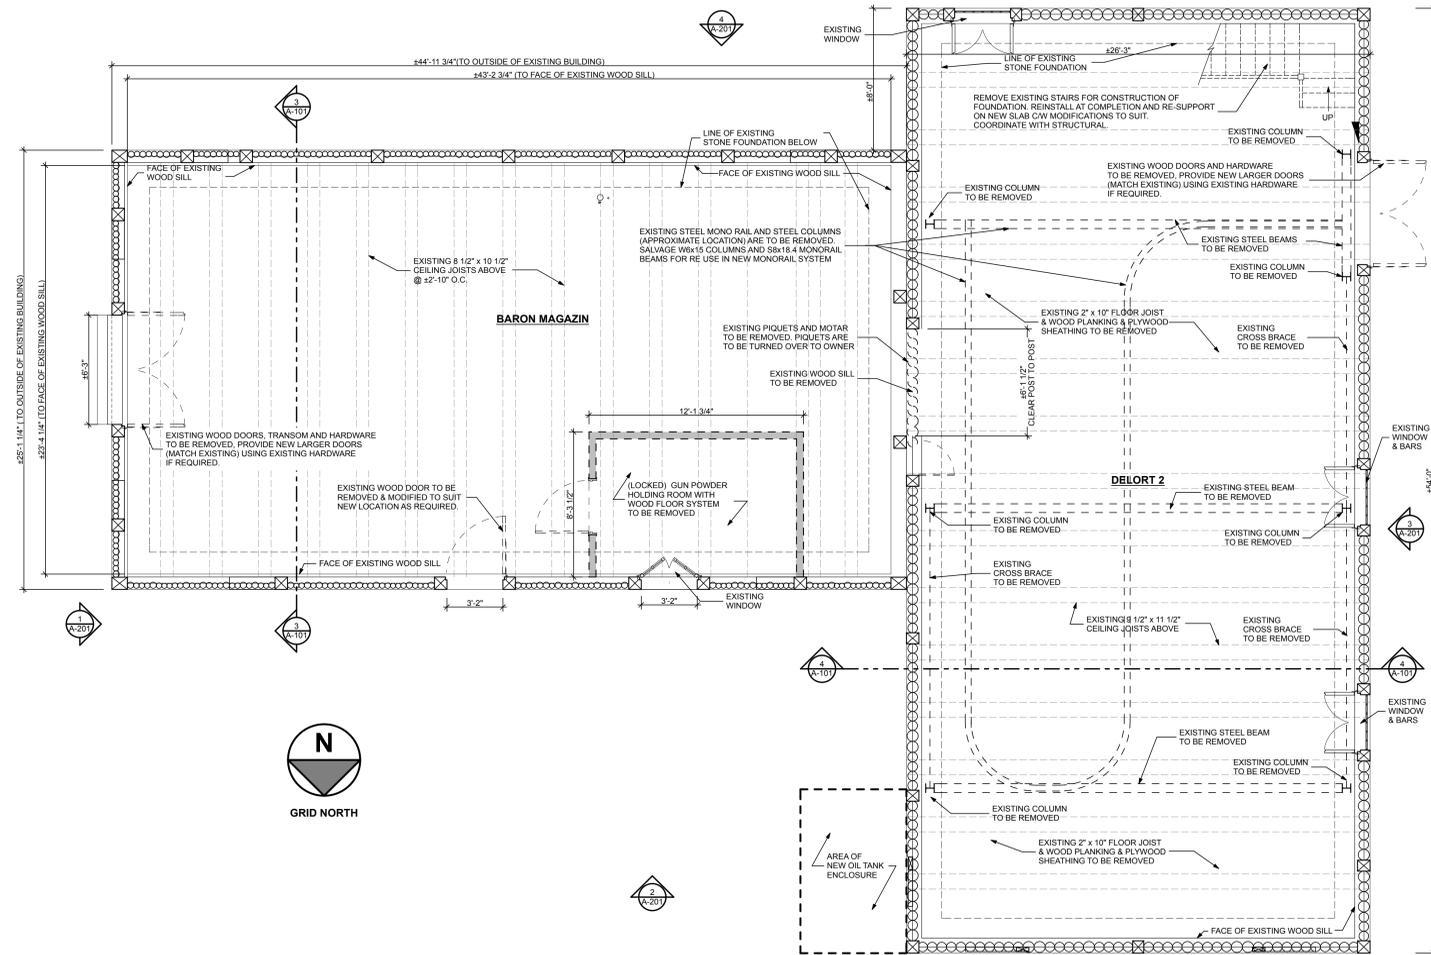

1 EXISTING/DEMOLITION MAIN FLOOR PLAN
A-101 SCALE: 1/4" = 1'-0"

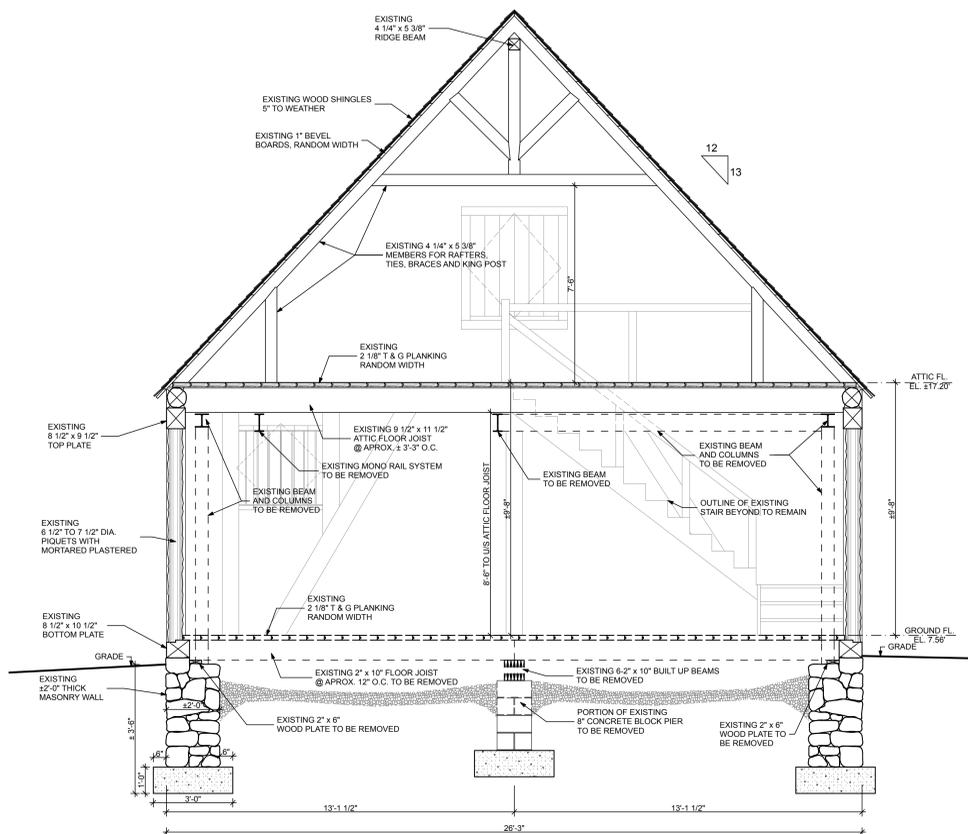

4 EXISTING/DEMOLITION DELORT 2 BUILDING SECTION
A-101 SCALE: 3/8" = 1'-0"

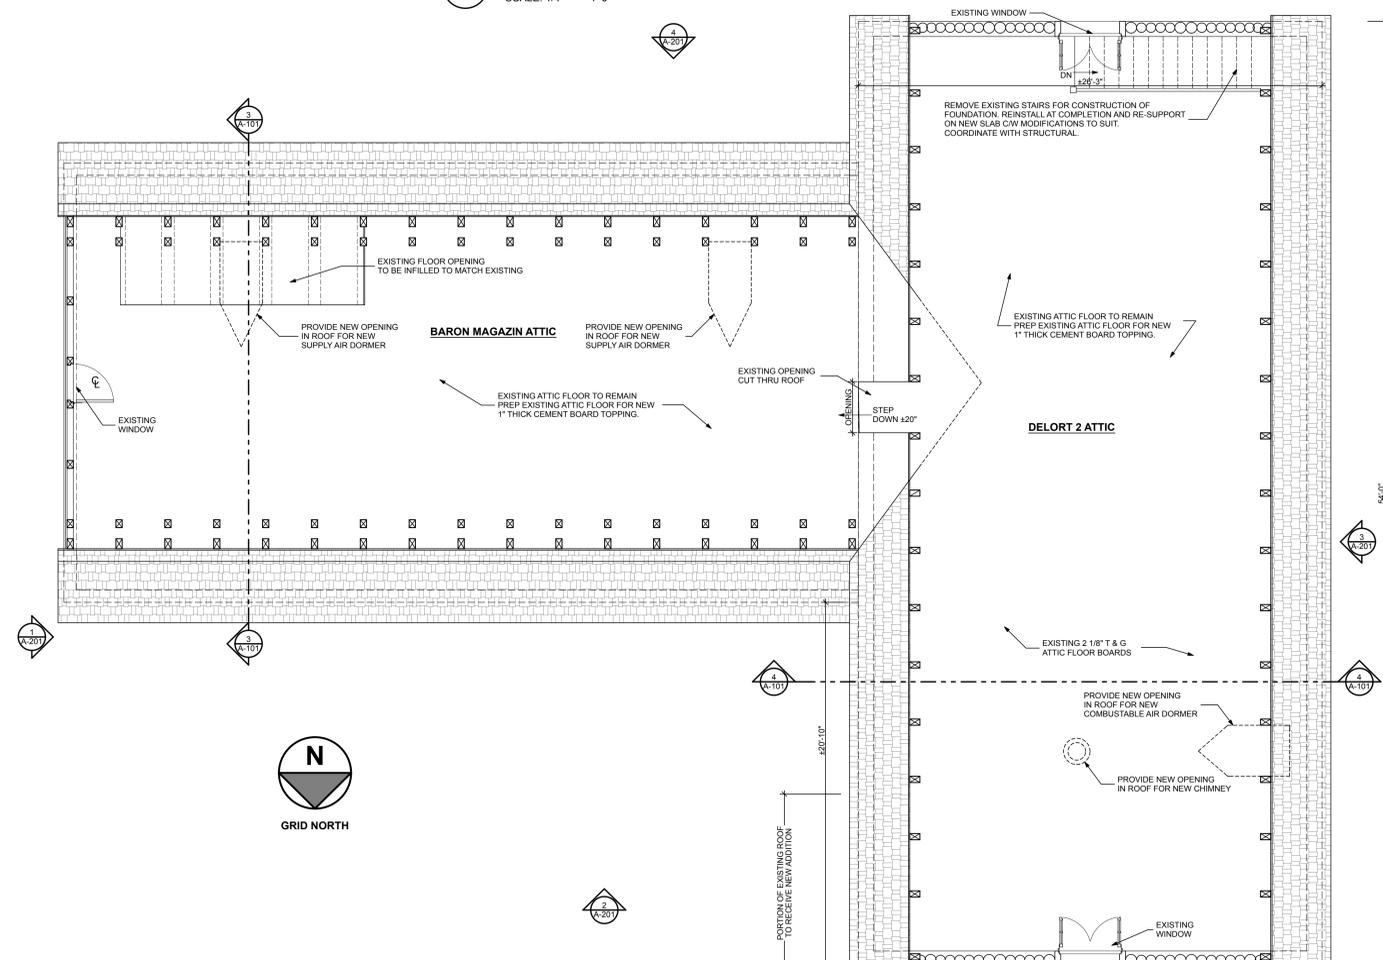

2 EXISTING/DEMOLITION ATTIC FLOOR PLAN
A-101 SCALE: 1/4" = 1'-0"

GENERAL NOTES


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NOTES



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NO.	DESCRIPTION	Y - M - D
1.	ISSUED FOR TENDER	16-11-21
REVISIONS		




PROJECT
CARPENTRY MILL SHOP
Fortress of Louisbourg
Louisbourg, N.S.

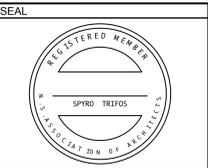DRAWING
BARON MAGAZIN & DELORT 2
EXISTING/DEMOLITION FLOOR PLANS
& BUILDING SECTIONS

DRAWN BY S.E.M.
CHECKED BY S.T.
SCALE AS NOTED
PLOT DATE 2016-11-21


CAD FILE MAIN/PROJ/CAD/15-049
DRWG. A-101

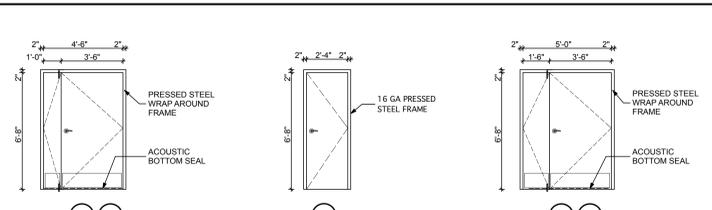

DOORS 1, 2
INSULATED METAL DOOR SYSTEM
 FRAME: 16 GAUGE THERMALLY BROKEN METAL - PAINT
 DOOR: 18 GAUGE INSULATED HOLLOW METAL - PAINT

DOOR 3
INSULATED METAL DOOR SYSTEM
 FRAME: 16 GAUGE THERMALLY BROKEN METAL - PAINT
 DOOR: 18 GAUGE INSULATED HOLLOW METAL - PAINT

DOORS 4, 5
INSULATED METAL DOOR SYSTEM
 FRAME: 16 GAUGE THERMALLY BROKEN METAL - PAINT
 DOOR: 18 GAUGE INSULATED HOLLOW METAL - PAINT

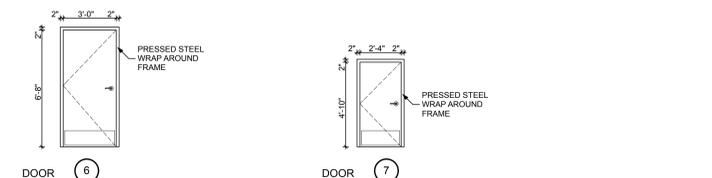

DOOR 6
INSULATED METAL DOOR SYSTEM
 FRAME: 16 GAUGE HOLLOW METAL - PAINT
 DOOR: 18 GAUGE HOLLOW METAL - PAINT

DOOR 7
INSULATED METAL DOOR SYSTEM
 FRAME: 16 GAUGE HOLLOW METAL - PAINT
 DOOR: 18 GAUGE HOLLOW METAL - PAINT


4 **INTERIOR DOOR SCHEDULE**
 SCALE: 1/4" = 1'-0"

NO.	DESCRIPTION	REVISIONS
1	ISSUED FOR TENDER	16-11-21
NO.	DESCRIPTION	Y - M - D




4a **EXTERIOR DOOR SCHEDULE**
 SCALE: 1/4" = 1'-0"


NO.	DESCRIPTION	REVISIONS
1	ISSUED FOR TENDER	16-11-21
NO.	DESCRIPTION	Y - M - D

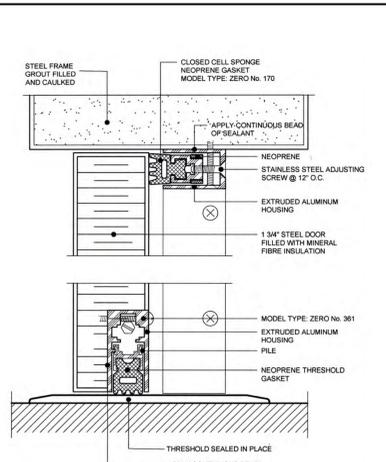


5 **DOOR GASKET DETAIL**
 NOT TO SCALE

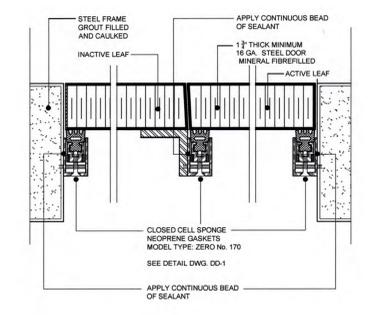


6 **PLAN DETAIL AT DOUBLE DOORS**
 NOT TO SCALE

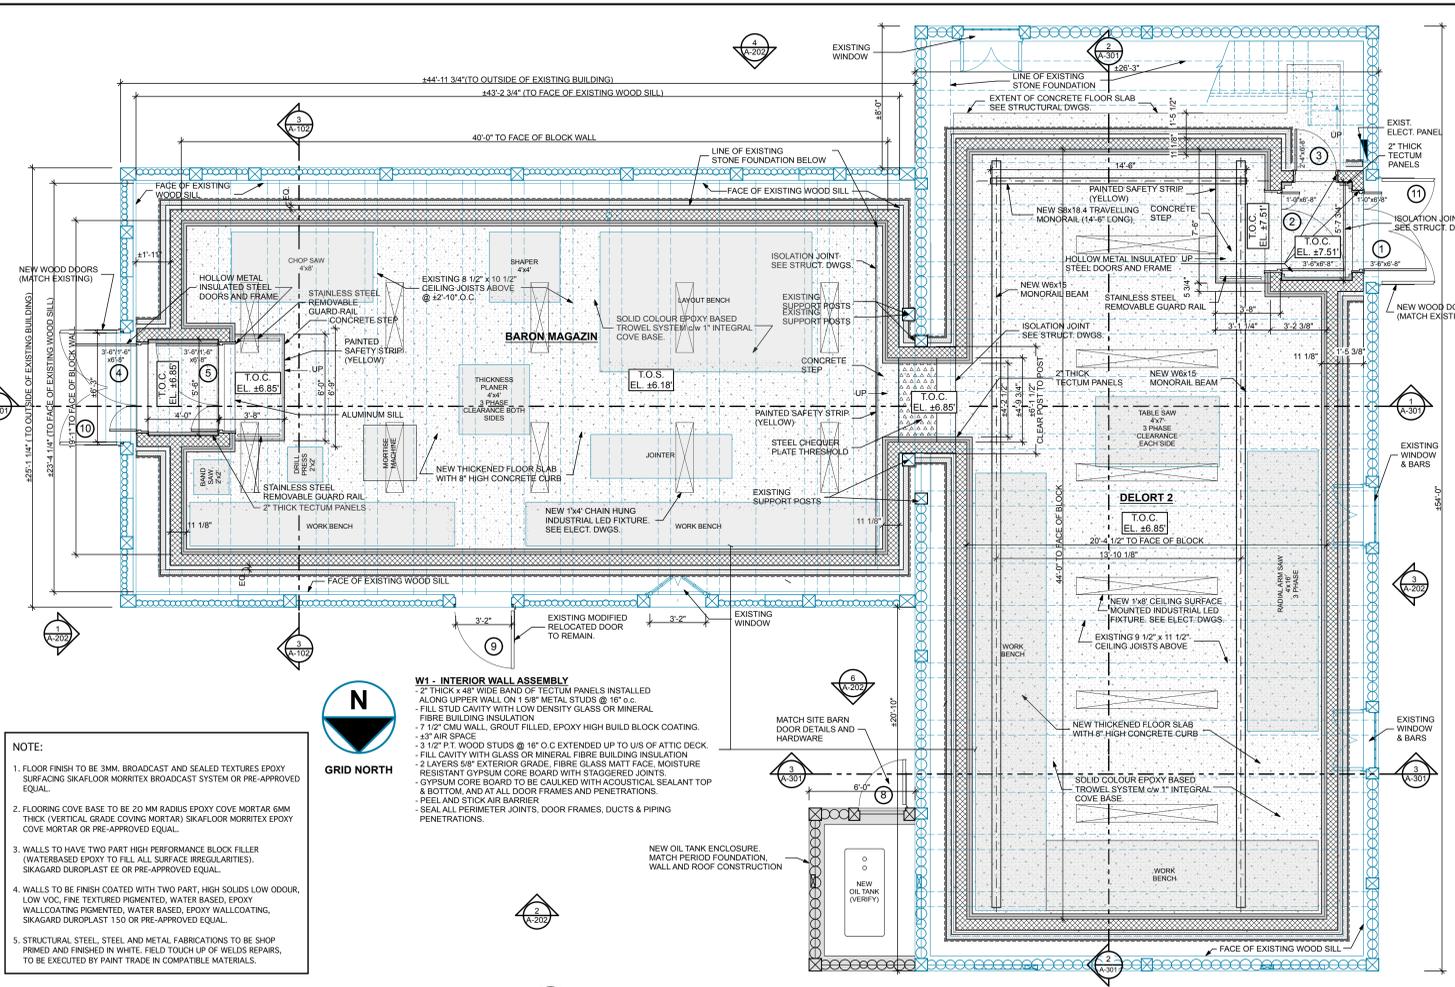

1 **RENOVATION MAIN FLOOR PLAN**
 SCALE: 1/4" = 1'-0"

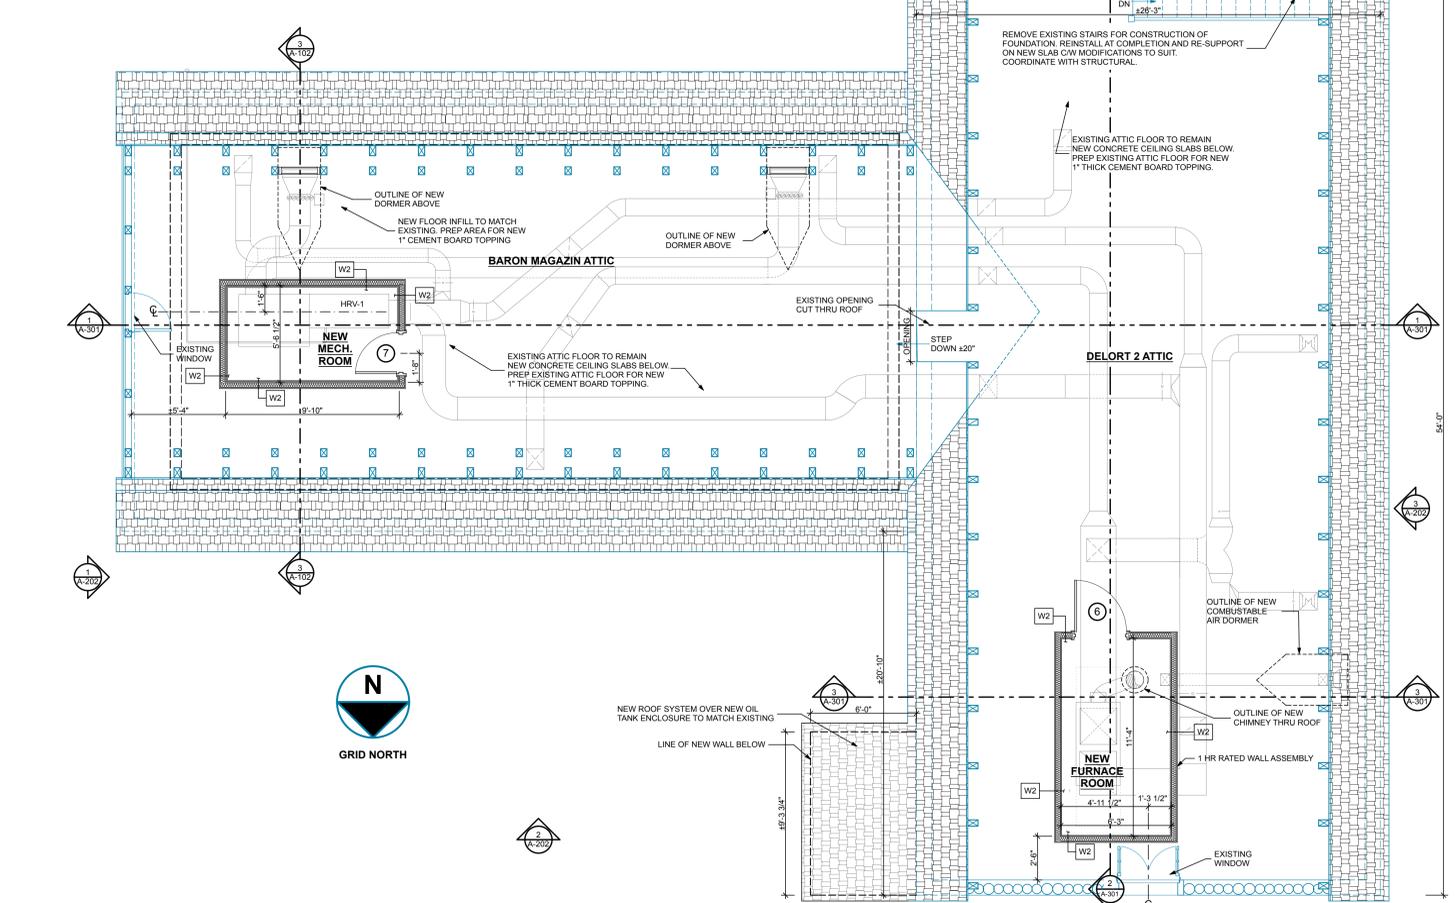

2 **RENOVATION ATTIC FLOOR PLAN**
 SCALE: 1/4" = 1'-0"

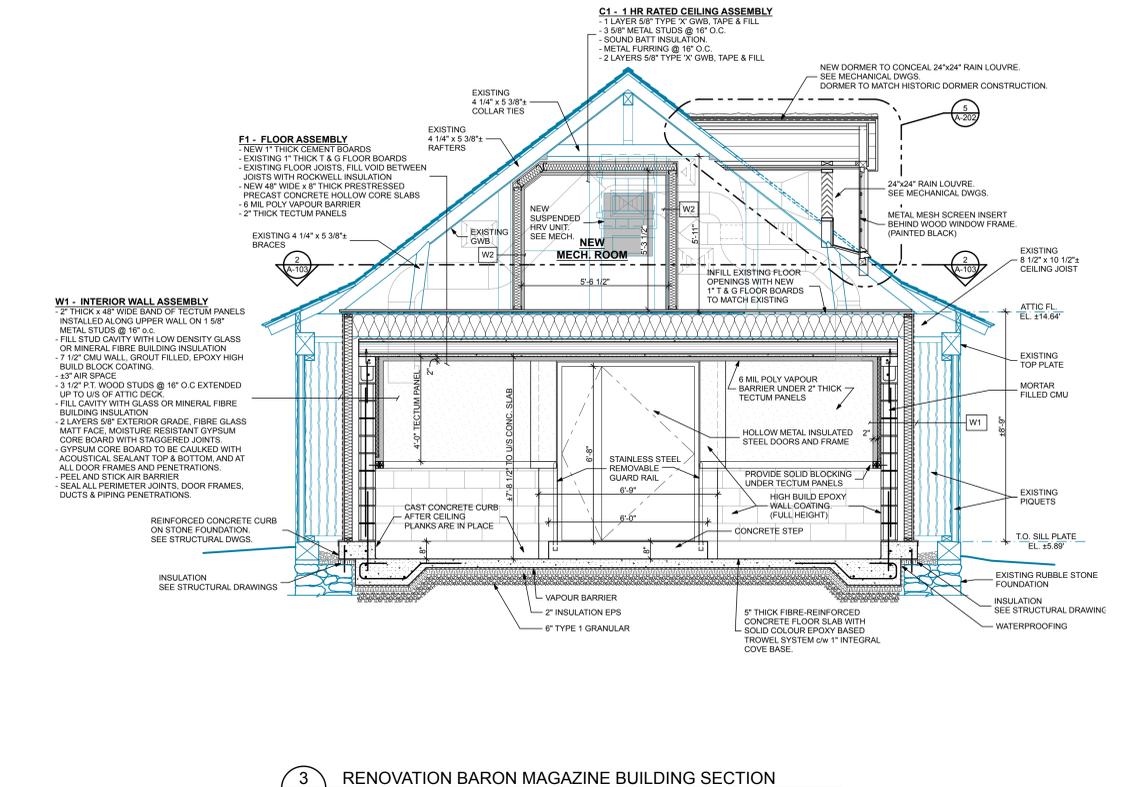

3 **RENOVATION BARON MAGAZINE BUILDING SECTION**
 SCALE: 3/8" = 1'-0"

GENERAL NOTES
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NOTES

MACHINERY WITH 3 PHASE MOTORS:
 THICKNESS PLANNER
 RADIAL ARM SAW
 MACHINERY WITH 110 MOTORS:
 BANDSAW
 TABLE SAW
 CHOP SAW
 MORTISE MACHINE
 MACHINES INCLUDING STATIONARY
ELECTRICAL:
 BUS COLLECTION
 BUS COLLECTION FLEXIBLE
 BUS COLLECTION FLEXIBLE
 BANDSAW
 DRILL PRESS
 SHAPER
 CHOP SAW
 MORTISE MACHINE

THE THICKNESS PLANNER AND TABLE SAW REQUIRE EQUAL CLEARANCE OF 14' ON BOTH SIDES.

W1 - INTERIOR WALL ASSEMBLY
 2" THICK x 48" WIDE BAND OF TECTUM PANELS INSTALLED ALONG UPPER WALL ON 1.5" METAL STUDS @ 16" O.C.
 FILL STUD CAVITY WITH LOW DENSITY GLASS OR MINERAL FIBRE BUILDING INSULATION
 7 1/2" CMU WALL, GROUT FILLED, EPOXY HIGH BUILD BLOCK COATING
 13" AIR SPACE
 3 1/2" x 12" WOOD STUDS @ 16" O.C. EXTENDED UP TO US OF ATTIC DECK
 FILL CAVITY WITH GLASS OR MINERAL FIBRE BUILDING INSULATION
 2 LAYERS 5/8" EXTERIOR GRADE, FIBRE GLASS MATT FACE, MOISTURE RESISTANT GYPSUM CORE BOARD WITH STAGGERED JOINTS
 GYPSUM CORE BOARD TO BE CALKED WITH ACOUSTICAL SEALANT TOP & BOTTOM AND AT ALL DOOR FRAMES AND PENETRATIONS
 PEEL AND STICK AIR BARRIER
 SEAL ALL PERIMETER JOINTS, DOOR FRAMES, DUCTS & PIPING PENETRATIONS.

W2 - 1 HR RATED WALL ASSEMBLY
 2 LAYERS 5/8" TYPE 'X' GWB, TAPE & FILL
 3 1/2" METAL STUDS @ 16" O.C.
 SOUND BATT INSULATION
 1 LAYER 5/8" TYPE 'X' GWB, TAPE & FILL
 SEAL ALL PERIMETER JOINTS, DOOR FRAMES, DUCTS & PIPING PENETRATIONS.

C1 - 1 HR RATED CEILING ASSEMBLY
 1 LAYER 5/8" TYPE 'X' GWB, TAPE & FILL
 3 1/2" METAL STUDS @ 16" O.C.
 SOUND BATT INSULATION
 METAL FURRING @ 16" O.C.
 2 LAYERS 5/8" TYPE 'X' GWB, TAPE & FILL
 SEAL ALL PERIMETER JOINTS, DOOR FRAMES, DUCTS & PIPING PENETRATIONS.

exp.

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 301 Alexandra St.
 Sydney, NS B1P 2B8
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NO.	DESCRIPTION	REVISIONS
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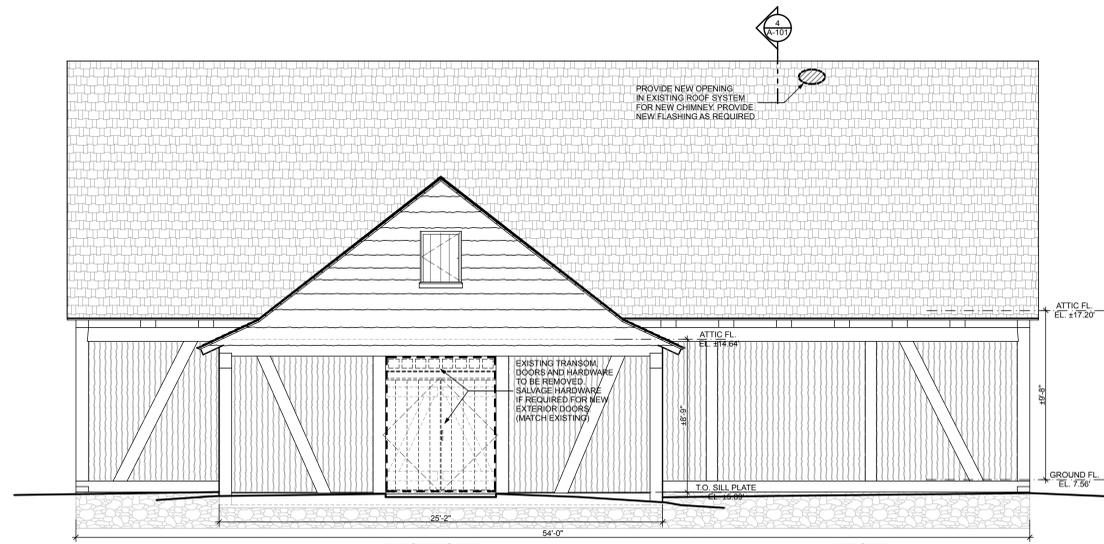
Trifos ARCHITECTURE
 P.O. Box 1072, Sydney, N.S., Canada
 Phone: 902-224-2294 Fax: 902-564-5660
 301 Alexandra St. Sydney, NS B1P 2B8 CANADA
 www.trifos.com

PROJECT
CARPENTRY MILL SHOP
 Fortress of Louisbourg
 Louisbourg, N.S.


DRAWING
BARON MAGAZIN & DELORT 2 RENOVATION FLOOR PLANS, BUILDING SECTION & DOOR SCHEDULE

DRAWN BY S.E.M.
CHECKED BY S.T.
SCALE AS NOTED
PLOT DATE 2016-11-21


CAD FILE MAIN/PROJ/CAD/15-049
DRWG. A-102




1
A-201 EXISTING/DEMOLITION EAST ELEVATION
SCALE: 1/4" = 1'-0"

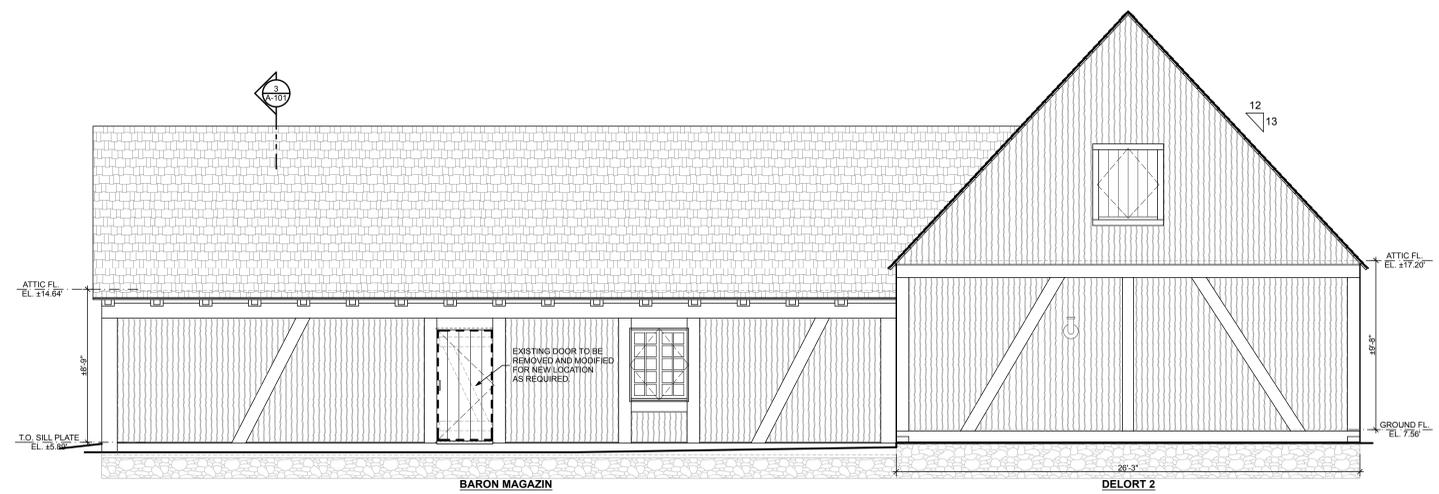

2
A-201 EXISTING/DEMOLITION NORTH ELEVATION
SCALE: 1/4" = 1'-0"

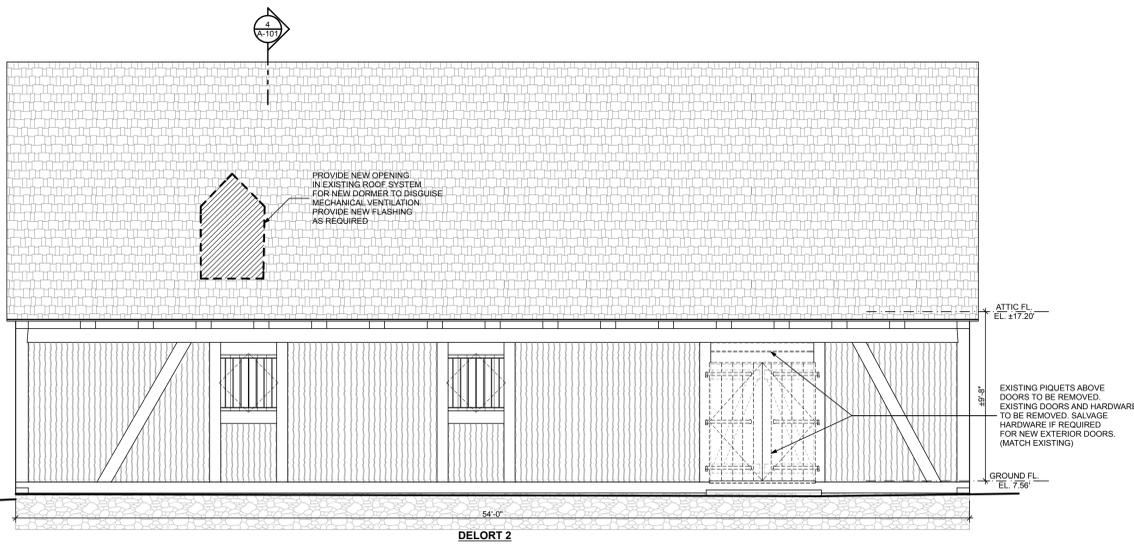

3
A-201 EXISTING/DEMOLITION WEST ELEVATION
SCALE: 1/4" = 1'-0"

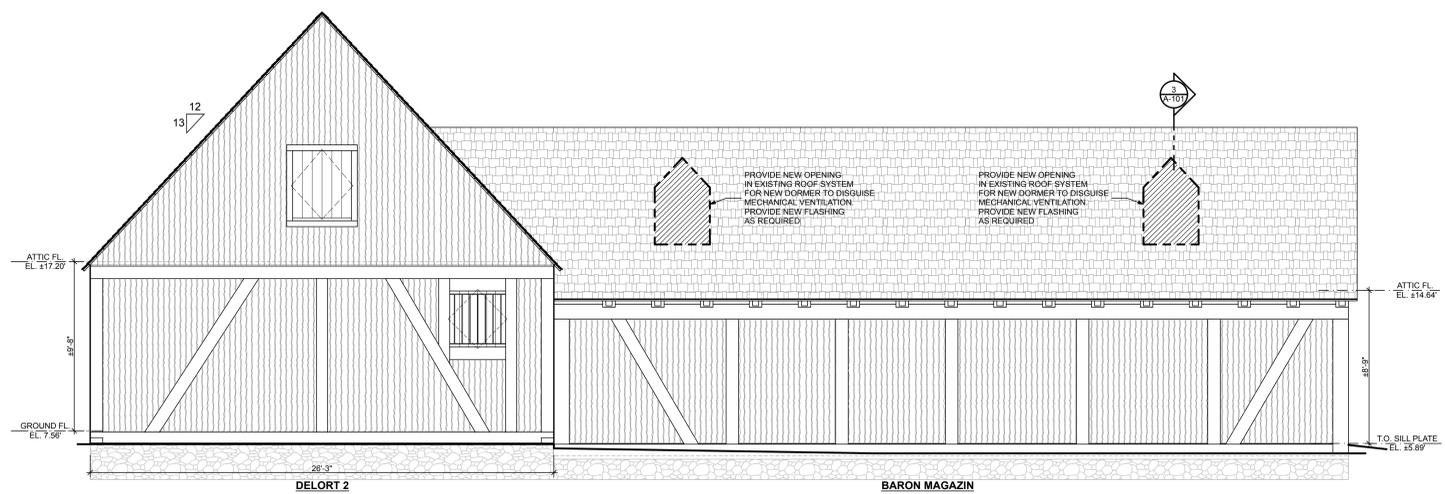

4
A-201 EXISTING/DEMOLITION SOUTH ELEVATION
SCALE: 1/4" = 1'-0"


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NOTES

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NO.	DESCRIPTION	Y - M - D
1.	ISSUED FOR TENDER	16-11-21
REVISIONS		



Trifos ARCHITECTURE

P.O. Box 1072, Sydney, N.S., Canada
 ph. 502-554-5670 fax. 502-554-1036
 trifos@exp.com www.trifos.com

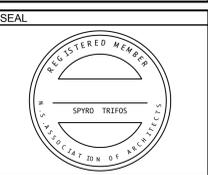PROJECT
CARPENTRY MILL SHOP
 Fortress of Louisbourg
 Louisbourg, N.S.

DRAWING
 BARON MAGAZIN & DELORT 2
 EXISTING/DEMOLITION ELEVATIONS

DRAWN BY S.E.M.
 CHECKED BY S.T.
 SCALE AS NOTED
 PLOT DATE 2016-11-21

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 DRWG. A-201

GENERAL NOTES


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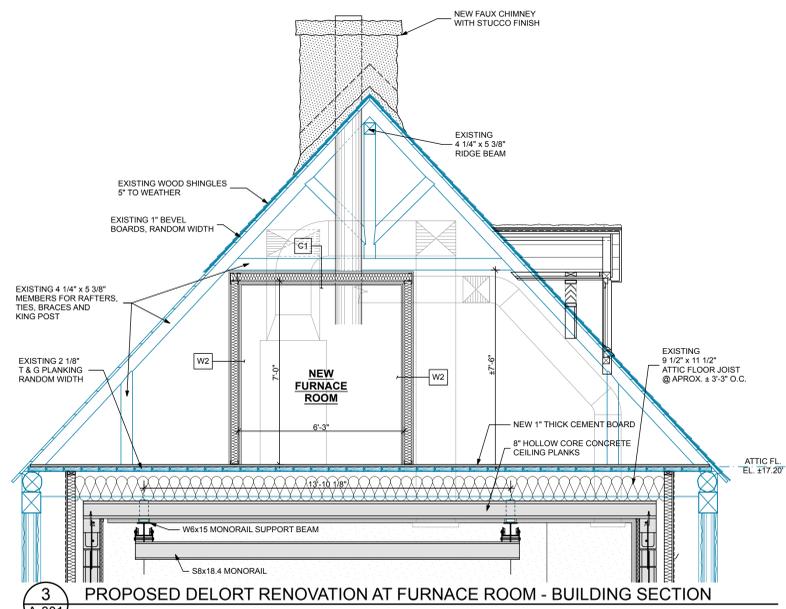
W1 - INTERIOR WALL ASSEMBLY
 - 2" THICK 48" WIDE BAND OF TECTUM PANELS INSTALLED ALONG UPPER WALL ON 1 5/8" METAL STUDS @ 16" O.C.
 - FILL STUD CAVITY WITH LOW DENSITY GLASS OR MINERAL FIBRE BUILDING INSULATION
 - 7 1/2" CMU WALL, GROUT FILLED, EPOXY HIGH BUILD BLOCK COATING
 - 1/2" AIR SPACE
 - 3 1/2" PLYWOOD STUDS @ 16" O.C. EXTENDED UP TO US OF ATTIC DECK
 - FILL CAVITY WITH GLASS OR MINERAL FIBRE BUILDING INSULATION
 - 2 LAYERS 5/8" EXTERIOR GRADE, FIBRE GLASS MATT FACE, MOISTURE RESISTANT GYPSUM CORE BOARD WITH STAGGERED JOINTS
 - GYPSUM CORE BOARD TO BE CAULKED WITH ACOUSTICAL SEALANT TOP & BOTTOM, AND AT ALL DOOR FRAMES AND PENETRATIONS
 - PEEL AND STICK AIR BARRIER
 - SEAL ALL PERIMETER JOINTS, DOOR FRAMES, DUCTS & PIPING PENETRATIONS.

W2 - 1 HR RATED WALL ASSEMBLY
 - 2 LAYERS 5/8" TYPE 'X' GWB, TAPE & FILL
 - 3 5/8" METAL STUDS @ 16" O.C.
 - SOUND BATT INSULATION
 - 1 LAYER 5/8" TYPE 'X' GWB, TAPE & FILL
 - SEAL ALL PERIMETER JOINTS, DOOR FRAMES, DUCTS & PIPING PENETRATIONS.


C1 - 1 HR RATED CEILING ASSEMBLY
 - 2 LAYERS 5/8" TYPE 'X' GWB, TAPE & FILL
 - 3 5/8" METAL STUDS @ 16" O.C.
 - SOUND BATT INSULATION
 - 1 LAYER 5/8" TYPE 'X' GWB, TAPE & FILL
 - SEAL ALL PERIMETER JOINTS, DOOR FRAMES, DUCTS & PIPING PENETRATIONS.



1 PROPOSED BARON MAGAZIN/DELORT RENOVATION BUILDING SECTION
 SCALE: 3/8" = 1'-0"

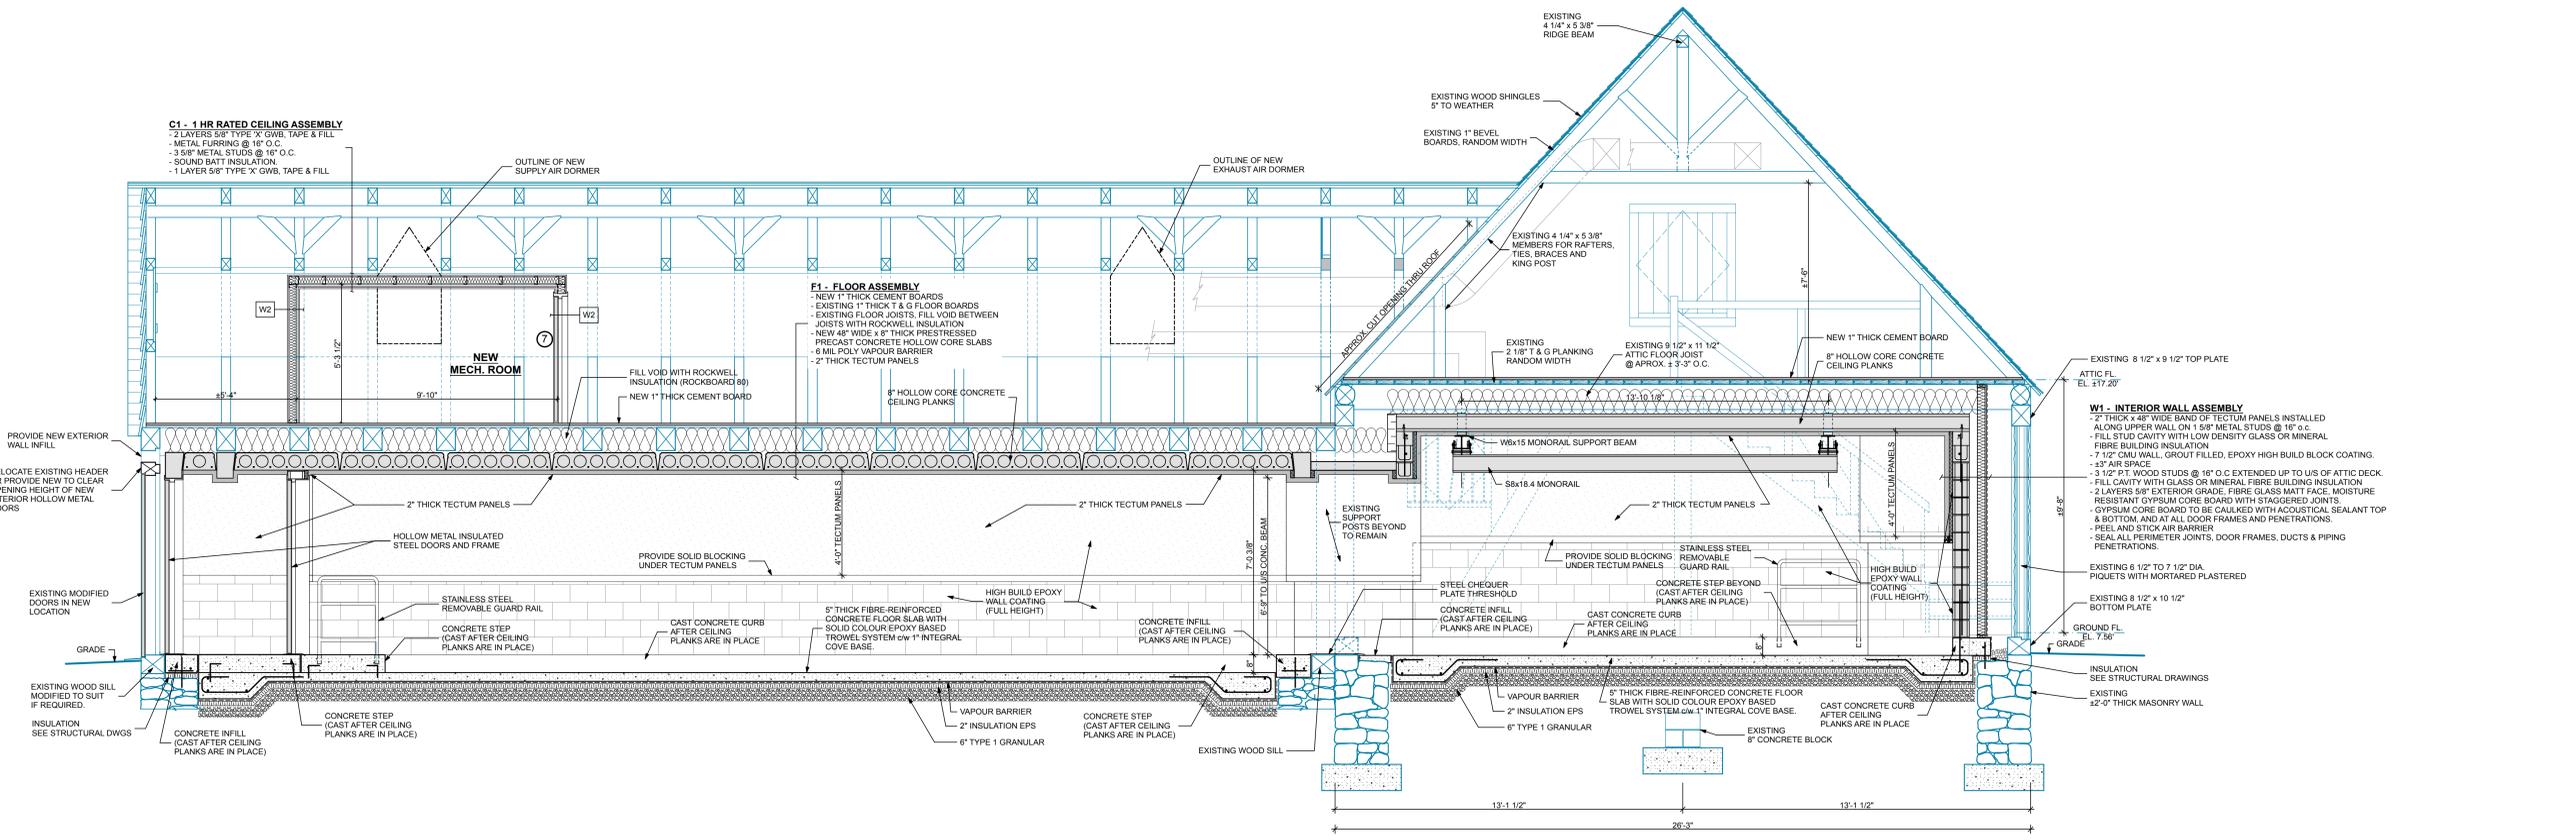

3 PROPOSED DELORT RENOVATION AT FURNACE ROOM - BUILDING SECTION
 SCALE: 3/8" = 1'-0"

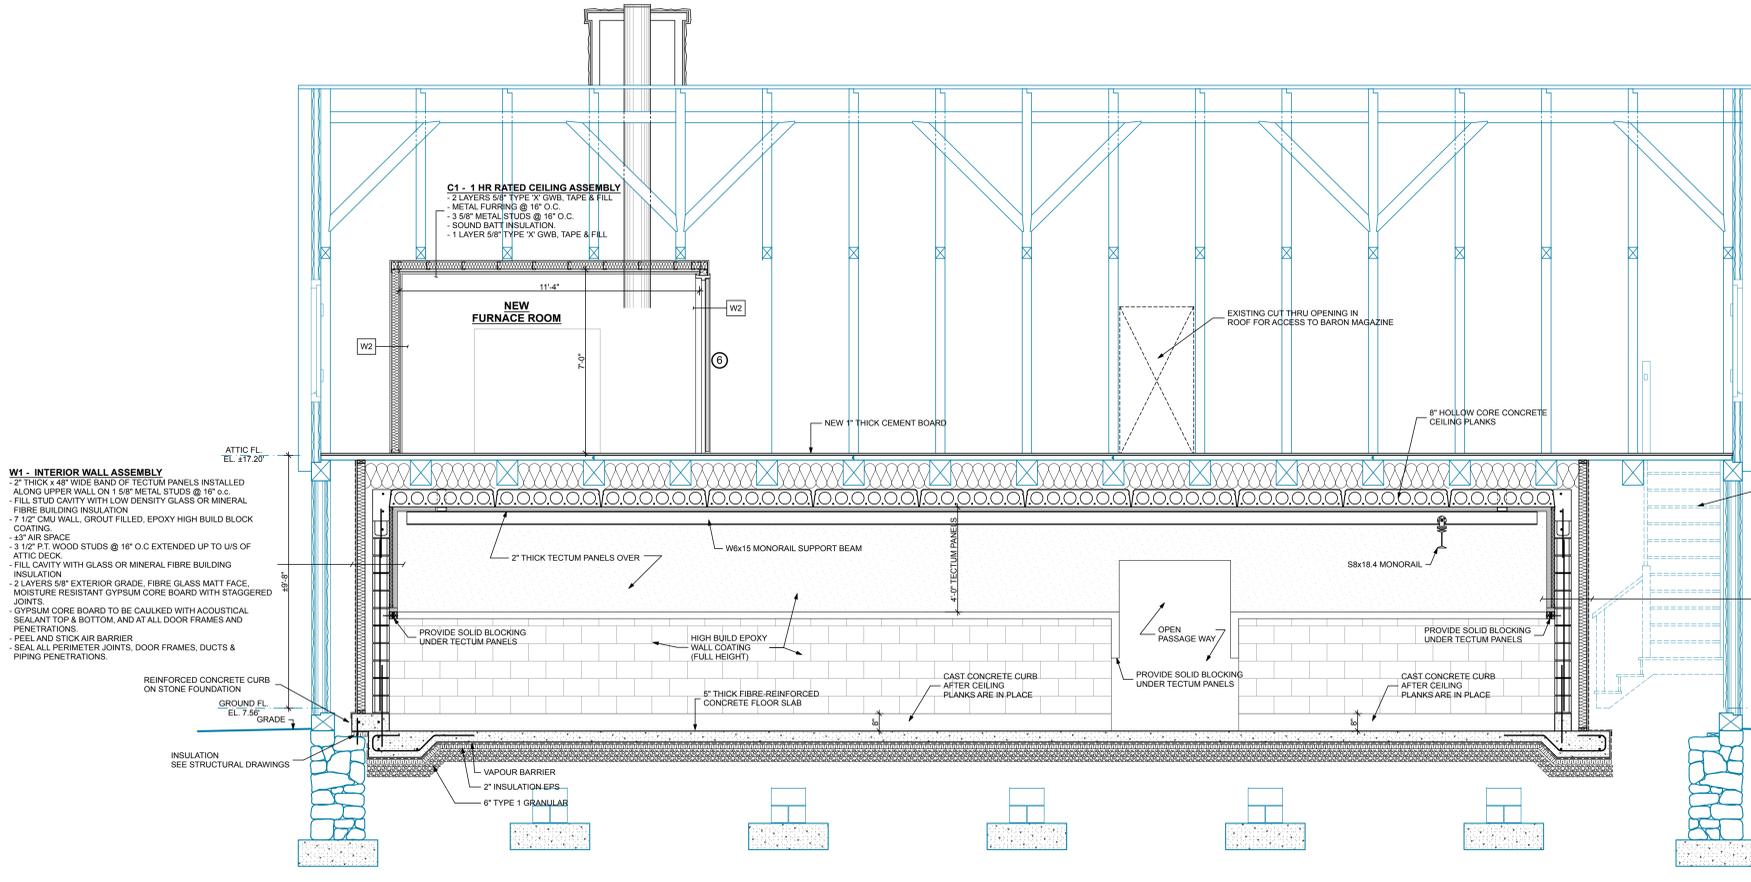

2 PROPOSED DELORT RENOVATION BUILDING SECTION
 SCALE: 3/8" = 1'-0"


NOTE:

- FLOOR FINISH TO BE 3MM, BROADCAST AND SEALED TEXTURES EPOXY SURFACING SKAFLOOR MORRTX BROADCAST SYSTEM OR PRE-APPROVED EQUAL.
- FLOORING COVE BASE TO BE 20 MM RADIUS EPOXY COVE MORTAR 6MM THICK (VERTICAL GRADE COVING MORTAR) SKAFLOOR MORRTX EPOXY COVE MORTAR OR PRE-APPROVED EQUAL.
- WALLS TO HAVE TWO PART HIGH PERFORMANCE BLOCK FILLER (WATERBASED EPOXY TO FILL ALL SURFACE IRREGULARITIES), SKAGARD DUROPLAST EE OR PRE-APPROVED EQUAL.
- WALLS TO BE FINISH COATED WITH TWO PART, HIGH SOLIDS LOW ODOR, LOW VOC, FINE TEXTURED PROMOTED, WATER BASED, EPOXY WALL COATING, SKAGARD DUROPLAST 150 OR PRE-APPROVED EQUAL.
- STRUCTURAL, STEEL, STEEL AND METAL FABRICATIONS TO BE SHOP PRIMED AND FINISHED IN WHITE. FIELD TOUCH UP OF WELDS REPAIRS, TO BE EXECUTED BY PAINT TRADE IN COMPATIBLE MATERIALS.

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NO.	DESCRIPTION	DATE
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NO.	REVISIONS	Y - M - D



Trifos ARCHITECTURE
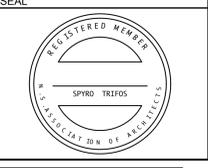
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PROJECT
 CARPENTRY MILL SHOP
 Fortress of Louisbourg
 Louisbourg, N.S.

DRAWING
 BUILDING SECTIONS

DRAWN BY S.E.M.
CHECKED BY S.T.
SCALE AS NOTED
PLOT DATE 2016-11-21

CAD FILE MAIN/PROJ/CAD/15-049
DRWS. A-301

