# FUEL TANK REPAIR AND REPLACEMENT PROJECT ARCTIC BAY, NUNAVUT

# **DRAWING LIST:**

## V009 - RESIDENCE

**DEMOLITION PLAN** M1.0 CONSTRUCTION PLAN M1.1

M2.0 TANK ELEVATIONS 2" FUEL LINE SUPPORT DETAILS M2.1

M3.0 SCHEMATIC

#### V100 - RESIDENCE

M1.0 **DEMOLITION PLAN** CONSTRUCTION PLAN M1.1M2.0 TANK ELEVATIONS

M2.1 2" FUEL LINE SUPPORT DETAILS

M3.0 SCHEMATIC

#### V102 - FACILIITY BUILDING

DEMOLITION PLAN CONSTRUCTION PLAN M1.1 M2.0 TANK ELEVATIONS

2" FUEL LINE SUPPORT DETAILS M2.1

M3.0 SCHEMATIC

#### STRUCTURAL DRAWING LIST

STRUCTURAL PROJECT NOTES S2 TYP TANK SLAB, BOLLARD AND BASE PLATE DETAILS AND ISOMETRIC VIEW OF METAL STAND **CONNECTION #1 DETAILS CONNECTION #2 DETAILS** TANK #1 - PLAN VIEW OF TANK ON SLAB TANK #1 - PLAN VIEW OF TANK ON SLAB TANK #2 - PLAN VIEW OF TANK ON LOW METAL STAND TANK #2 - ELEVATIONS OF LOW METAL STAND TANK #2 - ELEVATIONS OF LOW METAL STAND TANK #3 - PLAN VIEW OF TANK ON HIGH METAL STAND TANK #3 - ELEVATIONS OF HIGH METAL STAND S11 TANK #3 - ELEVATIONS OF HIGH METAL STAND S12 TANK #4 - PLAN VIEW OF TANK ON LOW DOUBLE METAL STAND TANK #4 - ELEVATIONS OF LOW DOUBLE METAL STAND S14 TANK #4 - ELEVATIONS OF LOW DOUBLE METAL STAND S15 TANK #5 - PLAN VIEW OF TANK ON HIGH DOUBLE METAL STAND S16 S17 TANK #5 - ELEVATIONS OF HIGH DOUBLE METAL STAND TANK #5 - ELEVATIONS OF HIGH DOUBLE METAL STAND



RCMP "V" DIVISION OIL TANK REPLACEMENT - ARCTIC BAY

TITLE PAGE

PROJECT NUMBER: 16-028-14-30

ISSUED FOR TENDER 18 05 18 REVISION

DATE (YY MM DD)

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REV.# REVISION

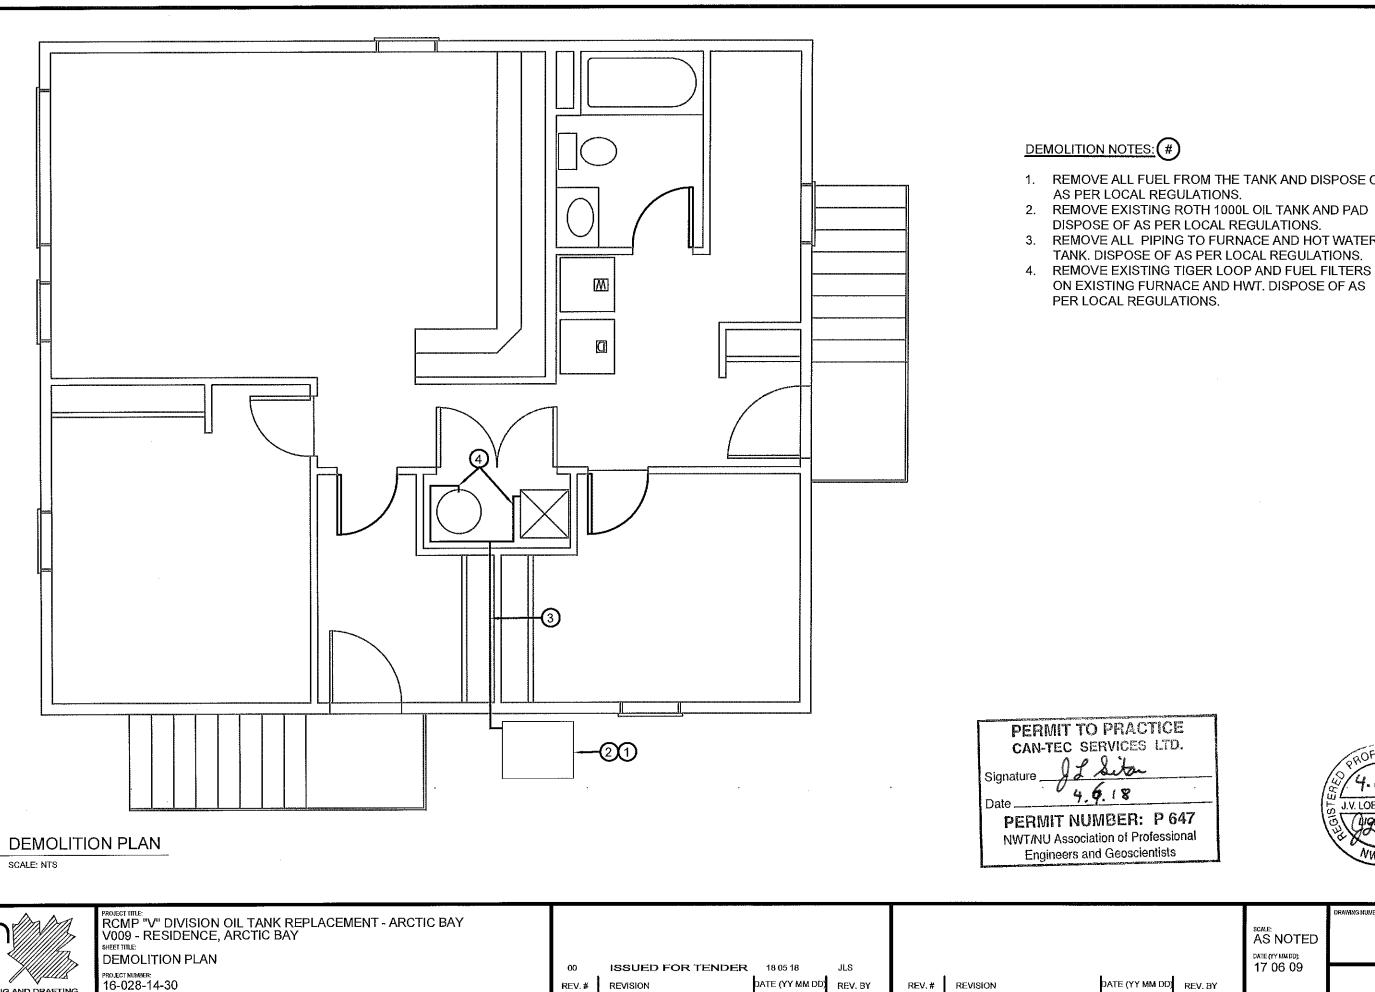
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AS NOTED DATE (YY MM DD): 17 06 09

M0.0

REVISION NUMBER

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- 1. REMOVE ALL FUEL FROM THE TANK AND DISPOSE OF
- 2. REMOVE EXISTING ROTH 1000L OIL TANK AND PAD DISPOSE OF AS PER LOCAL REGULATIONS.
- REMOVE ALL PIPING TO FURNACE AND HOT WATER TANK. DISPOSE OF AS PER LOCAL REGULATIONS.
- ON EXISTING FURNACE AND HWT. DISPOSE OF AS





PROJECT NUMBER: 16-028-14**-**30

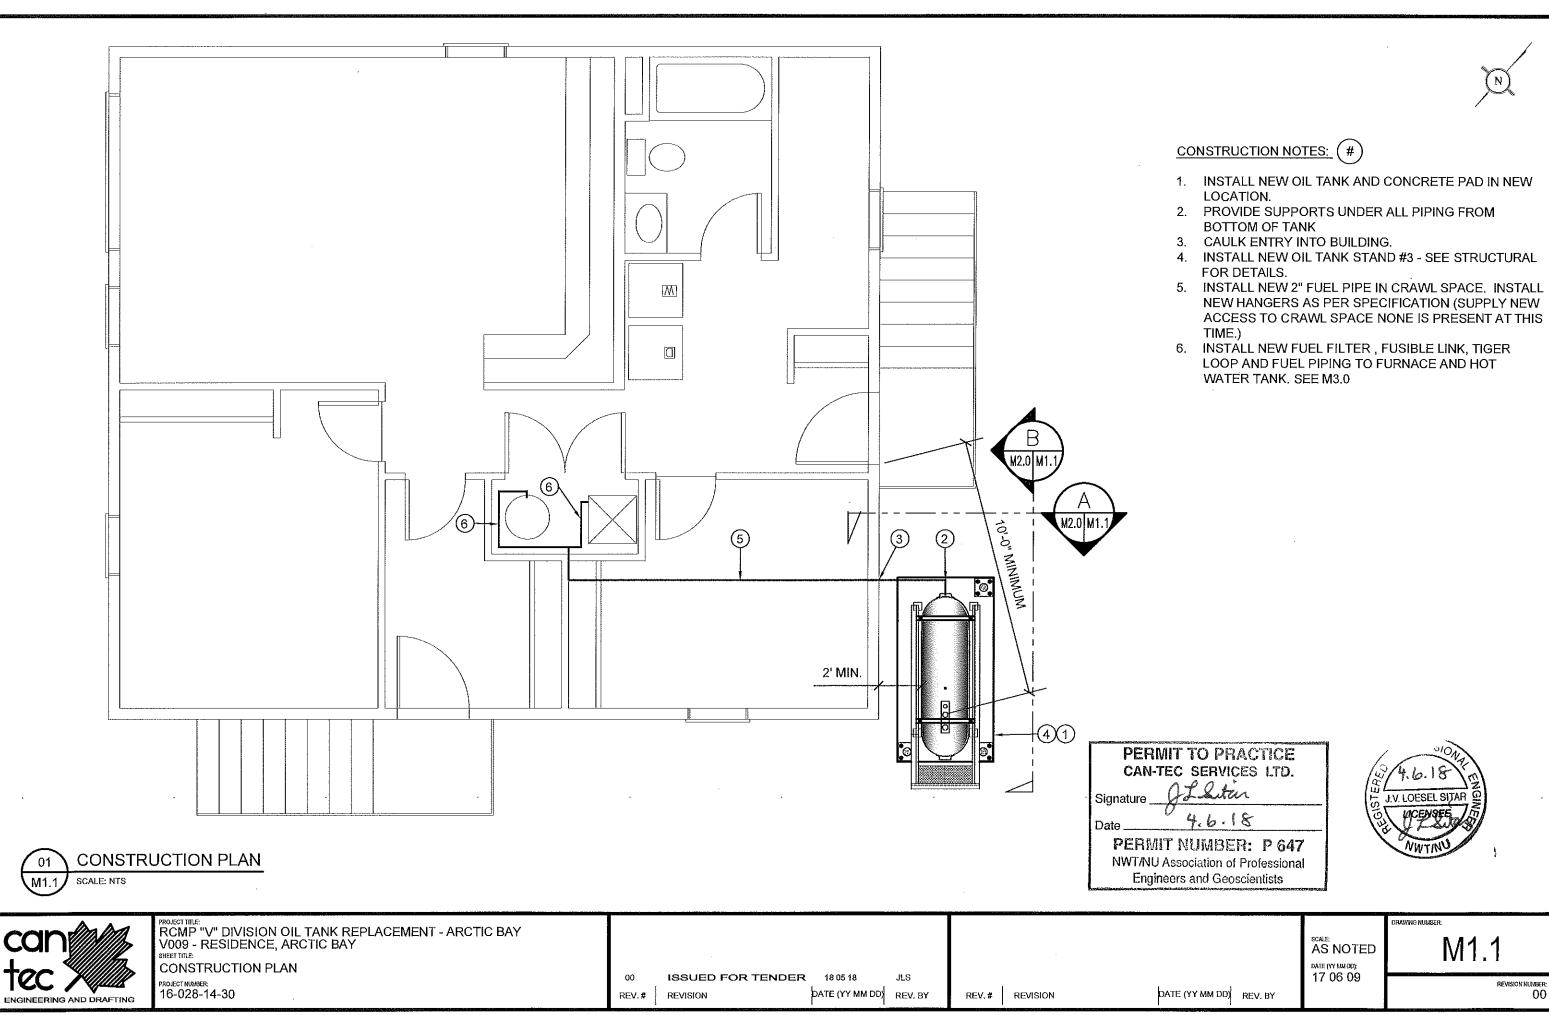
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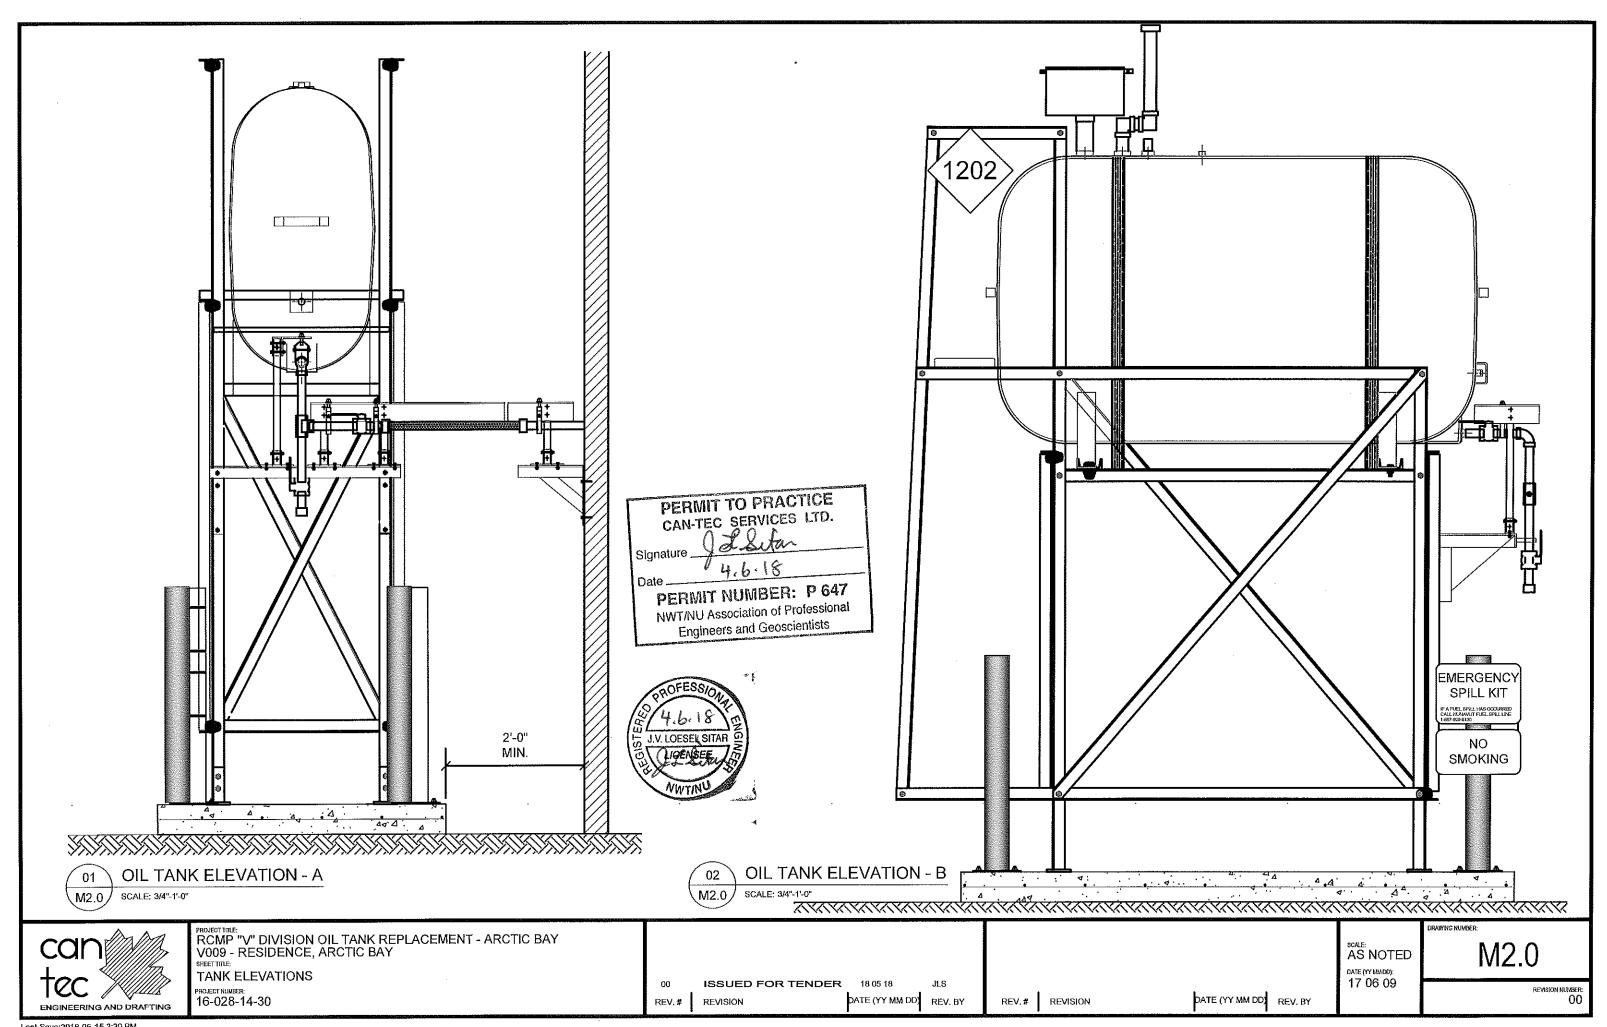
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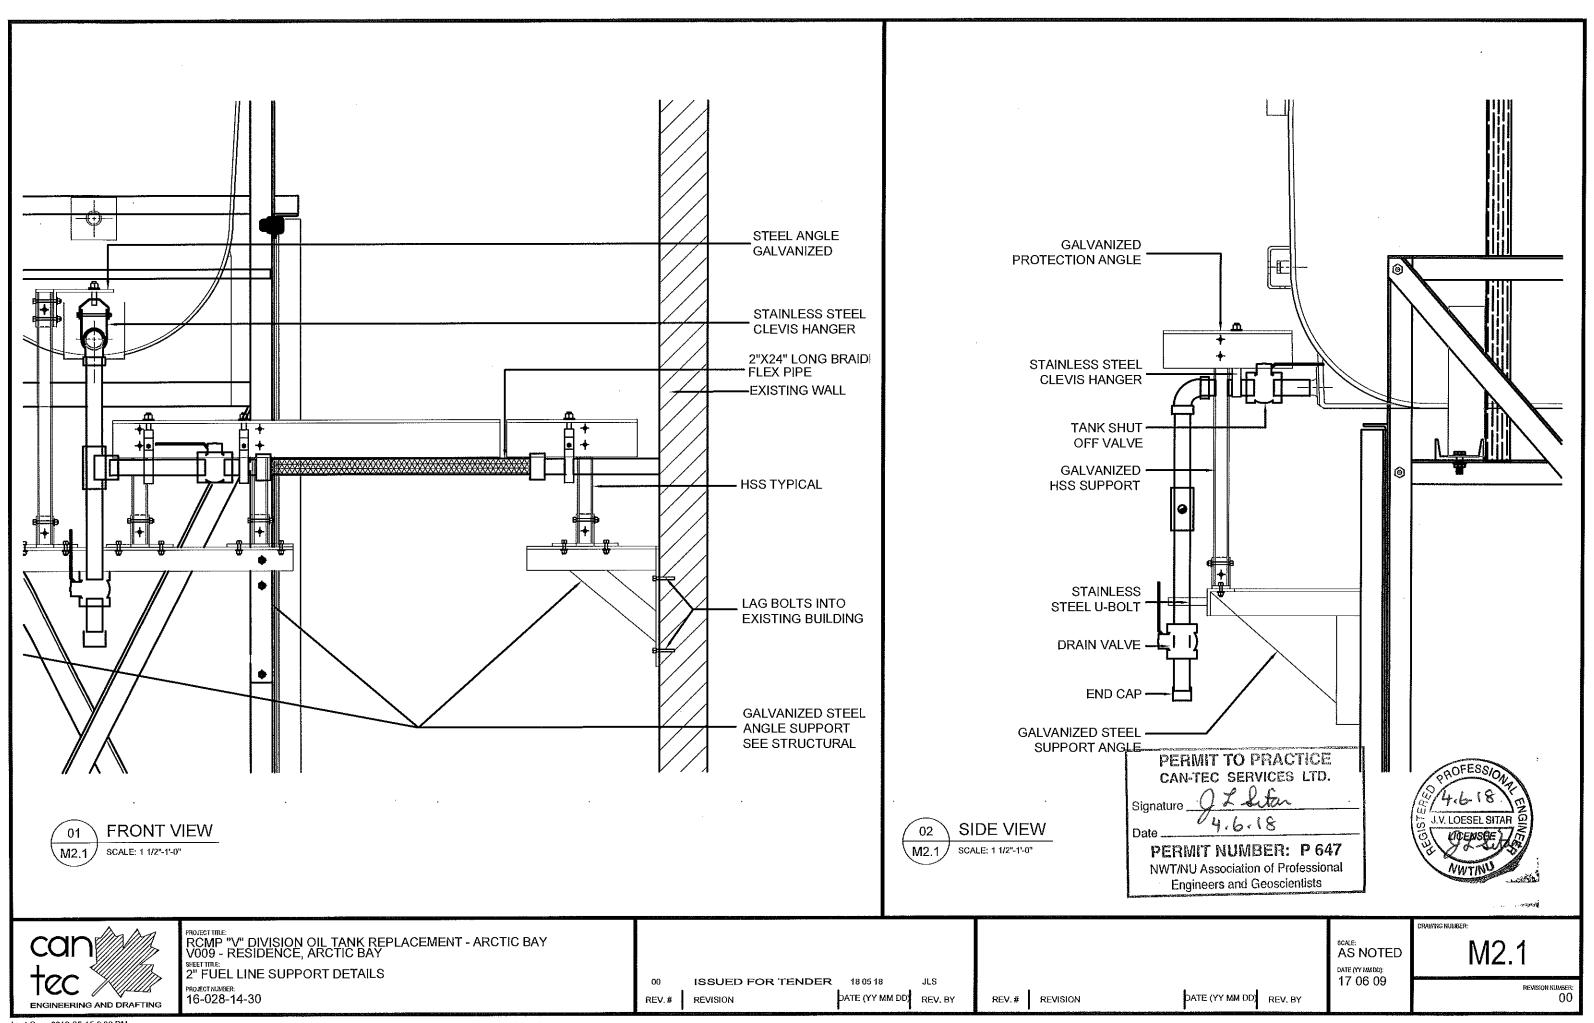
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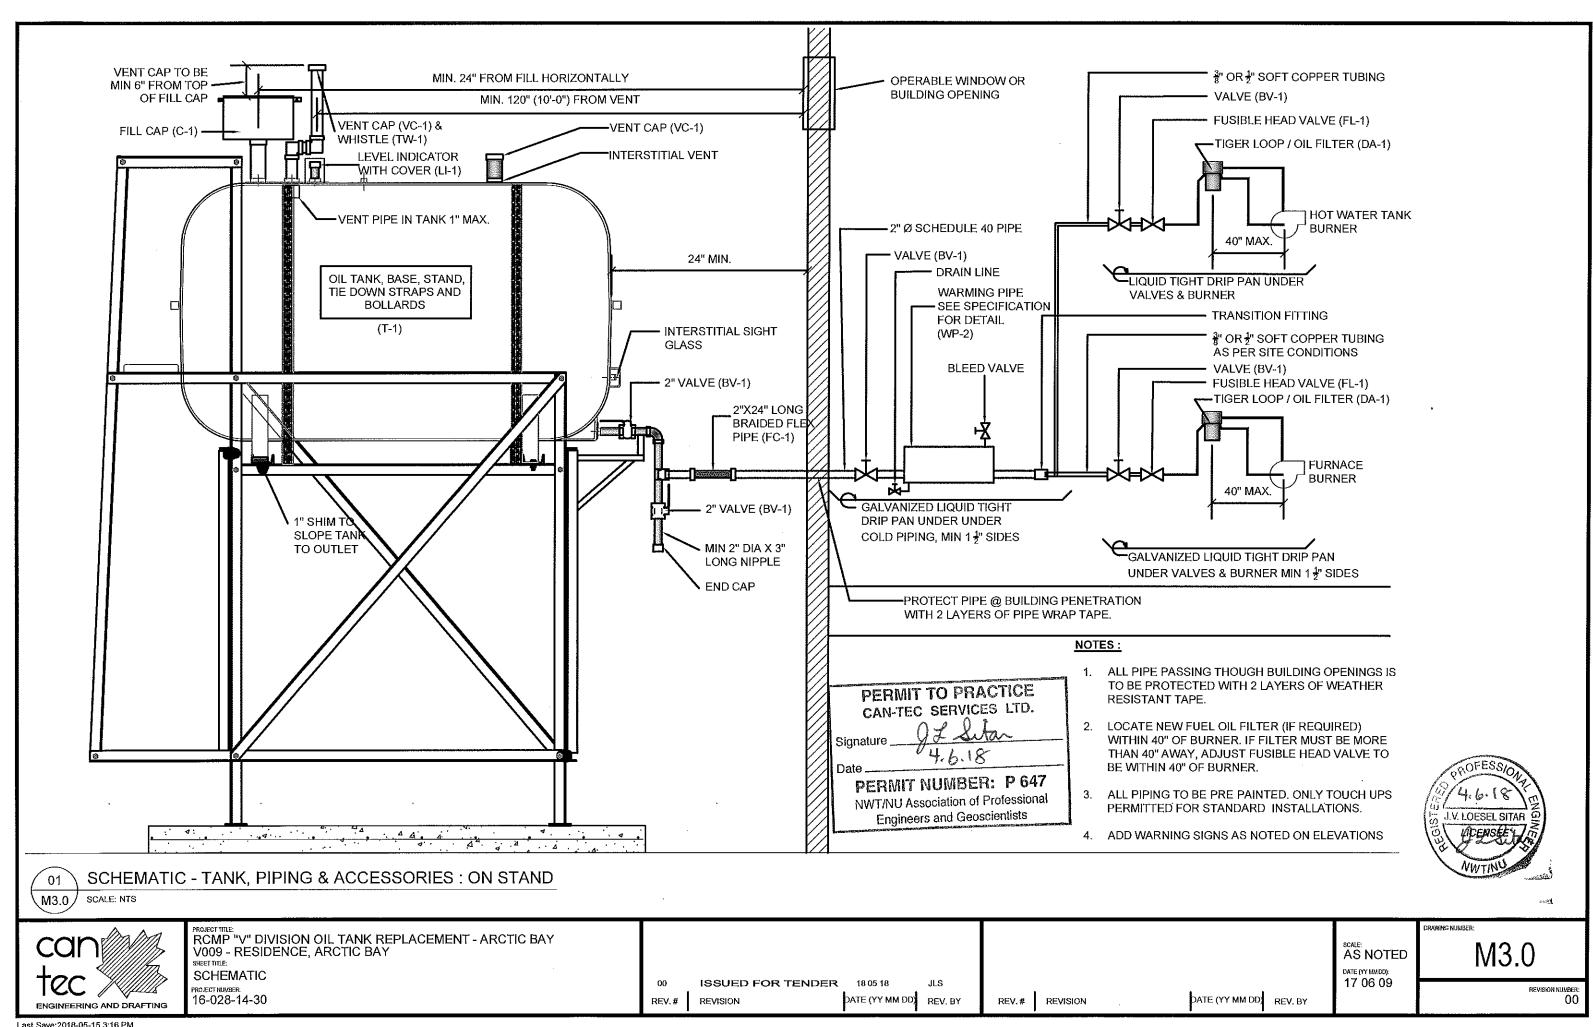
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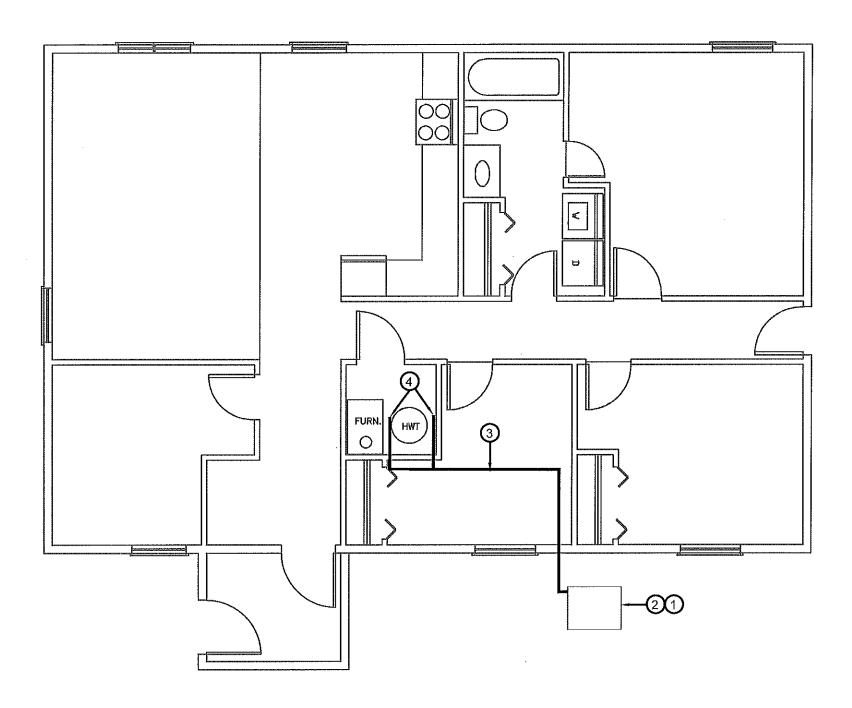


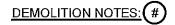


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- 1. REMOVE ALL FUEL FROM THE TANK AND DISPOSE OF AS PER LOCAL REGULATIONS.
- 2. REMOVE EXISTING ROTH 1000L OIL TANK AND PAD DISPOSE OF AS PER LOCAL REGULATIONS.
- 3. REMOVE ALL PIPING TO FURNACE AND HOT WATER TANK, DISPOSE AS PER REGULATIONS.
- 4. REMOVE EXISTING TIGER LOOP AND FUEL FILTERS ON EXISTING FURNACE AND HWT. DISPOSE AS PER REGULATIONS.

PERMIT TO PRACTICE CAN-TEC SERVICES LTD.

Date.

PERMIT NUMBER: P 647 NWT/NU Association of Professional

4.6.18

Engineers and Geoscientists

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ENGINEERING AND DRAFTING

M1.0 SCALE: NTS

RCMP "V" DIVISION OIL TANK REPLACEMENT - ARCTIC BAY V100 - RESIDENCE, ARCTIC BAY NU

DEMOLITION PLAN

PROJECT NUMBER: 16-028-14-30

**DEMOLITION PLAN** 

ISSUED FOR TENDER 18 05 18 REVISION

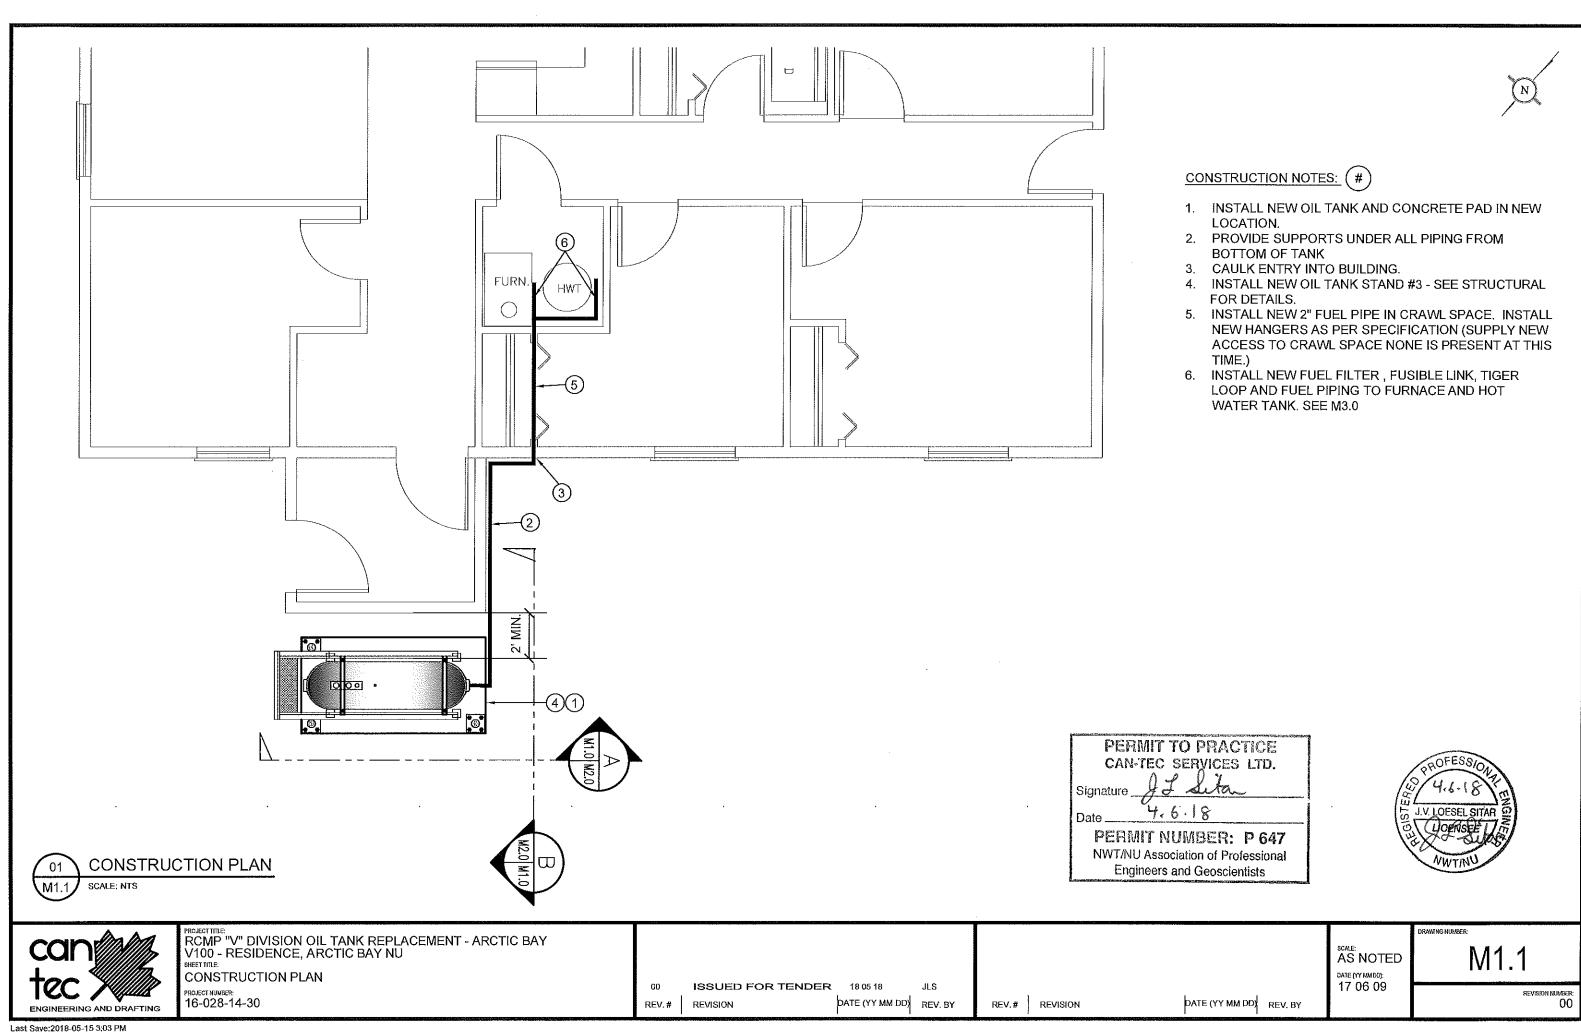
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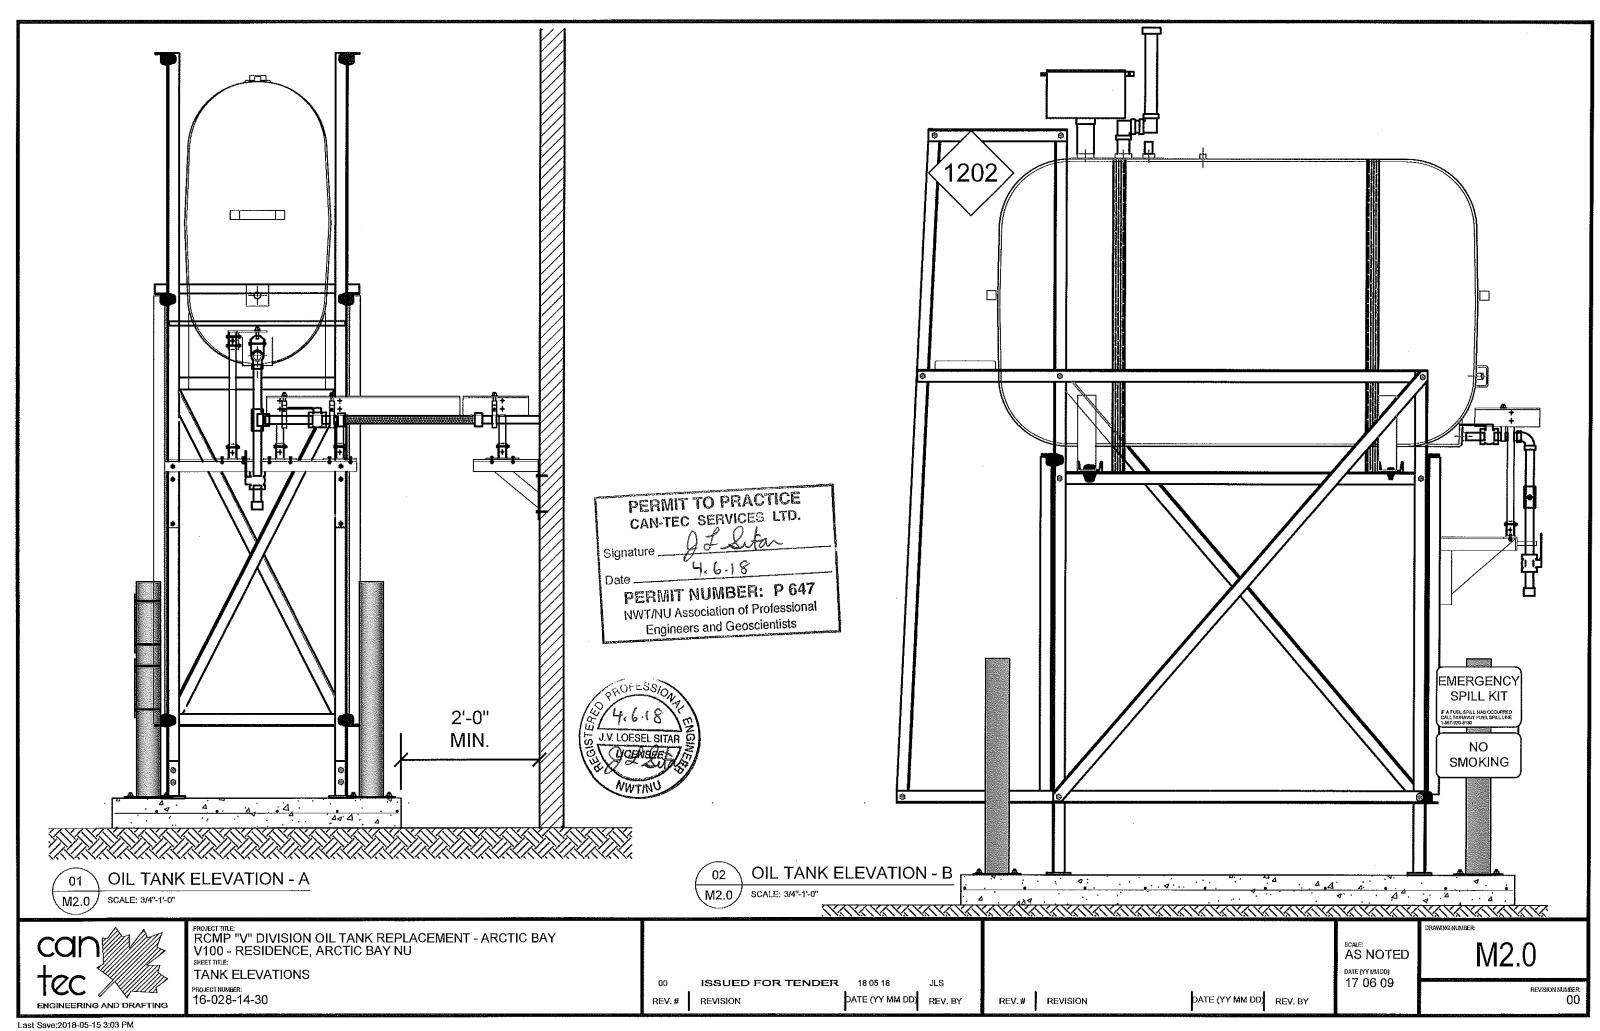
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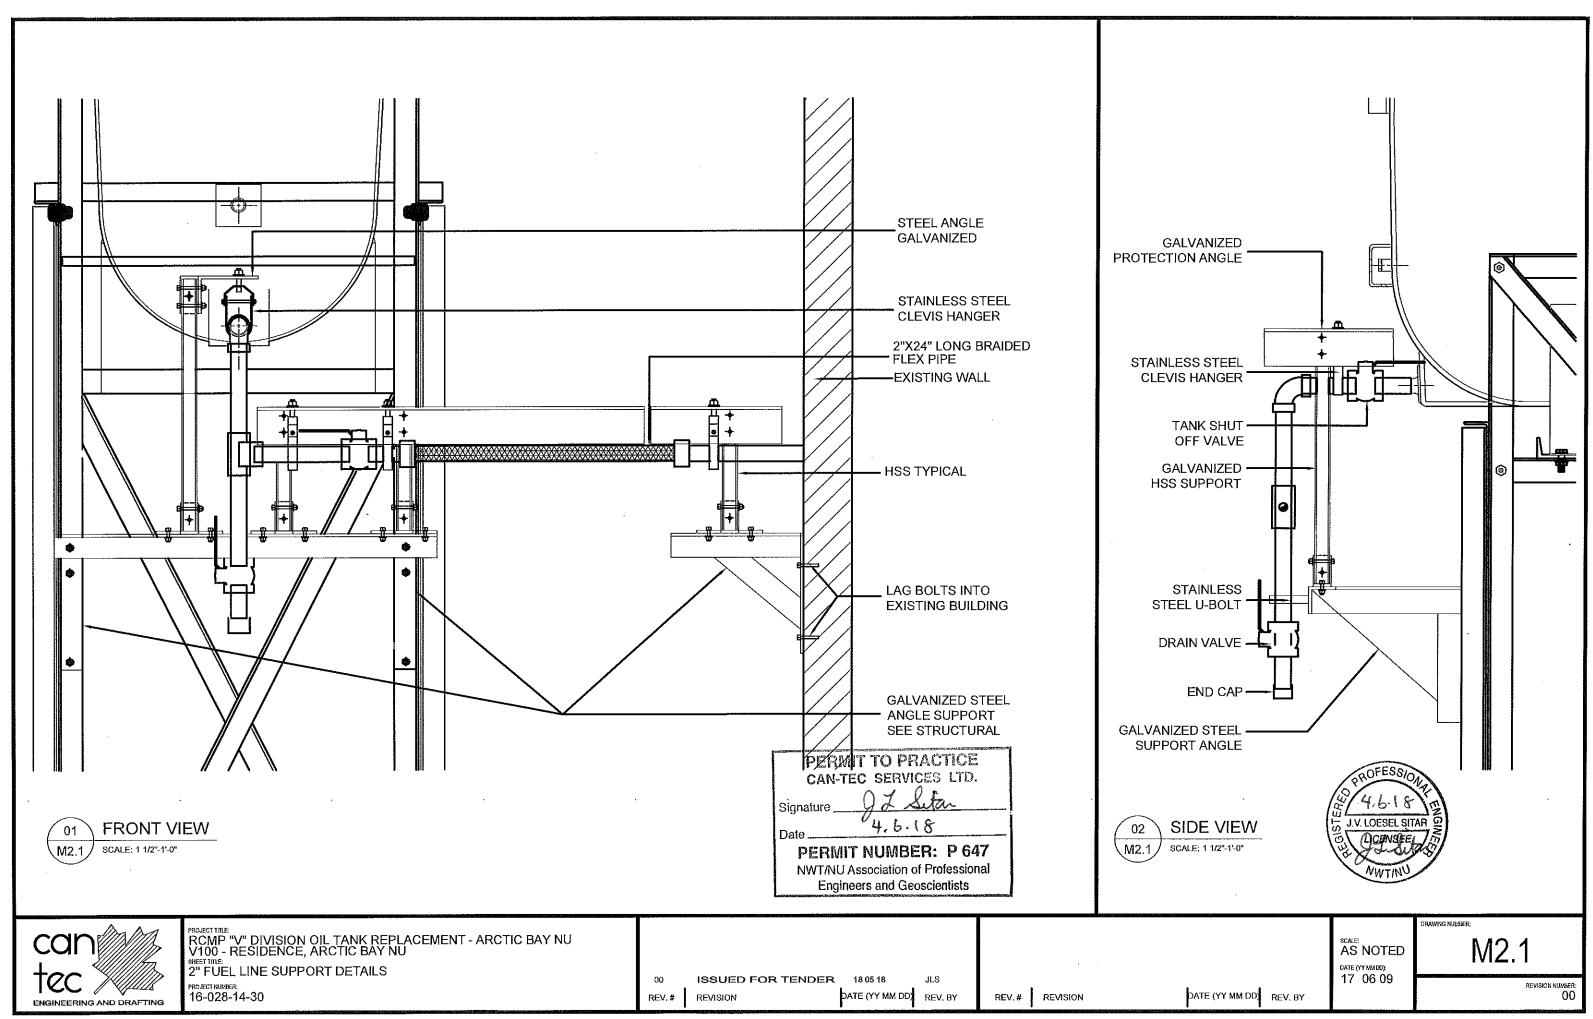
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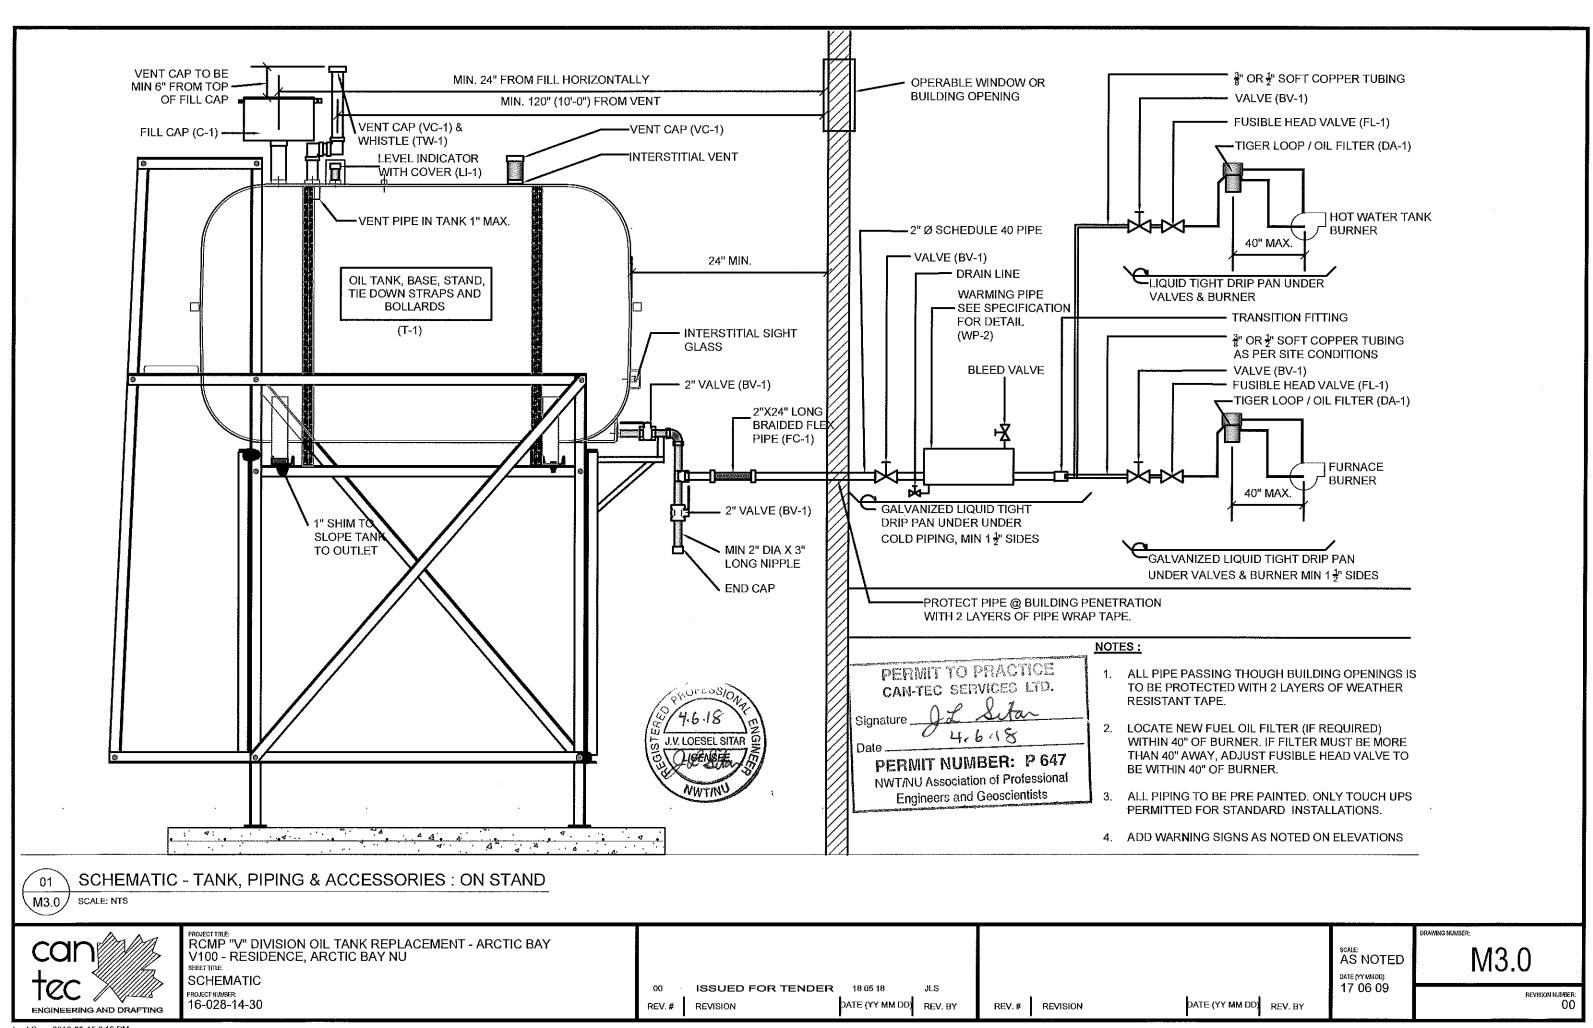
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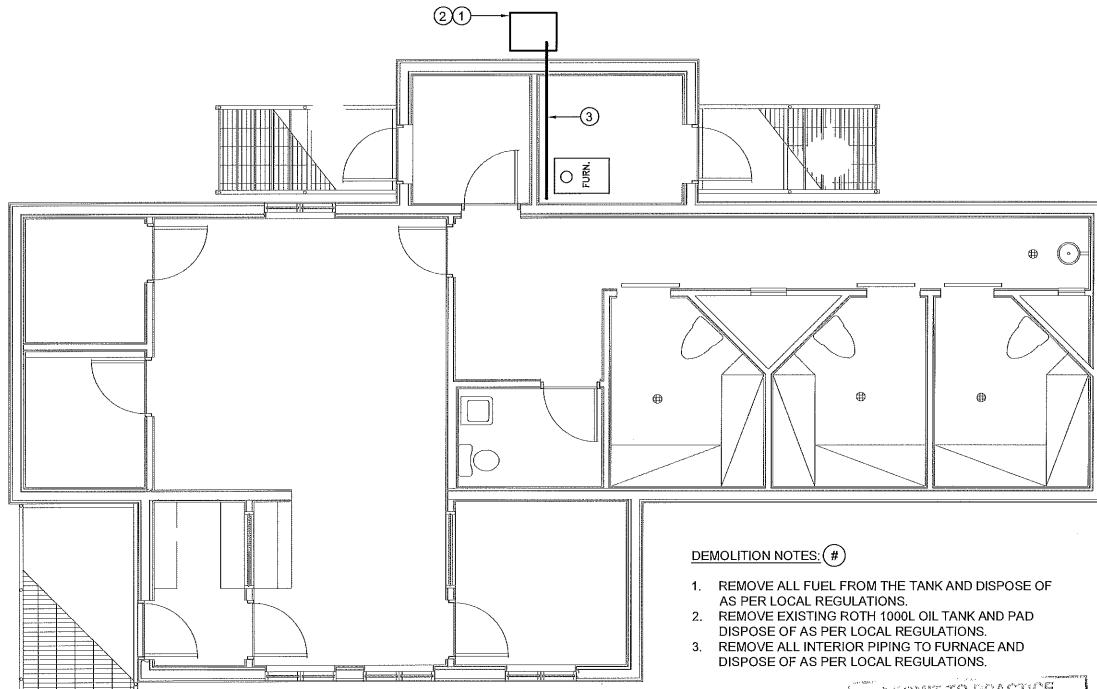




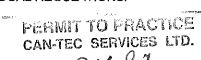


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Signature \_\_\_\_\_ J

Date 4.6.18

PERMIT NUMBER: P 647
NWT/NU Association of Professional
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PROJECT TITLE:
RCMP "V" DIVISION OIL TANK REPLACEMENT - ARCTIC BAY
V102 - FACILITY BUILDING, ARCTIC BAY NU

DEMOLITION PLAN

PROJECT NUMBER: 16-028-14-30 
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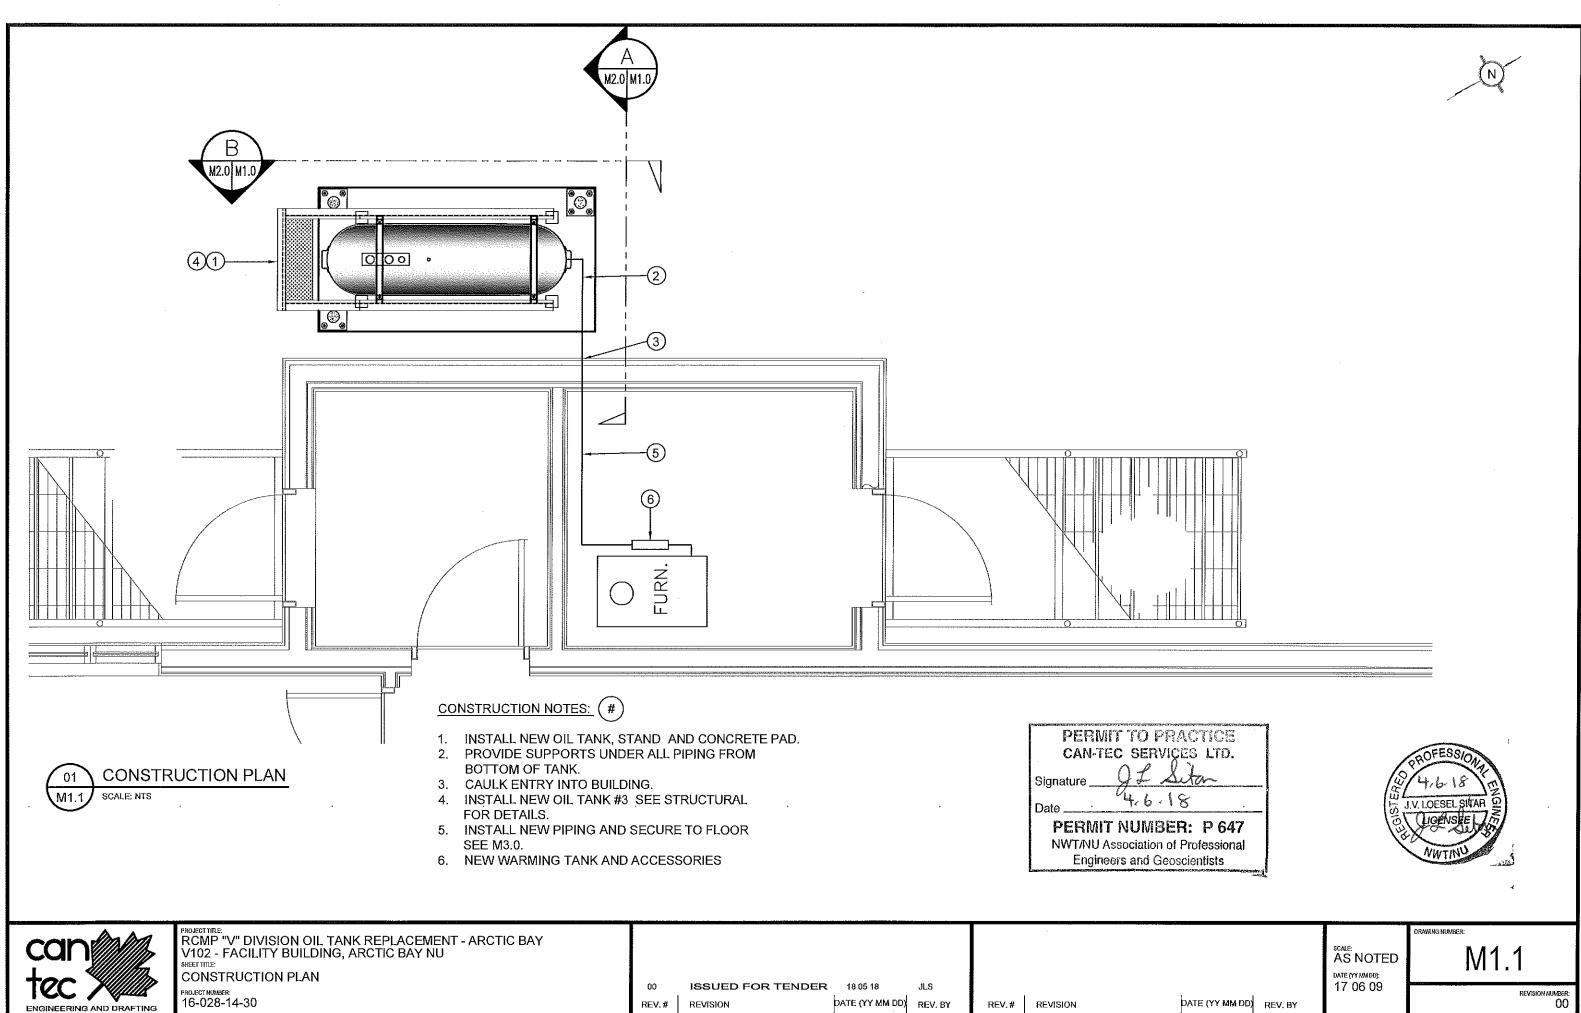
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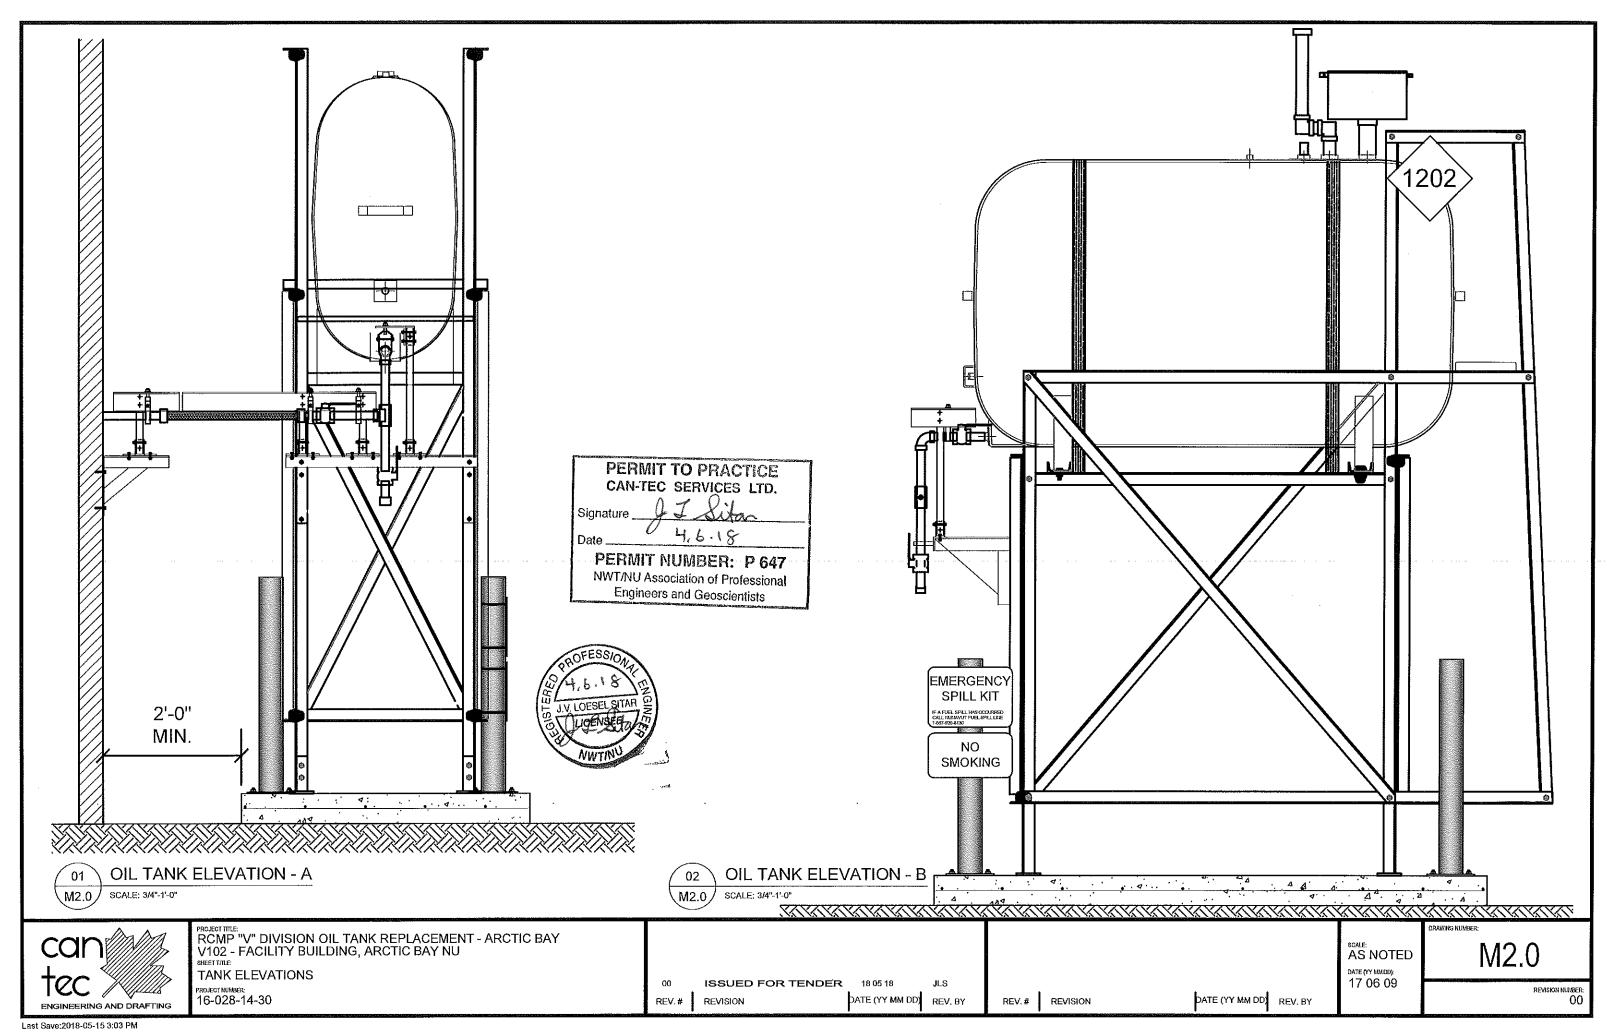
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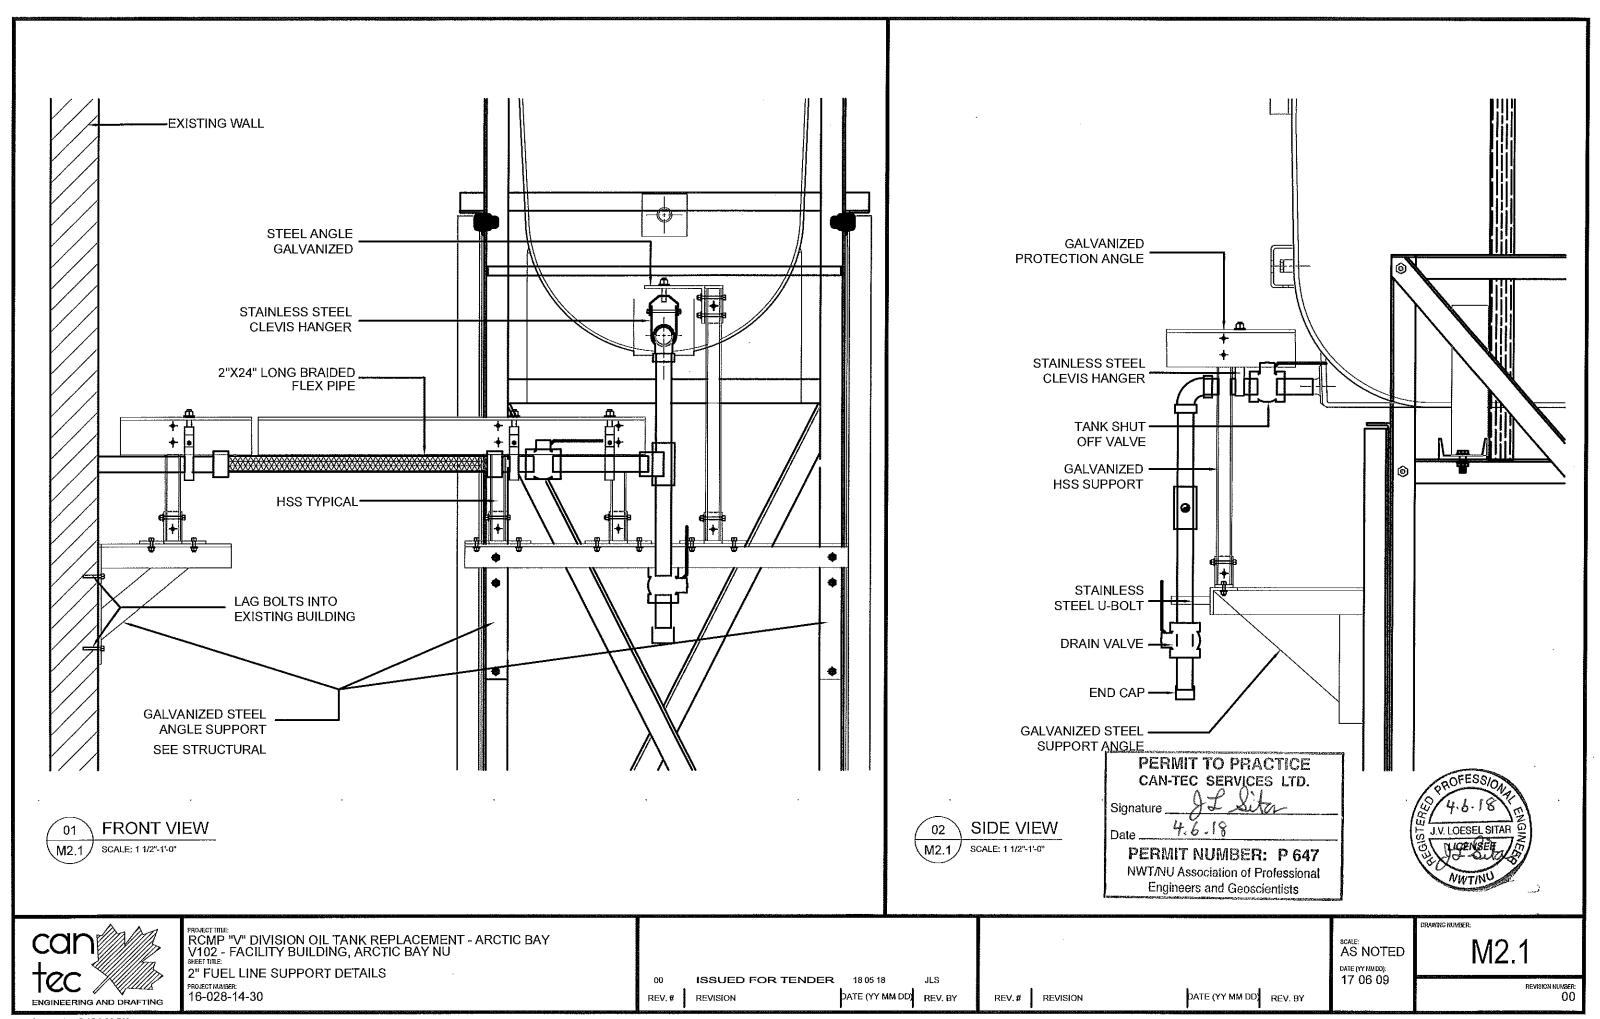
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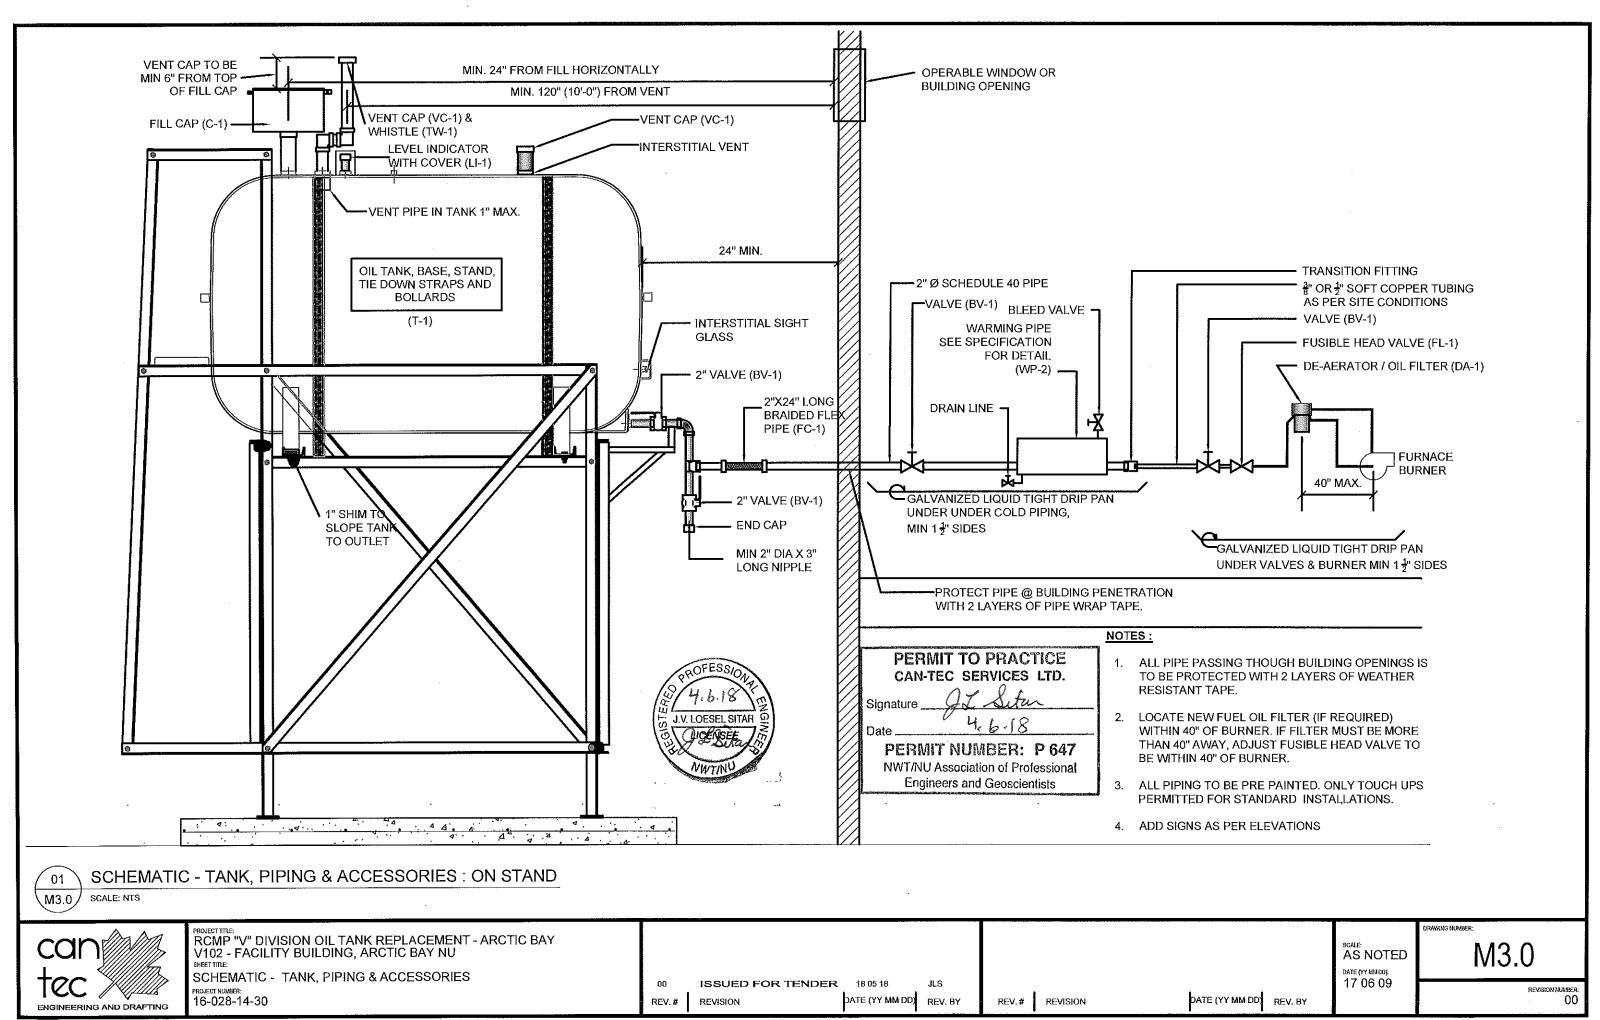


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# FUEL TANK REPAIR AND REPLACEMENT PROJECT HALL BEACH, NUNAVUT

# **DRAWING LIST:**

## V054 - GARAGE

M1.0 SITE PLAN AND CONSTRUCTION PLAN

M2.0 TANK ELEVATIONS

M2.1 2" FUEL LINE SUPPORT DETAILS

#### V053 - RESIDENCE

M1.0 SITE PLAN AND CONSTRUCTION PLAN

**DETAILS** M1.1

#### V055 - RESIDENCE

M1.0 DEMOLITION AND CONSTRUCTION PLAN

M2.0 **TANK ELEVATIONS** 

M2.1 2" FUEL LINE SUPPORT DETAIL

M3.0 **SCHEMATIC** 

#### V058 - FACILITY BUILDING

CONSTRUCTION PLAN

TANK ELEVATIONS M2.0

2" FUEL LINE SUPPORT DETAIL M2.1

## STRUCTURAL DRAWING LIST

STRUCTURAL PROJECT NOTES TYP TANK SLAB, BOLLARD AND BASE PLATE DETAILS AND S2

ISOMETRIC VIEW OF METAL STAND

S3 **CONNECTION #1 DETAILS** S4 **CONNECTION #2 DETAILS** 

S5 TANK #1 - PLAN VIEW OF TANK ON SLAB

TANK #1 - PLAN VIEW OF TANK ON SLAB S6

TANK #2 - PLAN VIEW OF TANK ON LOW METAL STAND S7

TANK #2 - ELEVATIONS OF LOW METAL STAND S8

TANK #2 - ELEVATIONS OF LOW METAL STAND S9

TANK #3 - PLAN VIEW OF TANK ON HIGH METAL STAND S10

TANK #3 - ELEVATIONS OF HIGH METAL STAND **S11** 

TANK #3 - ELEVATIONS OF HIGH METAL STAND

TANK #4 - PLAN VIEW OF TANK ON LOW DOUBLE METAL STAND S13

TANK #4 - ELEVATIONS OF LOW DOUBLE METAL STAND S14

TANK #4 - ELEVATIONS OF LOW DOUBLE METAL STAND S15

TANK #5 - PLAN VIEW OF TANK ON HIGH DOUBLE METAL STAND TANK #5 - ELEVATIONS OF HIGH DOUBLE METAL STAND S17

TANK #5 - ELEVATIONS OF HIGH DOUBLE METAL STAND



RCMP "V" DIVISION OIL TANK REPLACEMENT - HALL BEACH

SHEET TITLE: TITLE PAGE

PROJECT NUMBER: 16-028-14-30 ISSUED FOR TENDER 18 05 18

REVISION

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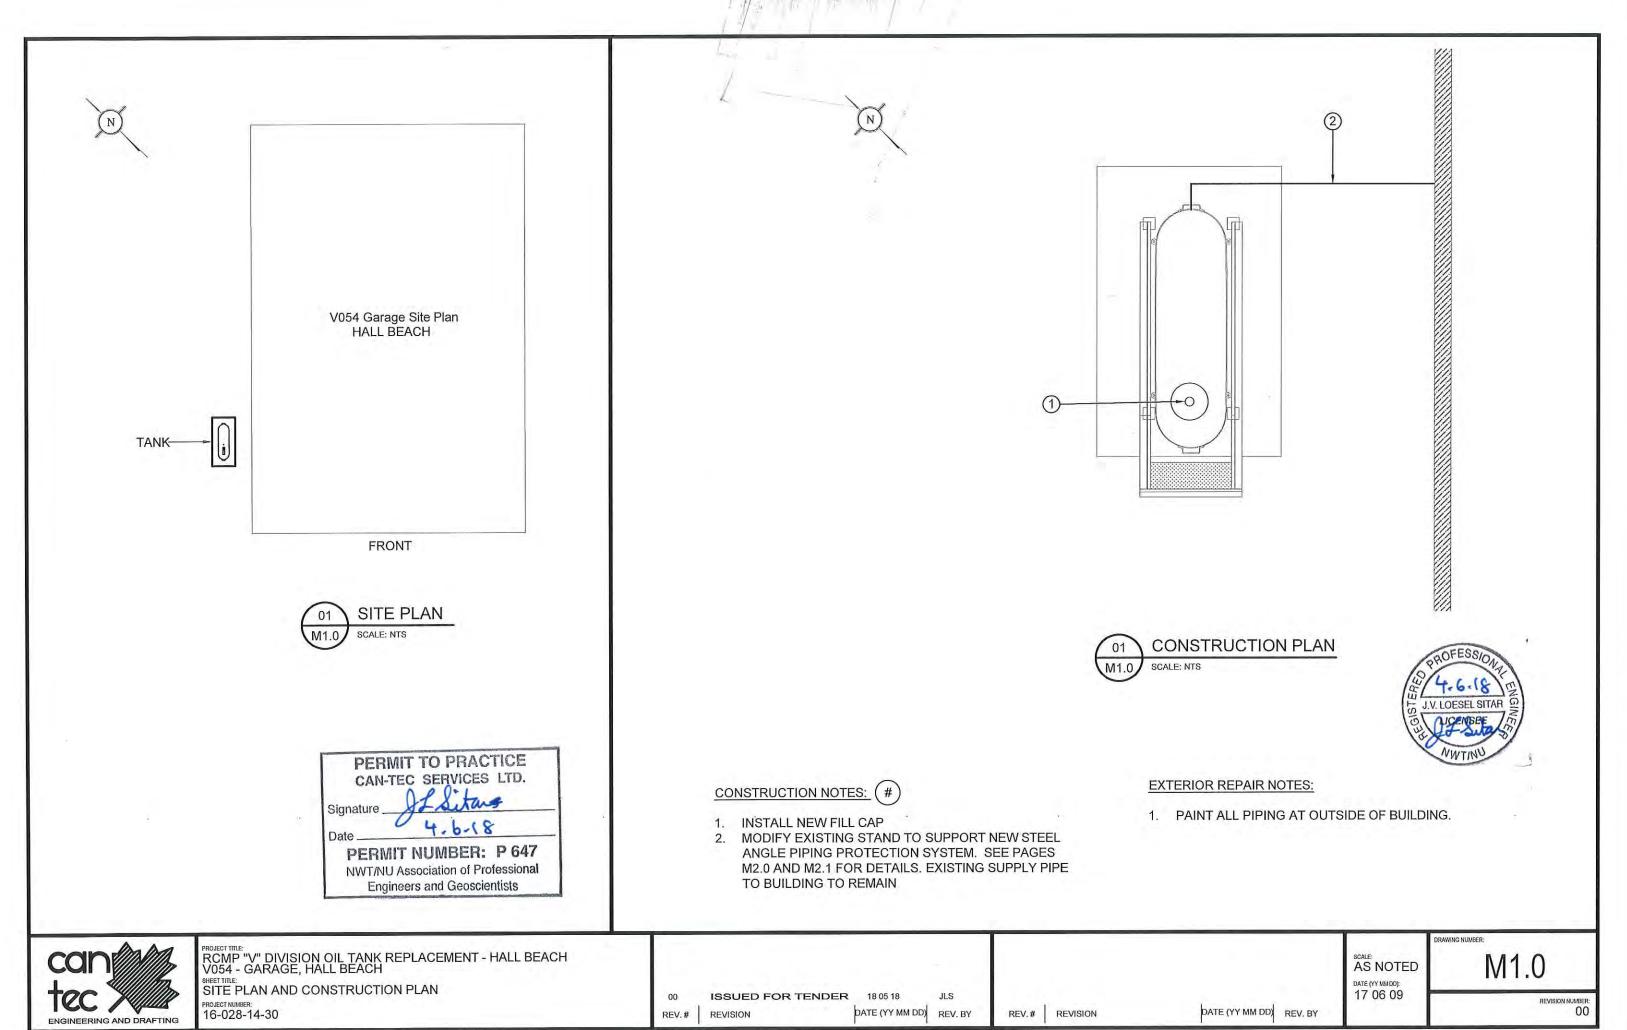
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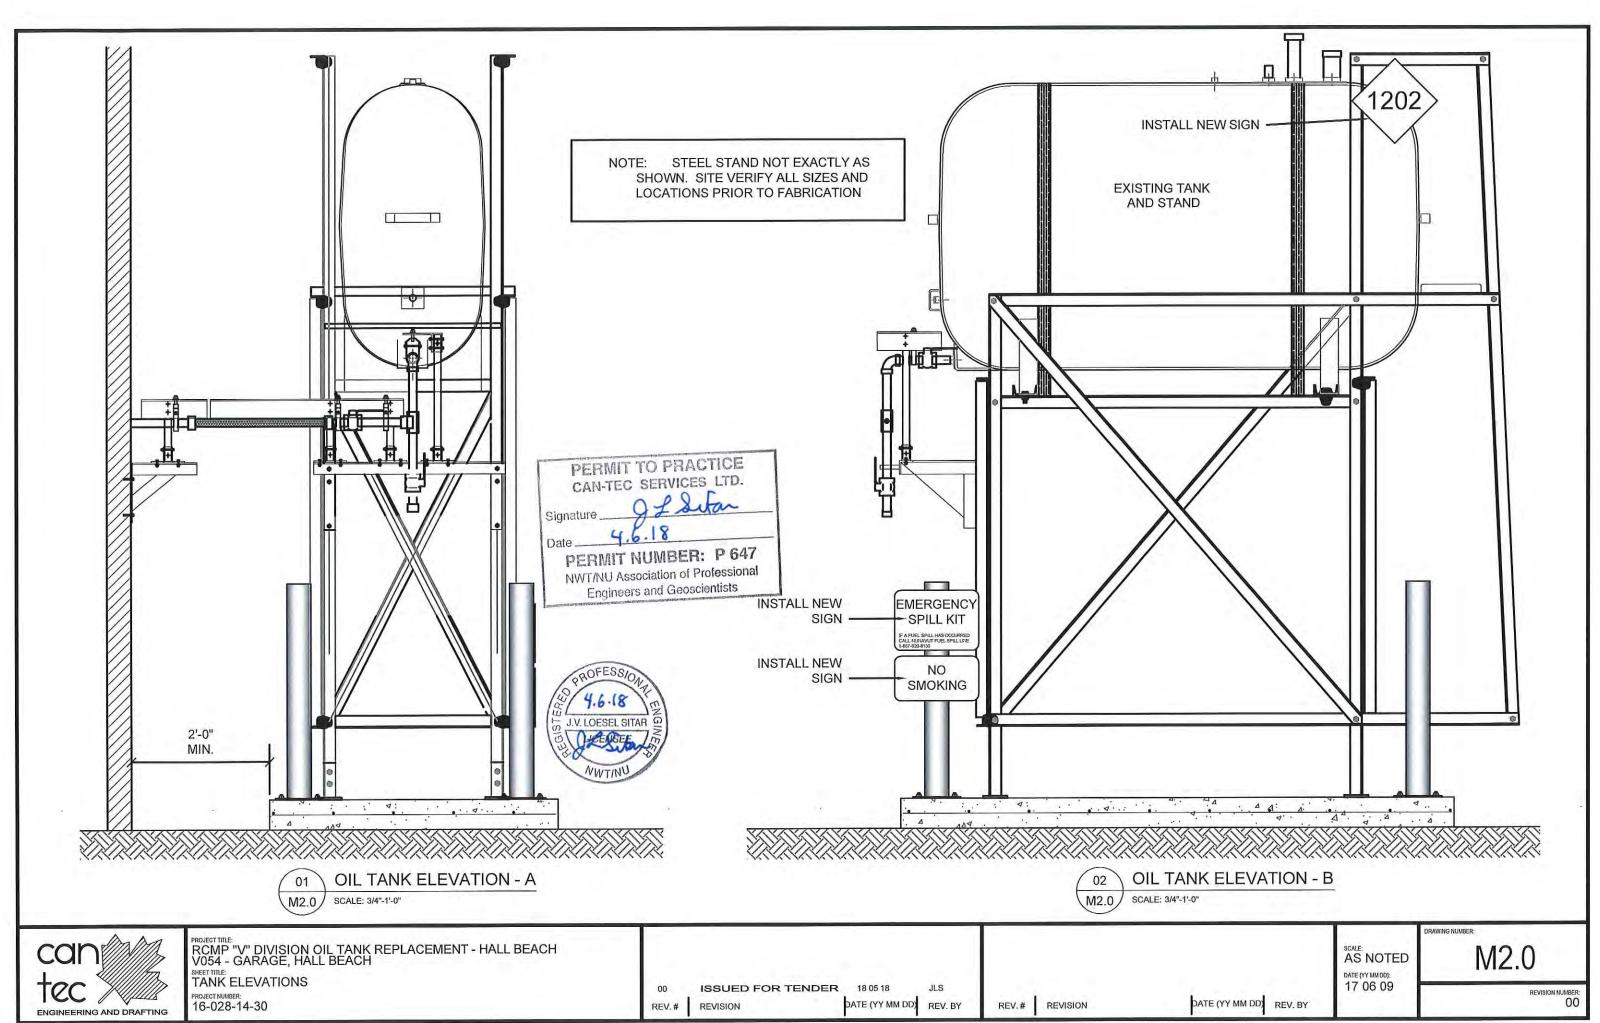
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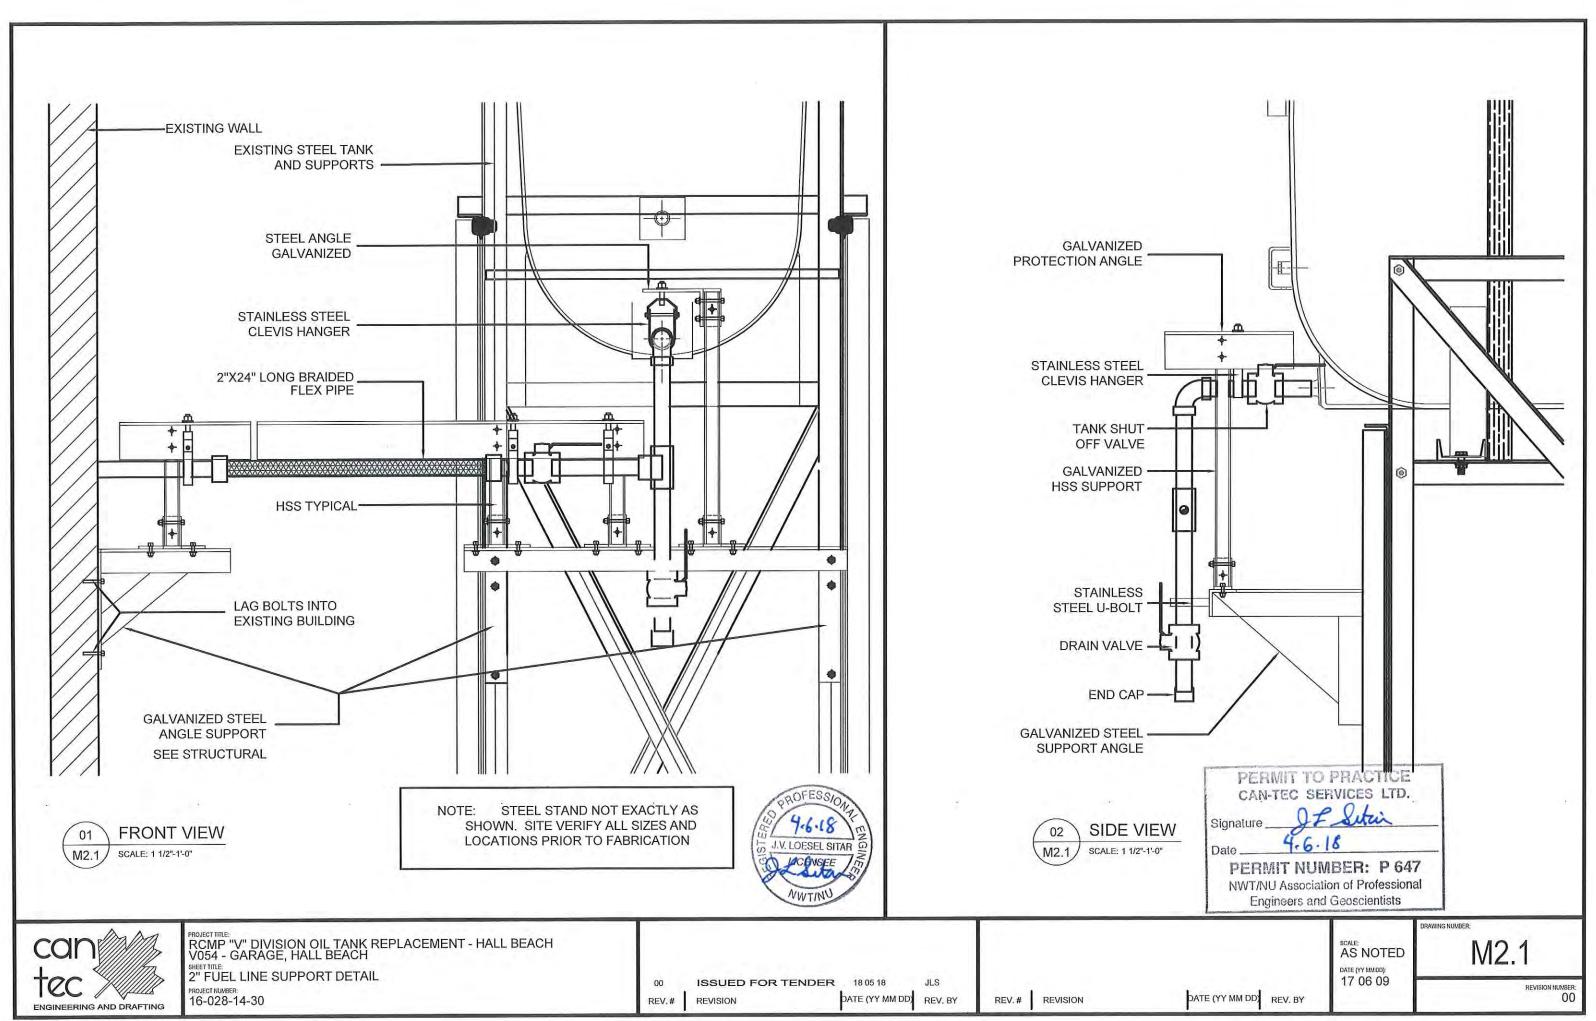
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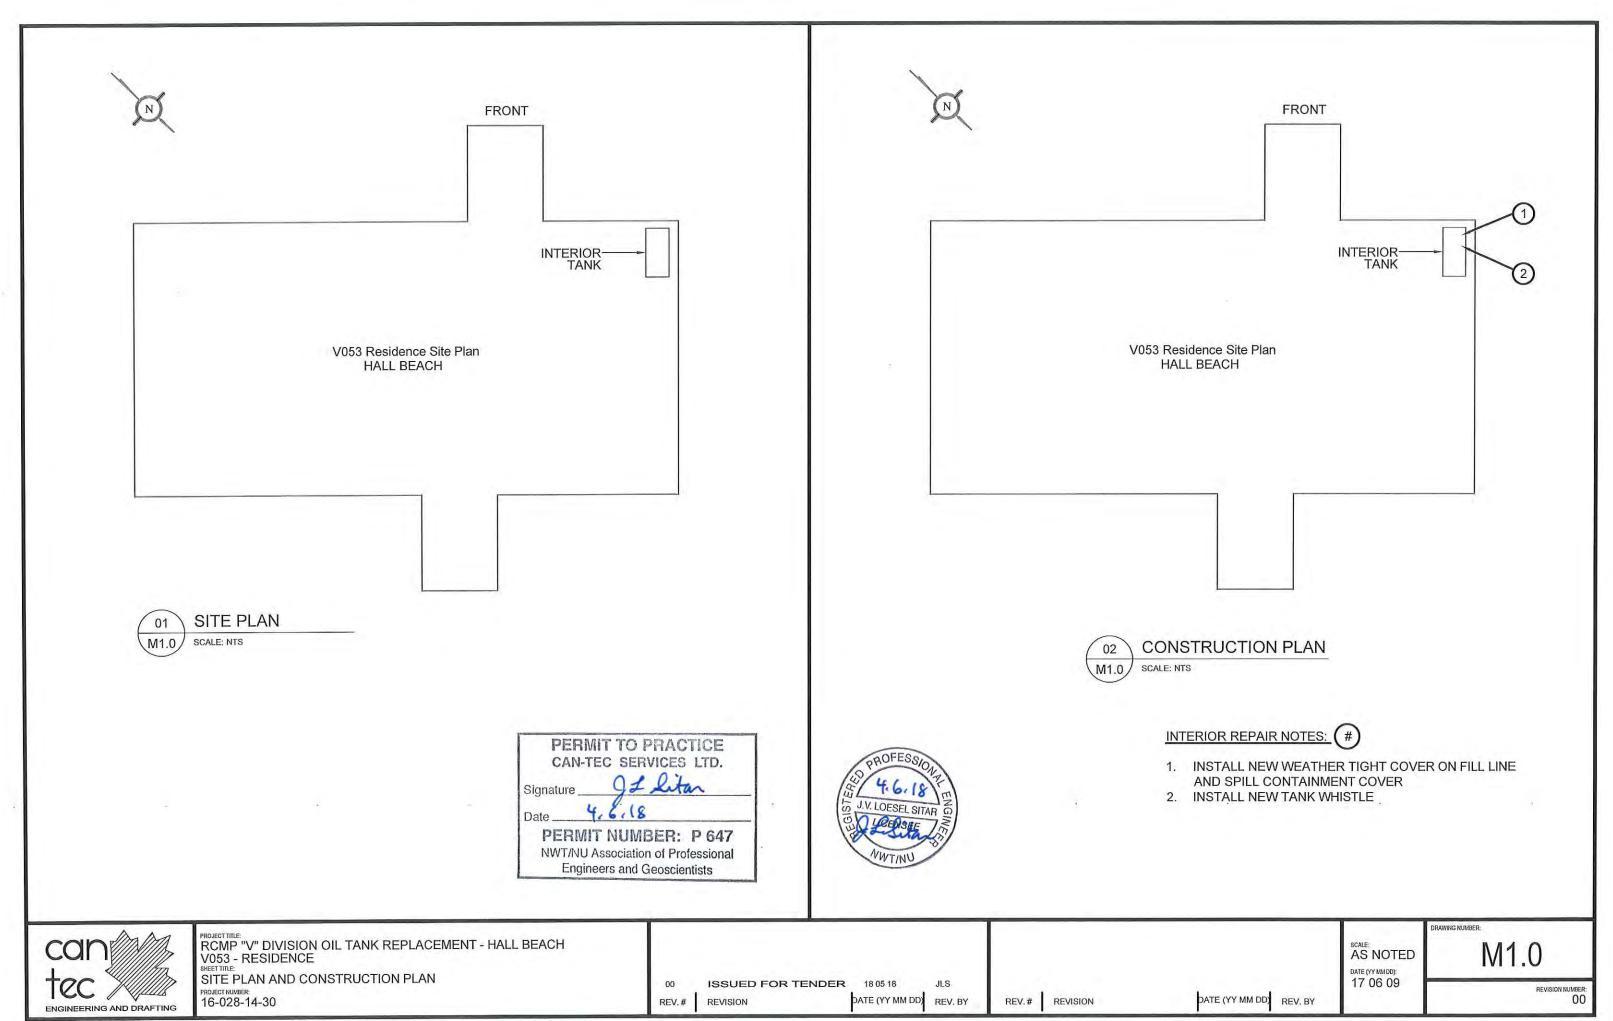
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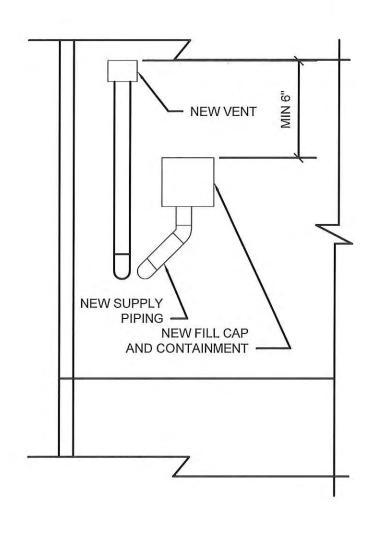


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INSTALL NEW VENT WHISTLE ON VENT LINE

REMOVE EXISTING FILL AND INSTALL NEW FILL LINE





**EXTERIOR ELEVATION** SCALE: NTS

INTERIOR TANK ELEVATION-

SCALE: NTS

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**EXTERIOR ELEVATION** SCALE: NTS





PROJECT TITLE:
RCMP "V" DIVISION OIL TANK REPLACEMENT - HALL BEACH

SHEET TITLE: V053 - RESIDENCE DETAILS

PROJECT NUMBER: 16-028-14-30

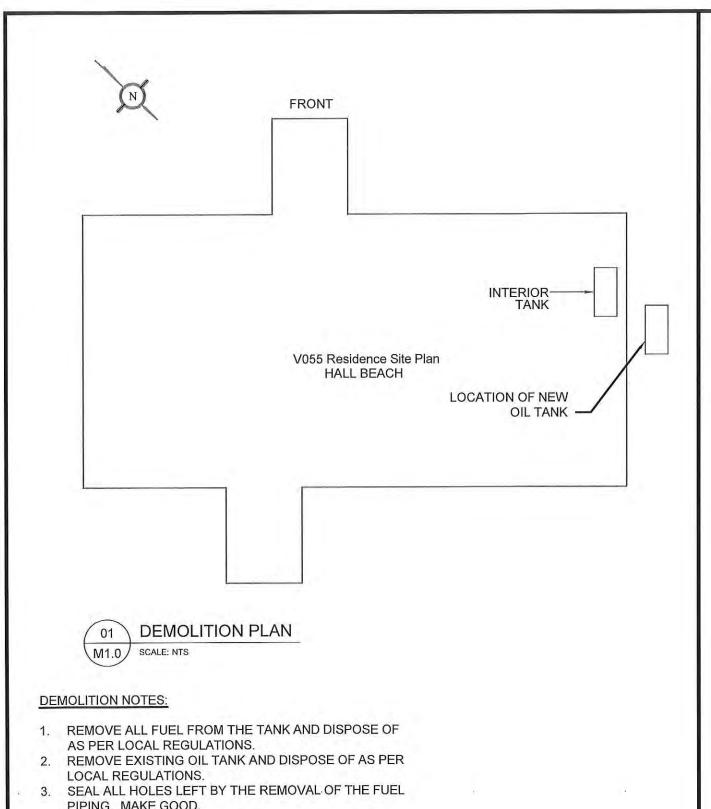
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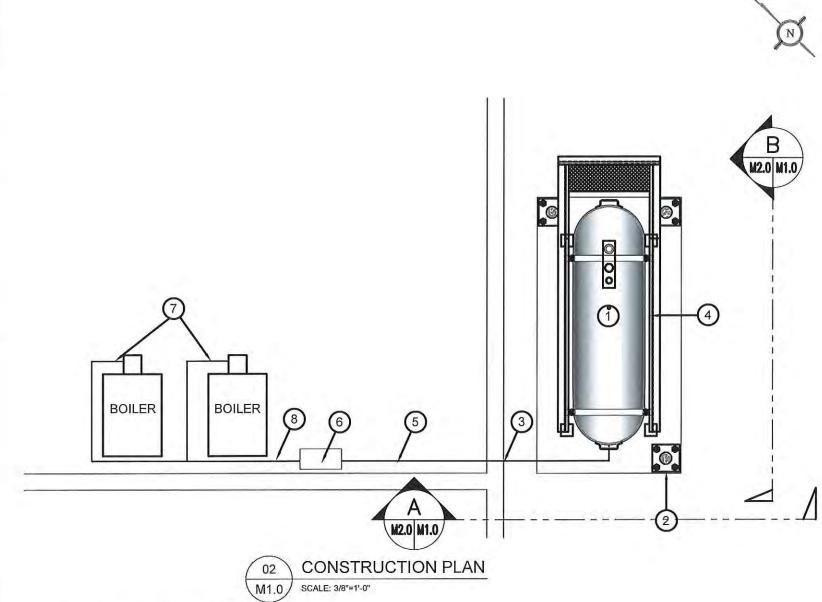
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AS NOTED DATE (YY MMDD): 17 06 09 DATE (YY MM DD) REV. BY

M1.1



PIPING. MAKE GOOD.



# CONSTRUCTION NOTES: (#)

- 1. INSTALL NEW OIL TANK AND CONCRETE PAD. SEE SHEET M2.0.
- INSTALL NEW BOLLARDS SEE SHEET M2.0.
- CAULK ENTRY INTO BUILDING.
- INSTALL NEW OIL TANK STAND #2 SEE STRUCTURAL FOR DETAILS.
- INSTALL NEW 2"Ø PIPING
- 6. NEW WARMING PIPE (WP-2)
- 7. NEW ACCESSORIES FOR BOILER SEE SHEET M3.0 FOR **DETAILS**
- 8. NEW 1"Ø PIPE

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PROJECT TITLE: RCMP "V" DIVISION OIL TANK REPLACEMENT - HALL BEACH V055 - RESIDENCE

SHEET TITLE:
DEMOLITION AND CONSTRUCTION PLAN

PROJECT NUMBER: 16-028-14-30

ISSUED FOR TENDER 18 05 18

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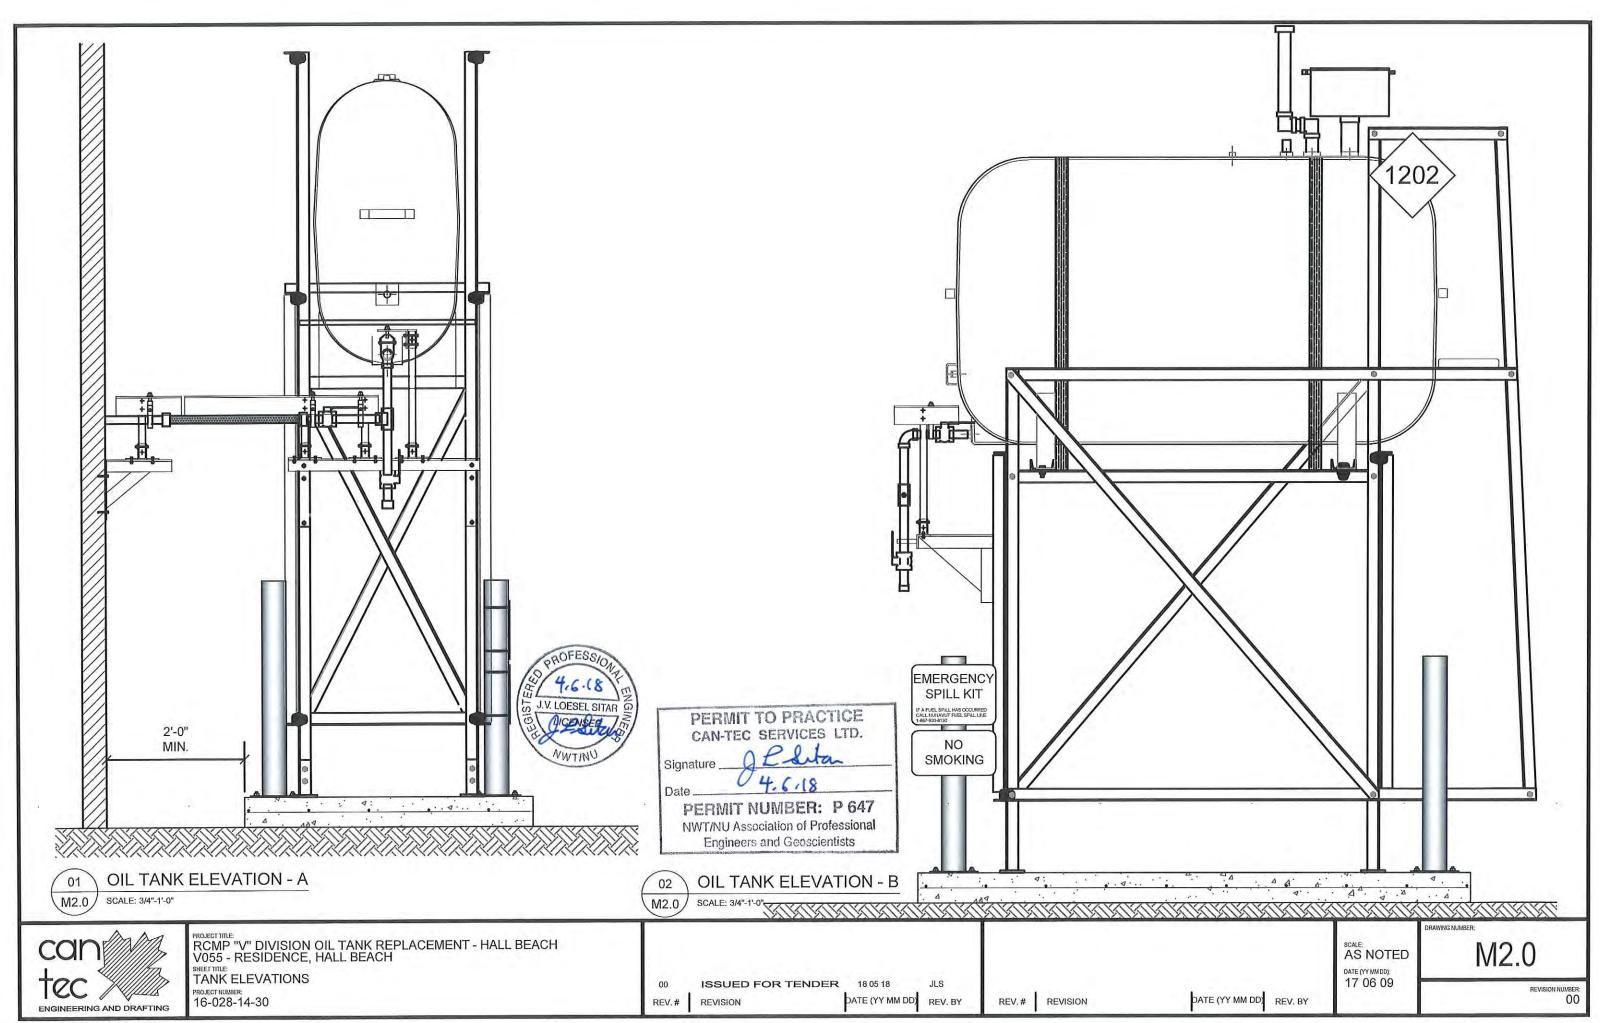
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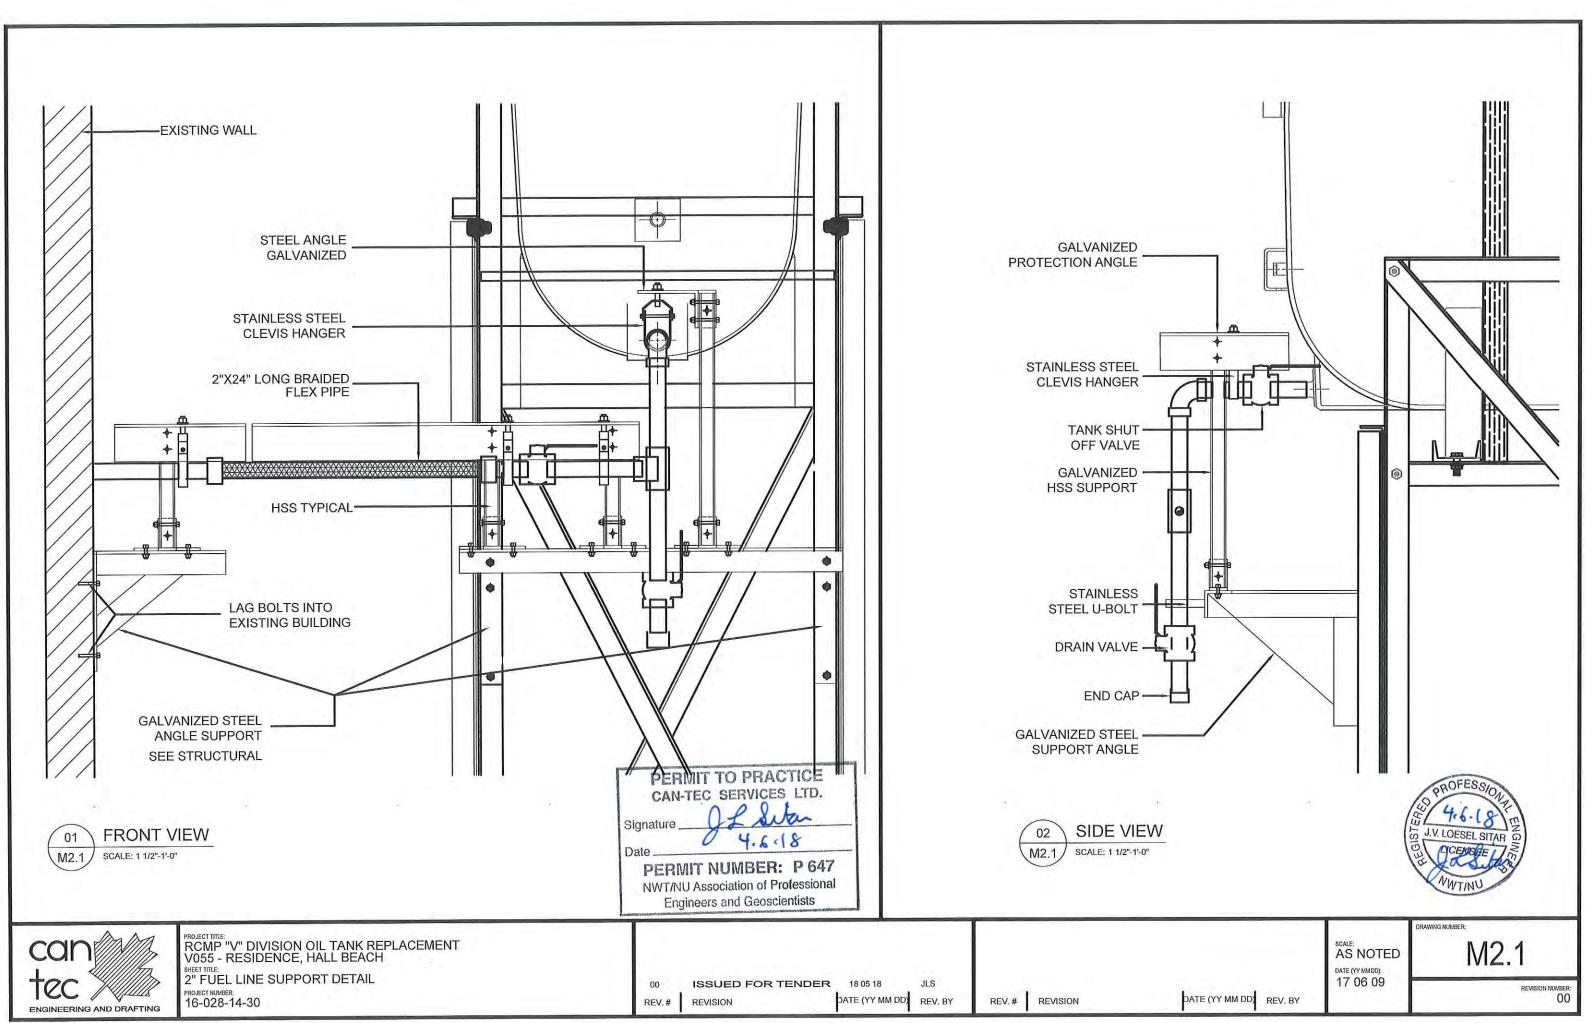
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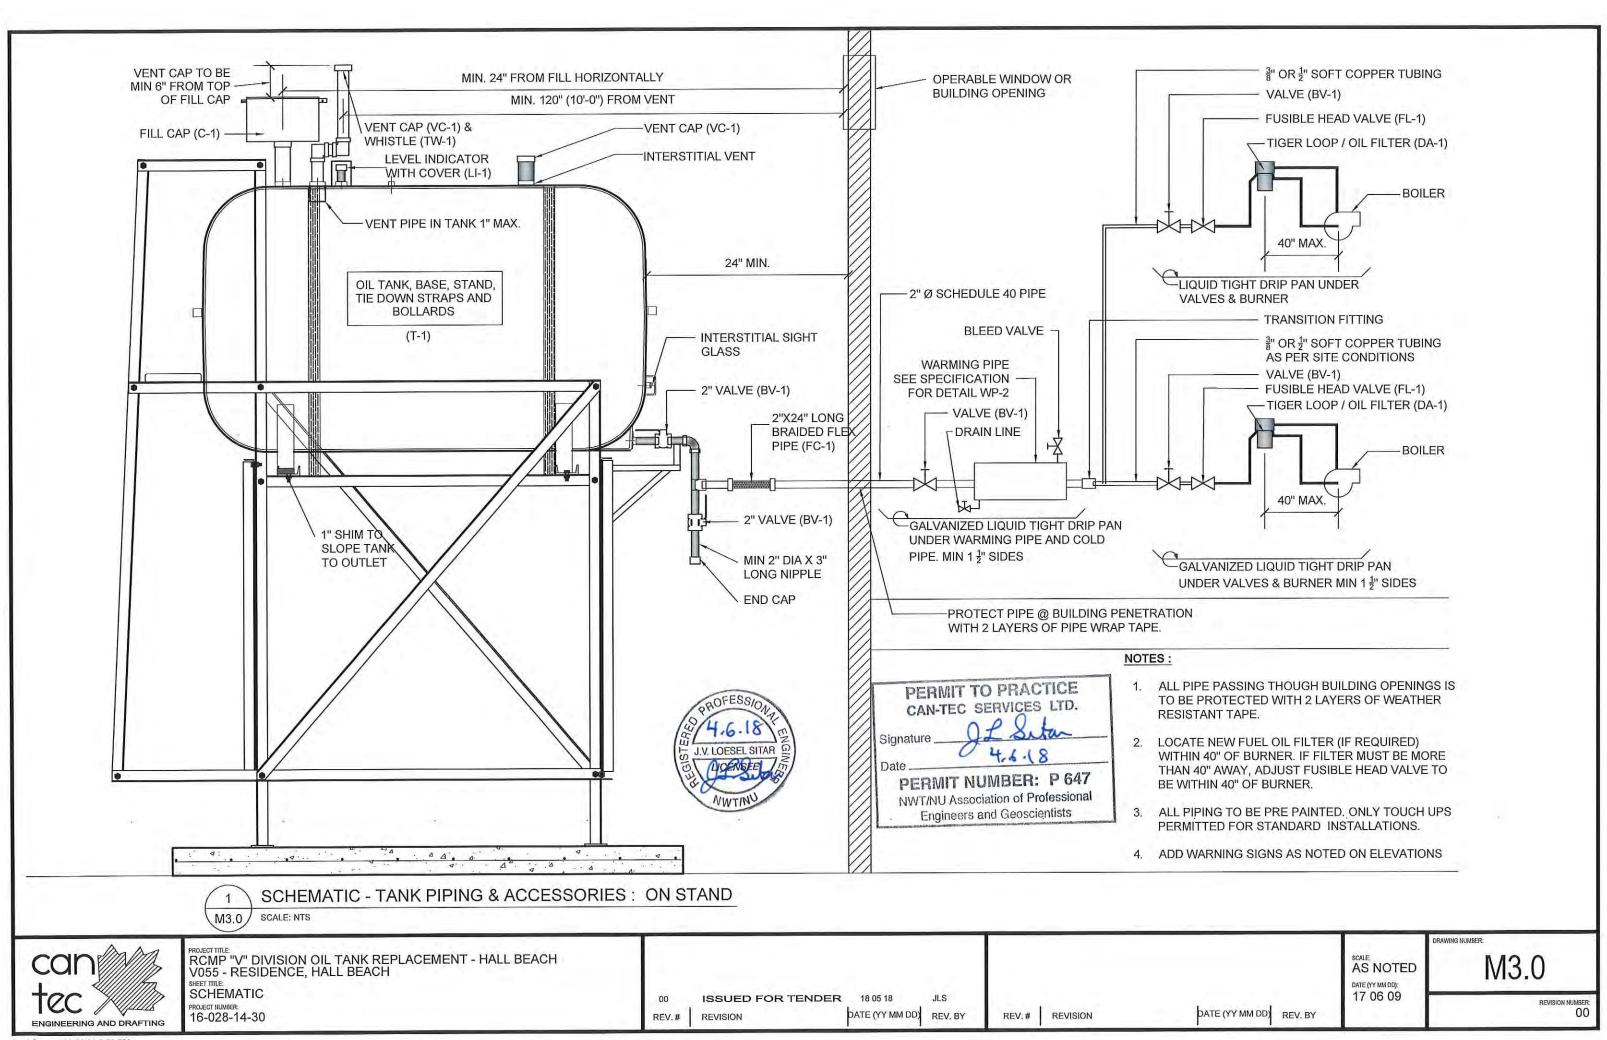
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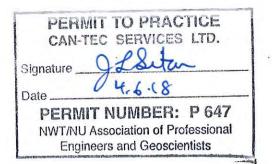
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## **CONSTRUCTION NOTES:**

- 1. REMOVE EXISTING FILL CAP AND INSTALL NEW WEATHER TIGHT FILL CAP
- 2. ADJUST PIPING TO INSTALL NEW PIPE SUPPORTS AND PROTECTION AS SHOWN ON SHEETS M2.0 AND M2.1



DATE (YY MM DD) REV. BY





PROJECT TITLE:
RCMP "V" DIVISION OIL TANK REPLACEMENT - HALL BEACH V058 - DETACHMENT, HALL BEACH
SHEET TITLE:

SHEET TITLE:
CONSTRUCTION PLAN
PROJECT NUMBER:
16-028-14-30

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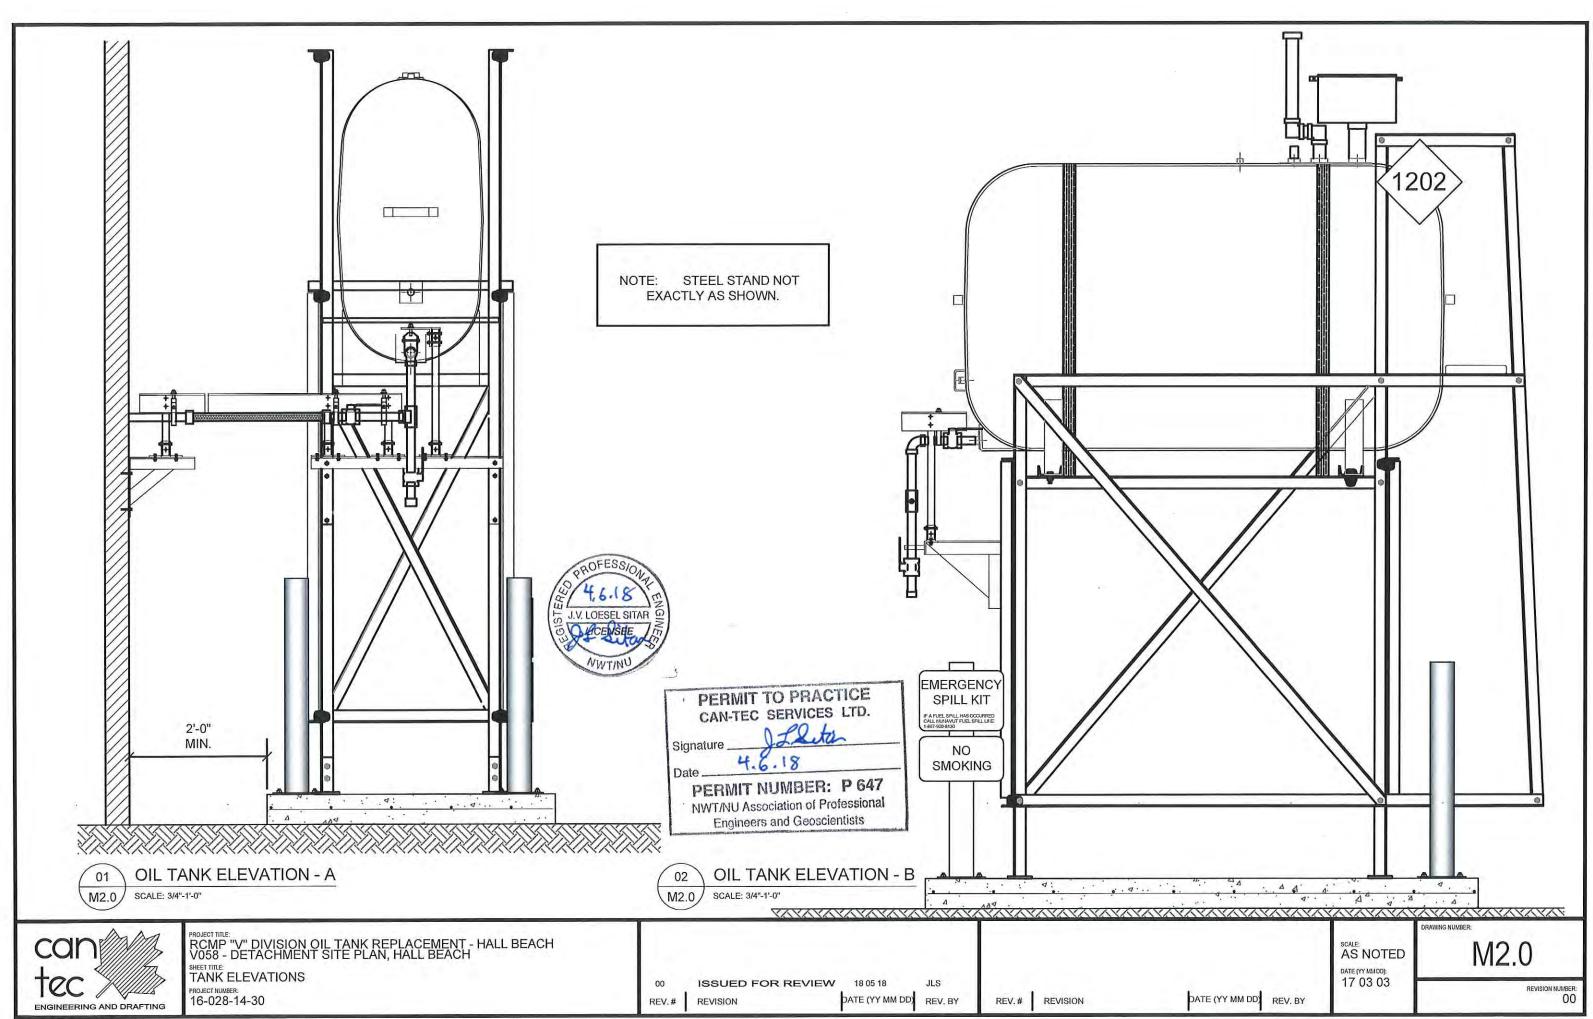
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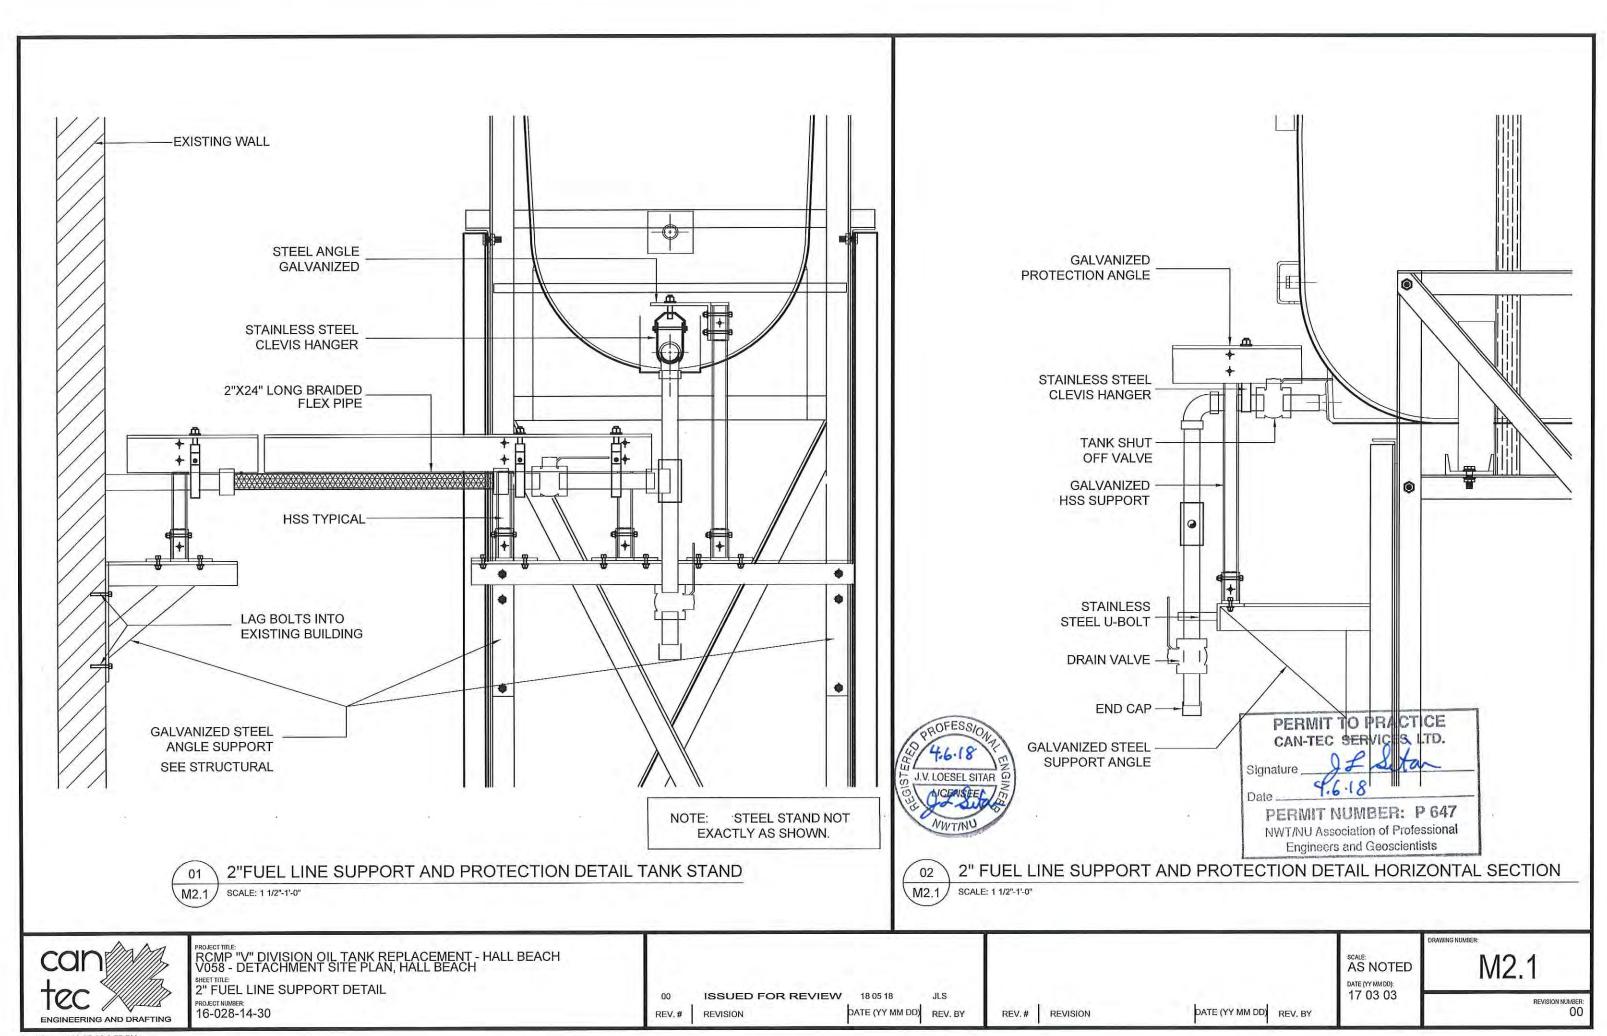
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M1.0

REVISION NUMBER:





# FUEL TANK REPAIR AND REPLACEMENT PROJECT POND INLET, NUNAVUT

# **DRAWING LIST:**

#### V135 - RESIDENCE

DEMOLITION PLAN

**CONSTRUCTION PLAN** M1.1 TANK ELEVATIONS

2" FUEL LINE SUPPORT DETAIL M2.1

SCHEMATIC

#### V136 - GARAGE/FITNESS BUILDING

DEMOLITION AND CONSTRUCTION PLAN

M2.0 TANK ELEVATIONS

2" FUEL LINE SUPPORT DETAIL M2.1

M3.0 SCHEMATIC

### V139 - RESIDENCE

**CONSTRUCTION PLAN** 

### V140 - RESIDENCE

**DEMOLITION PLAN** M1.0 CONSTRUCTION PLAN M1.1

M2.0 TANK ELEVATIONS

2" FUEL LINE SUPPORT DETAIL M2.1

M3.0 SCHEMATIC

### STRUCTURAL DRAWING LIST

STRUCTURAL PROJECT NOTES

TYP TANK SLAB, BOLLARD AND BASE PLATE DETAILS AND

ISOMETRIC VIEW OF METAL STAND

**CONNECTION #1 DETAILS** S3 **CONNECTION #2 DETAILS** 

TANK #1 - PLAN VIEW OF TANK ON SLAB TANK #1 - PLAN VIEW OF TANK ON SLAB

TANK #2 - PLAN VIEW OF TANK ON LOW METAL STAND

TANK #2 - ELEVATIONS OF LOW METAL STAND

TANK #2 - ELEVATIONS OF LOW METAL STAND

TANK #3 - PLAN VIEW OF TANK ON HIGH METAL STAND S10 TANK #3 - ELEVATIONS OF HIGH METAL STAND

TANK #3 - ELEVATIONS OF HIGH METAL STAND

TANK #4 - PLAN VIEW OF TANK ON LOW DOUBLE METAL STAND S13 TANK #4 - ELEVATIONS OF LOW DOUBLE METAL STAND S14

TANK #4 - ELEVATIONS OF LOW DOUBLE METAL STAND S15

TANK #5 - PLAN VIEW OF TANK ON HIGH DOUBLE METAL STAND S16

TANK #5 - ELEVATIONS OF HIGH DOUBLE METAL STAND S17

TANK #5 - ELEVATIONS OF HIGH DOUBLE METAL STAND S18



RCMP "V" DIVISION OIL TANK REPLACEMENT - POND INLET

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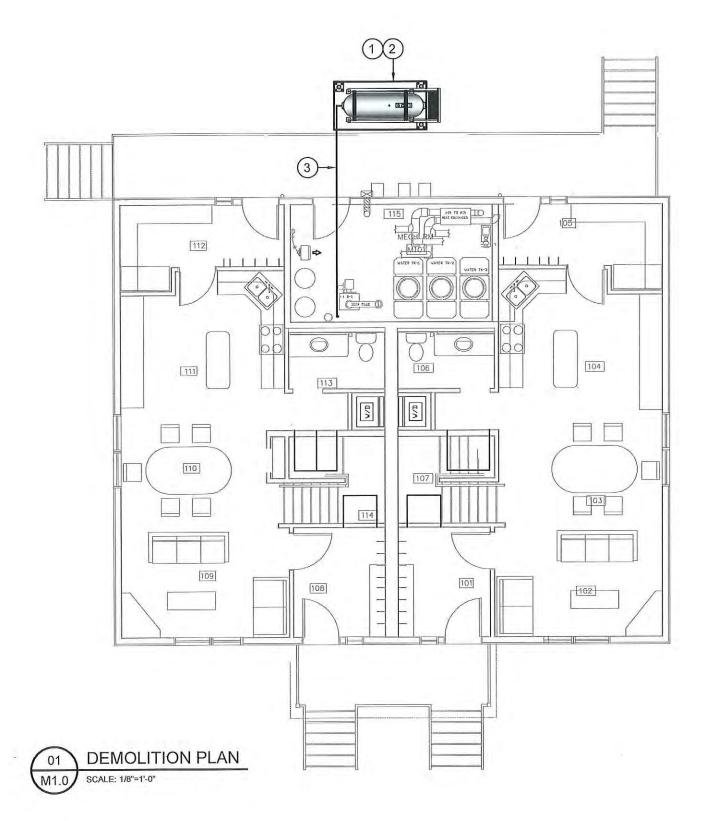
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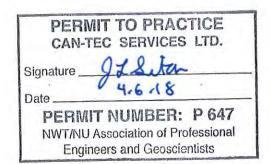
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## DEMOLITION NOTES: (#)

- 1. REMOVE ALL FUEL FROM THE TANK AND DISPOSE OF AS PER LOCAL REGULATIONS.
- 2. REMOVE EXISTING OIL TANK, STAND AND PAD DISPOSE OF AS PER LOCAL REGULATIONS.
- REMOVE ALL PIPING UNDER DUPLEX TO EXISTING BOILER.







PROJECT VITLE:
RCMP "V" DIVISION OIL TANK REPLACEMENT - POND INLET
V135 - DUPLEX RESIDENCE , POND INLET

SHEET TITLE: DEMOLITION PLAN PROJECT NUMBER: 16-028-14-30

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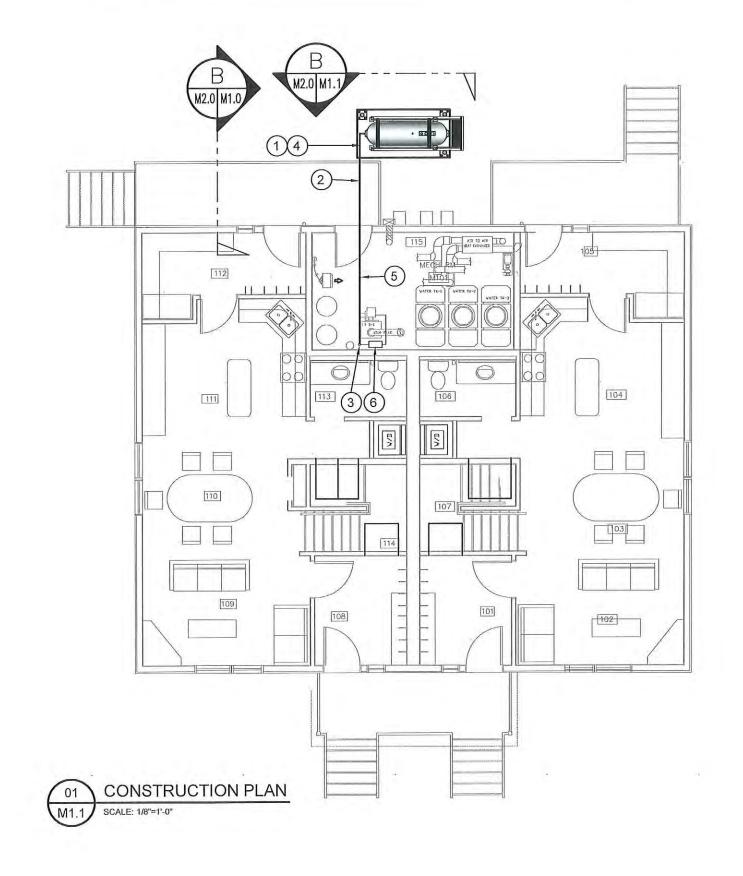
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AS NOTED DATE (TY MMDD): 17 06 09

DATE (YY MM DD) REV. BY

M1.0

REVISION NUMBER:



CONSTRUCTION NOTES: (#)



- 1. INSTALL NEW OIL TANK, STAND AND CONCRETE PAD. SEE SHEET M2.0
- 2. INSTALL NEW PIPING SUPPORT AS PER SHEET M2.1. INSTALL PIPE HANGERS AS REQUIRED TO SUPPORT PIPING UNDER DUPLEX
- CAULK ENTRY INTO BUILDING.
- INSTALL NEW OIL TANK STAND #3 SEE STRUCTURAL FOR DETAILS.
- INSTALL NEW 2" DIA SCH 40 PIPE AND HANGERS AS PER SPECIFICATION
- 6. INSTALL NEW WARMING PIPE, FUEL FILTER, FUSIBLE LINK, TIGER LOOP AND DRIP TRAYS.

PERMIT TO PRACTICE CAN-TEC SERVICES LTD.

Signature

Date.

PERMIT NUMBER: P 647 NWT/NU Association of Professional

**Engineers and Geoscientists** 

J.V. LOESEL SITAR



PROJECT TITLE:
RCMP "V" DIVISION OIL TANK REPLACEMENT - POND INLET
V135 - DUPLEX RESIDENCE , POND INLET

SHEET TITLE: CONSTRUCTION PLAN

PROJECT NUMBER: 16-028-14-30

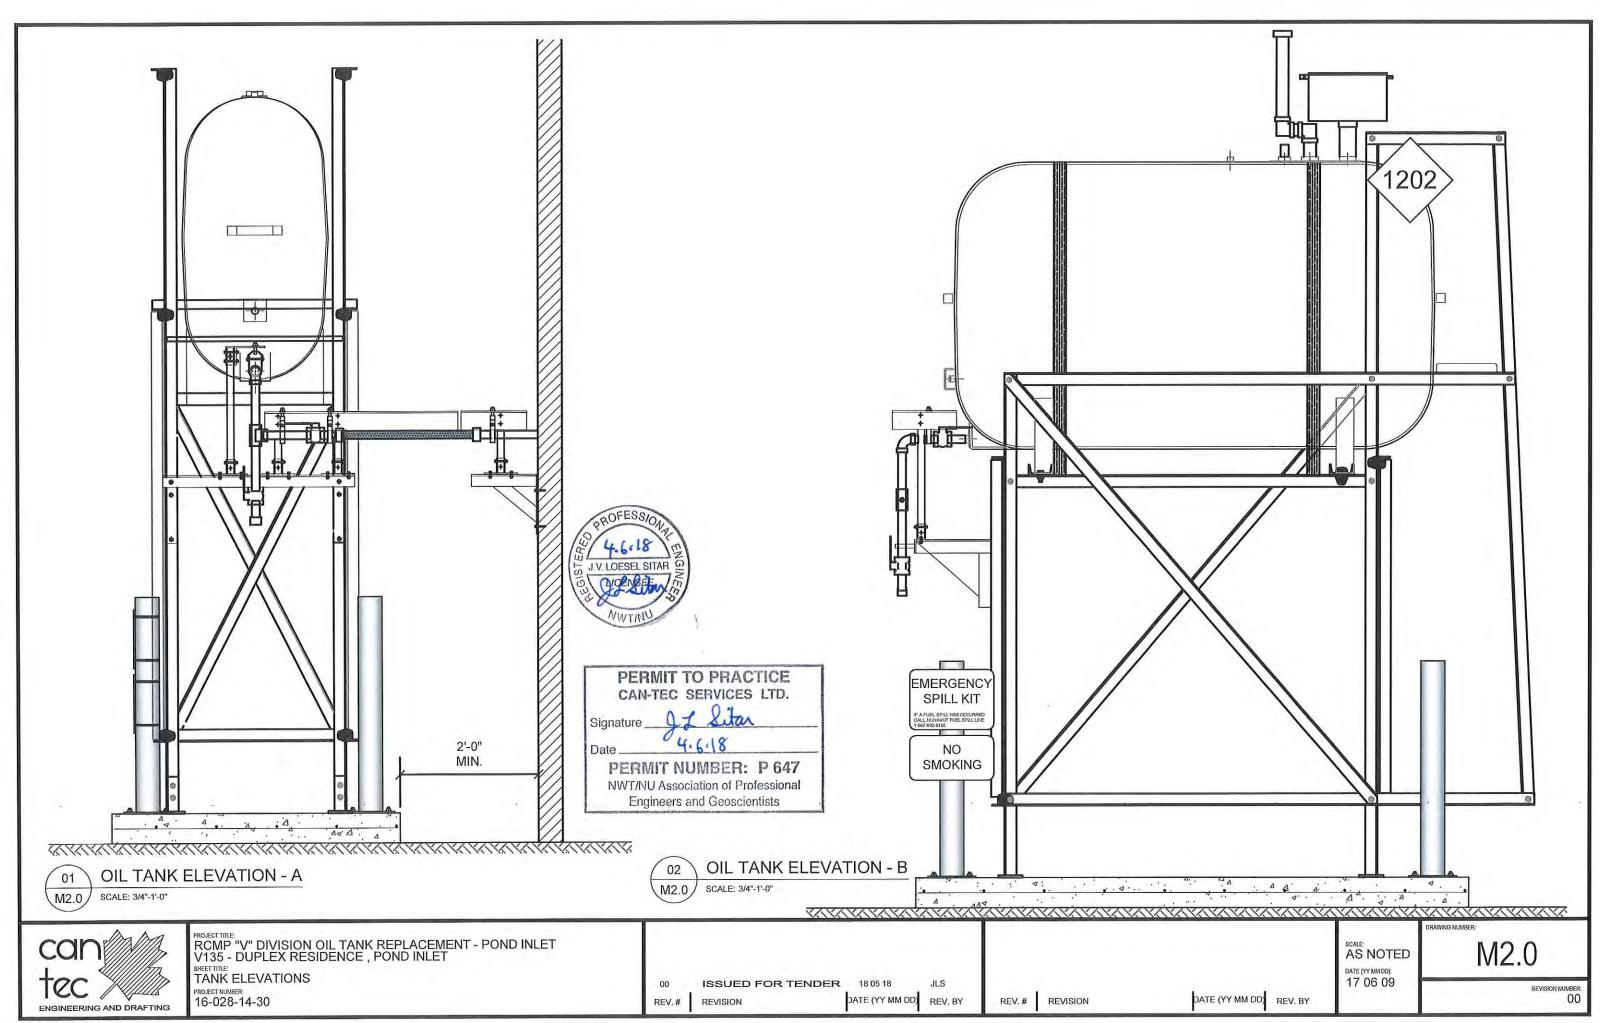
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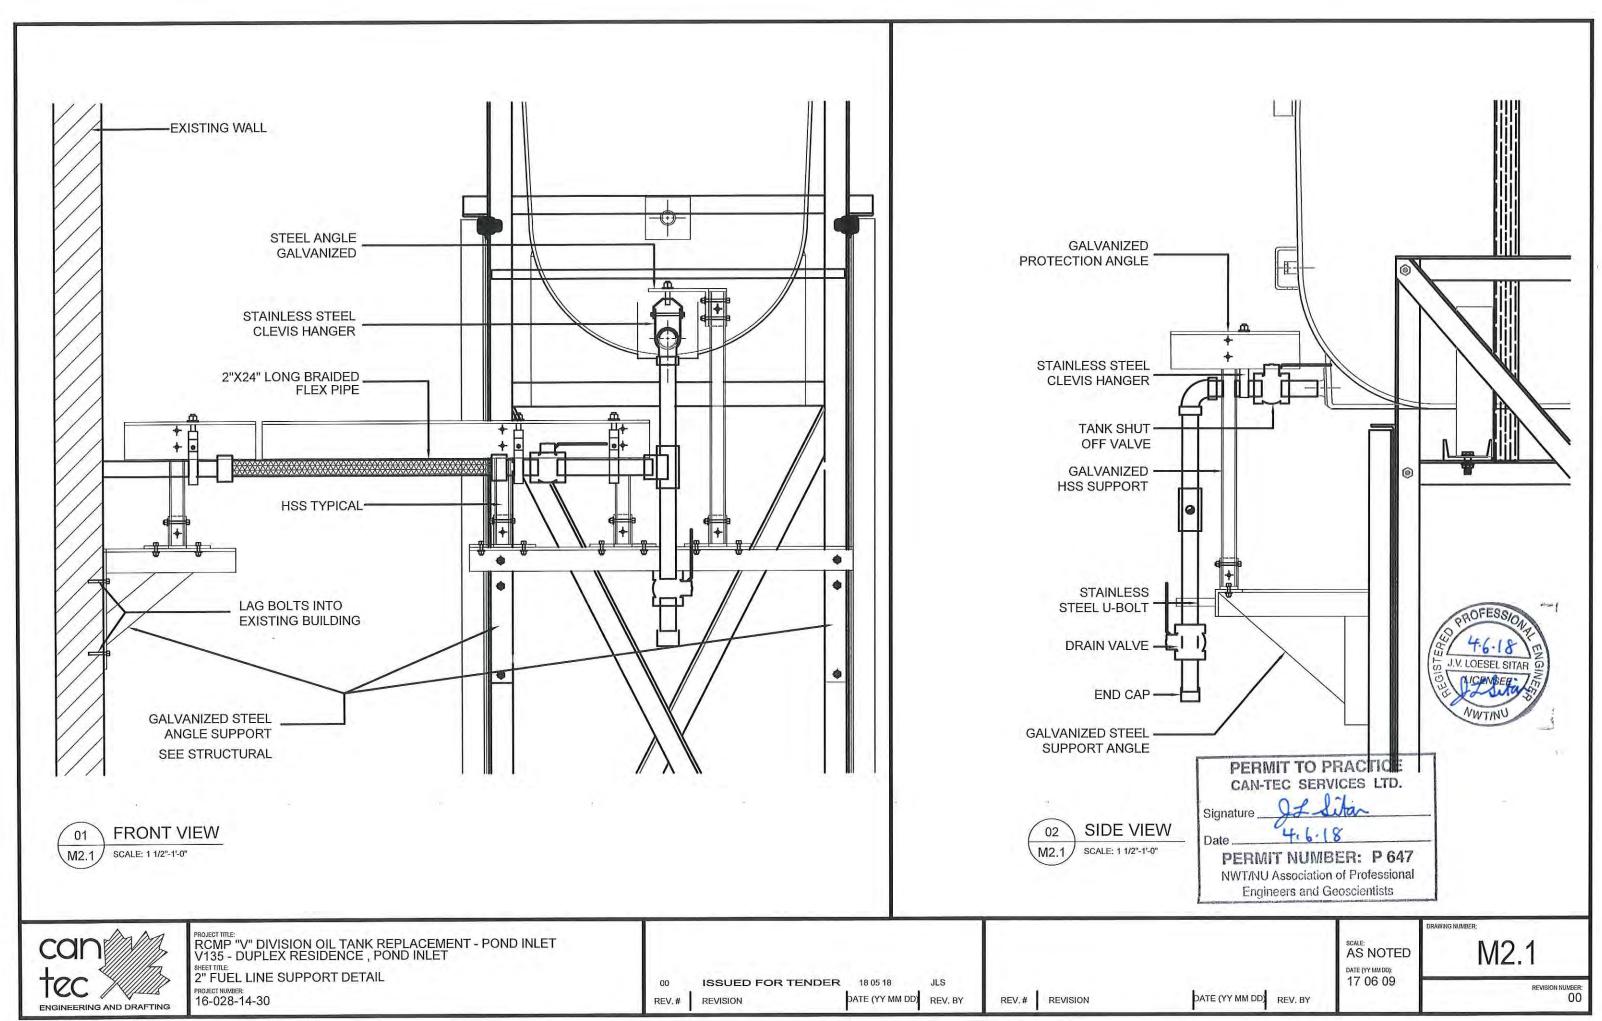
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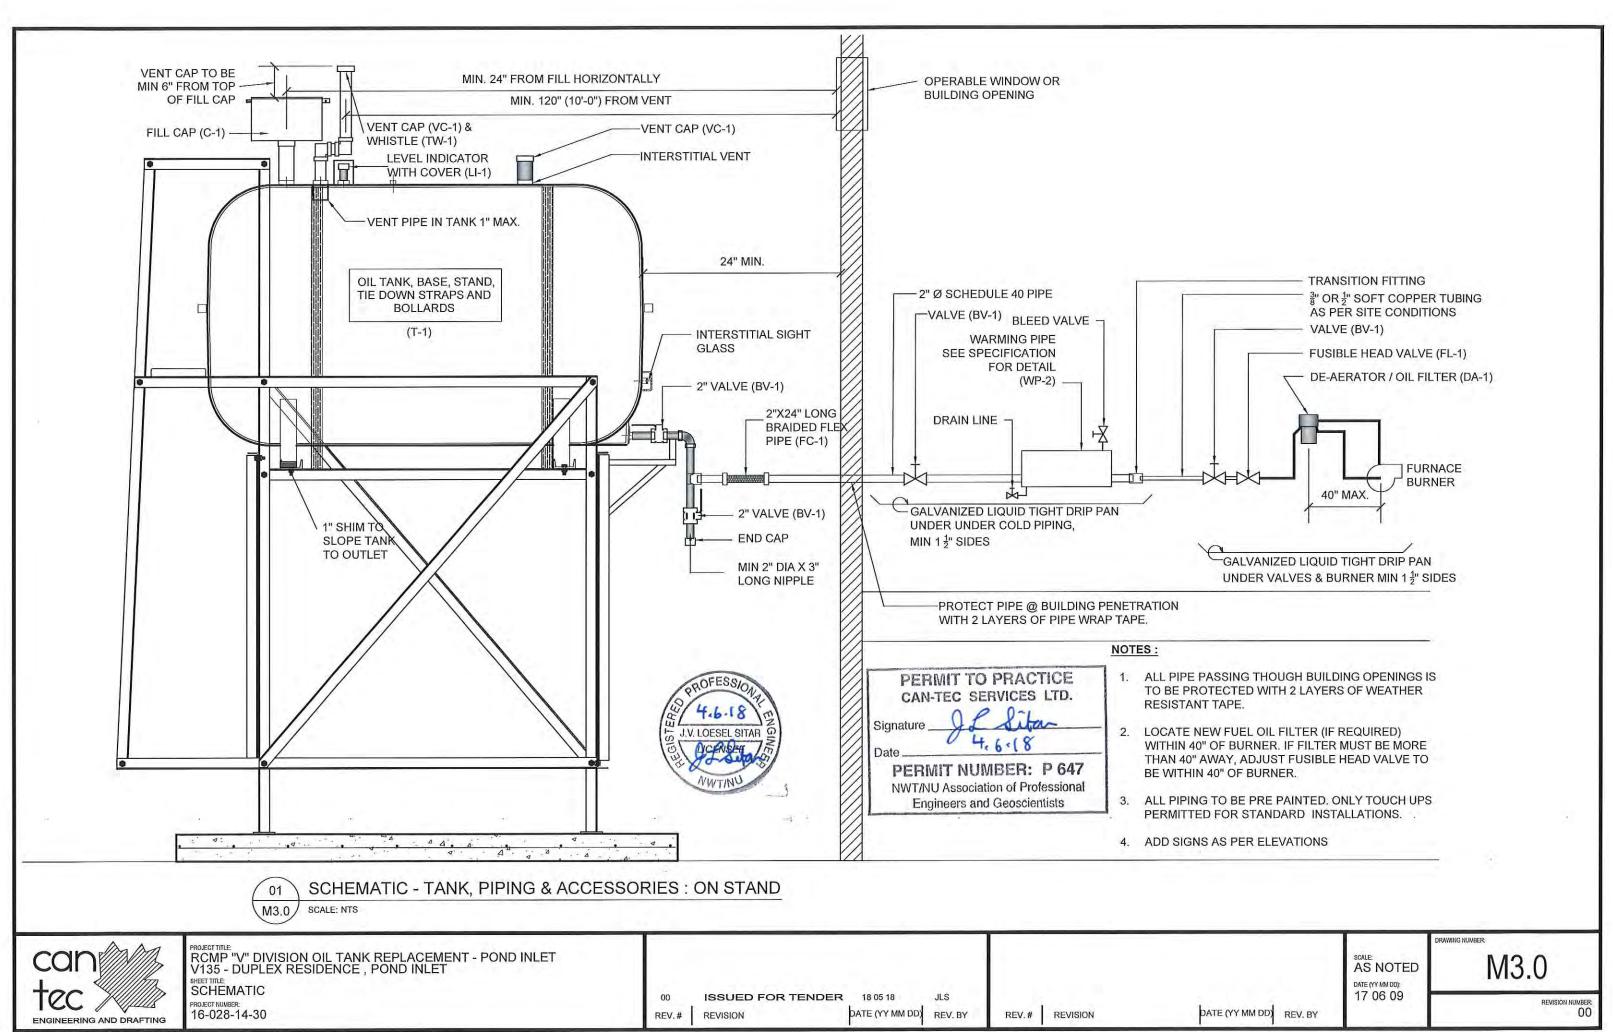
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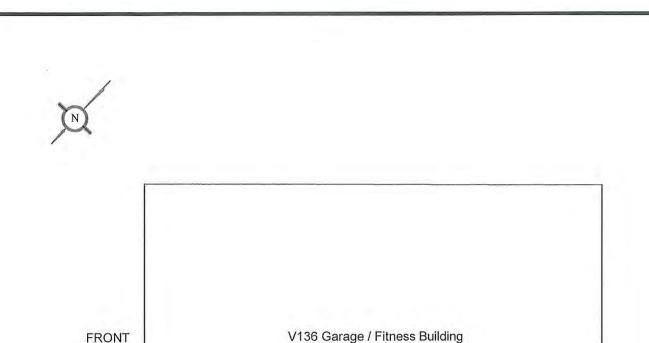
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-TANK 

**POND INLET** 

**DEMOLITION PLAN** SCALE: NTS M1.0/

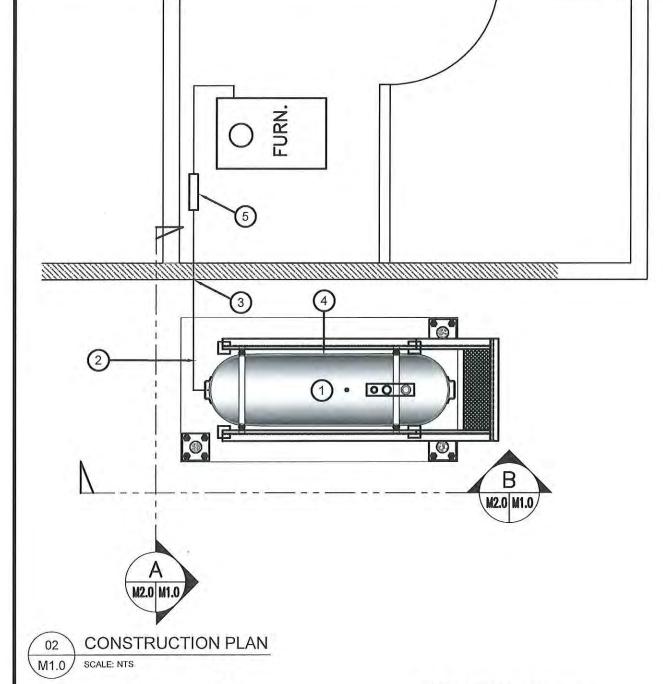
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PERMIT NUMBER: P 647 NWT/NU Association of Professional Engineers and Geoscientists

## **DEMOLITION NOTES:**

- 1. REMOVE ALL FUEL FROM THE TANK AND DISPOSE OF AS PER LOCAL REGULATIONS.
- 2. REMOVE EXISTING ROTH 1000L OIL TANK AND PAD DISPOSE OF AS PER LOCAL REGULATIONS.





# CONSTRUCTION NOTES: (#)

- INSTALL NEW OIL TANK, AND STAND CONCRETE PAD. SEE SHEET M2.0
- INSTALL NEW PIPING SUPPORT AS PER SHEET M2.0.
- CAULK ENTRY INTO BUILDING.
- INSTALL NEW OIL TANK STAND #2 SEE STRUCTURAL FOR DETAILS.
- 5. INSTALL NEW WARMING PIPE (WP-2)

## **INTERIOR REPAIR NOTES:**

DATE (YY MM DD) REV. BY

INSTALL NEW FUEL SYSTEM TO EXISTING FURNACE BURNER. INCLUDING FUEL LINES, VALVES, FUSIBLE LINK AND DE-AREATOR/FILTER.



RCMP "V" DIVISION OIL TANK REPLACEMENT - POND INLET V136 - GARAGE / FITNESS BUILDING , POND INLET DEMOLITION AND CONSTRUCTION PLAN

16-028-14-30

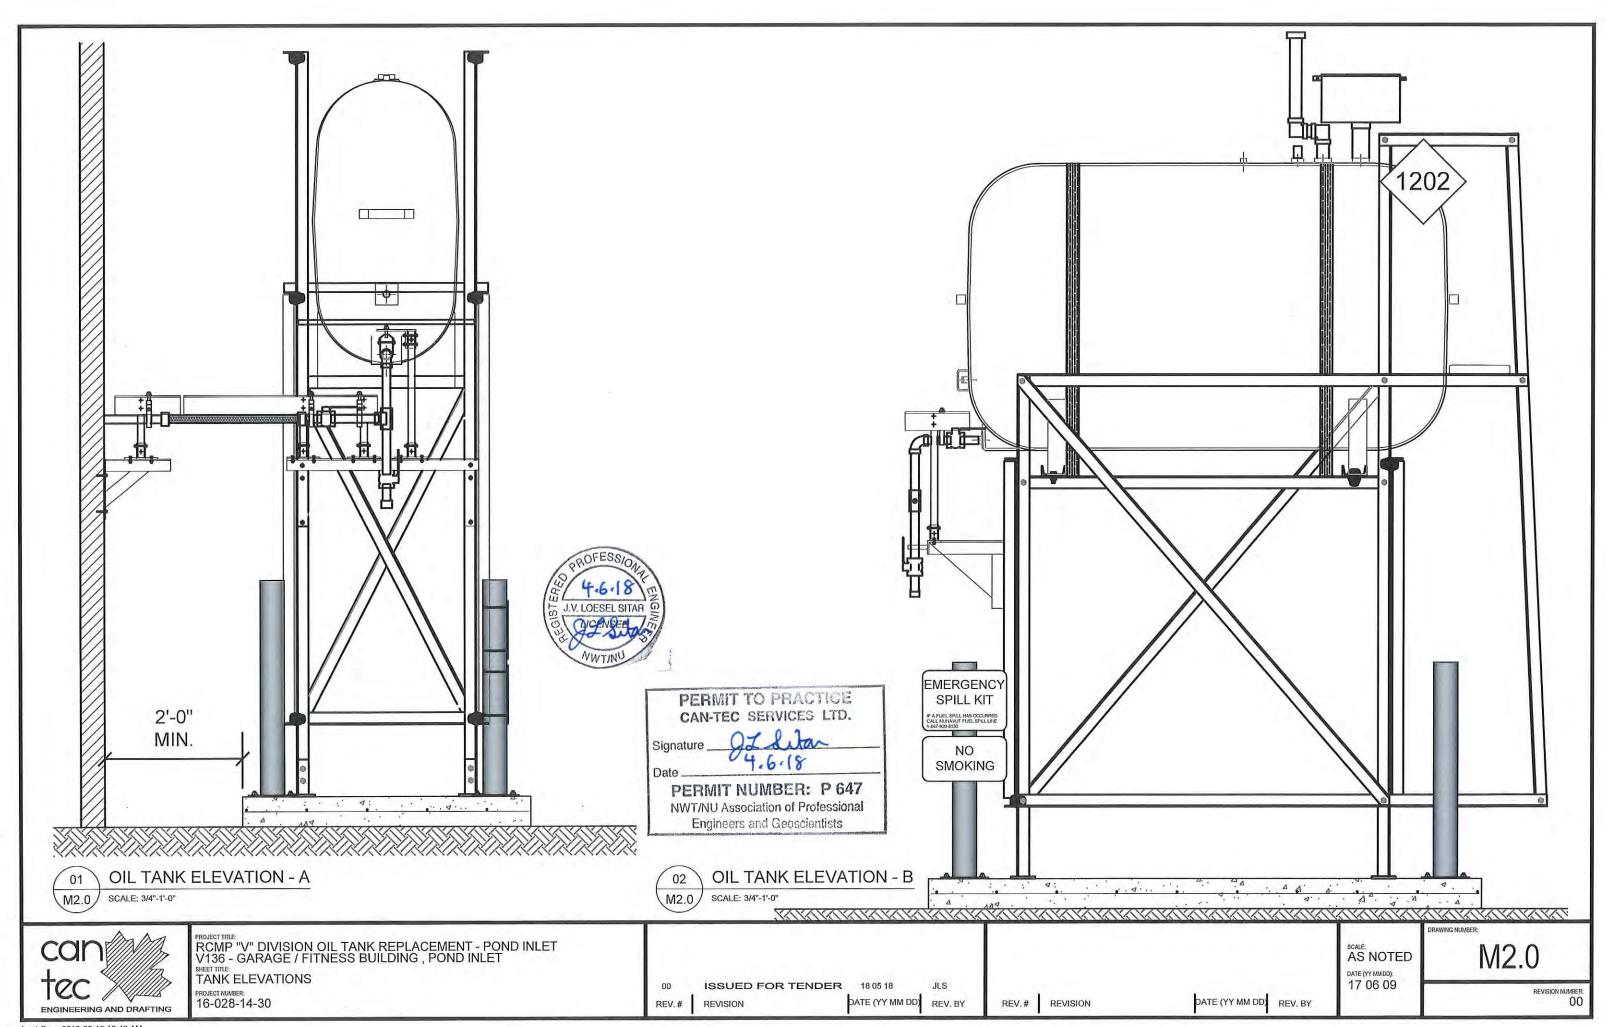
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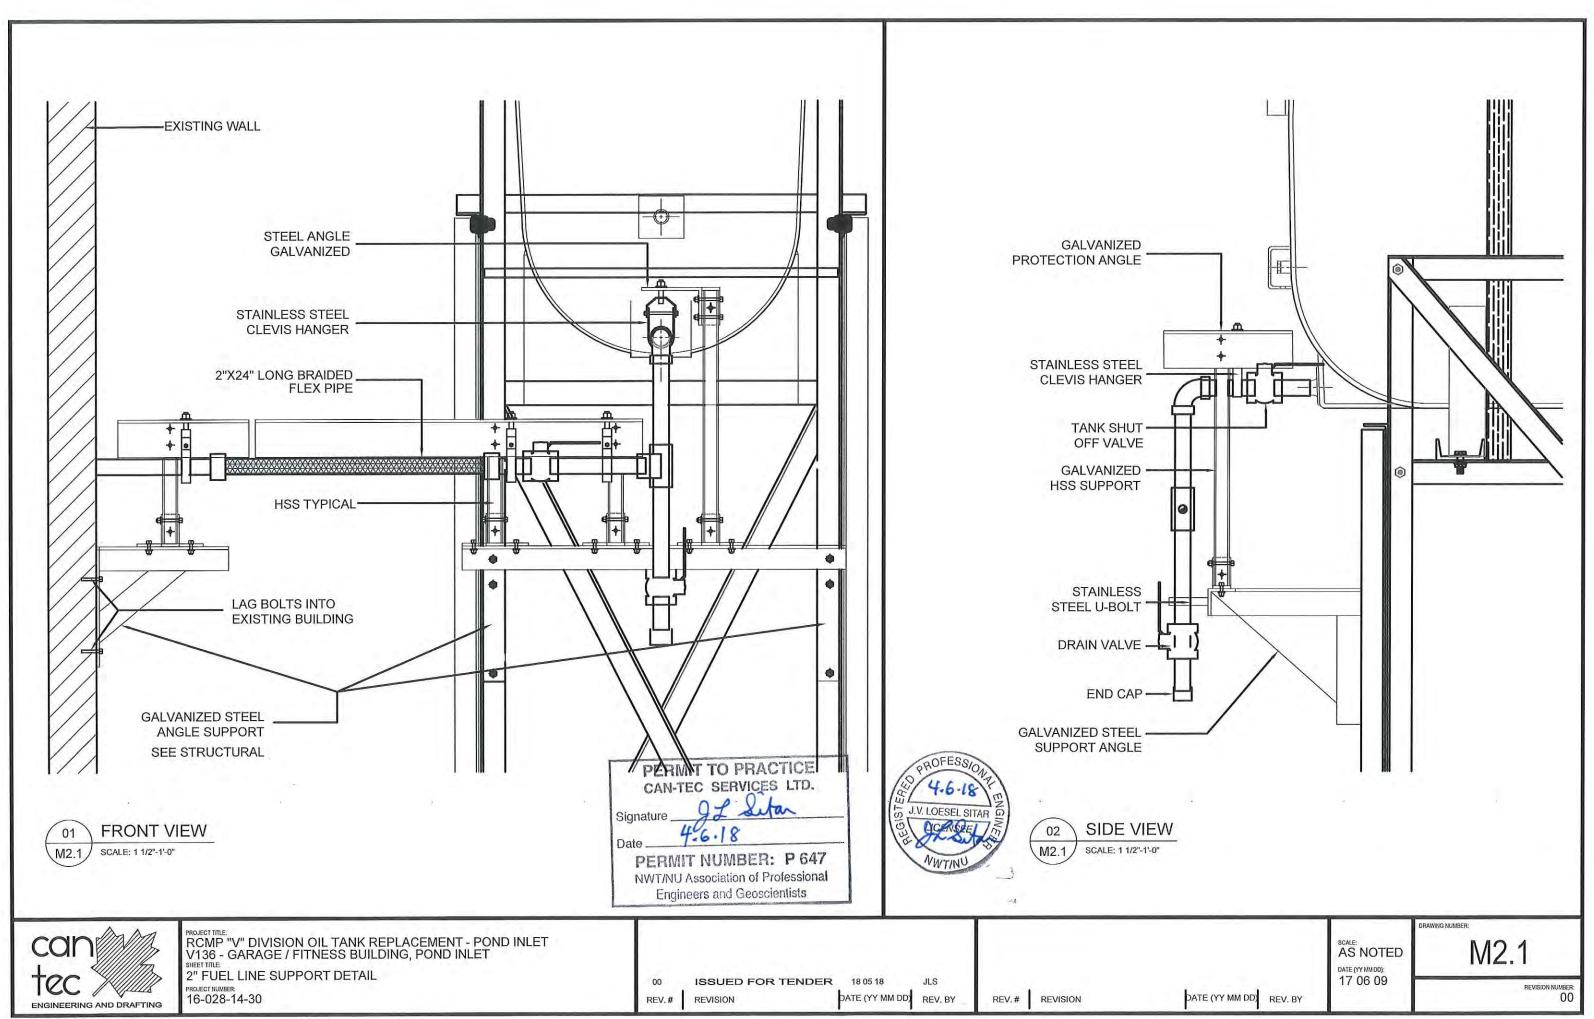
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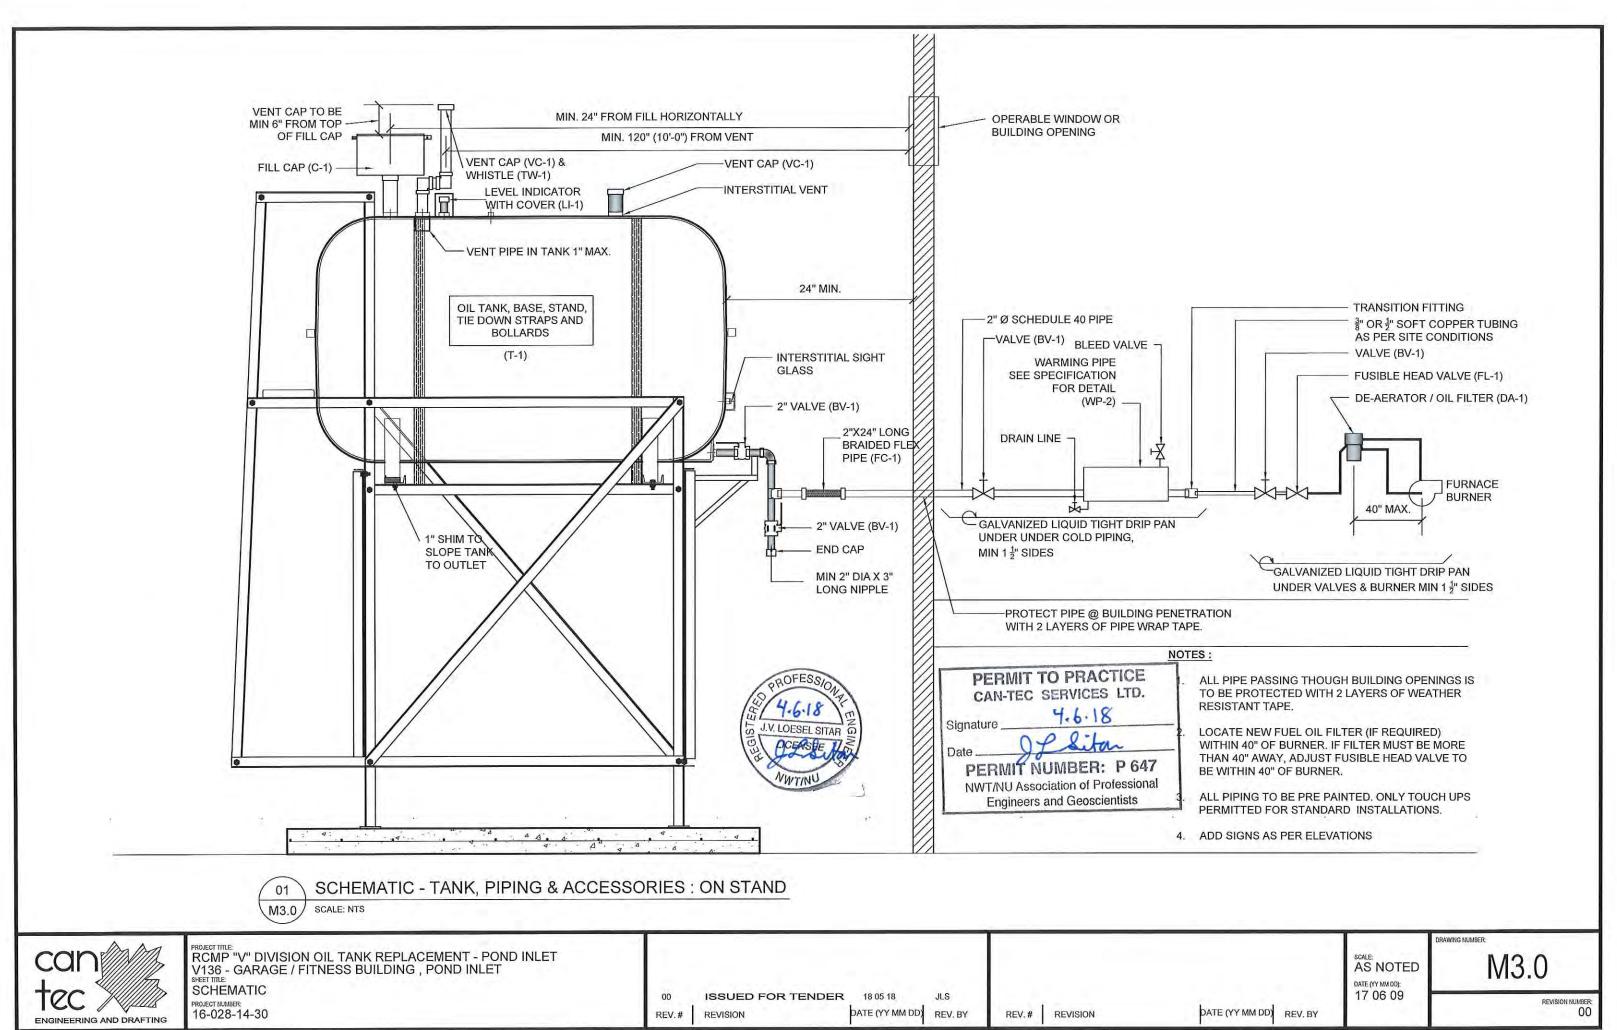
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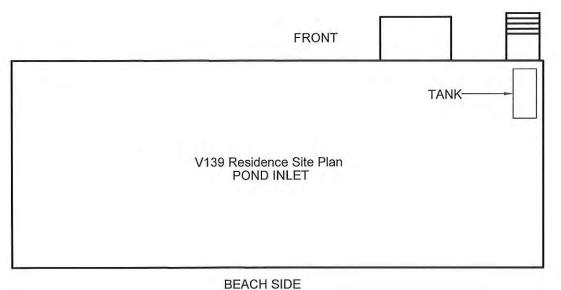
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REMOVE EXISTING VENT CAP AND EXTEND PIPE SO THAT TOP OF PIPE IS MIN 6" ABOVE TOP OF NEW SPILL CAP.

INSTALL NEW FILL CAP AND SPILL CONTAINMENT CAP. ADJUST PIPING AS REQUIRED

> CAULK AND SEAL ALL OPENINGS



**EXTERIOR ELEVATION** SCALE: NTS M1.0



#### INTERIOR REPAIR NOTES:

- 1. MODIFY INTERIOR PIPING AND INSTALL NEW VENT WHISTLE ON EXISTING VENT LINE.
- **INSTALL NEW VENT CAP**
- MODIFY INTERIOR EMERGENCY VENT AND INSTALL **NEW CAP**
- MODIFY EXISTING FILL CAP AND INSTALL NEW SPILL CONTAINMENT FILL CAP
- 5. PAINT ALL EXTERIOR AND INTERIOR PIPING



ADD NEW VENT CAP CAULK SEAL ALL **OPENINGS** 

INSTALL NEW VENT WHISTLE -

J.V. LOESEL SITAR

INTERIOR ELEVATION SCALE: NTS M1.0



PROJECT TITLE: RCMP "V" DIVISION OIL TANK REPLACEMENT POND INLET

Signature

V139 - RESIDENCE CONSTRUCTION PLAN

16-028-14-30

ISSUED FOR TENDER 18 05 18 REVISION

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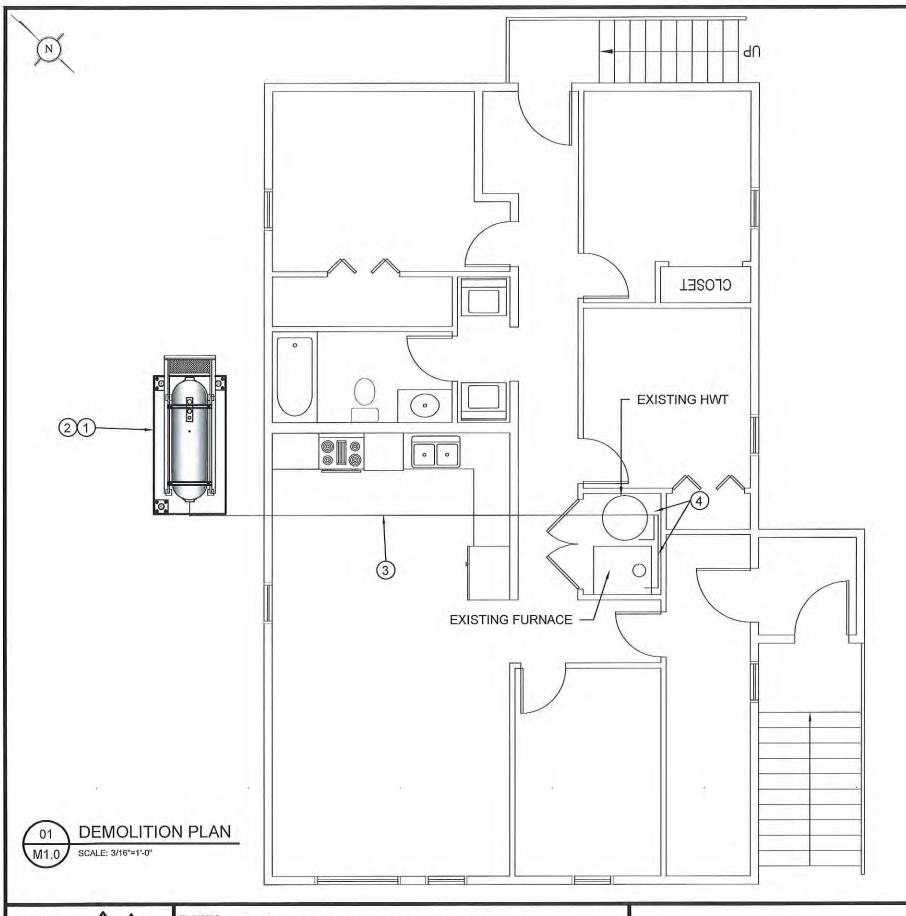
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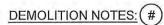
DATE (YY MM DD): 17 06 09 DATE (YY MM DD) REV. BY

AS NOTED

M1.0

REVISION NUMBER 00





- 1. REMOVE ALL FUEL FROM THE TANK AND DISPOSE OF AS PER LOCAL REGULATIONS.
- 2. REMOVE EXISTING TANK AND PAD DISPOSE OF AS PER LOCAL REGULATIONS.
- 3. REMOVE ALL PIPING TO FURNACE AND HOT WATER TANK. DISPOSE OF AS PER LOCAL REGULATIONS.
- REMOVE EXISTING TIGER LOOP AND FUEL FILTERS ON EXISTING FURNACE AND HWT. DISPOSE OF AS PER REGULATIONS.



PERMIT TO PRACTICE CAN-TEC SERVICES LTD. Date.

PERMIT NUMBER: P 647 NWT/NU Association of Professional **Engineers and Geoscientists** 

ENGINEERING AND DRAFTING

PROJECT TITLE: RCMP "V" DIVISION OIL TANK REPLACEMENT - POND INLET V140 - RESIDENCE , POND INLET

SHEET TITLE:
DEMOLITION PLAN PROJECT NUMBER: 16-028-14-30

ISSUED FOR TENDER 18 05 18 REVISION

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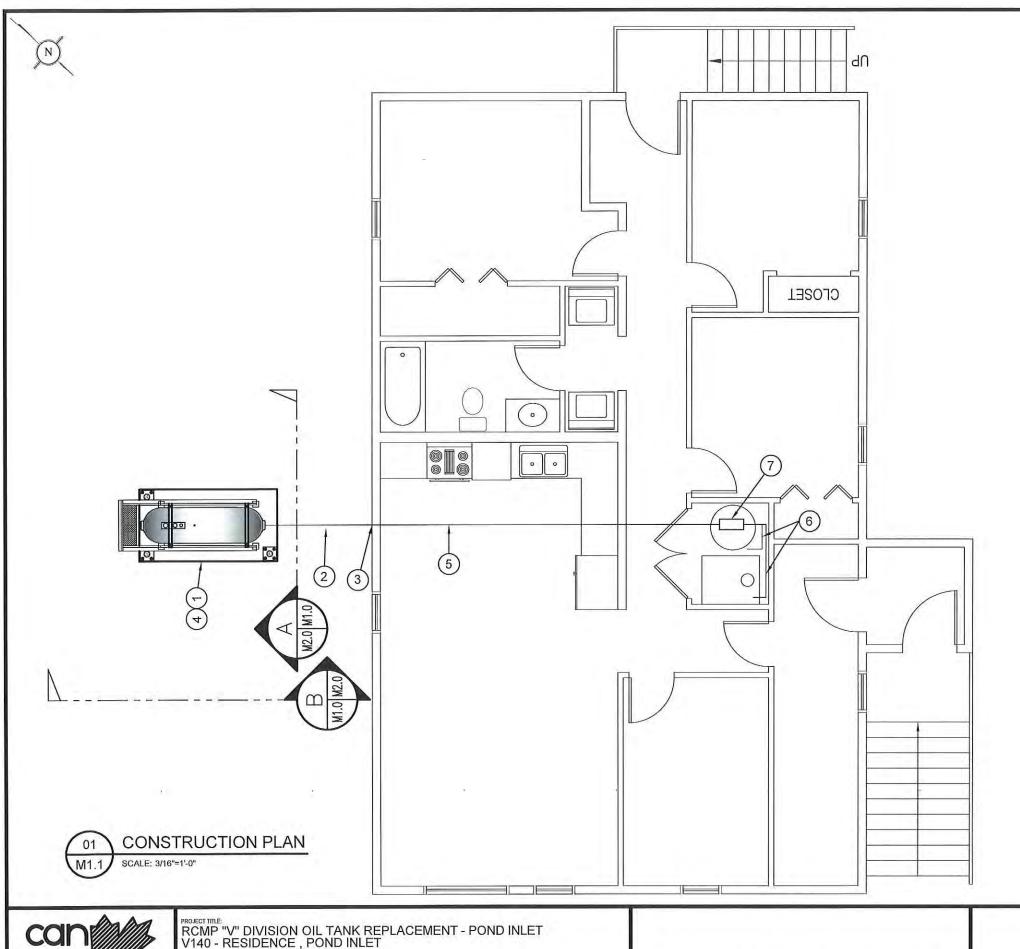
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AS NOTED DATE (YY MM DD): 17 06 09

DATE (YY MM DD) REV. BY

M1.0

REVISION NUMBER:



## CONSTRUCTION NOTES: (#)

- 1. INSTALL NEW OIL TANK, STAND AND CONCRETE PAD.
- SEE SHEET M2.0 INSTALL NEW PIPING SUPPORT AS PER SHEET M2.1
- CAULK ENTRY INTO BUILDING.
- INSTALL NEW OIL TANK STAND TYPE #3.
- INSTALL NEW 2" FUEL PIPE IN CRAWL SPACE. INSTALL NEW HANGERS AS PER SPECIFICATION (SUPPLY NEW ACCESS TO CRAWL SPACE NONE IS PRESENT AT THIS
- 6. INSTALL NEW FUEL FILTER, FUSIBLE LINK, TIGER LOOP AND FUEL PIPING TO FURNACE AND HOT WATER TANK. SEE M3.0
- 7. INSTALL NEW WARMING TANK (WP-2)



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Signature

PERMIT NUMBER: P 647

NWT/NU Association of Professional Engineers and Geoscientists



PROJECT TITLE:
RCMP "V" DIVISION OIL TANK REPLACEMENT - POND INLET
V140 - RESIDENCE , POND INLET

SHEET TITLE: CONSTRUCTION PLAN PROJECT NUMBER: 16-028-14-30

ISSUED FOR TENDER 18 05 18 REVISION

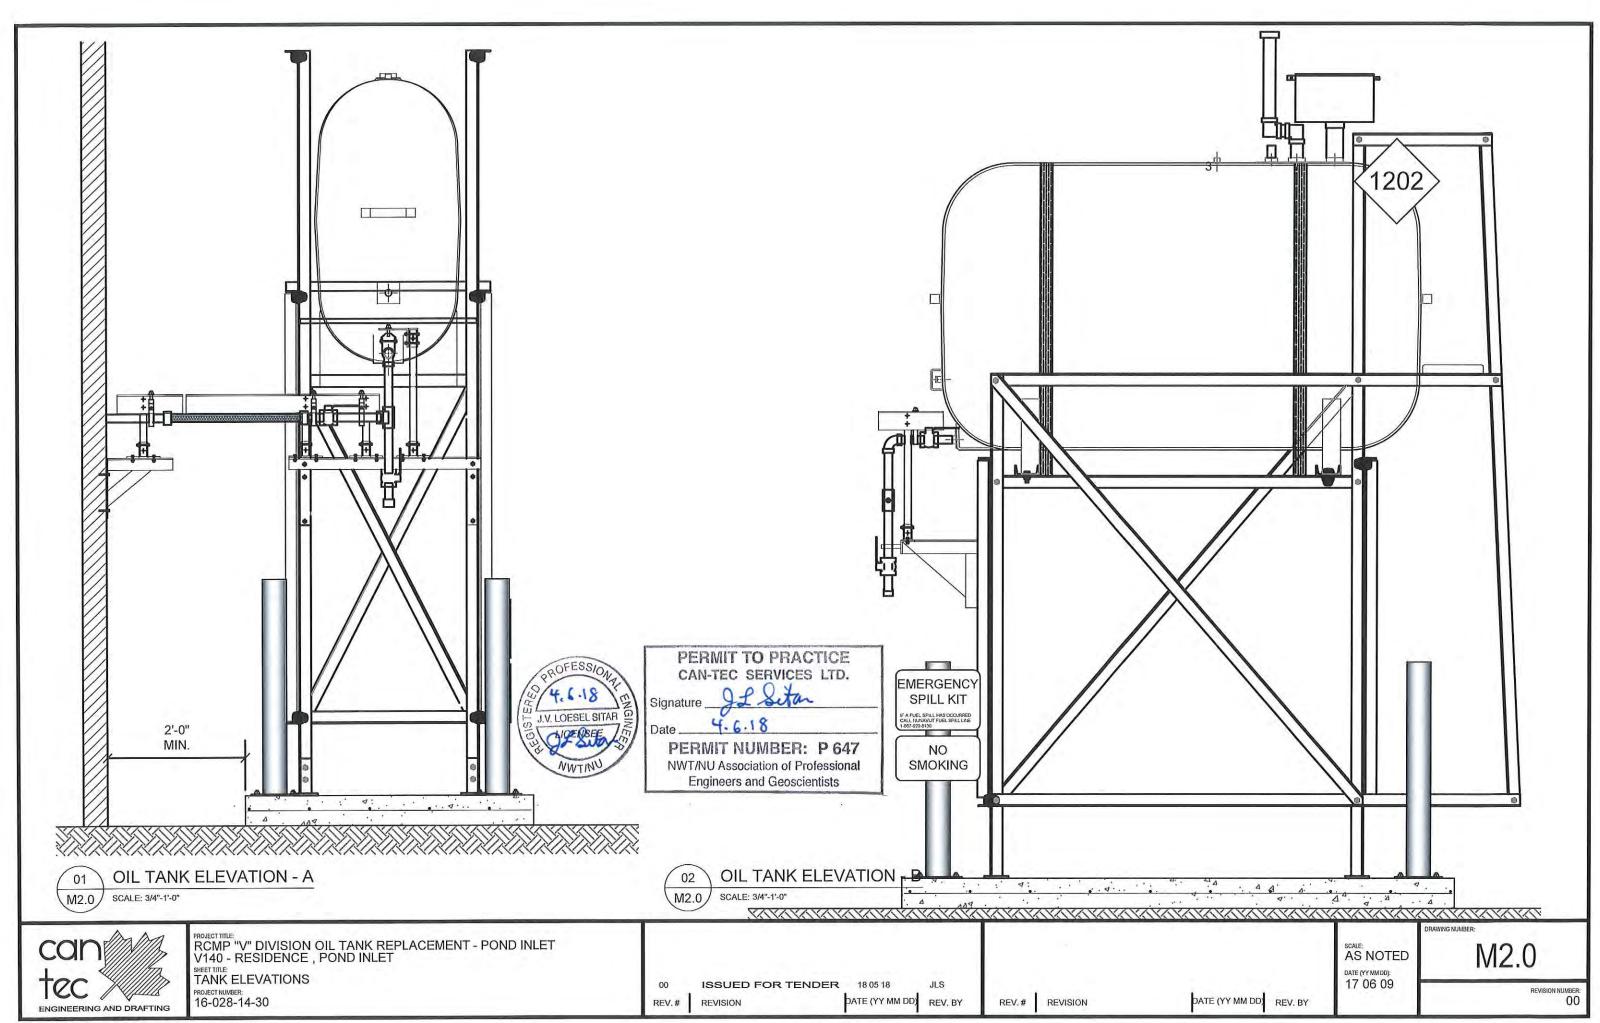
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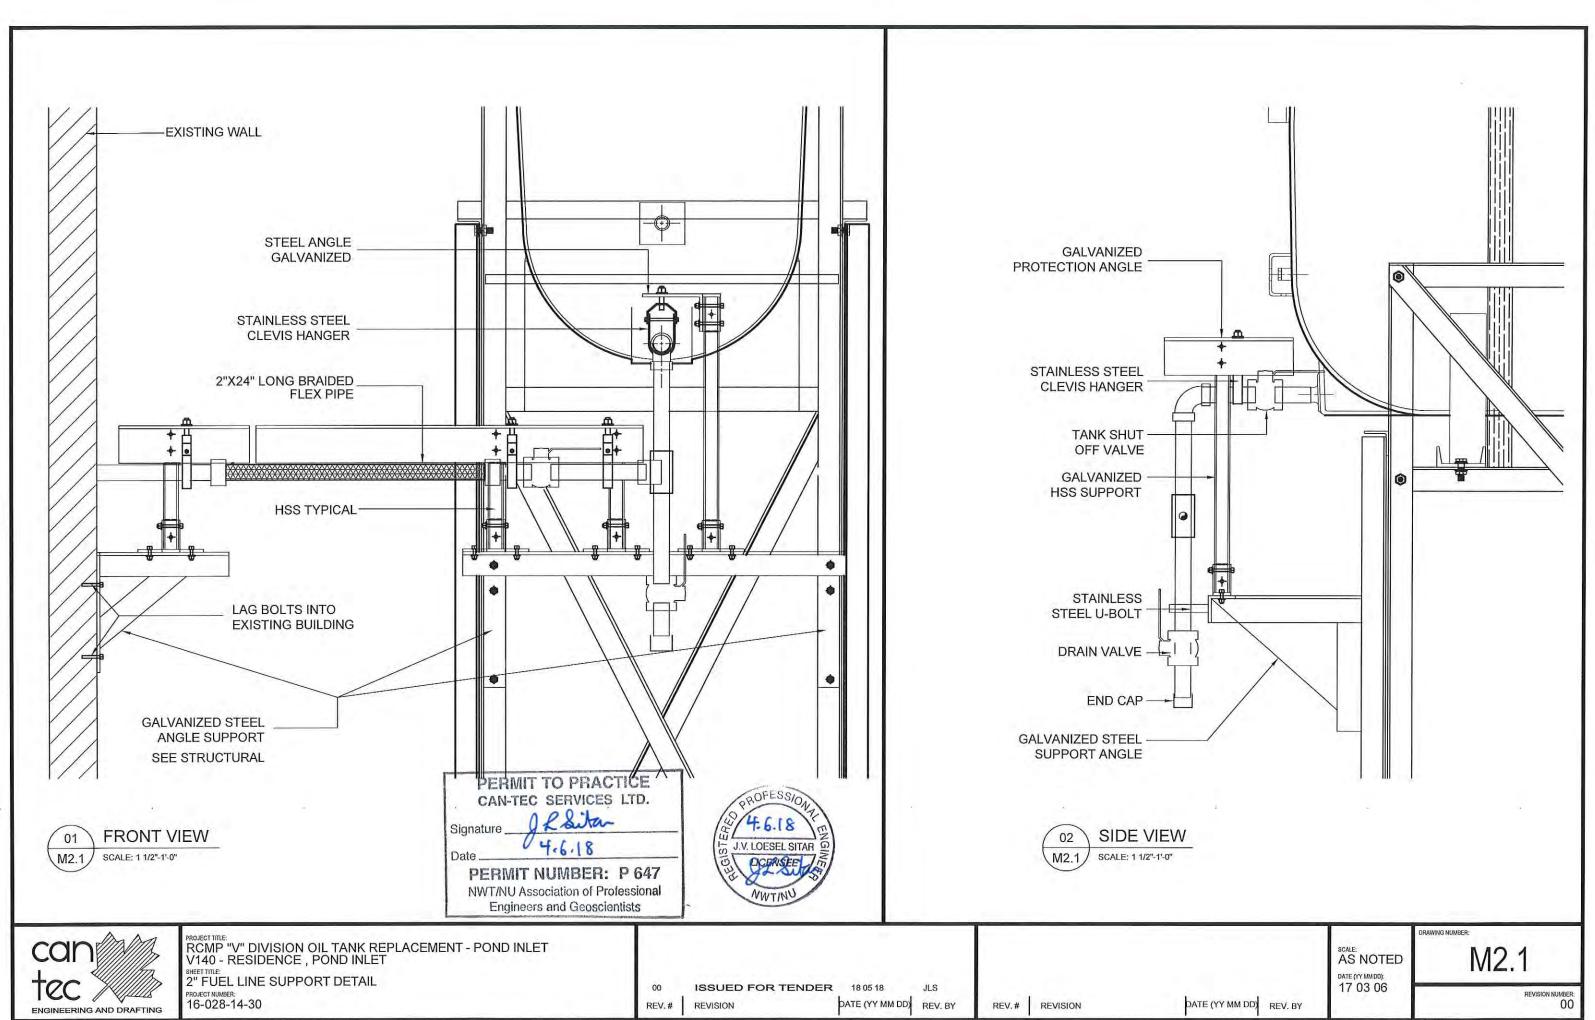
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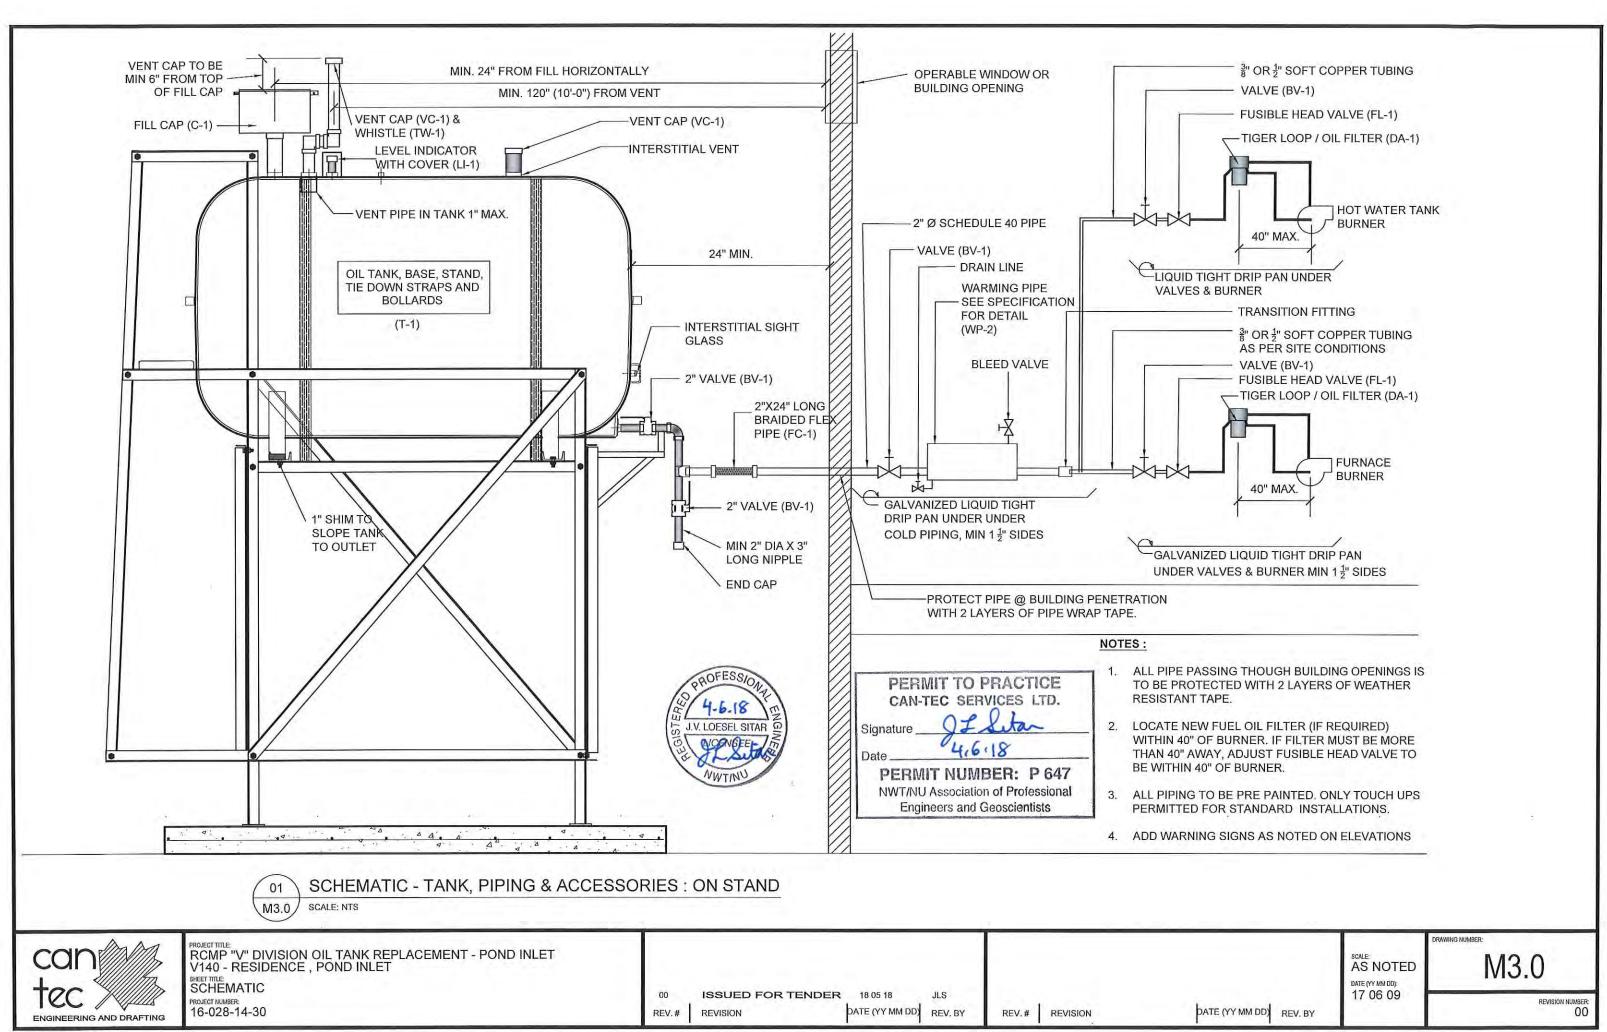
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## FUEL TANK REPAIR AND REPLACEMENT PROJECT PANGNIRTUNG, NUNAVUT

## DRAWING LIST:

#### V471 - NEW DUPLEX

M1.0 CONSTRUCTION PLAN M2.0 TANK ELEVATIONS

2" FUEL LINE SUPPORT DETAILS M2.1

M3.0 SCHEMATIC

#### V128 - RESIDENCE

DEMOLITION AND CONSTRUCTION PLAN

SECTION DETAILS

M2.1 2" FUEL LINE SUPPORT DETAILS

SCHEMATIC - TANK, PIPING & ACCESSORIES M3.0

#### V129 - STORAGE GYM

M1.0 DEMOLITION AND CONSTRUCTION PLAN

M2.0 SECTION DETAILS

M2.1 2" FUEL LINE SUPPORT DETAILS

M3.0 SCHEMATIC - TANK, PIPING & ACCESSORIES

DEMOLITION AND CONSTRUCTION PLAN

M2.0 SECTION DETAILS

M2.1 2" FUEL LINE SUPPORT DETAILS

M3.0 SCHEMATIC - TANK, PIPING & ACCESSORIES



PROJECT TITLE:
RCMP "V" DIVISION OIL TANK REPLACEMENT - PANGNIRTUNG

TITLE PAGE

16-028-14-30

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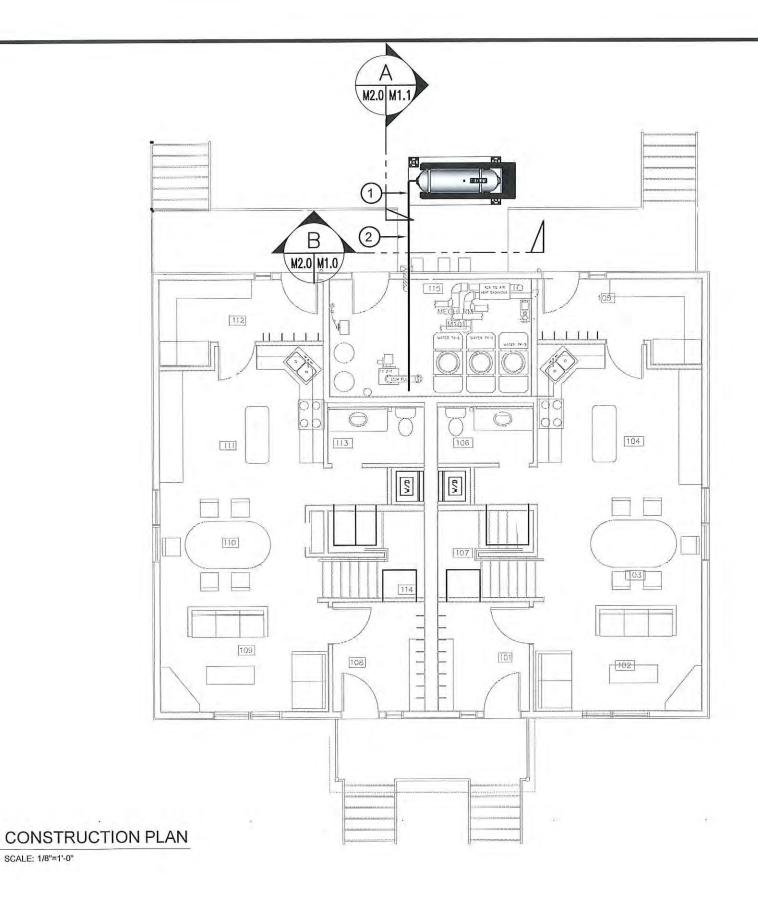
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DATE (YY MM DD) REV. BY

AS NOTED DATE (YY MM DD): 17 01 30

M0.0





CONSTRUCTION NOTES: (#)

- 1. INSTALL NEW PIPING SUPPORT AS PER SHEET M2.1. INSTALL PIPE HANGERS AS REQUIRED TO SUPPORT PIPING UNDER DUPLEX
- 2. REMOVE ALL EXTERIOR VALVES AND REPLACE AS PER SCHEMATIC M3.0
- ADD SPILL CAP AS PER SCHEMATIC M3.0
- ADD SIGNS AND BOLLARDS AS PER ELEVATION M2.0

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M1.0

SCALE: 1/8"=1'-0"

PROJECT NUMBER: 16-028-14-30

PROJECT TITLE: RCMP "V" DIVISION OIL TANK REPLACEMENT V471 - NEW DUPLEX, PANGNIRTUNG SHEET TITLE: CONSTRUCTION PLAN

00 REV.#

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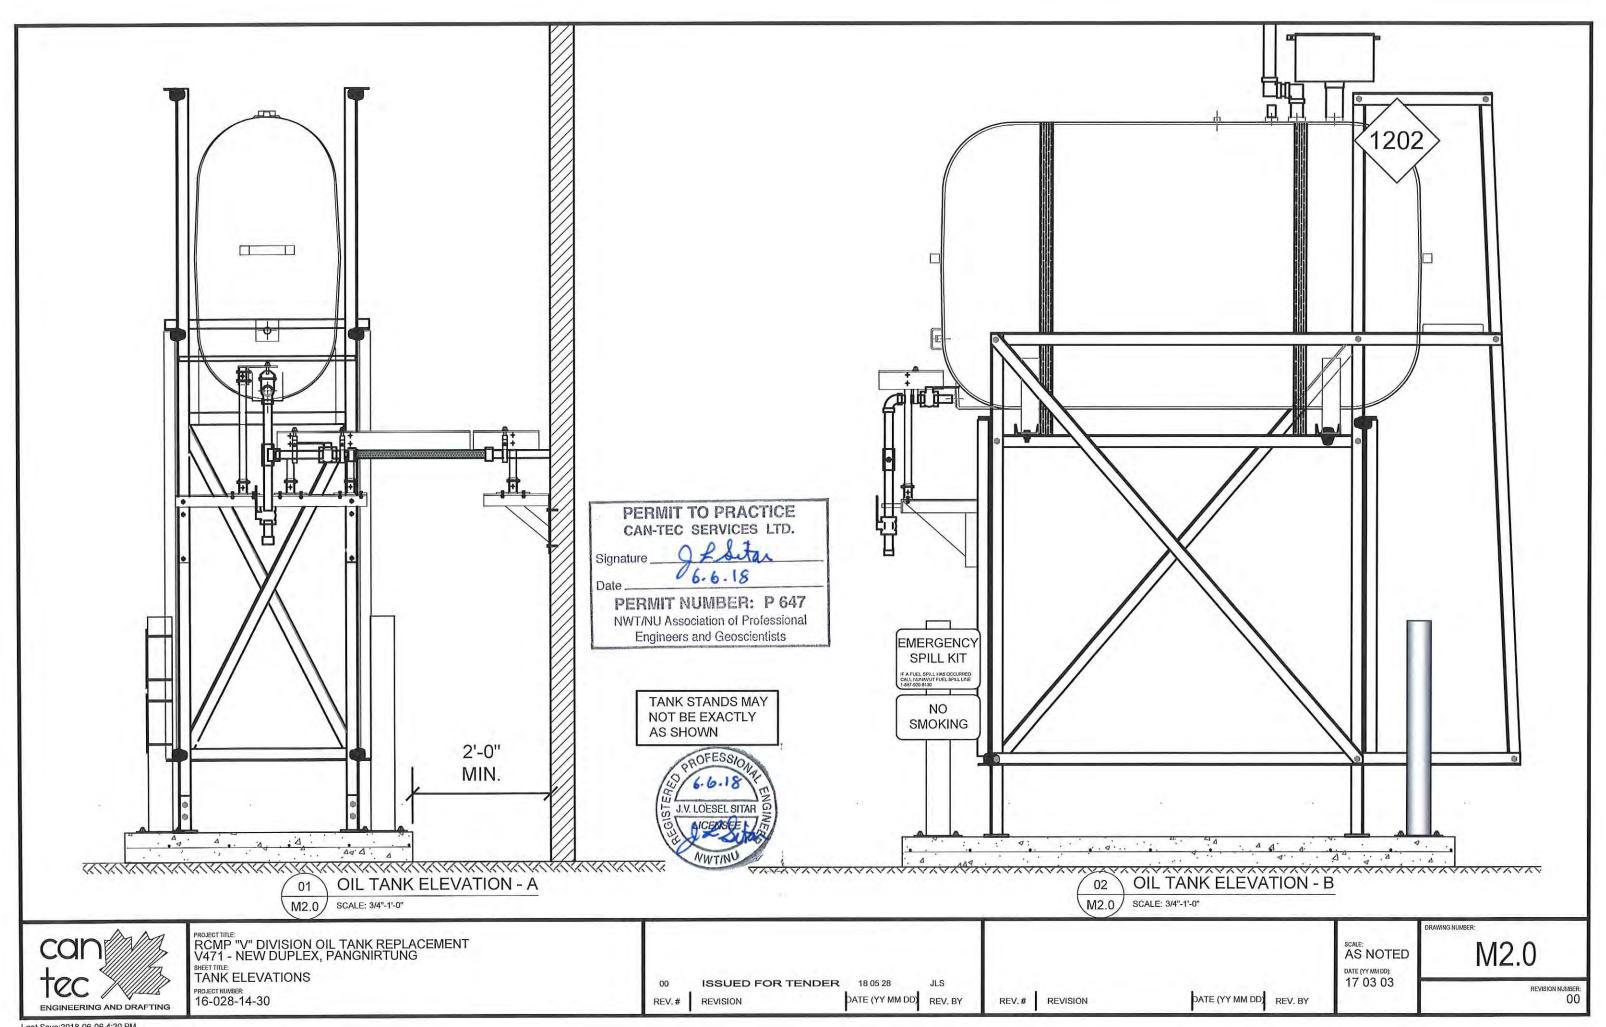
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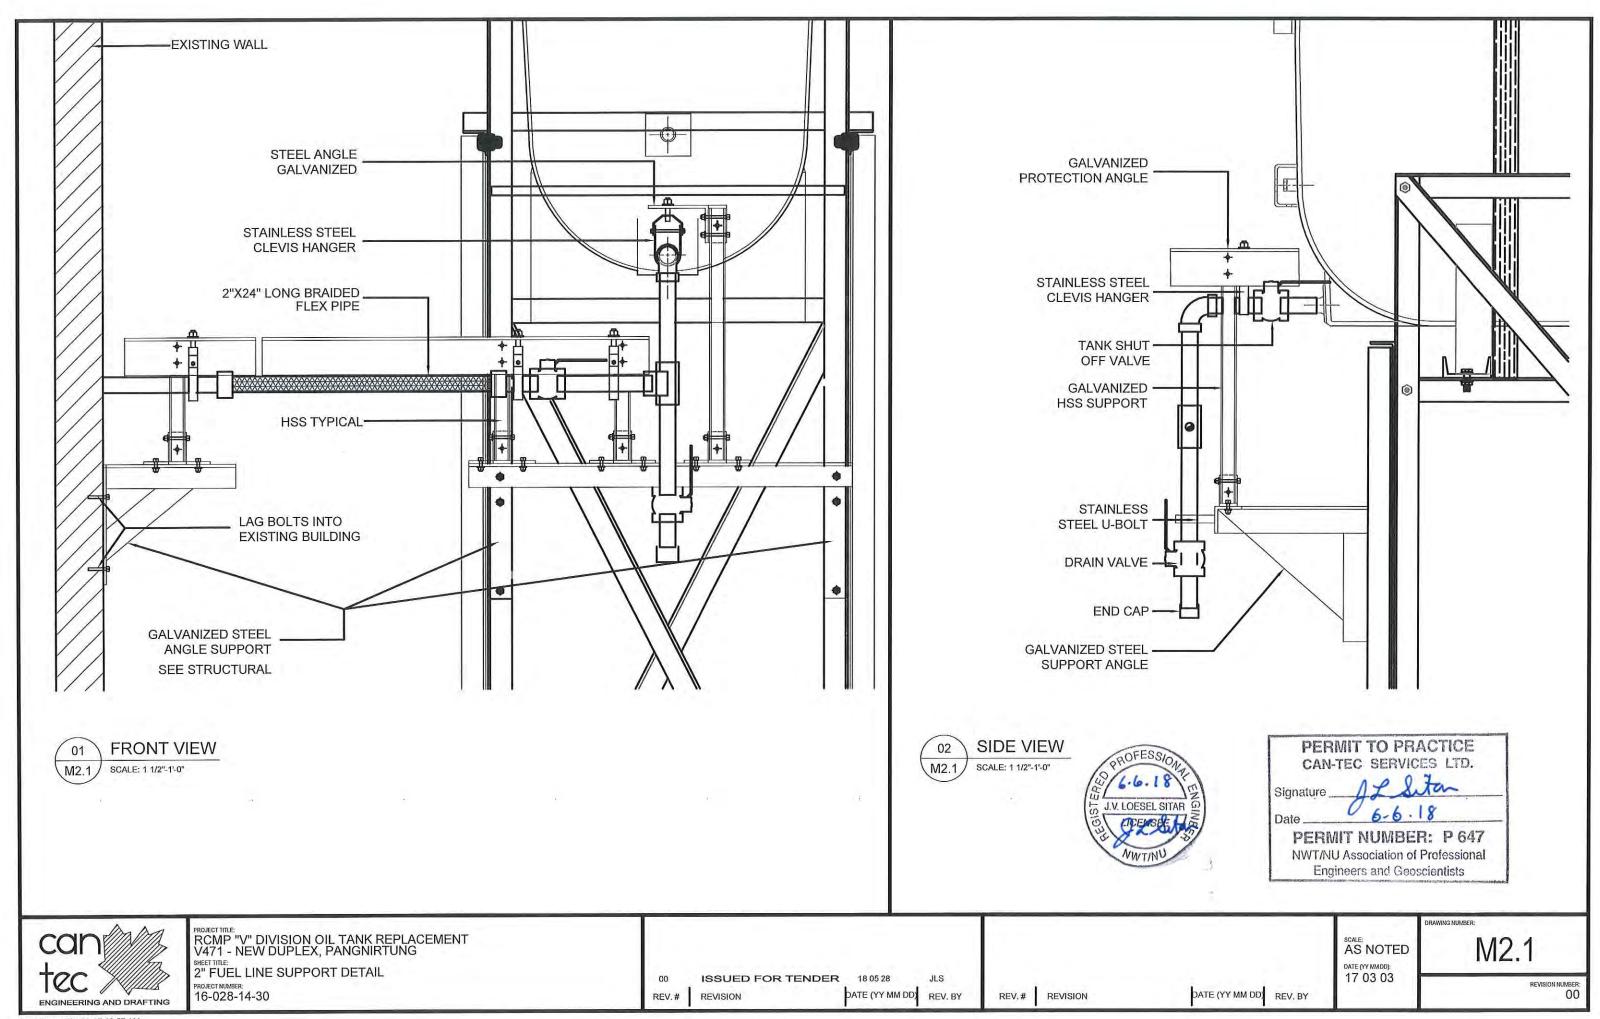
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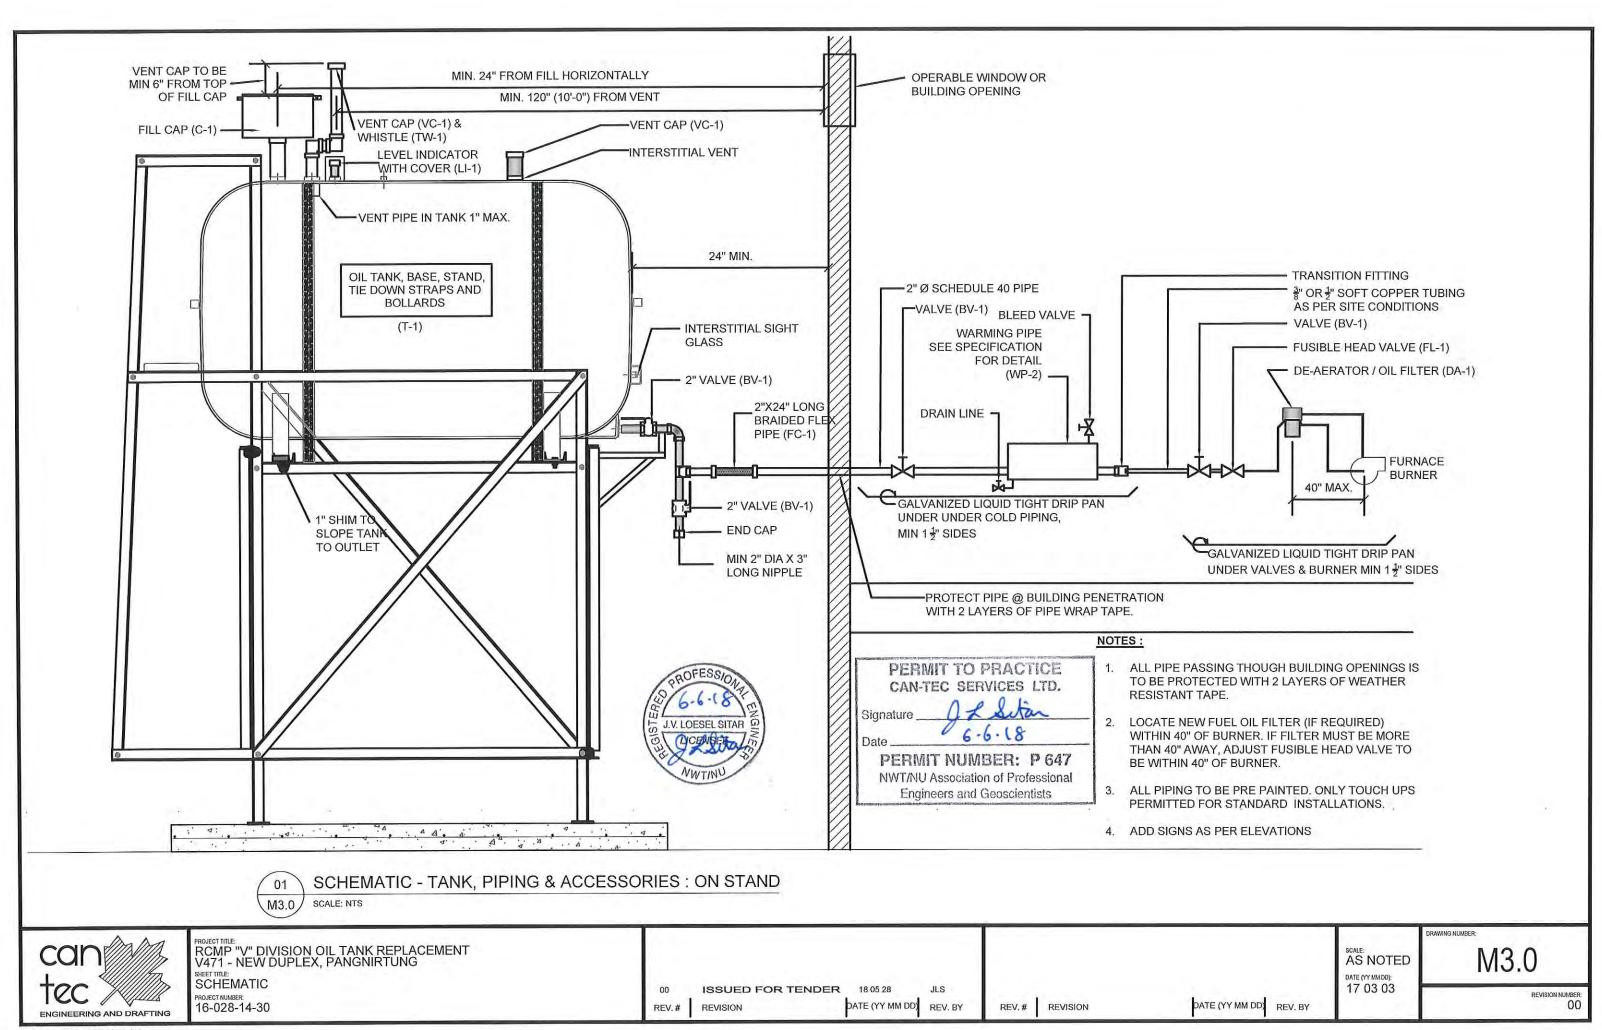
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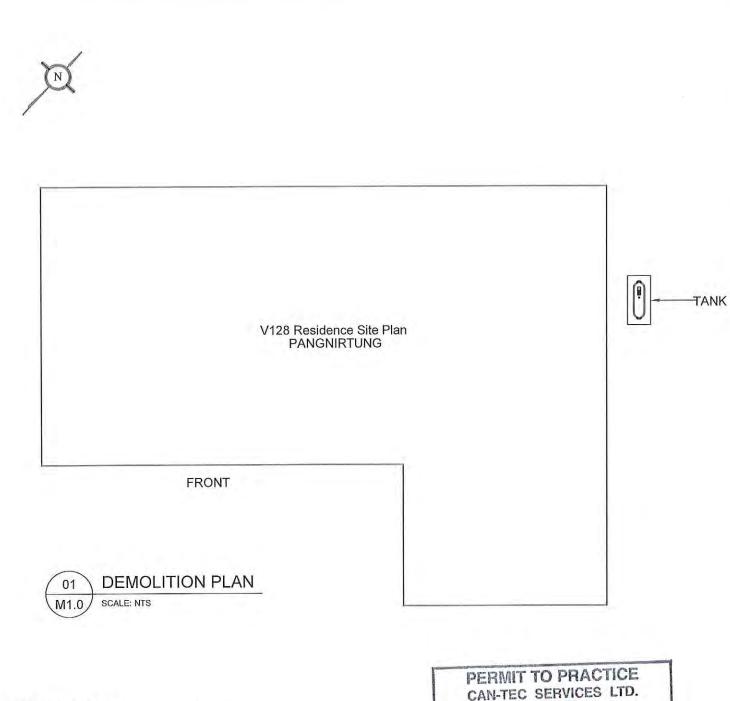




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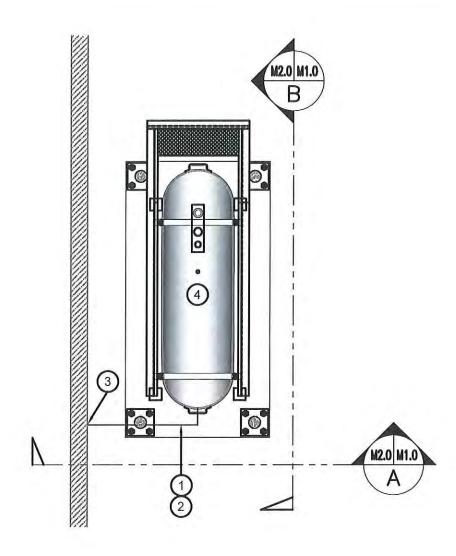
## **DEMOLITION NOTES:**

- 1. REMOVE ALL FUEL FROM THE TANK
- 2. DISCONNECT ALL PIPING FROM THE HOUSE.

Signature 6-6-18 PERMIT NUMBER: P 647 NWT/NU Association of Professional

**Engineers and Geoscientists** 







## CONSTRUCTION NOTES: (#)

- 1. INSTALL NEW PIPING AND PIPE GUARDS TO EDGE OF WALL.
- 2. INSTALL NEW PIPING ACCESSORIES ON TANK.
- INSTALL NEW SUPPORTS AND FLEXIBLE LINK AS PER M2.1 AND M3.0
- 4. MOVE TANK, STAND AND PAD 24" FROM EDGE OF BUILDING AS PER M2.0



PROJECT TITLE.
RCMP "V" DIVISION OIL TANK REPLACEMENT
V128 - RESIDENCE SITE PLAN, PANGNIRTUNG SHEET TITLE:
DEMOLITION AND CONSTRUCTION PROJECT NUMBER: 16-028-14-30

ISSUED FOR TENDER 18 05 28 REVISION

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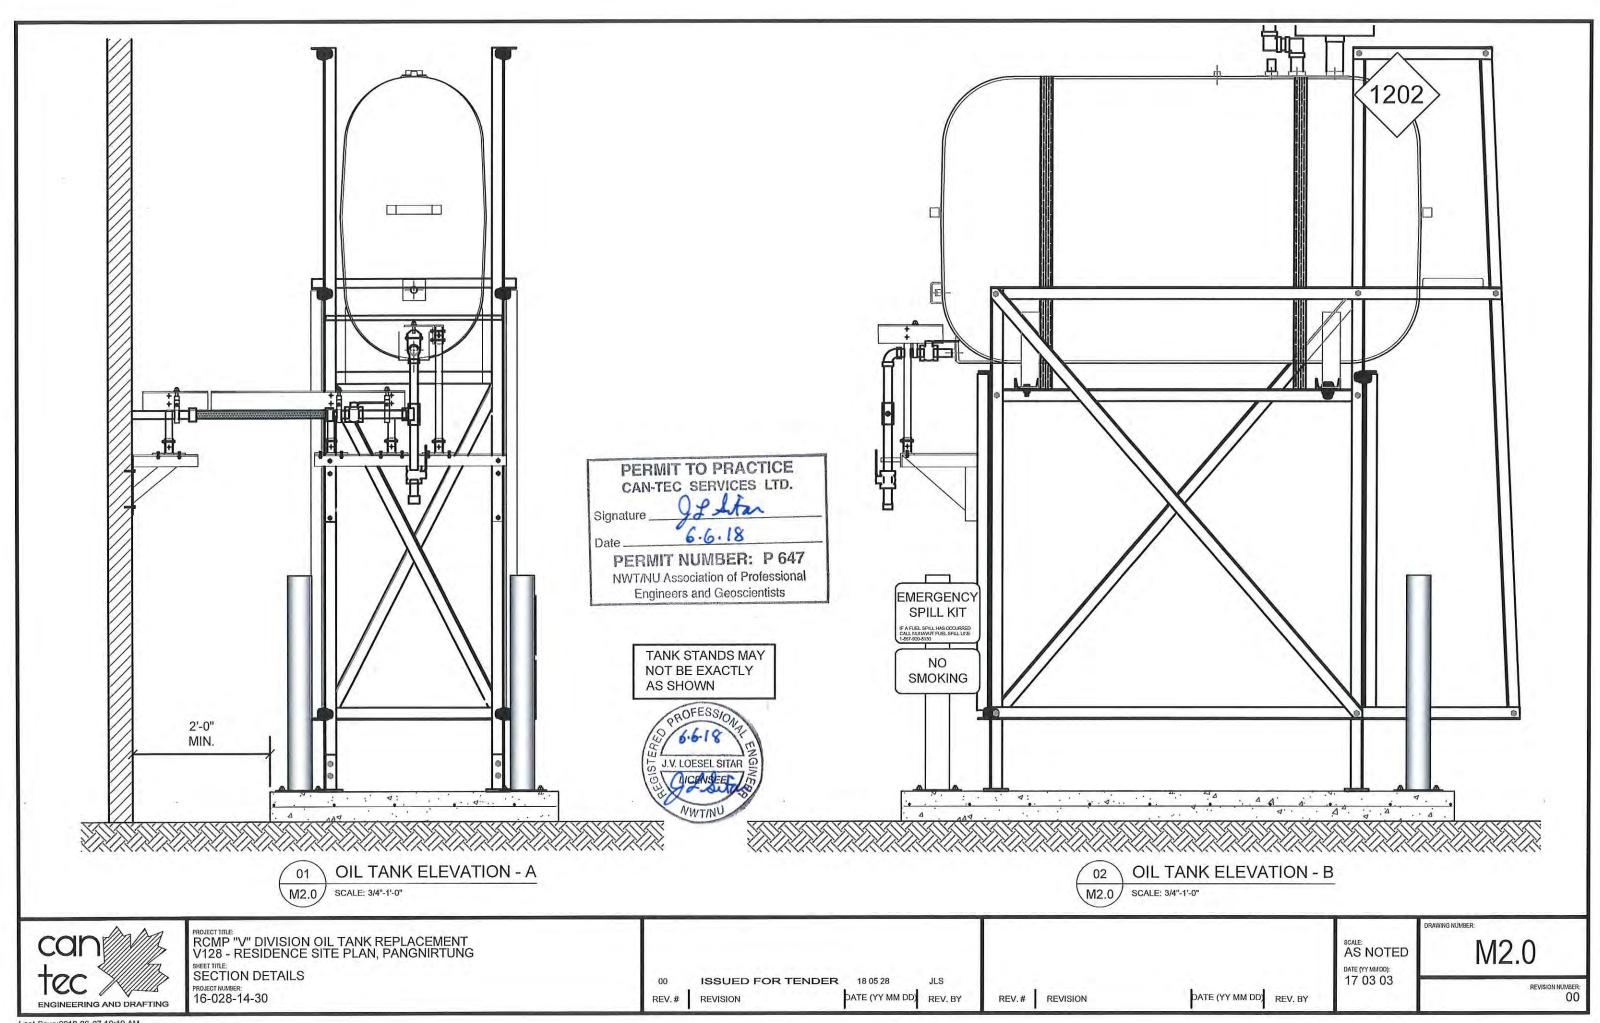
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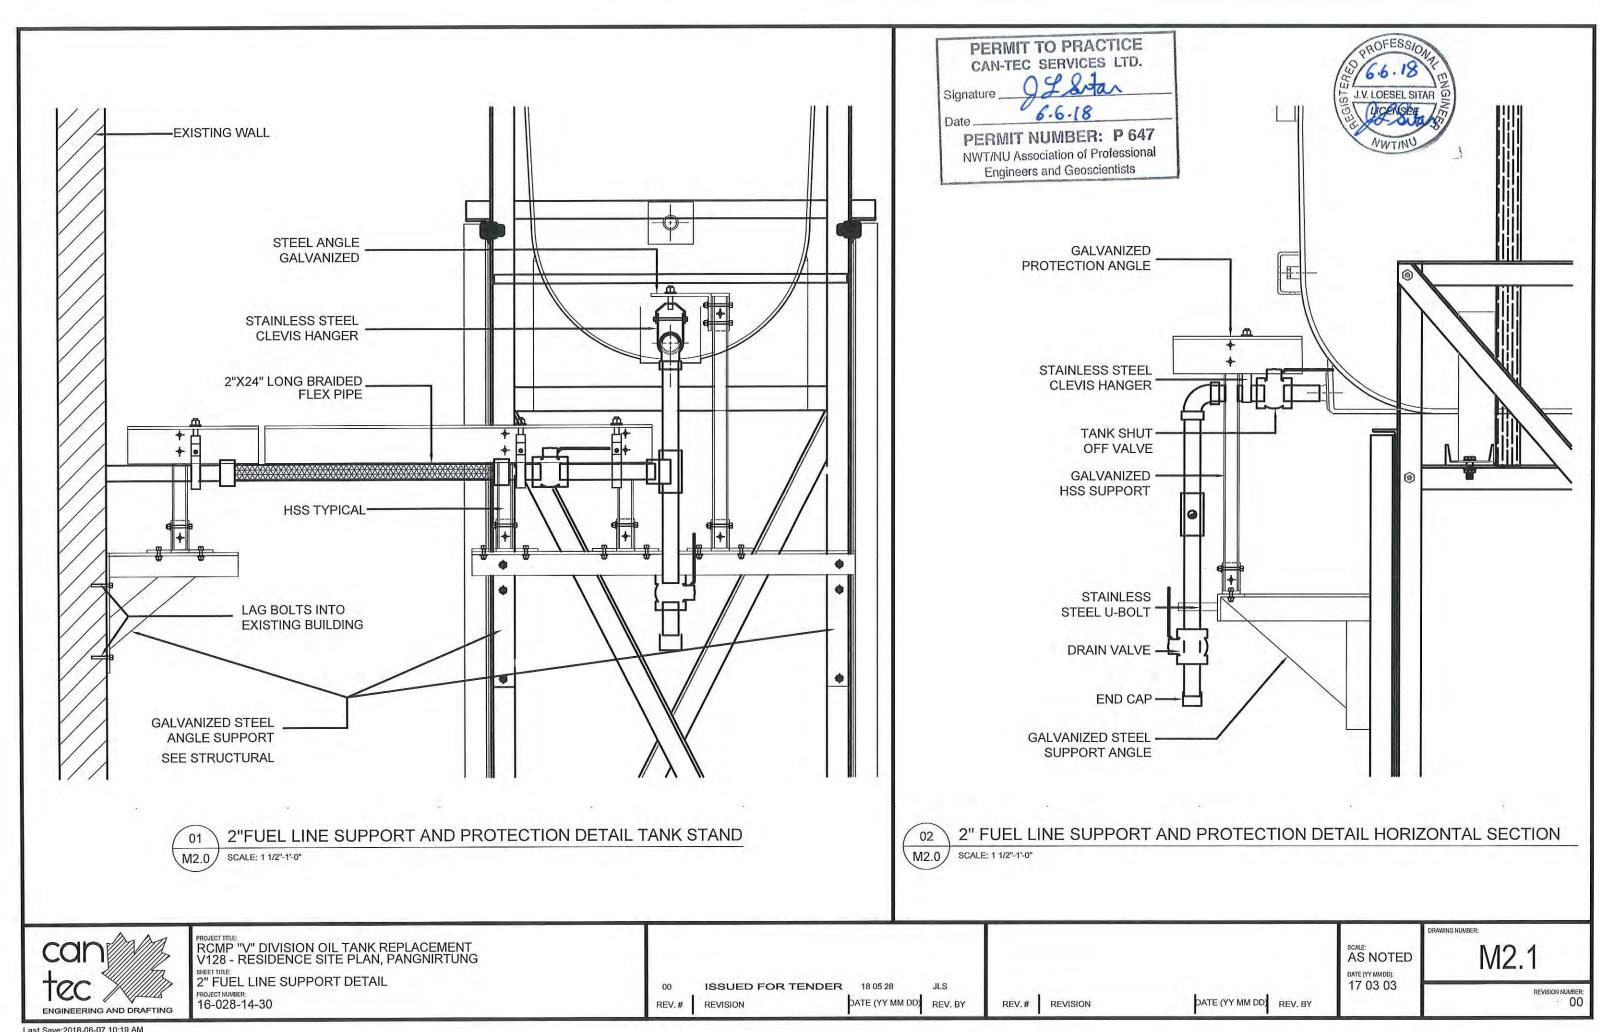
AS NOTED M1.0

REVISION NUMBER:

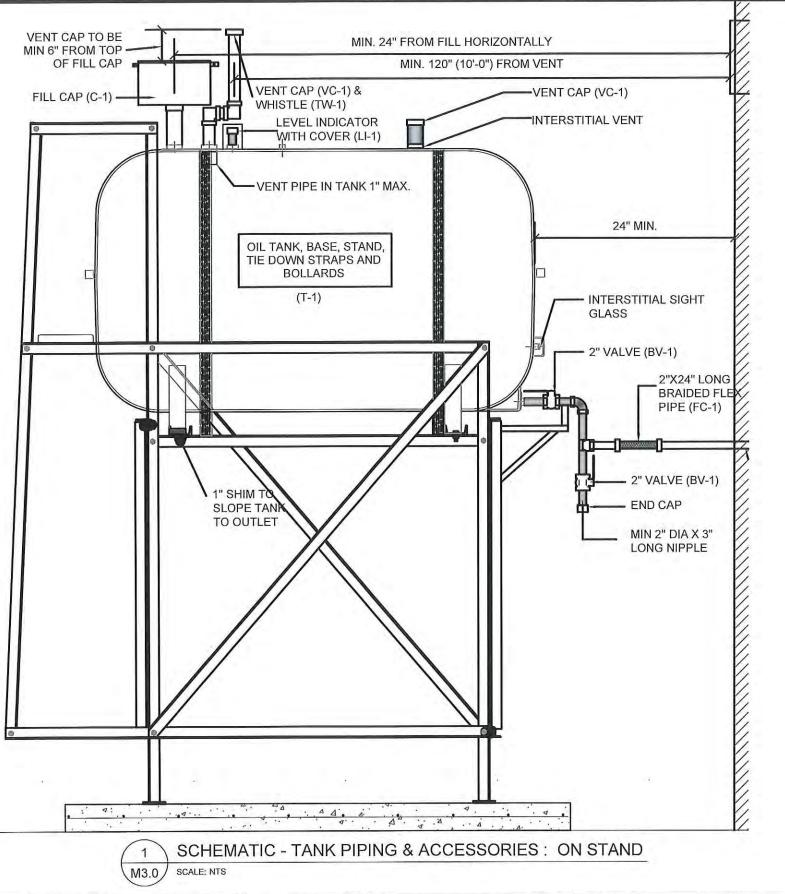
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#### NOTES:

- INSTALL ALL NEW ACCESSORIES TO TOP OF TANK
- REMOVE EXISTING FLEXIBLE LINK AND INSTALL NEW FLEXIBLE
- REMOVE ALL EXISTING VALVES AND INSTALL NEW VALVES AS SHOWN. EXISTING VALVES ARE NOT TO SPECIFICATION



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RCMP "V" DIVISION OIL TANK REPLACEMENT V128 RESIDENCE, PANGNIRTUNG SCHEMATIC - TANK, PIPING & ACCESSORIES PROJECT NUMBER: 16-028-14-30

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REV.# REVISION

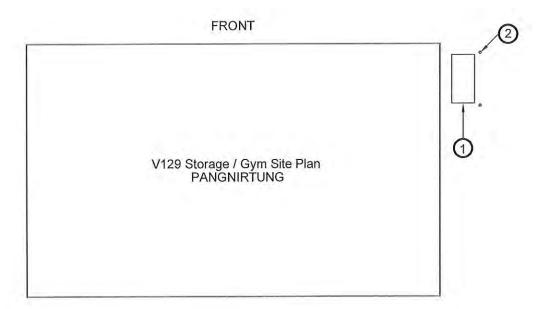
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M3.0

REVISION NUMBER:

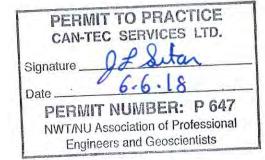


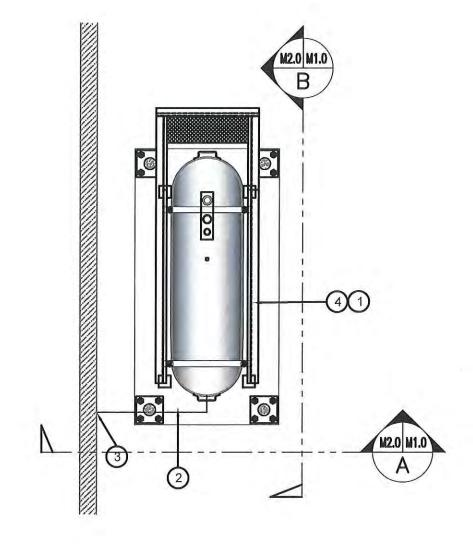




## **DEMOLITION NOTES:**

- REMOVE ALL FUEL FROM THE TANK
- DISCONNECT ALL PIPING FROM THE GYM
- 3. SALVAGE EXISTING FIBERGLASS TANK.









## **CONSTRUCTION NOTES:**

- INSTALL SALVAGED OIL TANK, AND CONCRETE PAD. SEE SHEET M2.0.
- INSTALL NEW PIPING SUPPORT AS PER SHEET M2.1
- CAULK ENTRY INTO BUILDING.
- INSTALL NEW TANK STAND #2 SEE STRUCTURAL FOR DETAILS.

## NOTES:

DATE (YY MM DD) REV. BY

- 1. INSTALL NEW ACCESSORIES TO TANK AND FURNACE AS PER SHEET M3.0
- 2. RE-USE EXISTING FIBERGLASS TANK IN NEW STAND



RCMP "V" DIVISION OIL TANK REPLACEMENT V129 - STORAGE GYM, PANGNIRTUNG SHEET TITLE:
DEMOLITION AND CONSTRUCTION

REV.#

ISSUED FOR TENDER 18 05 28 REVISION

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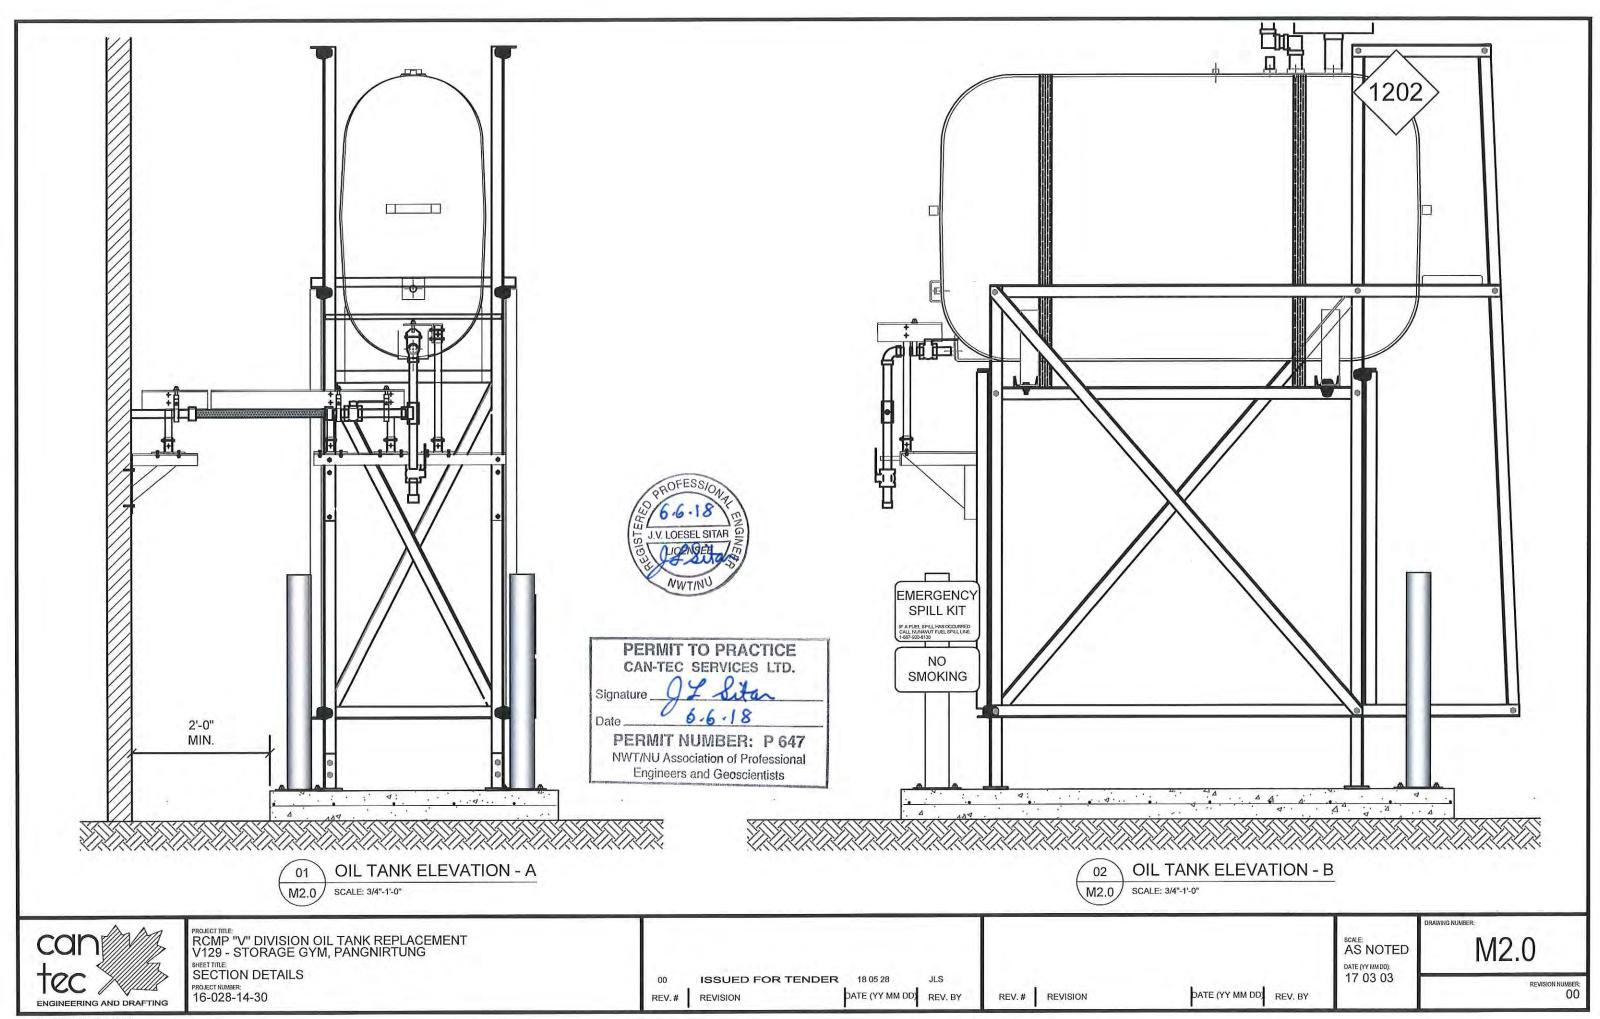
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M1.0

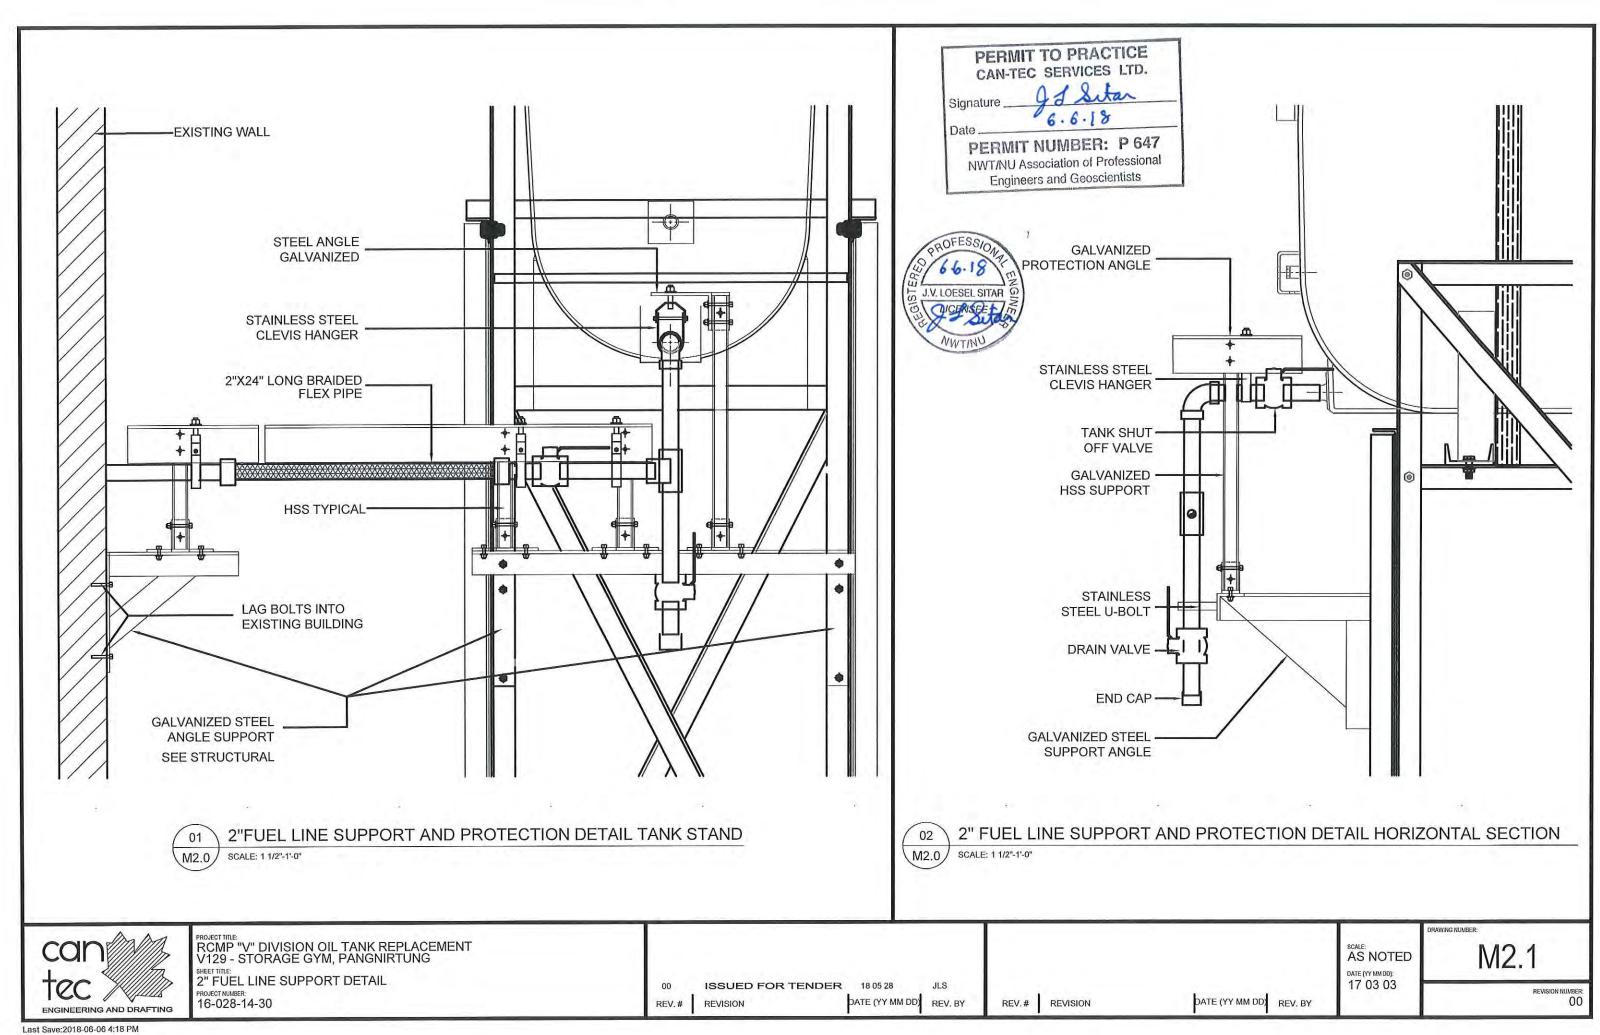
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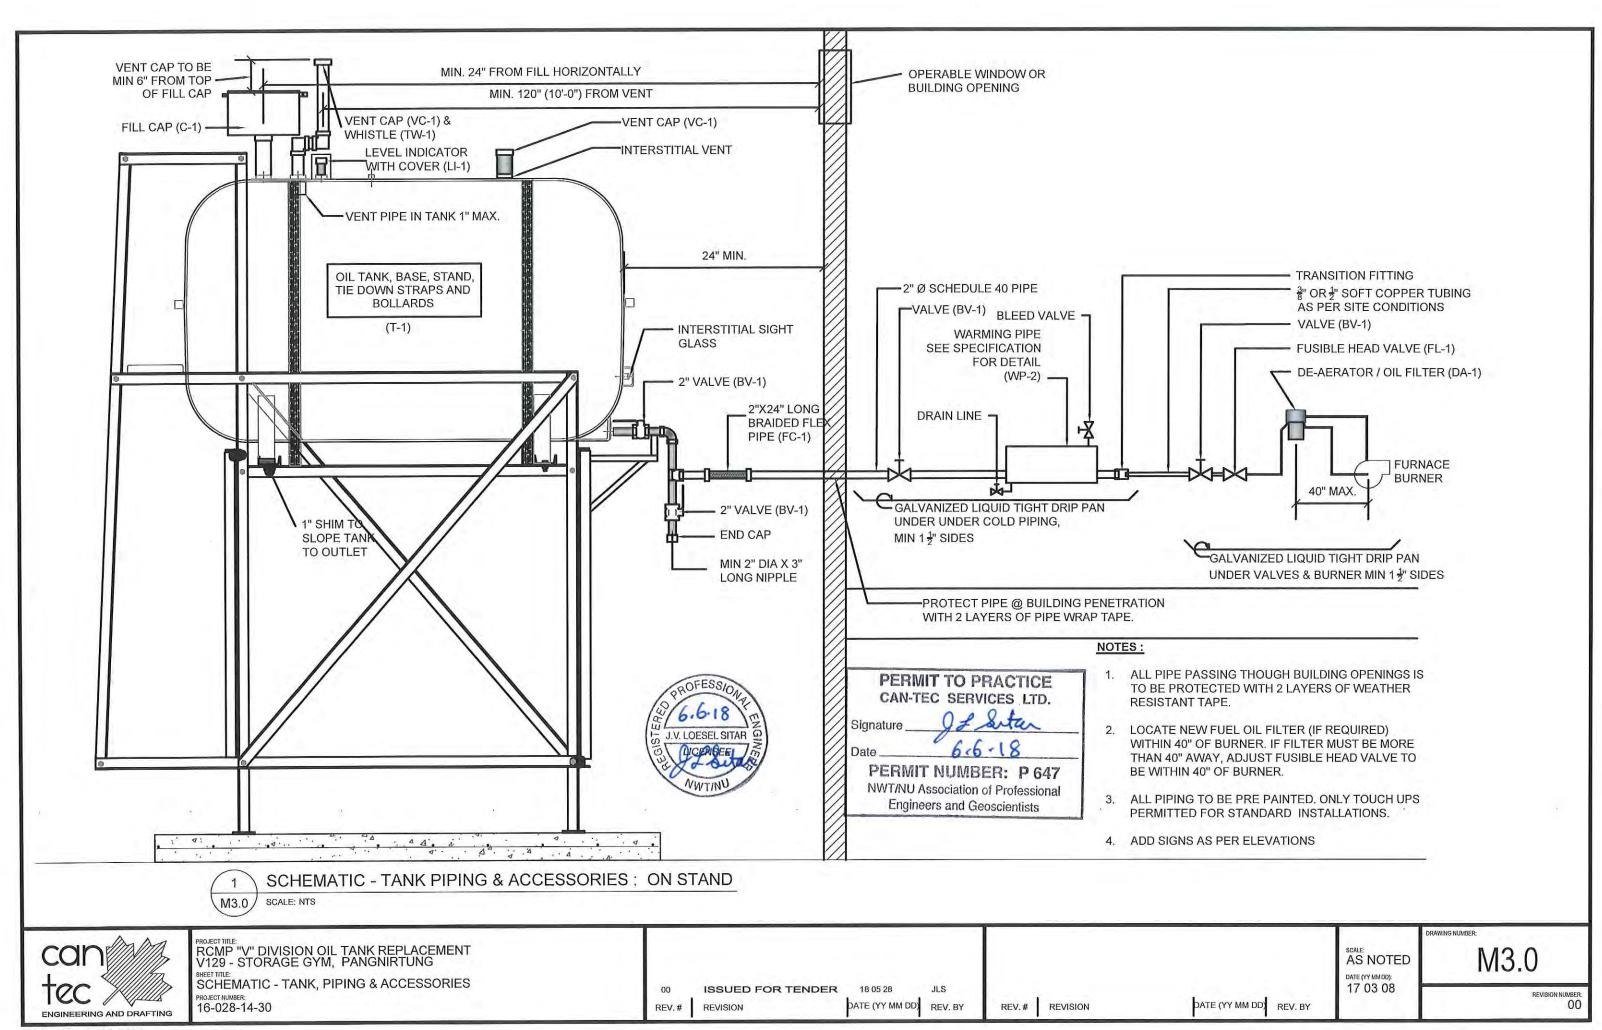
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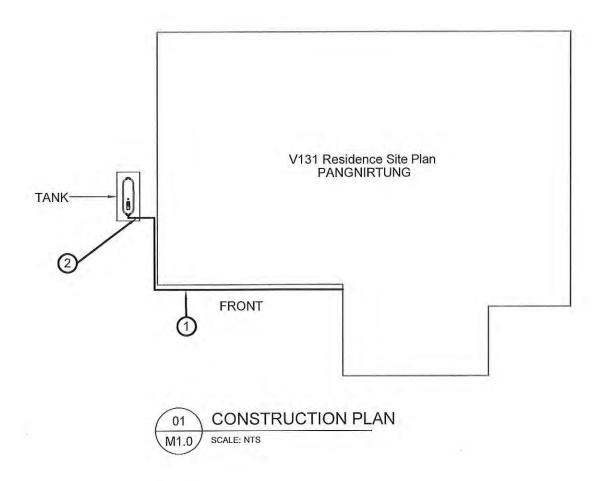
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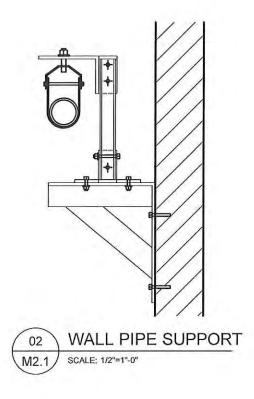




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#### **DEMOLITION NOTES:**

1. REMOVE ALL FUEL FROM THE TANK AND DISPOSE OF AS PER LOCAL REGULATIONS

## CONSTRUCTION NOTES: (#)

1. INSTALL NEW PIPE SUPPORT TO 2" PIPING ALONG THE SIDE OF THE HOUSE SEE DETAIL THIS SHEET

2. INSTALL NEW PIPING SUPPORTS TO EXISTING STAND AS PER DRAWINGS M2.0 AND M2.1

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RCMP "V" DIVISION OIL TANK REPLACEMENT - PANGNIRTUNG V131 - RESIDENCE SITE PLAN, PANGNIRTUNG

DEMOLITION AND CONSTRUCTION

PROJECT NUMBER: 16-028-14-30

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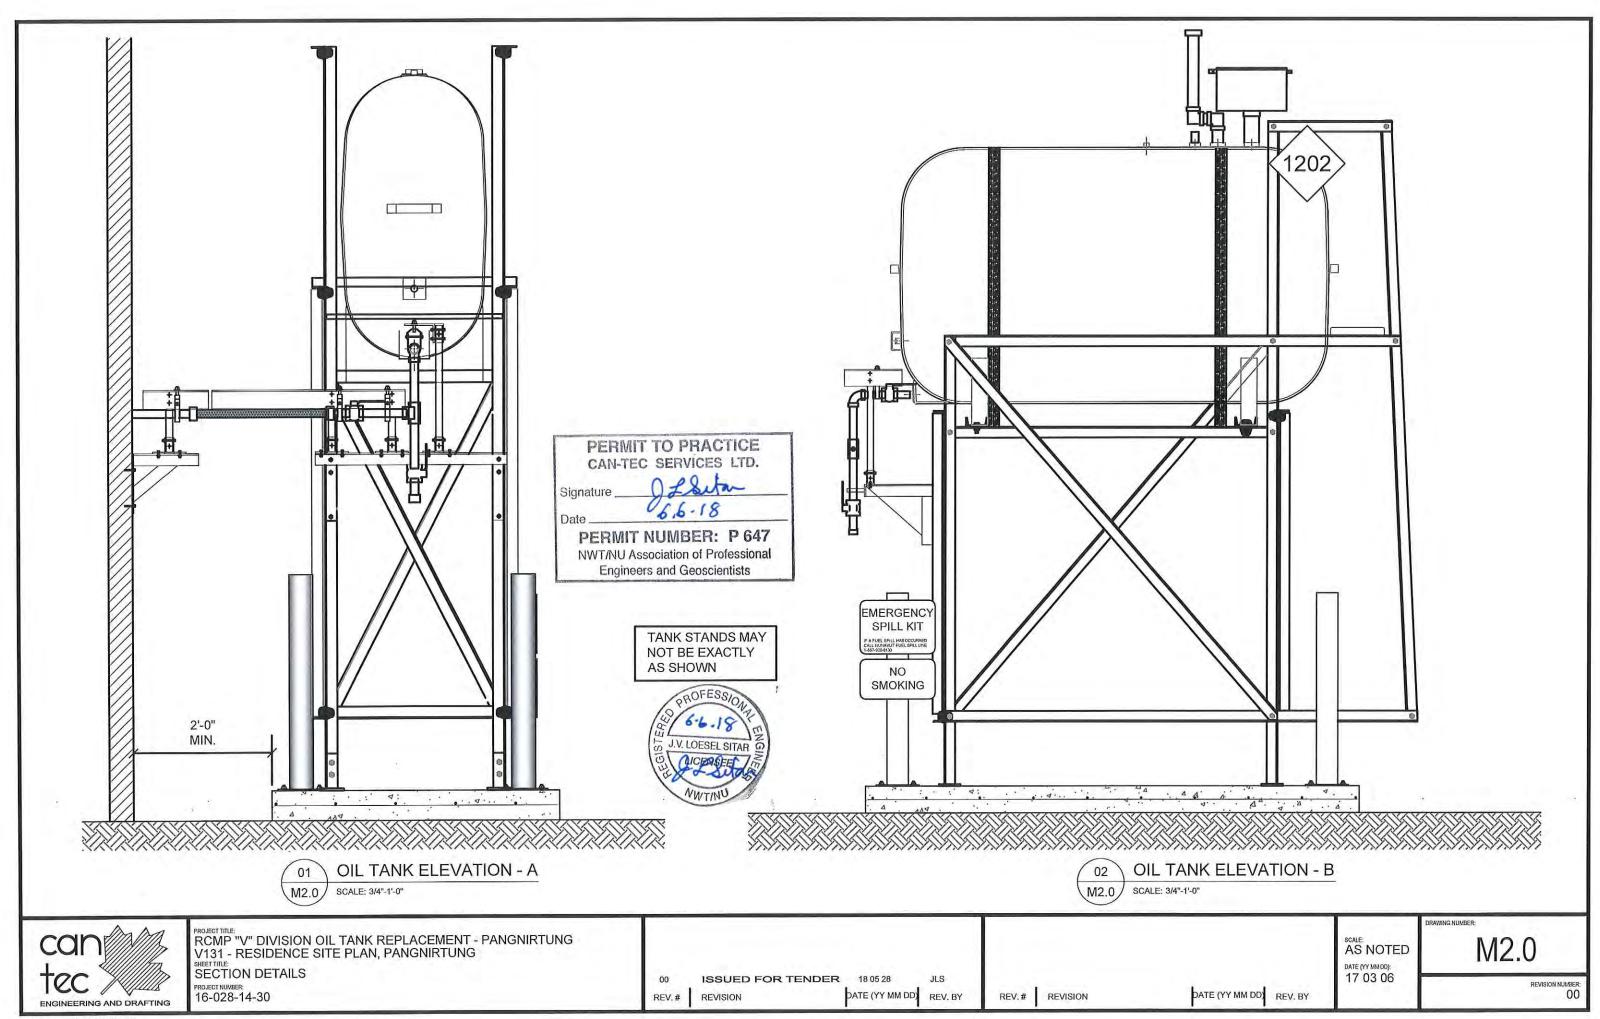
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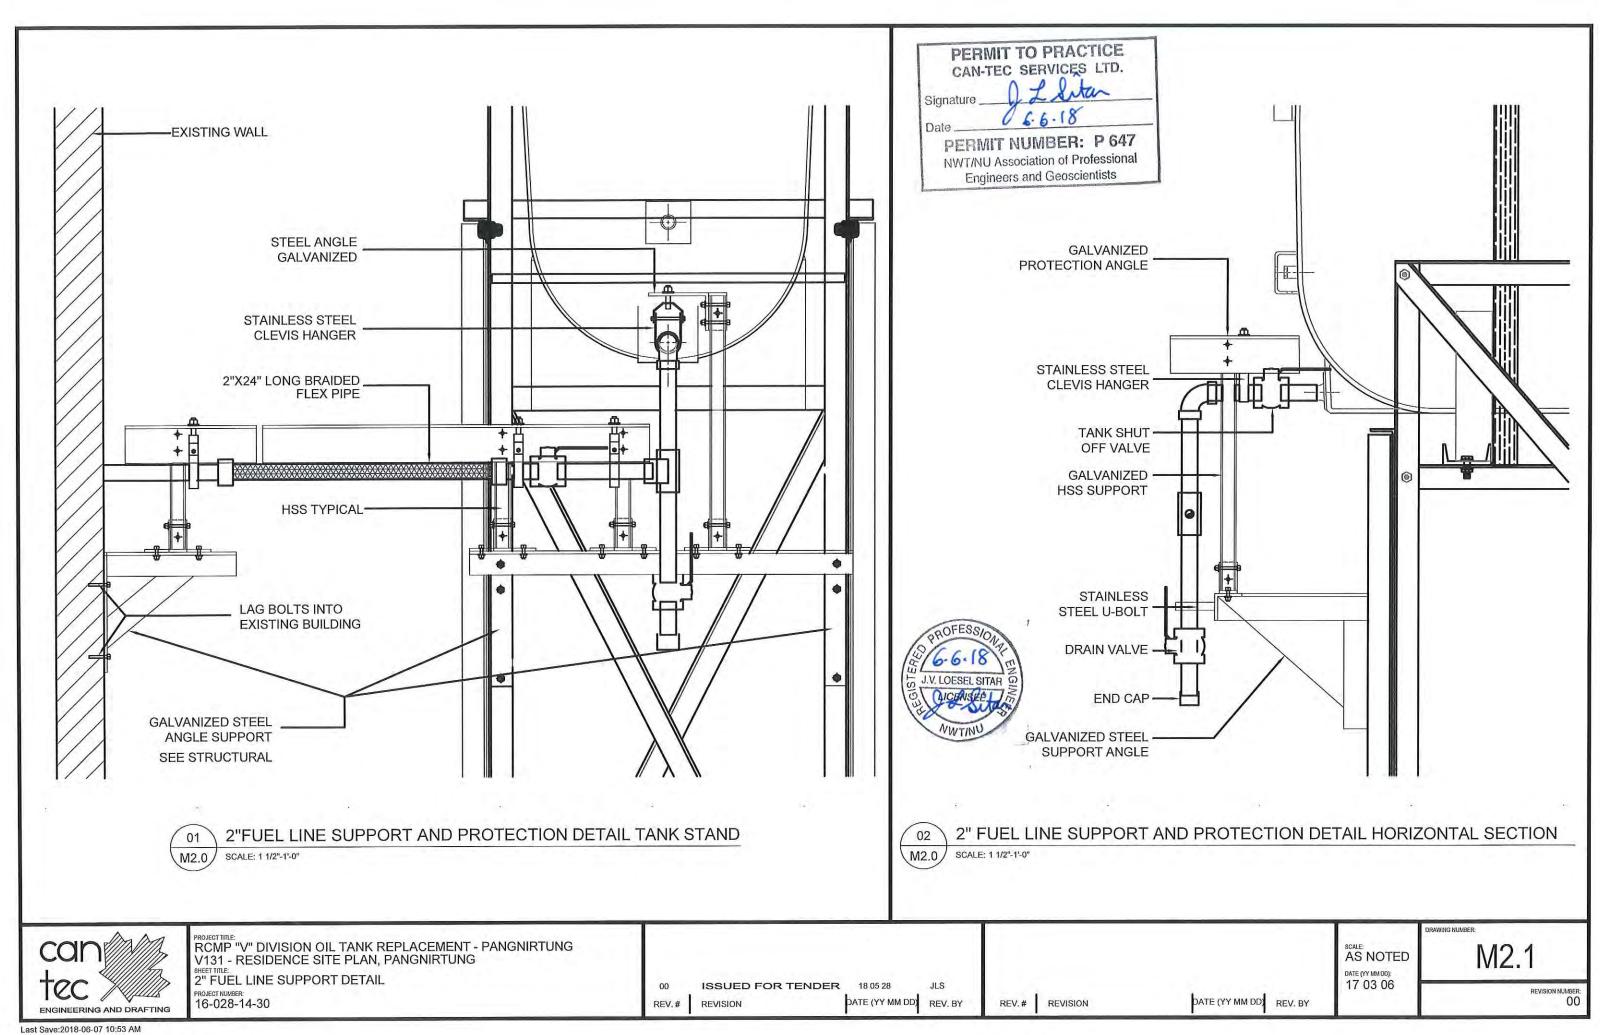
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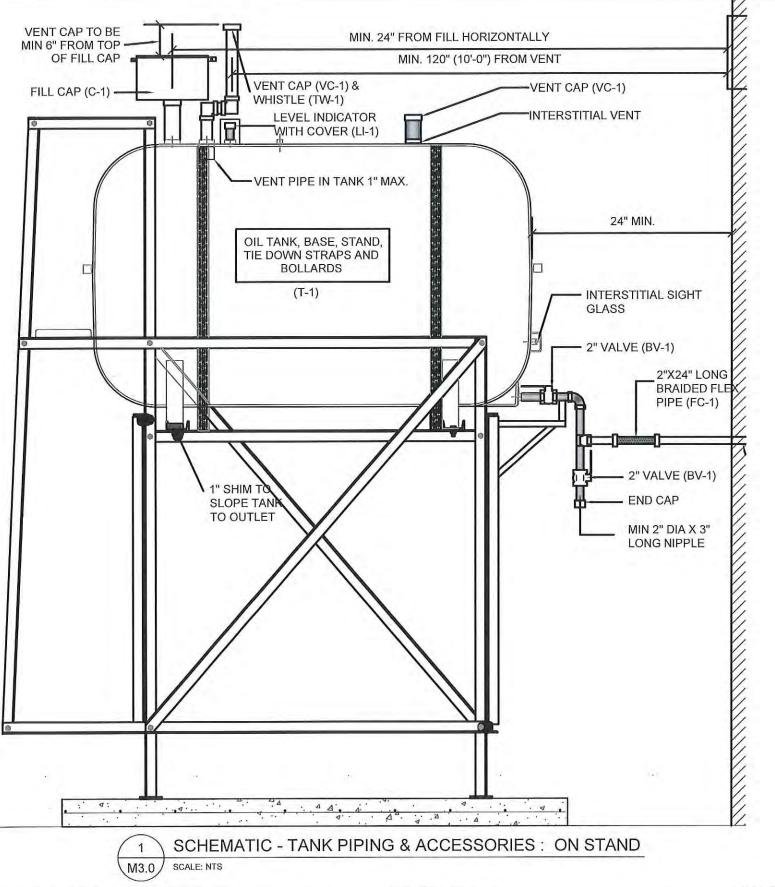
M1.0

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#### NOTES:

- INSTALL ALL NEW ACCESSORIES TO TOP OF TANK
- REMOVE EXISTING FLEXIBLE LINK AND INSTALL NEW FLEXIBLE
- REMOVE ALL EXISTING VALVES AND INSTALL NEW VALVES AS SHOWN. EXISTING VALVES ARE THE NOT TO SPECIFICATION

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RCMP "V" DIVISION OIL TANK REPLACEMENT V131 RESIDENCE, PANGNIRTUNG SCHEMATIC - TANK, PIPING & ACCESSORIES PROJECT NUMBER: 16-028-14-30

ISSUED FOR TENDER REV.# REVISION

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REV.# REVISION

AS NOTED DATE (YY MM DD): 17 03 08

M3.0

REVISION NUMBER:

# FUEL TANK REPAIR AND REPLACEMENT PROJECT KIMMIRUT, NUNAVUT

## **DRAWING LIST:**

## V289 - RESIDENCE

M1.0 **DEMOLITION & CONSTRUCTION PLAN** 

M2.0 TANK ELEVATIONS

2" FUEL LINE SUPPORT DETAILS M2.1

M3.0 SCHEMATIC - TANK, PIPING & ACCESSORIES

### V026 - GARAGE

**DEMOLITION & CONSTRUCTION PLAN** M1.0

M2.0 TANK ELEVATIONS

2" FUEL LINE SUPPORT DETAILS M2.1

SCHEMATIC - TANK, PIPING & ACCESSORIES

#### V293 - FACILITY BUILDING

**DEMOLITION & CONSTRUCTION PLAN** 

M2.0 TANK ELEVATIONS

2" FUEL LINE SUPPORT DETAILS M2.1

SCHEMATIC - TANK, PIPING & ACCESSORIES



PROJECT TITLE:
RCMP "V" DIVISION OIL TANK REPLACEMENT, KIMMIRUT

TITLE PAGE

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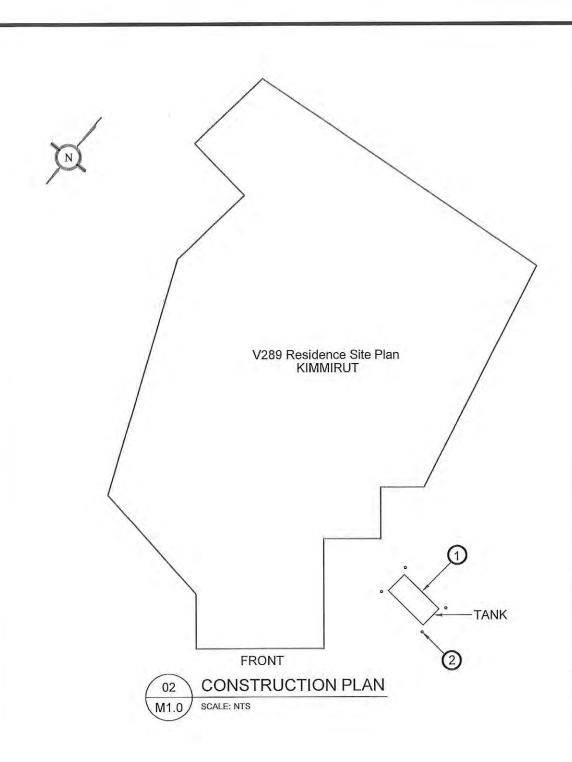
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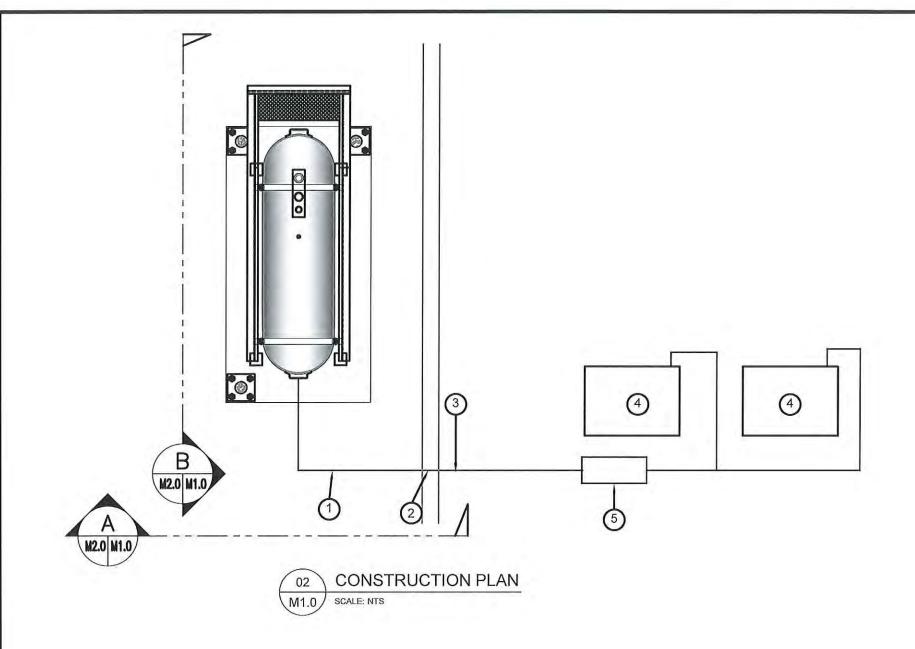
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M0.0



## **DEMOLITION NOTES:**

- 1. REMOVE ALL FUEL FROM THE EXISTING STEEL FUEL
- 2. EXISTING FUEL TANK, STAND AND CONCRETE BASE IS RETAINED FOR RE-INSTALLATION. REMOVE ALL ACCESSORIES TO BOILERS



## REPAIR NOTES:

- 1. REMOVE ALL ACCESSORIES AND INSTALL ALL NEW ACCESSORIES ON FUEL TANKS AND BOILER SEE DRAWING M3.0 FOR DETAILS.
- 2. TANK, STAND AND CONCRETE PAD IS TO BE SALVAGED ALL OTHER EQUIPMENT IS TO BE INSTALLED AS NEW.
- 3. ADJUST LOCATION OF CONCRETE PAD AS PER ATTACHED DETAILS FOR SEPARATION FROM BUILDING

## CONSTRUCTION NOTES: (#)

- 1. INSTALL NEW PIPING SUPPORT AS PER SHEET M2.1, ALSO PROVIDE SUPPORT FOR FILLGAUGE LINE.
- 2. CAULK ENTRY INTO BUILDING.
- 3. INSTALL NEW 2" DIA PIPE
- 4. EXISTING BOILER5. NEW DAY TANK

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PERMIT NUMBER: P 647 NWT/NU Association of Professional Engineers and Geoscientists





PROJECT TITLE:
RCMP "V" DIVISION OIL TANK REPLACEMENT - KIMMIRUT V289 - RESIDENCE

SHEETITILE:
DEMOLITION AND CONSTRUCTION PLAN

16-028-14-30

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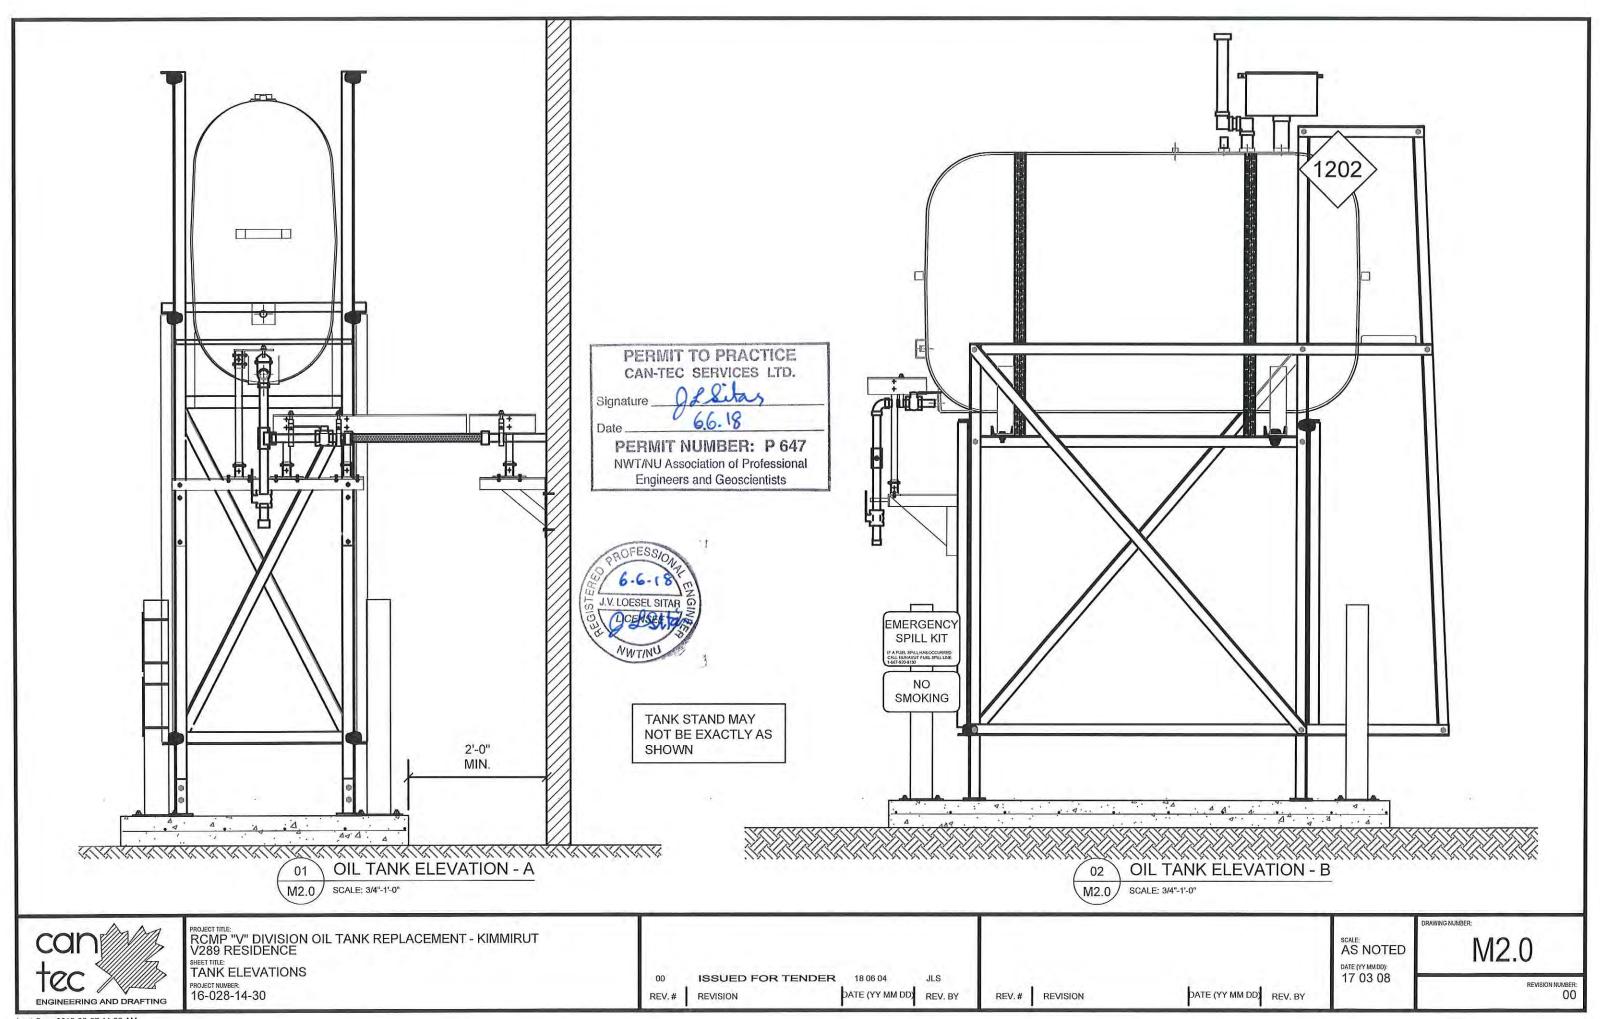
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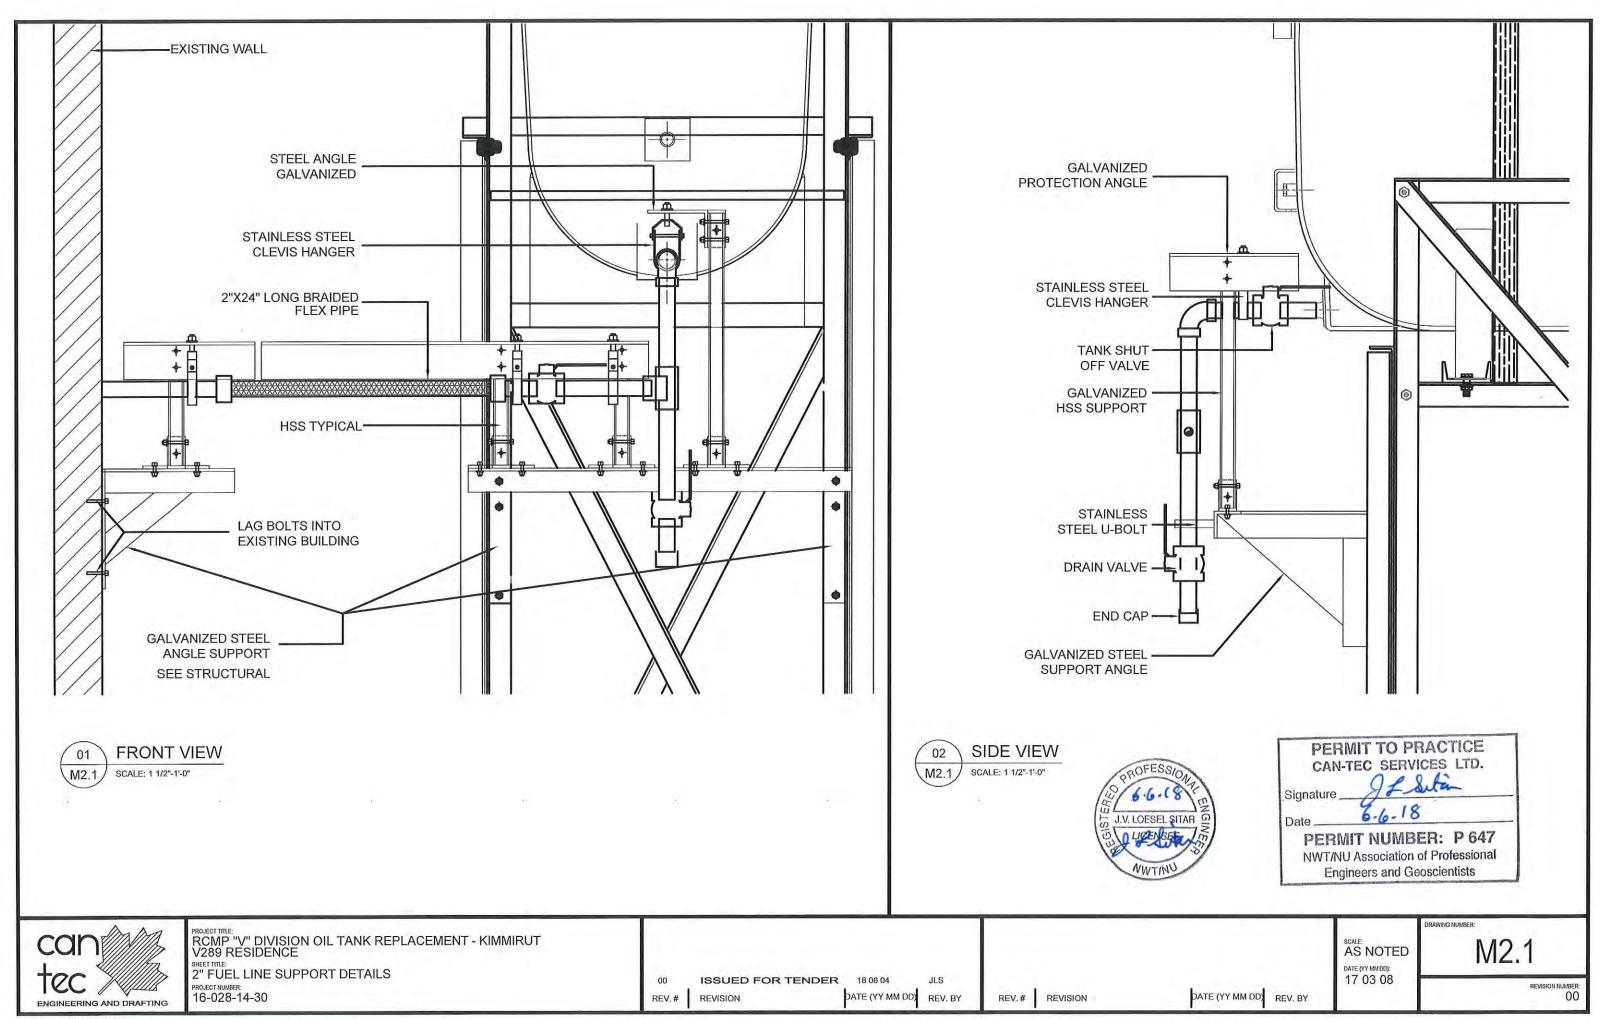
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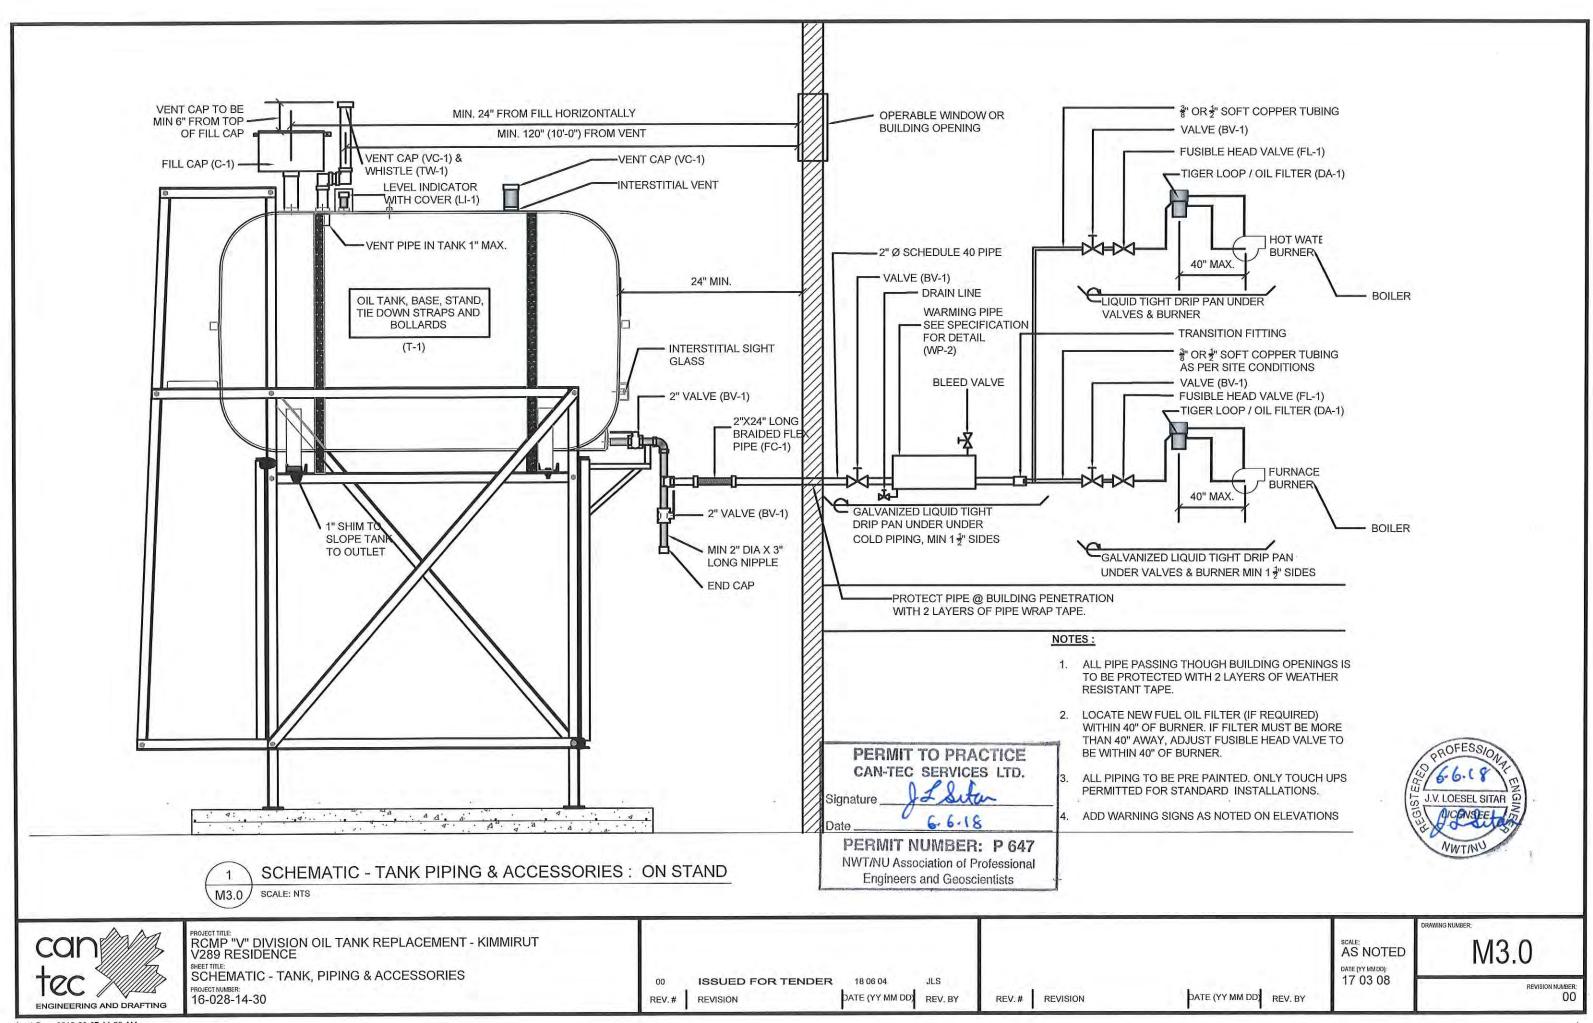
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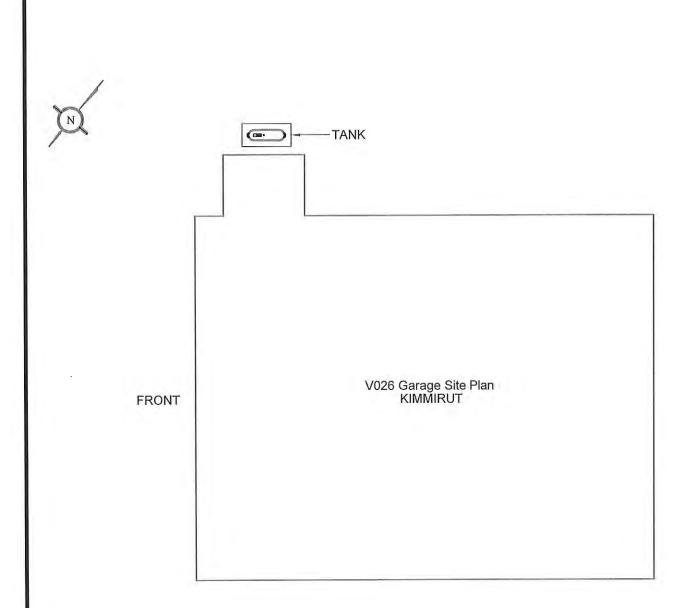




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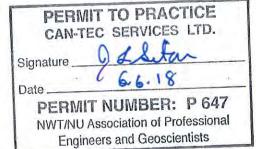
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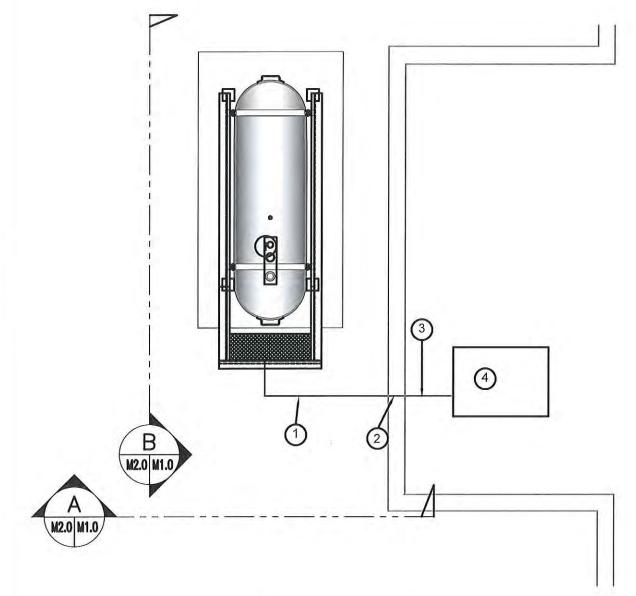




### **DEMOLITION NOTES:**

- REMOVE ALL ASSOCIATED PIPING FROM TANK TO FURNACE IN GARAGE
- 2. REMOVE ALL FUEL FROM TANK.





02 CONSTRUCTION PLAN
M1.0 SCALE: NTS

## REPAIR NOTES:

- REMOVE ALL ACCESSORIES AND INSTALL ALL NEW ACCESSORIES ON FUEL TANKS AND FURNACE SEE DRAWING M3.0 FOR DETAILS.
- ONLY TANK, CONCRETE PAD AND STAND IS TO BE SALVAGED ALL OTHER EQUIPMENT IS TO BE INSTALLED AS NEW.
- 3. ADJUST LOCATION OF CONCRETE PAD AS PER ATTACHED DETAILS.

CONSTRUCTION NOTES: (#)



- 1. INSTALL NEW PIPING SUPPORT AS PER SHEET M2.1
- 2. CAULK ENTRY INTO BUILDING.
- 3. INSTALL NEW 2" DIA PIPE
- 4. EXISTING FURNACE





PROJECT TITLE: RCMP "V" DIVISION OIL TANK REPLACEMENT - KIMMIRUT V026 - GARAGE, KIMMIRUT

SHEET TITLE:
DEMOLITION & CONSTRUCTION PLAN

PROJECT NUMBER: 16-028-14-30

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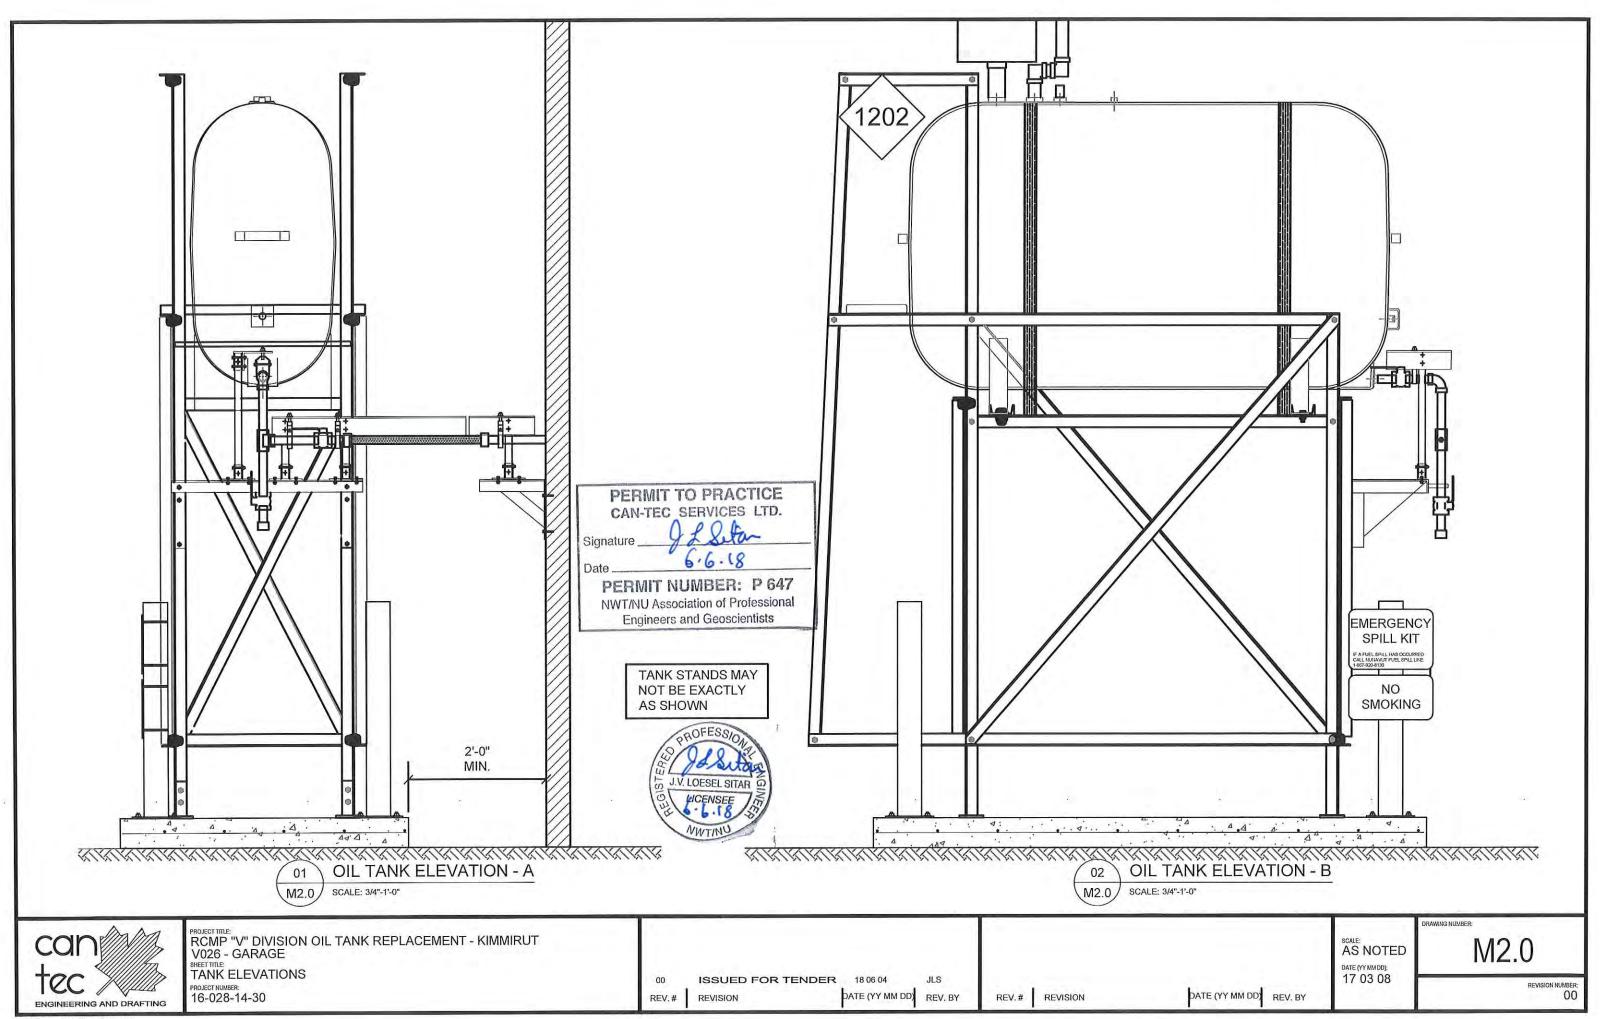
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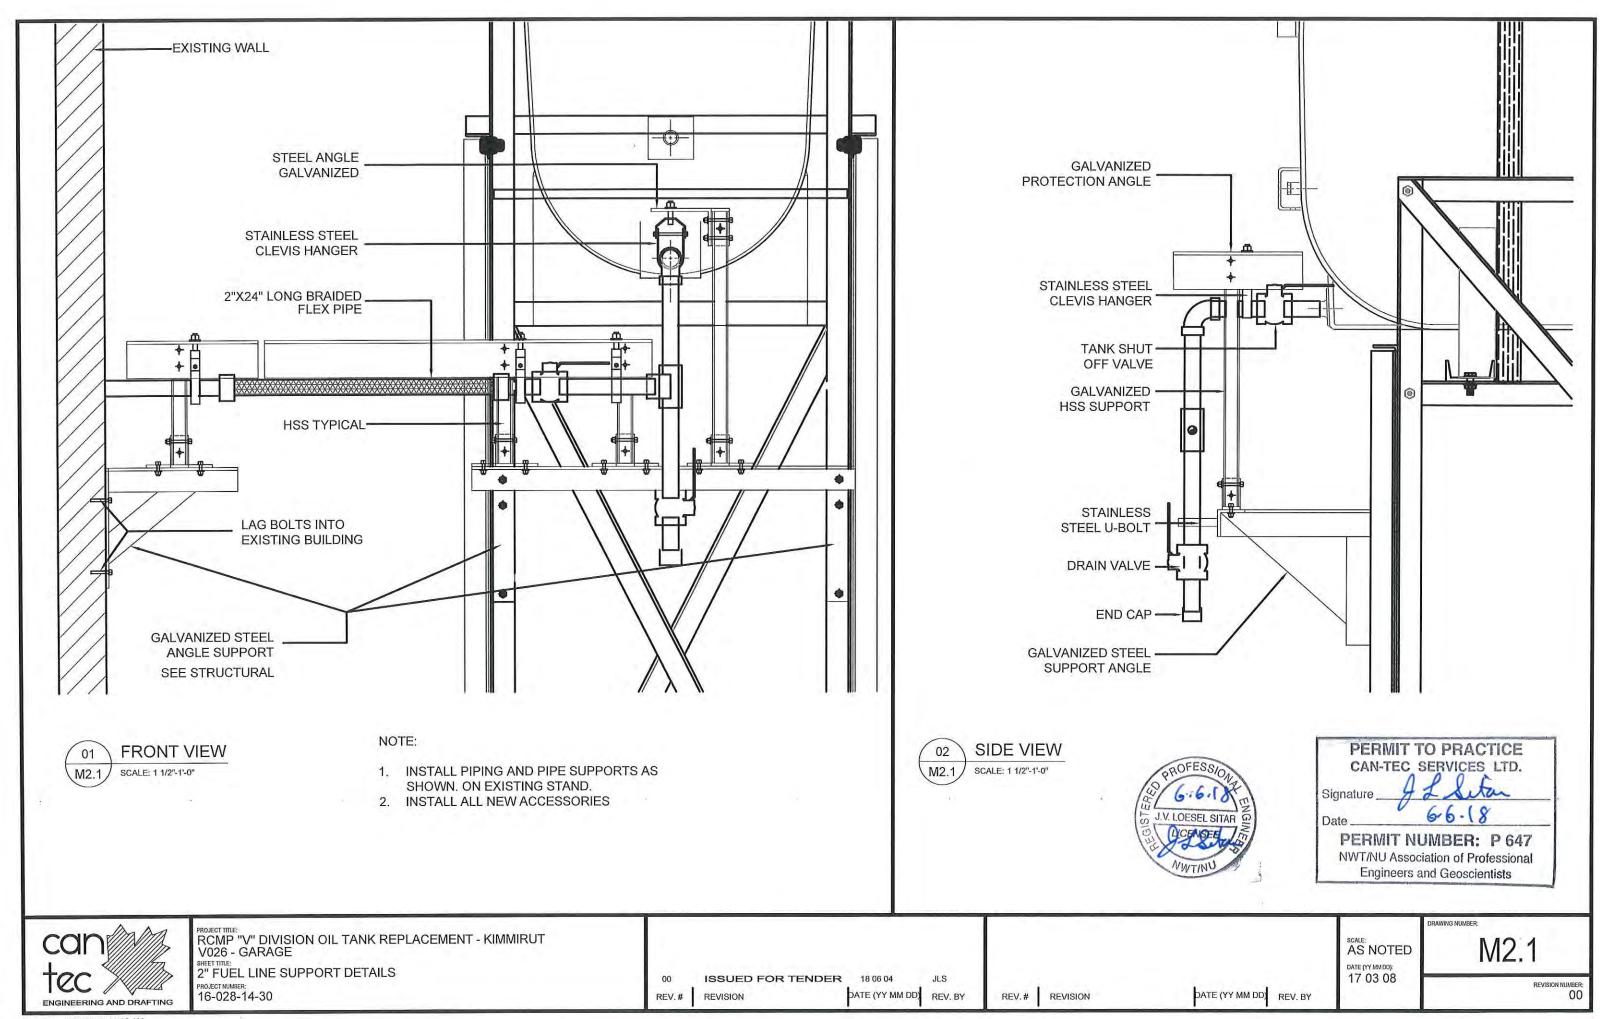
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DATE (YY MMDD):
17 06 09

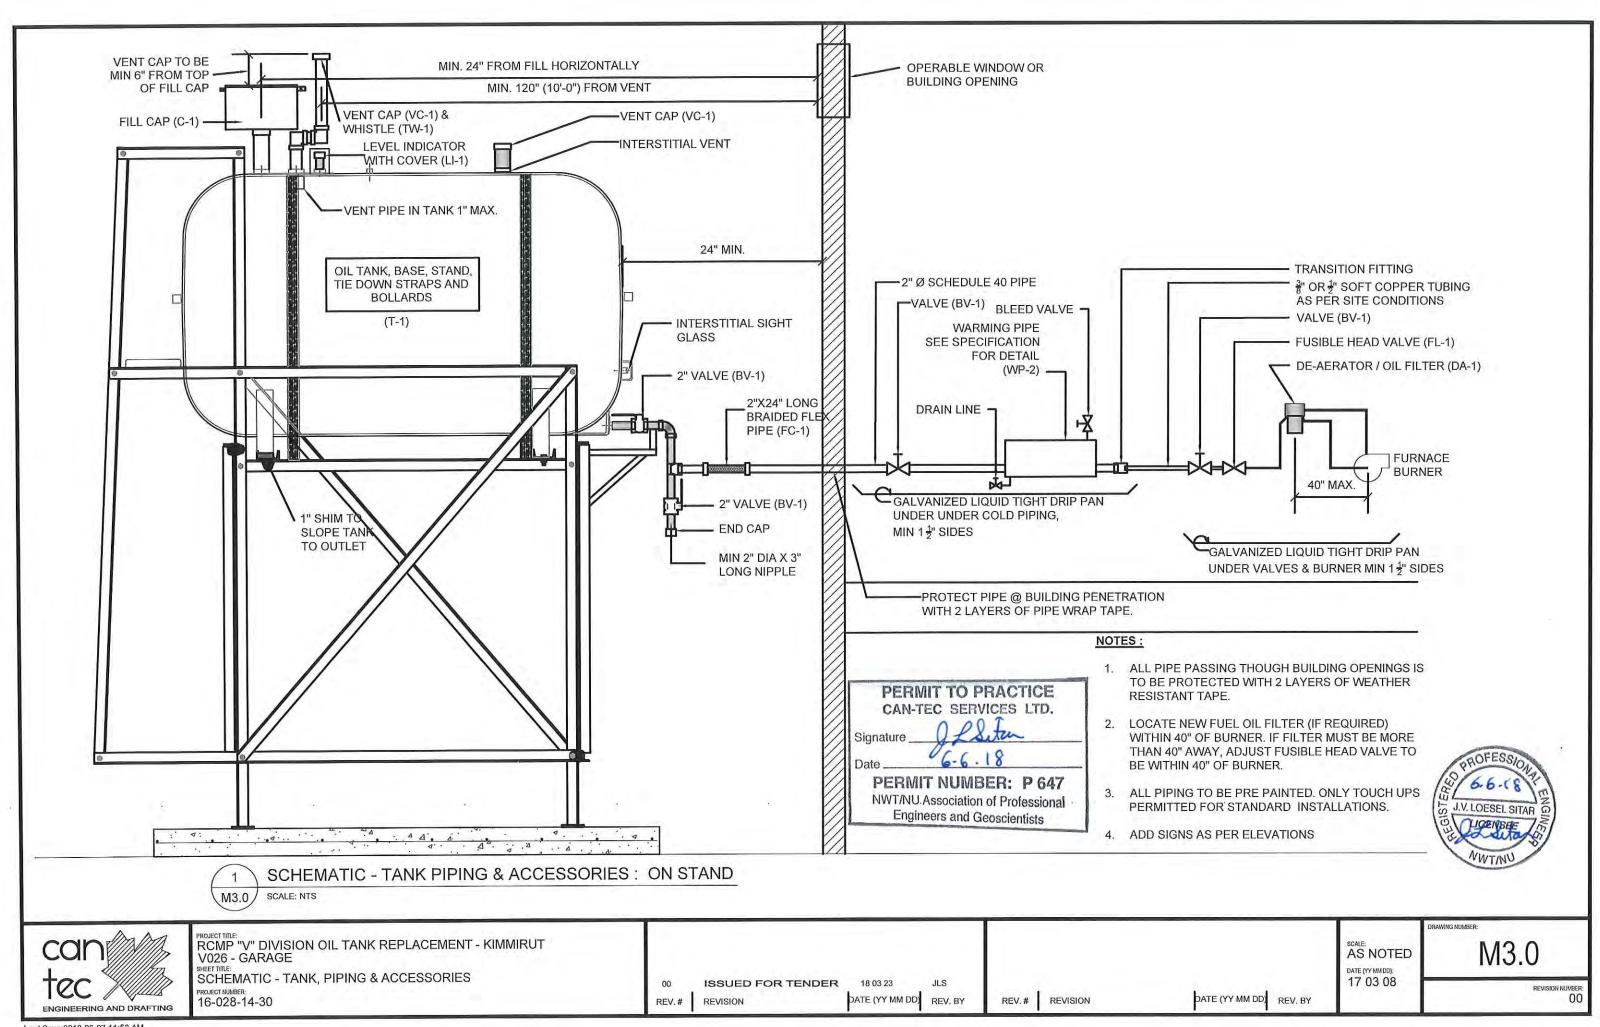
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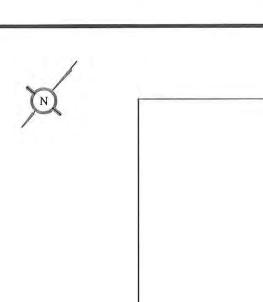




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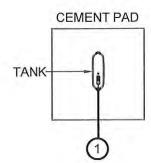


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V0293 Detachment Site Plan KIMMIRUT

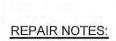
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#### **DEMOLITION NOTES:**

- 1. REMOVE ALL FUEL FROM THE EXISTING STEEL FUEL TANK.
- EXISTING FUEL TANK, STAND AND CONCRETE BASE TO BE RETAINED FOR RE-INSTALLATION. REMOVE ALL ACCESSORIES TO BOILERS



M2.0 M1.0

1. REMOVE ALL ACCESSORIES AND INSTALL ALL NEW ACCESSORIES ON FUEL TANKS AND BOILER SEE DRAWING M3.0 FOR DETAILS.

0

2. TANK, STAND AND CONCRETE PAD IS TO BE SALVAGED ALL OTHER EQUIPMENT IS TO BE INSTALLED AS NEW.

M2.0 M1.0

3. ADJUST LOCATION OF CONCRETE PAD AS PER ATTACHED DETAILS FOR SEPARATION FROM BUILDING

## CONSTRUCTION NOTES:

1. INSTALL NEW PIPING SUPPORT AS PER SHEET M2.1 ALSO PROVIDE SUPPORT FOR FILL GAUGE LINE.

4

- 2. CAULK ENTRY INTO BUILDING.
- INSTALL NEW 2" DIA PIPE
- 4. EXISTING BOILERS



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NWT/NU Association of Professional **Engineers and Geoscientists** 

> AS NOTED DATE (YY MM DD):

17 06 09



RCMP "V" DIVISION OIL TANK REPLACEMENT - KIMMIRUT V293 FACILITY BUILDING **DEMOLITION & CONSTRUCTION PLAN** 

PROJECT NUMBER: 16-028-14-30

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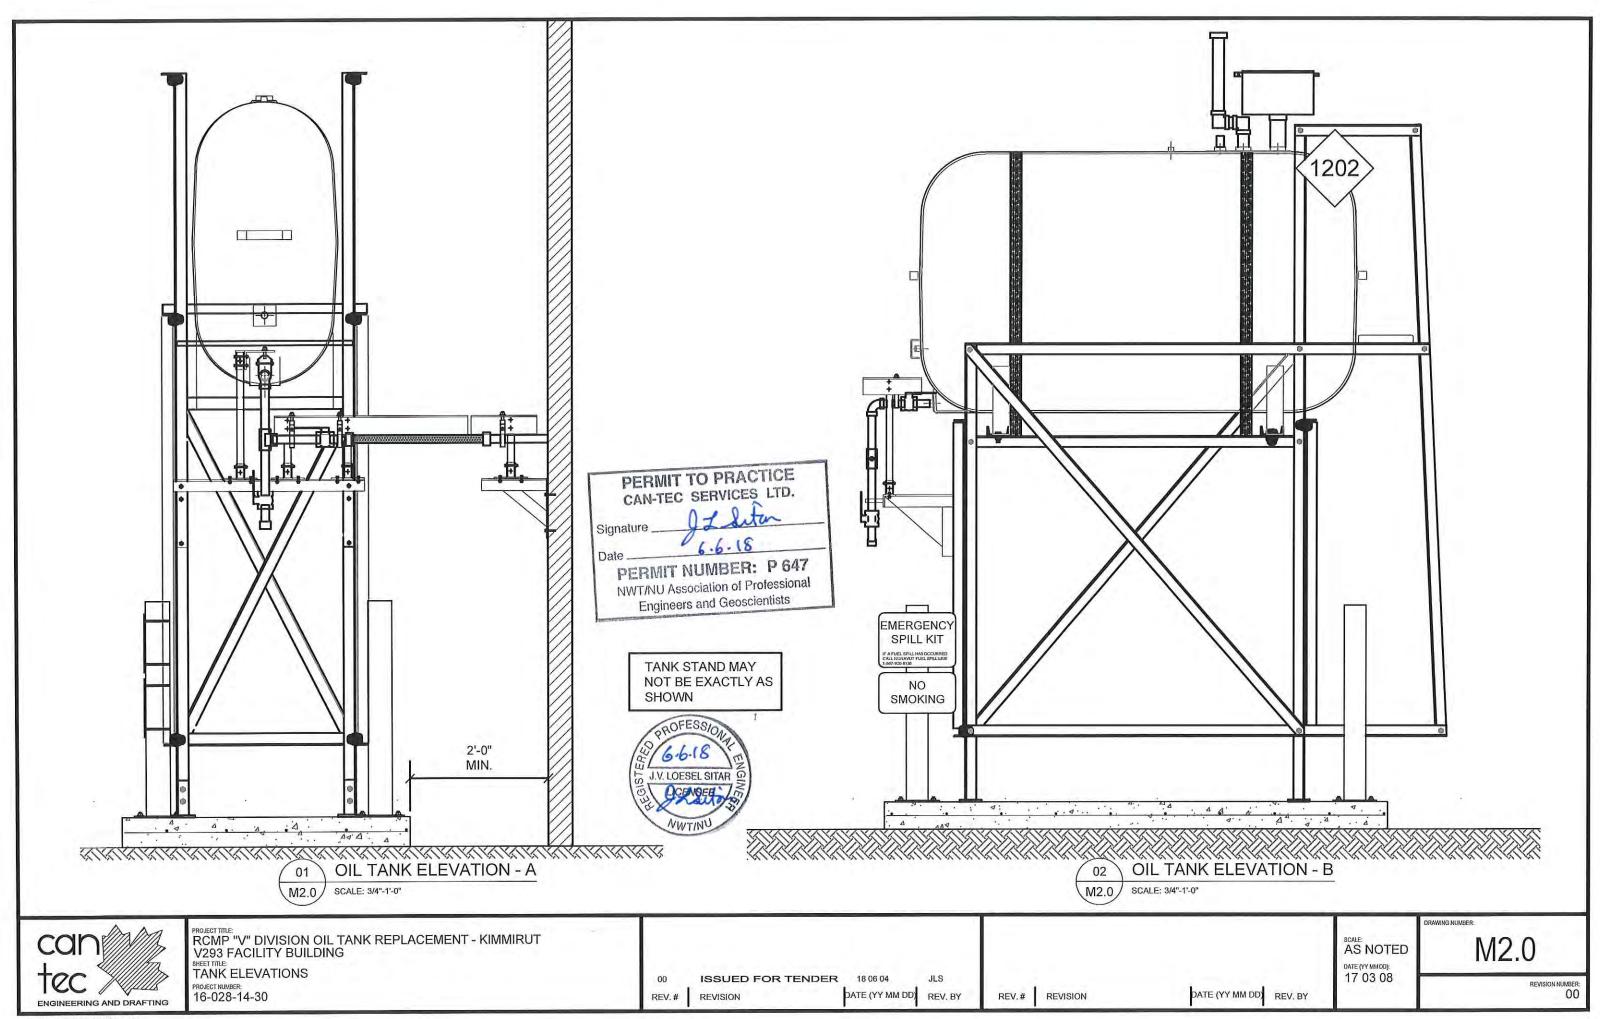
REVISION

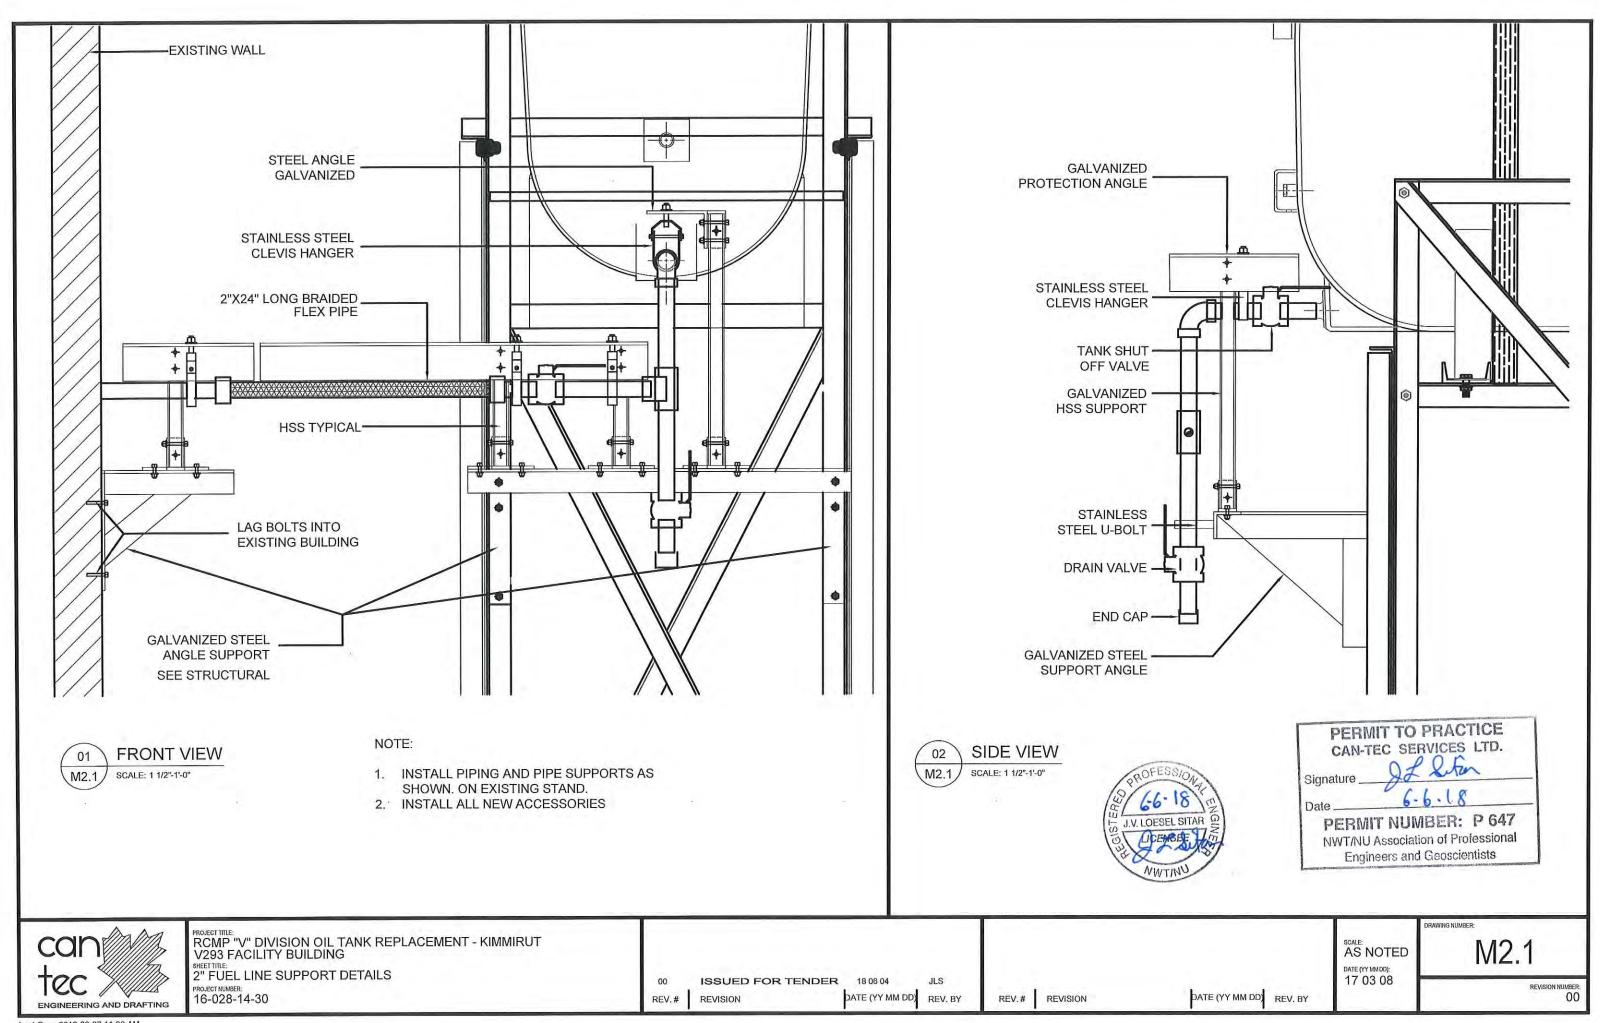
CONSTRUCTION PLAN

SCALE: NTS

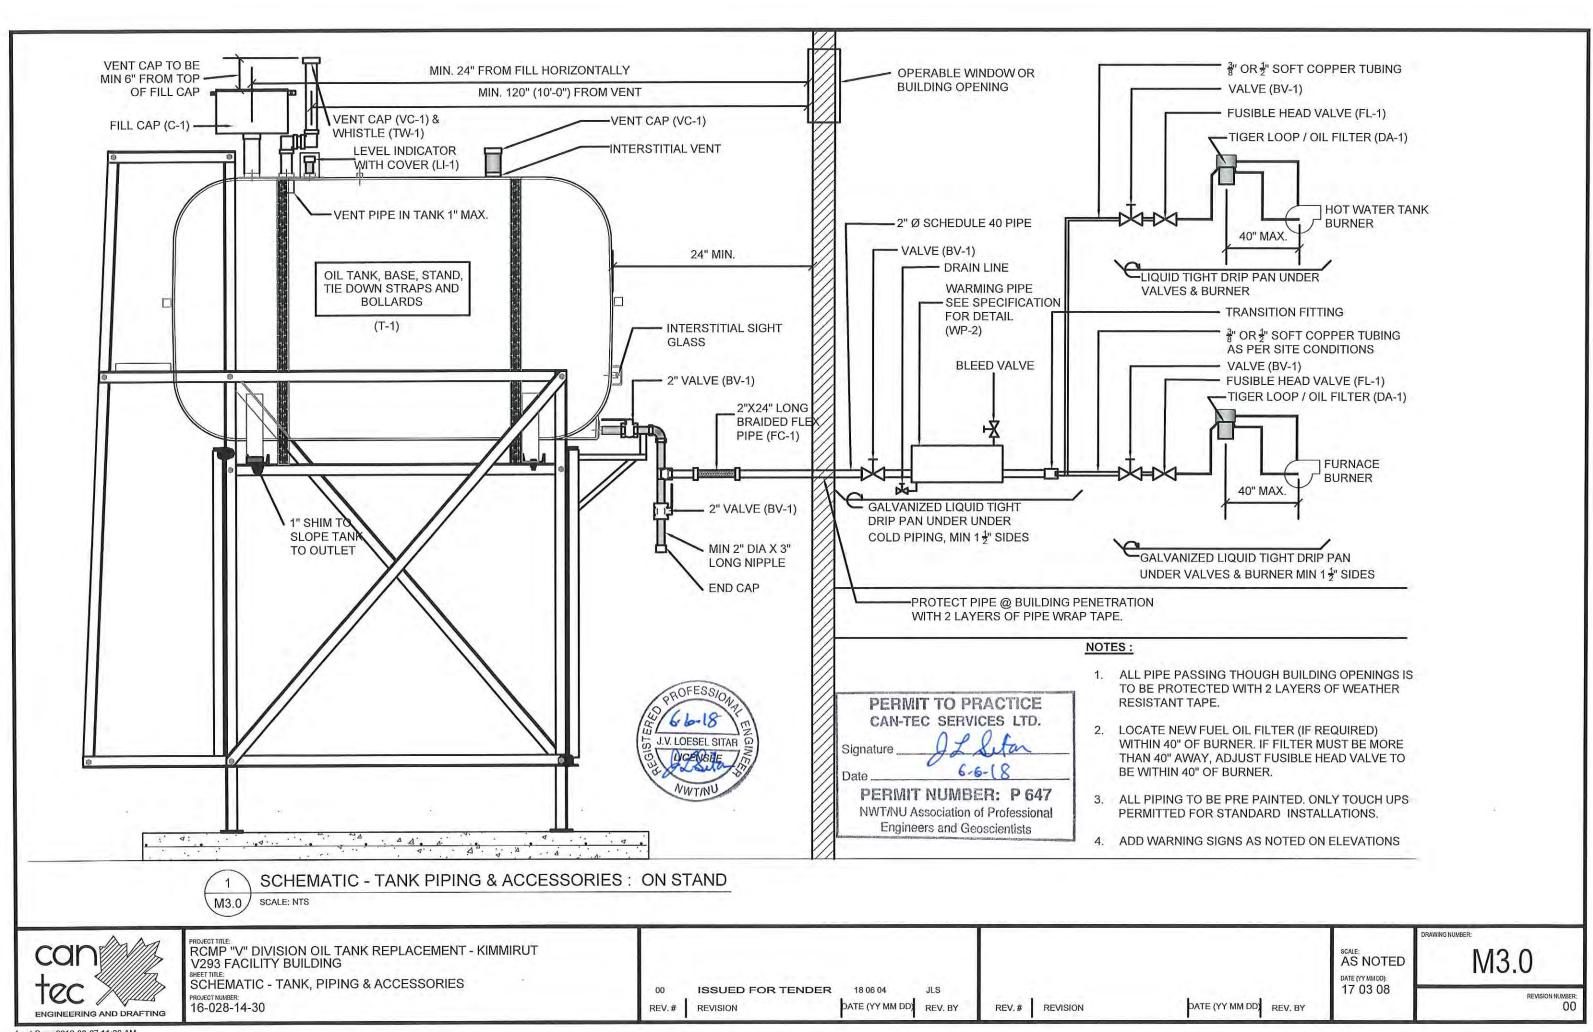
DATE (YY MM DD) REV. BY

M1.0





Last Save:2018-06-07 11:26 AM



Last Save: 2018-06-07 11:26 AM