# NATIONAL RESEARCH COUNCIL CANADA

# Montreal road Campus, Institutes and Laboratories Ottawa, Ontario, Canada

ADMINISTRATIVE SERVICES AND PROPERTY PREPARED BY:

MANAGEMENT, ENGINEERING SERVICES 1200 MONTREAL ROAD, M-19 (RM 340) OTTAWA, ONTARIO, CANADA KIA ØR6

PROJECT: PROJECT NO. = 5553


BUILDING U-61 (UPLANDS CAMPUS)


U-61: RM205 - WASHROOM RENOVATION (EXPAND LOCKER ROOM AND SHOWER AREA)

## DRAWING SHEET LIST:

STRUCTURAL	N/A	
ARCHITECTURAL	5553-AØØ	<ul> <li>COVER SHEET</li> <li>GENERAL DRAWING LIST</li> <li>PROJECT INFO</li> <li>ABBREVIATION LEGEND</li> </ul>
	5553-AØ1	ROOMS 205 & 205A (C/W PHOTOS)  - DEMOLITION FLOOR PLAN  - DEMOLITION REFLECTED CEILING PLAN  - ARCHITECTURAL REMOVAL NOTES  - FINISH SCHEDULE AND LEGENDE
	5553-AØ2	RROOM 205 & 205A NEW FLOOR PLAN — NEW REFLECTED CEILING PLAN — MISC NEW WALL ELEVATION — ARCHITECTURAL NEW NOTES
	5553-AØ3	ROOM 205 & 205A MISC SHOWER ASSEMBLY — SHOWER CURB & DRAIN, FLOOR DRAIN AND MISC DETAILS — SHOWER WALL PLAN AND ELEVATION
	5553-AØ4	ROOM 205 & 205A  - DOOR AND MASONRY SCHEDULE  - MISC DOOR AND FRAME DETAILS  - CORRIDOR WALL ELEVATION  - PVC CLADDING AND TOILET ASSEMBLIES
MECHANICAL	5553-MØ1	- MECHANICAL: DEMOLITION AND NEW WORK
ELECTRICAL	5553-EØ1	- ELECTRICAL: POWER AND SYSTEMS NEW AND DEMOLITION
SPECIFICATIONS:	SEE SEPARATE	BINDED MANUAL



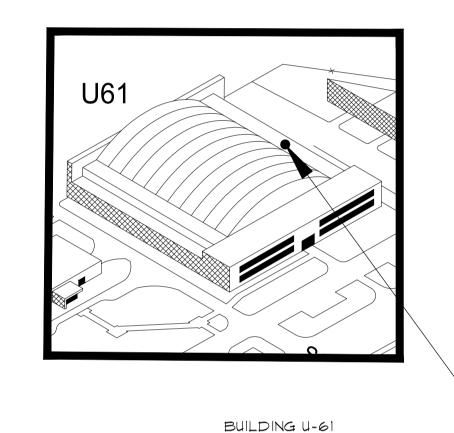

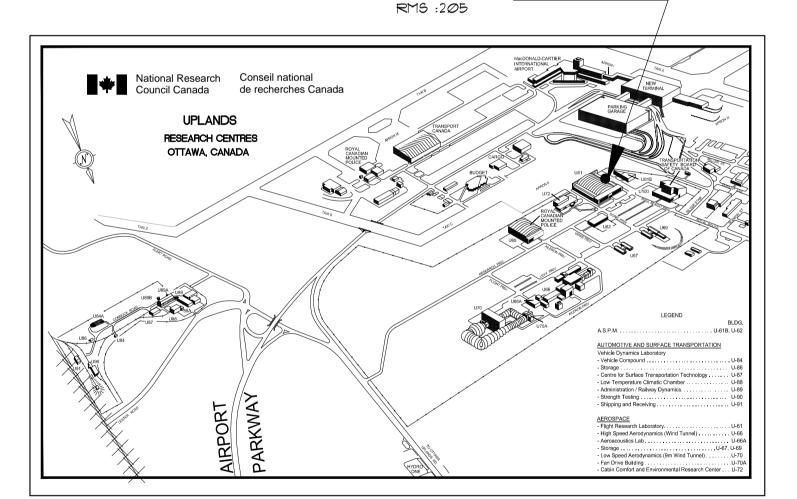



<b>ABBREV</b>	IATION LEGEND:				
AFF.	ABOVE FINISHED	E.E.W	EXISTING EYE WASH	O. F.	OUTSIDE FRAME
	FL <i>OOR</i>		STATION	MIN.	OPPOSITE
AL.	ALUMINUM	E×.	EXPANSION	POLY.	POLYETHYLENE
$\triangle \wedge \vee$	AIR/VAPOUR	EXT.	EXTERIOR	P. T.	PRESSURE TREATED
APPROX.	APPROXIMATELY	E.W.	EYE WASH	REINF.	REINFORCING
CEIL.	CEILING	FIN.	FINISH	REQ'D	REQUIRED
CONC.	CONCRETE	F.EXT	FIRE EXTINGUISHER	R. O.	ROUGH OPENING
CONT.	CONTINUOUS	F. R.	FIRE RATED	SIM.	SIMILAR
CONST.	CONSTRUCTION	GA.	GAUGE	SHE	SPRINKLER HEAD EXISTING
COMP.	COMPLETELY	GALY.	GALVANIZED	SHN	SPRINKLER HEAD NEW
C/W	COMPLETE WITH	G. B.	GYPSUM BOARD	sH $ imes$	SPRINKLER HEAD REMOVED
DIA.	DIAMETER	G. C.	GENERAL CONTRACTOR	SPEC	SPECIFICATION
DIAG.	DIAGONAL	HORIZ.	HORIZONTAL	SQ.	SQUARE
DWG	DRAWING	l. D.	INSIDE DIAMETER	S. S.	STAINLESS STEEL
E.A.P.	EXISTING ACCESS	INCL.	INCLUDING	STRUCT.	STRUCTURAL
	PANEL	INSUL.	INSULATION	SUSP.	SUSPENDED
E.F.D.	EXISTING FLOOR DRAIN	INT.	INTERIOR	T. & G.	TONGUE & GROOVE
E.F.P.	EXISTING FLOOR PLATES	MLD	MOTION LIGHT DETECTOR	T. ₫ B.	TOP & BOTTOM
EXIST.	EXISTING	MIN	MINIMUM	T. O. F.	TOP OF FRAME
EX.SHWR	EXISTING EMERGENCY	mm	MILLIMETRE	T. O. S.	TOP OF STEEL
	SHOWER STATION	N. I. C.	NOT IN CONTRACT	TYP	TYPICAL
		0. C.	ON CENTER	U/S	UNDERSIDE
		0. D.	OUTSIDE DIAMETER	VERT	VERTICAL

National Research Council Canada

Administrative Services

de recherches Canada Division des services and Property Management administratifs et gestion de l'immobilier

## NRC - CNRC


#### GENERAL NOTES

- CONTRACTORS TO CHECK AND VERIFY ALL DIMENSIONS ON SITE PRIOR TO DEMOLITION OR CONSTRUCTION AND REPORT ANY ERRORS OR OMISSIONS TO DEPARTMENTAL
- FAMILIARIZE THEMSELVES WITH THE SCOPE
- CONTRACTORS MUST PREVENT THE SPREAD OF DUST & DEBRIS BEYOND THE WORK AREA AND CLEAN ALL SURFACES AT COMPLETION OF THEIR WORK, MAKE GOOD ALL SURFACES AFFECTED BY THIS WORK...
- G.C. TO PATCH AND MAKE GOOD ALL WALLS CEILINGS AND FLOORS WHERE MECHANICAL, ELECTRICAL & ARCHITECTURAL ITEMS HAVE BEEN REMOVED.
- COORDINATE ALL SHUTDOWNS WITH THE DEPARTMENTAL REPRESENTATIVE.
- ARCHITECTURAL DRAWING 5553-A00 TO 5553-A04 TO BE READ IN CONJUNCTION WITH MECHANICAL DRAWINGS 5553-MOI \$ ELECTRICAL 5553-EØI AND SPECIFICATIONS.

			. 1
1	NOV 2018	195UED FOR TENDER	JCW
0	21 SEPT 2018	DESIGN FINAL REVIEW - APPROVAL	JCW
No.	Date	Revision	By: Par:


Date Printed

KEY PLAN

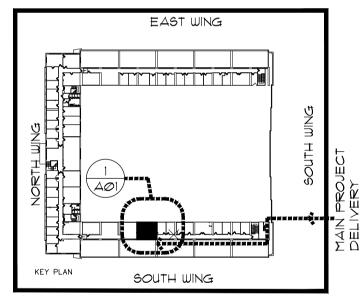

#### **BUILDING U-61 KEY PLAN** NOT TO SCALE

- Verify all dimensions and site conditions and be responsible
- Vérifier toutes les dimensions et l'état des liéux et en

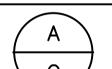

No. du détail

B Location drawing no sur dessin no. C Drawing no.

U-61: RM205 - WASHROOM RENOVATION (EXPAND LOCKER ROOM AND SHOWER

#### UPLANDS CAMPUS

- COVER SHEET

- GENERAL DRAWING LIST


- PROJECT INFO - ABBREVIATION LEGEND


JC. W.	conçu	AUG	G 2018	date
drawn JC.W.	dessiné	scale	SHOWN	échelle
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s.H. / B.L.	vérifié	sheet <b>1</b>	of/de <b>5</b>	feuille
approved	approuvé	W.O.no.		D.T.no.
D.F.		A1-01	1227-1	2


5553-A00 cad File: **5553-U61-A00-TENDER** 


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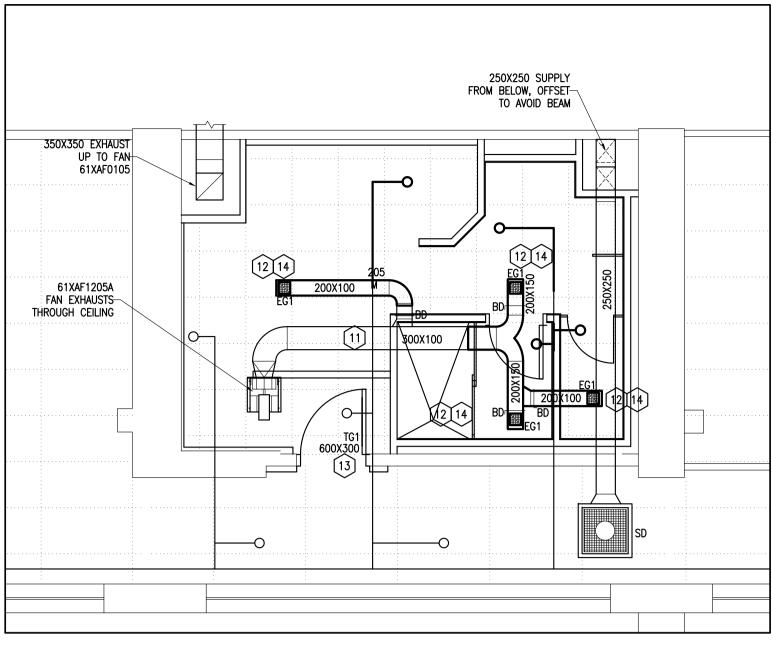
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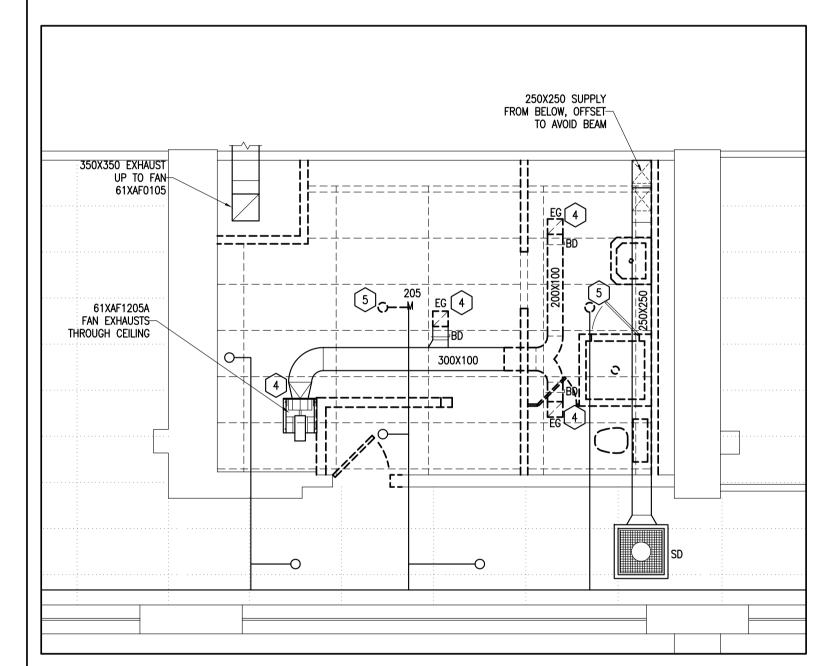




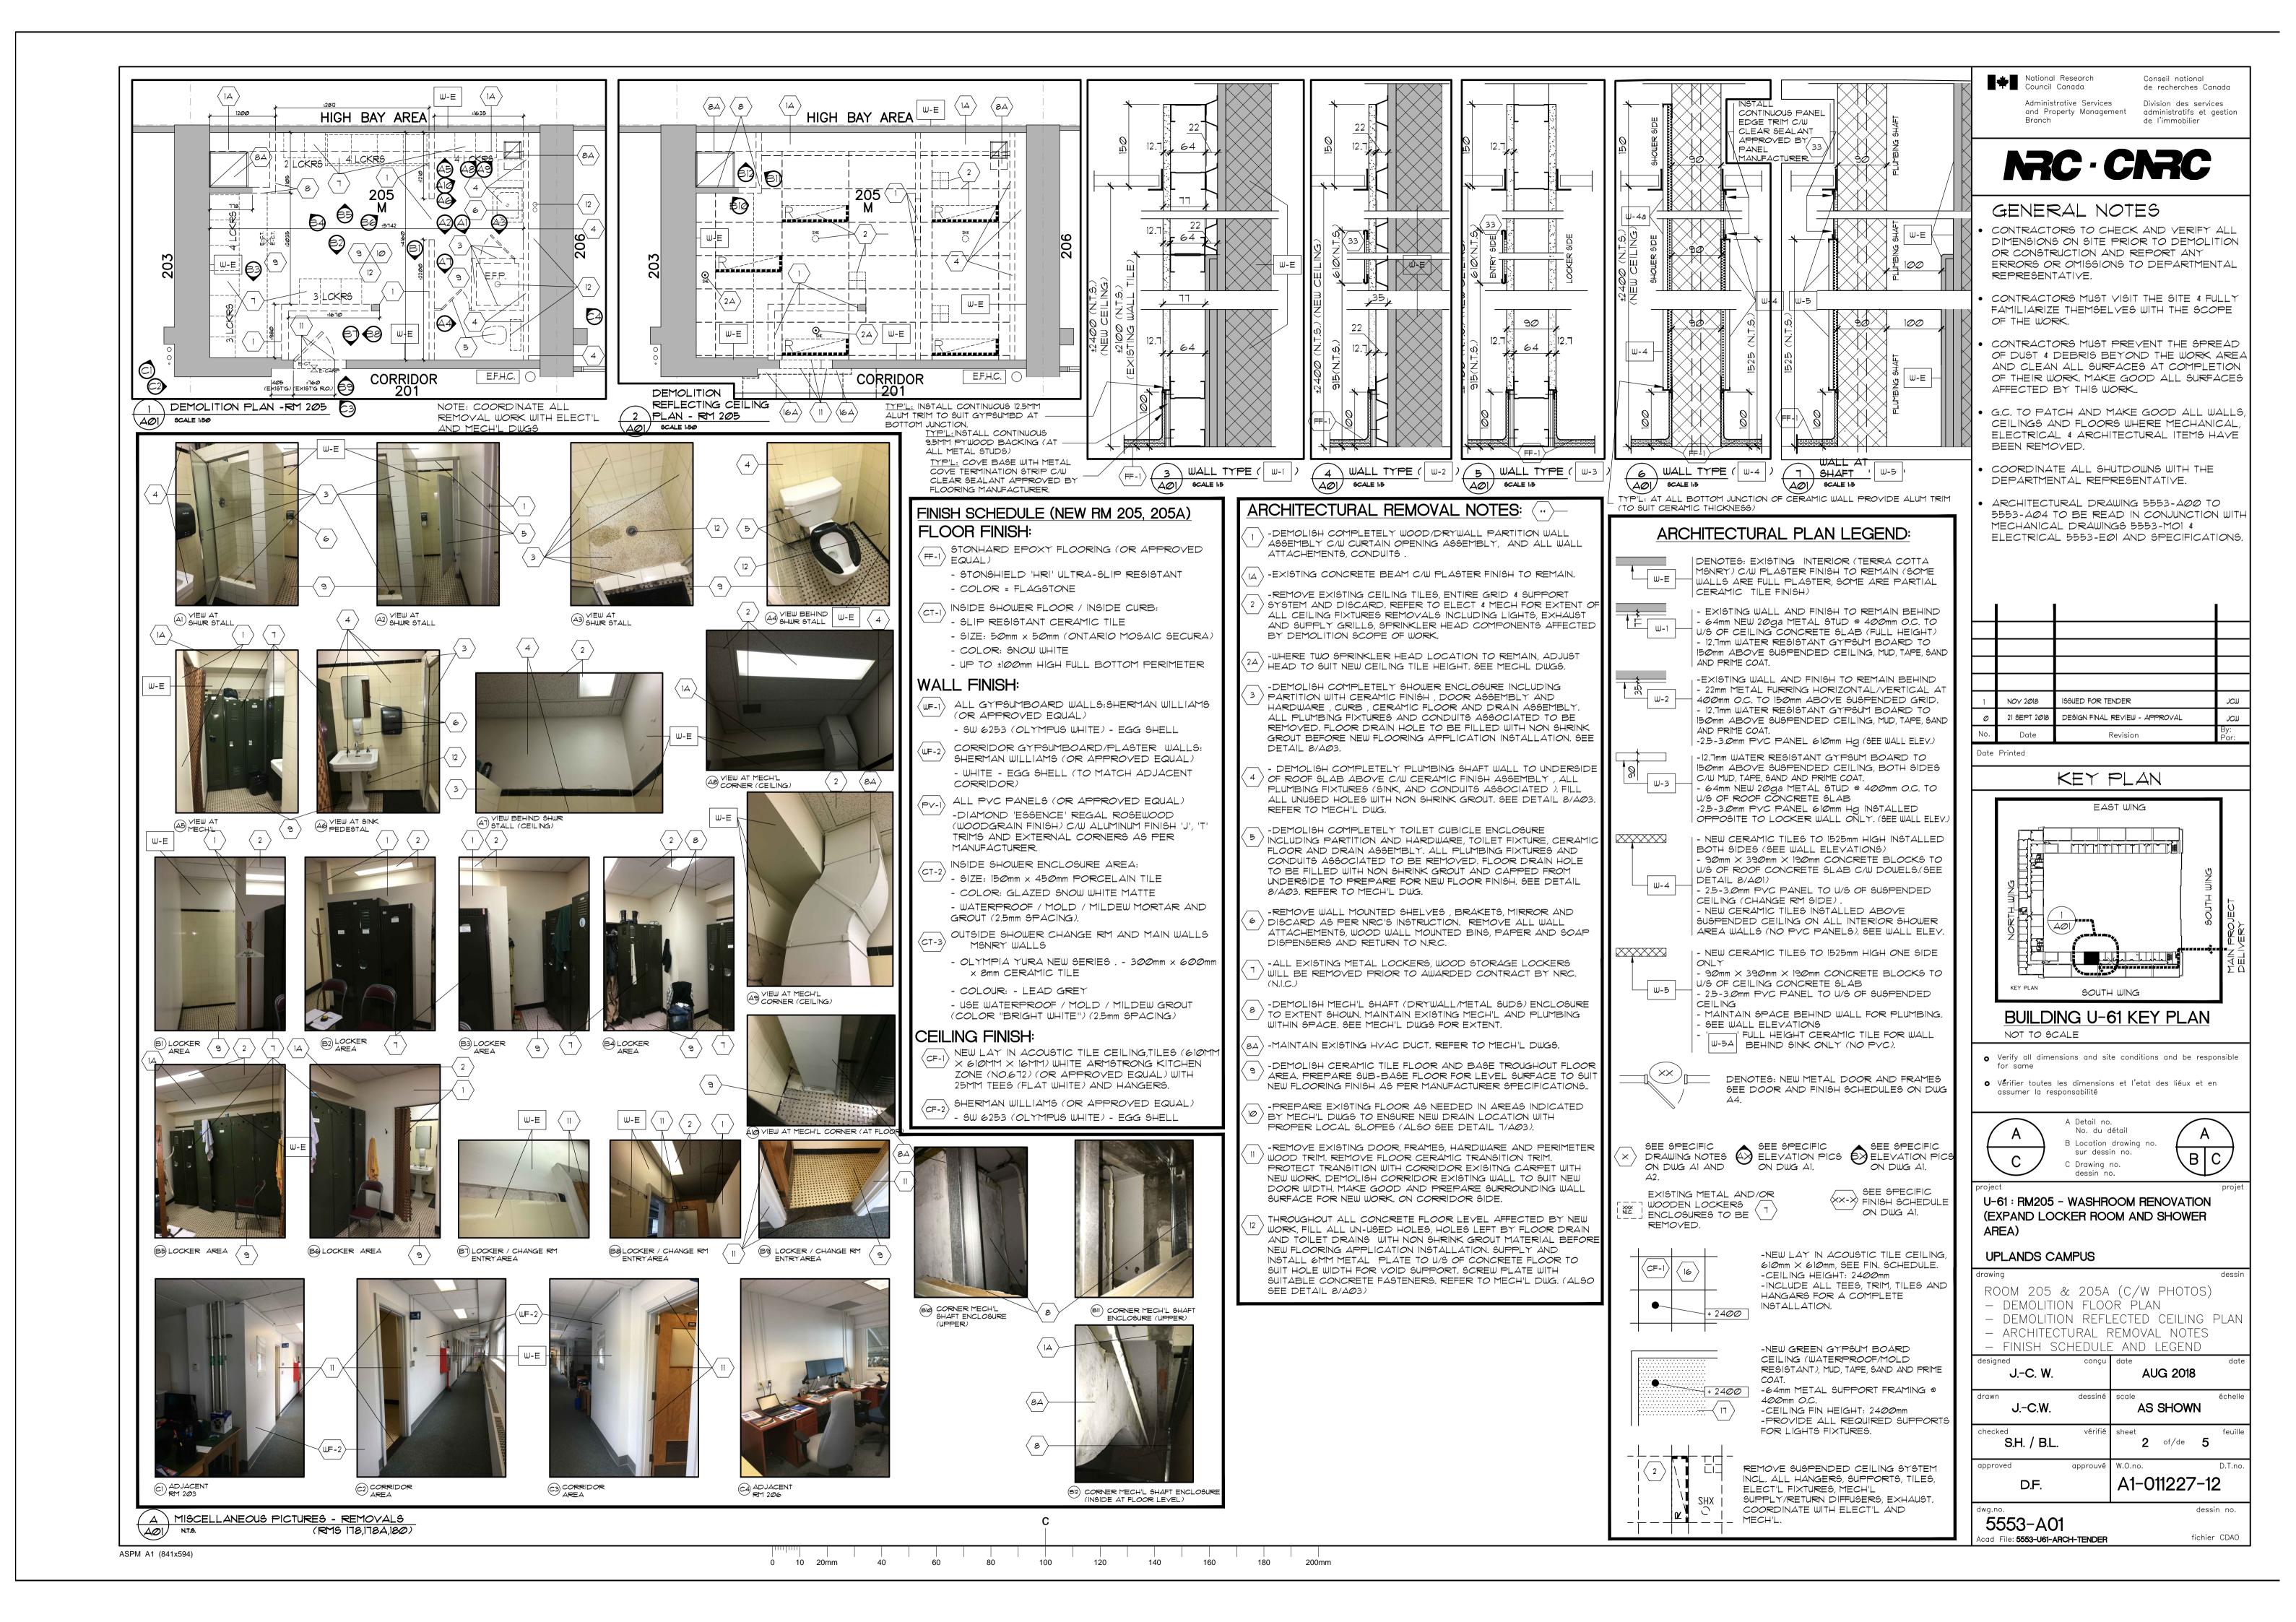

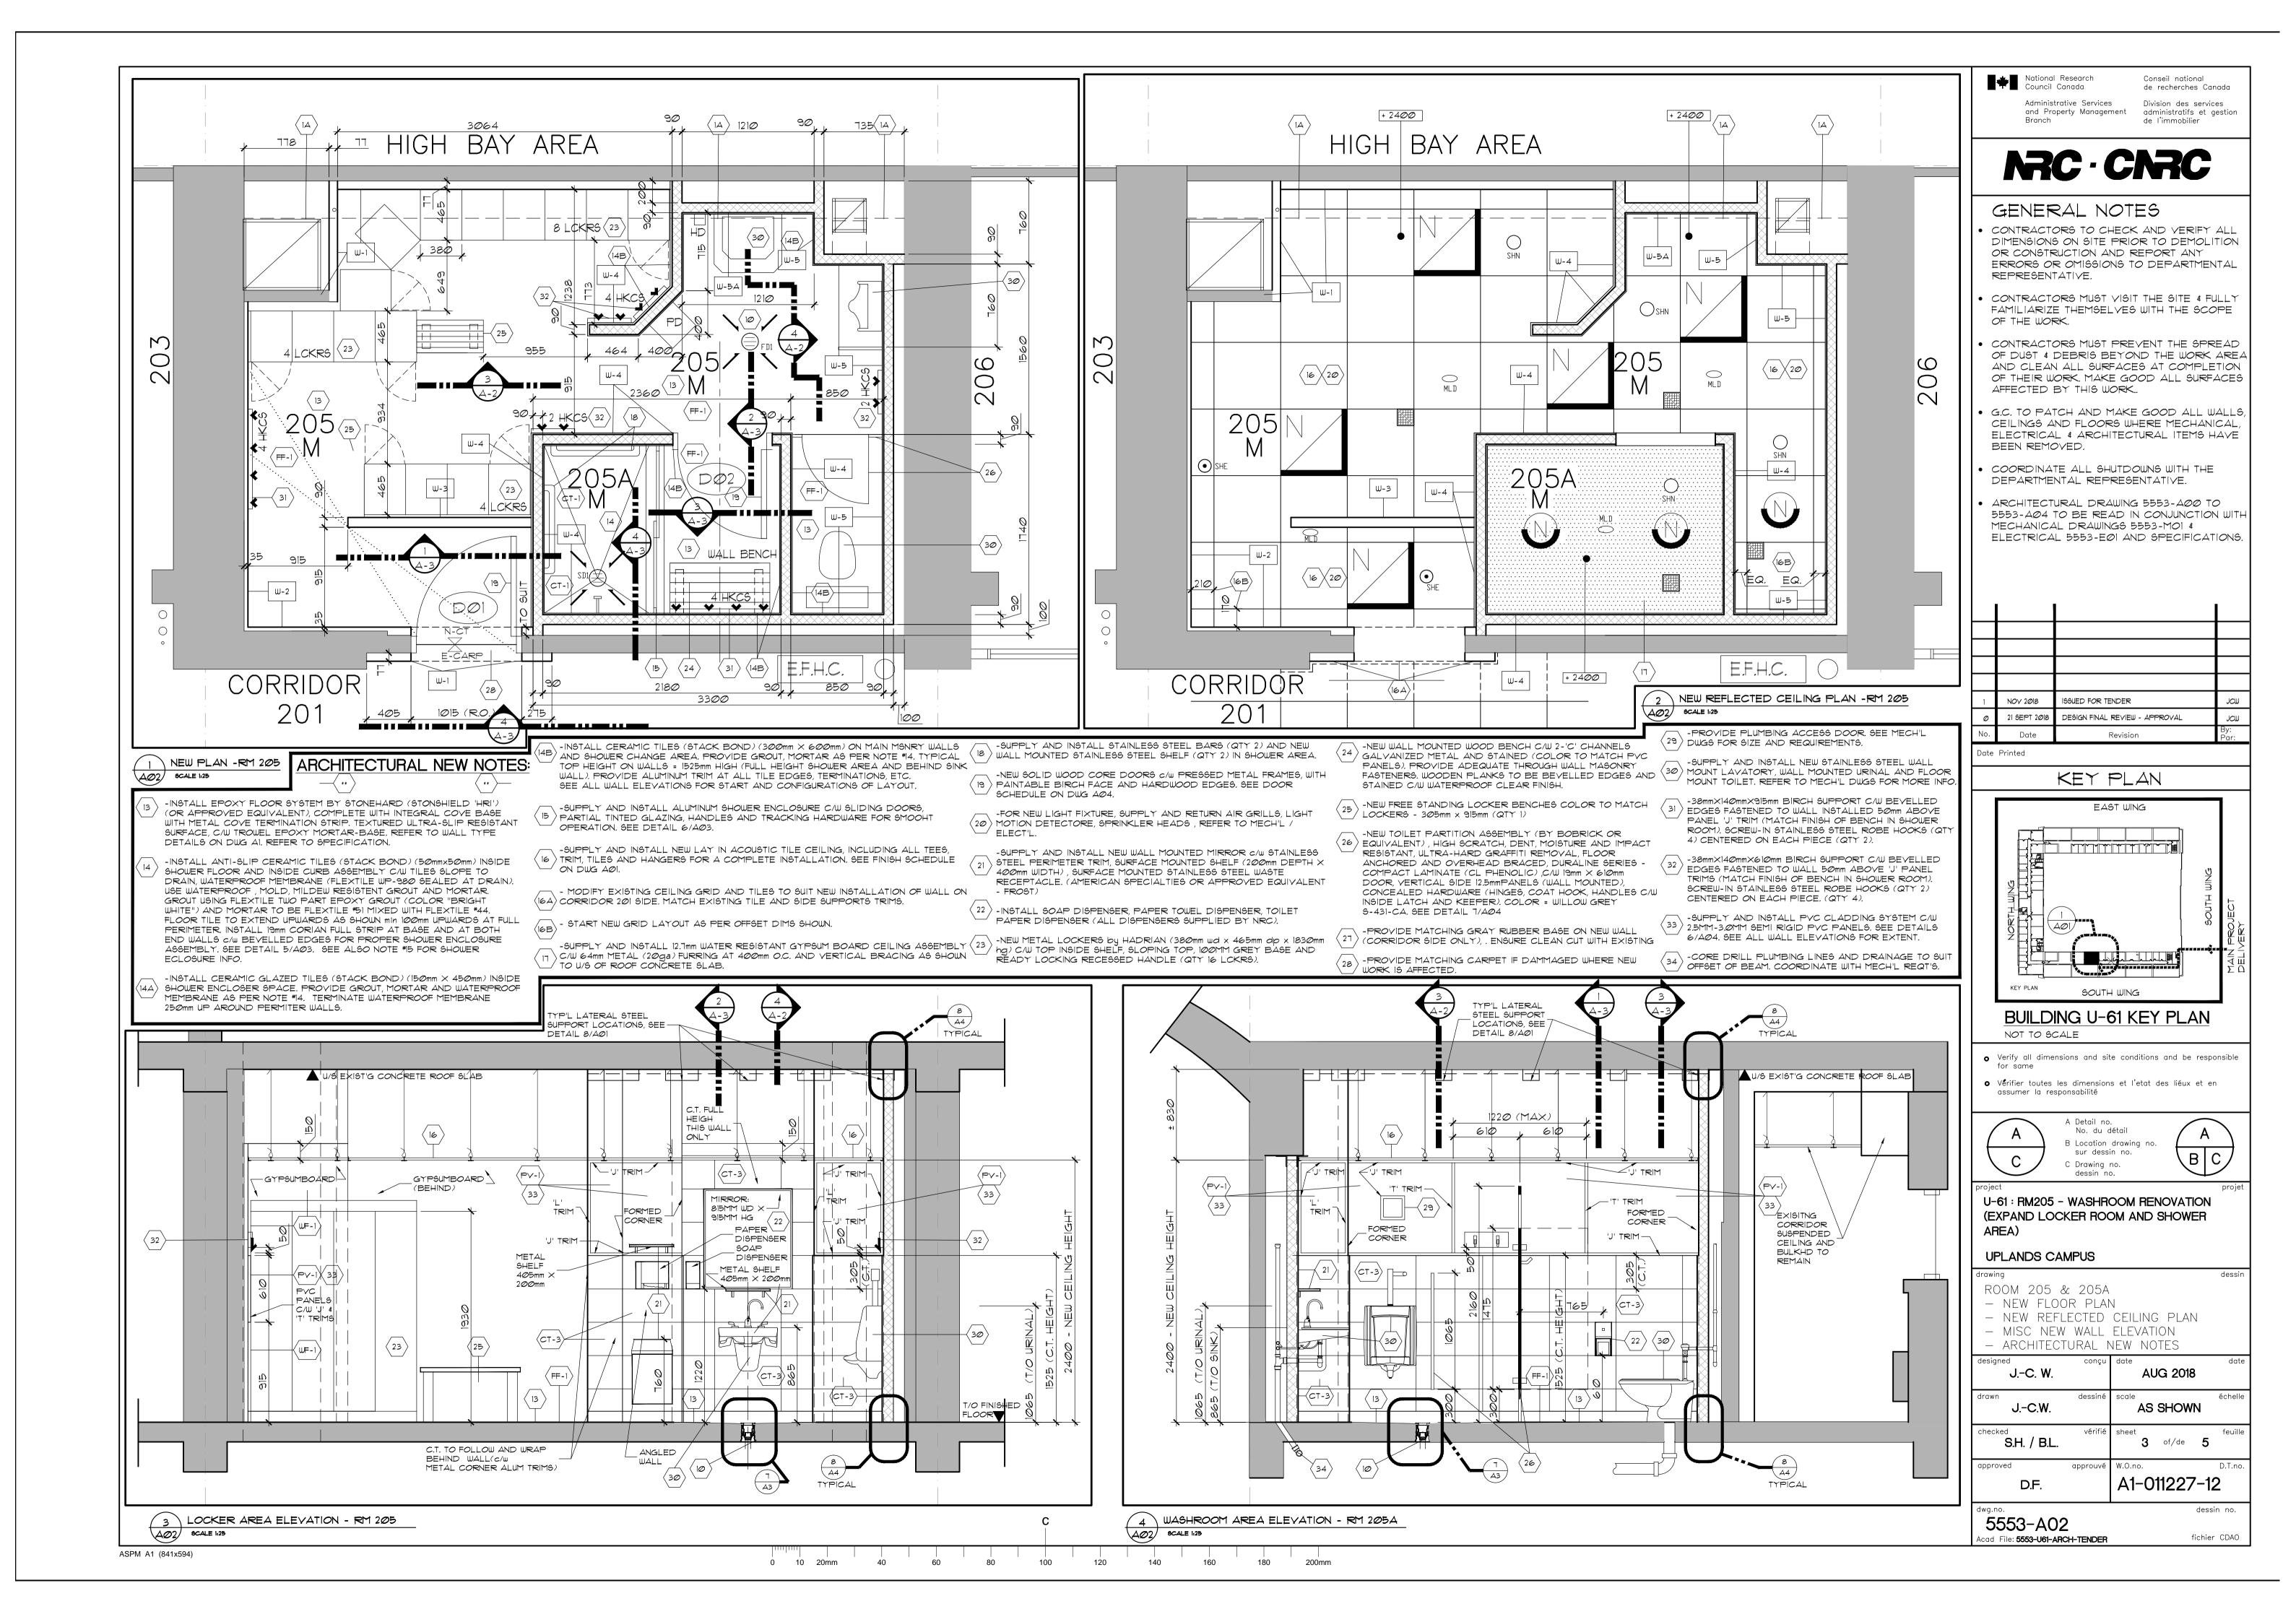
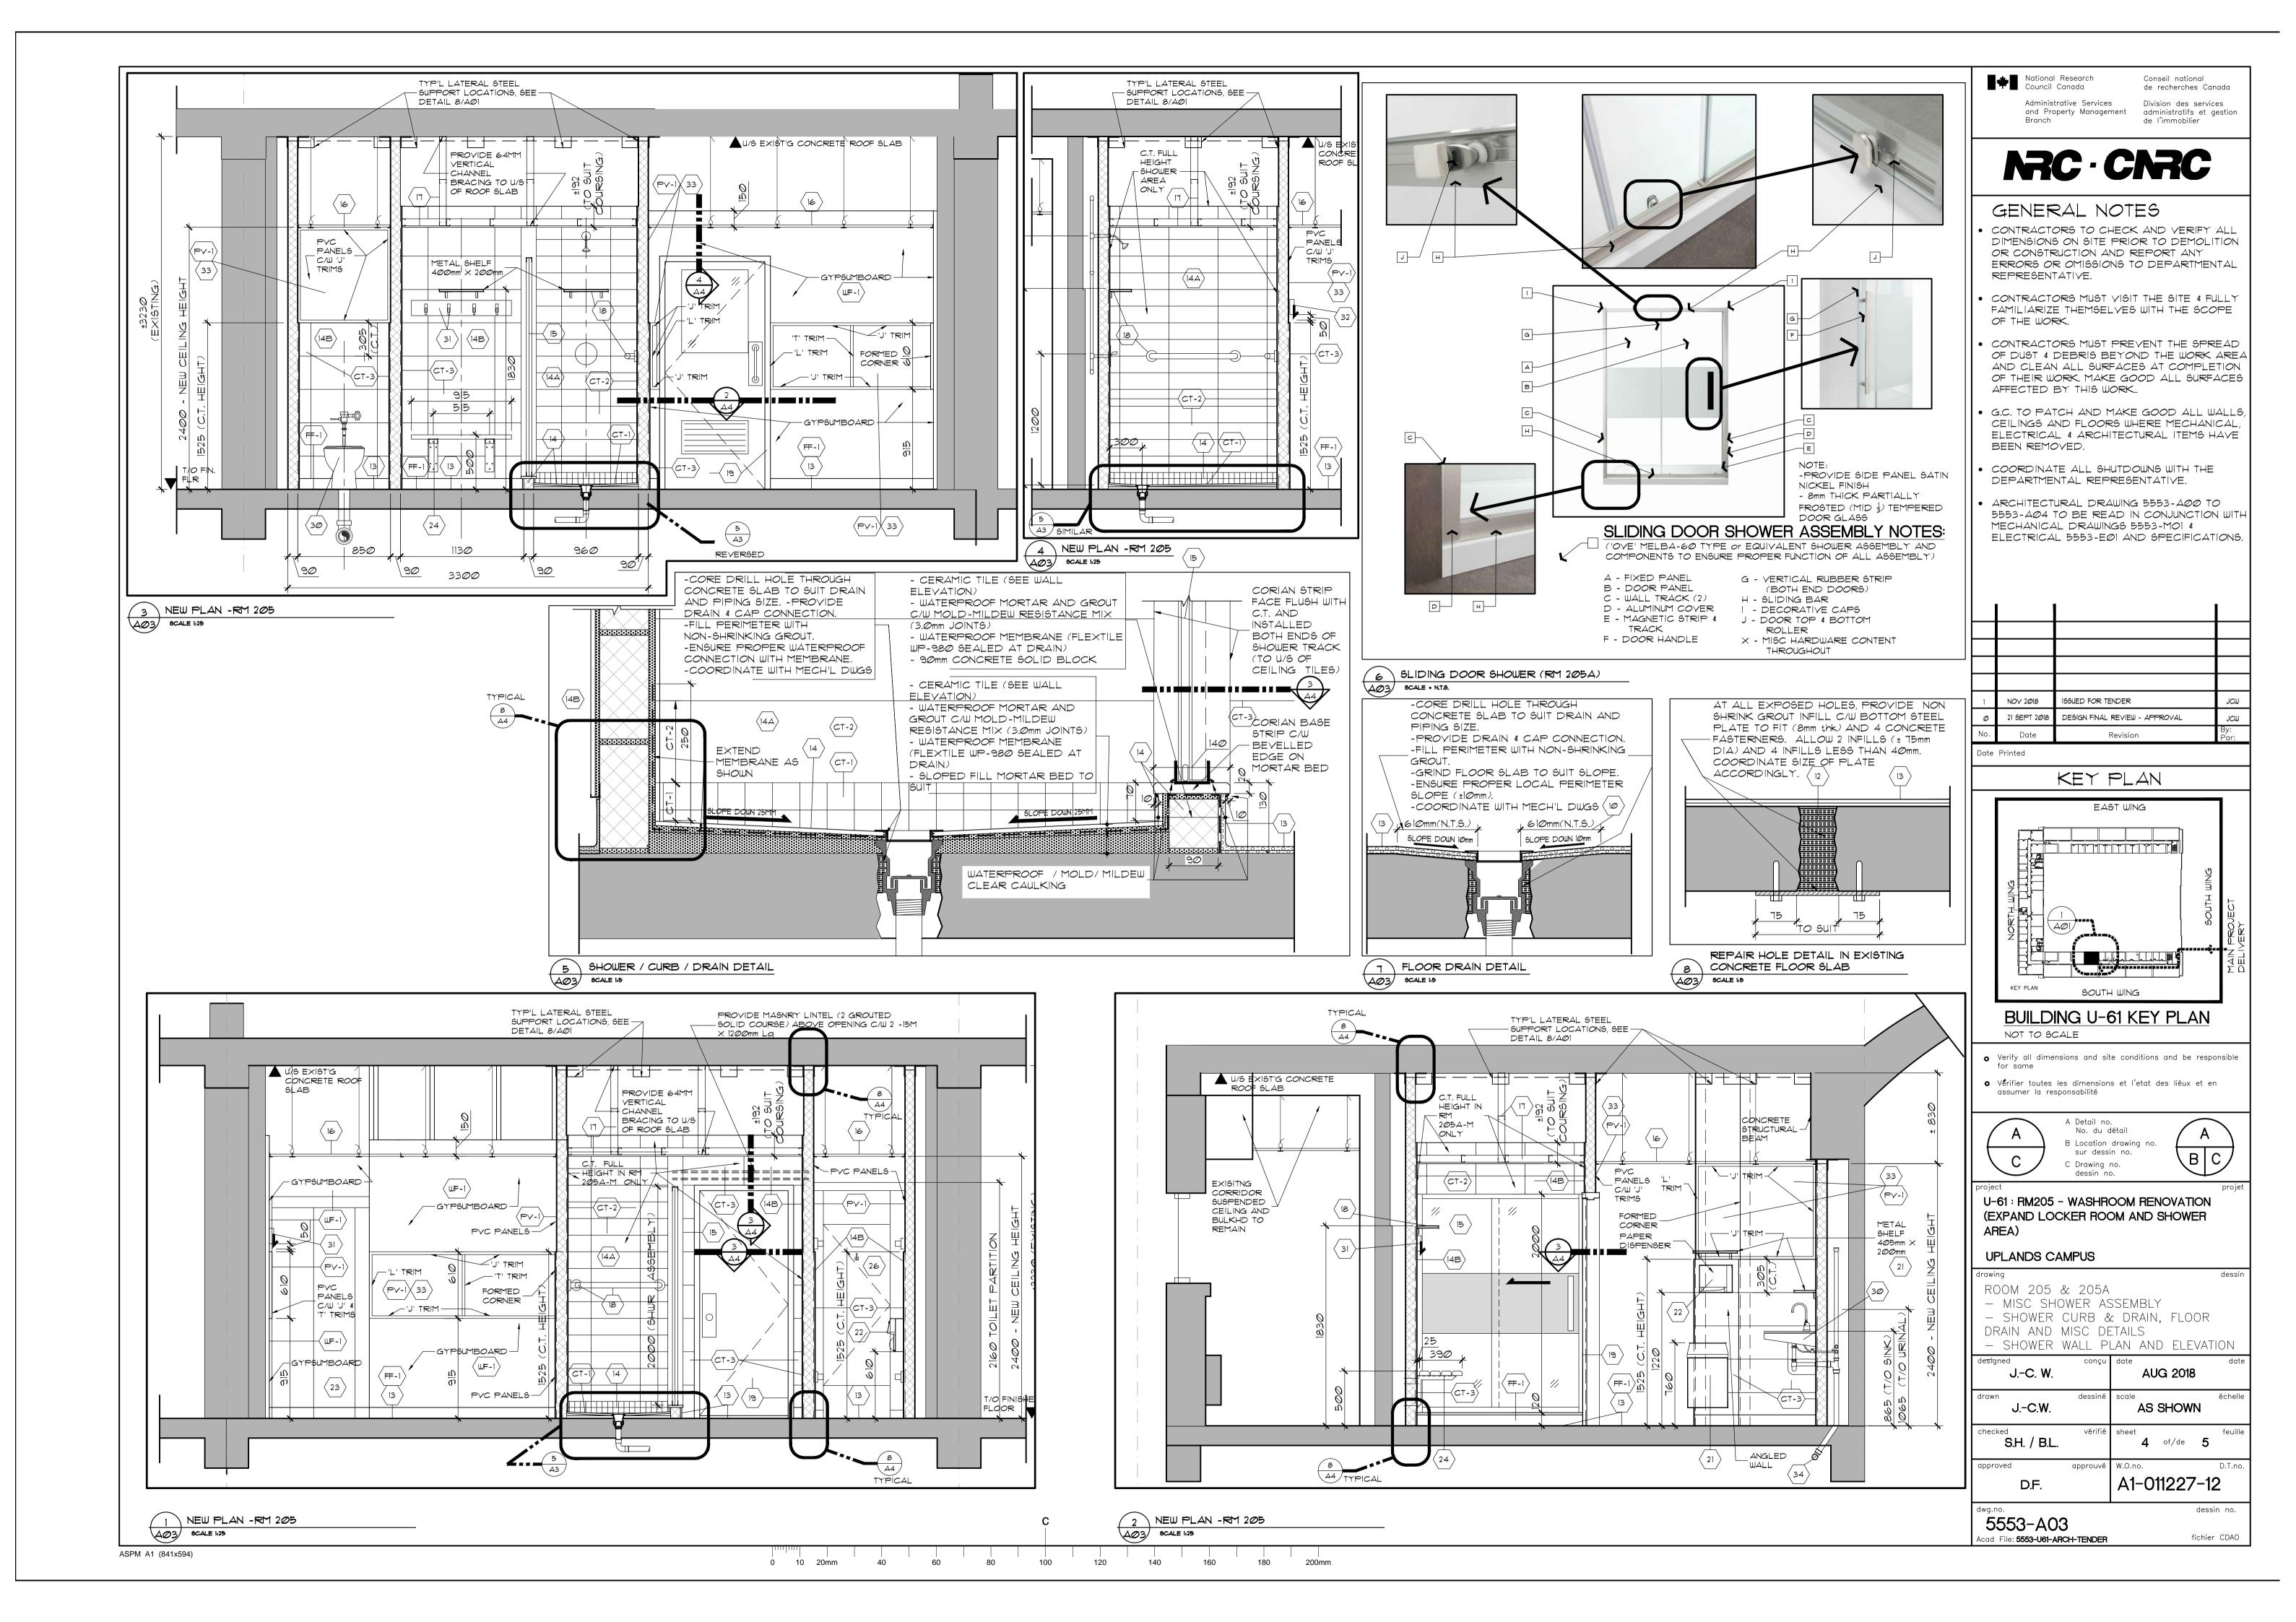
# U-61 PART PLAN- ROOM 205 FIRE PROTECTION + HVAC- NEW WORK

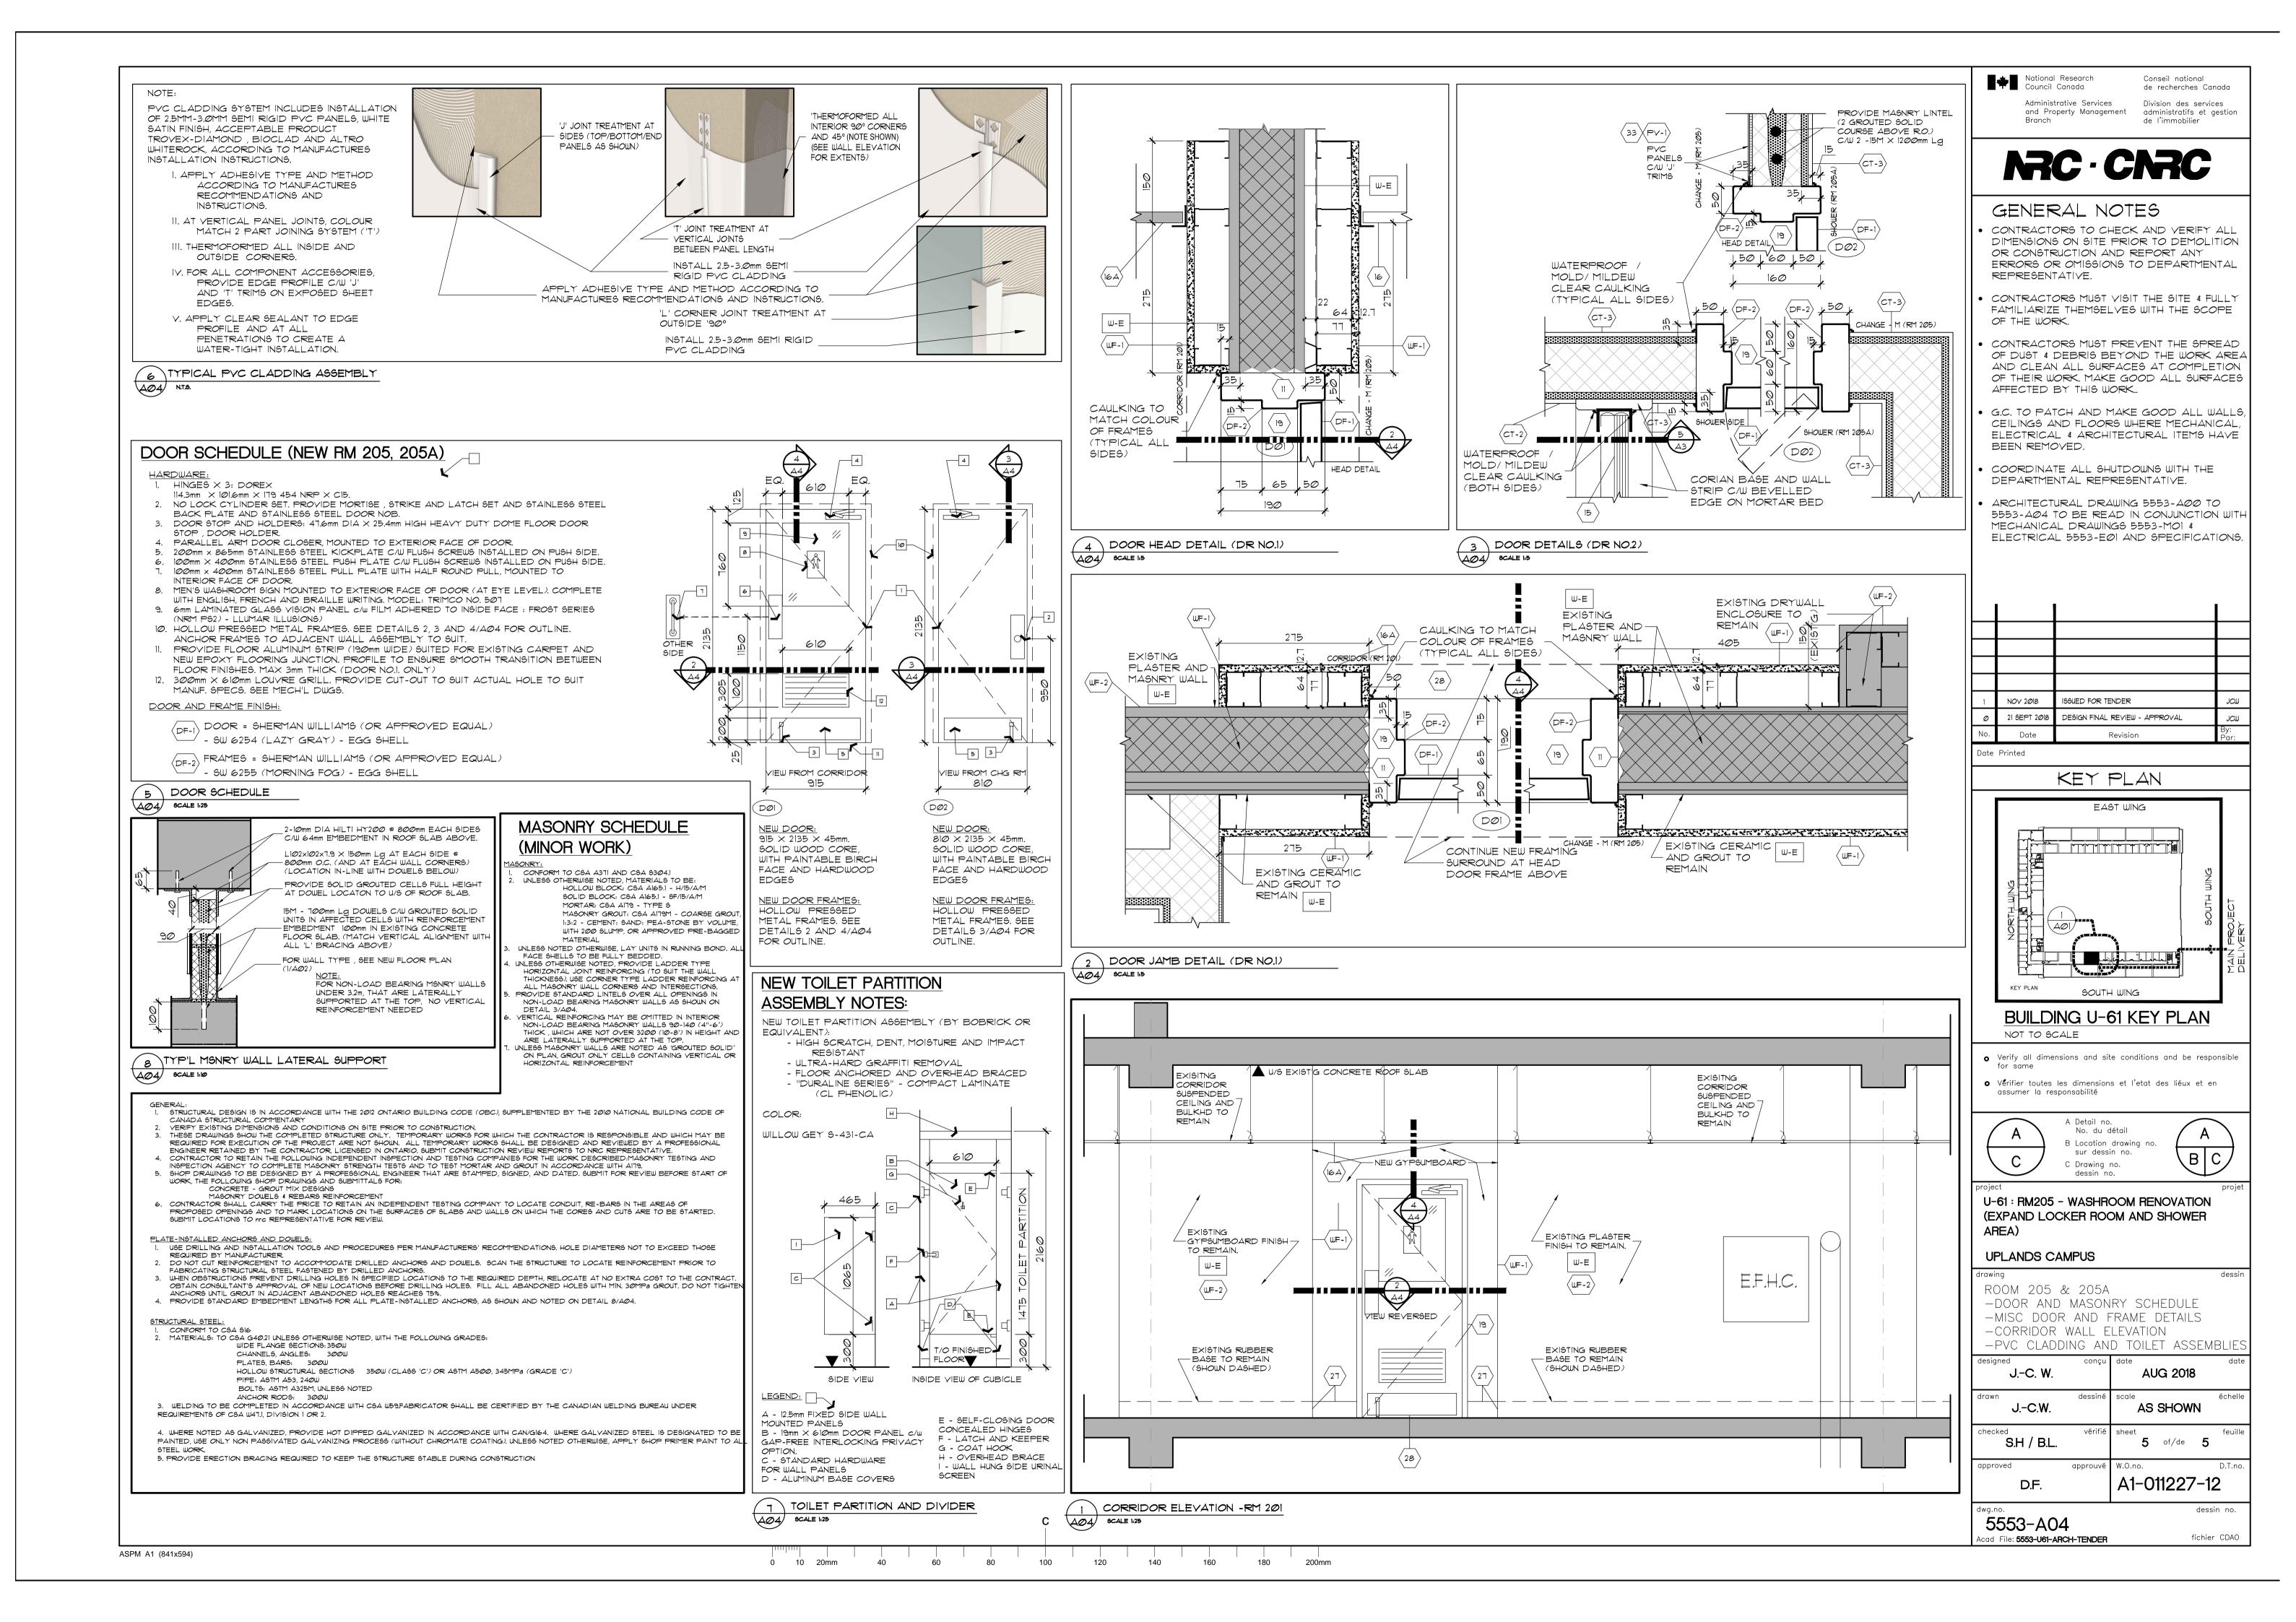



M01 SCALE: 1:50

M01

SCALE: 1:50

FIXTURE SCHEDULE DCW DHW DHWR SAN VENT REMARKS LAV1 LAVATORY 13ø | 13ø | N/A | 38ø 38ø NEW- LAVATORY, MANUAL FAUCET FD1 FLOOR DRAIN --75ø NEW- SEE SPECIFICATIONS WC1 WATER CLOSET | 25ø | N/A | N/A | 75ø | NEW- FLOOR MOUNT- FLUSH VALVE UR1 20ø | N/A | N/A | NEW- WALL MOUNT URINAL SD1 -- | -- | --50ø SHOWER DRAIN NEW- SEE SPECIFICATIONS

### NOTE:


NEW FIXTURES ARE TO BE CONNECTED TO EXISTING DOMESTIC COLD WATER, DOMESTIC HOT WATER, DOMESTIC HOT WATER, SANITARY DRAIN AND VENT SERVICES. ALL NEW DOMESTIC COLD, DOMESTIC HOT TO BE INSULATED AS PER SPECIFICATIONS. NOTE THAT ALL URINALS SHALL BE HANDS FREE OPERATION.

NEW- SEE SPECIFICATIONS

--

13ø | 13ø |

- ALL SANITARY PIPING TO BE SLOPED AS PER NATIONAL BUILDING CODE STANDARDS (NBC). PROVIDE NEW BALL TYPE ISOLATION VALVES ON ALL INCOMING DOMESTIC HOT AND COLD WATER SERVICES TO LAV1'S UNDER THE LAVATORIES. VALVES SHALL BE INSTALLED IN WALLS, ACCESSIBLE BY STAINLESS STEEL ACCESS DOORS.
- NEW WATER CLOSET (WC1) IS BASED ON AN AMERICAN STANDARD "MADERA" (TOP SPUD- FLOOR MOUNTED) C/W MANUAL AMERICAN STANDARD (1-1/2" TOP SPUD) FLUSHOMETER (MODEL 6047.161.002). NEW URINAL (UR1) IS BASED ON AMERICAN STANDARD MODEL "WASHBROOK" C/W AUTOMATIC FLUSH VALVE, AMERICAN STANDARD MODEL 6063101. NOTE DOMESTIC COLD WATER FEED TO BE BROUGHT FROM BELOW URINALS WITH SINGLE BALL
- TYPE ISOLATION VALVE INSTALLED IN WALL ACCESSIBLE THROUGH STAINLESS STEEL ACCESS DOOR AND THEN UP TO URINAL NEW LAVATORY (LAV1) IS BASED ON AMERICAN STANDARD MODEL "MURRO" C/W AMERICAN STANDARD SUPPLIED KNEE SHROUD AND FAUCET IS BASED ON AN AMERICAN STANDARD MODEL "MONTERREY- MODEL 7500.170" MANUAL OPERATION.
- NEW FLOOR DRAIN (FD1) IS BASED ON A WATTS FD-100 AND IS TO BE SUPPLIED WITH A TRAP SEAL PRIMER CONNECTED TO THE DOMESTIC COLD WATER TO OF THE NEW LAVATORY (LAV1).
- NEW SHOWER HEAD, CONTROL TRIM AND MIXING VALVE ARE BASED ON AMERICAN STANDARD MODEL "RELIANT 3" SHOWER ONLY TRIM KIT C/W AMERICAN STANDARD MODEL R121 PRESSURE BALANCE VALVE. SHOWER DRAIN IS BASED ON WATTS
- CONTRACTOR SHALL SCAN FLOOR BEFORE CORING ANY NEW HOLES. PATCH AND REPAIR EXISTING, ABANDONED CORE HOLES USING CONCRETE AS PER INSTRUCTIONS IN ARCHITECTURAL

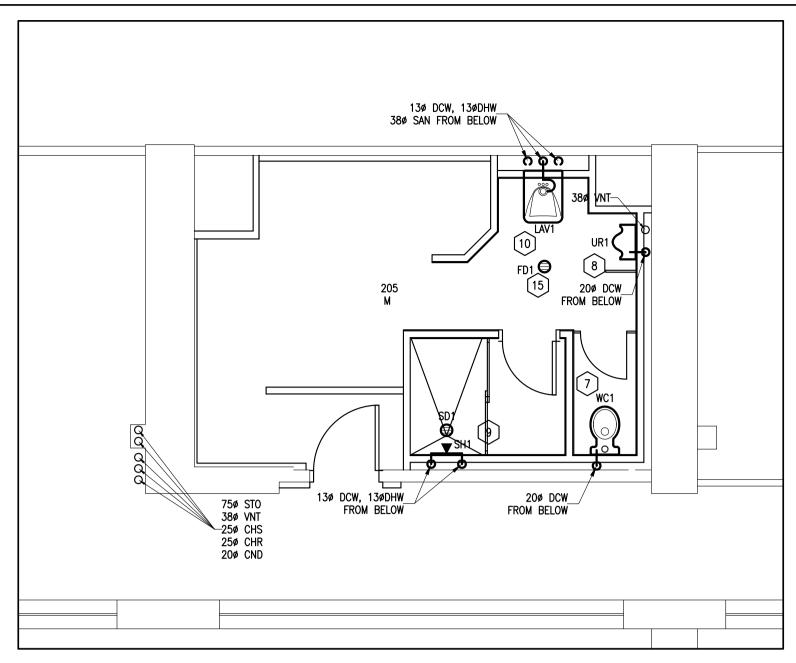



### U-61 PART PLAN- ROOM 205 PLUMBING NEW WORK

SCALE: 1:50

38ø VNT------SH 7 1 \_\_\_\_\_ 25ø CHS 25ø CHR 20ø CND



#### U-61 PART PLAN- ROOM 205 PLUMBING DEMOLITION

SCALE: 1:50


DIFFUSER AND GRILLE SCHEDULE TYPE REMARKS (MMXMM) (MMXMM) 150X150 100X100 35 L/S EGG-CRATE NEW LOUVRE FACE N/A 600X300 NEW

NEW EXHAUST GRILLES EG1'S ARE BASED ON EH PRICE MODEL 80, COLOUR WHITE. REFER TO

SPECIFICATION FOR ADDITIONAL DETAILS. NEW TRANSFER GRILLE MOUNTED IN NEW WASHROOM DOOR IS BASED ON A E.H. PRICE MODEL 535, WITH 45° DEFLECTION, 13MM BLADE SPACING. GRILLE TO BE MOUNTED ON EXTERIOR OF DOOR.

13ø DCW, 13ø DHW ABOVE FROM FD1 20ø DCW 50ø SAN\_ FROM ABOVE 75¢ SAN DOWN 13ø DCW 9 13ø DHW 20ø DCW\_

U-61 PART PLAN- ROOM 107 PLUMBING NEW WORK M01 SCALE: 1:50

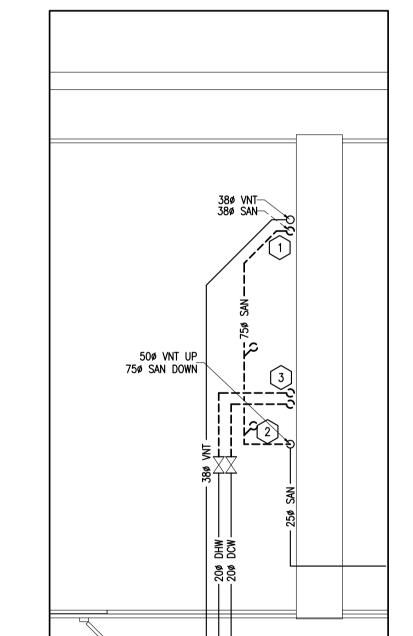

U-61 PART PLAN- ROOM 107 PLUMBING DEMOLITION

SCALE: 1:50

M01

	MECHANICAL LEGEND
SYMBOL	DESCRIPTION
$\bowtie$	GATE VALVE
$\square$	BALL VALVE
0	PIPE UP
n	PIPE DOWN
ی	SANITARY TRAP
<b>-</b> 11	CLEAN-OUT
1 1	UNION
Г	CAP
O	FLOOR CLEAN OUT
⊜	FLOOR DRAIN (FD1)/ SHOWER DRAIN (SH1)
	WATER CLOSET
•	SHOWER HEAD
	LAVATORY SINK
$\triangle$	URINAL
	EXHAUST GRILLE
BD	BALANCING DAMPER
	TRANSFER DUCT
	RECTANGULAR DUCTWORK

	MECHANICAL LINE TYPE LEGEND						
LINE	DESCRIPTION						
DCW	DOMESTIC COLD WATER						
DHW	DOMESTIC HOT WATER						
SAN	SANITARY PIPING						
v	VENT PIPING						
	UNDERGROUND PIPING						
	INDICATES NEW						
	INDICATES EXISTING (TO REMAIN)						
	INDICATES DEMOLISHED/ REMOVED						

#### MECHANICAL DRAWING NOTES: (x)

- ISOLATE, DISCONNECT AND REMOVE EXISTING LAVATORY (LAV), TRIM, ASSOCIATED DOMESTIC HOT (DHW) WATER, DOMESTIC COLD (DCW) WATER AND SANITARY DRAIN PIPING AS INDICATED. MAIN ISOLATION VALVES ARE LOCATED IN CEILING SPACE OF FLOOR BELOW. ALL
- MATERIAL TO BE DISPOSED OFF SITE AS PER SPECIFICATIONS. 2. ISOLATE, DISCONNECT AND REMOVE EXISTING WATER CLOSET (WC), ASSOCIATED DOMESTIC COLD WATER AND SANITARY PIPING AS INDICATED. ALL MATERIAL TO BE DISPOSED OFF
- 3. ISOLATE DISCONNECT AND REMOVE EXISTING SHOWER (SH), SHOWER DRAIN, DOMESTIC HOT WATER, DOMESTIC COLD WATER AND SANITARY DRAIN PIPING AS INDICATED. ALL MATERIAL TO BE DISPOSED OFF SITE AS PER SPECIFICATIONS.
- EXISTING EXHAUST GRILLES (EG) AND EXHAUST DUCTWORK AS INDICATED. TEMPORARILY CAP AND SEAL REMAINING DUCTWORK DURING CONSTRUCTION UNTIL READY FOR NEW
- 5. ISOLATE, REMOVE AND RETAIN TWO (2) SPRINKLERS AS INDICATED. RETAINED REMOVED
- NEW BRANCH PIPING REQUIRED. 6. INSTALL RETAINED SPRINKLERS AND PROVIDE ONE (1) NEW SPRINKLER AND ASSOCIATED
- BRANCH PIPING AS INDICATED. COORDINATE ALL LOCATIONS WITH LIGHTS AND EXHAUST
- 7. PROVIDE NEW WATER CLOSET (WC1), DOMESTIC COLD WATER AND SANITARY PIPING AS INDICATED. REFER TO SPECIFICATIONS AND SCHEDULE FOR ADDITIONAL INFORMATION.
- AS INDICATED. REFER TO SPECIFICATIONS AND SCHEDULE FOR ADDITIONAL INFORMATION. 9. PROVIDE NEW SHOWER (SH1), SHOWER HEAD, SHOWER DRAIN, DOMESTIC HOT WATER,
- AND SCHEDULE FOR ADDITIONAL INFORMATION. 10. PROVIDE NEW LAVATORY (LAV1), FAUCET, DOMESTIC COLD WATER, DOMESTIC HOT WATER
- ADDITIONAL INFORMATION. 11. VACUUM INTERIOR OF ALL EXISTING DUCTWORK TO ONE HOSE LENGTH DISTANCE FROM EACH EXISTING OPENING BEFORE COMMENCING NEW HVAC WORK.
- 12. PROVIDE NEW EXHAUST GRILLES (EG1) AND ASSOCIATED BRANCH DUCTWORK AS INDICATED. REFER TO SCHEDULE AND SPECIFICATIONS FOR AIR FLOWS AND BASIS OF DESIGN FOR
- 13. PROVIDE NEW TRANSFER GRILLES (TG1'S) SIZED AND LOCATED IN NEW DOOR AS INDICATED. COORDINATE DOOR OPENING CUTTING AND INSTALLATION WITH ARCHITECTURAL
- 14. TEST, ADJUST AND BALANCE FAN AND EXHAUST GRILLES TO AIR QUANTITIES INDICATED ON SCHEDULE.
- DCW FROM NEW LAVATORY (LAV1) DOMESTIC COLD WATER TO TRAP SEAL PRIMER ON

	MECHANICAL LEGEND
SYMBOL	DESCRIPTION
$\bowtie$	GATE VALVE
	BALL VALVE
0	PIPE UP
С	PIPE DOWN
v	SANITARY TRAP
٦I	CLEAN-OUT
Щ	UNION
[	CAP
0	FLOOR CLEAN OUT
	FLOOR DRAIN (FD1)/ SHOWER DRAIN (SH1)
	WATER CLOSET
•	SHOWER HEAD
	LAVATORY SINK
$\triangle$	URINAL
	EXHAUST GRILLE
BD	BALANCING DAMPER
	TRANSFER DUCT


	MECHANICAL LINE TYPE LEGEND
LINE	DESCRIPTION
—DCW——	DOMESTIC COLD WATER
——DHW——	DOMESTIC HOT WATER
SAN	SANITARY PIPING
— v —	VENT PIPING
	UNDERGROUND PIPING
	INDICATES NEW
	INDICATES EXISTING (TO REMAIN)
	INDICATES DEMOLISHED/ REMOVED

- SITE AS PER SPECIFICATIONS.
- ISOLATE AND SHUT DOWN EXISTING WASHROOM EXHAUST FAN, DISCONNECT AND REMOVE
- SPRINKLERS SHALL BE RE-INSTALLED TO SUIT NEW ROOM LAYOUT. PROVIDE ANY AND ALL
- 8. PROVIDE NEW URINAL (UR1), FLUSH VALVE, DOMESTIC COLD WATER AND SANITARY PIPING
- DOMESTIC COLD WATER AND SANITARY PIPING AS INDICATED. REFER TO SPECIFICATIONS
- AND SANITARY PIPING AS INDICATED. REFER TO SPECIFICATIONS AND SCHEDULE FOR


- 15. PROVIDE NEW FLOOR DRAIN (FD1), TRAP AND SANITARY PIPING AS INDICATED. PROVIDE 80 FLOOR DRAIN.

GEND		<b>Z≑</b> Z	National Research Council Canada	Conseil national de recherches Canada
RIPTION			Administrative Services and Property Management	Division des services administratifs et gestion
VALVE			Branch	de l'immobilier
VALVE				
E UP			ac · C	
DOWN				_
RY TRAP			GENERAL NOTES	S
N-OUT		DEMOLITIO	ORS TO CHECK AND VERIFY ALL [ N OR CONSTRUCTION AND REPORT NTAL REPRESENTATIVE.	
NION			ORS MUST VISIT THE SITE & FULL	Y FAMILIARIZE THEMSELVES WITH
CAP		THE SCOP	E OF THE WORK.	
CLEAN OUT			THE SPREAD OF DUST & DEBRIS SURFACES AT COMPLETION.	BEYOND THE WORK AREA AND
SHOWER DRAIN (SH1)		MAKE GOO	DD ALL SURFACES AFFECTED BY T	HIS WORK.
CLOSET		COORDINAT	TE ALL SHUTDOWNS WITH THE DEF	PARTMENTAL REPRESENTATIVE.
ER HEAD			ALL LABOUR AND MATERIAL REQUIF AL SYSTEM AS DESCRIBED ON DRA	
RY SINK				
INAL				
	•			

		CLEAN ALE SON ACES AT COMMENTAL.
)		MAKE GOOD ALL SURFACES AFFECTED BY THIS WORK.
		COORDINATE ALL SHUTDOWNS WITH THE DEPARTMENTAL REPRESENTATIVE.
		PROVIDE ALL LABOUR AND MATERIAL REQUIRED TO FORM A COMPLETE, FUNCTIONAL SYSTEM AS DESCRIBED ON DRAWINGS.
	1	

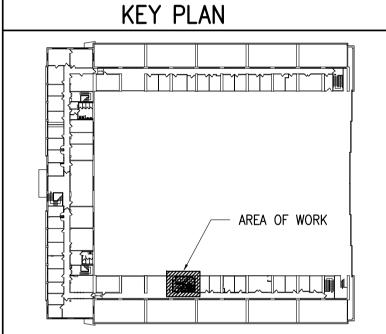


BUILDING U-61- SECOND FLOOR PLAN

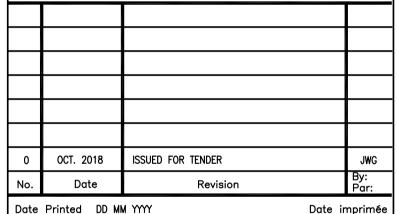

Verify all dimensions and site conditions and be responsible

o Vérifier toutes les dimensions et l'etat des liéux et en assumer la responsabilité

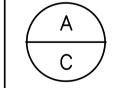

A Detail no. No. du détail

B Location drawing no. sur dessin no. C Drawing no.

Date imprimée

dessin no.

BUILDING U-61- ROOM 205- MEN'S WASHROOM RENOVATION


UPLANDS CAMPUS

MECHANICAL NEW WORK, DEMOLITION WORK, SCHEDULES AND DESCRIPTION OF WORK.

designed	JWG	conçu	OCT. 2018	ate
drawn	JWG	dessiné	AS INDICATED éch	elle
checked	ZM	vérifié	sheet feu <b>1</b> of/de <b>1</b>	ille
approved		approuvé	W.O.no. D.T.	no.
	BV		A1-011227-12	

5553-M01

ASPM A1 (841x594)

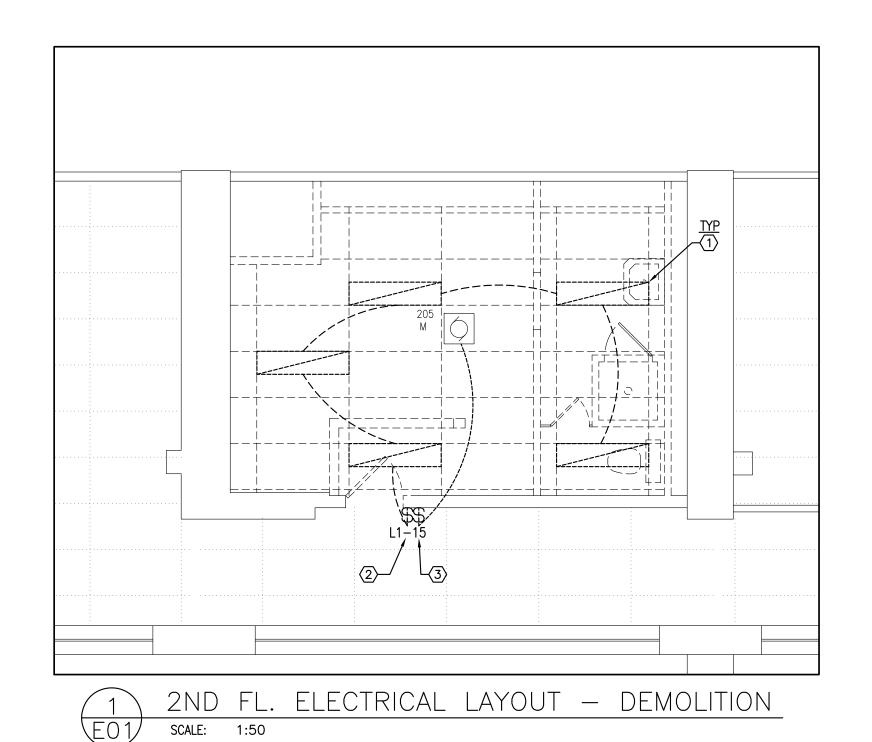

LEGEND

CEILING RECESSED LUMINAIRE, SIZE AS SHOWN

120V, 15A DUPLEX RECEPTACLE

120V, 15A GFCI DUPLEX RECEPTACLE

DARK SOLID LINE DENOTES NEW OR RELOCATED

LIGHT SOLID LINE DENOTES EXISTING TO REMAIN

DARK DASHED LINE DENOTES DEMOLITION

WALL MOUNTED MOTION CONTROL SWITCH


CEILING MOUNTED MOTION CONTROL SWITCH

SYMBOL DESCRIPTION

ELECTRICAL PANEL

CONDUIT UP

CONDUIT DOWN

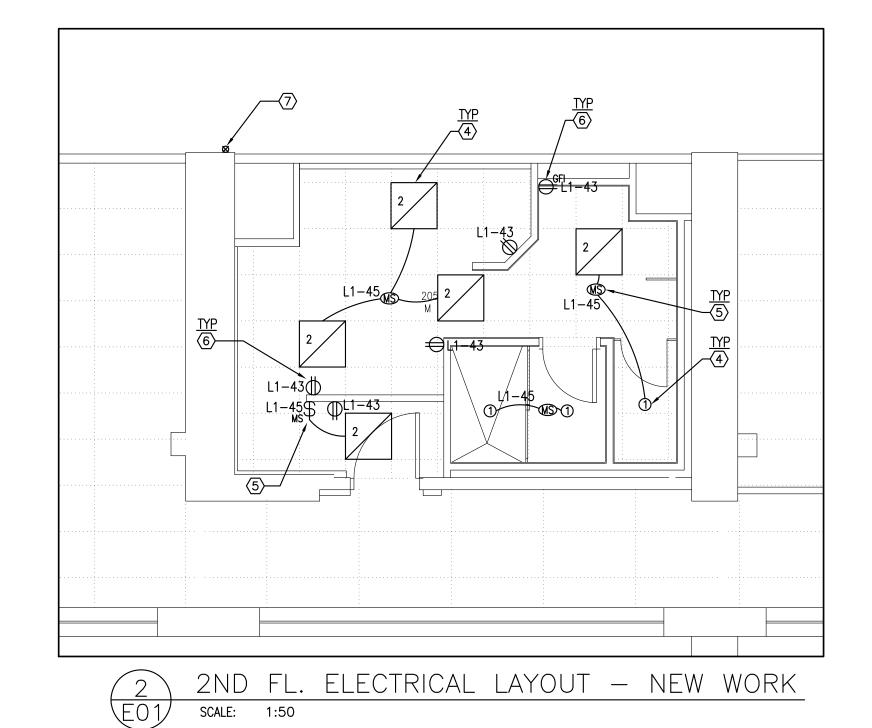

1ST FL. ELECTRICAL LAYOUT - NEW WORK SCALE: 1:50

LUMINAIRE SCHEDULE									
TYPE	LUMINAIRE TYPE	LAMP TYPE	LAMP WATT	LAMP VOLTAGE	MODEL NUMBER	SIZE	NOTES		
1	ROUND SLIM SURFACE LED	LED	14.2	120	PHILIPS S7R835K10AL	1	ALUMINUM FINISH RATED FOR WET LOCATION		
2	2'X2' RECESSED LED	LED	31.3	120	PHILIPS 2-AVE-G-32L-835-2-ACR-UNV-DIM	2'X2'			

#### GENERAL NOTES:

- A. READ THIS DRAWING IN CONJUNCTION WITH SPECIFICATIONS, ARCHITECTURAL AND MECHANICAL DRAWINGS.
- B. CONTRACTORS TO CHECK AND VERIFY ALL DIMENSIONS ON SITE PRIOR TO DEMOLITION OR CONSTRUCTION AND REPORT ANY ERRORS OR OMISSIONS TO NRC DEPARTMENTAL REPRESENTATIVE.
- C. CONTRACTORS MUST VISIT THE SITE & FULLY FAMILIARIZE THEMSELVES WITH THE SCOPE OF THE WORK.
- D. PREVENT THE SPREAD OF DUST & DEBRIS BEYOND THE WORK AREA AND CLEAN ALL SURFACES AT COMPLETION. MAKE GOOD ALL SURFACES AFFECTED BY THIS WORK.
- F. FILL ALL HOLES, PATCH & PAINT ALL SURFACES IN CONTRACT AREA. PAINT ALL SURFACE CONDUITS. COLOR SCHEME TO MATCH EXISTING.
- N. COORDINATE WORK WITH OTHER DIVISIONS FOR INSTALLATION AND TO AVOID INTERFERENCE. O. COORDINATE ALL SHUTDOWNS WITH THE NRC DEPARTMENTAL
- REPRESENTATIVE. P. REMOVE MEANS REMOVE AND DISPOSE OF OFF SITE UNLESS
- OTHERWISE NOTED. J. REMOVE REDUNDANT CONDUIT AND WIRING BACK TO SOURCE
- UNLESS OTHERWISE NOTED, AND MAKE SAFE. K. PROVIDE LABELS TO NEW DEVICES TO INDICATE POWER SOURCE. UPDATE PANEL SCHEDULES AFTER JOB COMPLETION.
- L. ALL INTERIOR WIRING SHALL BE #12 AWG CONDUCTOR MINIMUM. TYPE R90 XLPE CROSS-LINK POLYETHYLENE STRANDED FOR SIZE NO.8 AND LARGER. TYPE T90 STRANDED FOR SIZE NO.10 AND SMALLER. ALL NEW RACEWAYS SHALL BE THIN WALL ELECTRICAL METALLIC TUBING (EMT) 1/2" MINIMUM UNLESS OTHERWISE INDICATED. CONDUITS TO BE COMPLETE WITH INSULATED TYPE CONNECTORS AND BUSHING.
- N. SURFACE CONDUIT TO RUN PARALLEL OR PERPENDICULAR TO BUILDING LINES. ALL CONDUITS AND JUNCTION BOXES TO BE ANCHORED TO THE BUILDING STRUCTURE.
- O. THE WORD 'PROVIDE' MEANS SUPPLY, INSTALL, CONNECT AND TEST.


#### ELECTRICAL DRAWING NOTES: (X)

- 1. DISCONNECT AND REMOVE EXISTING LUMINAIRE, C/W ALL REDUNDANT WIRING AND CONDUITS, BACK TO SOURCE AND MAKE SAFE. REMAIN CIRCUIT IN THE AREA FOR CONNECTION TO NEW LUMINAIRE.
- 2. DISCONNECT AND REMOVE EXISTING SWITCH C/W ALL WIRING AND CONDUITS BACK TO SOURCE.
- 3. EXISTING EXHAUST FAN TO REMAIN AND TO BE CONTROLLED BY B.A.S. DIV.26 TO DISCONNECT AND REMOVE TOGGLE SWITCH FROM THE FAN. ENSURE THE FAN STILL OPERATES PROPERLY.
- 4. PROVIDE NEW LUMINAIRE AND CONNECT TO EXISTING CIRCUIT FOR THE AREA. REFER TO LUMINAIRE SCHEDULE FOR ADDITIONAL INFORMATION.
- 5. PROVIDE WALL OR CEILING MOUNTED MOTION DETECTOR AND CONNECT TO LUMINAIRES AS SHOWN. CONFIRM LOCATION AND MOUNTING ANGLE ON SITE TO ENSURE SWITCH OPERATES PROPERLY.
- 6. PROVIDE NEW RECEPTACLE, TYPE AS SHOWN, AND CONNECT TO CIRCUIT AS INDICATED.
- 7. REUSE TWO EXISTING 15A BREAKERS IN PANEL 'L1' AND CONNECT TO NEW LOADS AS SHOWN. RUN CONDUIT ON THE OUTSIDE WALL TO REACH 2ND FLOOR AND CONNECT TO THE LOADS.

National Research Council Canada

Conseil national de recherches Canada Administrative Services and Property Management Branch Division des services administratifs et gestion de l'immobilier




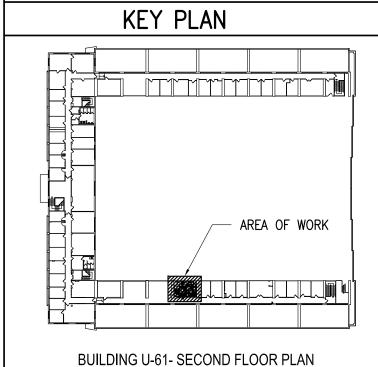

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o Vérifier toutes les dimensions et l'etat des liéux et en



BUILDING U-61- ROOM 205- MEN'S WASHROOM RENOVATION

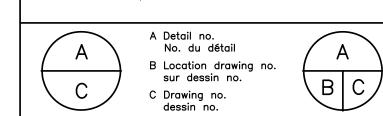UPLANDS CAMPUS

ELECTRICAL LAYOUT

CYC OCT. 2018 AS INDICATED CYC checked 1 of/de 1 approuvé W.O.no. A1-011227-12

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