




ELEVATION – TECK CABLE U/S OF EXIST. DECK **D**
E1 E3
SCALE : 1:20
0mm 500mm 1000mm 1500mm 2000mm 2500mm

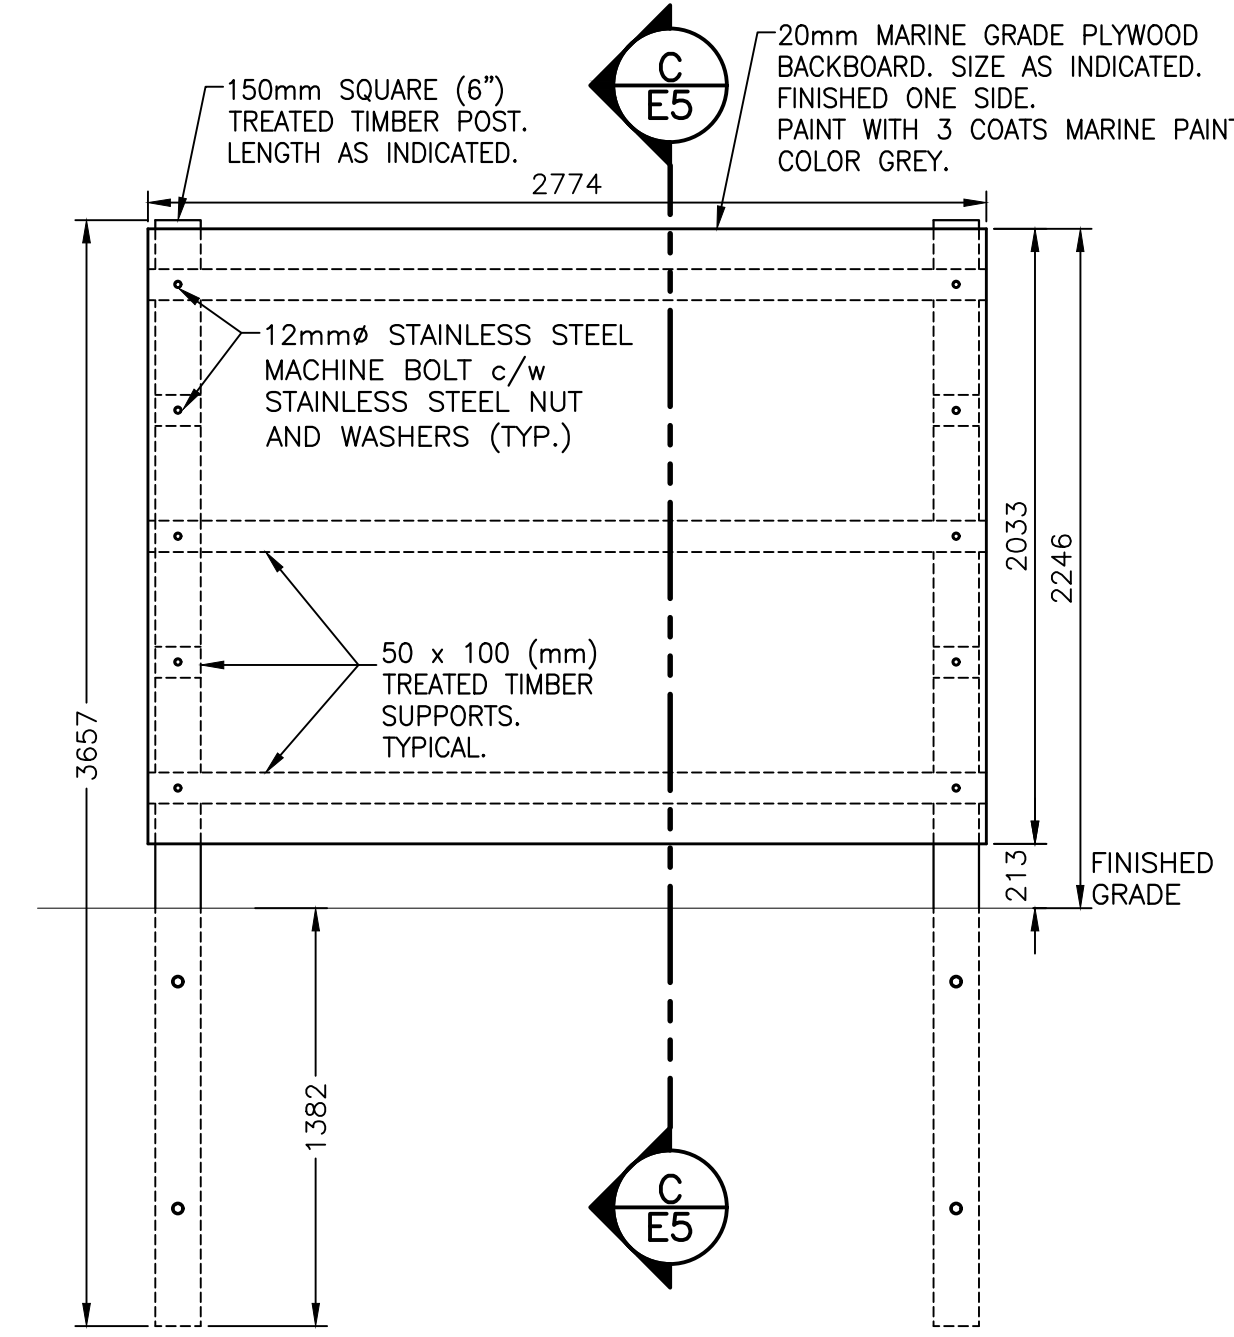

MAIN SERVICE BACKBOARD –STRUCTURAL **2**
E3
SCALE : 1:25
0mm 500mm 1000mm 1500mm 2000mm 2500mm
NOTE: ALL DIMENSIONS ARE IN MILLIMETERS.

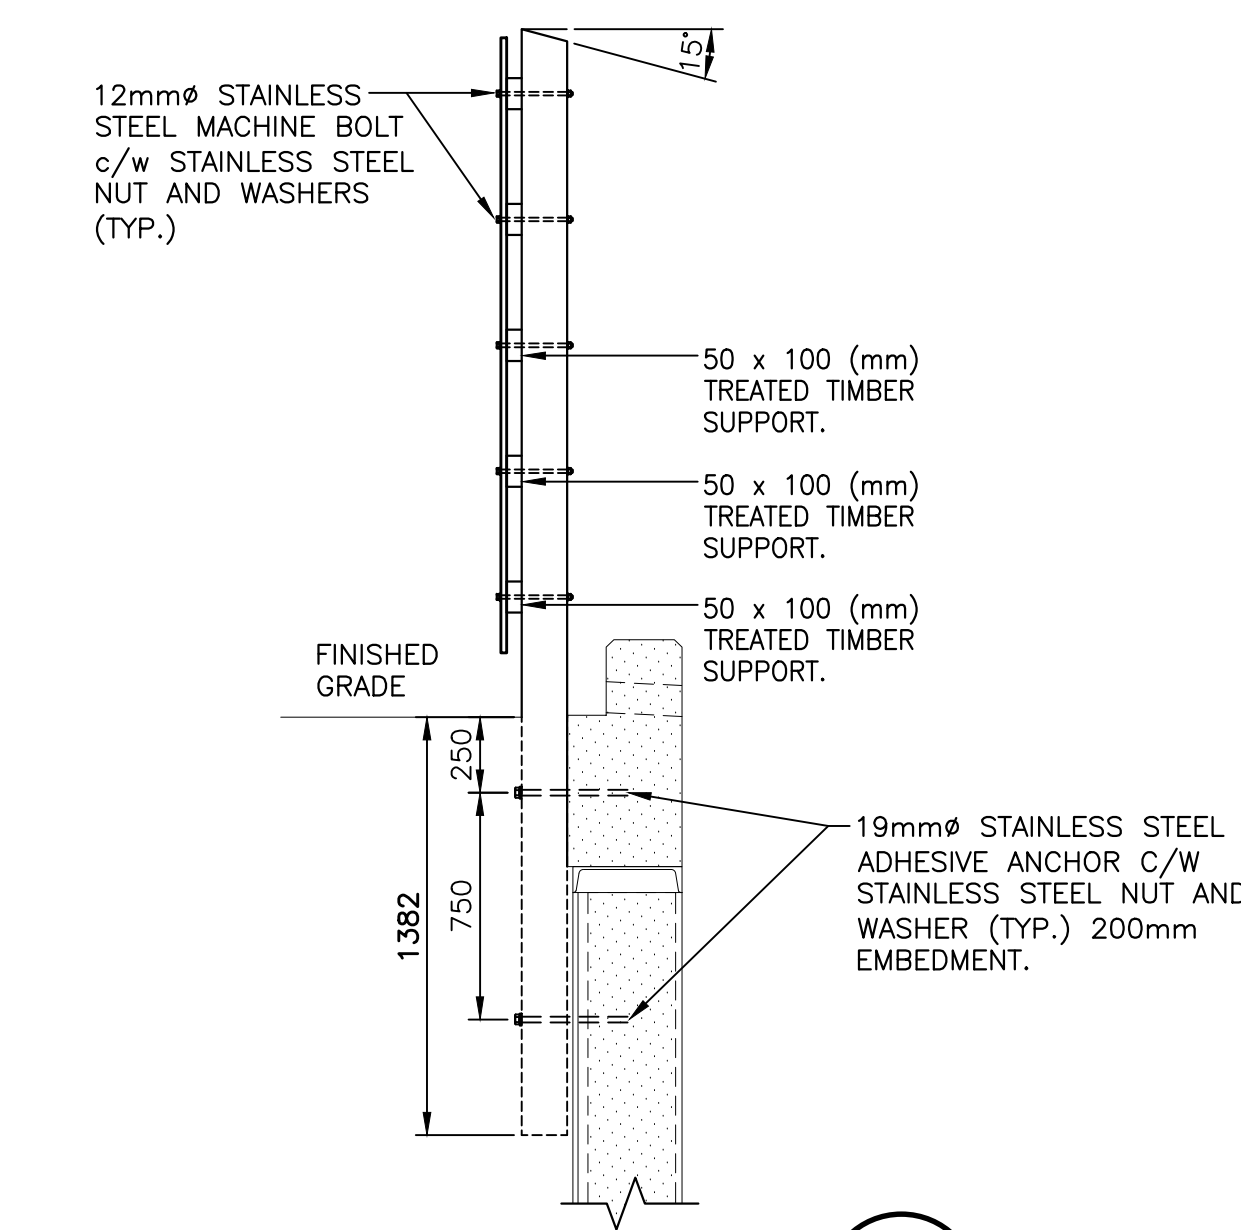

SECTION **C**
E3
SCALE : 1:25
0mm 500mm 1000mm 1500mm 2000mm 2500mm
NOTE: ALL DIMENSIONS ARE IN MILLIMETERS.

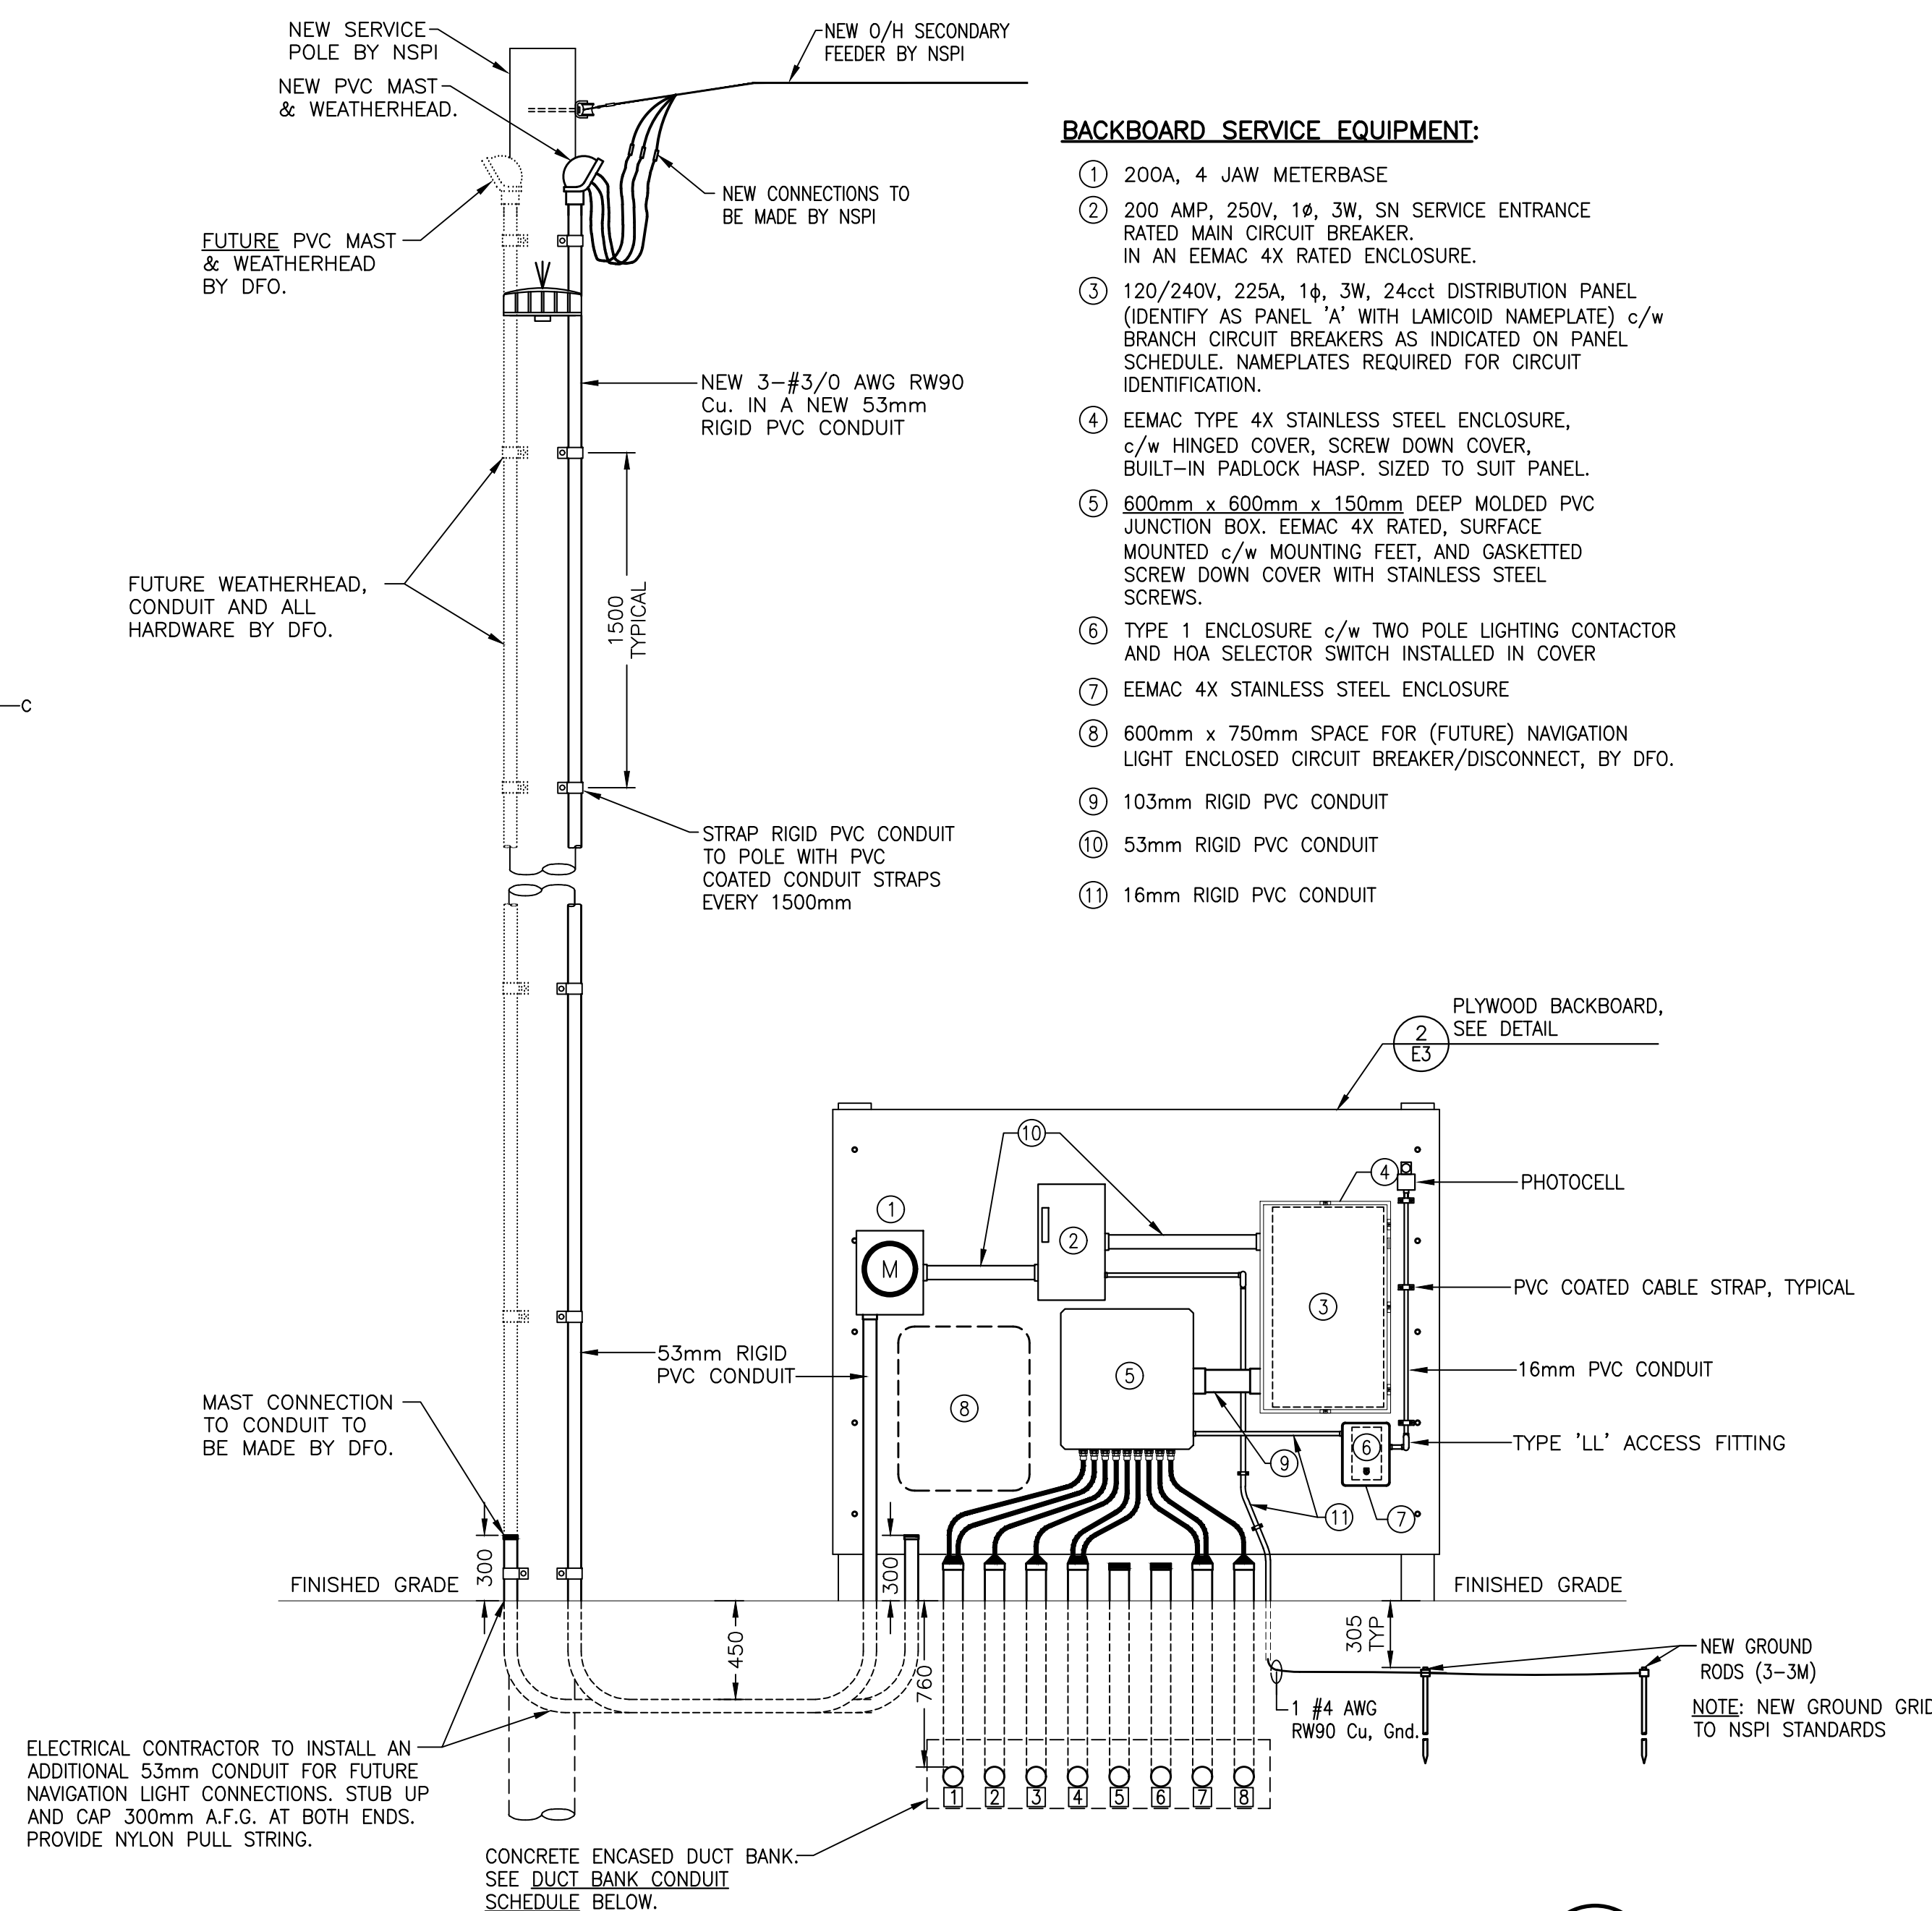

SERVICE POLE AND BACKBOARD **1**
E1 E3
SCALE : 1:25
0mm 500mm 1000mm 1500mm 2000mm 2500mm

NOTE:

- SERVICE POLE INSTALLED TO NSPI STANDARDS.
- ALL DIMENSIONS ARE IN MILLIMETERS.
- SEAL AROUND CONDUIT OPENINGS TO PREVENT WATER FROM ENTERING CONDUIT.
- ALL CONDUITS ARE TO BE COMPLETE WITH NYLON PULL STRING.
- ALL CONDUITS FOR FUTURE USE ARE TO BE CAPPED AND STUBBED UP AS PER DRAWINGS.

DUCT BANK CONDUIT SCHEDULE:

- 78MM CONDUIT TO POWER PEDESTAL PP#1
- 78MM CONDUIT TO POWER PEDESTAL PP#2
- 78MM CONDUIT TO LIGHT POLES LP#1, LP#2 AND LP#3
- 78MM CONDUIT TO POWER PEDESTAL PP#3
- 78MM CONDUIT FOR FUTURE DERRICK
- 78MM CONDUIT FOR NAVIGATION LIGHT
- 78MM CONDUIT FOR POWER PEDESTAL PP#4
- 78MM CONDUIT TO LIGHT POLE LP#4

0	ISSUED FOR TENDER	NOV. 2018
revisions		date
project	project	
BERLIN WALL APPROACH STRUCTURE PEREAU (DELHAVEN) KINGS COUNTY NOVA SCOTIA		
drawing	dessin	
SITE ELECTRICAL DETAILS		
designed	K.WOLFE	conçu
date	NOVEMBER 2018	
drawn	K.WOLFE	dessiné
date	NOVEMBER 2018	
approved	approuvé	
date		
Tender	Soumission	
PWSC Project Manager	Administrateur de projets TPSCG	
project number	no. du projet	
R.100038.001		
drawing no.	no. du dessin	