INSTITUTE OF OCEAN SCIENCES DEPOT LIGHTING UPGRADES

ISSUED FOR TENDER

DRAWING INDEX								
DRAWING No.	DRAWING No. DESCRIPTION							
E000	COVER SHEET & DRAWING INDEX	PA						
E001	SYMBOL LEGEND, KEY PLAN & GENERAL NOTES	PA						
E002	SITE PLAN	PA						
E100	AREA ENLARGEMENT - WINCH SHOP - DEMOLITION	PA						
E101	AREA ENLARGEMENT - WINCH SHOP - PROPOSED	PA						
E102	AREA ENLARGEMENT - DEPOT	PA						
E120	WORKSHOP/HANGAR LOWER LEVEL	PA						
E121	WORKSHOP/HANGAR UPPER LEVEL	PA						
E500	DETAILS	PA						
E510	LIGHTING RELAY SCHEDULES	PA						
E600	LUMINAIRE SCHEDULE	PA						



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PA	18N0V23	ISSUED FOR REVIEW	ABS	RC	RC	PROJECT
Rev.	DATE	ISSUE / REVISION DESCRIPTION	DESN	QC	QA	IN

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Fisheries and Oceans Canada

NSTITUTE OF OCEAN SCIENCES
DEPOT LIGHTING UPGRADES

PBX ENSINEERING

COVER SHEET & DRAWING INDEX

SCALE PROJECT NUMBER DRAWING NUMBER AS SULGIANA 19440 FOOO

LINE TYPE LEGEND						
LINE	DESCRIPTION					
	120/240V CONDUIT/CABLE					
·_	347/600V CONDUIT/CABLE					
	OVER 600V CONDUIT/CABLE					
	COMMUNICATIONS CONDUIT/CABLE					
	TECK CONDUIT/CABLE					
	IN SLAB CONDUIT/CABLE					

ELECTRICAL CIVIL NOTES:

- .1 ALL CONDUITS SHALL BE VERIPIED USING THE FOLLOWING PROCEDURE:

 1 TO VERIPY INTEGRITY OF CONDUIT PULL THROUGH EACH DUCT A HARD
 RUBBER MANDREI, NOT LESS THAN JOOMM LONG AND OF A DUMBERE
 6mm LESS THAN INTERNAL DUMBERE OF DUCT, PRECEDED BY A SWAB
 OF SUITABLE DUMBEREN TO REMOVE SAND, EARTH, AND OTHER FOREIGN
 MATERIALS.
 2 CLEAN DUCTS BEFORE LAYING, CAP ENDS OF DUCTS DURING
 CONSTRUCTION AND AFTER INSTALLATION TO PREVENT ENTRANCE OF
 REPERLON MATERIALS.
- FOREIGN MATERIALS.
- .3 INSTALL PULL LINE AND CAP ENDS OF DUCT USING RUBBER DUCT
- INSIAL FULL LINE AND CAP ENDS OF DUCT USING RUBBER DUCT INSIAL PULL LINE AND LAYER APPLIES AND SHALL BE COPPED. PULL STRING SHALL NE POLYPROPYLENE WITH A MINIMUM TENSILE STRENGTH OF 1.14M.
 CONDUIT LOCATIONS ARE APPROXIMENTE. CONTRACTOR TO INSTALL EACH CONDUIT AS APPROPRIATE FOR EQUIPMENT LOCATIONS.

ELECTRICAL GENERAL NOTES:

- .1 NOT ALL SYMBOLS MAY APPEAR ON ALL DRAWINGS.
 .2 ALL CONCRETE BASES, OUTDOOR LUMINAIRES, AND JB SYMBOLS ARE NOT TO SCALE.
- .3 COORDINATE ALL WORK WITH OWNER AND CIVIL CONTRACTOR.
- .4 ALL DIMENSIONS ARE IN MM UNLESS NOTED OTHERWISE.
 5 CONTRACTOR SHALL READ THESE DRAWINGS AND SPECIFICATIONS IN CONJUNCTION WITH THE CANADIAN ELECTRICAL CODE (CURRENT EDITION) AND
- CONTOUR TIME WITH THE UNBODIENT ELECTRICAL CODE, CLOTHER LETTING AND THE BC BUILDING CODE (CURRENT EDITION), ALL WORK SHALL BE IN COMPLIANCE WITH THESE CODES.

 6. INFORMATION ON THESE DRAWINGS HAS BEEN RECEIVED FROM RECORD INFORMATION PROVIDED BY OTHERS. CONTRACTOR SHALL VISIT THE SITE AND CONFIRM EACH LOCATIONS OF EQUIPMENT AND CONDUTT ON SITE. NOTIFY
- DIFFERENCES OF ANY DESCREPANCIES IMMEDIATELY PRIOR TO PERFORMING.

 7. ALL IN-GROUND CONDUITS SHALL DRAIN TO JUNCTION BOX.

 8. THE CONTRACTOR SHALL PROVIDE AND INSTALL ALL NECESSARY BENDS,
 COUPLINGS, REDUCERS, BELL END FITTINGS, PLUGS, CAPS, AND ADAPTOR
 TO THE SAME PRODUCT MATERIAL AS THE CONDUIT TO ENSURE A COMPLETE INSTALLATION
- INSTALLATION.

 9 ALL MANUFACTURER AND EQUIPMENT LABELS SHALL BE VISIBLE ON COMPLETION OF INSTALLATION.

 10 PROVIDE GROUNDING AND BONDING IN COMPLIANCE WITH THE CANADIAN ELECTRICAL CODE. SUPPLY COPIES OF ALL INSPECTION REPORTS TO ENGINEER WITHIN 24 HOURS OF INSPECTION.








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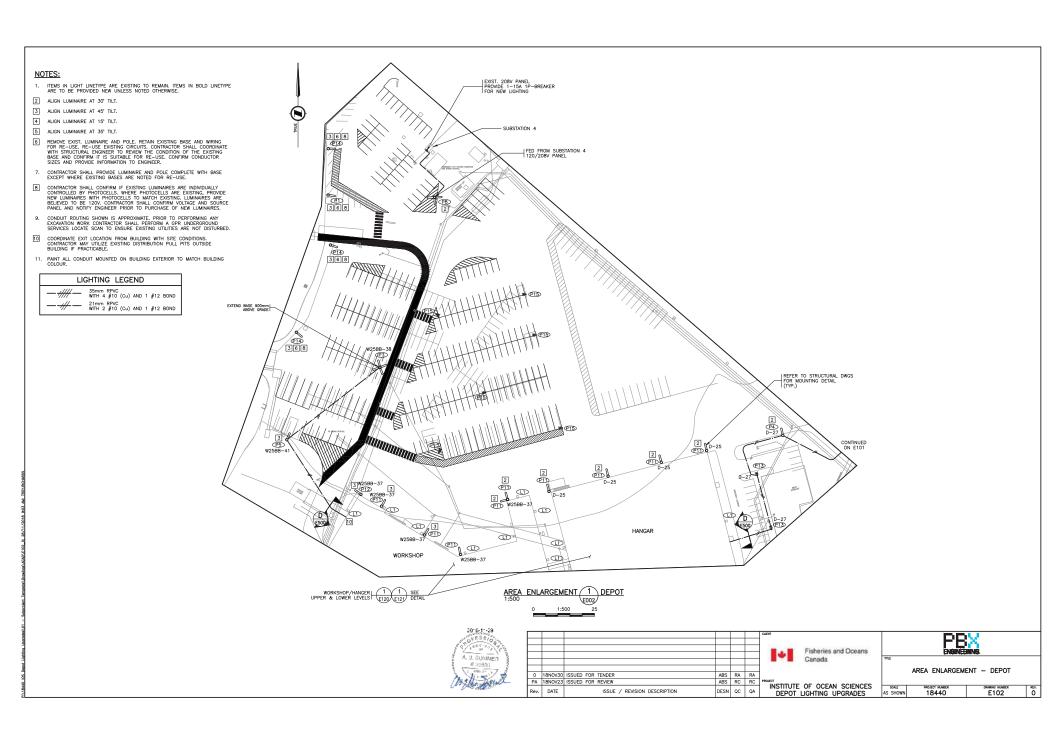
SYMBOL LEGEND, KEY PLAN, & GENERAL NOTES


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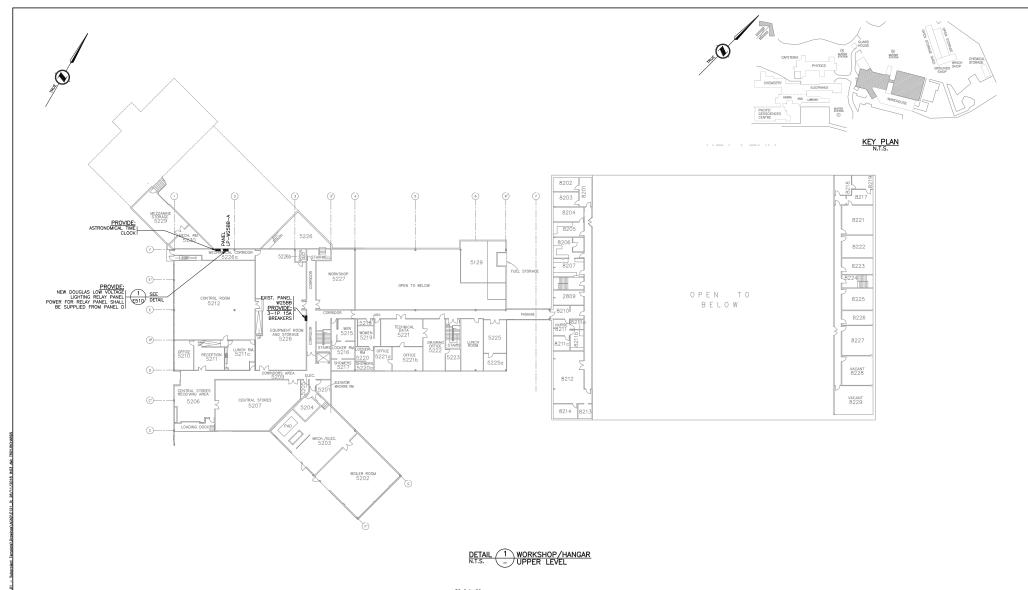




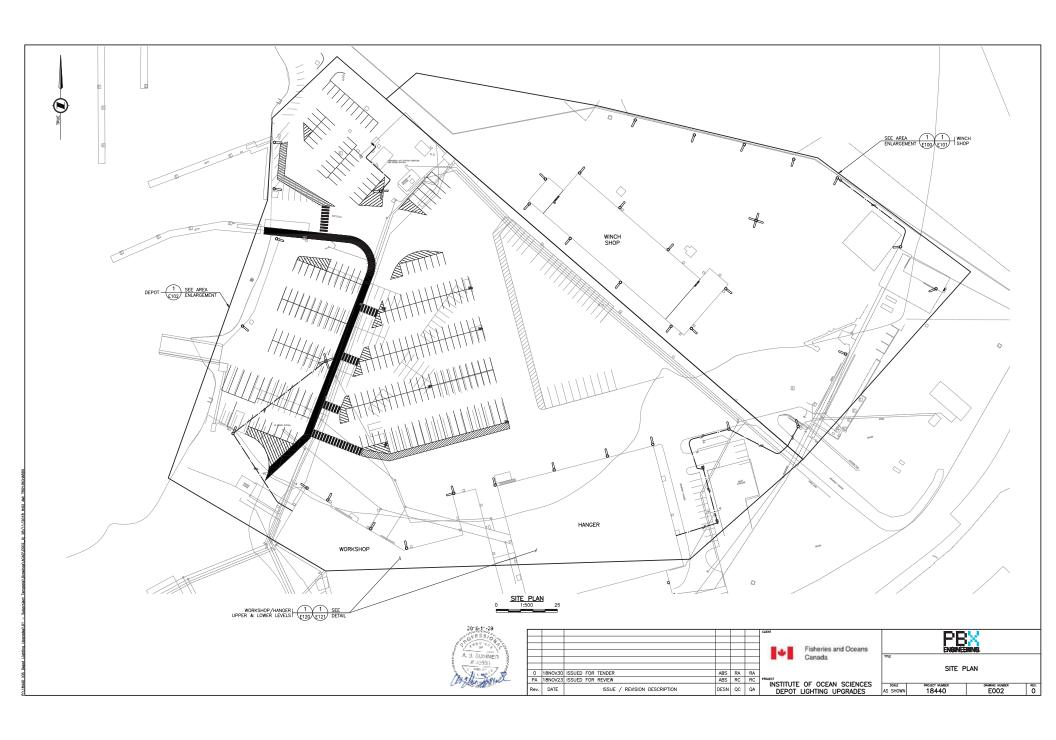

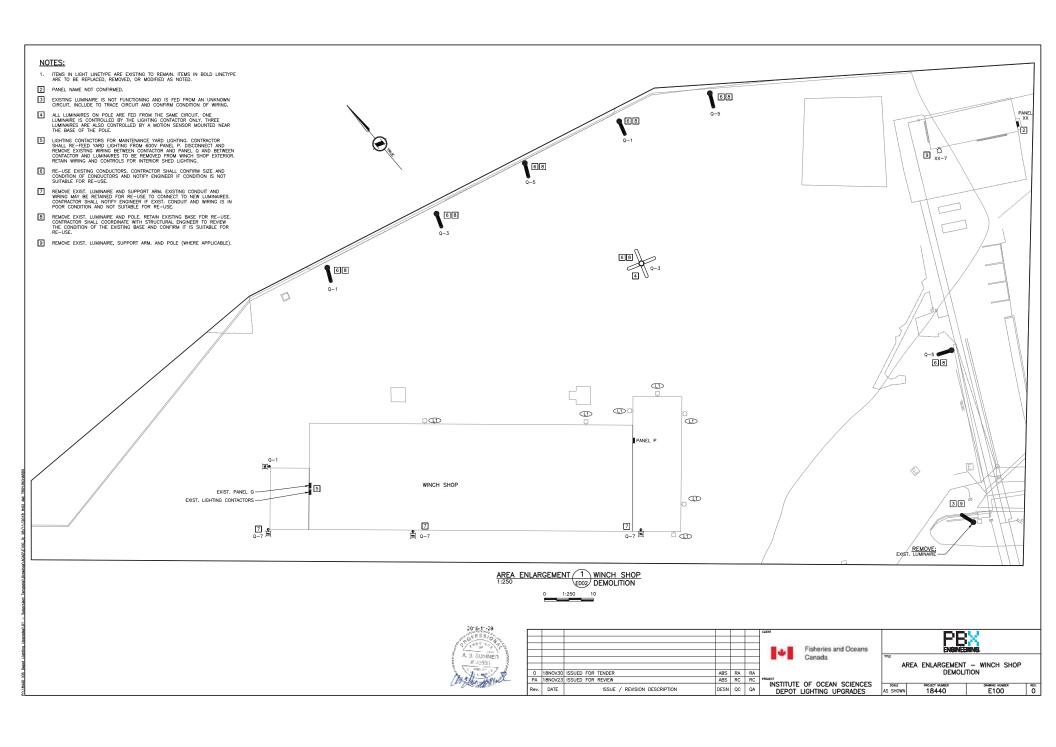

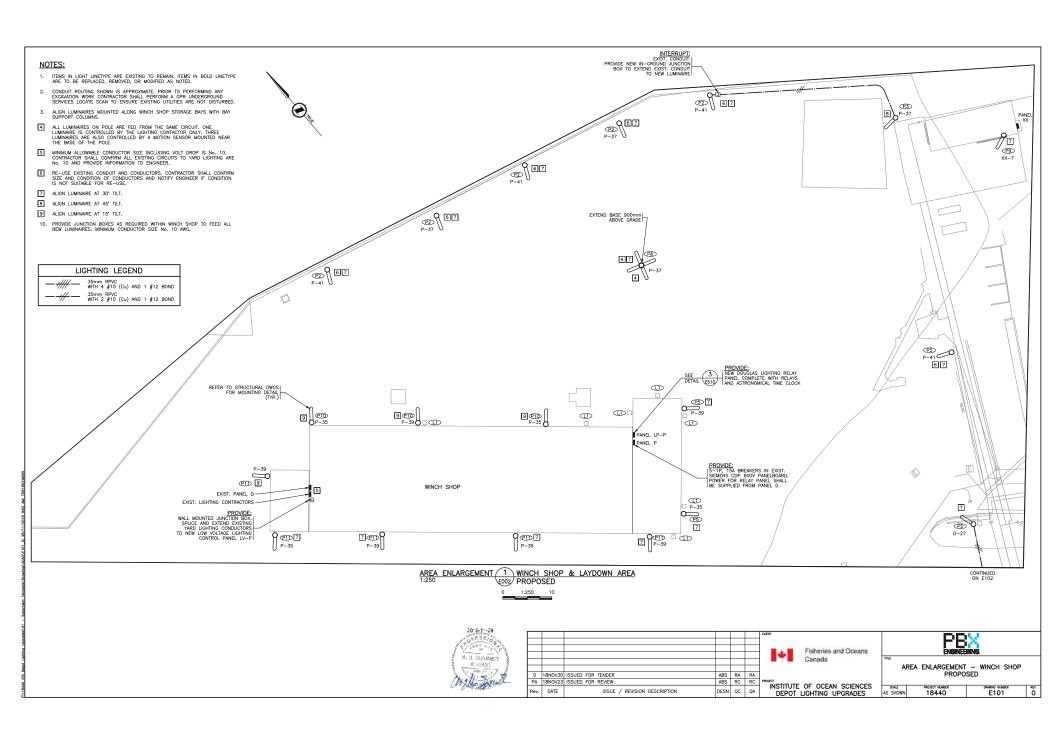

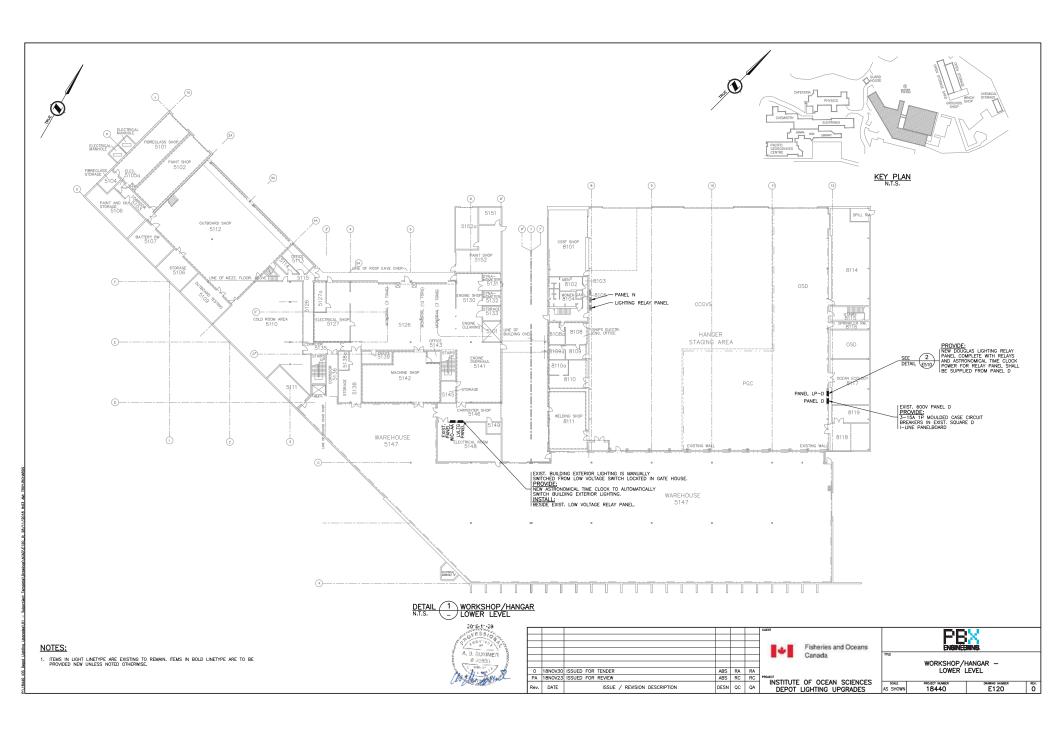

NOTES:

ITEMS IN LIGHT LINETYPE ARE EXISTING TO REMAIN. ITEMS IN BOLD LINETYPE ARE TO BE PROVIDED NEW UNLESS NOTES OTHERWISE.



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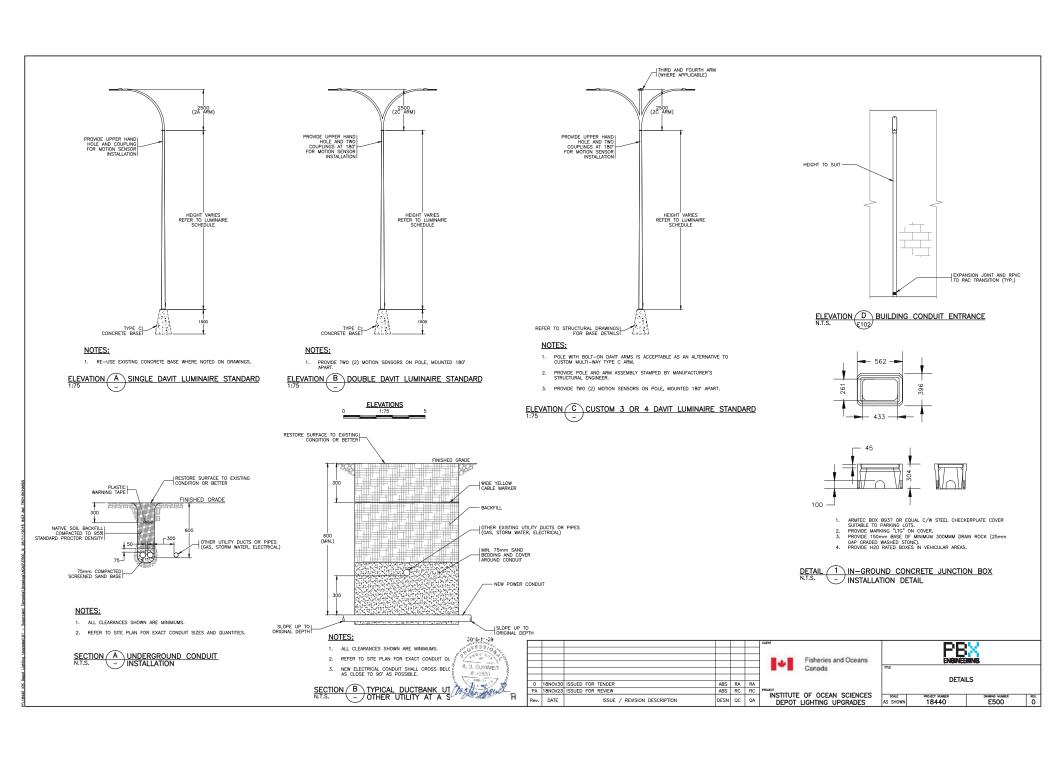


Fisheries and Oceans Canada

PBX WORKSHOP/HANGAR -UPPER LEVEL PROJECT NUMBER 18440

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INSTITUTE OF OCEAN SCIENCES DEPOT LIGHTING UPGRADES





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DEPOT LIGHTING UPGRADES

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Fisheries and Oceans

	LIGHTING RELAY	SCHEDULES
wn	18440	E510

SPARE	9
SPARE	10
SPARE	11
SPARE	12
NOTE DESCRIPTION	
	SPARE SPARE SPARE

WORKSHOP LIGHTING CONTROL PANEL

2

4

7

DESCRIPTION

PARKING PARKING

SPARE

SPARE

SPARE

SPARE

WORKSHOP PERIMETER LTG

						LP-W25BB-A
I.T.S.	E121	RELAY	SC	HEDUL	E	

	NOTE DESCRIPTION	
1		
2		
3		
4		

WORKSHOP LIGHTING CONTROL PANEL

2

4

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7

8

9

10

11

12

DESCRIPTION

HANGAR PERIMETER LIGHTING HANGAR EAST PARKING & BINS

SPARE

SPARE SPARE

SPARE

SPARE

SPARE

SPARE

SPARE

SPARE

DETAIL	(2)	LIGHTIN	١G	RELAY	PANEL	LP-D
N.T.S.	E120	RELAY	SC	HEDUL	E	

NOTE	DESCRIPTION	RELAY		
	LAYDOWN AREA LTG	1		
	LAYDOWN AREA LTG	2		
	WINCH SHOP PERIMETER LTG	3		
	WINCH SHOP PERIMETER LTG	4		
	SPARE	5		
	SPARE	6		
	SPARE	7		
	SPARE	8		
	SPARE	9		
	SPARE	10		
	SPARE	11		
	SPARE	12		
	NOTE DESCRIPTION			
1				
2				
3				
4				

MAINTENANCE LIGHTING CONTROL PANEL

 $\underbrace{\text{DETAIL}}_{\text{N.T.S.}}\underbrace{3}_{\text{E101}}\underbrace{\text{LIGHTING}}_{\text{RELAY}}\underbrace{\text{PANEL}}_{\text{ED01}}\underbrace{\text{LP-P}}_{\text{RELAY}}$

	LUMINAIRE SCHEDULE										
TYPE		LUMINAIRE DETAILS									
	DESCRIPTION	LUMINAIRE	DISTRIBUTION	DRIVER/ BALLAST	VOLTAGE	ACCESSORIES	POLE	MOUNTING HEIGHT (m)	BASE	MOUNTING	NOTES
P1	Single Davit Pole Mount Luminaire c/w pole and mounting	Philips Road Focus RFL-180/W80LED-3K-G2-R3M-UNV-DMG-PH9-RCD7- BR FINISH: BRONZE NO SUBSTITUTIONS	Type III Medium (ASYM)	LED	120V	Acuity Sensor Switch Outdoor Pole/Fixture Mount Motion Sensor SBOR 6 ODP D HVOLT WH 62 5V Contractor to provide white Nixalite Model S Bird Spikes or equivalent.		6	MMCD TYPE C	Pole Mounted C/W 2.5M DAVIT ARM	PROVIDE PHOTOCELLS WHERE PRESENT ON EXISTING LUMINAIRES TO BE REPLACED. OTHERWISE PROVIDE SHORTING CAP.
P2	Single Davit Pole Mount Luminaire c/w pole and mounting	Philips Road Focus RFL-180/W80LED-3K-G2-R3M-HVU-DMG-PH9-RCD7- BR FINISH: BRONZE NO SUBSTITUTIONS	Type III Medium (ASYM)	LED	347V	Aculty Sensor Switch Quiddoor Pole/Fixture Mount Motion Sensor SBOR 6 OEX D HVOLT WH 82 5V Contractor to provide white Nixalite Model S Bird Spikes or equivalent.	101–30–A2008A-F1 NSD 20x8 Single Davit, Galv, NOVA OR APPROVED EQUAL c/w 2.5m Davit Arm Galvanized Steel Finish	6	MMCD TYPE C	Pole Mounted C/W 2.5M DAVIT ARM	
P3	Single Davit Pole Mount Luminaire c/w pole and mounting	Philips Road Focus RFL_241W112LED3K-G2-R3M-HVU-DMG-PH9-RCD7- BR FINISH: BRONZE NO SUBSTITUTIONS	Type III Medium (ASYM)	LED	347V			6	MMCD TYPE C	Pole Mounted C/W 2.5M DAVIT ARM	
P4	Single Davit Pole Mount Luminaire c/w pole and mounting	Philips Road Focus RFL_241W112LED3K-G2-R3M-HVU-DMG-PH9-RCD7-BR FINISH: BRONZE NO SUBSTITUTIONS	Type III Medium (ASYM)	LED	347V		101-30-A2708A-F1 NSD 27x8 Single Davit, Galv, NOVA OR APPROVED EQUAL c/w 2.5m Davit Arm Galvanized Steel Finish	8	MMCD TYPE C	Pole Mounted C/W 2.5M DAVIT ARM	
P5	Single Davit Pole Mount Luminaire c/w pole and mounting	Philips Road Focus RFL-260W76LED3K-G2-R3M-HVU-DMG-PH9-RCD7-B R FINISH: BRONZE NO SUBSTITUTIONS	Type III Medium (ASYM)	LED	347V		101-30-A2008A-F1 NSD 20x8 Single Dovit, Galv, NOVA OR APPROVED EQUAL c/w 2.5m Dovit Arm Galvanized Steel Finish	6	MMCD TYPE C	Pole Mounted C/W 2.5M DAVIT ARM	
P6	4Way Custom Davit Pole Mount Luminaire c/w pole and mounting	Philips Road Focus RFL-180W80LED-3K-G2-R3M-HVU-DMG-PH9-RCD7-BR FINISH: BRONZE NO SUBSTITUTIONS	Type III Medium (ASYM)	LED	347V		CUSTOM - PROVIDE SHOP DRAWINGS STAMPED BY STRUCTURAL ENGINEER c/w 2.5m Davit Arm Galvanized Steel Finish	10	CUSTOM REFER TO STRUCTURAL DWGS	Pole Mounted C/W 2.5M DAVIT ARM	
P7	4-Way Custom Davit Pole Mount Luminaire c/w pole and mounting	METEOR Lighting – ILOS Corporation Bolt Series BTS—220—308—HVT—STV—80—BLK—BRK—GSV—RTC—OUT FINISH: BRONZE NO SUBSTITUTIONS	80 deg.	LED	347V		CUSTOM - PROVIDE SHOP DRAWINGS STAMPED BY STRUCTURAL ENGINEER c/w 2.5m Davit Arm Galvanized Steel Finish	12		Pole Mounted C/W 2.5M DAVIT ARM	
P8	3-Way Custom Davit Pole Mount Luminaire c/w pole and mounting	Philips Road Focus RFL_241W112LED3K-G2-R3M-UNV-DMG-PH8-RCD7- BR FINISH: BRONZE NO SUBSTITUTIONS	Type III Medium (ASYM)	LED	120V	Acuity Sensor Switch Outdoor Pole/Fixture Mount Motion Sensor SBOR 6 ODP D HVOLT WH BZ 5V	CUSTOM - PROVIDE SHOP DRAWINGS STAMPED BY STRUCTURAL ENGINEER c/w 2.5m Davit Arm Galvanized Steel Finish	10		Pole Mounted C/W 2.5M DAVIT ARM	MOTION SENSOR C/W INTEGRATED PHOTOCELL
P9	Custom Davit arm affixed to building.	Philips Road Focus RFL-145W64LED3K-G2-4-UNY-DMG-PH8-RCD7 -BR FINISH: BRONZE NO SUBSTITUTIONS	TYPE IV (ASYM)	LED	120V	Contractor to provide white Nixalite Model S Bird Spikes or equivalent.	101-30-A2008A-F1 NSD 20x8 Single Davit, Galv, NOVA OR APPROVED EQUAL c/w 2.5m Davit Arm Galvanized Steel Finish	6	N/A	Building mounted 2.5M davit arm	MOTION SENSOR C/W INTEGRATED PHOTOCELL
P10	Custom Davit arm affixed to building.	Philips Road Focus RFL-180W80LED3K-G2-R3M-HVU-DMG-PH9-RCD7 -BR FINISH: BRONZE NO SUBSTITUTIONS	Type III Medium (ASYM)	LED	347V		Pole extension c/w slipfit tenon top Galvanized Steel Finish	10	N/A	Building mount (30cm Arm)	
P11	Custom Davit arm affixed to building.	Philips Road Focus RFL_241W112LED3K-G2-R3M-HVU-DMG-PH9-RCD7- BR NO SUBSTITUTIONS	Type III Medium (ASYM)	LED	347V	Acuity Sensor Switch Outdoor Pole/Fixture Mount Motion Sensor SBOR 6 OEX D HVOLT WH BZ 5V Contractor to provide white Nixolite Model S Bird Spikes or equivalent.	c/w 2.5m Davit Arm Galvanized Steel Finish	10	N/A	Building mounted 2.5M davit arm	
P12	Custom Davit arm affixed to building.	Philips Road Focus RFL_260W76LED3K-G2_R3M-HVU-DMG-PH9-RCD7 -BR FINISH: BRONZE NO SUBSTITUTIONS	Type III Medium (ASYM)	LED	347V		101-30-A3208A-F1 NSD 32x8 Single Davit, Galv, NOVA OR APPROVED EQUAL c/w 2.5m Davit Arm Galvanized Steel Finish	10	N/A	Building mounted 2.5M davit arm	
P13	Pole Mount Luminaire	Philips Road Focus RFL-220W64LED3K-G2-5-HVU-DMG-PH9-RCD7 -BR FINISH: BRONZE NO SUBSTITUTIONS	Type V	LED	347V		101-70-1NST20_F1 NST 20 Straight Taper 2 3/6" Tenon, Galv, NOVA OR APPROVED EQUAL Pole c/w slipfit tenon Galvanized Steel Finish 101-30-A200BA_F1	6	MMCD TYPE B	Poletop c/w slipfit tenon	
P14	Single Davit Pole Mount Luminaire c/w pole and mounting	Philips Road Focus RFL—260W76LED3K—G2—R3M—UNV—DMG—PH9—RCD7—B R FINISH: BRONZE NO SUBSTITUTIONS	Type III Medium (ASYM)	LED	120V	Acuity Sensor Switch Outdoor Pole/Fixture Mount Motion Sensor SBOR 6 ODP D HVOLT WH BZ 5V Contractor to provide white Nixalite Model S Bird Spikes or equivalent.	101-30-A2008A-F1 NSD 20x8 Single Dovit, Golv, NOVA OR APPROVED EQUAL c/w 2.5m Dovit Arm Galvanized Steel Finish	6	MMCD TYPE C	Pole Mounted C/W 2.5M DAVIT ARM	PROVIDE PHOTOCELLS WHERE PRESENT ON EXISTING LUMINAIRES TO BE REPLACED.
P15	Solar Luminaire complete with solar panel, battery, photocell and motion sensor dimming control.	Solar Path HIGHLIGHT ALPYA-HAVE-D-150W-SLA-90W-T4M1-30K-D-150AH -EZ-1-01V		LED	SOLAR	Motion sensor profile to dim luminaire to 50%. Increase Level to 100% when motion detected. Contractor to provide white Nixalite Model S Bird Spikes or equivalent.	Supplied with luminaire	6	CUSTOM REFER TO STRUCTURAL DWGS EXTEND BASE 900mm ABOVE GRADE BASE TO BE WIDENED TO MOUNT BATTERY CABINET ON TOP OF BASE	Pole Mount	PROVIDE LUMINAIRES COMPLETE WITH INTEGRATED PHOTOCELL.
LI	Wall pack	Cooper Crosstour	-	LED	-	-	_	-	-	-	_

Notes:

1. REFER TO DRAWINGS FOR AIMING ANGLES



RA
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PBX ENGINEERING LUMINAIRE SCHEDULE

E600

PROJECT
INSTITUTE OF OCEAN SCIENCES
DEPOT LIGHTING UPGRADES

PROJECT NUMBER 18440

ALT --- ALTERNATE

ARCH --- ARCHITECTURAL

B/S --- BOTH SIDES

C/W --- COMPLE TE WITH

Q --- CENTRE LINE

CLR --- CONCRETE

CONC --- CONUMN

CONT --- CONTINUOUS

DP --- DEEP

DL --- DEAD LOAD

DWG --- DRAWING

E/E --- EACH END

E/F --- EACH FACE

E/S --- EACH SIDE

ELEV --- EACH WAY

EXT --- EXTERIOR

(E) --- EXISTING

GALV --- GALVANIZED

A.1.A. --- HOOKED ONE END

H.2.E. --- HOOKED TWO ENDS

HORIZ --- HORIZONTAL

INT --- INTERIOR

LG --- LONG

LL --- LONG WAY L/W --- LONG WAY SYMBOLS LEGEND ---- NEW STRIP FOOTING (PF1) NEW PAD FOOTING STRUCTURAL DRAWING LIST S101 ABBREVIATIONS, LEGEND, DRAWINGS LIST AND DRAWING ISSUE RECORD S102 SITE PLAN ELEVATIONS, SECTIONS & DETAILS STRUCTURAL DRAWING ISSUE RECORD ISSUE DATE No. (YYYY.MM.DD) ISSUED FOR 1 2018.11.30 TENDER

ISSUES LIST OF ABBREVIATIONS No. DATE YYYY.MM.DD ISSUED FOR 2018.11.30 TENDER LV --- LENGTH VARIES

MAX --- MAXIMUM

MECH --- MECHANICAL

MIN --- MINIMUM

No --- NUMBER

NTS --- NOT TO SCALE NTS --- NOT TO SCALE

o/c --- ON CENTRE

O/F --- OUTSIDE FACE

OPP --- OPPOSITE

PL --- PLATE

PT --- PRESSURE TREATED (LUMBER)

REINF --- REINFORCE (MENT)

R/W --- REINFORCE WITH

SDL --- SUPERIMPOSED DEAD LOAD

STIR --- STIRRUP

STL STEEL

SIM --- SIMILAR

S/W --- SHORT WAY

THK --- THICK

THK --- THICK

T.O. --- TOP OF


TYP --- TYPICAL


U/S --- UNDERSIDE

UNO --- UNLESS NOTED OTHERWISE

VERT --- VERIFY IN FIELD

W/ --- WITH --- PRESSURE TREATED (LUMBER) SUB CONSULTANT

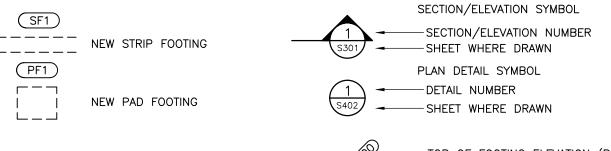

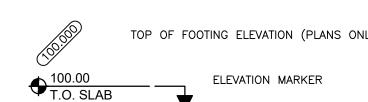

DRAWING NUMBER

TOP OF FOOTING ELEVATION (PLANS ONLY) 100.00 T.O. SLAB

INSTITUTE OF OCEAN SCIENCES DEPOT LIGHTING STRUCTURAL DETAIL

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BC

SIDNEY

HEROLD ENGINEERING

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LEGEND, DRAWING LIST AND DRAWING ISSUE RECORD

DRB	ENGINEER'S SEAL
DESIGN REVIEW DRB	
DRAFTED ADS	
DRAFTING REVIEW DRB	
PROJECT No. 1184-114	CLIENT DRAWING No.
SCALE AS SHOWN	PERMIT No. n/a

HEL DRAWING No. S101

DESTROY ALL DRAWINGS SHOWING PREVIOUS REVISION



