


BASEMENT FLOOR PLAN - PLUMBING DEMOLITION

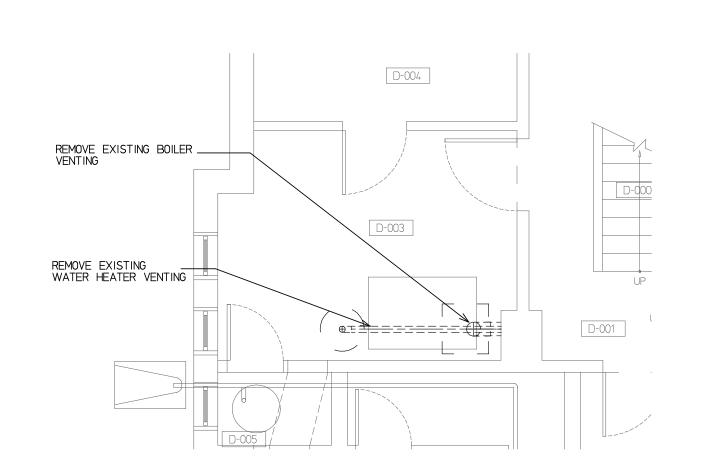

completion of the project.

1. Before submitting his tender the mechanical contractor shall examine the site and all existing conditions affecting the work under this contract. The contractor shall investigate and allow for cost of services to be provided under this contract and satisfy himself/herself that he can supply and install all the services without any additional charges after award **LEGEND**

Existing hot water heating supply


Existing hot water heating return

Existing pipe up

Natural gas pipe Sanitary line

Existing pipe down Existing fire extinguisher

- 2. All materials and installations to meet the latest requirements of the Alberta Building Code, the local authority having jurisdiction, and the National Plumbing Code of Canada.
- 3. Air conditioning system to be balanced to air quantities shown and a report submitted to the engineer. 4. Contractor to provide "As-built" drawings to the building owner upon
- 5. Contractor to give all necessary notices, obtain all permits and pay all fees in order that the work may be carried out.
- 6. At completion of work, provide a final certificate of inspection as evidence that all work installed conforms with the laws and regulations of all authorities having jurisdiction.
- 7. All equipment and systems shall be tested for proper, suitable operation and to the satisfaction of the Engineers, owner and all authorities having jurisdiction. Any corrections, retesting, etc. as required to complete systems shall be done at no expense to the owner.
- 8. Contractor to clean and recalibrate all existing thermostats and any missing or damaged thermostats to be replaced.
- conflict with existing ducts, piping, electrical, beams and joists.
- 10. Exhaust ducts to be insulated from outside to 7'-0" inside building.
- 11. All duct runouts to be provided with balance damper at take-off.
- 12. Sealing tape shall not be used as the primary sealant for air-handling ducts and plenums.

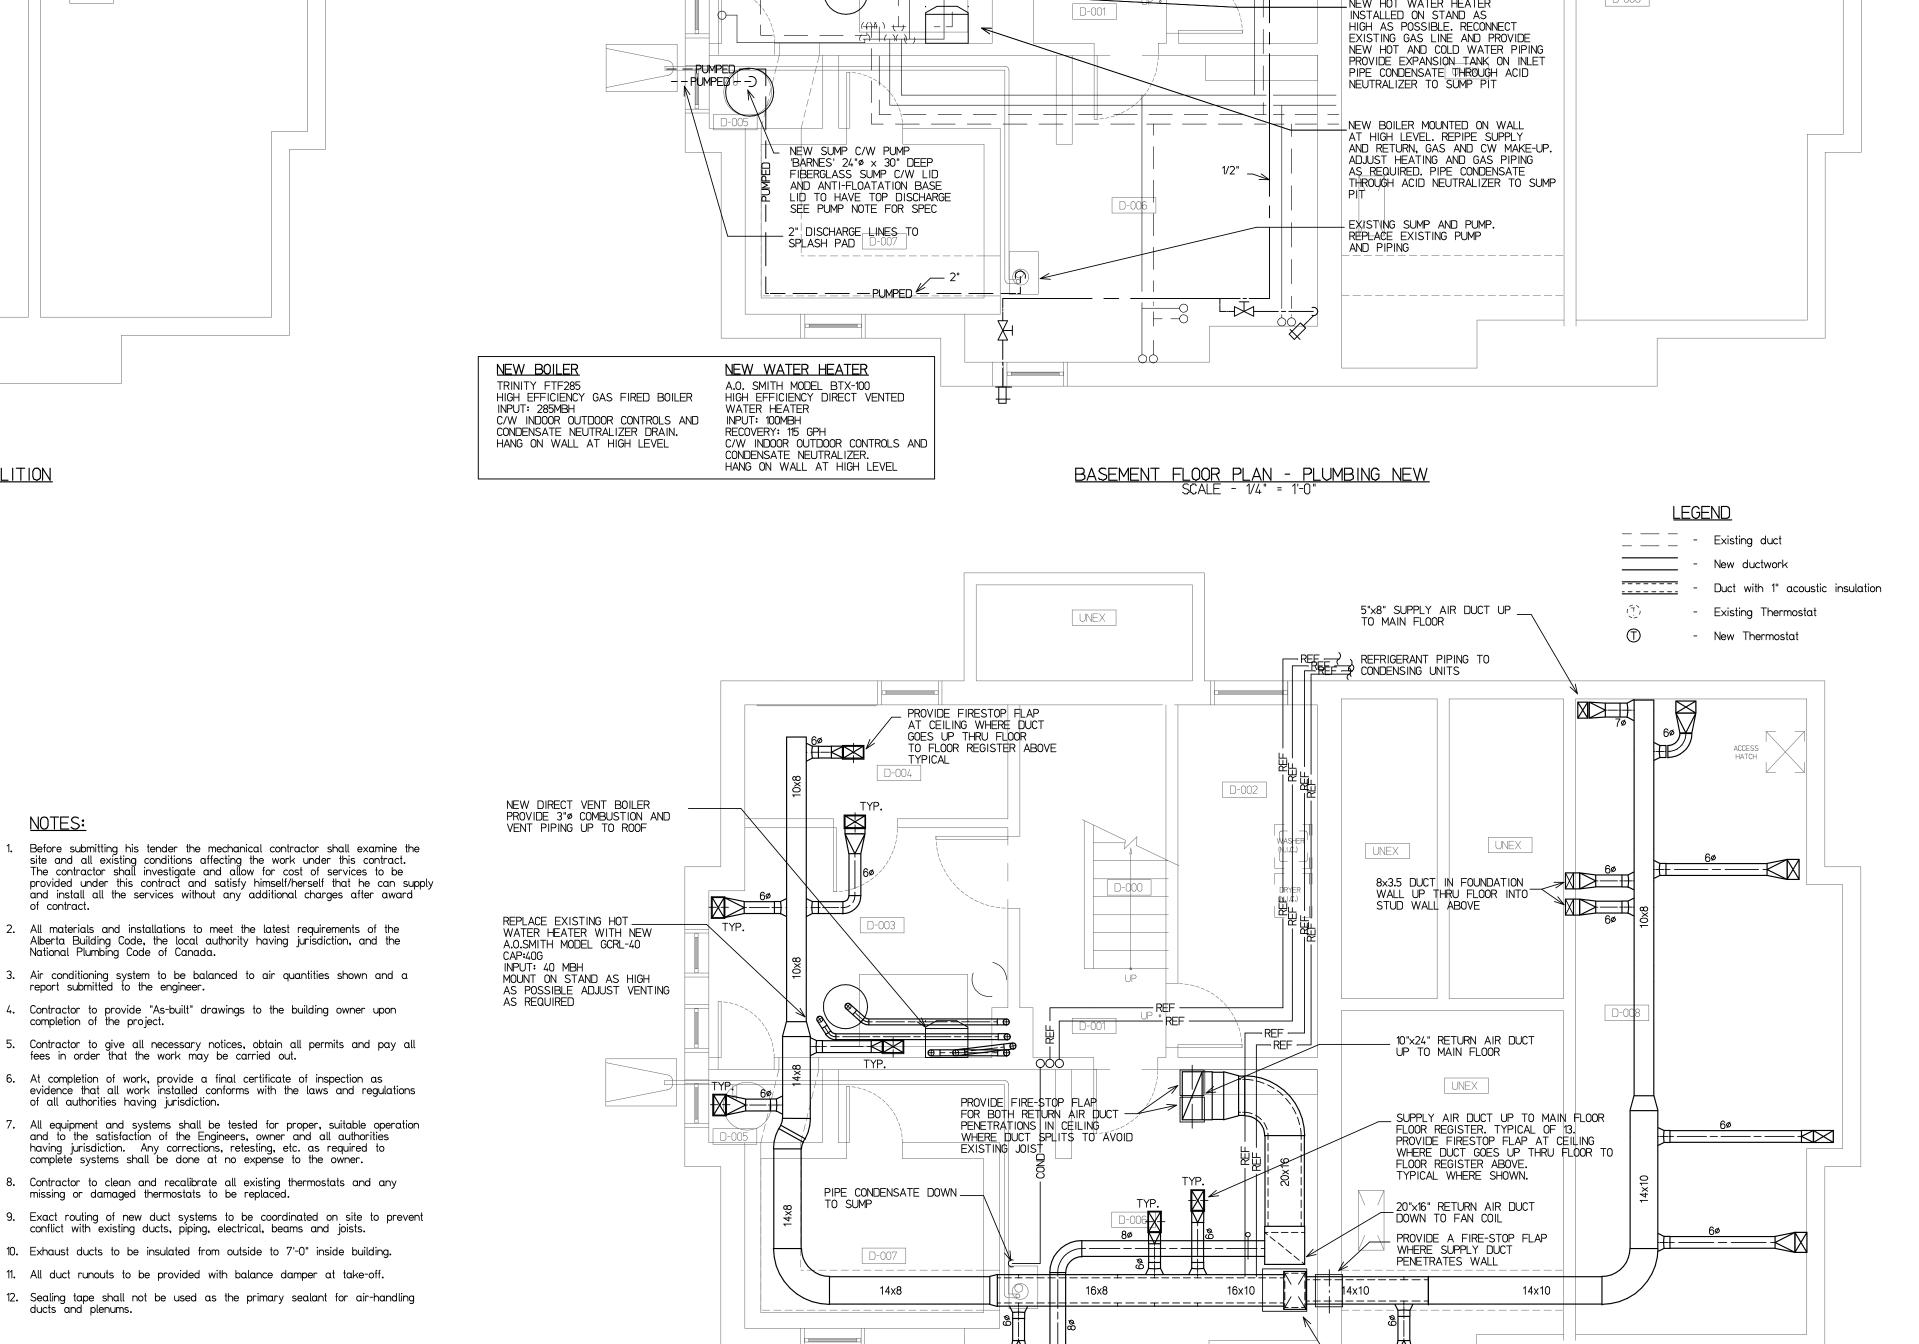

.8"Ø OUTDOOR AIR DUCT FROM

BASEMENT FLOOR PLAN - SHEET METAL SCALE - 1/4" = 1'-0"

WALLCAP TO RETURN AIR
DUCT

NEW FAN COIL #1 CARRIER MODEL FB4CNP048L00 CAP: 41.23 MBH MOTO: 3/4 HP

CARRIER MODEL 24ACB348A0N3 230/1/60

230/1/60

UNEX

CONNECT TO BOILER

EXISTING EXPANSION TANK TO BE RELOCATED ON NEW STAND PIPE FROM NEW LOCATION ON

STAND TO NEW BOILER SYSTEM

CONNECT NEW 1" C.W. SERVICE

OF EXISTING ON SITE

NEW 1" WATER SERVICE

TO EXISTING CONFIRM EXACT LOCATION

C/W WITH ISOLATION VALVE AND DRAIN

NEW HOT WATER HEATER

NEW FAN COIL #1 CARRIER MODEL FB4CNP048L00

UNEX

NEW SUMP PUMP

"BARNES" MODEL SP-50 MOTOR: 1/2HP 120/1/60 CAP: 50 GPM ● 12' HD C/W LEVEL CONTROL

D-008

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revisions

issued - ISSUED FOR 99% REVIEW 11/23/2018

- ISSUED FOR TENDER 12/11/2018 - ISSUED FOR TENDER UPDATE 01/15/2019

- RE-ISSUED FOR TENDER 03/15/2019

stamp / permit

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REHABILITATION OF HISTORIC GOVERNMENT OF CANADA BUILDINGS IN WATERTON

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drawing title


MAIN BUILDING BASEMENT FLOOR PLAN **MECHANICAL**

drawing info

D.B. D.L. drawn date JULY 2018

scale NOTED checked S.E.M.

drawing number

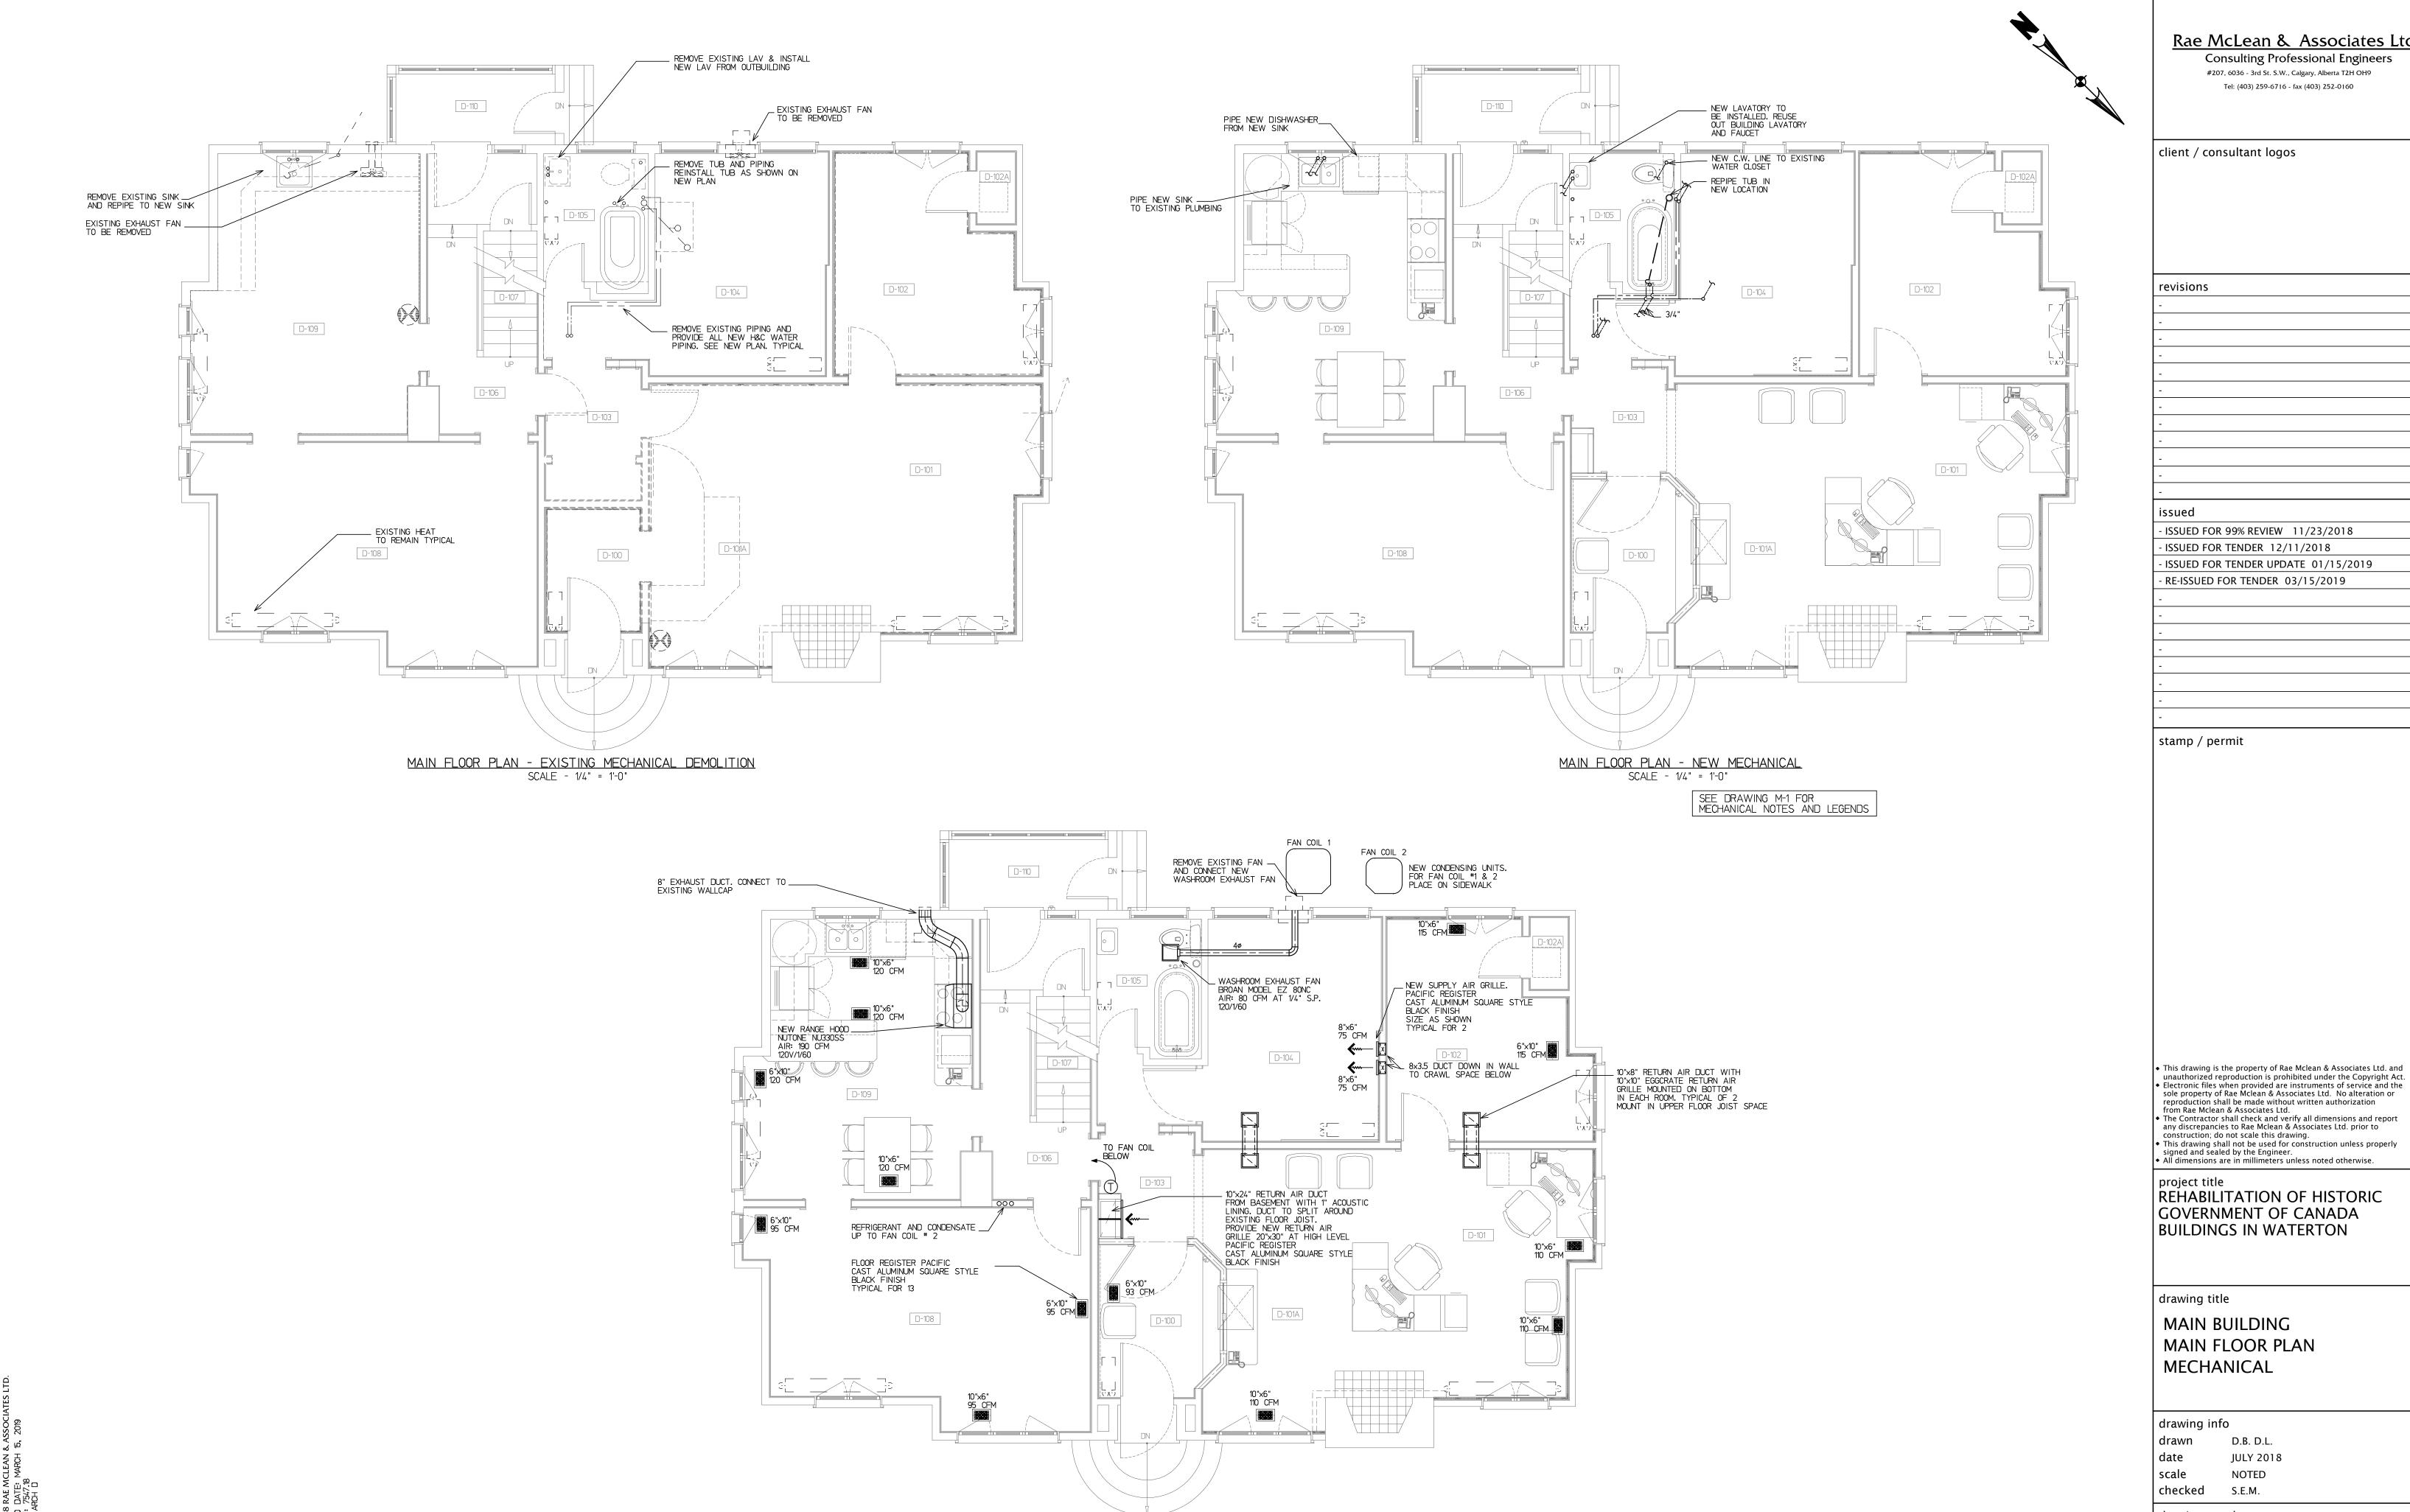

MAIN FLOOR PLAN - NEW SHEET METAL SCALE - 1/4" = 1'-0"


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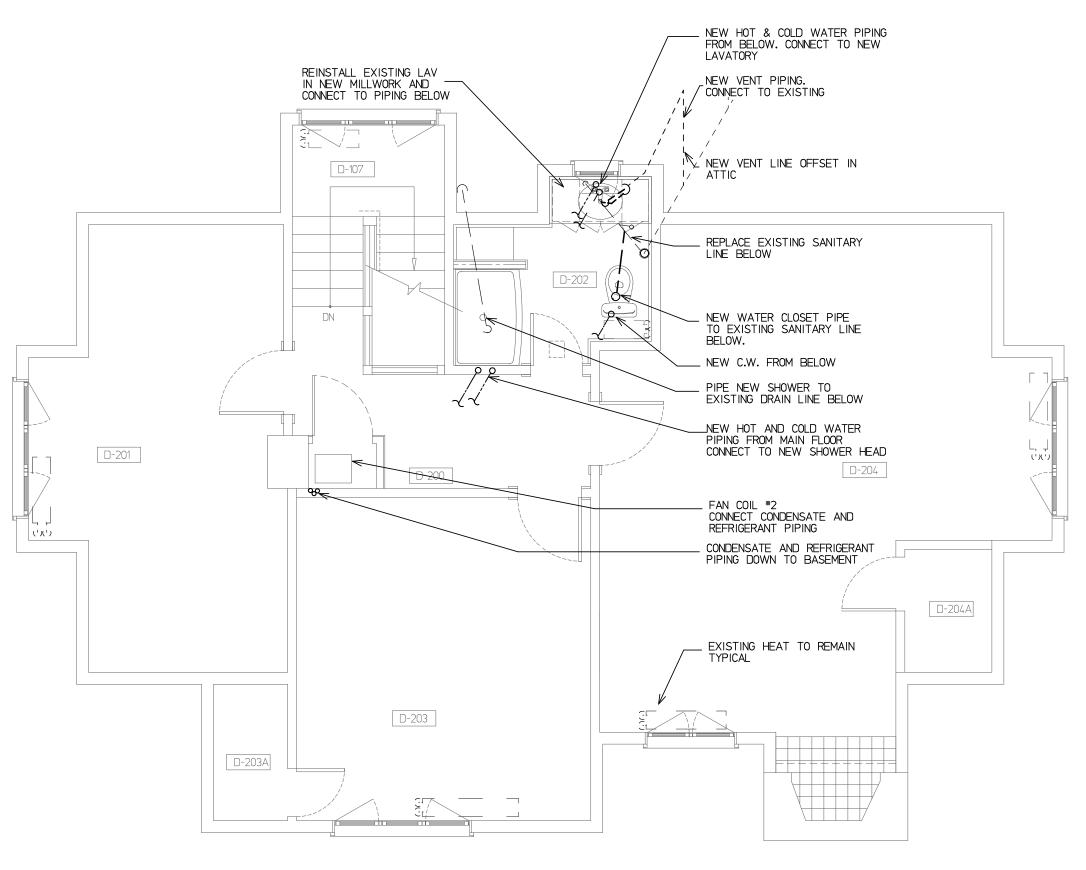
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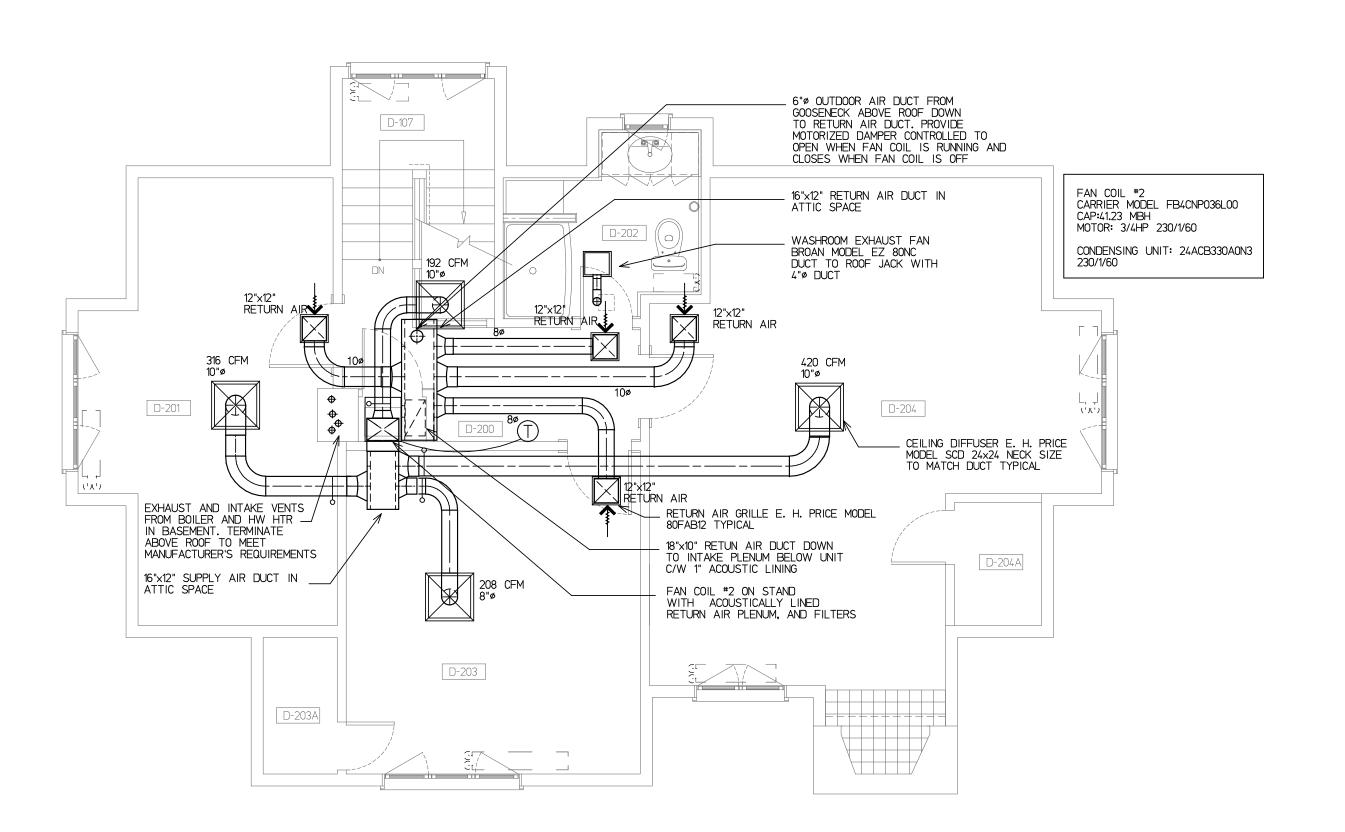


SCALE - 1/4" = 1'-0"



UPPER FLOOR PLAN - NEW PLUMBING SCALE - 1/4" = 1'-0"

SEE DRAWING M-1 FOR MECHANICAL NOTES AND LEGENDS

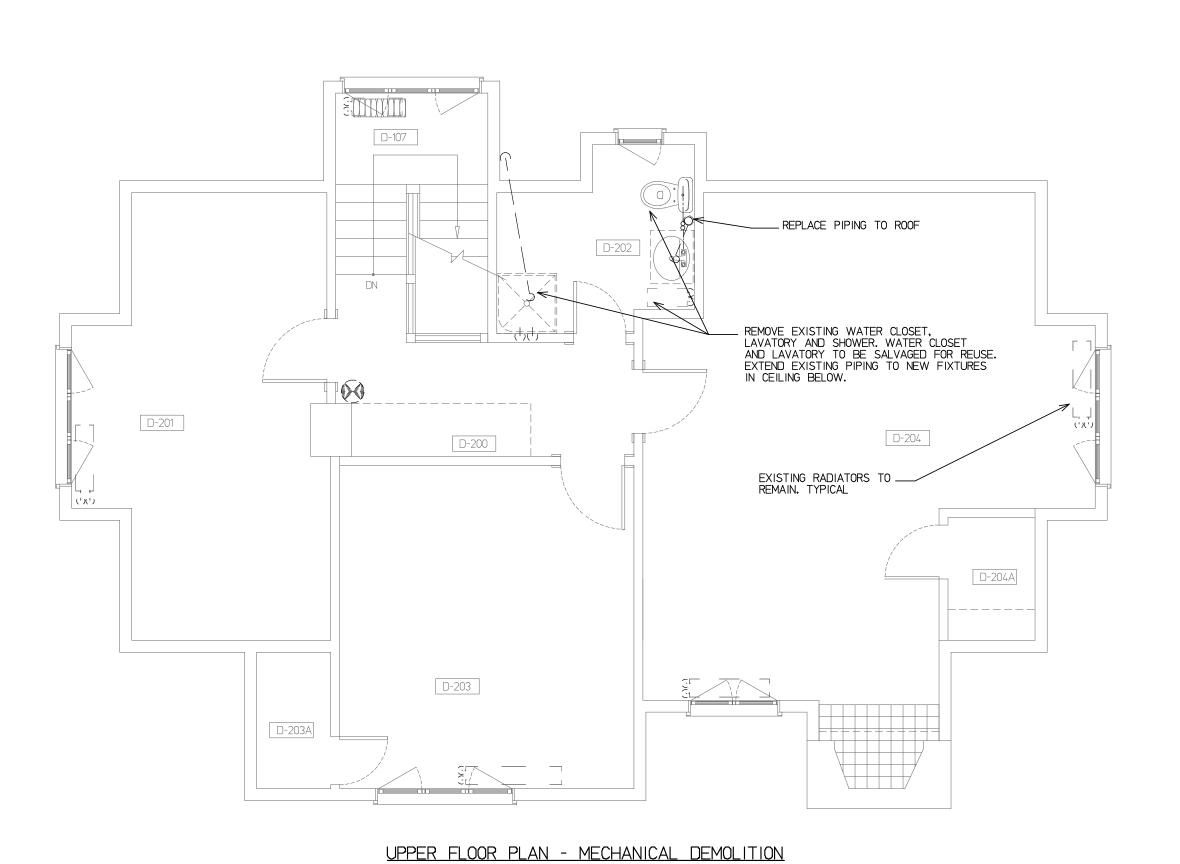

<u>UPPER FLOOR PLAN - NEW SHEET METAL</u> SCALE - 1/4" = 1'-0"

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REHABILITATION OF HISTORIC GOVERNMENT OF CANADA BUILDINGS IN WATERTON


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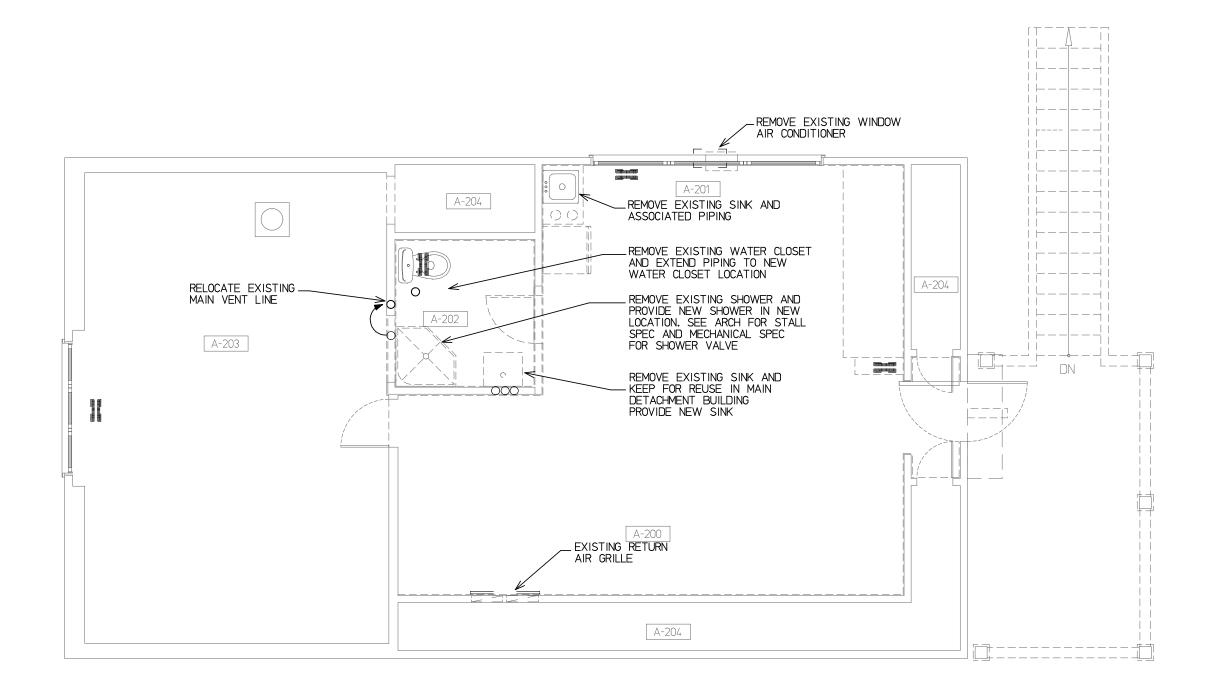
MAIN BUILDING
UPPER FLOOR PLAN
MECHANICAL

drawing info

drawn D.B. D.L.
date JULY 2018
scale NOTED
checked S.E.M.


drawing number




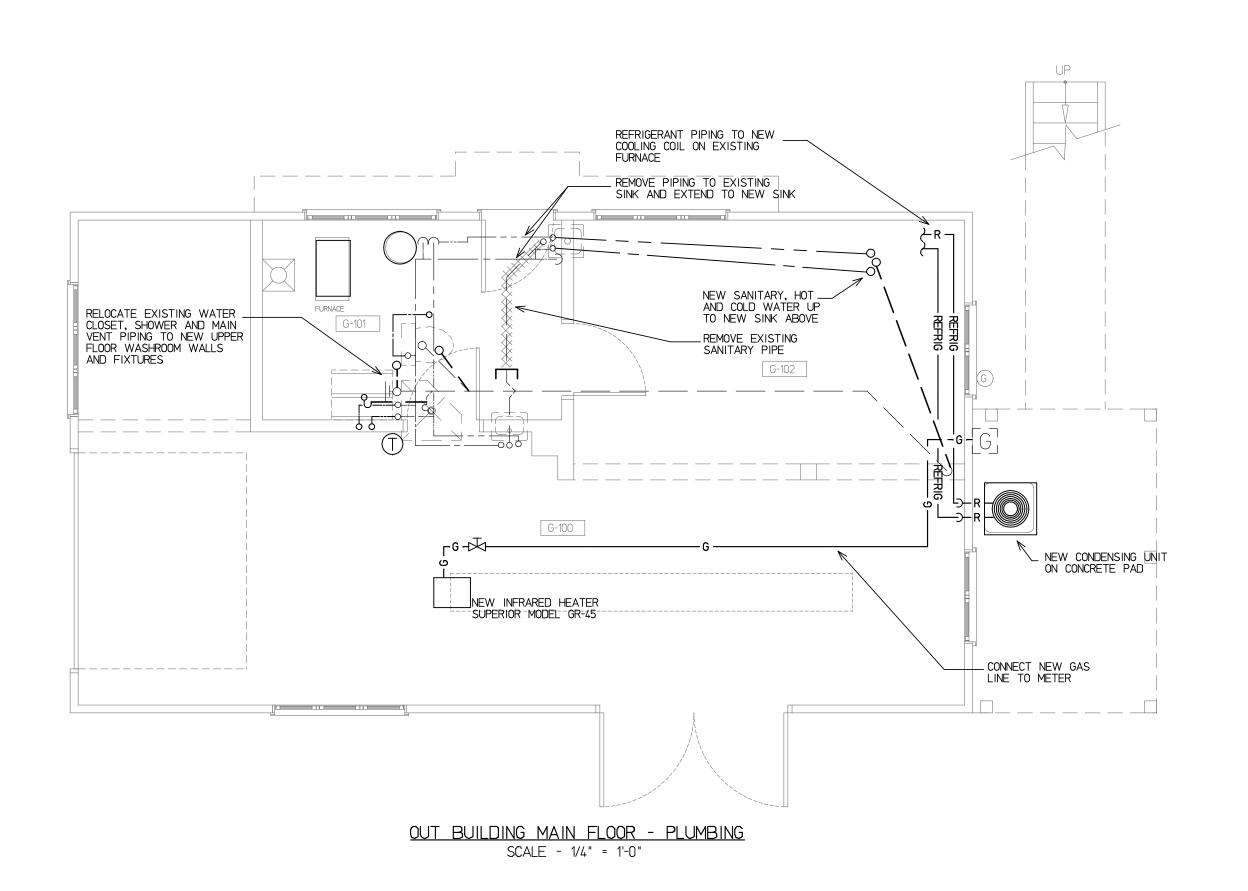

OUT BUILDING UPPER FLOOR - DEMOLITION

SCALE - 1/4" = 1'-0"

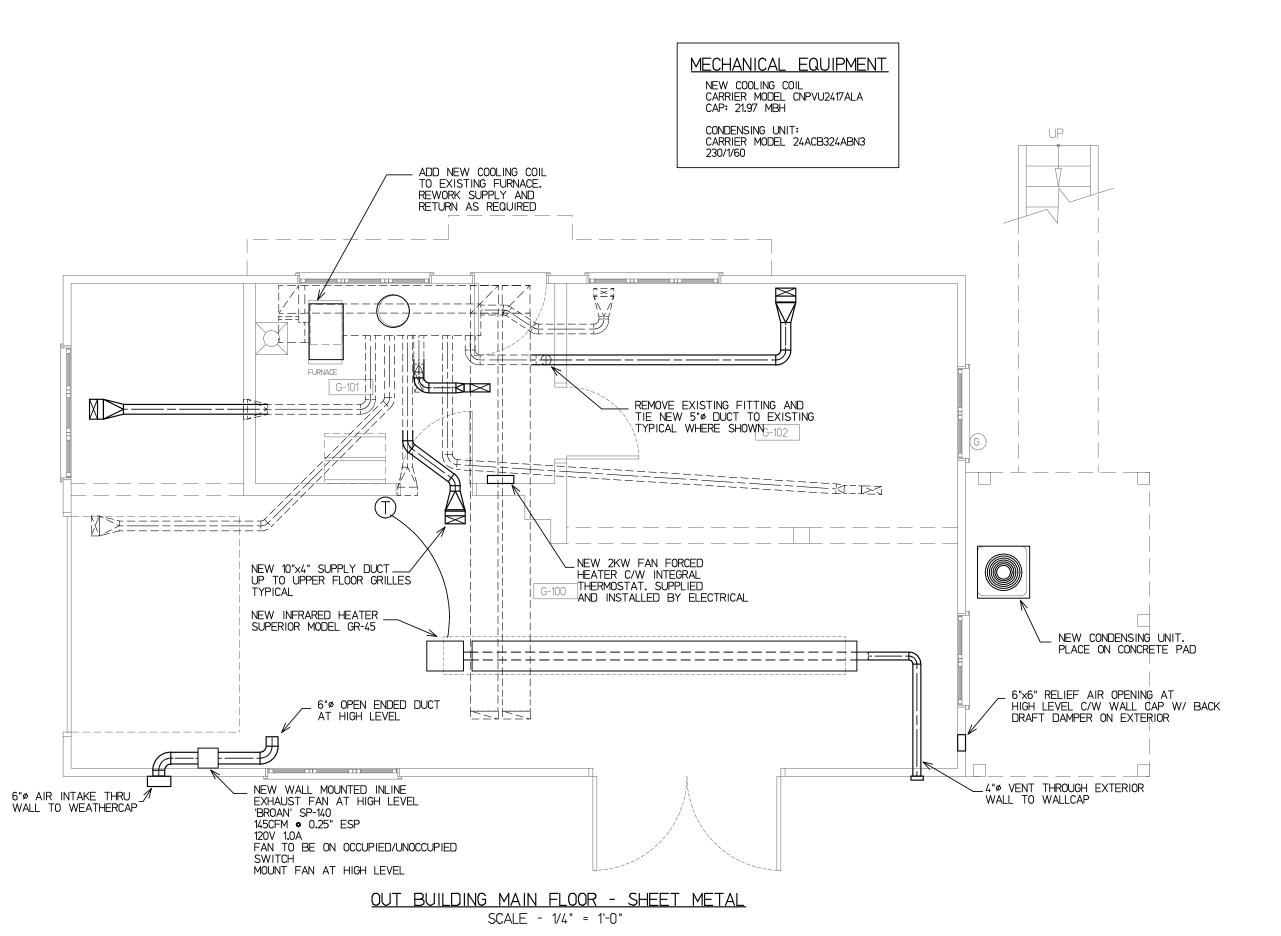

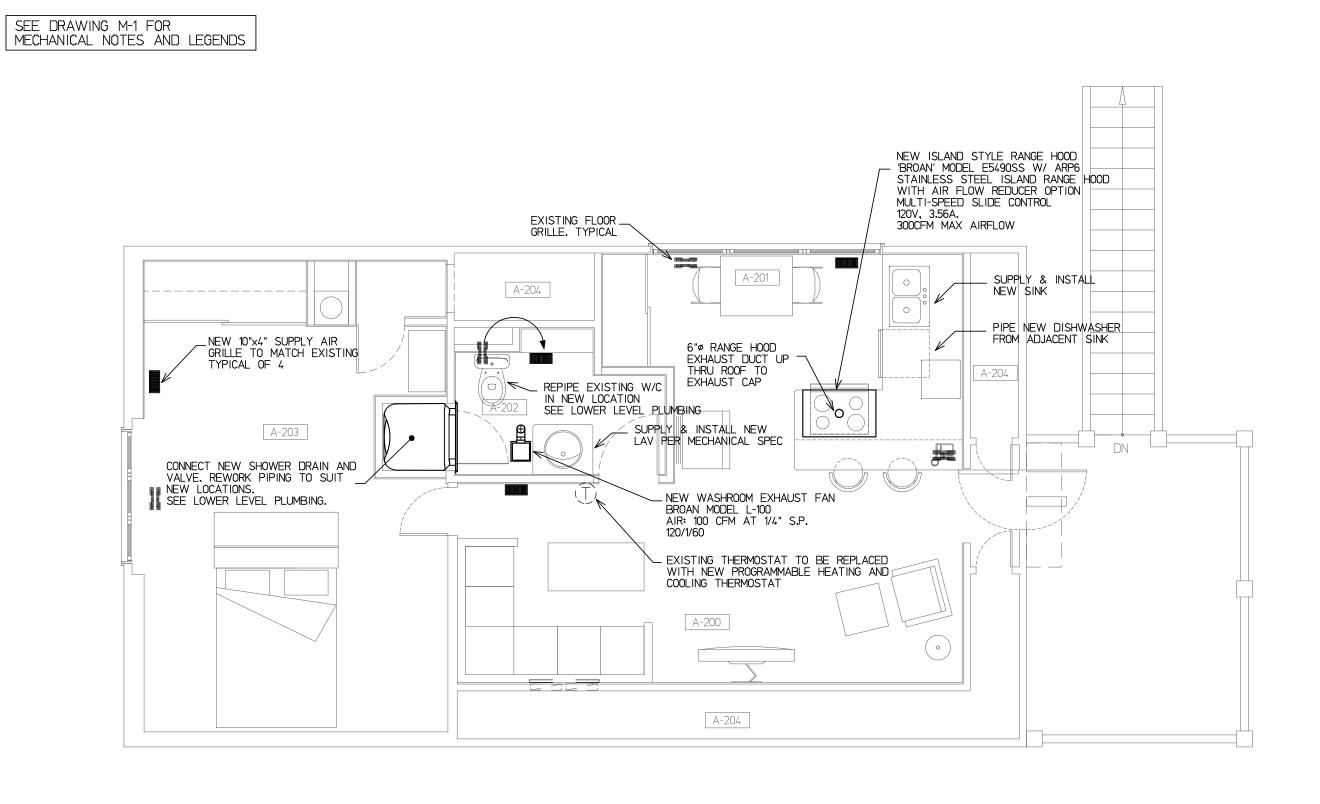

OUT BUILDING UPPER FLOOR - NEW MECHANICAL

SCALE - 1/4" = 1'-0"

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project title
REHABILITATION OF HISTORIC
GOVERNMENT OF CANADA
BUILDINGS IN WATERTON

drawing title

OUT BUILDING MECHANICAL

drawing info
drawn D.B. D.L.
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