

RAE MIN DATE: 7542.18 PCH D

C 2019 PLOTTED PROJECT: SHEET: A

### POWER LEGEND:

-(=)-	Existing duplex receptacle
	Existing voice outlet
2:> -> ->	Existing combination voice/data outlet
-(-)-	Existing specialty outlet
$(\cdot)$	Existing floor mounted duplex receptacle
<5)	Existing smoke alarm
Г Л Ц <sup>у</sup> ц	Existing junction box
	Existing panel
( <u>C</u> )¦	Existing wall clock
R	Denotes existing to be removed
$\frown$	Denotes existing to be removed and relocated as shown, reuse as new
RR	Denotes existing to be removed and re-installed back
Ð	New duplex receptacle
$\ominus$	New specialty outlet
$\Rightarrow$	New t.v. outlet
$\triangleright$	New AI Phone (Cat 6)
₽	New voice outlet
	New combination 1 Voice/1 Data outlet
۲	New floor mounted combination voice/data outlet
	New panel
M <del>-ው  </del>	New manual single phase starter
$\bigcirc$	New thermostat (supplied by mechanical, installed by electrical)
마	New unfused disconnect switch
WP	Denotes weatherproof

### LIGHTING LEGEND:

r       	Existing 2'x4' surfaced mounted fluorescent light fixure
· · · · · · · · · · · · · · · · · · ·	Existing 1'x4' surfaced mounted fluorescent light fixture
[]	Existing security wall mounted light
	Existing surfaced mounted light
	Existing wall mounted light fixture
ÎTE	Existing battery pack c/w heads
	Existing wall mounted exit light
-67-1	Existing light switch
:340-4	Existing dimmer switch
<b>3</b> -67-¦	Existing three-way light switch
$\bigcirc$	Existing ceiling mounted junction box
R	Denotes existing fixture to be removed
$\frown$	Denotes existing fixture to be removed and relocated, reused as new
	New 1'X4' surfaced mounted light fixure
	New undercabinet light fixture
X	New 8" semi-flush mounted light fixture
	Relocated existing battery pack c/w heads
) X H	New wall mounted running man LED exit light LUMACELL - LA SERIES (120V)
$\langle 1 \rangle$	Light fixture type

	MANUFACTURER
EXISTING HISTORIC LIGHT FIXTORE	
EXISTING HISTORIC LIGHT FIXTURE	
NEW SEMI-FLUSH MOUNT SCHOOL HOUSE LIGHT	SEA GULL LIGHTING-ACADEMY 77436EN3-782 C/W LED MEDIUM
EXISTING CONTEMPORAY LIGHT FIXTURE	
EXISTING BASE AND BULB	
NEW 1'X4' CLOUD TYPE FIXTURE	PACO LIGHTING-PUCL-2-48-W-32T8-120V
EXTERIOR WALL PACK	RAYON LIGHTING-T651LED-30-UNI12-40-T3-BZ-PC1
EXTERIOR WALL PACK	RAYON LIGHTING-T651LED-10-UNI12-40-T3-BZ-PC1
NEW 11"X11" CLOUD TYPE FIXTURE	SPECTRUM LIGHTING-SX1003SQLEDGV-15-35K-EX-SM-0P-MW
NEW UNDERCABINET LIGHT	RAYON LIGHTING-RULA-36-30-WH
NEW UNDERCABINET LIGHT	RAYON LIGHTING-RULA-22-30-WH
	NEW SEMI-FLUSH MOUNT SCHOOL HOUSE LIGHT EXISTING CONTEMPORAY LIGHT FIXTURE EXISTING BASE AND BULB NEW 1X4' CLOUD TYPE FIXTURE EXTERIOR WALL PACK EXTERIOR WALL PACK NEW 11"X11" CLOUD TYPE FIXTURE NEW UNDERCABINET LIGHT



## NOTES:

1. Before submitting his tender the electrical contractor shall examine the site and all existing conditions affecting the work under this contract. The contractor shall investigate and allow for cost of services to be provided under this contract and satisfy himself that he can supply and install all the services without any additional charges after award of contract contract.

2. All materials and installations to meet the latest requirements of the C.E.C., N.B.C. and to the satisfaction of the local authority having jurisdiction.

3. Contractor to give all necessary notices, obtain all permits and all fees in order that the work may be carried out.

4. All equipment and systems shall be tested for proper, suitable operation and to the satisfaction of the Engineers, owner and all authorities having jurisdiction. Any corrections, retesting, etc. as required to complete systems shall be done at no expense to the owner.

At completion of work, provide a final certifcate of inspection as evidence that all work installed conforms with the laws and regulations of all authorities having jurisdiction.

6. As-built drawings to be provided to building owner upon completion of project.

7. Remove all existing redundant conduit and wiring as required.

8. Exact placement of all devices to be coordinated with tenant. 9. All outlets to be mounted 12" above floor unless noted otherwise.

10. Contractor to notify Engineer 48 hours prior to rough-in and final completion.

 Circuit numbers indicated are actual circuits to be used. Circuits shown may not be connected to any other device other than shown. Integrity of the circuit design shall be maintained. 12. Provide new circuit breakers in existing panel board to circuit receptacles

as required. 13. Contractor to provide typed, updated panel schedules.

14. All power feed wiring to be installed in conduit. Minimum #12 R90 copper conductors may be used. #12 AC90 conductors may be used for final drop to devices. AC90 is not allowed to be installed from device to device. No horizontal runs in walls will be permitted.

15. Provide 3/4" conduit from each new telephone/data outlet and stub into ceiling space. Cabling to be Cat6 back to data rack and telephone board located in room D-104.

16. All devices to be of standard specification grade.

#### LAMP TYPE VOLTAGE MOUNTING TYPE JM A19 BASE 9.5W LAMP (3500K) 9.5W LED SURFACE 120V SURFACE 2-T8-32W 120V 30W LED 120V SURFACE 10W LED 120V SURFACE 9W LED 120V SURFACE 16W LED 120V SURFACE 120V SURFACE 11W LED

### Rae McLean & Associates Ltd. Consulting Professional Engineers #207, 6036 - 3rd St. S.W., Calgary, Alberta T2H OH9

Tel: (403) 259-6716 - fax (403) 252-0160

client / consultant logos

revisions

issued

- ISSUED FOR 99% REVIEW 11/23/2018 - ISSUED FOR TENDER 12/11/2018 - ISSUED FOR TENDER UPDATE 01/15/2019

- RE-ISSUED FOR TENDER 03/15/2019

stamp / permit

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project title REHABILITATION OF HISTORIC GOVERNMENT OF CANADA BUILDINGS IN WATERTON


drawing title

# MAIN BUILDING BASEMENT FLOOR PLAN ELECTRICAL


drawing info				
drawn	D.B. D.L.			
date	JULY 2018			
scale	NOTED			
checked	S.E.M.			
.1				

E-2


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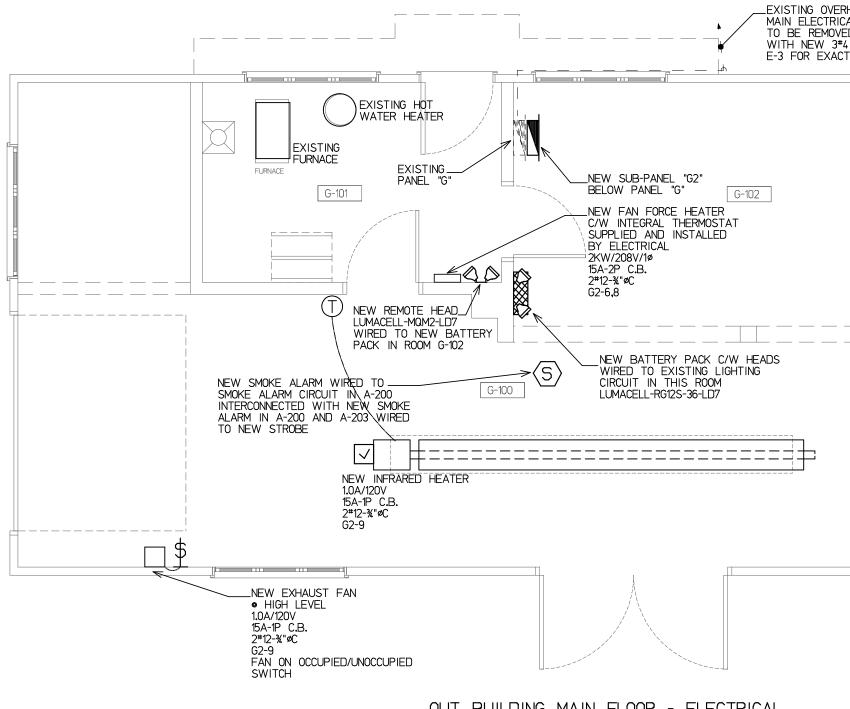


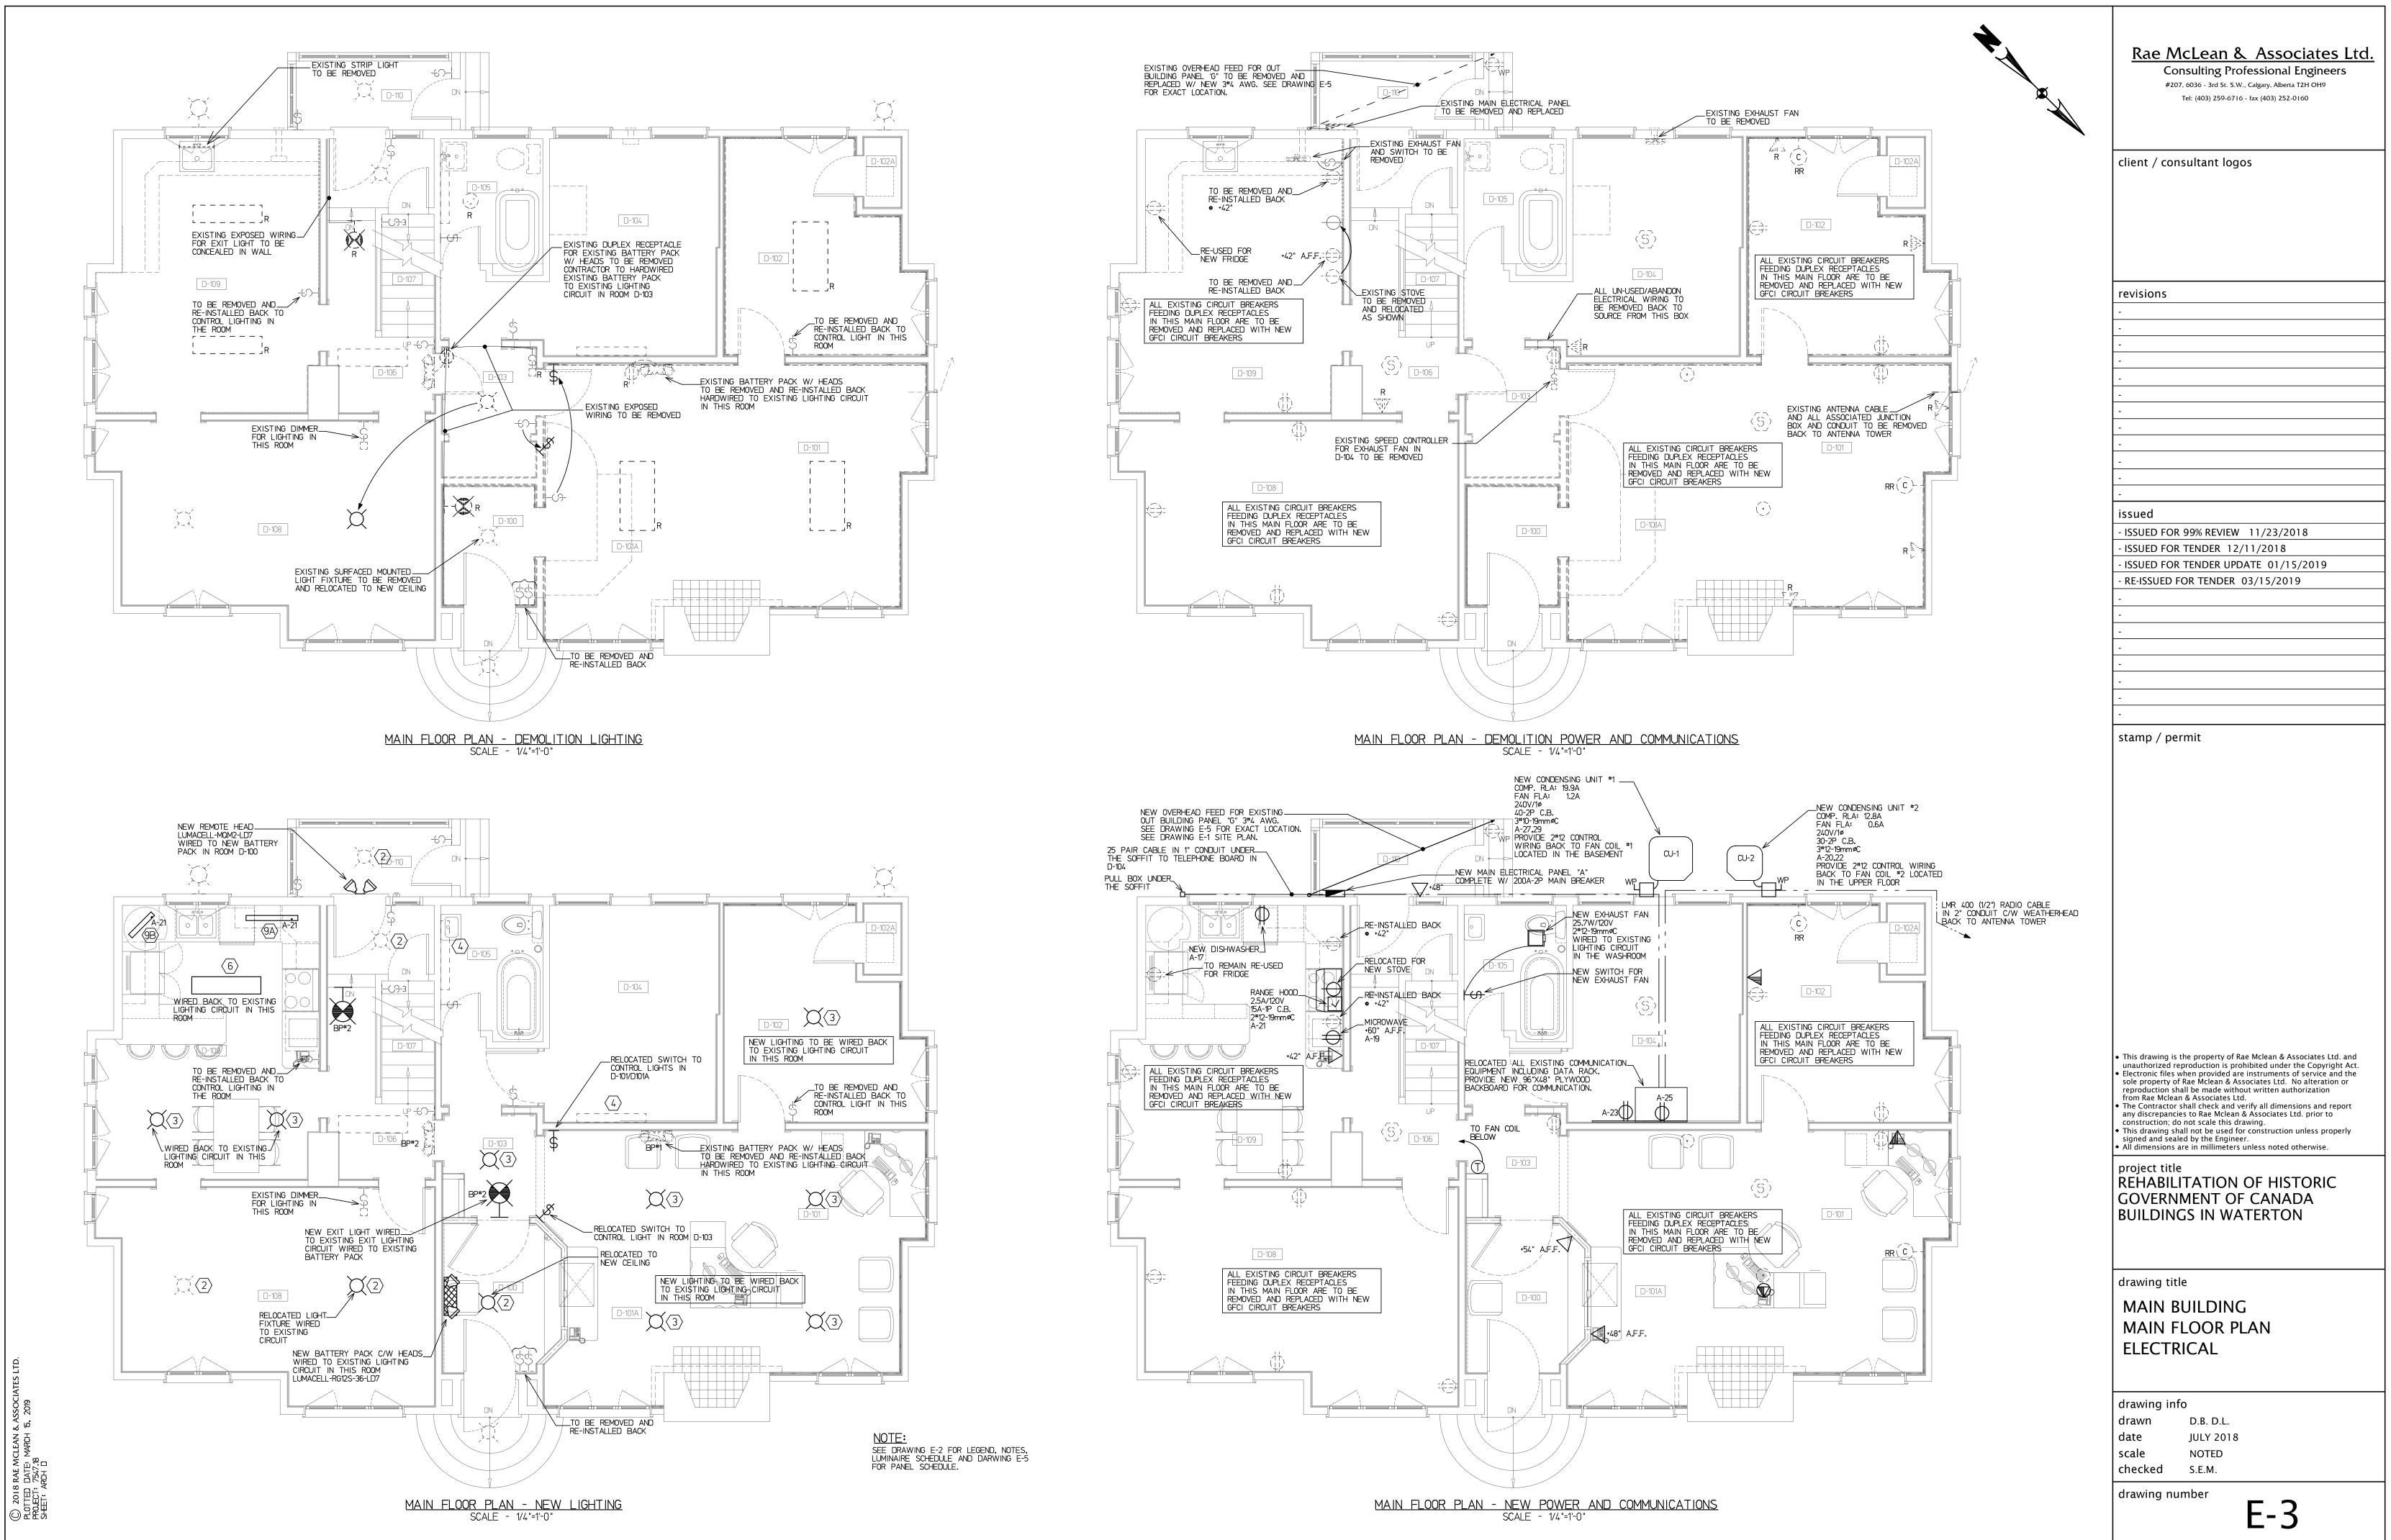

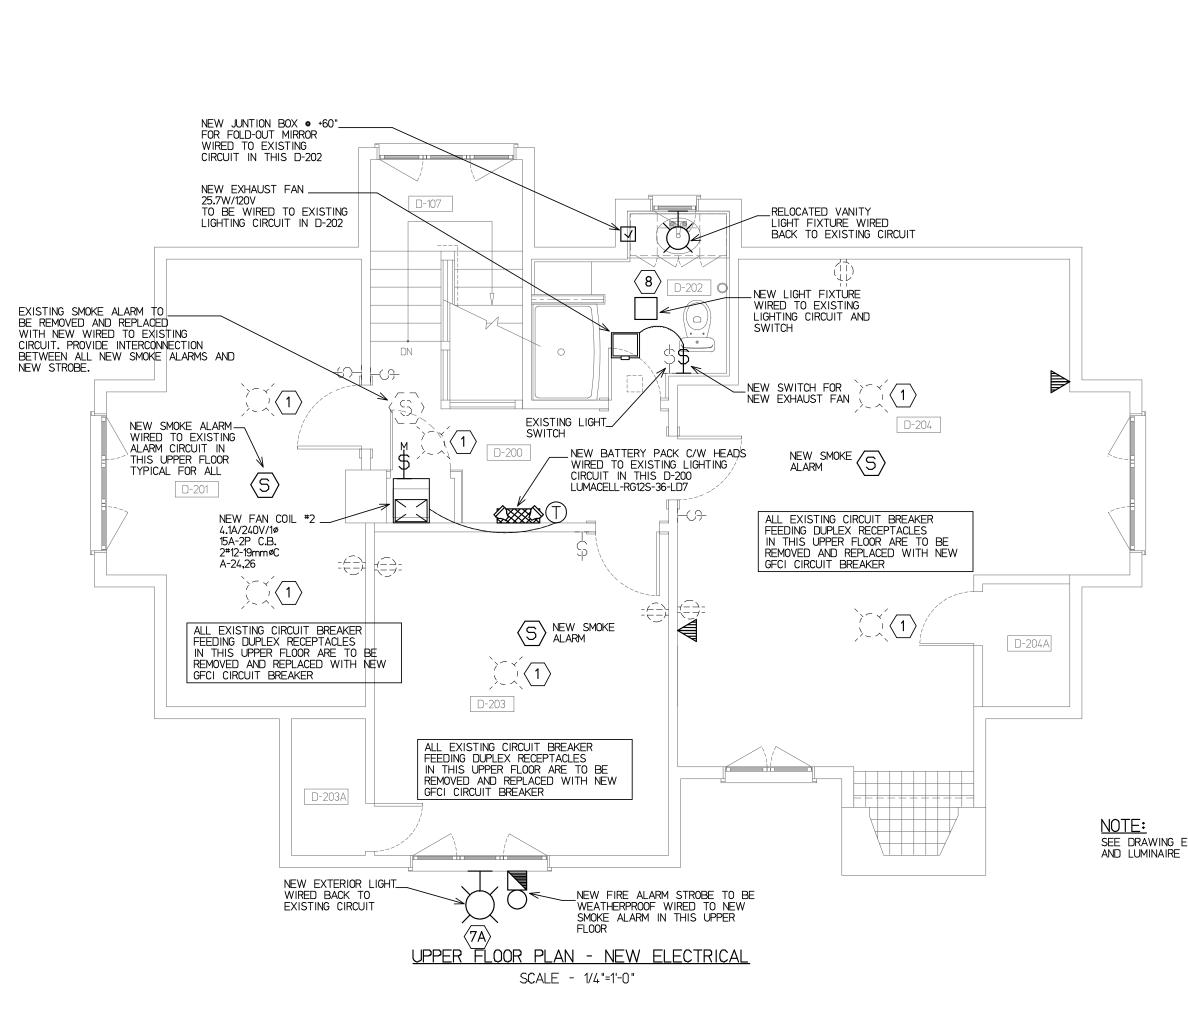


NOTE: SEE DRAWING E-2 FOR LEGEND AND LUMINAIRE SCHEDULE

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	project title
	REHABILITATION OF HISTORIC
	GOVERNMENT OF CANADA
	BUILDINGS IN WATERTON
	drawing title
	MAIN BUILDING
	UPPER FLOOR PLAN
	ELECTRICAL
	drawing info
	drawn D.B. D.L.
	date JULY 2018 scale NOTED
	scale NOTED checked S.E.M.
	drawing number
	E-4
	L-4

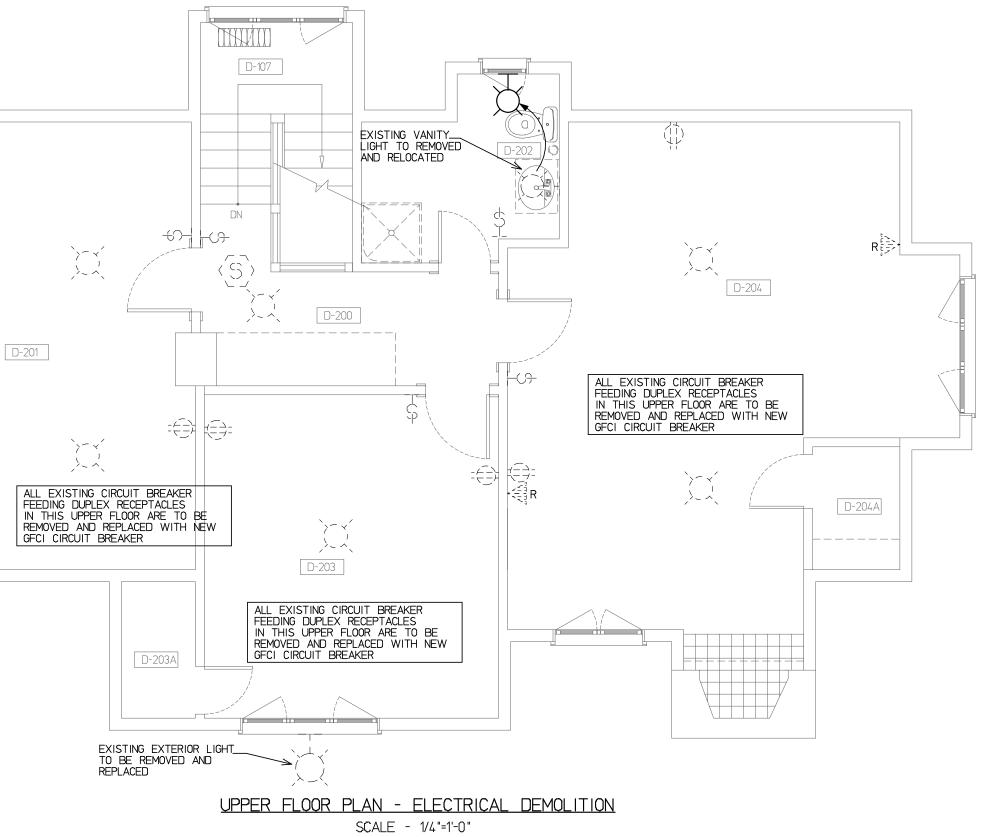

OUT BUILDING MAIN FLOOR - ELECTRICAL SCALE - 1/4"=1'-0"

<u>    1    </u> PHASE <u>    3    </u> WIRE			LOCATION OUT BU	100A	JSSING				
				FEEDER3*8-3	μ"øC	SURF.	ACE	— MTG.	
		WAT	TAGE		REMARKS	WATTAGE			
CIR.	BKR.	øA	øB	- REMARKS	REMARNS	ØĄ	øB	BKR.	CIR.
1	15A			NEW DISHWASHER	NEW CONDENSING UNIT			30A	
3	15A			NEW RANGE HOOD				2P	
5	15A			KITCHEN COUNTER	FAN FORCE HEATER			15A	6
7	20A			EXTERIOR PLUG (GFCI)				2P	E
9	15A			INFRARED HEATER/EXH. FAN	SPARE			15A	1
11	15A			SPARE	SPARE			15A	1
тот	ALS							тот	ALS
øΑ	TOTAL	=					_		
øв	TOTAL	-							
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	1	) VOLTS _ PHASE _ WIRE		PANEL LOCATIONM FEEDER3*:	
CIR.	BKR.		TAGE	REMARKS	REMARKS
		øA	øB		
1	40A			_	
3	2P				
5	40A				TED CIRCUIT (ISTING PANEL
7	2P				ISTING FANEL
9	20A				
11	15A				
13	15A				
15	15A				_
17	15A			NEW DISHWASHER	
19	15A			NEW MICROWAVE	NEW CONDENSING UNIT #2
21	15A			NEW RANGE HOOD	
23	15A			COMM. BOARD RECEPT.	NEW FAN COIL #2
25	15A			COMM. BOARD RECEPT.	
27	40A			NEW CONDENSING UNIT #1	SPARE
29	2P				SPARE
31	15A			NEW FAN COIL #1	SPARE
33	2P				SPARE
35	15A			NEW SUMP PUMP	
37					
39					GARAGE PANEL "G"
41					
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	TOTAL =				
	EL TOTAL	-			
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<u>    1    </u> PHASE <u>    3    </u> WIRE			LOCATIONOUT_BUILDING FEEDERNEW_3#4			125AA. BUSSING SURFACEMTG.			
w		WATTAGE				WATTAGE			
CIR.	BKR.	øĄ	øB		REMARKS -	øĄ	øB	BKR.	CIR.
1	15A			EXIST. PLUGS UP	EXIST. FURNACE			15A	2
3	15A			EXIST. BASEBOARD HEATER	EXIST. BEDROOM PLUGS			15A	4
5	2P				EXIST. FRIDGE			15A	6
7	15A			EXIST. BASEBOARD HEATER	NEW SUB PANEL "G2"			40A	8
9	2P							2P	10
11	40A			NEW STOVE	EXIST. MICROWAVE			15A	12
13	2P				EXIST. BATHROOM FAN/PLUGS			15A	14
15	15A			EXIST. GARAGE DR/PLUGS/LIGHTS	EXIST. WATER HEATER			15A	16
тот	ALS							тот	ALS
ØΑ	TOTAL =							•	
øв	TOTAL =								
<i>a</i> c	TOTAL =								

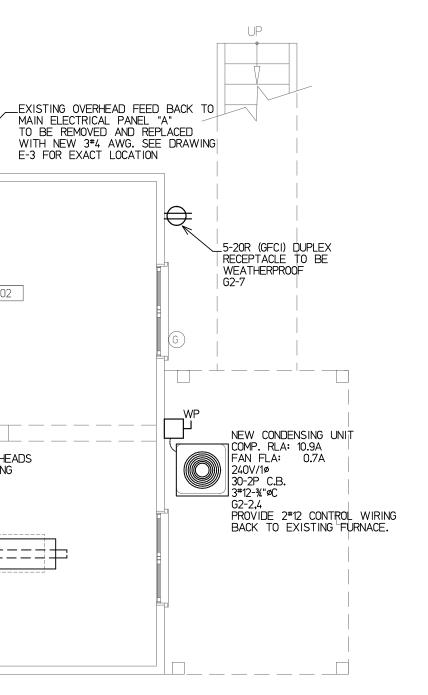
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MAII	g title BUILDING N FLOOR CTRICAL
drawing drawn date scale	g info D.B. D.L. JULY 2018 NOTED

drawing number

E-5

225A	A. E	SUSSING	
SURFA		— MTG.	
WAT	TAGE		
øĄ	øB	BKR.	CIR.
		15A	2
		15A	4
		15A	6
		15A	8
		15A	10
		15A	12
		15A	14
		15A	16
		15A	18
		30A	20
		2P	22
		15A	24
		2P	26
		15A	28
		15A	30
		15A	32
		15A	34
			36
			38
		70A	40
		2P	42
		тот	ALS

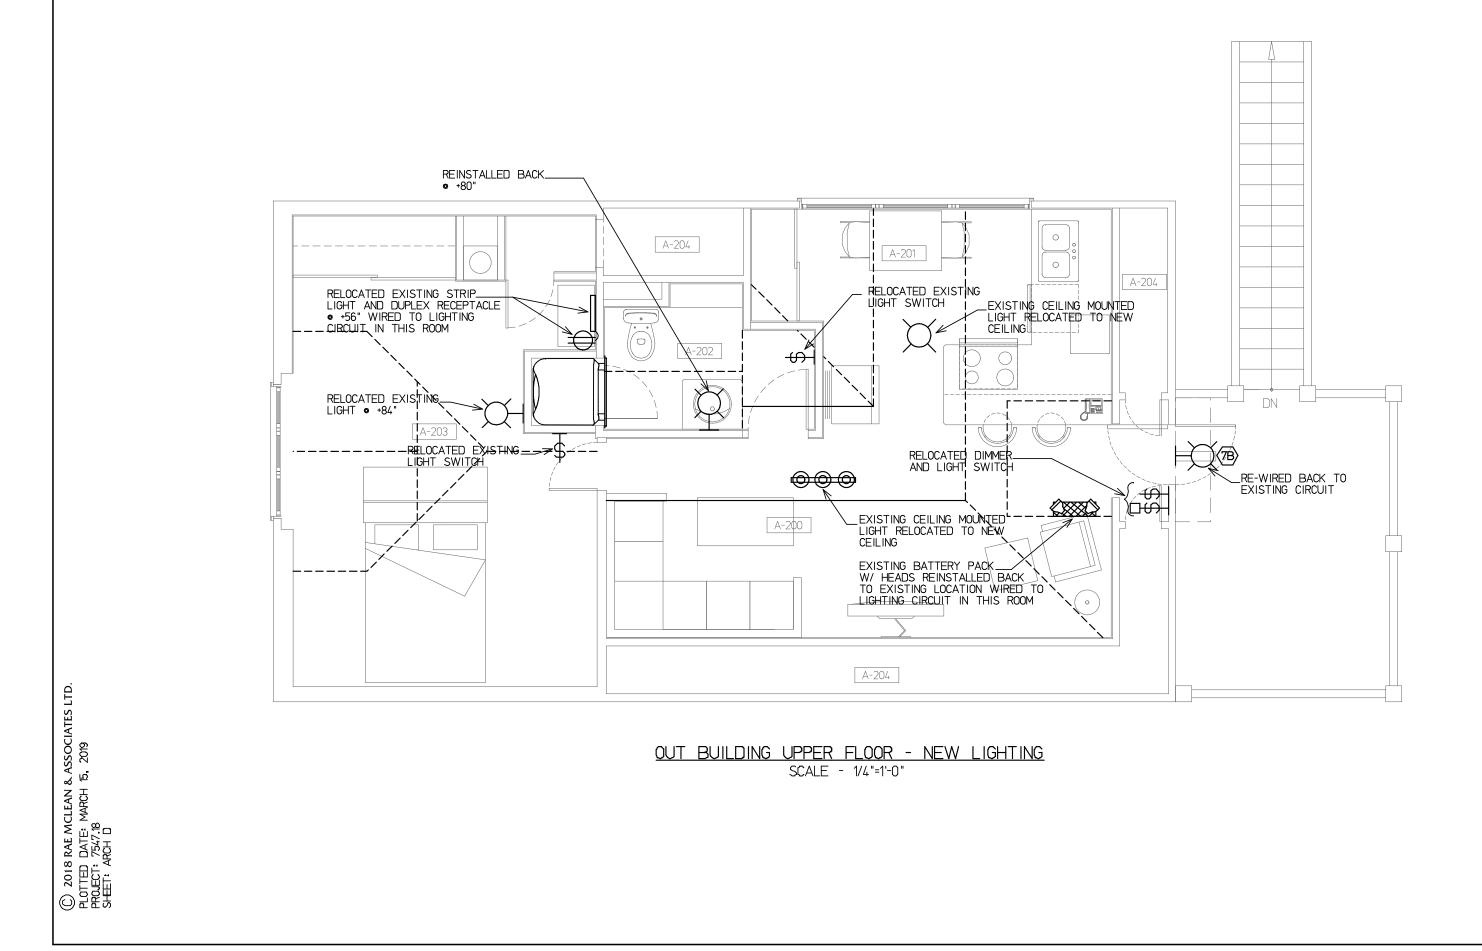

OUT BUILDING UPPER FLOOR - DEMOLITION LIGHTING SCALE - 1/4"=1'-0"

