

RAE MIN DATE: 7542.18 PCH D

C 2019 PLOTTED PROJECT: SHEET: A


POWER LEGEND:

| -(=)- | Existing duplex receptacle |
|-------------------------|---|
| | Existing voice outlet |
| 2:> -> -> | Existing combination voice/data outlet |
| -(-)- | Existing specialty outlet |
| (\cdot) | Existing floor mounted duplex receptacle |
| <5) | Existing smoke alarm |
| Г Л Ц ^у ц | Existing junction box |
| | Existing panel |
| (<u>C</u>)¦ | Existing wall clock |
| R | Denotes existing to be removed |
| \frown | Denotes existing to be removed and relocated as shown, reuse as new |
| RR | Denotes existing to be removed and re-installed back |
| Ð | New duplex receptacle |
| \ominus | New specialty outlet |
| \Rightarrow | New t.v. outlet |
| \triangleright | New AI Phone (Cat 6) |
| ₽ | New voice outlet |
| | New combination 1 Voice/1 Data outlet |
| ۲ | New floor mounted combination voice/data outlet |
| | New panel |
| M -ው | New manual single phase starter |
| \bigcirc | New thermostat (supplied by mechanical, installed by electrical) |
| 마 | New unfused disconnect switch |
| WP | Denotes weatherproof |
| | |

LIGHTING LEGEND:

| r | Existing 2'x4' surfaced mounted fluorescent light fixure |
|---------------------------------------|--|
| · · · · · · · · · · · · · · · · · · · | Existing 1'x4' surfaced mounted fluorescent light fixture |
| [] | Existing security wall mounted light |
| | Existing surfaced mounted light |
| | Existing wall mounted light fixture |
| ÎTE | Existing battery pack c/w heads |
| | Existing wall mounted exit light |
| -67-1 | Existing light switch |
| :340-4 | Existing dimmer switch |
| 3 -67-¦ | Existing three-way light switch |
| \bigcirc | Existing ceiling mounted junction box |
| R | Denotes existing fixture to be removed |
| \frown | Denotes existing fixture to be removed and relocated, reused as new |
| | New 1'X4' surfaced mounted light fixure |
| | New undercabinet light fixture |
| X | New 8" semi-flush mounted light fixture |
| | Relocated existing battery pack c/w heads |
|) X H | New wall mounted running man LED exit light LUMACELL - LA SERIES (120V) |
| $\langle 1 \rangle$ | Light fixture type |

| | MANUFACTURER |
|---|--|
| | |
| EXISTING HISTORIC LIGHT FIXTORE | |
| EXISTING HISTORIC LIGHT FIXTURE | |
| NEW SEMI-FLUSH MOUNT SCHOOL HOUSE LIGHT | SEA GULL LIGHTING-ACADEMY 77436EN3-782 C/W LED MEDIUM |
| EXISTING CONTEMPORAY LIGHT FIXTURE | |
| EXISTING BASE AND BULB | |
| NEW 1'X4' CLOUD TYPE FIXTURE | PACO LIGHTING-PUCL-2-48-W-32T8-120V |
| EXTERIOR WALL PACK | RAYON LIGHTING-T651LED-30-UNI12-40-T3-BZ-PC1 |
| EXTERIOR WALL PACK | RAYON LIGHTING-T651LED-10-UNI12-40-T3-BZ-PC1 |
| NEW 11"X11" CLOUD TYPE FIXTURE | SPECTRUM LIGHTING-SX1003SQLEDGV-15-35K-EX-SM-0P-MW |
| NEW UNDERCABINET LIGHT | RAYON LIGHTING-RULA-36-30-WH |
| NEW UNDERCABINET LIGHT | RAYON LIGHTING-RULA-22-30-WH |
| | NEW SEMI-FLUSH MOUNT SCHOOL HOUSE LIGHT EXISTING CONTEMPORAY LIGHT FIXTURE EXISTING BASE AND BULB NEW 1X4' CLOUD TYPE FIXTURE EXTERIOR WALL PACK EXTERIOR WALL PACK NEW 11"X11" CLOUD TYPE FIXTURE NEW UNDERCABINET LIGHT |

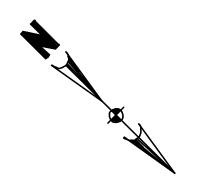

NOTES:

1. Before submitting his tender the electrical contractor shall examine the site and all existing conditions affecting the work under this contract. The contractor shall investigate and allow for cost of services to be provided under this contract and satisfy himself that he can supply and install all the services without any additional charges after award of contract contract.

2. All materials and installations to meet the latest requirements of the C.E.C., N.B.C. and to the satisfaction of the local authority having jurisdiction.

3. Contractor to give all necessary notices, obtain all permits and all fees in order that the work may be carried out.

4. All equipment and systems shall be tested for proper, suitable operation and to the satisfaction of the Engineers, owner and all authorities having jurisdiction. Any corrections, retesting, etc. as required to complete systems shall be done at no expense to the owner.

At completion of work, provide a final certifcate of inspection as evidence that all work installed conforms with the laws and regulations of all authorities having jurisdiction.

6. As-built drawings to be provided to building owner upon completion of project.

7. Remove all existing redundant conduit and wiring as required.

8. Exact placement of all devices to be coordinated with tenant. 9. All outlets to be mounted 12" above floor unless noted otherwise.

10. Contractor to notify Engineer 48 hours prior to rough-in and final completion.

 Circuit numbers indicated are actual circuits to be used. Circuits shown may not be connected to any other device other than shown. Integrity of the circuit design shall be maintained. 12. Provide new circuit breakers in existing panel board to circuit receptacles

as required. 13. Contractor to provide typed, updated panel schedules.

14. All power feed wiring to be installed in conduit. Minimum #12 R90 copper conductors may be used. #12 AC90 conductors may be used for final drop to devices. AC90 is not allowed to be installed from device to device. No horizontal runs in walls will be permitted.

15. Provide 3/4" conduit from each new telephone/data outlet and stub into ceiling space. Cabling to be Cat6 back to data rack and telephone board located in room D-104.

16. All devices to be of standard specification grade.

LAMP TYPE VOLTAGE MOUNTING TYPE JM A19 BASE 9.5W LAMP (3500K) 9.5W LED SURFACE 120V SURFACE 2-T8-32W 120V 30W LED 120V SURFACE 10W LED 120V SURFACE 9W LED 120V SURFACE 16W LED 120V SURFACE 120V SURFACE 11W LED

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Tel: (403) 259-6716 - fax (403) 252-0160

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revisions

issued

- ISSUED FOR 99% REVIEW 11/23/2018 - ISSUED FOR TENDER 12/11/2018 - ISSUED FOR TENDER UPDATE 01/15/2019

- RE-ISSUED FOR TENDER 03/15/2019

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The Contractor shall check and verify all dimensions and report any discrepancies to Rae Mclean & Associates Ltd. prior to

construction; do not scale this drawing. • This drawing shall not be used for construction unless properly signed and sealed by the Engineer. • All dimensions are in millimeters unless noted otherwise.

project title REHABILITATION OF HISTORIC GOVERNMENT OF CANADA BUILDINGS IN WATERTON


drawing title

MAIN BUILDING BASEMENT FLOOR PLAN ELECTRICAL


| drawing info | | | | |
|--------------|-----------|--|--|--|
| drawn | D.B. D.L. | | | |
| date | JULY 2018 | | | |
| scale | NOTED | | | |
| checked | S.E.M. | | | |
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E-2


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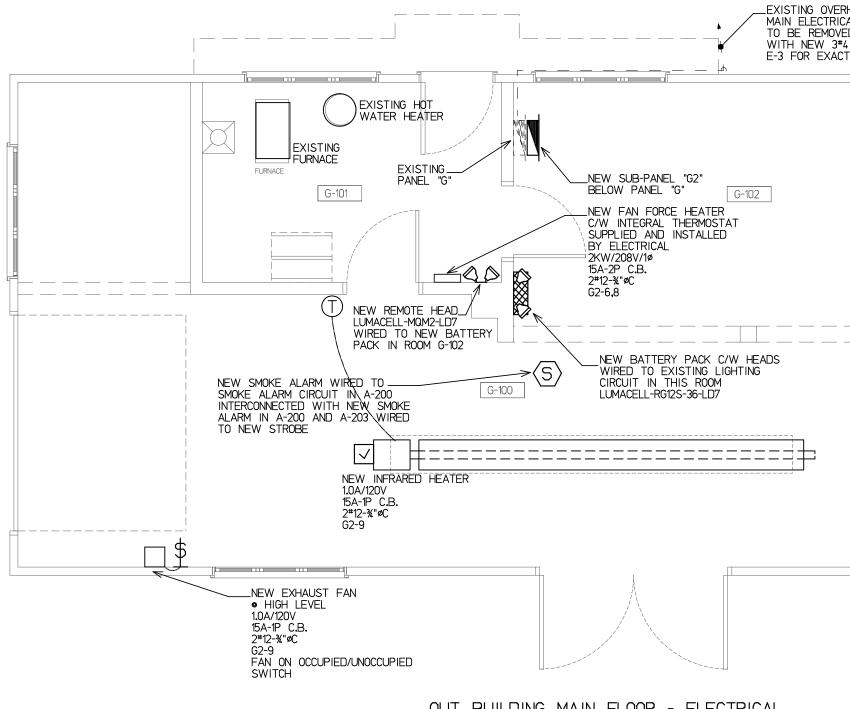




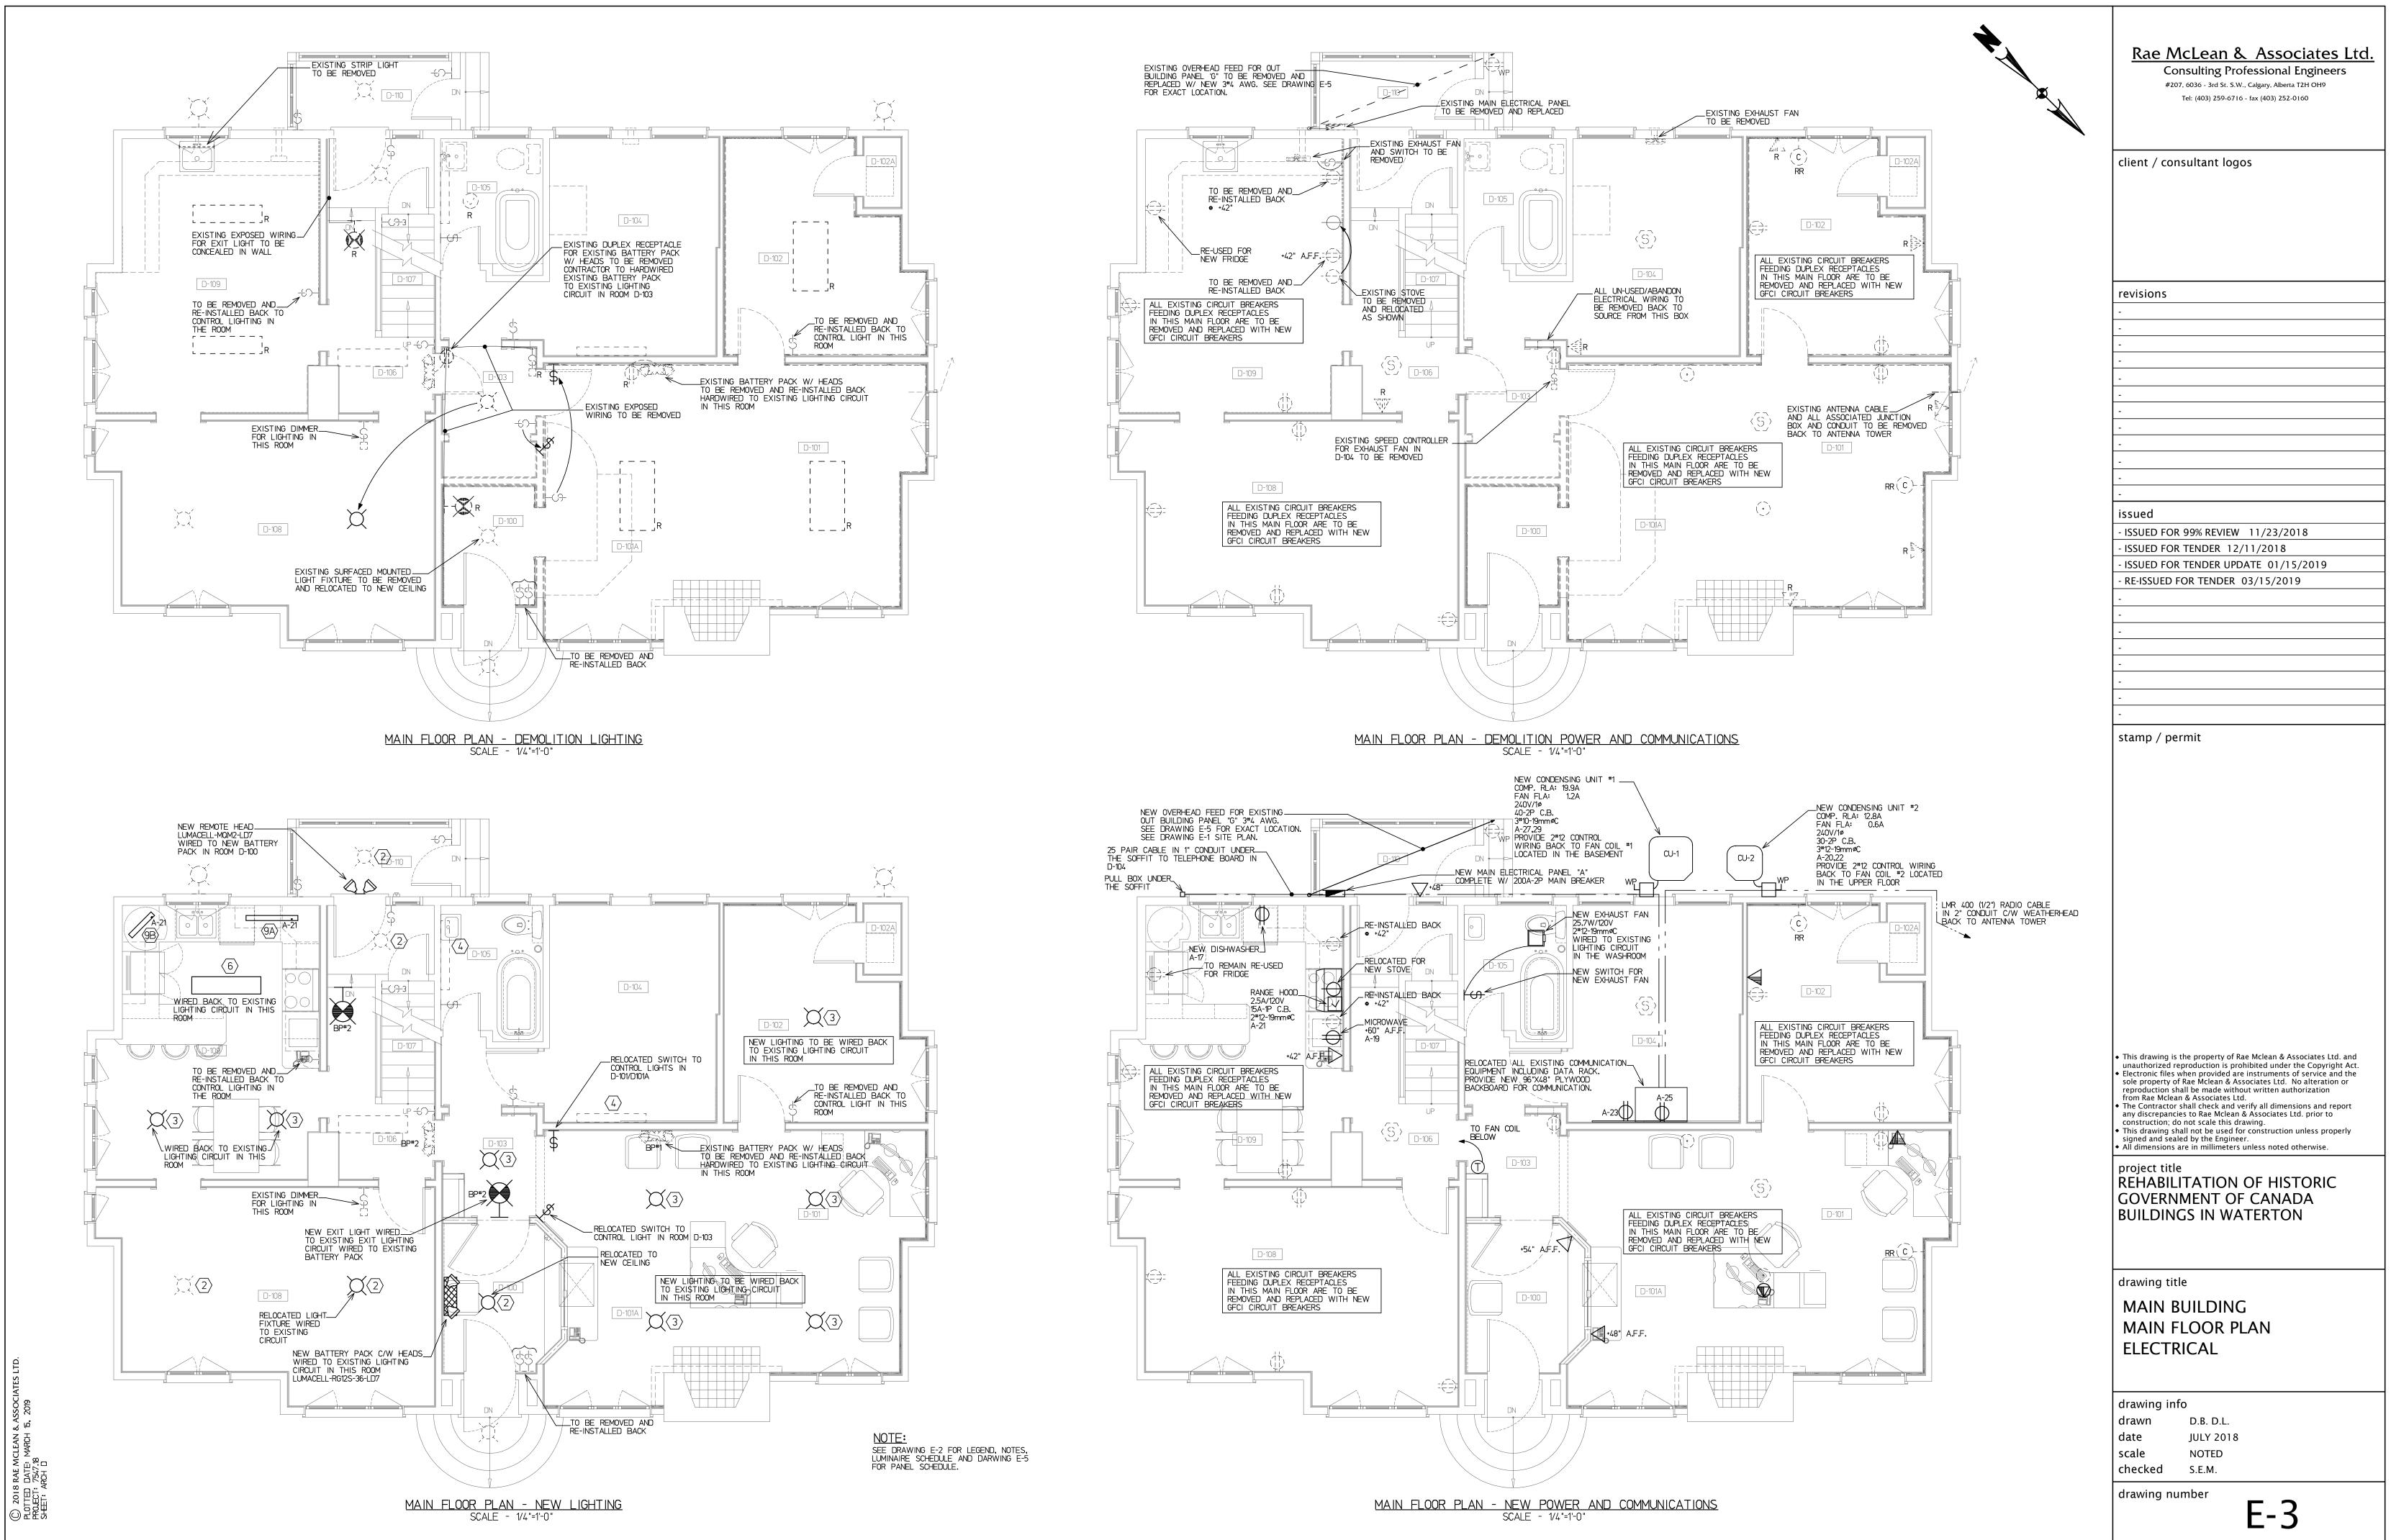


NOTE: SEE DRAWING E-2 FOR LEGEND AND LUMINAIRE SCHEDULE
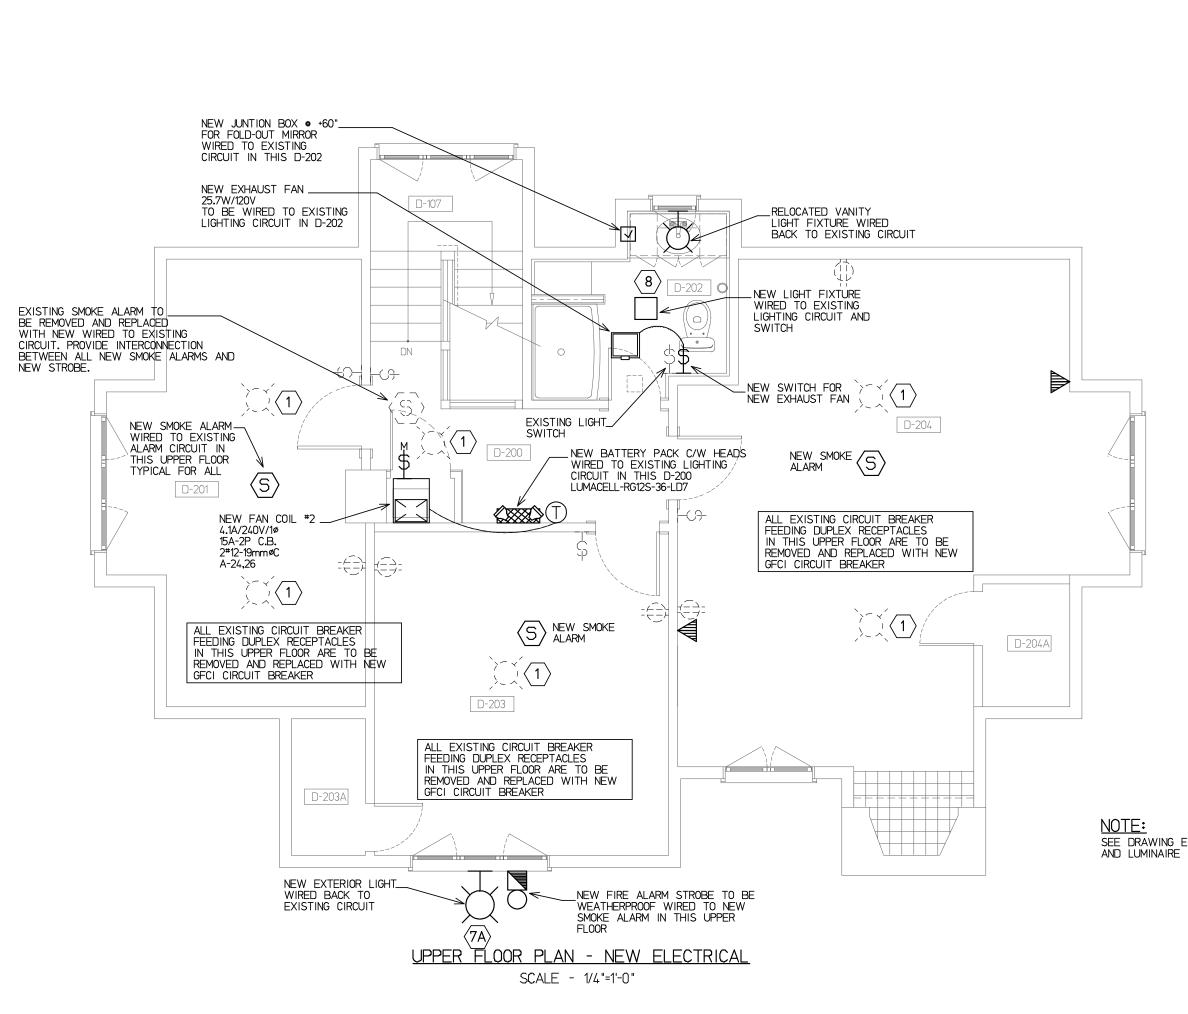
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| | project title |
| | REHABILITATION OF HISTORIC |
| | GOVERNMENT OF CANADA |
| | BUILDINGS IN WATERTON |
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| | |
| | drawing title |
| | MAIN BUILDING |
| | UPPER FLOOR PLAN |
| | ELECTRICAL |
| | |
| | |
| | drawing info |
| | drawn D.B. D.L. |
| | date JULY 2018 scale NOTED |
| | scale NOTED checked S.E.M. |
| | drawing number |
| | E-4 |
| | L-4 |
| | |

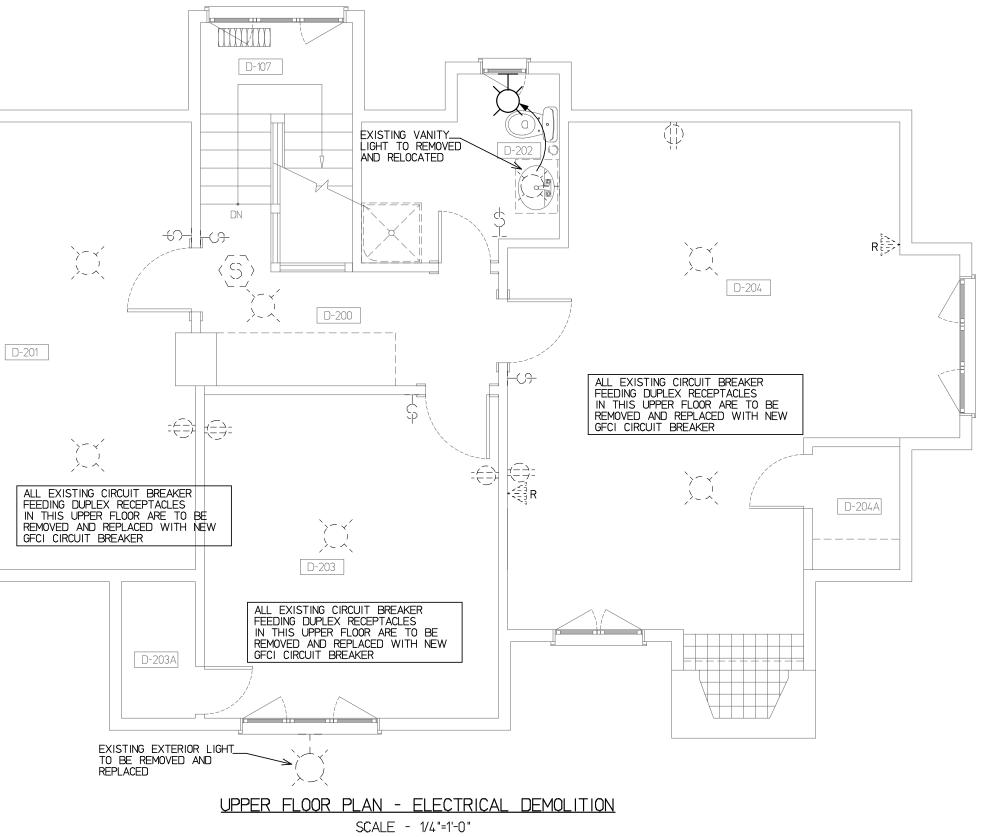

OUT BUILDING MAIN FLOOR - ELECTRICAL SCALE - 1/4"=1'-0"

| <u> 1 </u> PHASE <u> 3 </u> WIRE | | | LOCATION OUT BU | 100A | JSSING | | | | |
|---|---------|-----|-----------------|--------------------------|---------------------|---------|-----|--------|------|
| | | | | FEEDER3*8-3 | μ"øC | SURF. | ACE | — MTG. | |
| | | WAT | TAGE | | REMARKS | WATTAGE | | | |
| CIR. | BKR. | øA | øB | - REMARKS | REMARNS | ØĄ | øB | BKR. | CIR. |
| 1 | 15A | | | NEW DISHWASHER | NEW CONDENSING UNIT | | | 30A | |
| 3 | 15A | | | NEW RANGE HOOD | | | | 2P | |
| 5 | 15A | | | KITCHEN COUNTER | FAN FORCE HEATER | | | 15A | 6 |
| 7 | 20A | | | EXTERIOR PLUG (GFCI) | | | | 2P | E |
| 9 | 15A | | | INFRARED HEATER/EXH. FAN | SPARE | | | 15A | 1 |
| 11 | 15A | | | SPARE | SPARE | | | 15A | 1 |
| тот | ALS | | | | | | | тот | ALS |
| øΑ | TOTAL | = | | | | | _ | | |
| øв | TOTAL | - | | | | | | | |
| øс | TOTAL - | | | | | | | | |

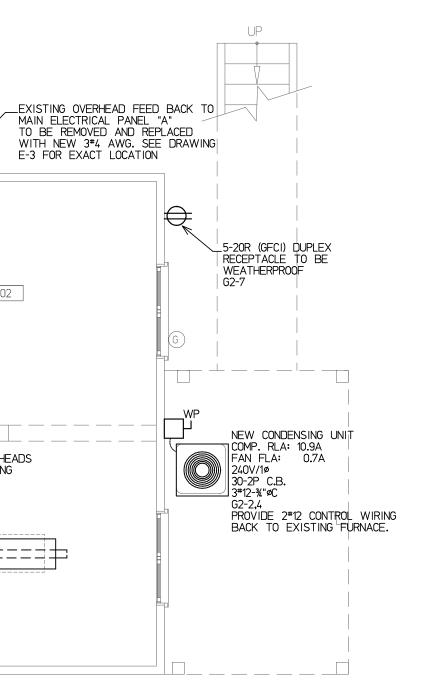

| | 1 |) VOLTS _ PHASE _ WIRE | | PANEL LOCATIONM FEEDER3*: | |
|------|----------|------------------------------|------|---------------------------------|------------------------------|
| CIR. | BKR. | | TAGE | REMARKS | REMARKS |
| | | øA | øB | | |
| 1 | 40A | | | _ | |
| 3 | 2P | | | | |
| 5 | 40A | | | | TED CIRCUIT (ISTING PANEL |
| 7 | 2P | | | | ISTING FANEL |
| 9 | 20A | | | | |
| 11 | 15A | | | | |
| 13 | 15A | | | | |
| 15 | 15A | | | | _ |
| 17 | 15A | | | NEW DISHWASHER | |
| 19 | 15A | | | NEW MICROWAVE | NEW CONDENSING UNIT #2 |
| 21 | 15A | | | NEW RANGE HOOD | |
| 23 | 15A | | | COMM. BOARD RECEPT. | NEW FAN COIL #2 |
| 25 | 15A | | | COMM. BOARD RECEPT. | |
| 27 | 40A | | | NEW CONDENSING UNIT #1 | SPARE |
| 29 | 2P | | | | SPARE |
| 31 | 15A | | | NEW FAN COIL #1 | SPARE |
| 33 | 2P | | | | SPARE |
| 35 | 15A | | | NEW SUMP PUMP | |
| 37 | | | | | |
| 39 | | | | | GARAGE PANEL "G" |
| 41 | | | | | |
| TO | TALS | | | | |
| | TOTAL = | | I | | |
| øв | TOTAL = | | | | |
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| | EL TOTAL | - | | | |
| REMA | | | | | |

| <u> 1 </u> PHASE <u> 3 </u> WIRE | | | LOCATIONOUT_BUILDING FEEDERNEW_3#4 | | | 125AA. BUSSING SURFACEMTG. | | | |
|---|---------|---------|---------------------------------------|-------------------------------|---------------------------|-------------------------------|----|------|------|
| w | | WATTAGE | | | | WATTAGE | | | |
| CIR. | BKR. | øĄ | øB | | REMARKS - | øĄ | øB | BKR. | CIR. |
| 1 | 15A | | | EXIST. PLUGS UP | EXIST. FURNACE | | | 15A | 2 |
| 3 | 15A | | | EXIST. BASEBOARD HEATER | EXIST. BEDROOM PLUGS | | | 15A | 4 |
| 5 | 2P | | | | EXIST. FRIDGE | | | 15A | 6 |
| 7 | 15A | | | EXIST. BASEBOARD HEATER | NEW SUB PANEL "G2" | | | 40A | 8 |
| 9 | 2P | | | | | | | 2P | 10 |
| 11 | 40A | | | NEW STOVE | EXIST. MICROWAVE | | | 15A | 12 |
| 13 | 2P | | | | EXIST. BATHROOM FAN/PLUGS | | | 15A | 14 |
| 15 | 15A | | | EXIST. GARAGE DR/PLUGS/LIGHTS | EXIST. WATER HEATER | | | 15A | 16 |
| тот | ALS | | | | | | | тот | ALS |
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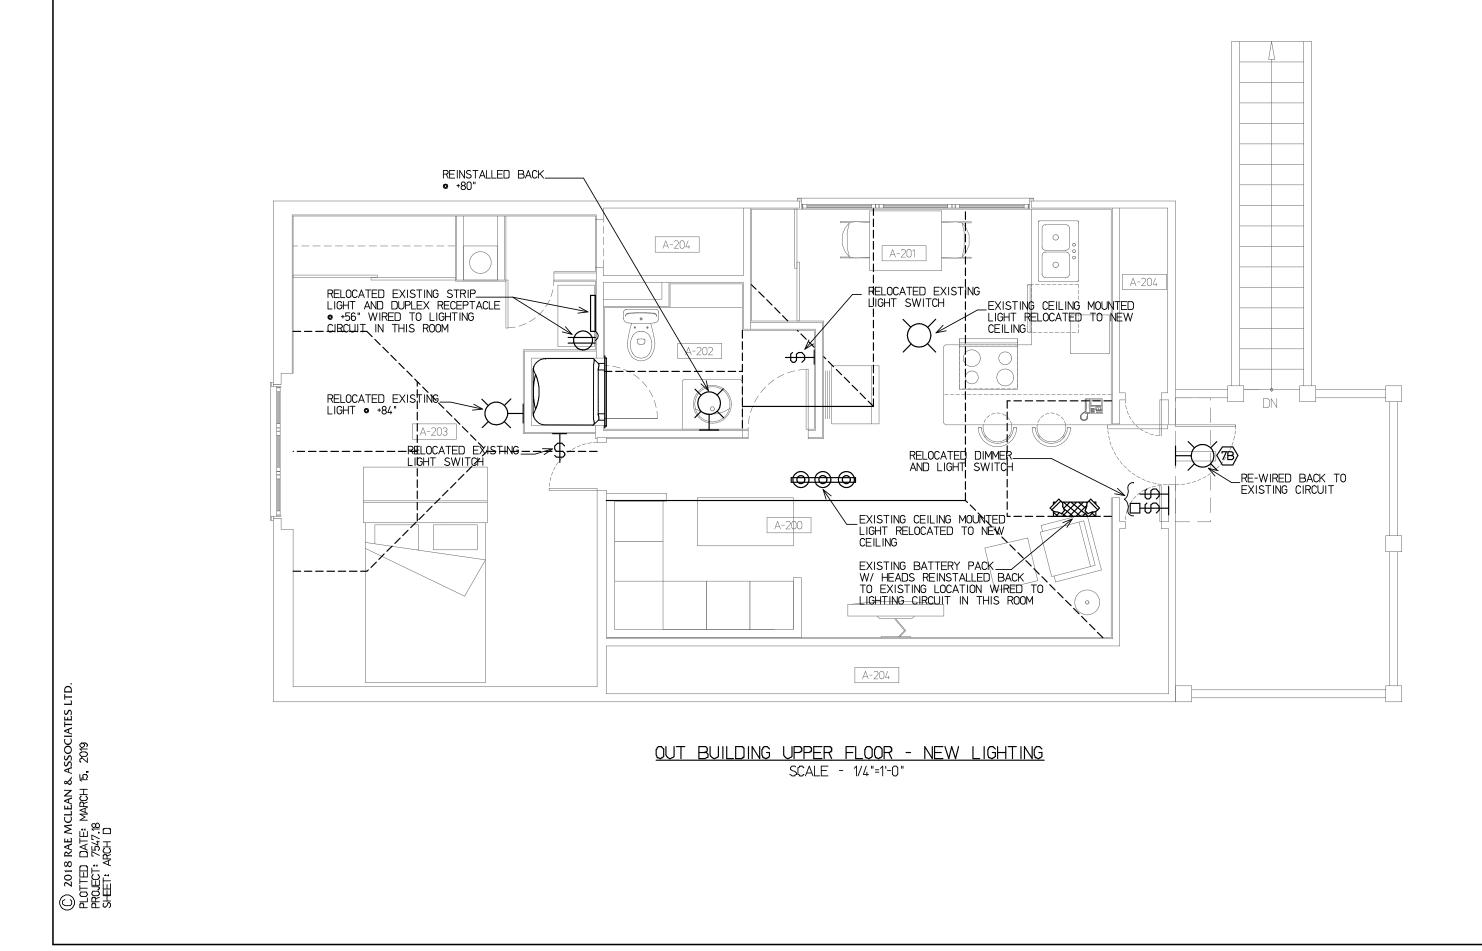
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| drawing drawn date scale | g info D.B. D.L. JULY 2018 NOTED |

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E-5

| 225A | A. E | SUSSING | |
|-------|------|---------|------|
| SURFA | | — MTG. | |
| WAT | TAGE | | |
| øĄ | øB | BKR. | CIR. |
| | | 15A | 2 |
| | | 15A | 4 |
| | | 15A | 6 |
| | | 15A | 8 |
| | | 15A | 10 |
| | | 15A | 12 |
| | | 15A | 14 |
| | | 15A | 16 |
| | | 15A | 18 |
| | | 30A | 20 |
| | | 2P | 22 |
| | | 15A | 24 |
| | | 2P | 26 |
| | | 15A | 28 |
| | | 15A | 30 |
| | | 15A | 32 |
| | | 15A | 34 |
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| | | | 38 |
| | | 70A | 40 |
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OUT BUILDING UPPER FLOOR - DEMOLITION LIGHTING SCALE - 1/4"=1'-0"

