



Parks Canada

Asset & Environmental  
Management  
Architectural &  
Engineering Services

Parcs Canada

Gestion des biens et  
de l'environnement  
Services d'architecture  
et d'ingénierie



Parks Canada

Banff National Park  
Banff Field Unit

Parcs Canada

Parc national Banff  
Unité de gestion de Banff



# BANFF ADMINISTRATION BUILDING

101 MOUNTAIN AVE., BANFF, AB, T1L 1K2




Parks Canada

Asset & Environmental  
Management  
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Engineering Services


Parcs Canada

Gestion des biens et  
de l'environnement  
Services d'architecture  
et d'ingénierie

revisions	description	date
4	ISSUED FOR TENDER	19/03/20
3	ISSUED FOR REVIEW	18/08/24
2	ISSUED FOR REVIEW	18/08/03
1	ISSUED FOR REVIEW	18/07/25

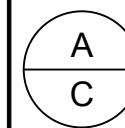

A detail no.  
no. du detail  
B location drawing no.  
sur dessin no.  
C drawing no.  
dessin no.

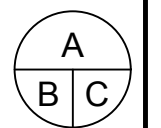

project projet

**BANFF ADMINISTRATION  
BUILDING**

drawing dessin

**COVER SHEET**

Designed By	CK	Conçu par
Date		(yyyy/mm/dd)
Drawn By	TK	Dessiné par
Date		(yyyy/mm/dd)
Reviewed By	JD	Examiné par
Date		(yyyy/mm/dd)
Approved By	JD	Approuvé par
Date		(yyyy/mm/dd)

Project no. No. du projet

Drawing no. No. du dessin

**A101**


# DRAWINGS LIST

## ARCHITECTURAL

- A101 COVER SHEET
- A102 KEY PLAN
- A103 SCOPE OF WORK, GENERAL NOTES, AND SITE PLAN
- A104 MAIN TOWER
- A105 NORTH ELEVATION
- A106 NORTH WING
- A107 EAST ELEVATION
- A108 WEST ELEVATION
- A109 SOUTH ELEVATION - 1
- A110 SOUTH ELEVATION - 2
- A111 SOUTH ELEVATION - 3
- A112 SOUTH ELEVATION - 4
- A113 MAIN TOWER FLAT ROOF
- A114 SOUTH ELEVATION FLAT ROOF
- A115 SLOPED ROOF, DORMERS, AND CHIMNEYS
- A116 WINDOW SCHEDULE -1
- A117 WINDOW SCHEDULE - 2

## DETAILS

- DT101 MASONRY DETAILS
- DT102 MASONRY AND CONCRETE DETAILS
- DT103 SLOPED ROOF / CEDAR SHAKES DETAILS
- DT104 SLOPED ROOF / FLASHING DETAILS
- DT105 FLAGPOLE AND SLOPING OF FLAT ROOFS
- DT106 FLAT ROOF DETAILS

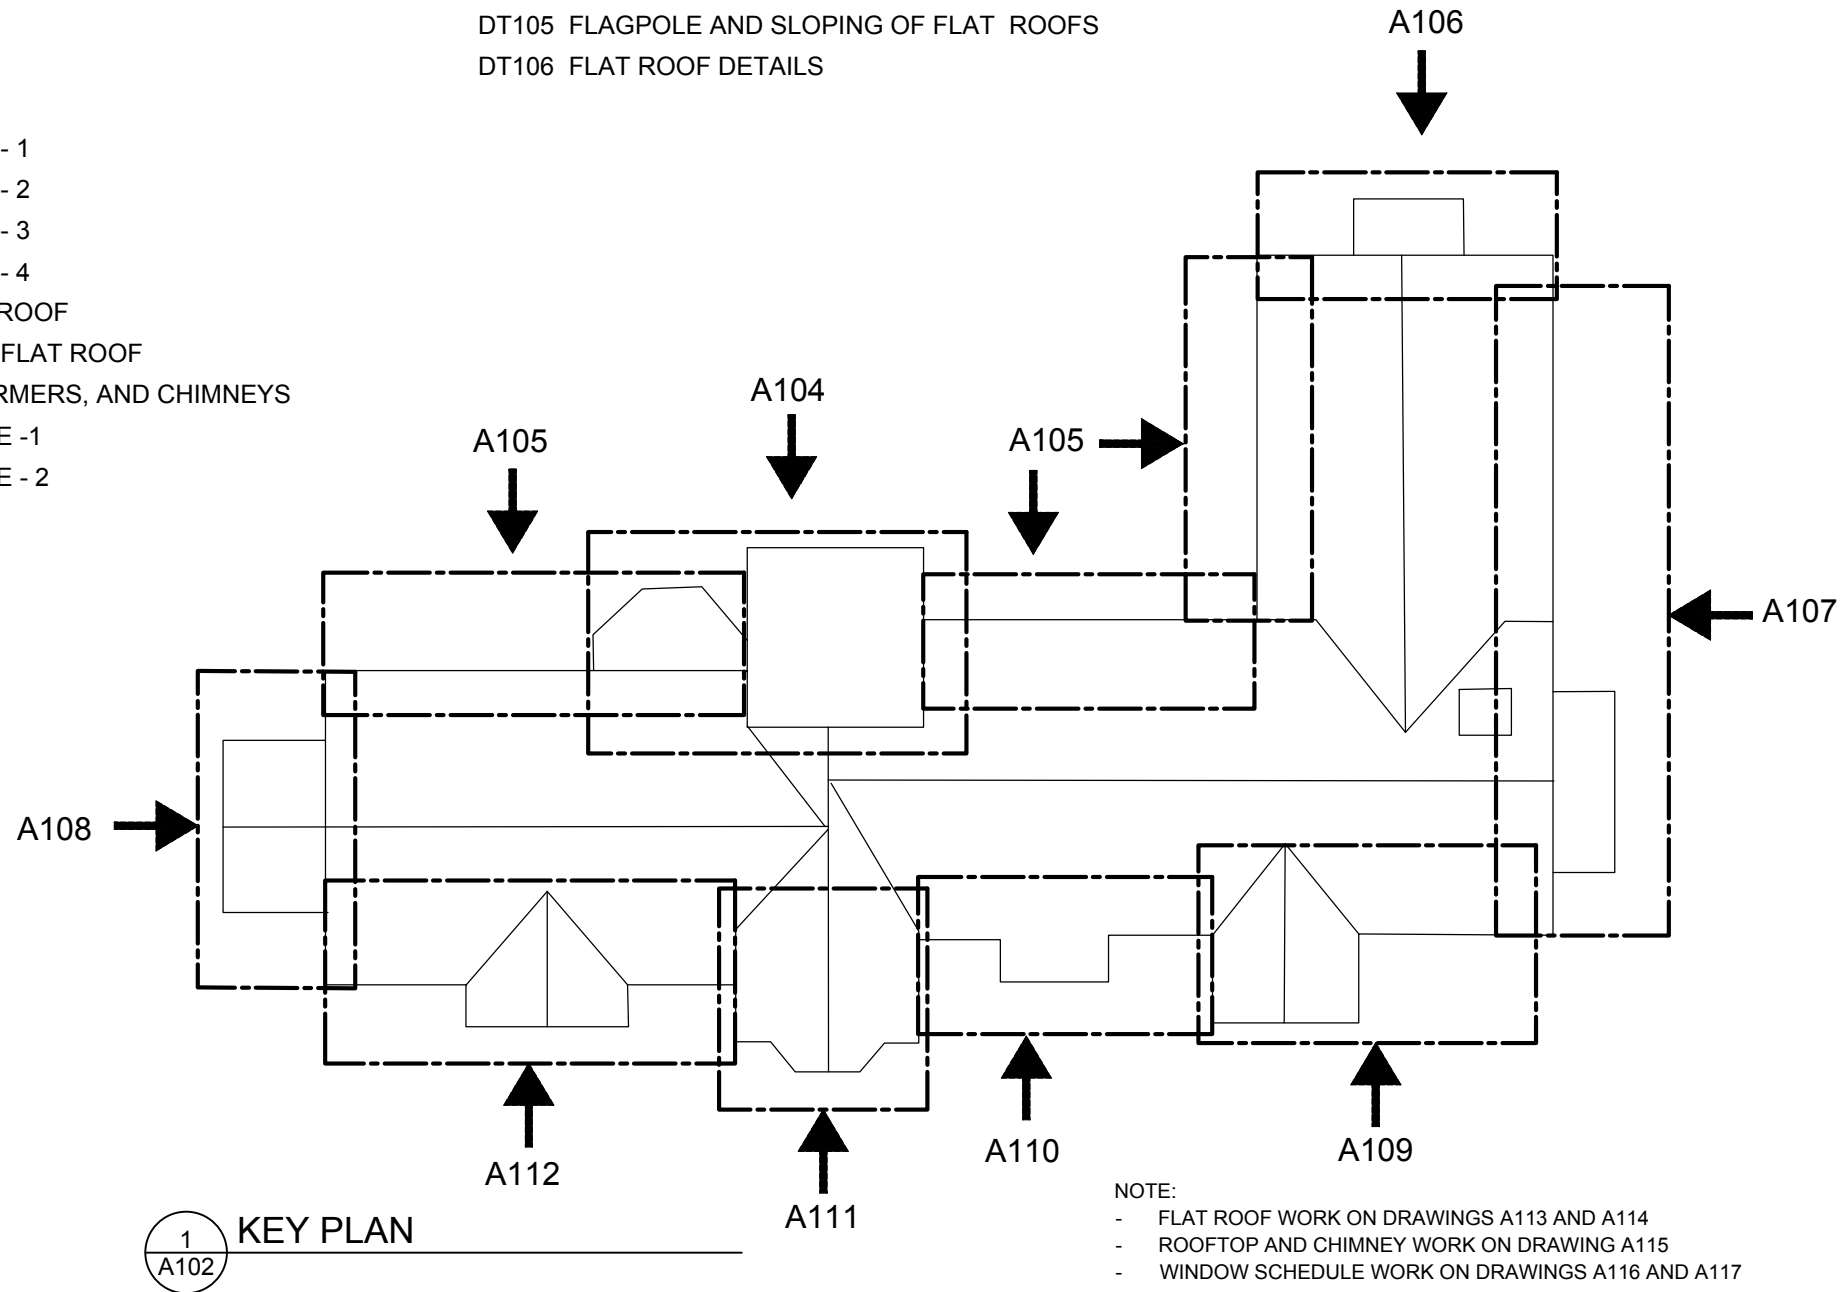

NOTE:  
 - FLAT ROOF WORK ON DRAWINGS A113 AND A114  
 - ROOFTOP AND CHIMNEY WORK ON DRAWING A115  
 - WINDOW SCHEDULE WORK ON DRAWINGS A116 AND A117

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A C	A detail no. no. du detail B location drawing no. sur dessin no. C drawing no. dessin no.	A B C
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project BANFF ADMINISTRATION BUILDING projet


drawing KEY PLAN dessin

Designed By	CK	Conçu par
Date		(yyyy/mm/dd)
Drawn By	TK	Dessiné par
Date		(yyyy/mm/dd)
Reviewed By	JD	Examiné par
Date		(yyyy/mm/dd)
Approved By	JD	Approuvé par
Date		(yyyy/mm/dd)

Project no. No. du projet

Drawing no. A102 No. du dessin



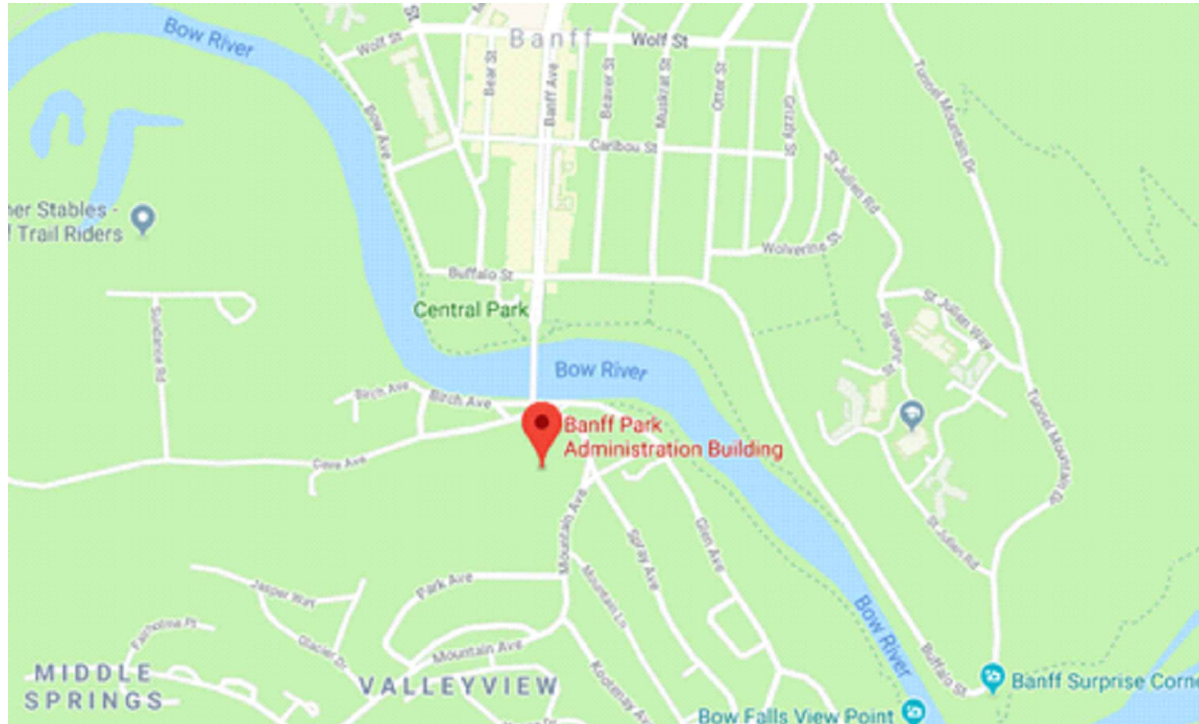

1 LOCATION OF SITE  
A103



2 SITE PLAN  
A103

**SCOPE OF WORK:**

- LOCALIZED MASONRY RAKING OUT, REPOINTING, AND CLEANING, INCLUDING 100% RAKING OUT AND REPOINTING OF ALL BRICK MASONRY BENEATH FLASHING, MASONRY PARAPETS, AND MASONRY LOW-WALLS.
- LOCALIZED CONCRETE AND MASONRY REPAIRS, INCLUDING LOCALIZED DUTCHMANS, HELICAL TIES, AND DOWELS.
- COMPLETE ROOF REPLACEMENT OF EXISTING STEPPED ROOFTOP FLASHING, AND ALL FLAT AND SLOPED ROOFS, INCLUDING SIDE OF DORMERS COVERED IN CEDAR SHAKES.
- INSTALLATION OF NEW ROOFTOP FLAGPOLE AND MAIN ENTRANCE HANDRAILS
- RE-SLOPING FLAT ROOFS TO ENSURE POSITIVE DRAINAGE TOWARDS EXISTING DRAINS AND SCUPPERS.
- COMPLETE REMOVAL OF ALL GUTTERS AND DOWNSPOUTS TO FACILITATE MASONRY AND ROOF WORK. REPLACE ALL FASCIAS AND SOFFITS. GUTTERS AND DOWNSPOUTS TO BE REINSTATED UPON COMPLETION OF MASONRY AND ROOFING WORK.
- LOCALIZED REPAIRS AND PAINTING OF THE EXTERIOR WOOD WINDOW FRAMES AND FLY SCREENS. EXISTING FLY SCREENS TO BE REMOVED TO FACILITATE WORK AND REINSTATED UPON COMPLETION.

**GENERAL NOTES:**

1. VERIFY ALL DIMENSIONS ON DRAWINGS AND REPORT ANY INCONSISTENCIES WITH DRAWINGS TO DEPARTMENTAL REPRESENTATIVE BEFORE PROCEEDING WITH WORK.
2. PROJECT SCOPE OF WORK IS LIMITED TO MASONRY AND ROOFING RELATED MAINTENANCE REPAIR WORK AND DOES NOT INCLUDE AN EVALUATION OF THE BUILDING AGAINST THE NBCC
3. AREAS OF WORK IDENTIFIED THROUGH PHOTO ELEVATIONS MAY VARY DUE TO DISTORTION. DO NOT SCALE FROM PHOTOS.
4. ESTIMATED QUANTITIES OF WORK HAVE BEEN DETERMINED BASED ON OBSERVABLE CONDITIONS THROUGH AN AT-GRADE SITE SURVEY. ACTUAL QUANTITIES AT EACH LOCATION MAY VARY. NOTIFY THE DEPARTMENTAL REPRESENTATIVE WHERE ON-SITE CONDITIONS MAY REQUIRE ADDITIONAL WORK BEYOND THE TOTAL ESTIMATED QUANTITIES AND REQUIRE MODIFICATION OF CONTRACT DOCUMENTS.
5. REMOVE ALL SIGNS, FIXTURES, ETC. WHERE REQUIRED TO COMPLETE WORK. REINSTATE UPON COMPLETION OF WORK.
6. THE BUILDING WILL REMAIN OPERATIONAL DURING THE COURSE OF WORK. ALL EFFORTS TO MINIMIZE DISTURBANCE TO OPERATIONS SHALL BE MADE. THE CONTRACTOR SHALL MAINTAIN SAFE ACCESS AND EGRESS FROM BUILDING AT ALL TIMES.
7. TO MINIMIZE SITE DISTURBANCE, PROVIDE SCAFFOLDING ONLY IN AREAS INACCESSIBLE BY MAN-LIFTS. COMPLETE WORK IN LOCALIZED SECTIONS TO MINIMIZE DISRUPTION AND IMPACT TO VISITORS AND OPERATIONS.
8. THE CONTRACTOR SHALL HAVE THE SOLE RESPONSIBILITY FOR THE DESIGN, ERECTION, OPERATION, MAINTENANCE, AND REMOVAL OF TEMPORARY SUPPORTS, STRUCTURE AND FACILITIES AND THE DESIGN AND EXECUTION OF CONSTRUCTION METHODS REQUIRED IN THEIR USE.
9. THE CONTRACTOR SHALL RESTORE ANY DISTURBED AREAS TO EQUAL OR BETTER CONDITION THAN EXISTED BEFORE CONSTRUCTION.
10. THE USE OF THESE DRAWINGS SHALL BE STRICTLY LIMITED TO THE INSTRUCTIONS IN THE REVISION BLOCK. BUILDING FROM THESE DRAWINGS SHALL PROCEED ONLY WHEN "ISSUED FOR CONSTRUCTION".

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A C	A detail no. / no. du detail B location drawing no. / sur dessin no. C drawing no. / dessin no.	A B C
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project / projet

**BANFF ADMINISTRATION BUILDING**


drawing / dessin  
**SCOPE, GENERAL NOTES, AND SITE PLAN**

Designed By / Conçu par	CK
Date / (yyyy/mm/dd)	
Drawn By / Dessiné par	TK
Date / (yyyy/mm/dd)	
Reviewed By / Examiné par	JD
Date / (yyyy/mm/dd)	
Approved By / Approuvé par	JD
Date / (yyyy/mm/dd)	

Project no. / No. du projet

Drawing no. / No. du dessin  
**A103**



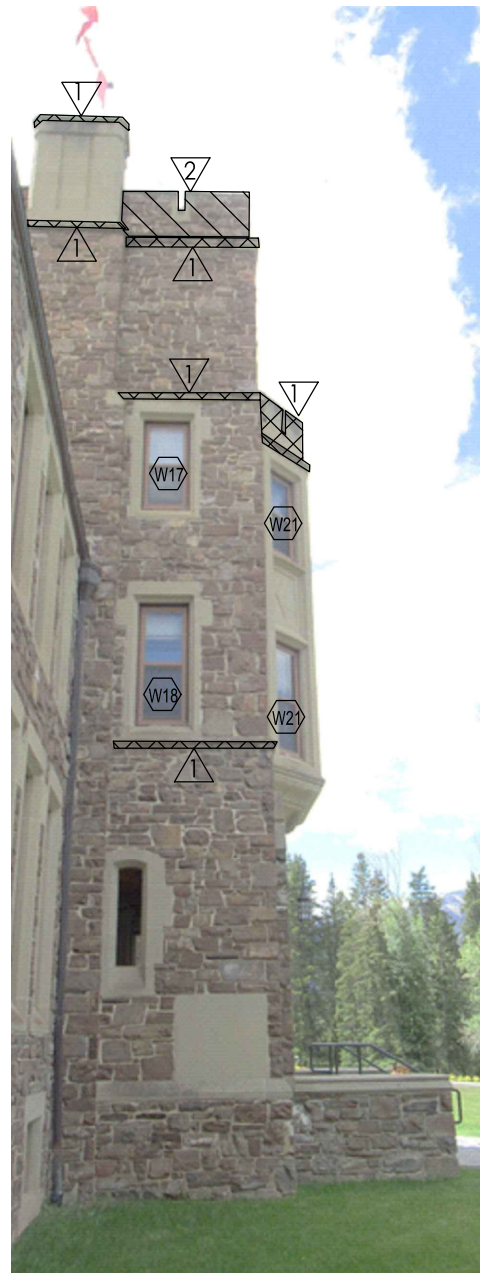


1 MAIN TOWER EAST ELEVATION  
A104



2 MAIN TOWER NORTH ELEVATION  
A104

REPLACE IN-KIND  
BROKEN GLAZED  
ELEMENT

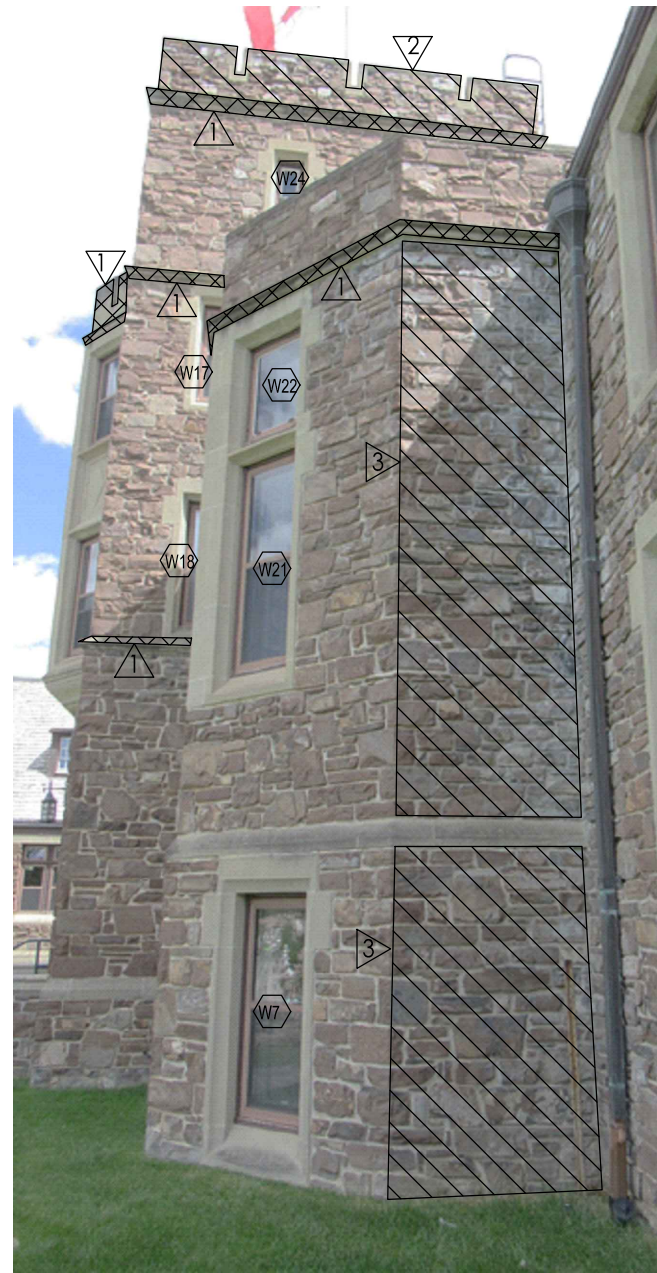


3 MAIN TOWER WEST ELEVATION  
A104


**DRAWING LEGEND**

- 1 CLEAN STAINED SANDSTONE BAND COURSES, WEATHERING BANDS, CAPSTONES AND CRENELS. REMOVE ALL BIOLOGICAL GROWTH.
- 2 100% RAKE OUT AND REPOINT MASONRY JOINTS. SEE DETAILS 4/DT101 AND 5/DT101. 100% RAKE OUT AND REPOINT ALL EXPOSED SIDES (I.E. FRONT AND BACK) OF ALL MASONRY LOW WALLS AND PARAPETS. NOTE FLAT ROOF PARAPETS HAVE A BRICK BACKUP - ONLY RAKE OUT AND REPOINT RUNDLE MASONRY.
- 3 CLEAN EFFLORESCENCE OFF FACE OF RUNDLE MASONRY. 100% RAKE OUT AND REPOINT MASONRY JOINTS. SEE DETAILS 4/DT101 AND 5/DT101.
- 4 REMOVE AND RESET ALL RUNDLE MASONRY ABOVE GRADE IN WINDOW WELL. 100% RAKE OUT AND REPOINT EXPOSED MASONRY WITHIN WINDOW WELL.
- 5 100% RAKE OUT AND REPOINT RUNDLE MASONRY. SEE DETAILS 4/DT101 AND 5/DT101. INSTALL HELICAL TILES IN HORIZONTAL JOINTS FOLLOWING DETAILS 1/DT101 WITH GENERAL SPACING OF TIES FOLLOWING DETAIL 6/DT101.
- 6 LOCALIZED DUTCHMAN REPAIR

- 7 CLEAN FERRIC STAINING OFF CONCRETE STEPS
- 8 LOCALIZED CONCRETE PATCH REPAIR FOLLOWING DETAIL 3/DT102.
- 9 REMOVE AND RESET SANDSTONE CAPSTONES IN A FULL BED OF MORTAR. EACH CAPSTONE TO RECEIVE TWO PINS FOLLOWING DETAIL 2/DT101. ALLOW FOR THE REMOVAL AND RESETTING OF TOP COURSE OF RUNDLE MASONRY WHICH MAY BECOME LOOSE DURING CAPSTONE REMOVAL.
- 10 REMOVE CORRODED STEEL BASE OF HANDRAIL. REINSTALL FOLLOWING CONNECTION DETAIL 4/DT102

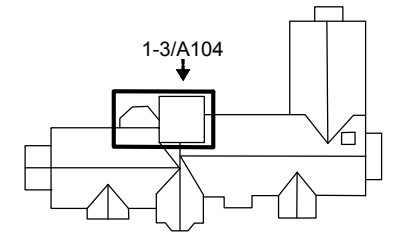

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project / projet

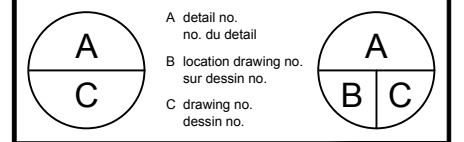**BANFF ADMINISTRATION BUILDING**

drawing / dessin  
**MAIN TOWER**

Designed By	CK	Conçu par
Date		(yyyy/mm/dd)
Drawn By	TK	Dessiné par
Date		(yyyy/mm/dd)
Reviewed By	JD	Examiné par
Date		(yyyy/mm/dd)
Approved By	JD	Approuvé par
Date		(yyyy/mm/dd)

Project no. / No. du projet

Drawing no. / No. du dessin

**A104**





1 NORTH ELEVATION- EAST OF MAIN TOWER  
A105




2 NORTH WING-WEST ELEVATIONS  
A105




3 NORTH ELEVATION-WEST OF MAIN TOWER  
A105

**DRAWING LEGEND**

- 1 CLEAN STAINED SANDSTONE BAND COURSES, WEATHERING BANDS, CAPSTONES AND CRENELS. REMOVE ALL BIOLOGICAL GROWTH.
- 2 100% RAKE OUT AND REPOINT MASONRY JOINTS. SEE DETAILS 4/DT101 AND 5/DT101. 100% RAKE OUT AND REPOINT ALL EXPOSED SIDES (I.E. FRONT AND BACK) OF ALL MASONRY LOW WALLS AND PARAPETS. NOTE FLAT ROOF PARAPETS HAVE A BRICK BACKUP - ONLY RAKE OUT AND REPOINT RUNDLE MASONRY.
- 3 CLEAN EFFLORESCENCE OFF FACE OF RUNDLE MASONRY. 100% RAKE OUT AND REPOINT MASONRY JOINTS. SEE DETAILS 4/DT101 AND 5/DT101.
- 4 REMOVE AND RESET RUNDLE MASONRY ABOVE GRADE IN WINDOW WELL. 100% RAKE OUT AND REPOINT EXPOSED MASONRY WITHIN WINDOW WELL.
- 5 100% RAKE OUT AND REPOINT RUNDLE MASONRY. SEE DETAILS 4/DT101 AND 5/DT101. INSTALL HELICAL TILES IN HORIZONTAL JOINTS FOLLOWING DETAILS 1/DT101 WITH GENERAL SPACING OF TIES FOLLOWING DETAIL 6/DT101.
- 6 LOCALIZED DUTCHMAN REPAIR
- 7 CLEAN FERRIC STAINING OFF CONCRETE STEPS
- 8 LOCALIZED CONCRETE PATCH REPAIR FOLLOWING DETAIL 3/DT102.
- 9 REMOVE AND RESET SANDSTONE CAPSTONES IN A FULL BED OF MORTAR. EACH CAPSTONE TO RECEIVE TWO PINS FOLLOWING DETAIL 2/DT101. ALLOW FOR THE REMOVAL AND RESETTING OF TOP COURSE OF RUNDLE MASONRY WHICH MAY BECOME LOOSE DURING CAPSTONE REMOVAL.
- 10 REMOVE CORRODED STEEL BASE OF HANDRAIL. REINSTALL FOLLOWING CONNECTION DETAIL 4/DT102

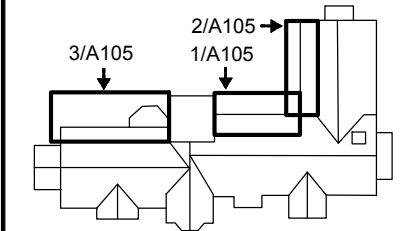

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4	ISSUED FOR TENDER	19/03/20
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project / projet

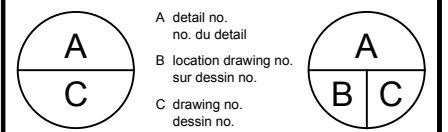**BANFF ADMINISTRATION BUILDING**

drawing / dessin  
**NORTH ELEVATION**

Designed By	CK	Conçu par
Date		(yyyy/mm/dd)
Drawn By	TK	Dessiné par
Date		(yyyy/mm/dd)
Reviewed By	JD	Examiné par
Date		(yyyy/mm/dd)
Approved By	JD	Approuvé par
Date		(yyyy/mm/dd)

Project no. / No. du projet

Drawing no. / No. du dessin

**A105**






**1 NORTH WING-NORTH ELEVATION**  
A106

**DRAWING LEGEND**

- ① CLEAN STAINED SANDSTONE BAND COURSES, WEATHERING BANDS, CAPSTONES AND CRENELS. REMOVE ALL BIOLOGICAL GROWTH.
- ② 100% RAKE OUT AND REPOINT MASONRY JOINTS. SEE DETAILS 4/DT101 AND 5/DT101. 100% RAKE OUT AND REPOINT ALL EXPOSED SIDES (I.E. FRONT AND BACK) OF ALL MASONRY LOW WALLS AND PARAPETS. NOTE FLAT ROOF PARAPETS HAVE A BRICK BACKUP - ONLY RAKE OUT AND REPOINT MASONRY.
- ③ CLEAN EFFLORESCENCE OFF FACE OF RUNDLE MASONRY. 100% RAKE OUT AND REPOINT MASONRY JOINTS. SEE DETAILS 4/DT101 AND 5/DT101.
- ④ REMOVE AND RESET RUNDLE MASONRY ABOVE GRADE IN WINDOW WELL. 100% RAKE OUT AND REPOINT EXPOSED MASONRY WITHIN WINDOW WELL.
- ⑤ 100% RAKE OUT AND REPOINT RUNDLE MASONRY. SEE DETAILS 4/DT101 AND 5/DT101. INSTALL HELICAL TIES IN HORIZONTAL JOINTS FOLLOWING DETAILS 1/DT101 WITH GENERAL SPACING OF TIES FOLLOWING DETAIL 6/DT101.
- ⑥ LOCALIZED DUTCHMAN REPAIR
- ⑦ CLEAN FERRIC STAINING OFF CONCRETE STEPS




**2 VESTIBULE-WEST ELEVATION**  
A106

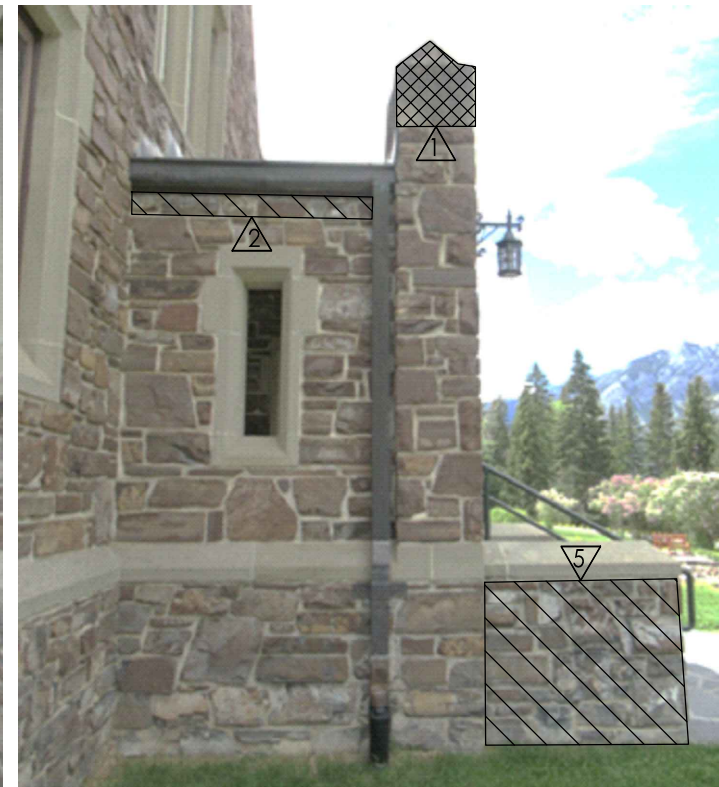


**3 VESTIBULE-EAST ELEVATION**  
A106

- ⑧ LOCALIZED CONCRETE PATCH REPAIR FOLLOWING DETAIL 3/DT102.
- ⑨ REMOVE AND RESET SANDSTONE CAPSTONES IN A FULL BED OF MORTAR. EACH CAPSTONE TO RECEIVE TWO PINS FOLLOWING DETAIL 2/DT101. ALLOW FOR THE REMOVAL AND RESETTING OF TOP COURSE OF RUNDLE MASONRY WHICH MAY BECOME LOOSE DURING CAPSTONE REMOVAL.
- ⑩ REMOVE CORRODED STEEL BASE OF HANDRAIL. REINSTALL FOLLOWING CONNECTION DETAIL 4/DT102

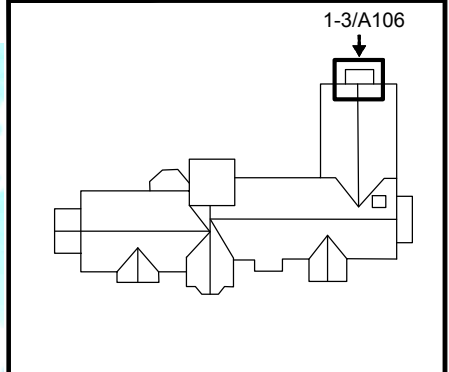

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project BANFF ADMINISTRATION BUILDING

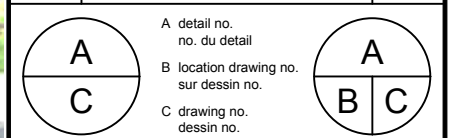drawing	NORTH WING		dessin
Designed By	CK	Conçu par	
Date		(yyyy/mm/dd)	
Drawn By	TK	Dessiné par	
Date		(yyyy/mm/dd)	
Reviewed By	JD	Examiné par	
Date		(yyyy/mm/dd)	
Approved By	JD	Approuvé par	
Date		(yyyy/mm/dd)	

Project no. / No. du projet

Drawing no. / No. du dessin

**A106**





1 EAST ELEVATION-ENTRANCE  
A107




2 EAST ELEVATION-NORTH OF ENTRANCE  
A107

**DRAWING LEGEND**


- ① CLEAN STAINED SANDSTONE BAND COURSES, WEATHERING BANDS, CAPSTONES AND CRENELS. REMOVE ALL BIOLOGICAL GROWTH.
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- ⑤ 100% RAKE OUT AND REPOINT RUNDLE MASONRY. SEE DETAILS 4/DT101 AND 5/DT101. INSTALL HELICAL TILES IN HORIZONTAL JOINTS FOLLOWING DETAILS 1/DT101 WITH GENERAL SPACING OF TIES FOLLOWING DETAIL 6/DT101.
- ⑥ LOCALIZED DUTCHMAN REPAIR. SEE DETAIL /DT102.
- ⑦ CLEAN FERRIC STAINING OFF CONCRETE STEPS

- ⑧ LOCALIZED CONCRETE PATCH REPAIR FOLLOWING DETAIL 3/DT102.
- ⑨ REMOVE AND RESET SANDSTONE CAPSTONES IN A FULL BED OF MORTAR. EACH CAPSTONE TO RECEIVE TWO PINS FOLLOWING DETAIL 2/DT101. ALLOW FOR THE REMOVAL AND RESETTING OF TOP COURSE OF RUNDLE MASONRY WHICH MAY BECOME LOOSE DURING CAPSTONE REMOVAL.
- ⑩ REMOVE CORRODED STEEL BASE OF HANDRAIL. REINSTALL FOLLOWING CONNECTION DETAIL 4/DT102

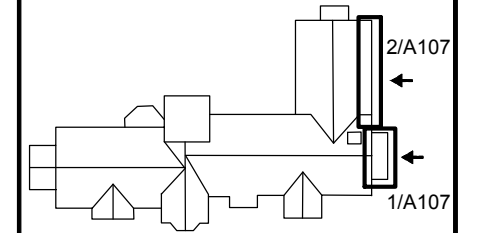

revisions		
4	ISSUED FOR TENDER	19/03/20
3	ISSUED FOR REVIEW	18/08/24
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project	description	date

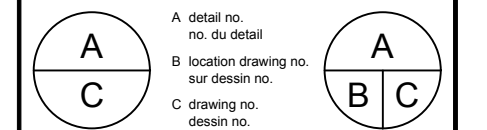

project	description	date

**BANFF ADMINISTRATION BUILDING**

drawing	description	dessin
	EAST ELEVATION	

Designed By	CK	Conçu par
Date		(yyyy/mm/dd)
Drawn By	TK	Dessiné par
Date		(yyyy/mm/dd)
Reviewed By	JD	Examiné par
Date		(yyyy/mm/dd)
Approved By	JD	Approuvé par
Date		(yyyy/mm/dd)

Project no.	No. du projet
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Drawing no.	No. du dessin
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**A107**





1 WEST ELEVATION-NW CORNER  
A108



2 WEST ELEVATION  
A108




3 WEST ELEVATION- SW CORNER  
A108


**DRAWING LEGEND**

- ① CLEAN STAINED SANDSTONE BAND COURSES, WEATHERING BANDS, CAPSTONES AND CRENELS. REMOVE ALL BIOLOGICAL GROWTH.
- ② 100% RAKE OUT AND REPOINT MASONRY JOINTS. SEE DETAILS 4/DT101 AND 5/DT101. 100% RAKE OUT AND REPOINT ALL EXPOSED SIDES (I.E. FRONT AND BACK) OF ALL MASONRY LOW WALLS AND PARAPETS. NOTE FLAT ROOF PARAPETS HAVE A BRICK BACKUP - ONLY RAKE OUT AND REPOINT RUNDLE MASONRY.
- ③ CLEAN EFFLORESCENCE OFF FACE OF RUNDLE MASONRY. 100% RAKE OUT AND REPOINT MASONRY JOINTS. SEE DETAILS 4/DT101 AND 5/DT101.
- ④ REMOVE AND RESET RUNDLE MASONRY ABOVE GRADE IN WINDOW WELL. 100% RAKE OUT AND REPOINT EXPOSED MASONRY WITHIN WINDOW WELL.
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- ⑥ LOCALIZED DUTCHMAN REPAIR

- ⑦ CLEAN FERRIC STAINING OFF CONCRETE STEPS
- ⑧ LOCALIZED CONCRETE PATCH REPAIR FOLLOWING DETAIL 3/DT102.
- ⑨ REMOVE AND RESET SANDSTONE CAPSTONES IN A FULL BED OF MORTAR. EACH CAPSTONE TO RECEIVE TWO PINS FOLLOWING DETAIL 2/DT101. ALLOW FOR THE REMOVAL AND RESETTING OF TOP COURSE OF RUNDLE MASONRY WHICH MAY BECOME LOOSE DURING CAPSTONE REMOVAL.
- ⑩ REMOVE CORRODED STEEL BASE OF HANDRAIL. REINSTALL FOLLOWING CONNECTION DETAIL 4/DT102

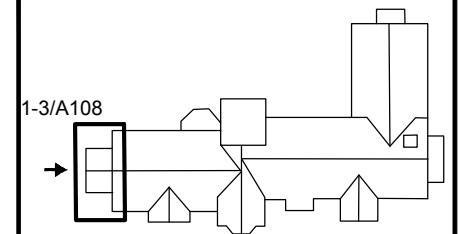

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project BANFF ADMINISTRATION BUILDING projet

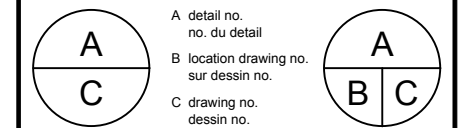drawing WEST ELEVATION dessin




Designed By	CK	Conçu par	
Date		(yyyy/mm/dd)	
Drawn By	TK	Dessiné par	
Date		(yyyy/mm/dd)	
Reviewed By	JD	Examiné par	
Date		(yyyy/mm/dd)	
Approved By	JD	Approuvé par	
Date		(yyyy/mm/dd)	

Project no. No. du projet

Drawing no. No. du dessin

**A108**



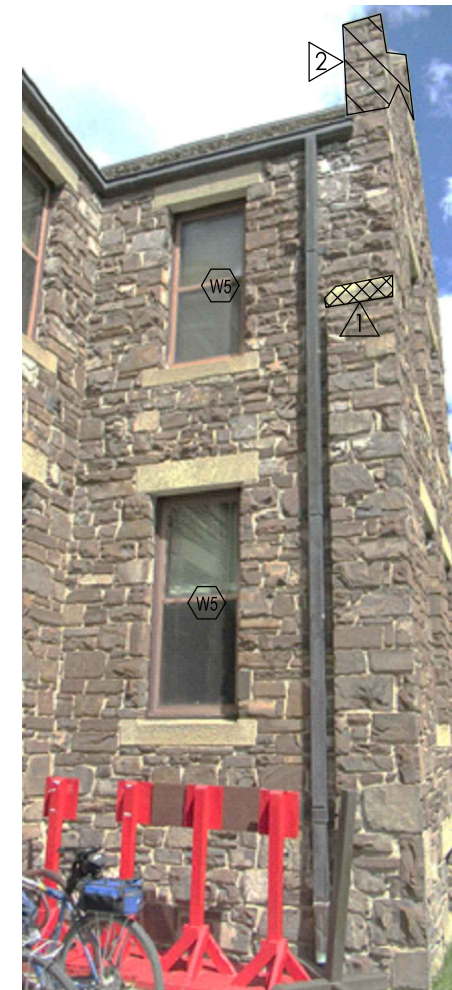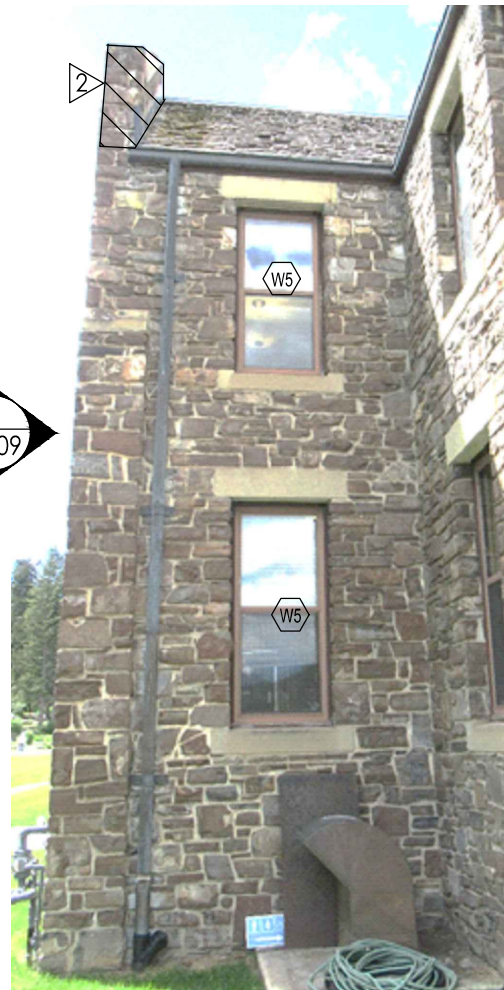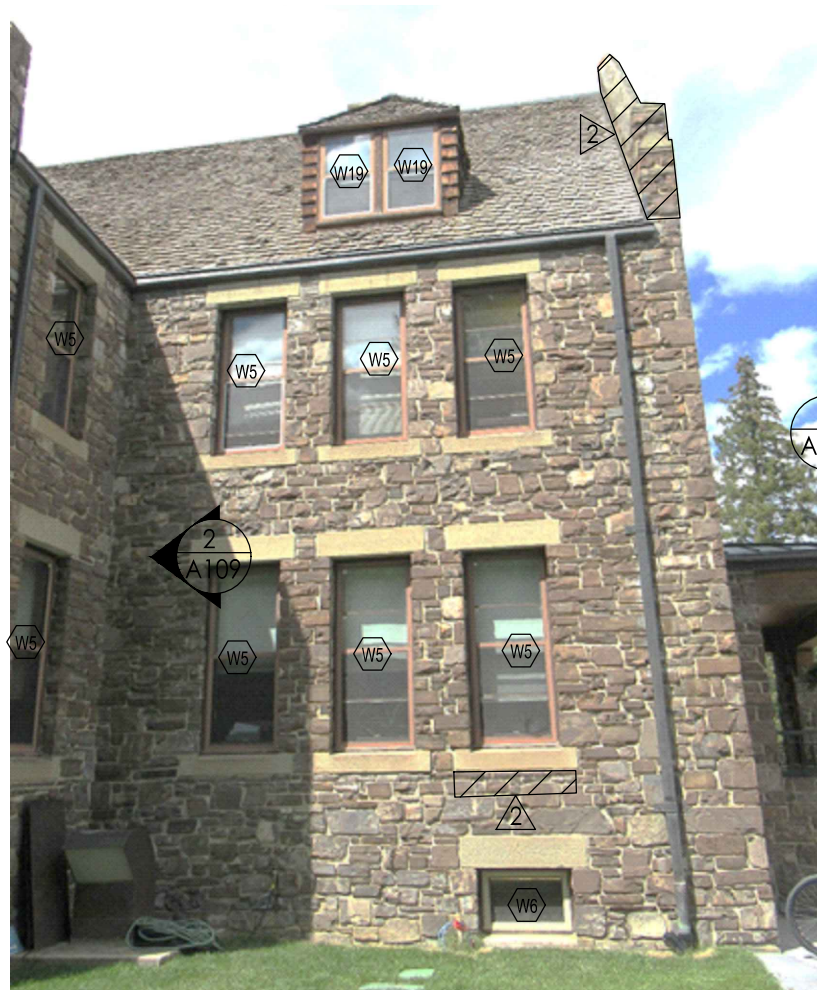

1 SOUTH ELEVATION  
A109

2 SOUTH ELEVATION  
A109


3 SOUTH ELEVATION  
A109

4 SOUTH ELEVATION  
A109

**DRAWING LEGEND**

- 1 CLEAN STAINED SANDSTONE BAND COURSES, WEATHERING BANDS, CAPSTONES AND CRENELS. REMOVE ALL BIOLOGICAL GROWTH.
- 2 100% RAKE OUT AND REPOINT MASONRY JOINTS. SEE DETAILS 4/DT101 AND 5/DT101. 100% RAKE OUT AND REPOINT ALL EXPOSED SIDES (I.E. FRONT AND BACK) OF ALL MASONRY LOW WALLS AND PARAPETS. NOTE FLAT ROOF PARAPETS HAVE A BRICK BACKUP - ONLY RAKE OUT AND REPOINT RUNDLE MASONRY.
- 3 CLEAN EFFLORESCENCE OFF FACE OF RUNDLE MASONRY. 100% RAKE OUT AND REPOINT MASONRY JOINTS. SEE DETAILS 4/DT101 AND 5/DT101.
- 4 REMOVE AND RESET RUNDLE MASONRY ABOVE GRADE IN WINDOW WELL. 100% RAKE OUT AND REPOINT EXPOSED MASONRY WITHIN WINDOW WELL.
- 5 100% RAKE OUT AND REPOINT RUNDLE MASONRY. SEE DETAILS 4/DT101 AND 5/DT101. INSTALL HELICAL TIES IN HORIZONTAL JOINTS FOLLOWING DETAILS 1/DT101 WITH GENERAL SPACING OF TIES FOLLOWING DETAIL 6/DT101.
- 6 LOCALIZED DUTCHMAN REPAIR

- 7 CLEAN FERRIC STAINING OFF CONCRETE STEPS
- 8 LOCALIZED CONCRETE PATCH REPAIR FOLLOWING DETAIL 3/DT102.
- 9 REMOVE AND RESET SANDSTONE CAPSTONES IN A FULL BED OF MORTAR. EACH CAPSTONE TO RECEIVE TWO PINS FOLLOWING DETAIL 2/DT101. ALLOW FOR THE REMOVAL AND RESETTING OF TOP COURSE OF RUNDLE MASONRY WHICH MAY BECOME LOOSE DURING CAPSTONE REMOVAL.
- 10 REMOVE CORRODED STEEL BASE OF HANDRAIL. REINSTALL FOLLOWING CONNECTION DETAIL 4/DT102

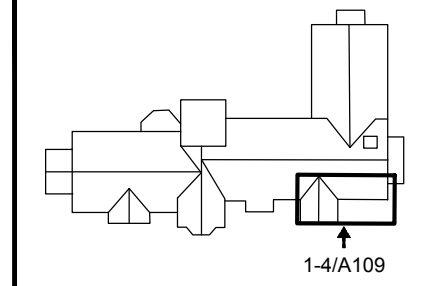

revisions	description	date
4	ISSUED FOR TENDER	19/03/20
3	ISSUED FOR REVIEW	18/08/24
2	ISSUED FOR REVIEW	18/08/03
1	ISSUED FOR REVIEW	18/07/25

A detail no. / no. du détail  
 B location drawing no. / sur dessin no.  
 C drawing no. / dessin no.

project / projet  
**BANFF ADMINISTRATION BUILDING**

drawing / dessin  
**SOUTH ELEVATION - 1**

Designed By	CK	Conçu par
Date		(yyyy/mm/dd)
Drawn By	TK	Dessiné par
Date		(yyyy/mm/dd)
Reviewed By	JD	Examiné par
Date		(yyyy/mm/dd)
Approved By	JD	Approuvé par
Date		(yyyy/mm/dd)

Project no. / No. du projet

Drawing no. / No. du dessin  
**A109**





1 SOUTH ELEVATION  
A110



2 SOUTH ELEVATION  
A110




3 SOUTH ELEVATION  
A110


**DRAWING LEGEND**

- 1 CLEAN STAINED SANDSTONE BAND COURSES, WEATHERING BANDS, CAPSTONES AND CRENELS. REMOVE ALL BIOLOGICAL GROWTH.
- 2 100% RAKE OUT AND REPOINT MASONRY JOINTS. SEE DETAILS 4/DT101 AND 5/DT101. 100% RAKE OUT AND REPOINT ALL EXPOSED SIDES (I.E. FRONT AND BACK) OF ALL MASONRY LOW WALLS AND PARAPETS. NOTE FLAT ROOF PARAPETS HAVE A BRICK BACKUP - ONLY RAKE OUT AND REPOINT RUNDLE MASONRY.
- 3 CLEAN EFFLORESCENCE OFF FACE OF RUNDLE MASONRY. 100% RAKE OUT AND REPOINT MASONRY JOINTS. SEE DETAILS 4/DT101 AND 5/DT101.
- 4 REMOVE AND RESET RUNDLE MASONRY ABOVE GRADE IN WINDOW WELL. 100% RAKE OUT AND REPOINT EXPOSED MASONRY WITHIN WINDOW WELL.
- 5 100% RAKE OUT AND REPOINT RUNDLE MASONRY. SEE DETAILS 4/DT101 AND 5/DT101. INSTALL HELICAL TILES IN HORIZONTAL JOINTS FOLLOWING DETAILS 1/DT101 WITH GENERAL SPACING OF TIES FOLLOWING DETAIL 6/DT101.
- 6 LOCALIZED DUTCHMAN REPAIR

- 7 CLEAN FERRIC STAINING OFF CONCRETE STEPS
- 8 LOCALIZED CONCRETE PATCH REPAIR FOLLOWING DETAIL 3/DT102.
- 9 REMOVE AND RESET SANDSTONE CAPSTONES IN A FULL BED OF MORTAR. EACH CAPSTONE TO RECEIVE TWO PINS FOLLOWING DETAIL 2/DT101. ALLOW FOR THE REMOVAL AND RESETTING OF TOP COURSE OF RUNDLE MASONRY WHICH MAY BECOME LOOSE DURING CAPSTONE REMOVAL.
- 10 REMOVE CORRODED STEEL BASE OF HANDRAIL. REINSTALL FOLLOWING CONNECTION DETAIL 4/DT102

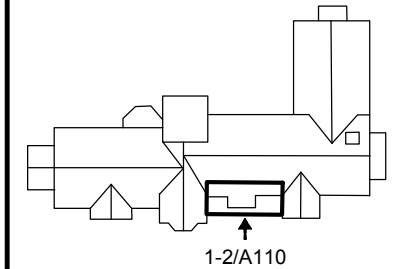

revisions	description	date
4	ISSUED FOR TENDER	19/03/20
3	ISSUED FOR REVIEW	18/08/24
2	ISSUED FOR REVIEW	18/08/03
1	ISSUED FOR REVIEW	18/07/25

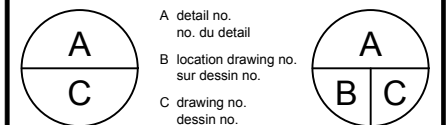

project BANFF ADMINISTRATION BUILDING project

**BANFF ADMINISTRATION BUILDING**

drawing SOUTH ELEVATION - 2 dessin

Designed By	CK	Conçu par
Date		(yyyy/mm/dd)
Drawn By	TK	Dessiné par
Date		(yyyy/mm/dd)
Reviewed By	JD	Examiné par
Date		(yyyy/mm/dd)
Approved By	JD	Approuvé par
Date		(yyyy/mm/dd)

Project no. No. du projet

Drawing no. No. du dessin

A110





1 SOUTH ELEVATION  
A111



2 SOUTH ELEVATION  
A111




3 SOUTH ELEVATION  
A111

INSTALL NEW CLAMP-TITE 3 INCH BOX CLAMP COPPER SCUPPER AND FABRICATE DOWNSPOUT TO SCUPPER TO MATCH OTHER EXISTING DOWNSPOUTS ON BUILDING. BASE OF DOWNSPOUT TO EXTEND 300 MM OUT FROM THE BUILDING TO TERMINATE WITH SURFACE DRAINAGE.


**DRAWING LEGEND**

- 1 CLEAN STAINED SANDSTONE BAND COURSES, WEATHERING BANDS, CAPSTONES AND CRENELS. REMOVE ALL BIOLOGICAL GROWTH.
- 2 100% RAKE OUT AND REPOINT MASONRY JOINTS. SEE DETAILS 4/DT101 AND 5/DT101. 100% RAKE OUT AND REPOINT ALL EXPOSED SIDES (I.E. FRONT AND BACK) OF ALL MASONRY LOW WALLS AND PARAPETS. NOTE FLAT ROOF PARAPETS HAVE A BRICK BACKUP - ONLY RAKE OUT AND REPOINT RUNDLE MASONRY.
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- 4 REMOVE AND RESET RUNDLE MASONRY ABOVE GRADE IN WINDOW WELL. 100% RAKE OUT AND REPOINT EXPOSED MASONRY WITHIN WINDOW WELL.
- 5 100% RAKE OUT AND REPOINT RUNDLE MASONRY. SEE DETAILS 4/DT101 AND 5/DT101. INSTALL HELICAL TILES IN HORIZONTAL JOINTS FOLLOWING DETAILS 1/DT101 WITH GENERAL SPACING OF TIES FOLLOWING DETAIL 6/DT101.
- 6 LOCALIZED DUTCHMAN REPAIR

- 7 CLEAN FERRIC STAINING OFF CONCRETE STEPS
- 8 LOCALIZED CONCRETE PATCH REPAIR FOLLOWING DETAIL 3/DT102.
- 9 REMOVE AND RESET SANDSTONE CAPSTONES IN A FULL BED OF MORTAR. EACH CAPSTONE TO RECEIVE TWO PINS FOLLOWING DETAIL 2/DT101. ALLOW FOR THE REMOVAL AND RESETTING OF TOP COURSE OF RUNDLE MASONRY WHICH MAY BECOME LOOSE DURING CAPSTONE REMOVAL.
- 10 REMOVE CORRODED STEEL BASE OF HANDRAIL. REINSTALL FOLLOWING CONNECTION DETAIL 4/DT102

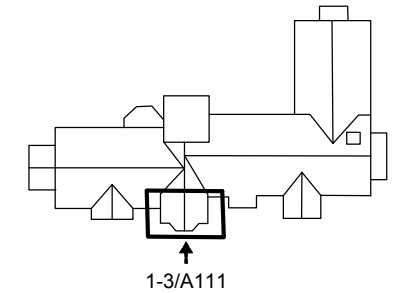

revisions	description	date
4	ISSUED FOR TENDER	19/03/20
3	ISSUED FOR REVIEW	18/08/24
2	ISSUED FOR REVIEW	18/08/03
1	ISSUED FOR REVIEW	18/07/25

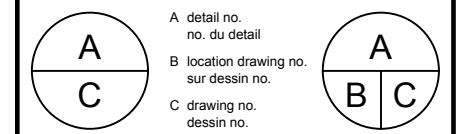

project BANFF ADMINISTRATION BUILDING

drawing SOUTH ELEVATION - 3 dessin

Designed By	CK	Conçu par
Date		(yyyy/mm/dd)
Drawn By	TK	Dessiné par
Date		(yyyy/mm/dd)
Reviewed By	JD	Examiné par
Date		(yyyy/mm/dd)
Approved By	JD	Approuvé par
Date		(yyyy/mm/dd)

Project no. / No. du projet

Drawing no. / No. du dessin

A111






1 SOUTH ELEVATION  
A112



2 SOUTH ELEVATION  
A112



3 SOUTH ELEVATION  
A112

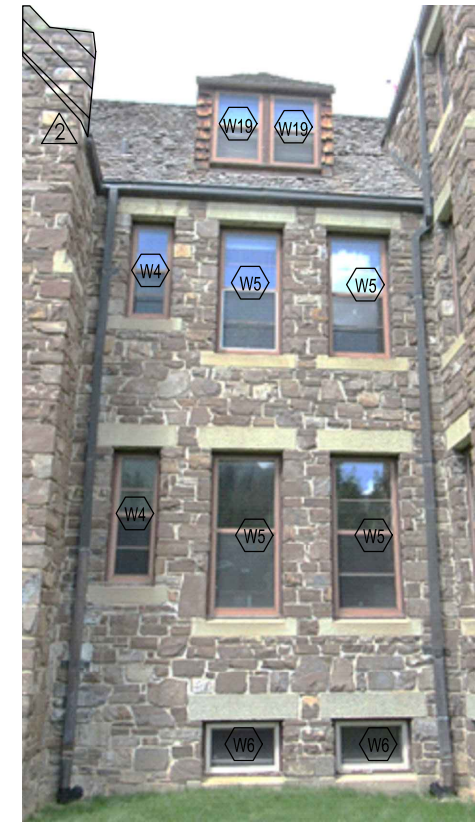


4 SOUTH ELEVATION  
A112




5 SOUTH ELEVATION  
A112

**DRAWING LEGEND**

- 1 CLEAN STAINED SANDSTONE BAND COURSES, WEATHERING BANDS, CAPSTONES AND CRENELS. REMOVE ALL BIOLOGICAL GROWTH.
- 2 100% RAKE OUT AND REPOINT MASONRY JOINTS. SEE DETAILS 4/DT101 AND 5/DT101. 100% RAKE OUT AND REPOINT ALL EXPOSED SIDES (I.E. FRONT AND BACK) OF ALL MASONRY LOW WALLS AND PARAPETS. NOTE FLAT ROOF PARAPETS HAVE A BRICK BACKUP - ONLY RAKE OUT AND REPOINT RUNDLE MASONRY.
- 3 CLEAN EFFLORESCENCE OFF FACE OF RUNDLE MASONRY. 100% RAKE OUT AND REPOINT MASONRY JOINTS. SEE DETAILS 4/DT101 AND 5/DT101.
- 4 REMOVE AND RESET RUNDLE MASONRY ABOVE GRADE IN WINDOW WELL. 100% RAKE OUT AND REPOINT EXPOSED MASONRY WITHIN WINDOW WELL.
- 5 100% RAKE OUT AND REPOINT RUNDLE MASONRY. SEE DETAILS 4/DT101 AND 5/DT101. INSTALL HELICAL TILES IN HORIZONTAL JOINTS FOLLOWING DETAILS 1/DT101 WITH GENERAL SPACING OF TIES FOLLOWING DETAIL 6/DT101.
- 6 LOCALIZED DUTCHMAN REPAIR
- 7 CLEAN FERRIC STAINING OFF CONCRETE STEPS
- 8 LOCALIZED CONCRETE PATCH REPAIR FOLLOWING DETAIL 3/DT102.
- 9 REMOVE AND RESET SANDSTONE CAPSTONES IN A FULL BED OF MORTAR. EACH CAPSTONE TO RECEIVE TWO PINS FOLLOWING DETAIL 2/DT101. ALLOW FOR THE REMOVAL AND RESETTING OF TOP COURSE OF RUNDLE MASONRY WHICH MAY BECOME LOOSE DURING CAPSTONE REMOVAL.
- 10 REMOVE CORRODED STEEL BASE OF HANDRAIL. REINSTALL FOLLOWING CONNECTION DETAIL 4/DT102

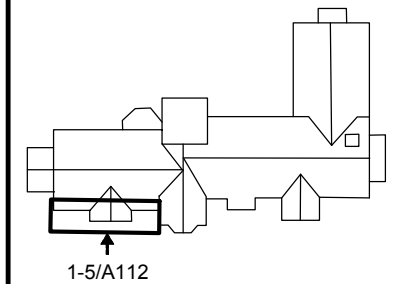

revisions	description	date
4	ISSUED FOR TENDER	19/03/20
3	ISSUED FOR REVIEW	18/08/24
2	ISSUED FOR REVIEW	18/08/03
1	ISSUED FOR REVIEW	18/07/25

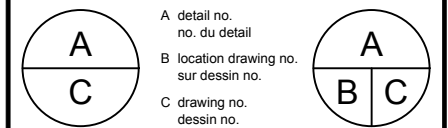

project project

**BANFF ADMINISTRATION BUILDING**

drawing SOUTH ELEVATION - 4 dessin


Designed By	CK	Conçu par
Date		(yyyy/mm/dd)
Drawn By	TK	Dessiné par
Date		(yyyy/mm/dd)
Reviewed By	JD	Examiné par
Date		(yyyy/mm/dd)
Approved By	JD	Approuvé par
Date		(yyyy/mm/dd)

Project no. No. du projet

Drawing no. No. du dessin

**A112**




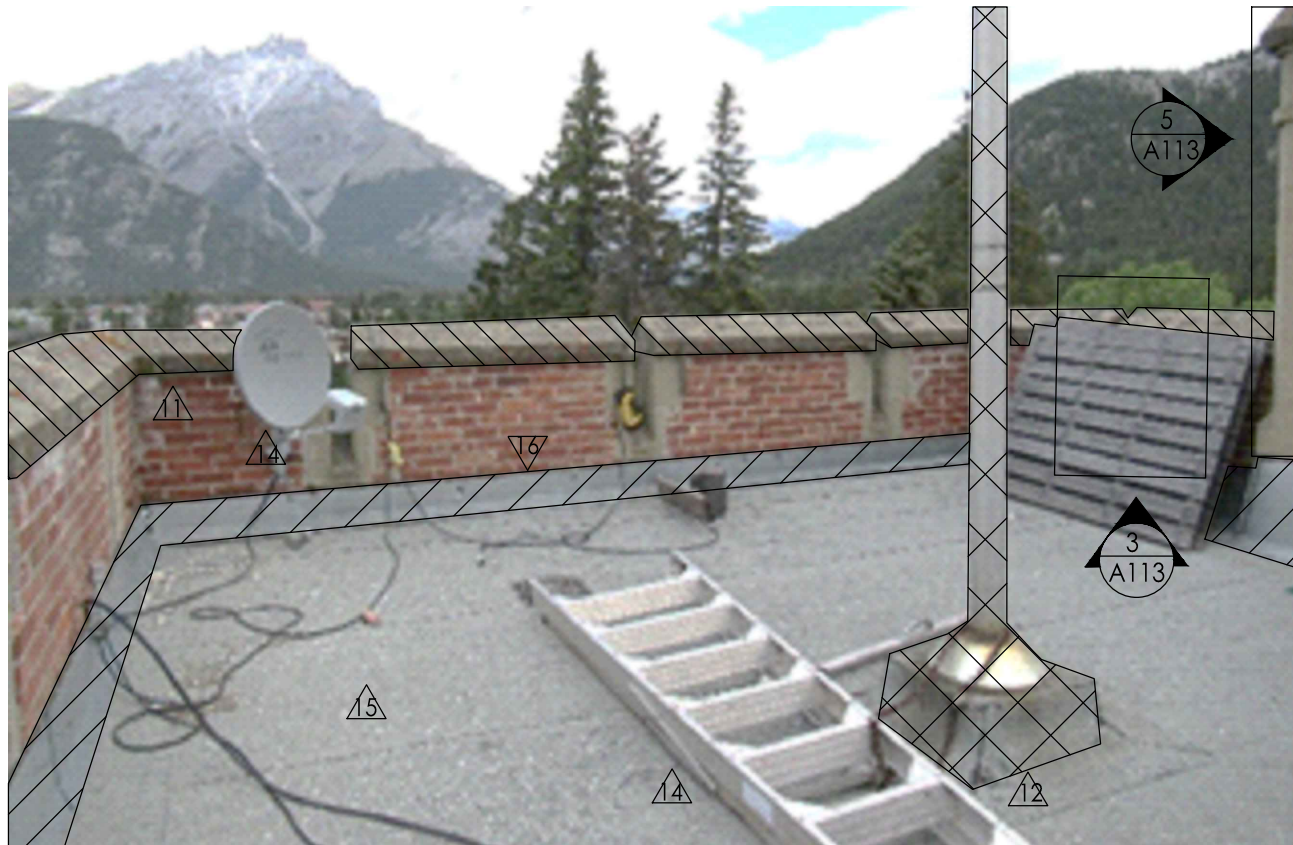

1 TOWER ROOF - LOOKING SOUTH  
A113



2 TOWER ROOF - LOOKING NORTH  
A113

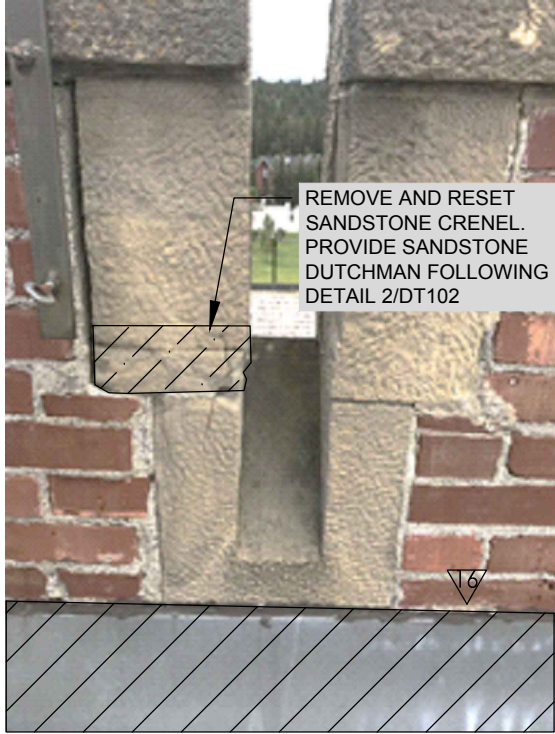







## DRAWING LEGEND

- △1 CLEAN STAINED SANDSTONE BAND COURSES, WEATHERING BANDS, CAPSTONES AND CRENELS. REMOVE ALL BIOLOGICAL GROWTH.
- △15 COMPLETE FLAT ROOF REPLACEMENT. REMOVE EXISTING ROOF MEMBRANE AND RE-SLOPE TO ENSURE POSITIVE DRAINAGE TOWARDS ROOF DRAINS. SEE DETAIL 3/DT105 AND TYPICAL FLAT ROOFING DETAILS ON DRAWING DT106. INSTALL NEW FLAT ROOF MBM.
- △17 EXISTING STAIR NOTCHED INTO EXISTING WINDOW SILL WITH NO MECHANICAL ATTACHMENTS. REMOVE AND PROVIDE NEW METAL STAIR, ELEVATED OFF THE CEDAR SHAKE ROOF, AND SUPPORTED ON EXISTING ROOF RAFTERS. PROVIDE WOOD DUTCHMAN REPAIRS FOR NOTCHES ON WINDOW SILL.
- △18 REMOVE ALL PERIMETER BASE FLASHING AND REPLACE IN KIND WITH NEW. SEE DETAIL 1/DT106. ALLOW FOR 100% BRICK MASONRY REPOINTING BENEATH FLASHING.
- △19 REMOVE FLASHING AND REPLACE IN KIND WITH NEW STEPPED FLASHING. SEE DETAIL 1/DT104.
- △20 REMOVE EXISTING SCUPPER AND INSTALL NEW CLAMP-TITE 3-INCH BOX CLAMP COPPER SCUPPER.
- △21 COMPLETE ROOF REPLACEMENT. REMOVE AND INSTALL NEW CEDAR SHAKES ON SLOPED ROOFS AND SIDES OF DORMERS. SEE TYPICAL SLOPED ROOFING DETAILS ON DRAWING DT103 AND DT104, AND TYPICAL FLAT ROOF DETAILS ON DRAWING DT106.

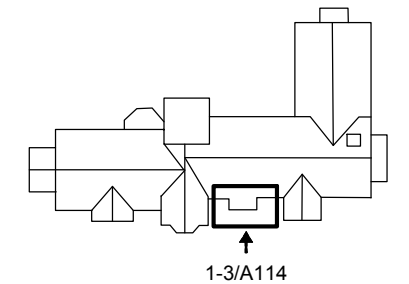

revisions	description	date
4	ISSUED FOR TENDER	19/03/20
3	ISSUED FOR REVIEW	18/08/24
2	ISSUED FOR REVIEW	18/08/03
1	ISSUED FOR REVIEW	18/07/25

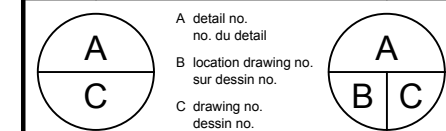

1 PLAN - FLAT ROOF ON NORTH ELEVATION  
A114



2 FLAT ROOF ON NORTH ELEVATION  
A114



3 SCUPPER COVER  
A114




4 BASE OF DORMER  
A114

project	projet	
<b>BANFF ADMINISTRATION BUILDING</b>		
drawing	dessin	
<b>SOUTH ELEVATION FLAT ROOF</b>		
Designed By	CK	Conçu par
Date		(yyyy/mm/dd)
Drawn By	TK	Dessiné par
Date		(yyyy/mm/dd)
Reviewed By	JD	Examiné par
Date		(yyyy/mm/dd)
Approved By	JD	Approuvé par
Date		(yyyy/mm/dd)
Project no.	No. du projet	
Drawing no.	No. du dessin	
<b>A114</b>		







1 CEDAR ROOFING - LOOWING SOUTH WEST  
A115

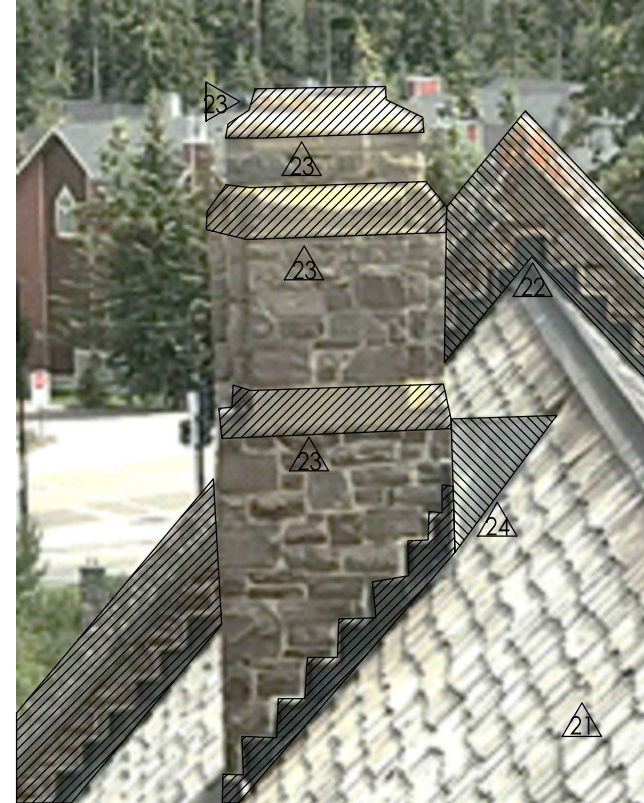

2 CHIMNEY  
A115

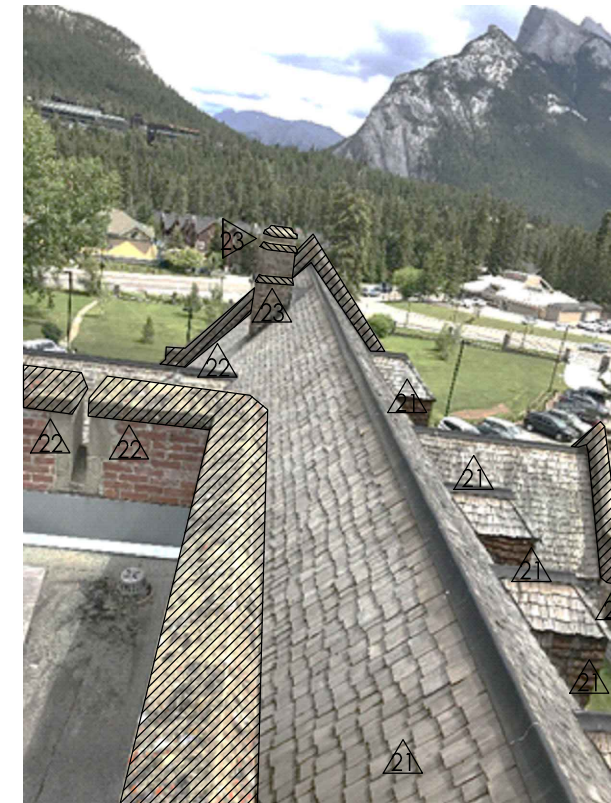


3 ROOFING - LOOKING WEST  
A115

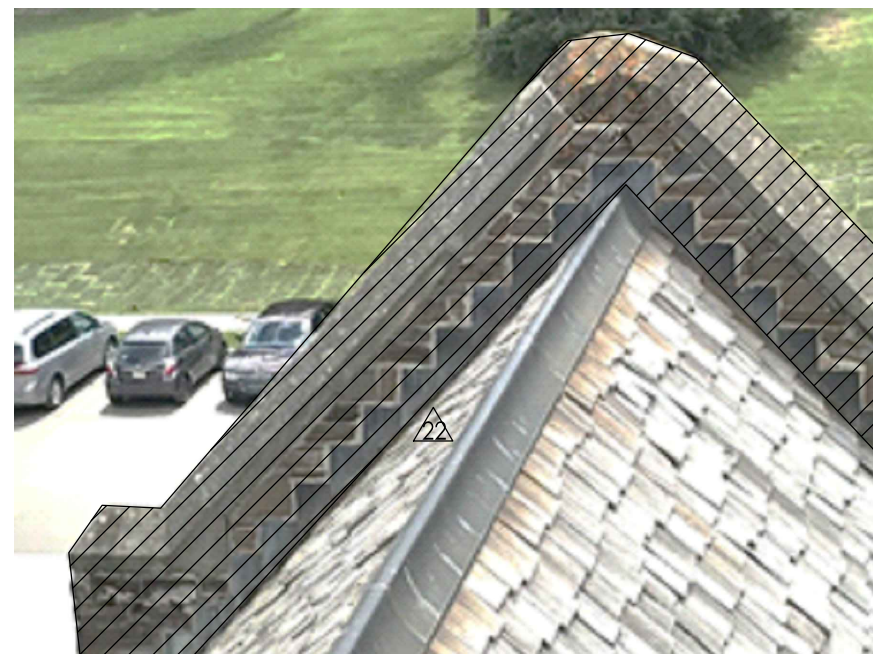

4 TYPICAL PARAPET  
A115

### DRAWING LEGEND

- 21 COMPLETE ROOF REPLACEMENT. REMOVE AND INSTALL NEW COPPER ROOFING AND CEDAR SHAKES ON ALL DORMERS AND NEW CEDAR SHAKES ON SLOPED ROOFS - TO MATCH EXISTING. SEE TYPICAL SLOPED ROOFING DETAILS ON DRAWING DT103 AND DT104.
- 22 CLEAN STAINED SANDSTONE CAPSTONES. 100% RAKE OUT AND REPOINT ALL SANDSTONE CAPSTONE AND RUNDLE MASONRY ON FRONT AND BACK OF PARAPETS FOLLOWING DETAIL 4/DT101 AND 5/DT101. REMOVE AND REPLACE STEPPED FLASHING FOLLOWING DETAIL 1/DT104. ALLOW FOR 100% RAKE OUT AND REPOINTING OF BRICK MASONRY BENEATH STEPPED FLASHING. TYPICAL FOR ALL PARAPETS ON BUILDING.
- 23 CLEAN STAINED SANDSTONE MASONRY. TYPICAL FOR ALL 4 SIDES ON CHIMNEY.
- 24 REPLACE IN-KIND EXISTING COPPER CRICKET, FOLLOWING DETAIL 3/DT104.
- 25 REMOVE ALL EAVES TROUGHS AND DOWNSPOUTS ON BUILDING TO FACILITATE MASONRY AND ROOFING WORK. REINSTATE FOLLOWING COMPLETION OF WORK. REPAIR HOLES IN ALL EAVES TROUGH AND ADJUST SLOPE TO PROVIDE POSITIVE DRAINAGE TO DOWNSPOUT LOCATIONS.

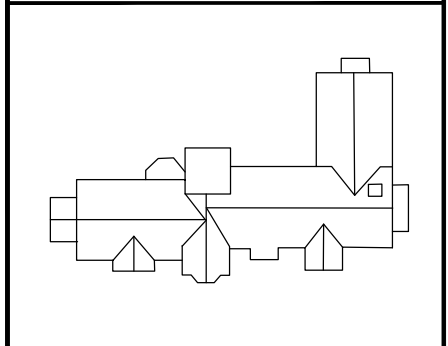

revisions	description	date
4	ISSUED FOR TENDER	19/03/20
3	ISSUED FOR REVIEW	18/08/24
2	ISSUED FOR REVIEW	18/08/03
1	ISSUED FOR REVIEW	18/07/25

A C	A detail no. no. du détail B location drawing no. sur dessin no. C drawing no. dessin no.	A B C
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project / projet

## BANFF ADMINISTRATION BUILDING


drawing / dessin  
 SLOPED ROOFS, DORMERS, AND CHIMNEYS

Designed By	CK	Conçu par
Date		(yyyy/mm/dd)
Drawn By	TK	Dessiné par
Date		(yyyy/mm/dd)
Reviewed By	JD	Examiné par
Date		(yyyy/mm/dd)
Approved By	JD	Approuvé par
Date		(yyyy/mm/dd)

Project no. / No. du projet

Drawing no. / No. du dessin  
**A115**



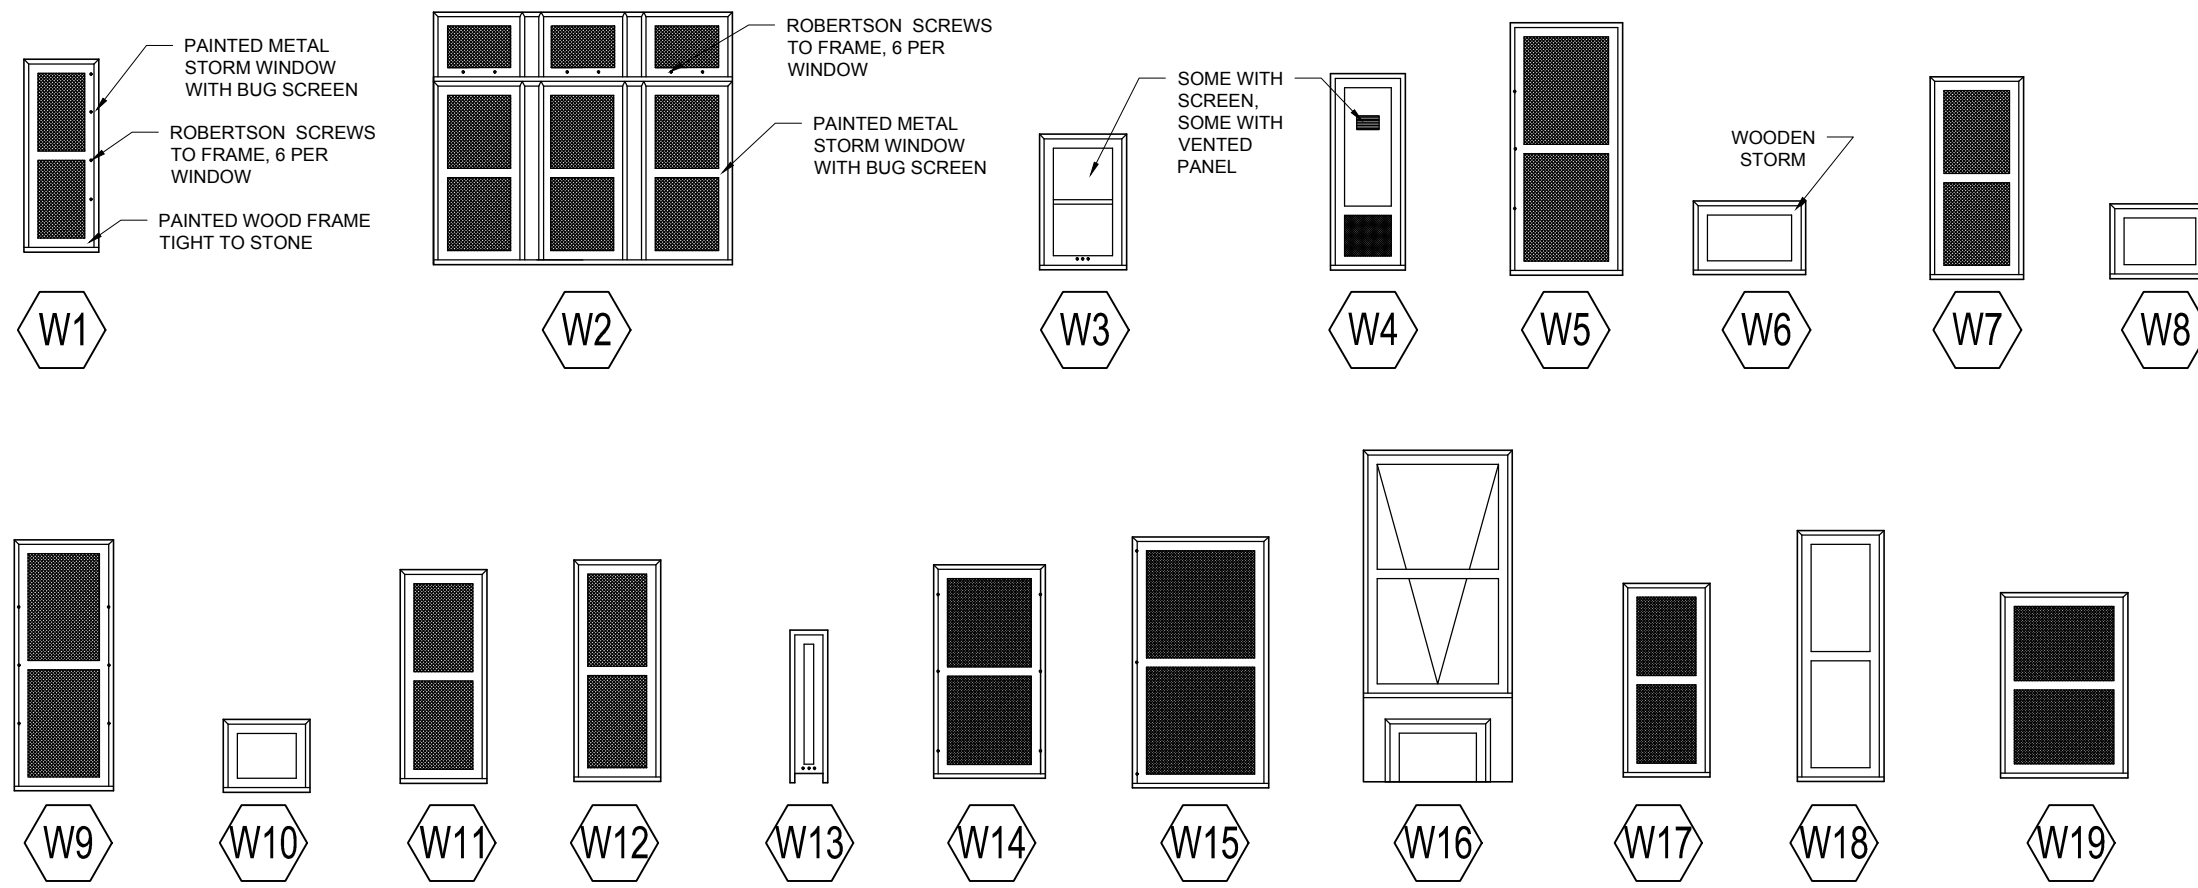

WINDOW SCHEDULE					
WINDOW #	QNTITY.	MATERIAL		FRAME	
		WINDOW	FRAME	WIDTH	HEIGHT
W1	2	IGU	WD	610	1570
W2	6	IGU	WD	2440	2060
W3	2	IGU	WD	710	1105
W4	3	IGU	WD	610	1600
W5	61	IGU	WD	915	2060
W6	28	IGU	WD	600	915
W7	2	IGU	WD	760	1650
W8	2	IGU	WD	810	610
W9	4	IGU	WD	810	2060
W10	3	IGU	WD	710	600

ACRONYMS:  
 IGU INSULATED GLASS UNITS  
 WD WOOD

WINDOW SCHEDULE					
WINDOW #	QNTITY.	MATERIAL		FRAME	
		WINDOW	FRAME	WIDTH	HEIGHT
W11	13	IGU	WD	710	1750
W12	4	IGU	WD	710	1815
W13	2	IGU	WD	310	1250
W14	2	IGU	WD	915	1750
W15	2	IGU	WD	1115	2060
W16	1	IGU	WD	1220	2720
W17	2	IGU	WD	710	1590
W18	2	IGU	WD	710	2060
W19	14	IGU	WD	1040	1520
W19A	2	IGU	WD	1730	1520

ACRONYMS:  
 IGU INSULATED GLASS UNITS  
 WD WOOD

**GENERAL WINDOW NOTES:**

1. ALL DIMENSIONS ARE TO BE CONFIRMED ON-SITE. NOTIFY DEPARTMENTAL REPRESENTATIVE OF ANY DISCREPANCIES.
2. CAREFULLY REMOVE ALL EXISTING FLY SCREENS.
3. SCRAPE OFF ALL EXISTING PAINT AND SAND OUTER FRAME OF ALL WINDOWS..
4. PROVIDE EPOXY REPAIRS AS REQUIRED.
5. PROVIDE LINSEED OIL FINAL PAINT COLOR SAMPLES FOR DEPARTMENTAL REPRESENTATIVE APPROVAL.
6. UPON APPROVAL OF FINAL PAINT COLOR, PROCEED TO PAINT EXTERIOR FRAMES.
7. PROTECT PAINTED COMPONENTS UNTIL DRY.
8. REINSTALL AND PAINT FLY SCREENS.

revisions	description	date
4	ISSUED FOR TENDER	19/03/20
3	ISSUED FOR REVIEW	18/08/24
2	ISSUED FOR REVIEW	18/08/03
1	ISSUED FOR REVIEW	18/07/25

A detail no. / no. du detail  
 B location drawing no. / sur dessin no.  
 C drawing no. / dessin no.

project / projet  
**BANFF ADMINISTRATION BUILDING**


drawing WINDOW SCHEDULE - 1 / dessin

Designed By / Conçu par	CK
Date / (yyyy/mm/dd)	
Drawn By / Dessiné par	TK
Date / (yyyy/mm/dd)	
Reviewed By / Examiné par	JD
Date / (yyyy/mm/dd)	
Approved By / Approuvé par	JD
Date / (yyyy/mm/dd)	


Project no. / No. du projet

Drawing no. / No. du dessin




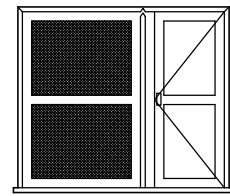


W19A

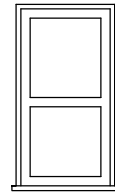


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W21

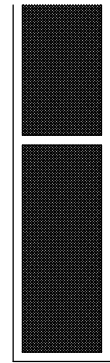

W22

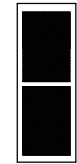

W23

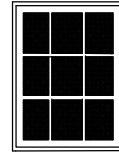


W24



W25



W26

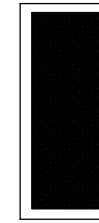

W27

WINDOW SCHEDULE					
WINDOW #	QNTITY.	MATERIAL		FRAME	
		WINDOW	FRAME	WIDTH	HEIGHT
W20	3	IGU	WD	934	1524
W21	12	IGU	WD	900	1300
W22	4	IGU	WD	730	1090
W23	13	IGU	WD	840	1280
W24	5	IGU	WD	540	1290
W25	3	IGU	WD	660	910
W26	3	IGU	WD	660	1700
W27	5	IGU	WD	760	1760

ACRONYMS:  
 IGU INSULATED GLASS UNITS  
 WD WOOD

**GENERAL WINDOW NOTES:**

1. ALL DIMENSIONS ARE TO BE CONFIRMED ON-SITE. NOTIFY DEPARTMENTAL REPRESENTATIVE OF ANY DISCREPANCIES.
2. CAREFULLY REMOVE ALL EXISTING FLY SCREENS.
3. SCRAPE OFF ALL EXISTING PAINT AND SAND OUTER FRAME OF ALL WINDOWS..
4. PROVIDE EPOXY REPAIRS AS REQUIRED.
5. PROVIDE LINSEED OIL FINAL PAINT COLOR SAMPLES FOR DEPARTMENTAL REPRESENTATIVE APPROVAL.
6. UPON APPROVAL OF FINAL PAINT COLOR, PROCEED TO PAINT EXTERIOR FRAMES.
7. PROTECT PAINTED COMPONENTS UNTIL DRY.
8. REINSTALL AND PAINT FLY SCREENS.

revisions		
4	ISSUED FOR TENDER	19/03/20
3	ISSUED FOR REVIEW	18/08/24
2	ISSUED FOR REVIEW	18/08/03
1	ISSUED FOR REVIEW	18/07/25

project	description	date

A C	A detail no. du detail B location drawing no. sur dessin no. C drawing no. dessin no.	A B C
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project	projet
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**BANFF ADMINISTRATION BUILDING**

drawing	WINDOW SCHEDULE - 2	dessin
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Designed By	CK	Conçu par
Date		(yyyy/mm/dd)

Drawn By	TK	Dessiné par
Date		(yyyy/mm/dd)

Reviewed By	JD	Examiné par
Date		(yyyy/mm/dd)







Approved By	JD	Approuvé par
Date		(yyyy/mm/dd)

Project no.	No. du projet
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Drawing no.	No. du dessin
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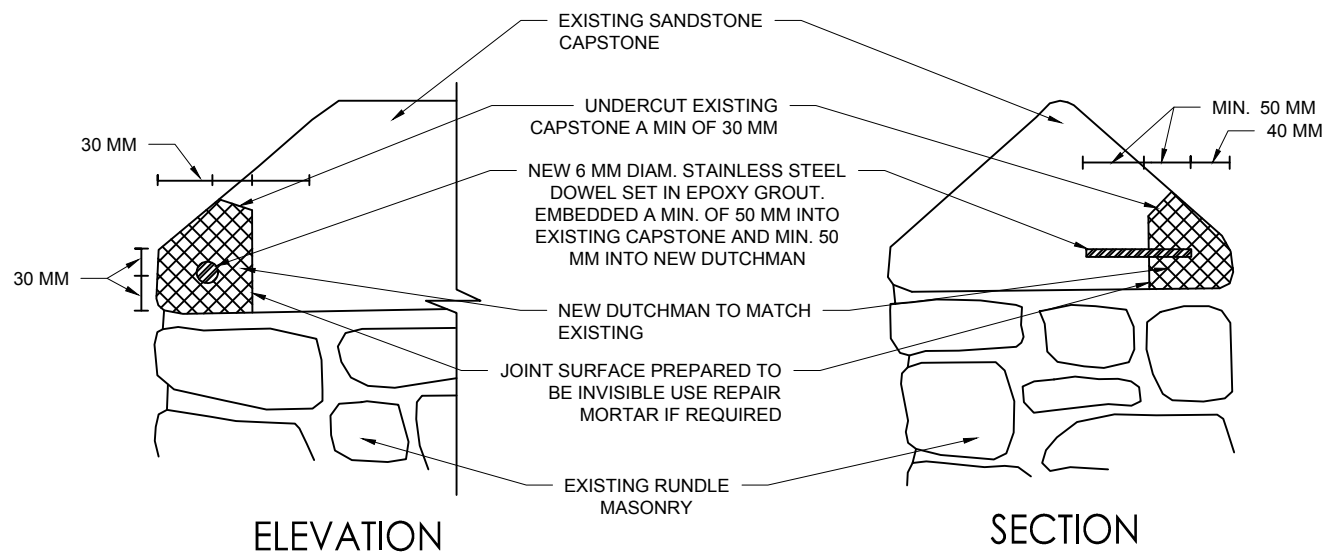
A117





Parks Canada / Parc Canada																
Asset & Environmental Management Architectural & Engineering Services	Gestion des biens et de l'environnement Services d'architecture et d'ingénierie															
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4	ISSUED FOR TENDER	19/03/20														
3	ISSUED FOR REVIEW	18/08/24														
2	ISSUED FOR REVIEW	18/08/03														
1	ISSUED FOR REVIEW	18/07/25														
revisions	description	date														
<table border="1"> <tr> <td>A</td> <td>A</td> </tr> <tr> <td>C</td> <td>B C</td> </tr> </table>		A	A	C	B C											
A	A															
C	B C															
project BANFF ADMINISTRATION BUILDING project																
drawing MASONRY DETAILS dessin																
Designed By CK Conçu par	Date (yyyy/mm/dd)															
Drawn By TK Dessiné par	Date (yyyy/mm/dd)															
Reviewed By JD Examiné par	Date (yyyy/mm/dd)															
Approved By JD Approuvé par	Date (yyyy/mm/dd)															
Project no.	No. du projet															
Drawing no.	No. du dessin															

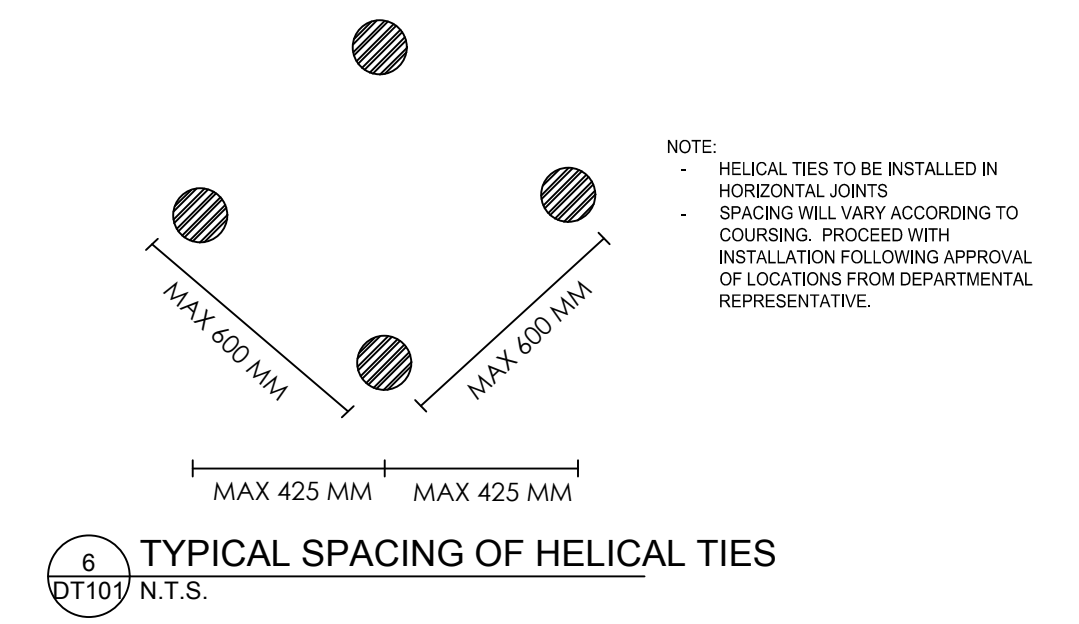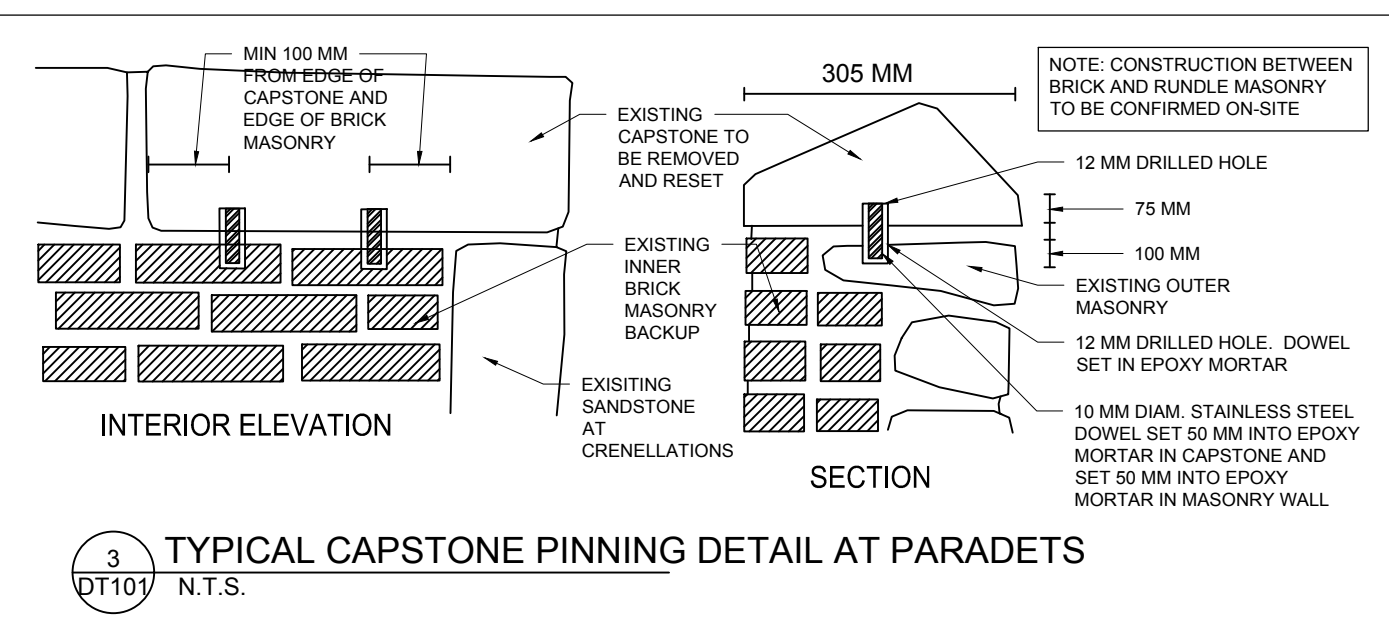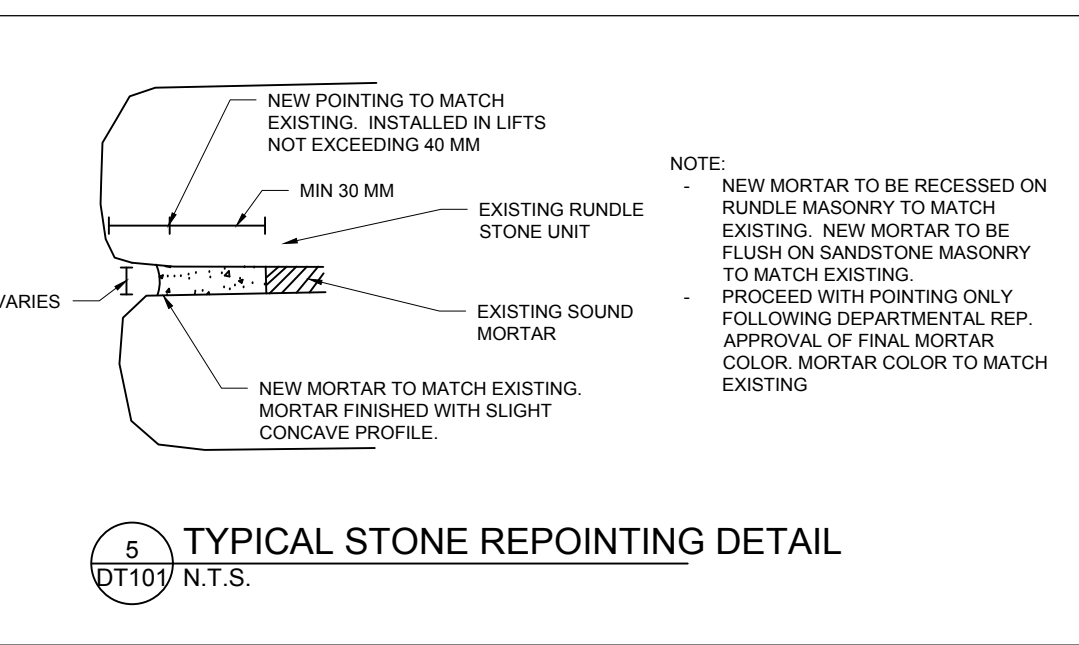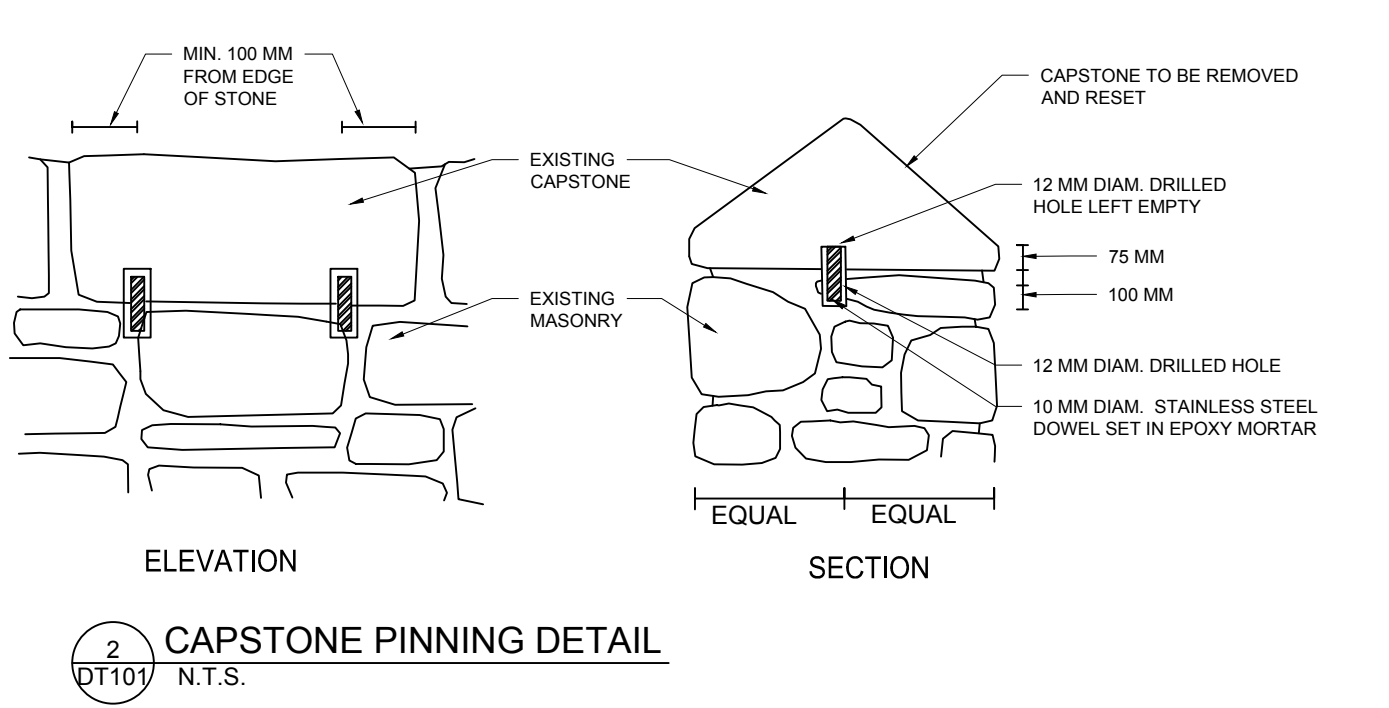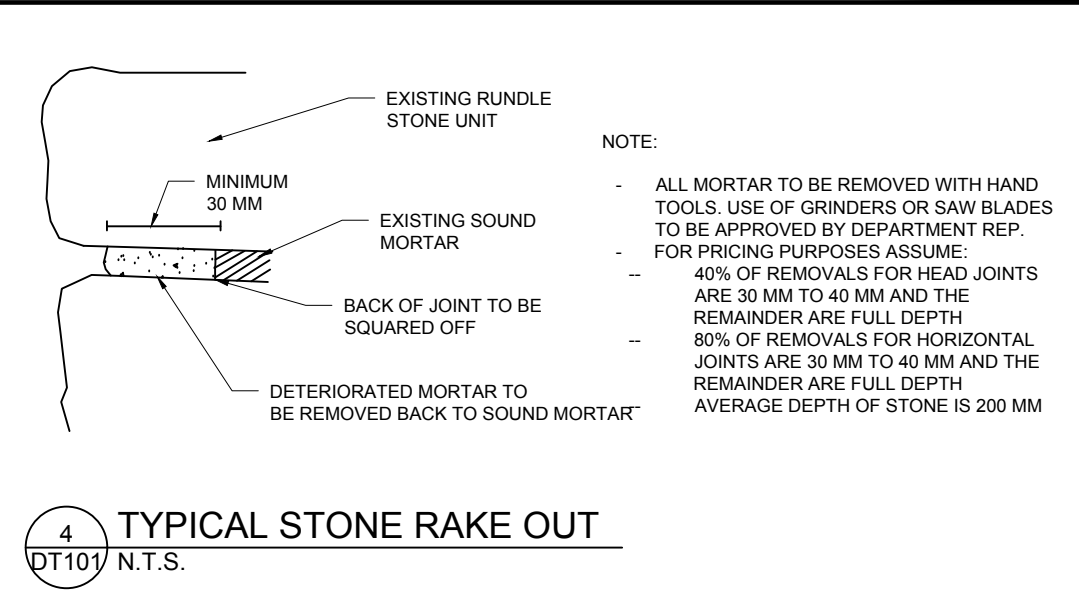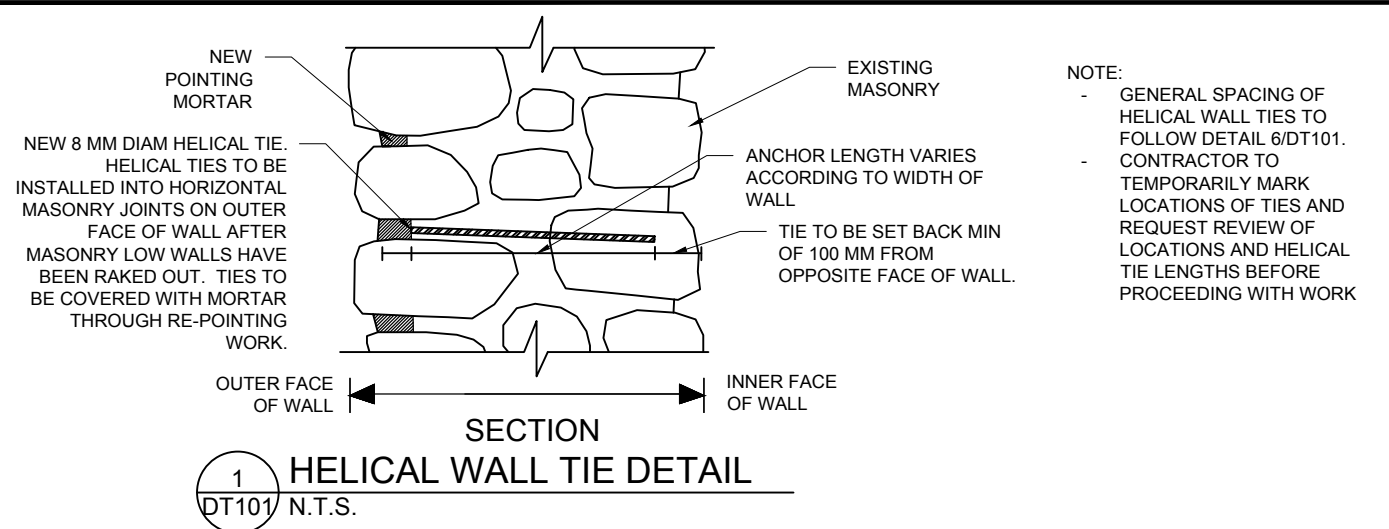




ELEVATION

SECTION

NOTE: DUTCHMAN PREPARATION TO BE INSPECTED BY DEPARTMENTAL REPRESENTATIVE PRIOR TO COMPLETING REPAIR

1 DUTCHMAN DETAIL ON CAPSTONE  
 DT102 SCALE: N.T.S

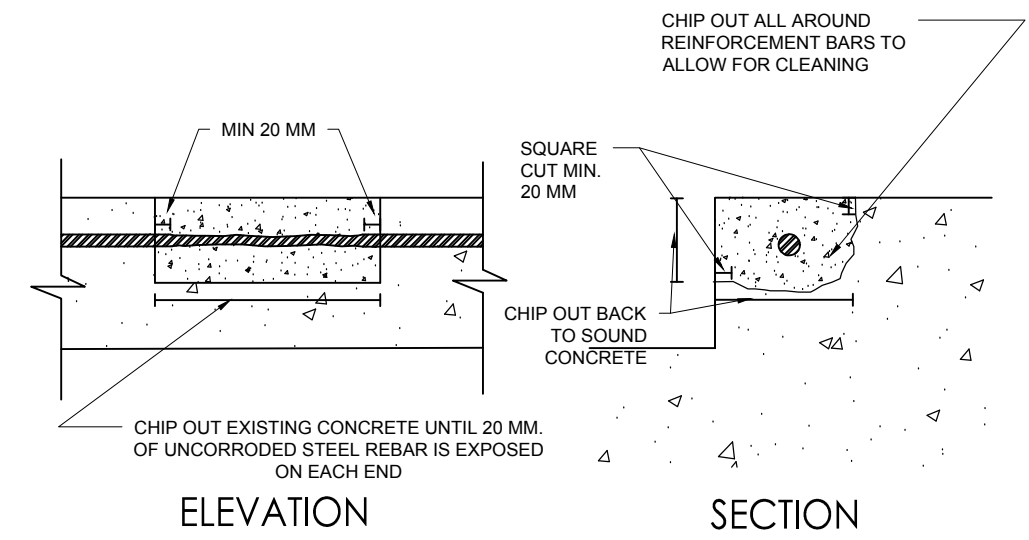


ELEVATION

SECTION

NOTE:  
 - REMOVE DETERIORATED CONCRETE WITH SQUARE CUT EDGES. LEAVE BASE SURFACE ROUGHENED TO INCREASE BOND WITH NEW CONCRETE PATCH.  
 - CLEAN REBAR WITH METAL WIRE BRUSH AND PAINT WITH COLD GALVANIZING COMPOUND. ADVISE DEPARTMENTAL REPRESENTATIVE WHEN REINFORCING BAR(S) ARE CLEAN FOR REVIEW.


3 CONCRETE PATCH REPAIR  
 DT102 SCALE: N.T.S

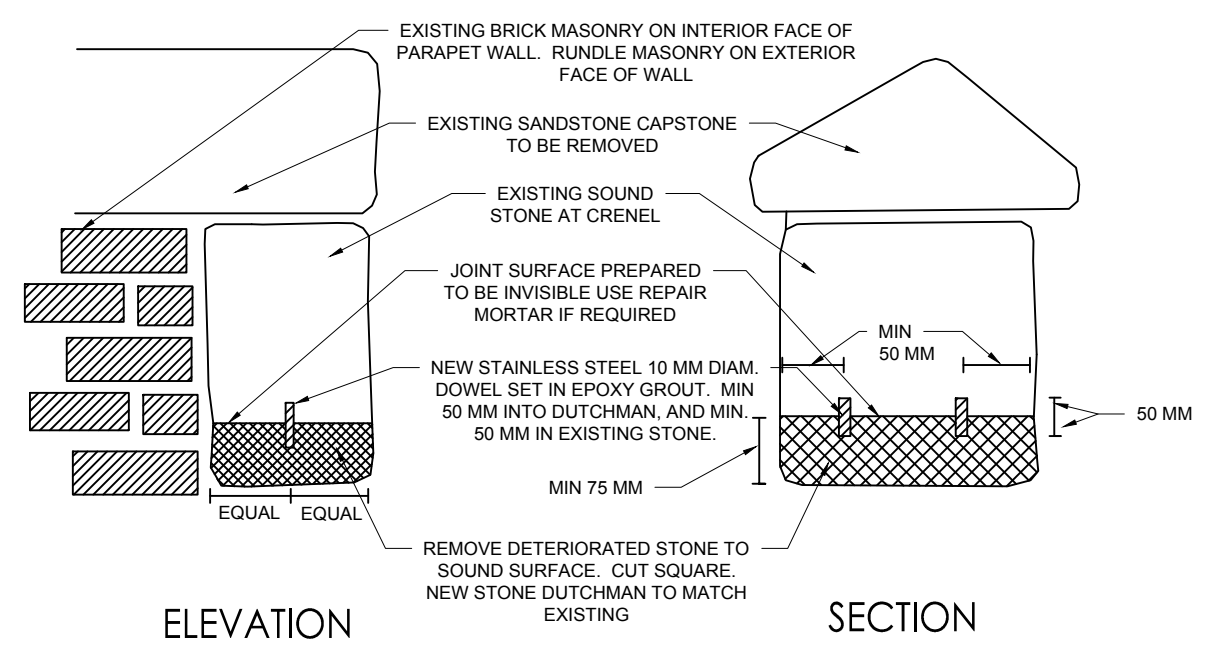

ELEVATION

SECTION

2 DUTCHMAN DETAIL ON CRENEL  
 DT102 SCALE: N.T.S

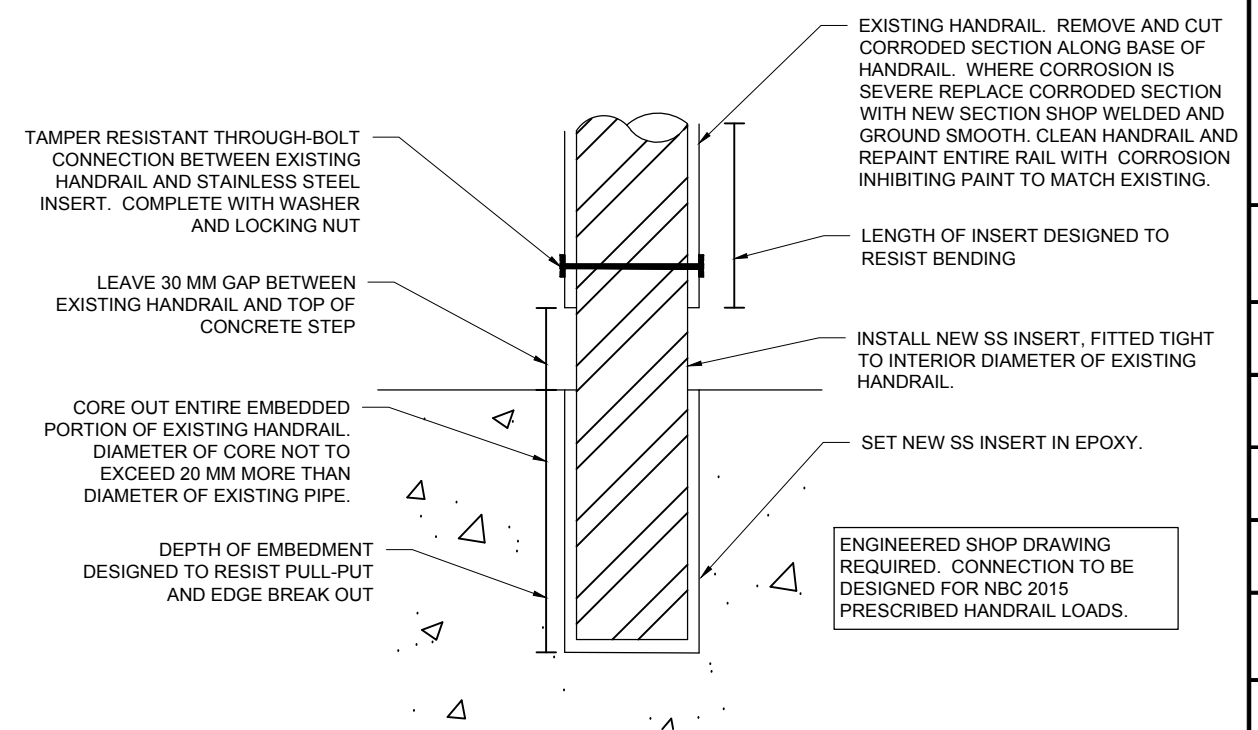

4 METAL HANDRAIL CONNECTION CONCEPT  
 DT102 SCALE: N.T.S

revisions	description	date
4	ISSUED FOR TENDER	19/03/20
3	ISSUED FOR REVIEW	18/08/24
2	ISSUED FOR REVIEW	18/08/03
1	ISSUED FOR REVIEW	18/07/25

A detail no. / no. du detail  
 B location drawing no. / sur dessin no.  
 C drawing no. / dessin no.

project / projet

BANFF ADMINISTRATION BUILDING

drawing / dessin  
 MASONRY AND CONCRETE DETAILS

Designed By	CK	Conçu par
Date		(yyyy/mm/dd)
Drawn By	TK	Dessiné par
Date		(yyyy/mm/dd)
Reviewed By	JD	Examiné par
Date		(yyyy/mm/dd)
Approved By	JD	Approuvé par
Date		(yyyy/mm/dd)

Project no. / No. du projet

Drawing no. / No. du dessin

DT102



**SHEET NOTE:**  
 COPPER FLASHING AND CEDAR SHAKE APPLICATION DETAILS ARE TYPICAL. CONTRACTOR SHALL PROVIDE SHOP DRAWINGS FOR SITE SPECIFIC CONDITIONS AT THE ADMINISTRATION BUILDING FOR REVIEW AND APPROVAL BY THE DEPARTMENTAL REPRESENTATIVE OF ALL INSTALLATION DETAILS, INCLUDING, BUT NOT LIMITED TO, THE RE-INSTALLATION OF EXISTING RIDGE CAP FLASHING AND FLASHING AT MASONRY FACED GABLES.

revisions	description	date
4	ISSUED FOR TENDER	19/03/20
3	ISSUED FOR REVIEW	18/08/24
2	ISSUED FOR REVIEW	18/08/03
1	ISSUED FOR REVIEW	18/07/25

A	A detail no. no. du detail	A
C	B location drawing no. sur dessin no.	B
	C drawing no. dessin no.	C

project \_\_\_\_\_ projet \_\_\_\_\_

## BANFF ADMINISTRATION BUILDING


drawing \_\_\_\_\_ dessin \_\_\_\_\_  
**SLOPED ROOF / CEDAR SHAKE DETAILS**

Designed By	CK	Conçu par
Date		(yyyy/mm/dd)
Drawn By	TK	Dessiné par
Date		(yyyy/mm/dd)
Reviewed By	JD	Examiné par
Date		(yyyy/mm/dd)
Approved By	JD	Approuvé par
Date		(yyyy/mm/dd)


Project no. \_\_\_\_\_ No. du projet \_\_\_\_\_

Drawing no. \_\_\_\_\_ No. du dessin \_\_\_\_\_

**DT103**

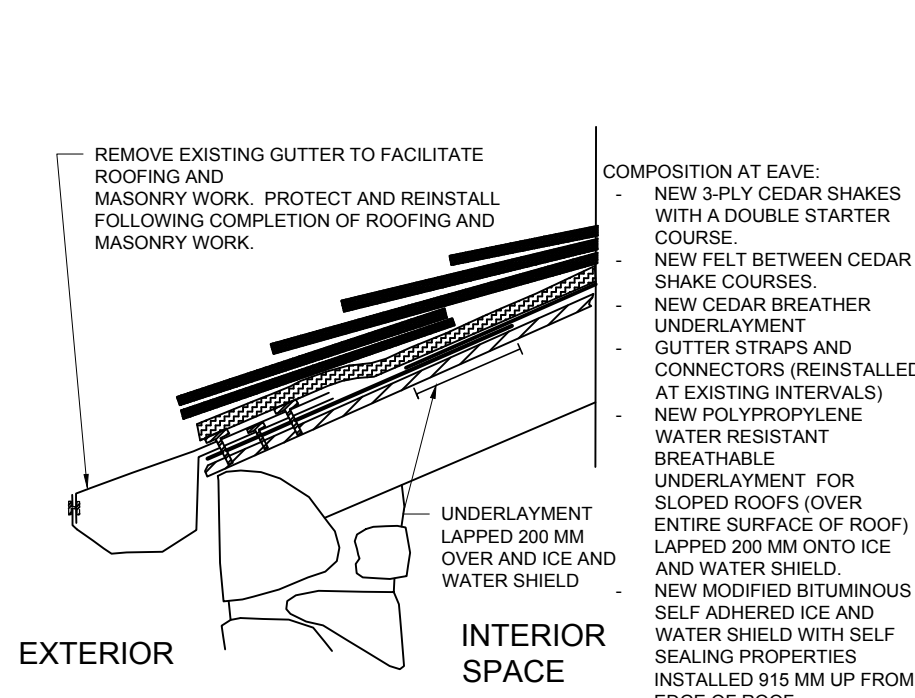


**1 TYPICAL EAVE DETAIL**  
 DT103 SCALE: N.T.S.

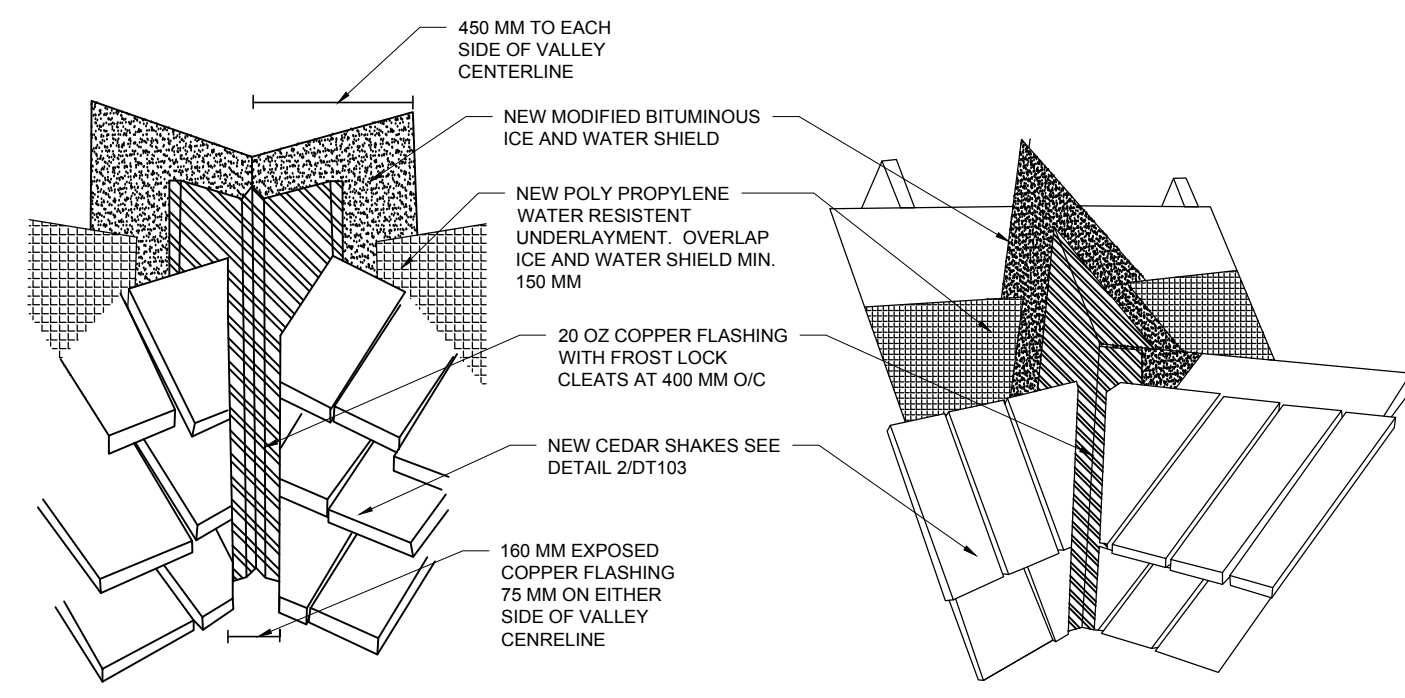


**2 TYPICAL VALLEY APPLICATION**  
 DT103 SCALE: N.T.S.

**3 TYPICAL SADDLE APPLICATION**  
 DT103 SCALE: N.T.S.

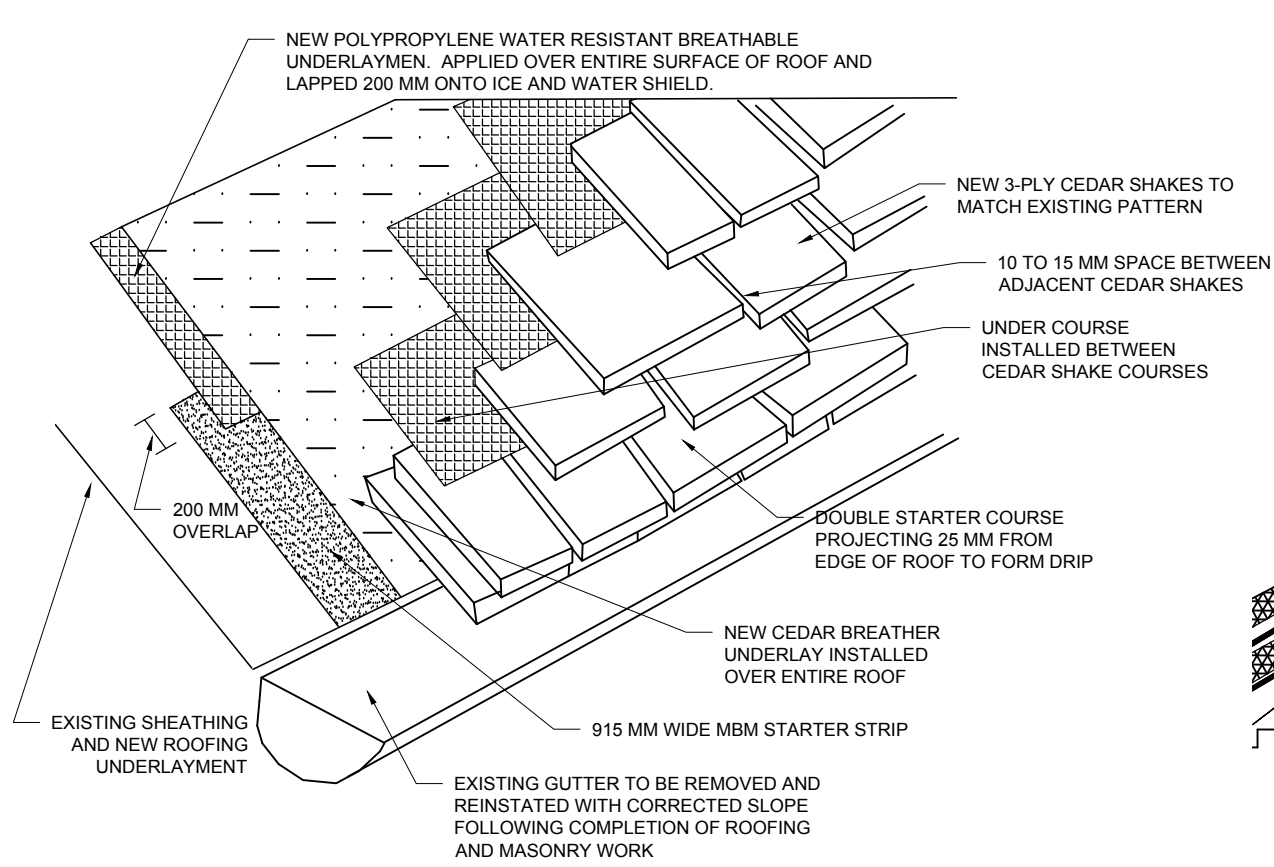

**4 GENERAL CEDAR SHAKE APPLICATION**  
 DT103 SCALE: N.T.S.

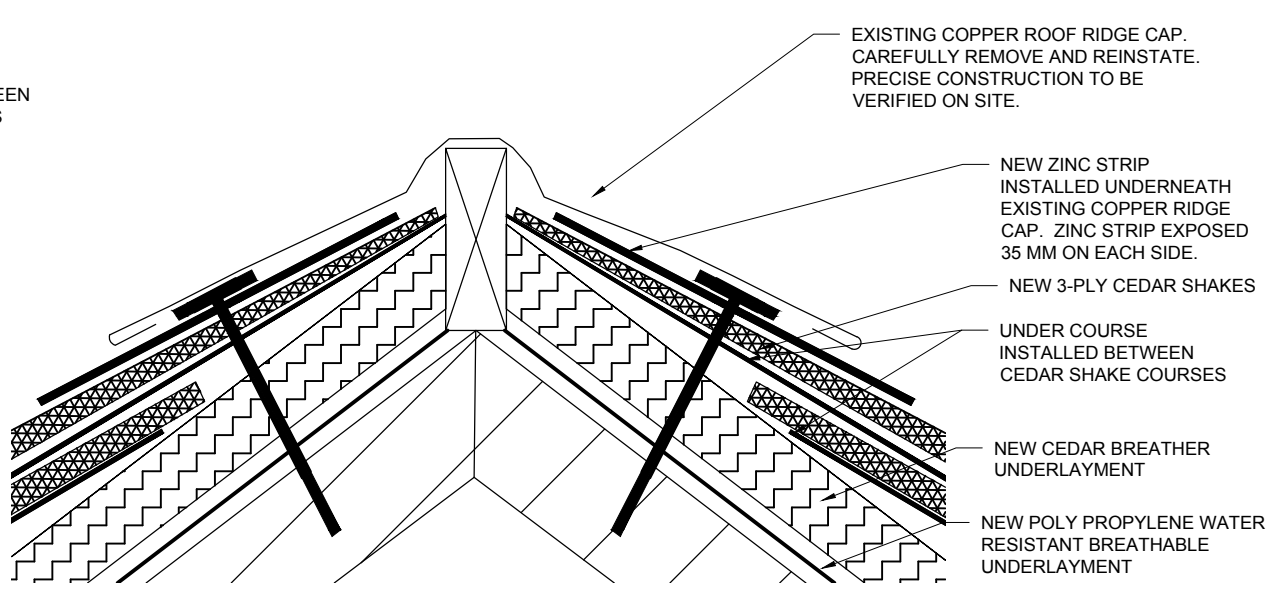

**5 TYPICAL ROOF RIDGE DETAIL**  
 DT103 SCALE: N.T.S.



**SHEET NOTE:**  
 COPPER FLASHING AND CEDAR SHAKE APPLICATION DETAILS ARE TYPICAL. CONTRACTOR SHALL PROVIDE SHOP DRAWINGS FOR SITE SPECIFIC CONDITIONS AT THE ADMINISTRATION BUILDING FOR REVIEW AND APPROVAL BY THE DEPARTMENTAL REPRESENTATIVE OF ALL INSTALLATION DETAILS, INCLUDING, BUT NOT LIMITED TO, THE RE-INSTALLATION OF EXISTING RIDGE CAP FLASHING AND FLASHING AT MASONRY FACED GABLES.

revisions	description	date
4	ISSUED FOR TENDER	19/03/20
3	ISSUED FOR REVIEW	18/08/24
2	ISSUED FOR REVIEW	18/08/03
1	ISSUED FOR REVIEW	18/07/25

A C	A detail no. du detail B location drawing no. sur dessin no. C drawing no. dessin no.	A B C
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project / projet

**BANFF ADMINISTRATION BUILDING**


drawing / dessin  
**SLOPED ROOF - FLASHING DETAILS**

Designed By	CK	Conçu par	
Date		(yyyy/mm/dd)	
Drawn By	TK	Dessiné par	
Date		(yyyy/mm/dd)	
Reviewed By	JD	Examiné par	
Date		(yyyy/mm/dd)	
Approved By	JD	Approuvé par	
Date		(yyyy/mm/dd)	

Project no. / No. du projet


Drawing no. / No. du dessin

**DT104**

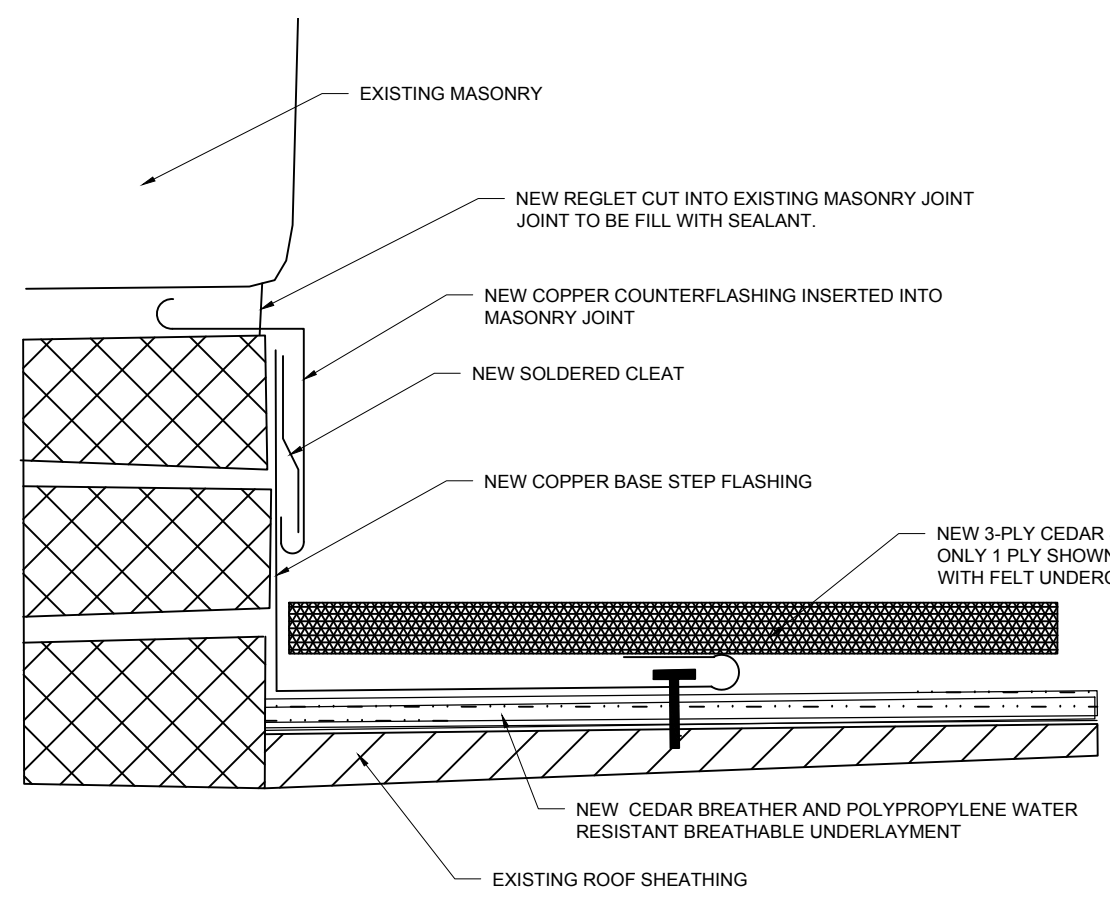


**NOTE:**  
 - STEPPED FLASHING TO BE INSTALLED FOLLOWING EXISTING FLASHING PATTERN/ JOINTING.  
 - BRICK MASONRY BENEATH EXISTING FLASHING. ALLOW FOR 100% BRICK MASONRY RAKE OUT AND REPOINTING

**1 TYPICAL STEPPED FLASHING DETAIL**  
 DT104 SCALE: N.T.S.

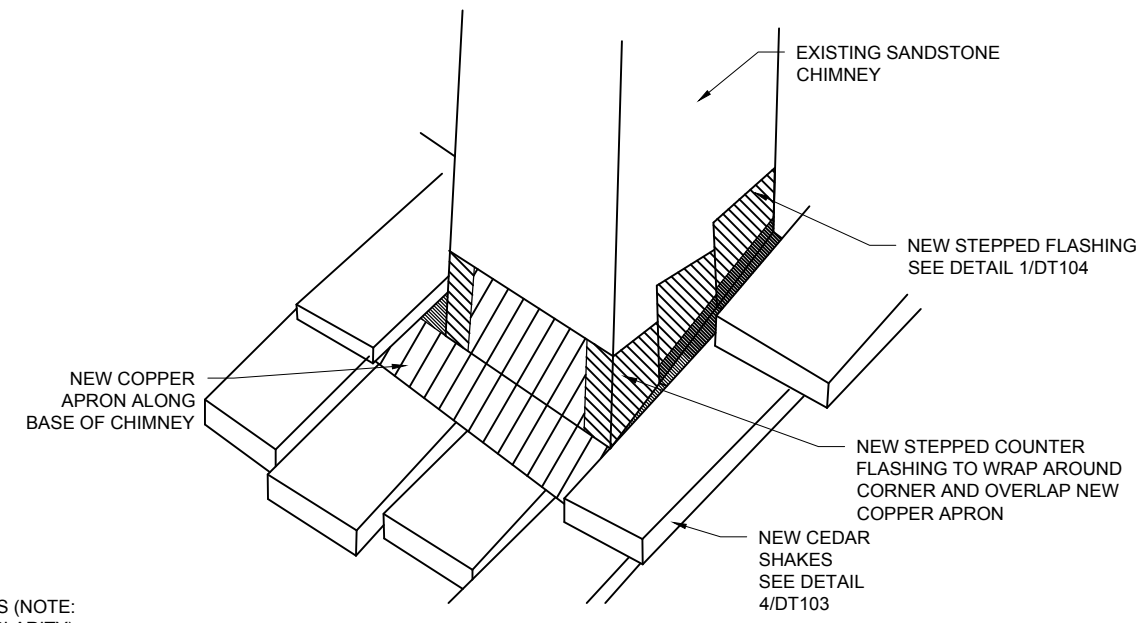


**2 CHIMNEY - FRONT APRON**  
 DT104 SCALE: N.T.S.

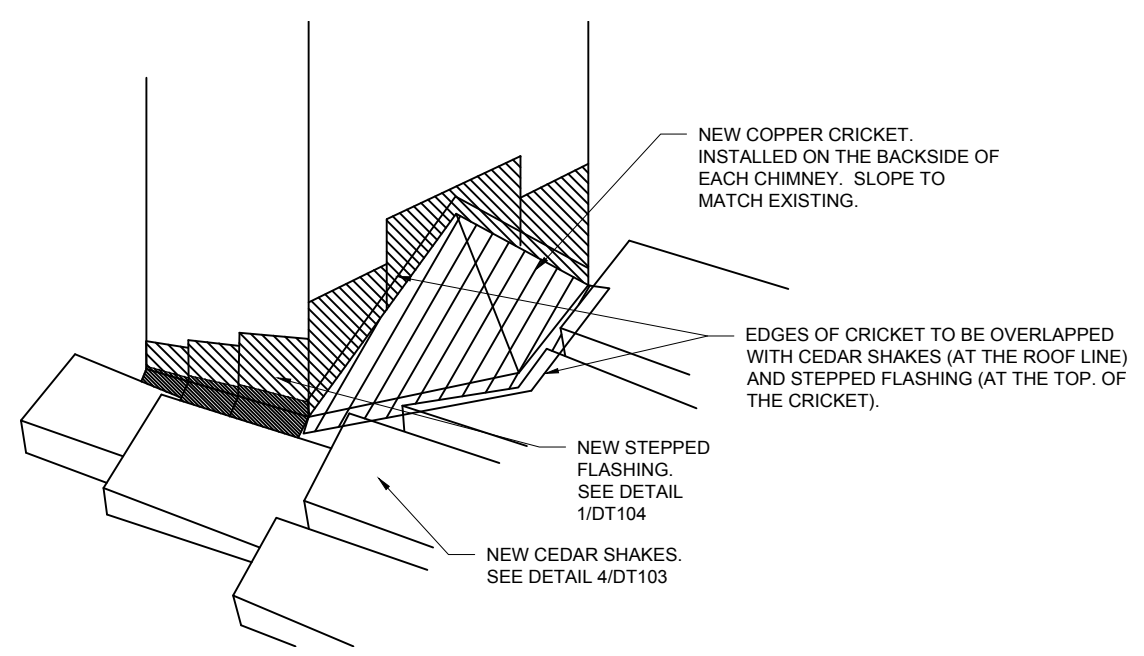


**3 CHIMNEY - BACKSIDE CRICKET**  
 DT104 SCALE: N.T.S.




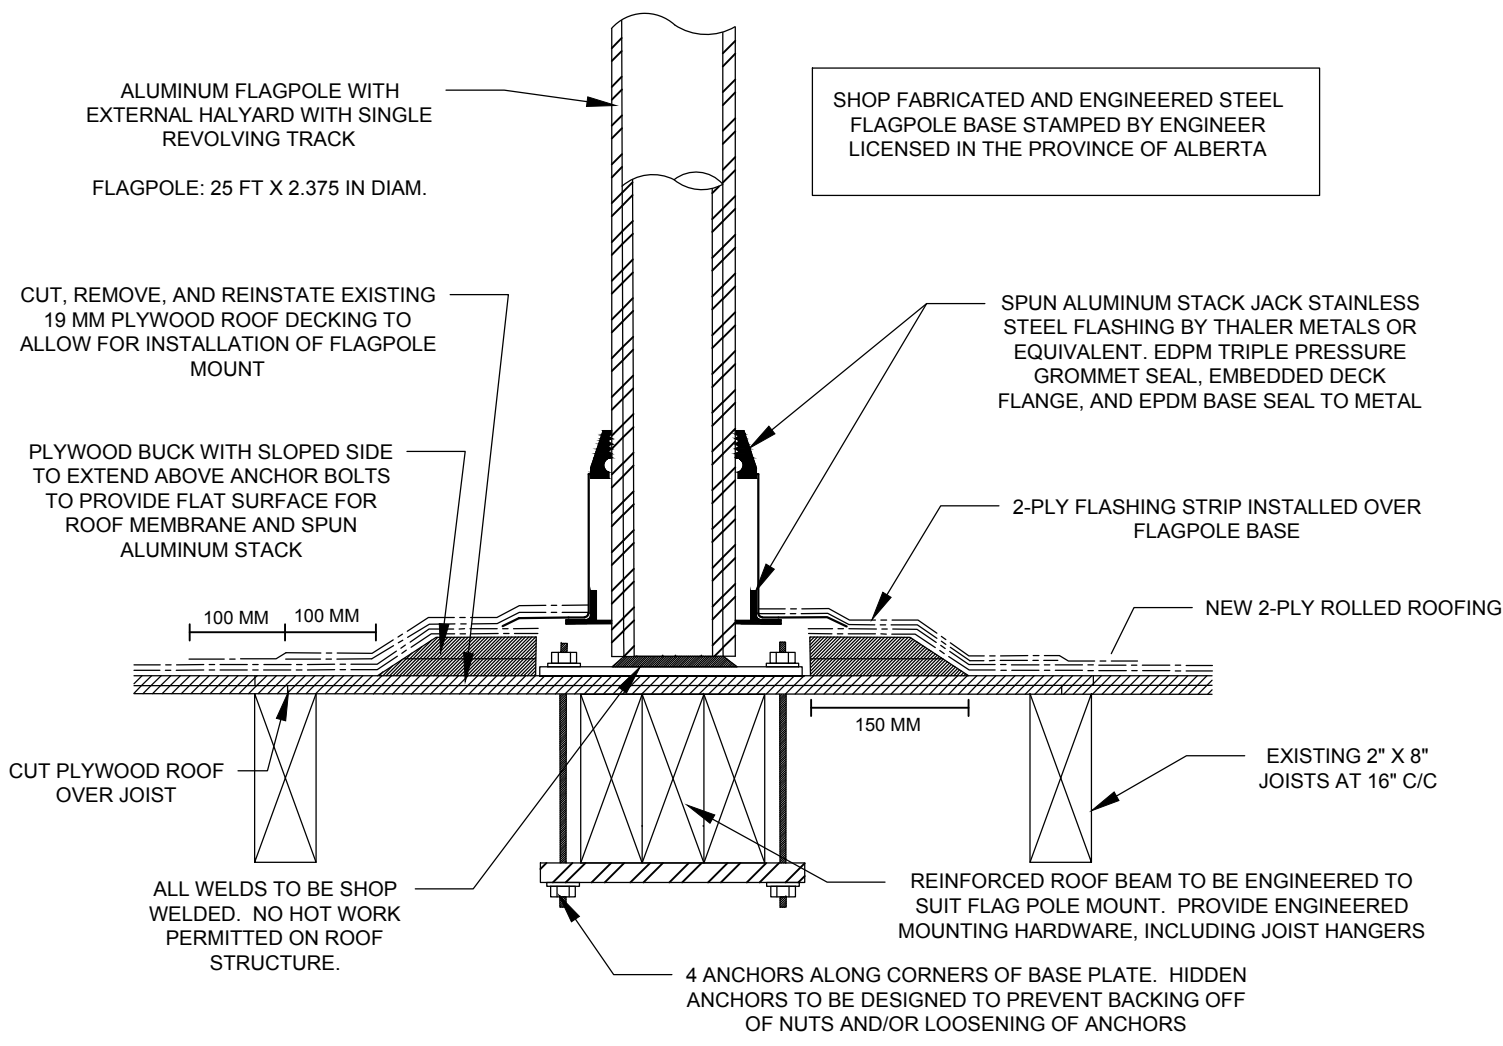

**1 FLAGPOLE INSTALLATION DETAIL**  
 DT105 SCALE: N.T.S.

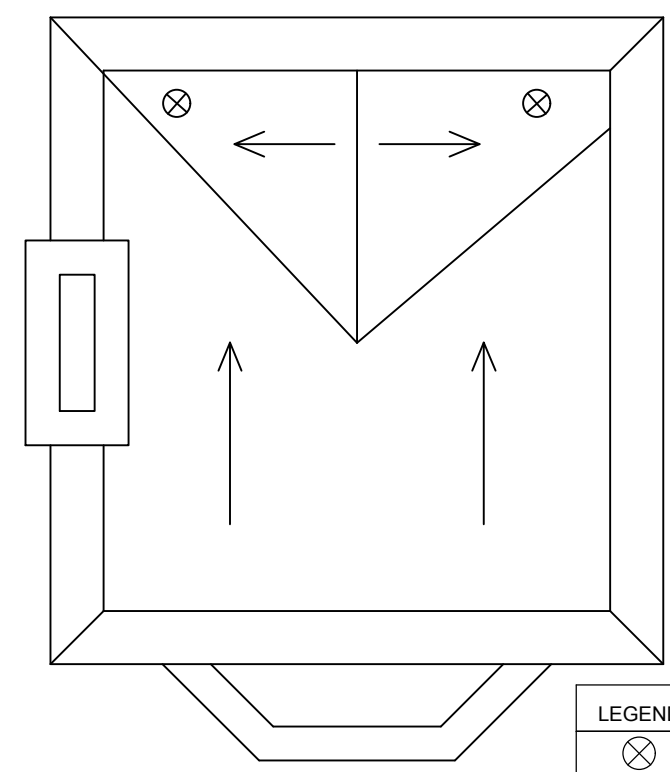

**2 SLOPING OF MAIN TOWER FLAT ROOF**  
 DT105 SCALE: N.T.S.

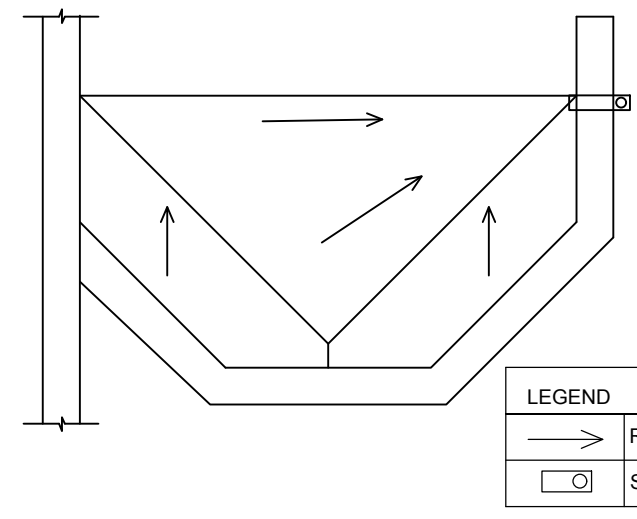

**3 SLOPING OF SOUTH FLAT ROOF**  
 DT105 SCALE: N.T.S.

revisions	description	date
4	ISSUED FOR TENDER	19/03/20
3	ISSUED FOR REVIEW	18/08/24
2	ISSUED FOR REVIEW	18/08/03
1	ISSUED FOR REVIEW	18/07/25

A C	A detail no. no. du detail B location drawing no. sur dessin no. C drawing no. dessin no.	A B C
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project \_\_\_\_\_ projet \_\_\_\_\_

**BANFF ADMINISTRATION BUILDING**


drawing  
**FLAGPOLE AND SLOPING OF FLAT ROOFS**

Designed By	CK	
Date		(yyyy/mm/dd)
Drawn By	TK	Dessiné par
Date		(yyyy/mm/dd)
Reviewed By	JD	Examiné par
Date		(yyyy/mm/dd)
Approved By	JD	Approuvé par
Date		(yyyy/mm/dd)

Project no. \_\_\_\_\_ No. du projet \_\_\_\_\_


Drawing no. **DT105** No. du dessin \_\_\_\_\_



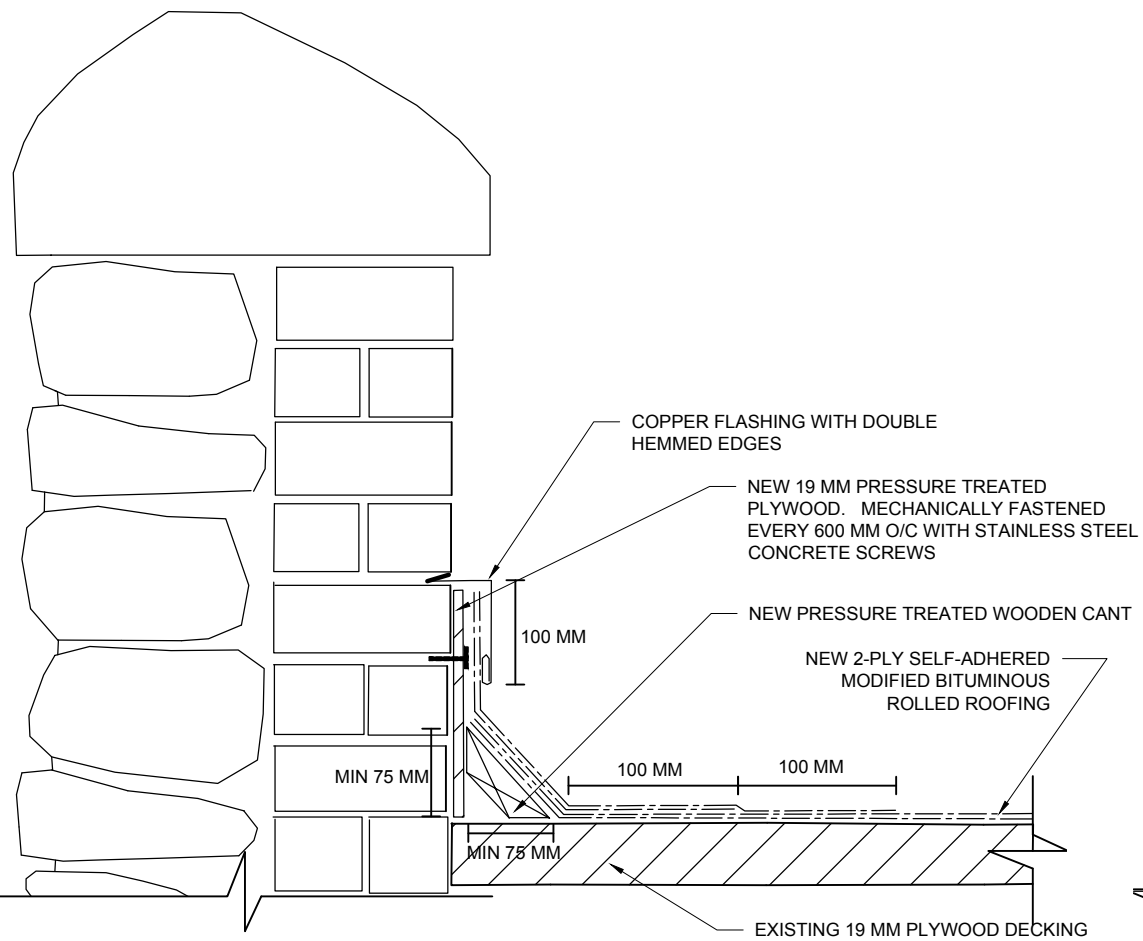


NOTE: REGLETS TO BE INSTALLED IN SAME LOCATION AS EXISTING. PRECISE SIZING (HEIGHT) OF MATERIAL WILL VARY ACCORDING TO LOCATION.

**1** TYPICAL FLAT ROOF PARAPET FLASHING  
DT106 SCALE: N.T.S.

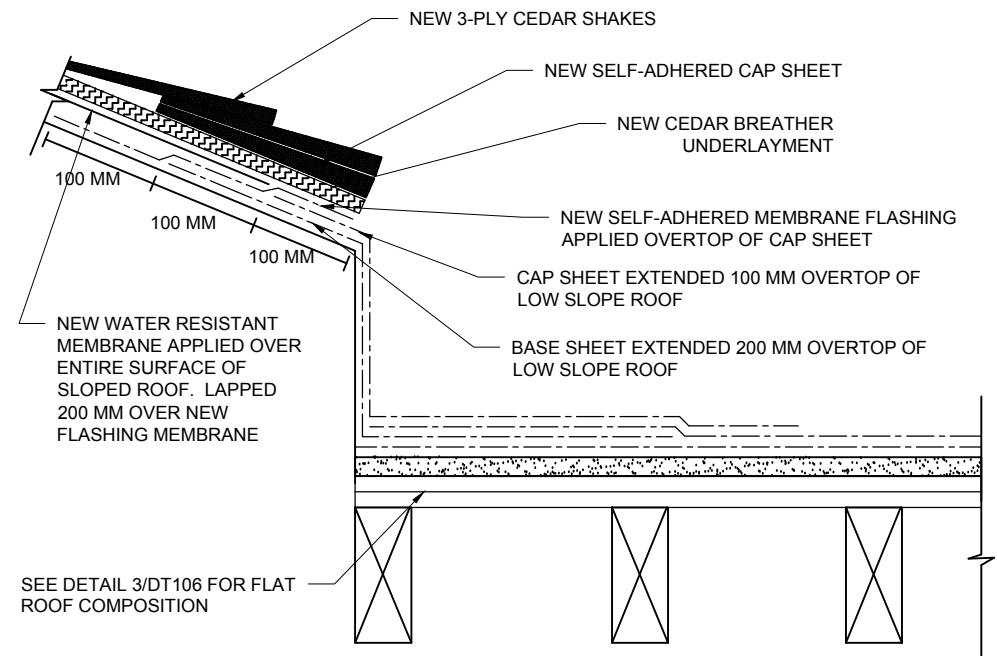

SEE DETAIL 3/DT106 FOR FLAT ROOF COMPOSITION

**2** SLOPE ROOF TO FLAT ROOF TRANSITION  
DT106 SCALE: N.T.S.

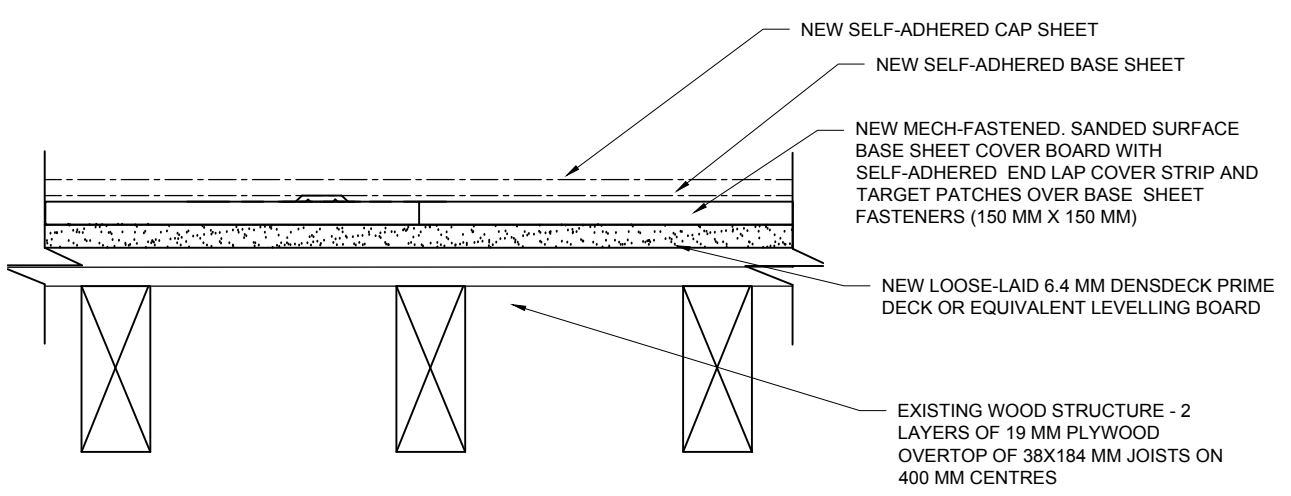

**3** TYPICAL FLAT ROOF COMPOSITION  
DT106 SCALE: N.T.S.

revisions	description	date
4	ISSUED FOR TENDER	19/03/20
3	ISSUED FOR REVIEW	18/08/24
2	ISSUED FOR REVIEW	18/08/03
1	ISSUED FOR REVIEW	18/07/25

A C	A detail no. no. du detail B location drawing no. sur dessin no. C drawing no. dessin no.	A B C
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project BANFF ADMINISTRATION BUILDING

drawing FLAT ROOF DETAILS

Designed By	CK	(yyyy/mm/dd)
Date		
Drawn By	TK	Dessiné par (yyyy/mm/dd)
Date		
Reviewed By	JD	Examiné par (yyyy/mm/dd)
Date		
Approved By	JD	Approuvé par (yyyy/mm/dd)
Date		

Project no. No. du projet

Drawing no. DT106 No. du dessin