




1 HUDDLE SOUTH ELEVATION
SCALE / ÉCHELLE 1:20

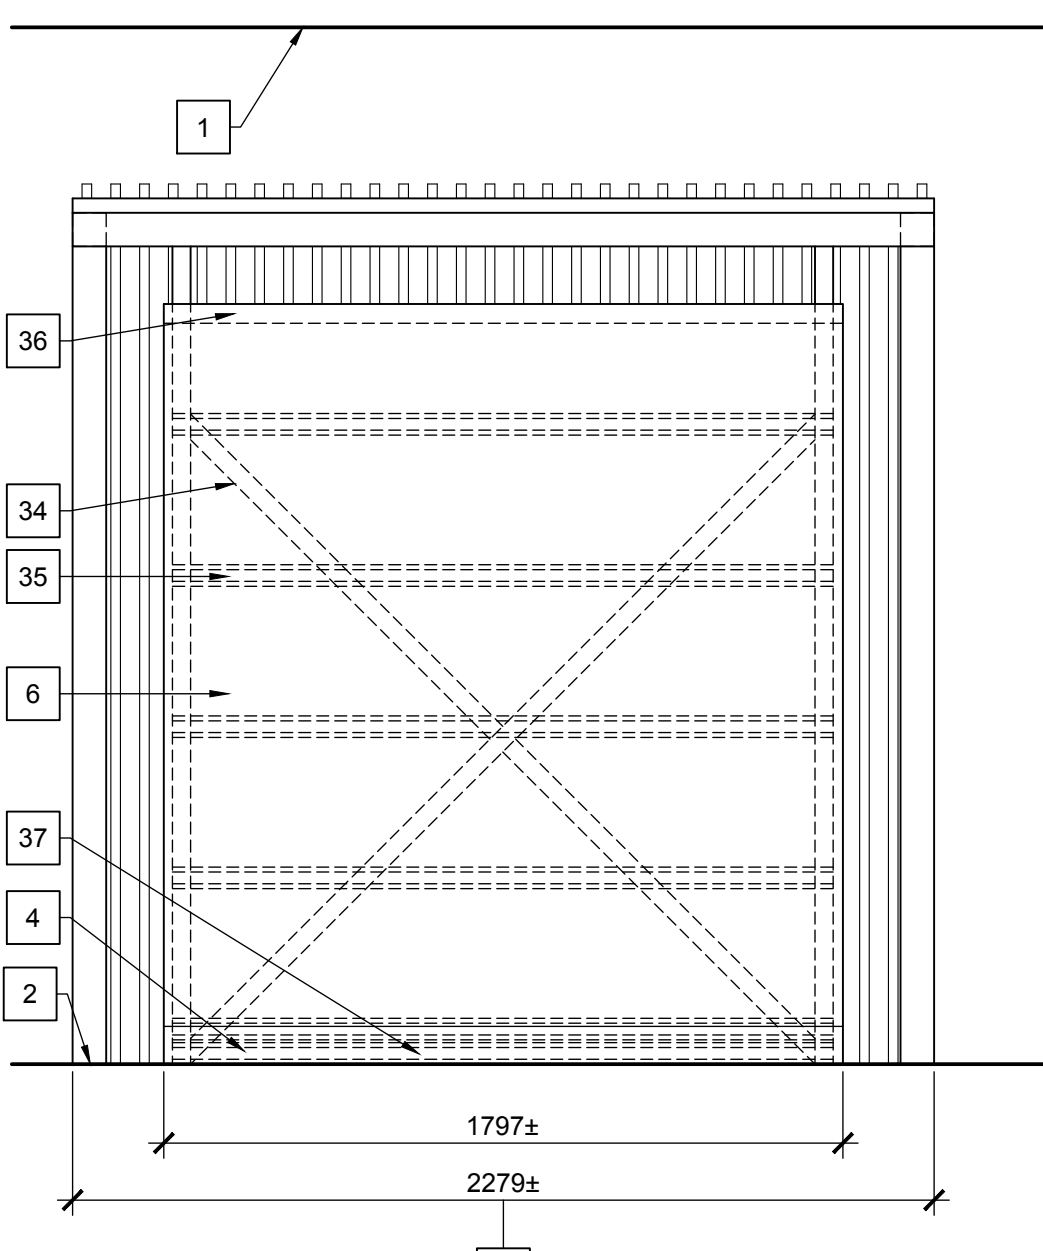


2 HUDDLE WEST ELEVATION
SCALE / ÉCHELLE 1:20

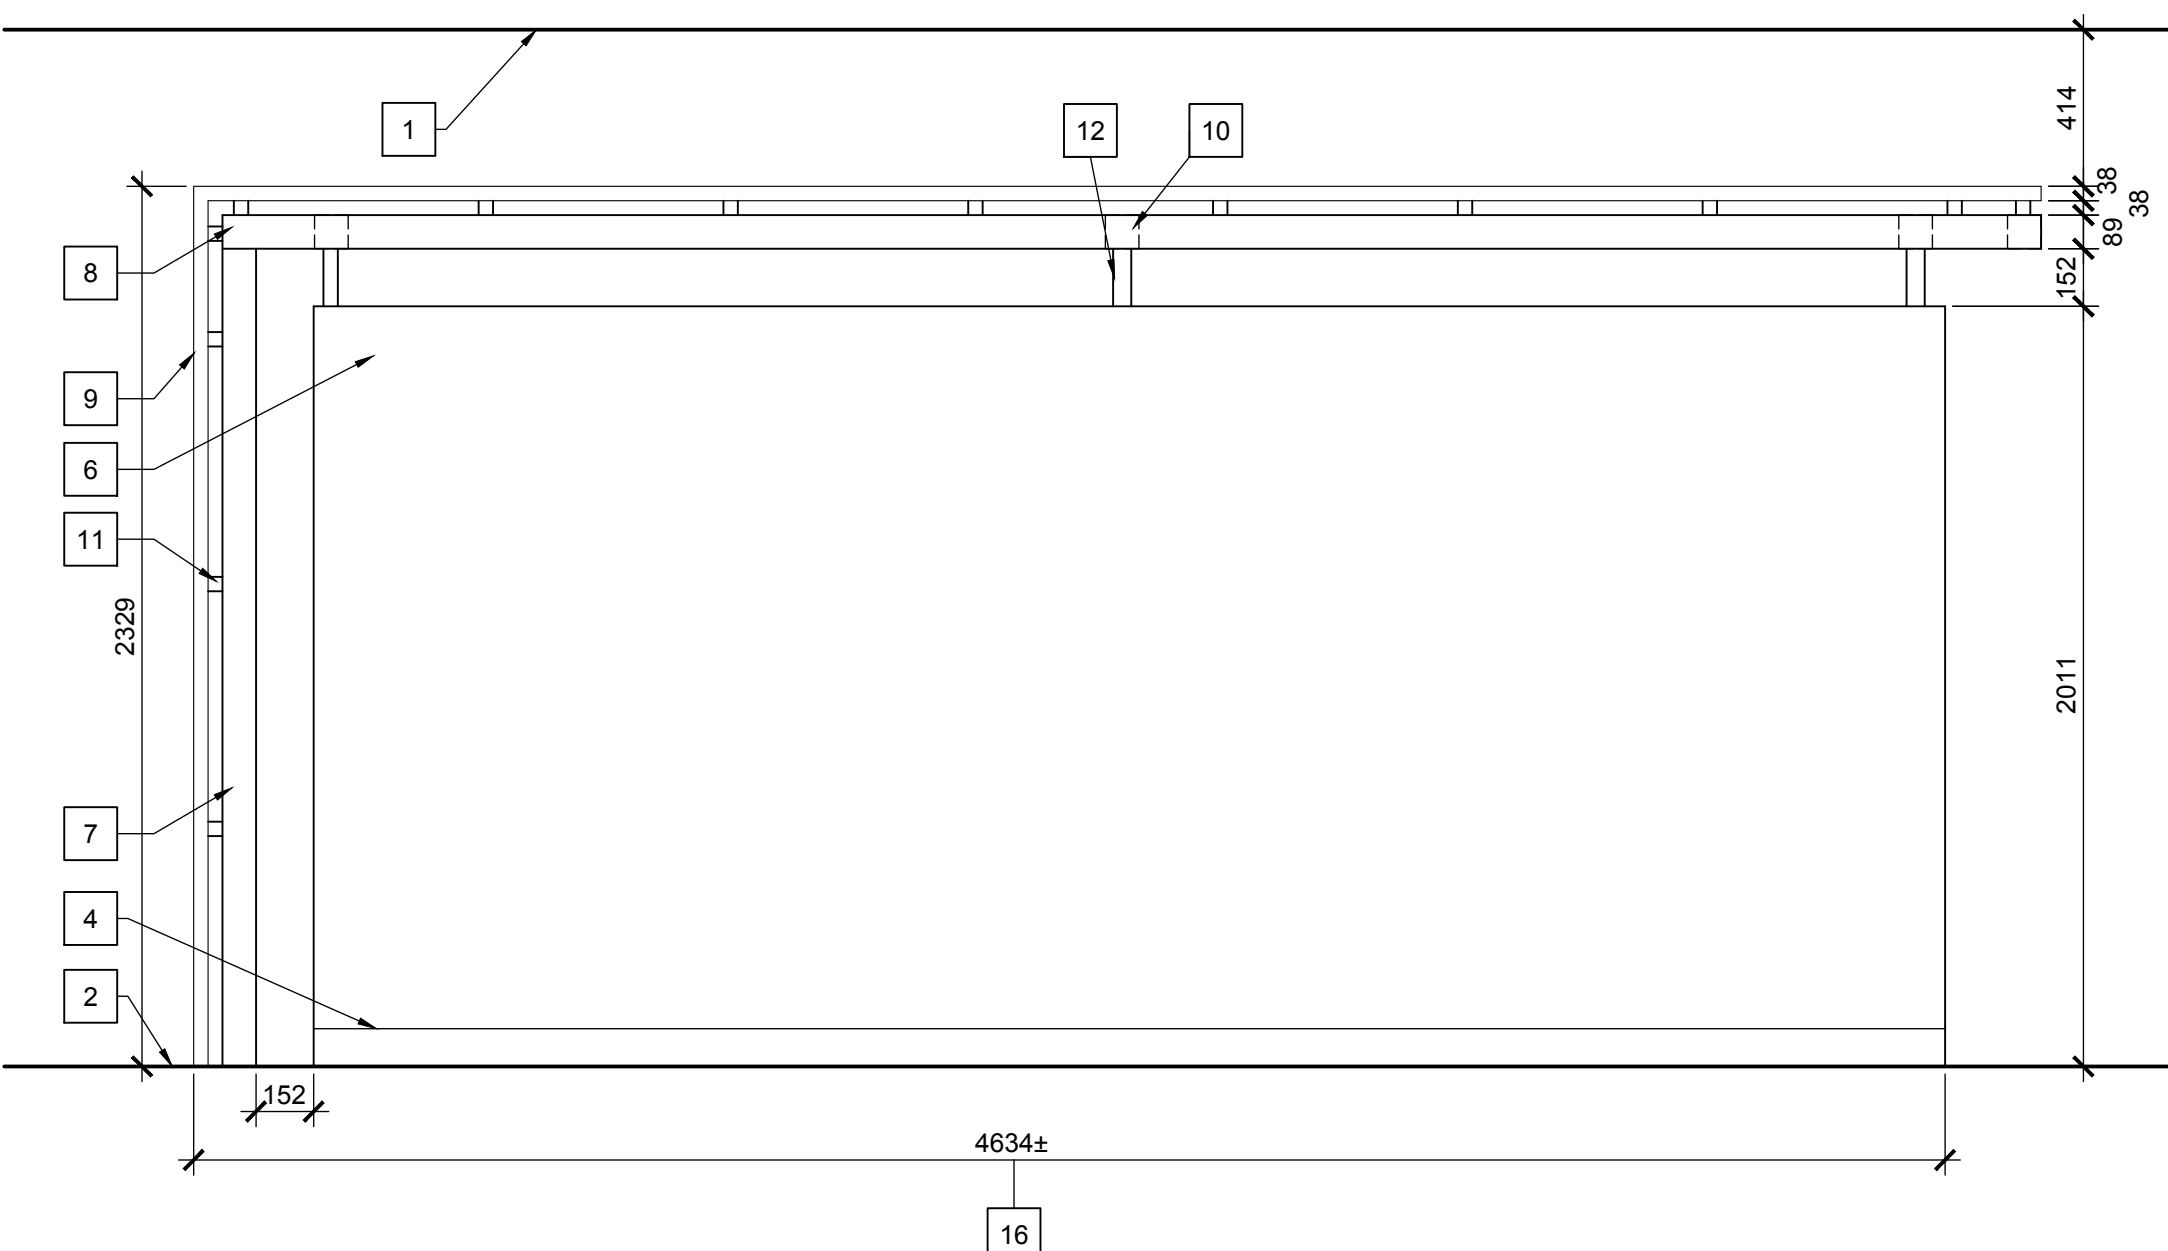


3 HUDDLE NORTH ELEVATION
SCALE / ÉCHELLE 1:20

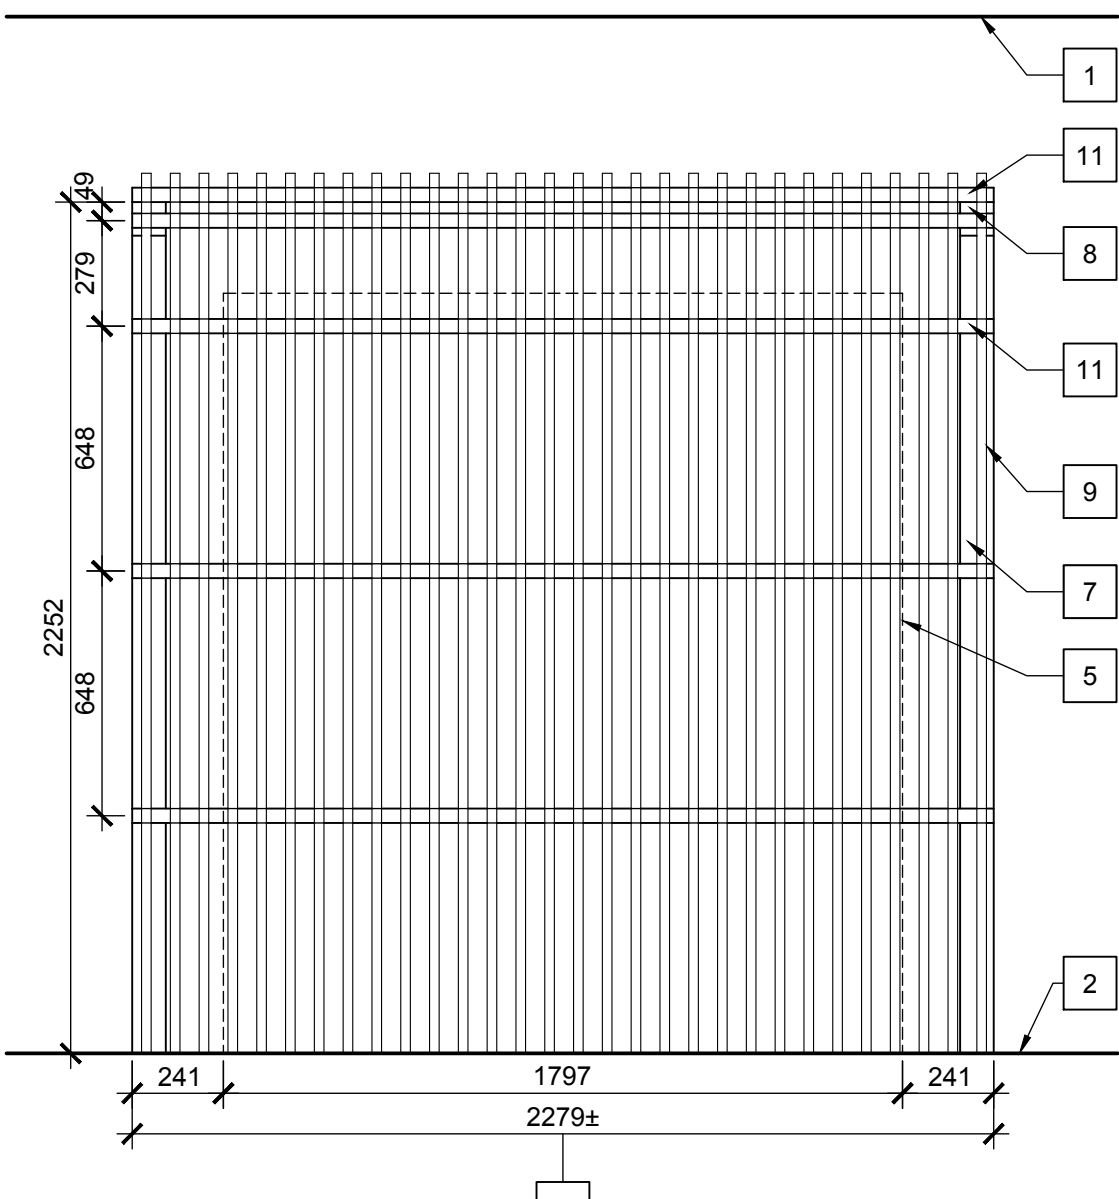


4 HUDDLE EAST ELEVATION
SCALE / ÉCHELLE 1:20

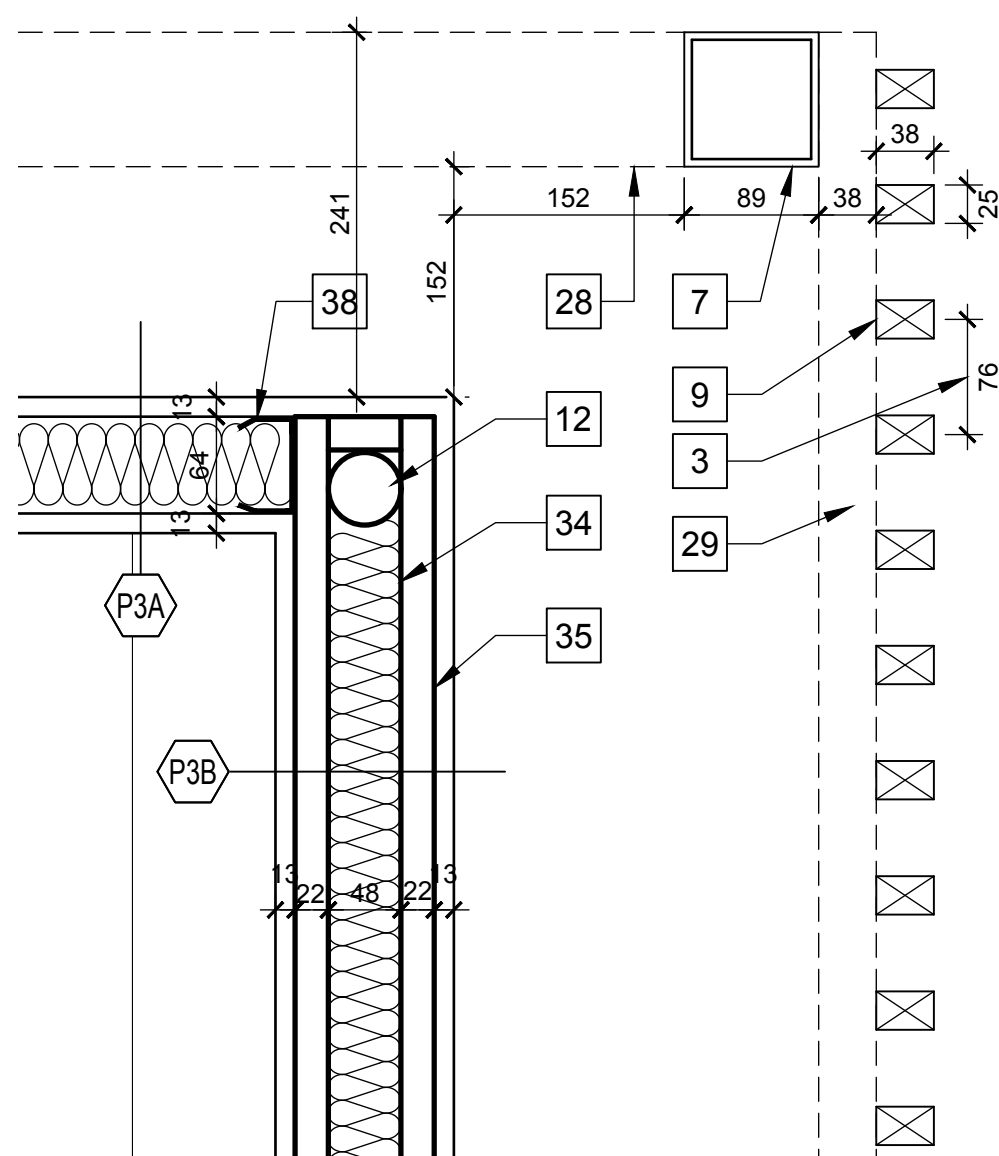


5 HUDDLE PLAN DETAIL TYPICAL AT STRUCTURE
SCALE / ÉCHELLE 1:5

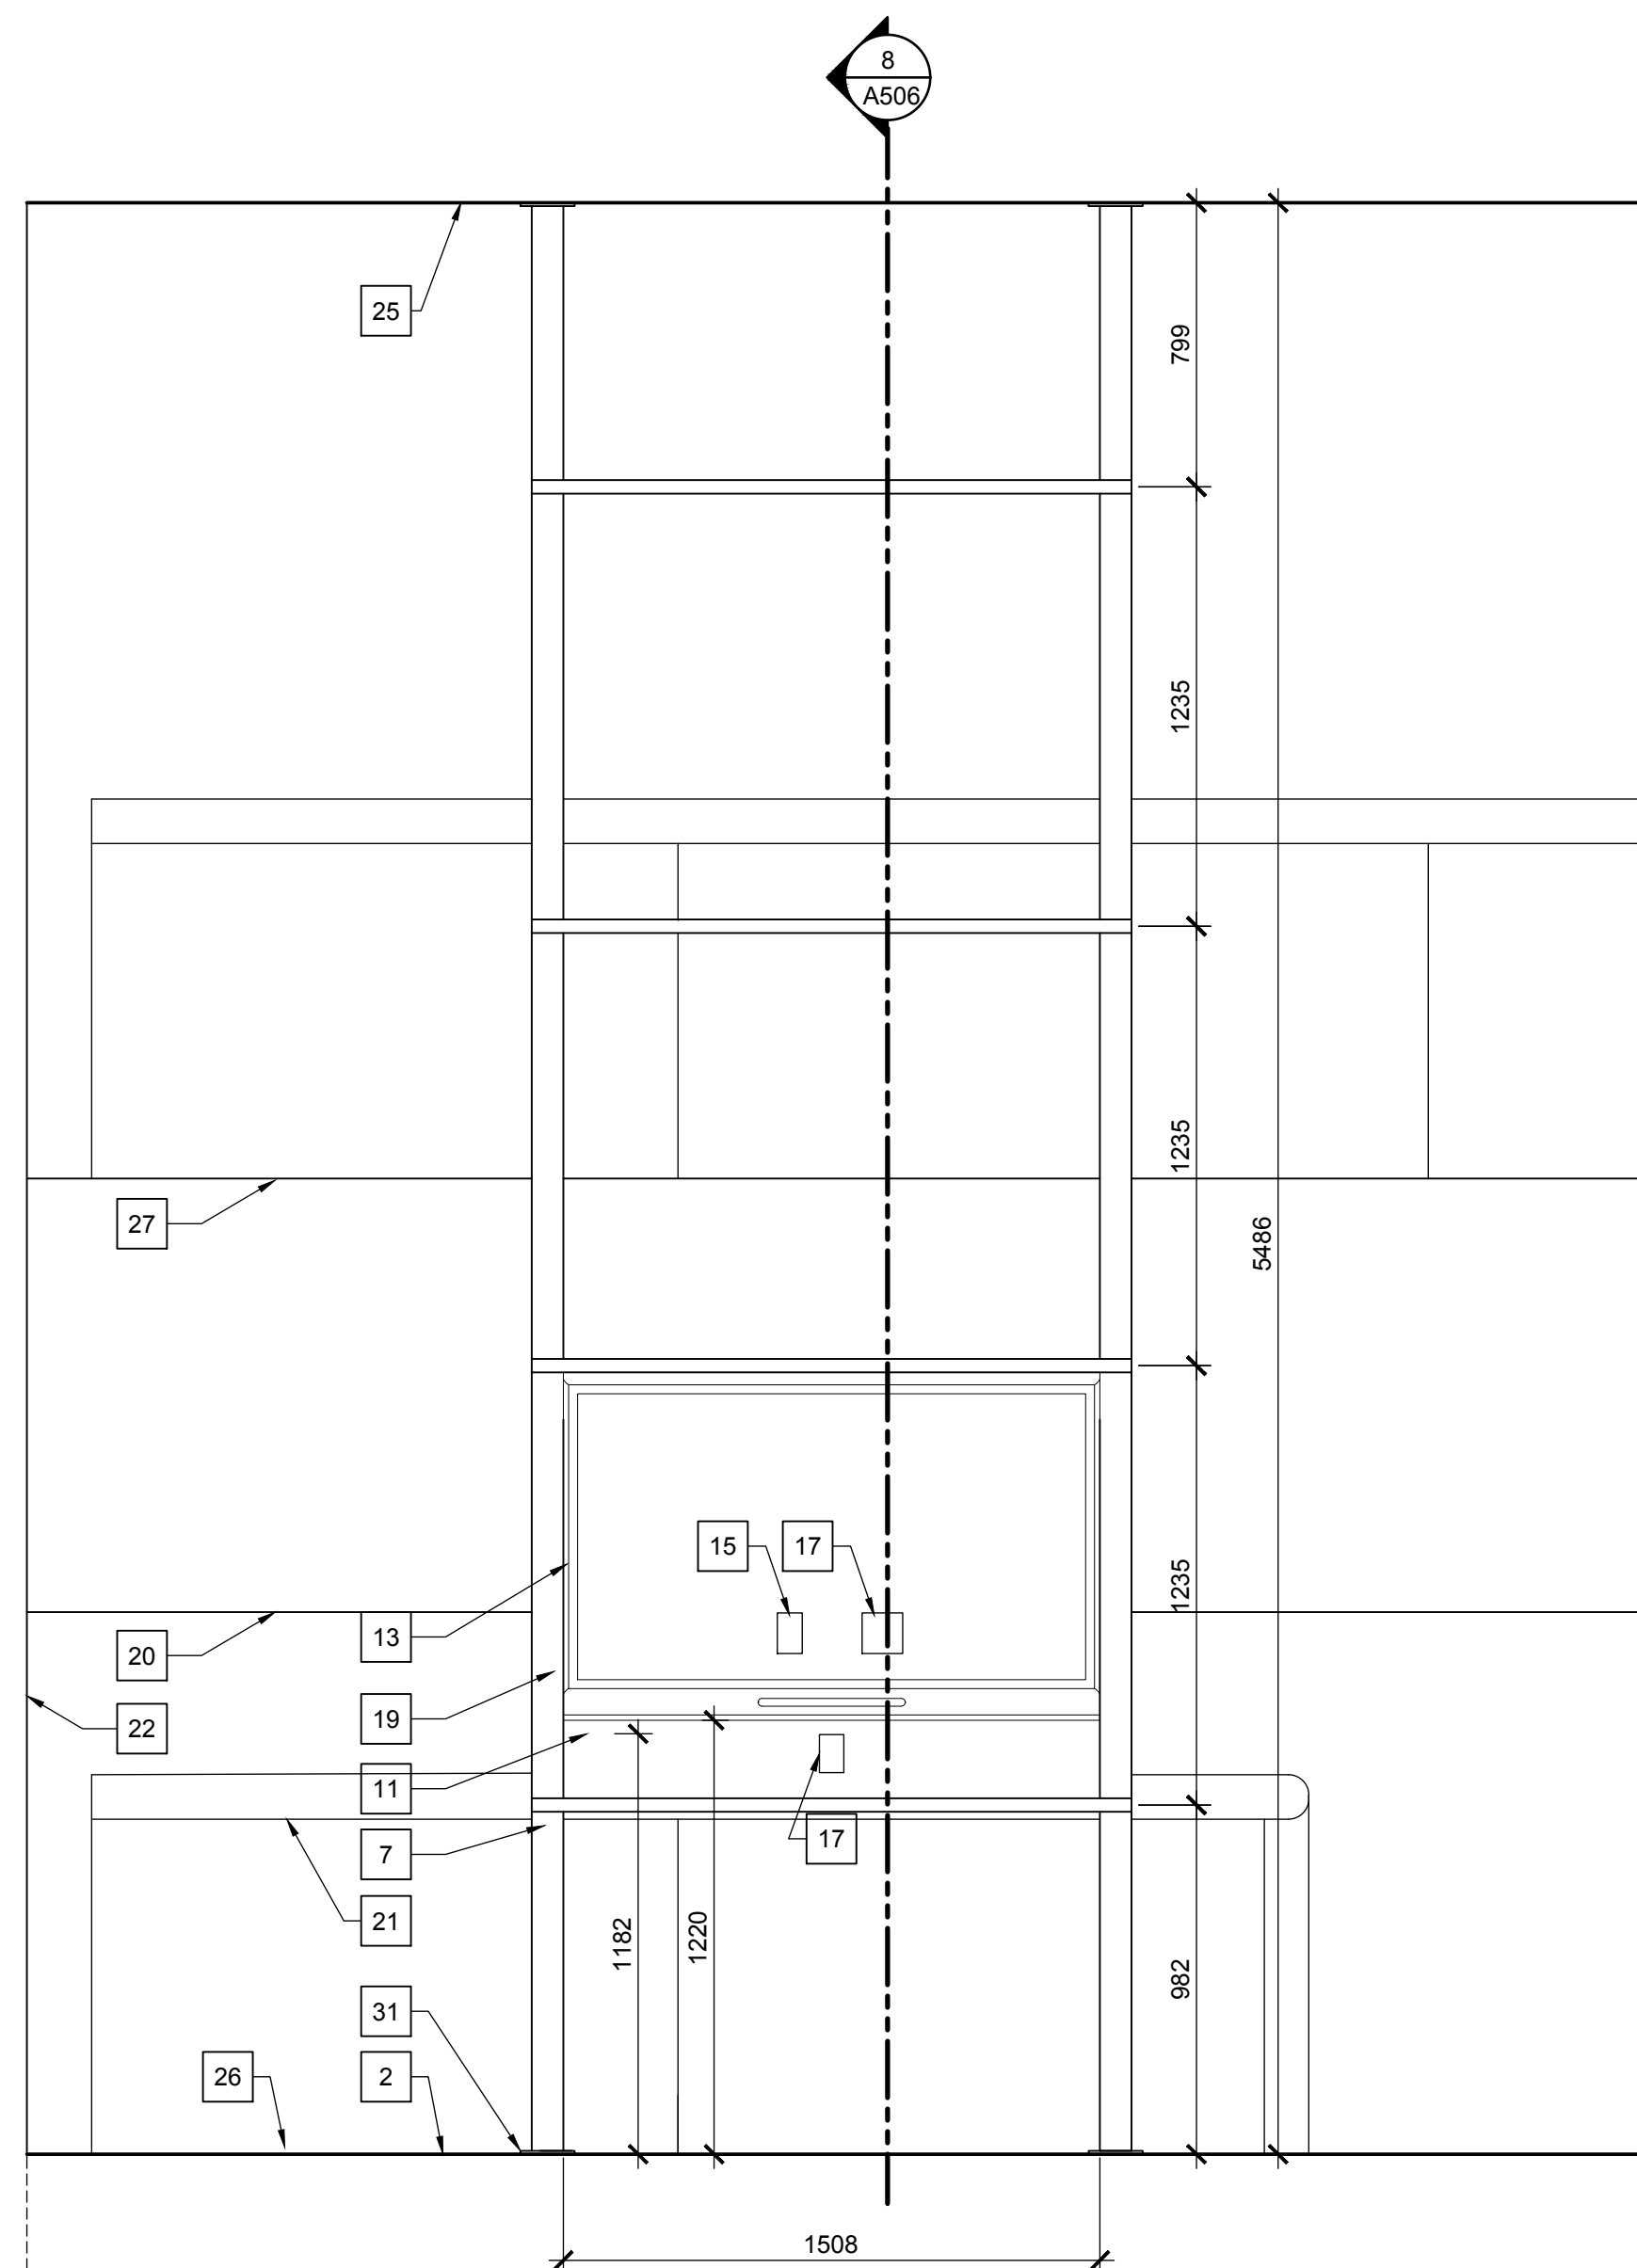


7 SMART BOARD STAND EAST ELEVATION
SCALE / ÉCHELLE 1:20

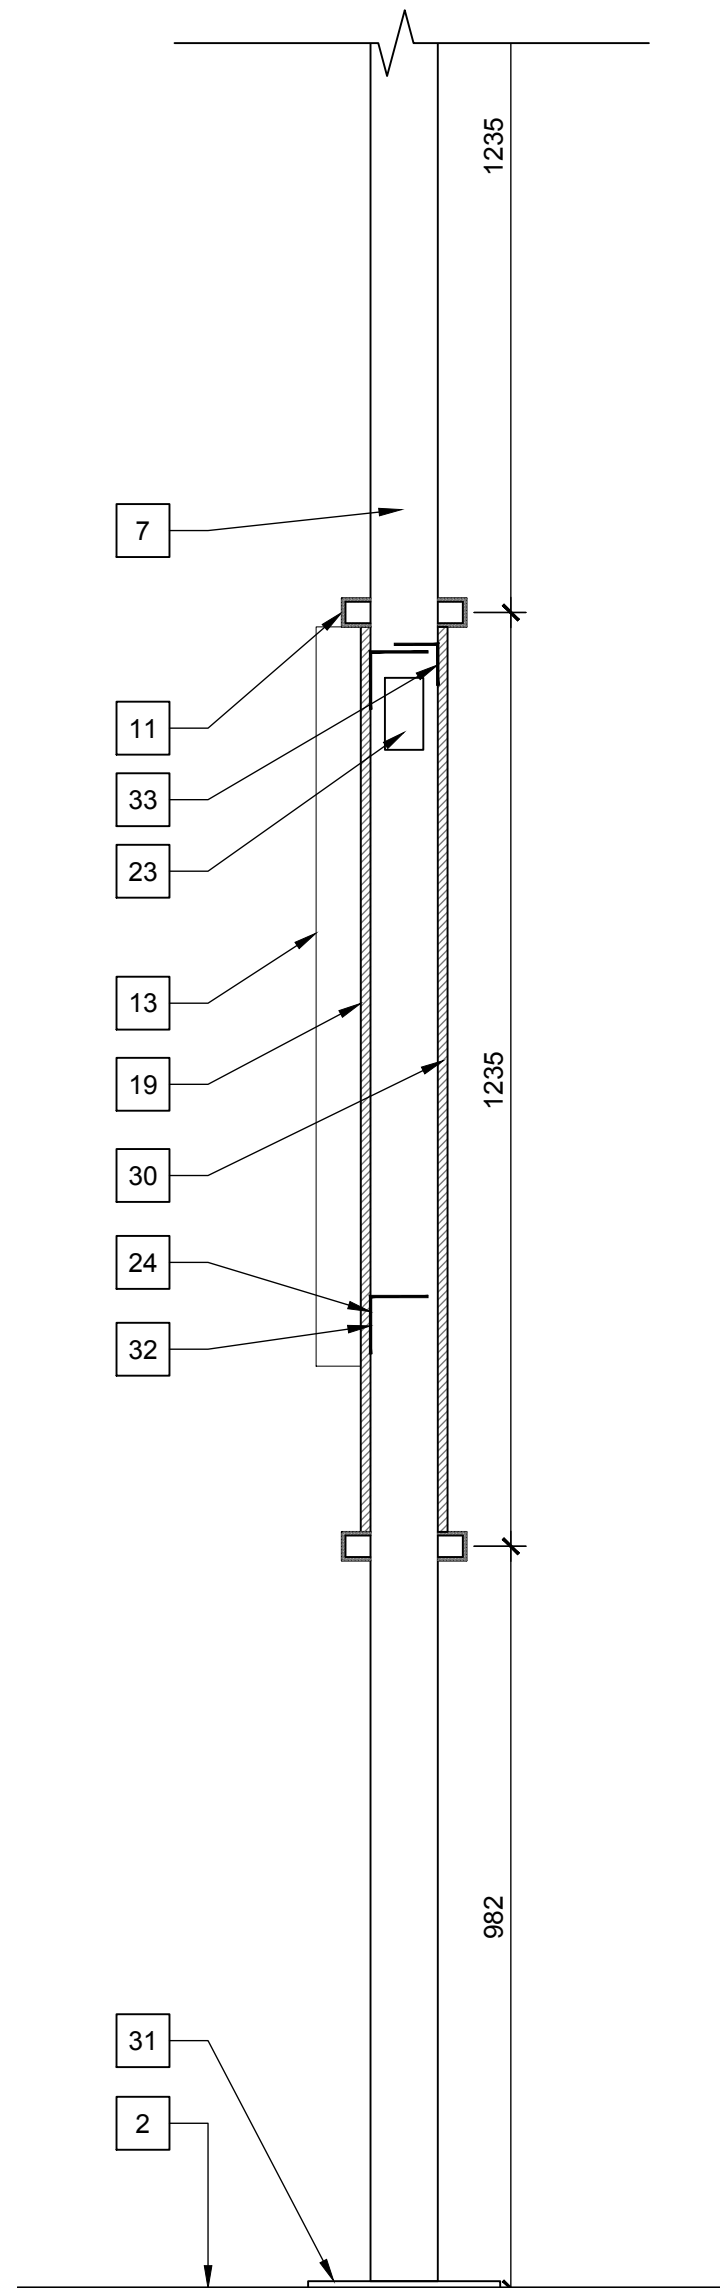

8 SMART BOARD STAND SECTION
SCALE / ÉCHELLE 1:10

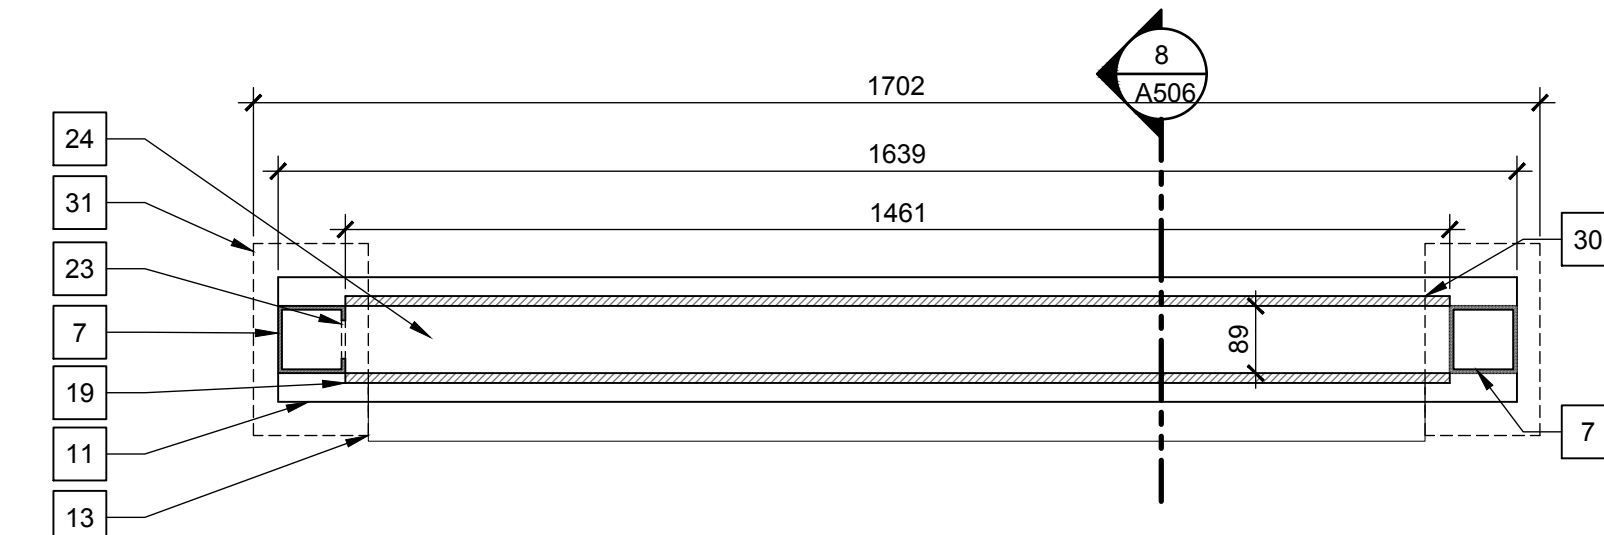

9 SMART BOARD STAND PLAN SECTION
SCALE / ÉCHELLE 1:10

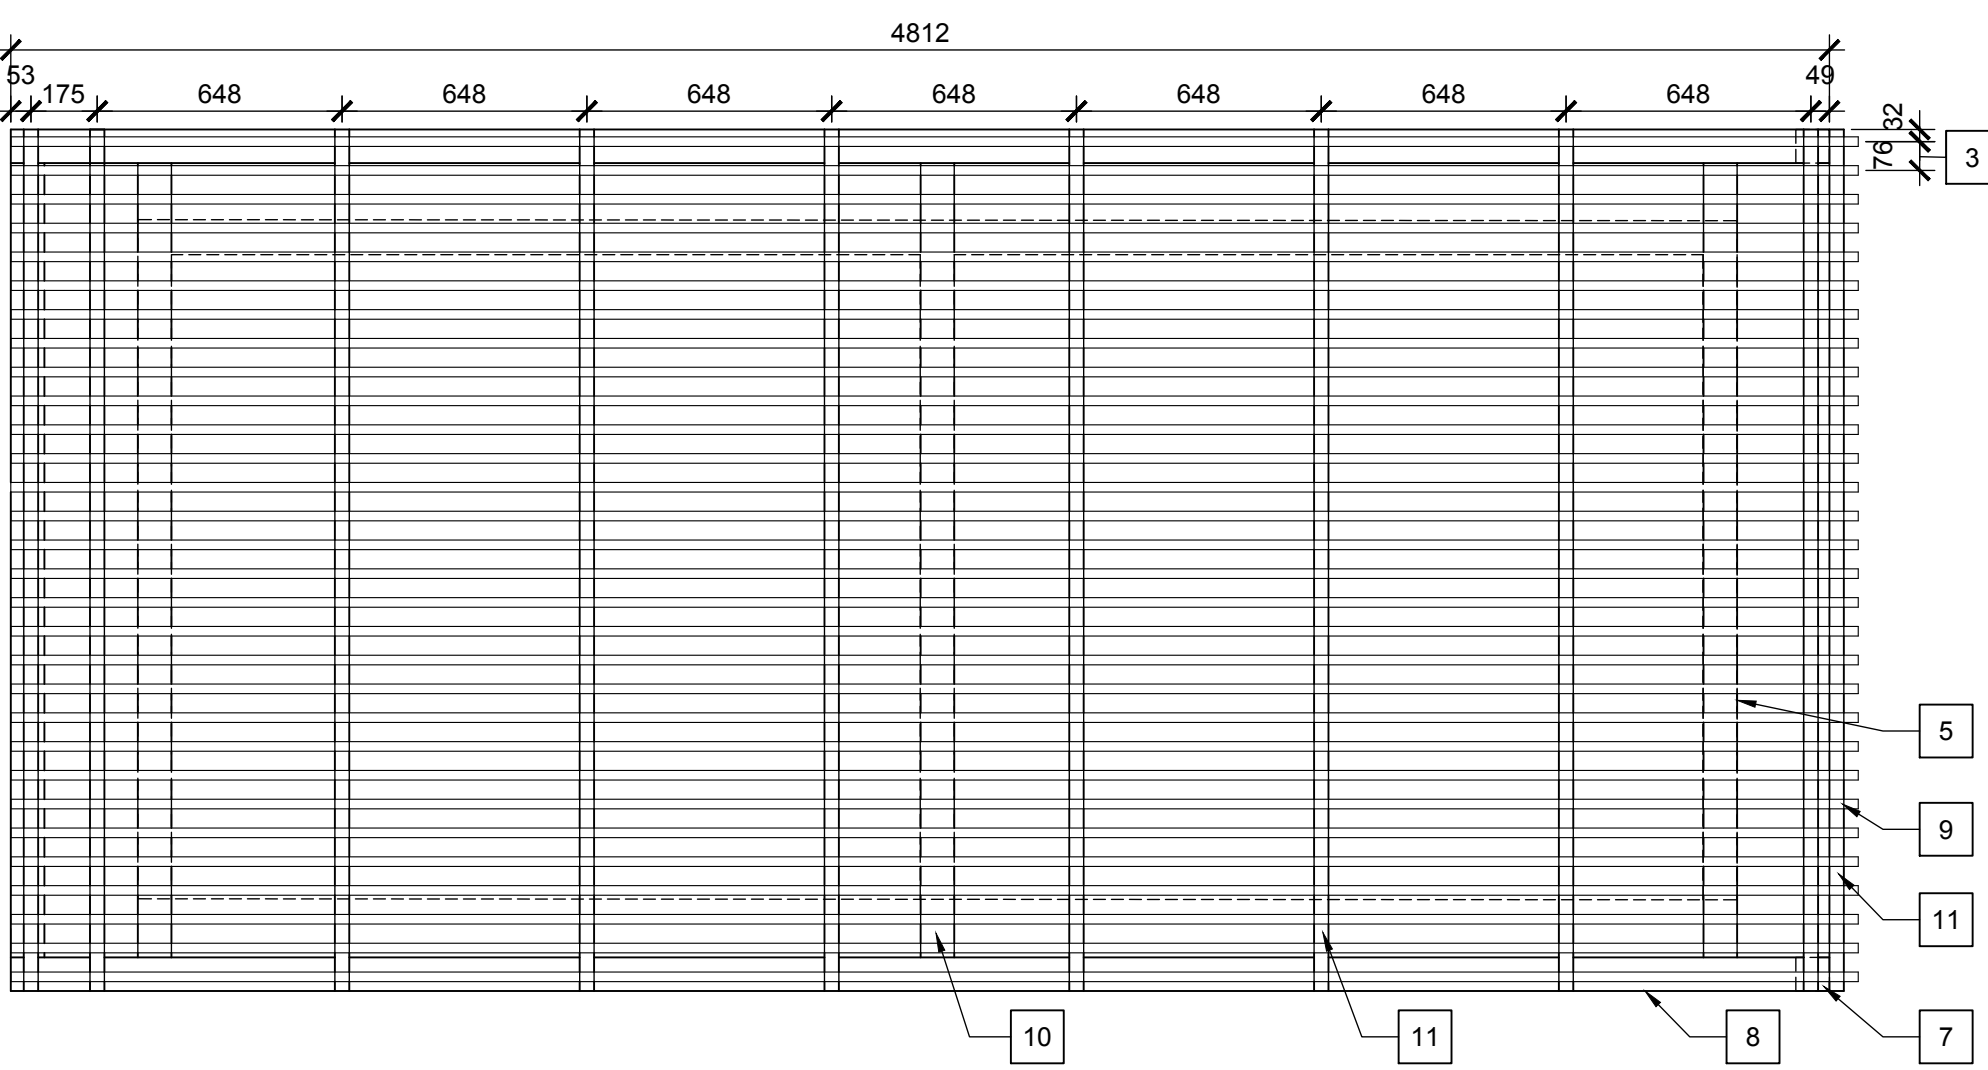

6 HUDDLE CEILING PLAN
SCALE / ÉCHELLE 1:20

DRAWING NOTES, A506

- SUSPENDED LAY-IN ACOUSTICAL TILE CEILING SYSTEM.
- FLOOR FINISH, REFER TO FLOOR FINISH PLANS A141.
- TYPICAL SPACING.
- RESILIENT BASE.
- INDICATES LOCATION OF PARTITION BEYOND.
- GYPSUM BOARD PARTITION, PAINT FINISH.
- HOLLOW STEEL POST, MATTE BLACK PAINT FINISH. SEE STRUCTURAL FOR SIZING AND CONNECTION DETAILS.
- HOLLOW STEEL BEAM, MATTE BLACK PAINT FINISH. SEE STRUCTURAL FOR SIZING AND CONNECTION DETAILS.
- 19mm x 38mm STAINED HARDWOOD SLATS ARRAYED AT 76mm O.C. TREAT WITH FIRE RETARDANT CLEAR COATING.
- 1HOLLOW STEEL CROSSBEAM, MATTE BLACK PAINT FINISH. SEE STRUCTURAL FOR SIZING AND CONNECTION DETAILS.
- 51mm X 51mm STEEL CROSSBEAM, MATTE BLACK PAINT FINISH. SEE STRUCTURAL FOR SIZING AND CONNECTION DETAILS.
- STEEL POST TO SUPPORT STEEL STRUCTURE, MATTE BLACK PAINT FINISH. SEE STRUCTURAL FOR SIZING AND CONNECTION DETAILS.
- SMART BOARD BY DEPARTMENTAL REPRESENTATIVE. INSTALL TV MOUNTING HARDWARE SUPPLIED BY DEPARTMENTAL REPRESENTATIVE.
- HUDDLE FURNITURE BY DEPARTMENTAL REPRESENTATIVE.
- POWER OUTLETS CENTERED AT 1170 A.F.F. REFER TO ELECTRICAL.
- OVERALL WIDTH TO BE CONFIRMED WITH DEPARTMENTAL REPRESENTATIVE TO COORDINATE WITH FURNITURE BY OTHERS.
- DATA OUTLETS LOCATION. SEE ELECTRICAL.
- FINISH TOP OF PARTITION WITH 13MM GYPSUM BOARD, PAINT FINISH.
- 19mm G2S HARDWOOD VENEER PLYWOOD MOUNTING BOARD WITH EDGES VENEERED. STAIN FINISH.
- LINE OF C2 LEVEL CEILING BULKHEAD BEHIND.
- EXISTING TEMPERED GLASS BALUSTRADE AND ALUMINUM GUARDRAIL. PROTECT.
- EXISTING EXTERIOR WALL.
- CUT CHANNEL IN 100mmX100mm STEEL POST TO ALLOW FOR POWER AND DATA CABLING TO SERVICE SMART BOARD.
- HIDDEN FASTENERS TO CONNECTED STEEL ANGLE TO BACKER BOARD FOR INSIDE ASSEMBLY.
- UNDERSIDE OF BULKHEAD BELOW LEVEL C3 ABOVE.
- WIREWAY TO PROVIDE POWER AND DATA TO MONITOR STAND. SEE ELECTRICAL.
- C3 LANDING
- LINE OF STEEL BEAM ABOVE AND EXTENTS OF CANOPY OVERHANG
- LINE OF STEEL CROSS MEMBER ABOVE
- 19mm G2S HARDWOOD VENEER PLYWOOD WITH EDGES VENEERED. STAIN FINISH.
- STEEL BASE PLATE, SEE STRUCTURAL.
- 76X76X4.8mm ANGLE WELDED TO HSS POST TO SUPPORT PLYWOOD BACKER BOARD. SEE STRUCTURAL.
- PROVIDE CONTINUOUS 38mm BY 385mm METAL ANGLE PLYWOOD SUPPORT BRACKET TO CARRY PLYWOOD PANEL ON STRUCTURAL ANGLE AS SHOWN.
- STRUCTURAL STEEL BRACING WITHIN WALL, SEE STRUCTURAL.
- FURRING CHANNEL, SEE ASSEMBLY SCHEDULE. A002
- TOP TRACK, SEE ASSEMBLY SCHEDULE. A002
- ALIGN BOTTOM FURRING CHANNEL WITH BASE OF WALL/FLOOR TO PROVIDE NAILING SURFACE.
- 64mm STUD, SEE ASSEMBLY SCHEDULE. A002
- TV MONITOR BY DEPARTMENTAL REPRESENTATIVE. INSTALL TV MOUNTING HARDWARE SUPPLIED BY DEPARTMENTAL REPRESENTATIVE.

GENERAL NOTES, A506

- A. SLAB TO SLAB HEIGHT: 3886mm± .
B. PROVIDE BACKING IN WALL TO SUPPORT CABINETS, COUNTERS, GABLES, OR MONITORS.

Canada

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L'ENTREPRENEUR DEVRA VÉRIFIER TOUTES LES DIMENSIONS ET LES CONDITIONS SUR LE CHANTIER ET AVISER SANS DÉLAI LE REPRÉSENTANT DU MINISTÈRE DE TOUTE ANOMALIE.
Contractor to verify all dimensions and conditions on site and immediately notify the departmental representative of all discrepancies.

revisions	description	date
4	REISSUED FOR TENDER	2019/09/25
3	ISSUED FOR TENDER	2019/05/03
2	ISSUED FOR 100% REVIEW	2019/04/08
1	ISSUED FOR 99% REVIEW	2019/03/19

A	A detail no. of detail	A
C	B location drawing no. sur dessin no.	B C
	C drawing no. dessin no.	

project projet

CD HOWE BLDG.
LEVEL C2
FIT-UP

235 QUEEN ST., OTTAWA, ONTARIO

drawing dessin

SPECIALTY
DETAILS

Designed By	AN/DL	Conçu par	Conçu par
Date	(yyyy/mm/dd)		
Drawn By	AN/PJKA	Dessiné par	Dessiné par
Date	(yyyy/mm/dd)		
Reviewed By	DL	Examiné par	Examiné par
Date	2019/05		
Approved By	PK/DL	Approuvé par	Approuvé par
Date	(yyyy/mm/dd)		
Tender	ISMAT BEGUM	Soumission	Soumission
Project Manager	Administrateur de projets		
Project no.	No. du projet		

R.100325.004

Drawing no. No. du dessin

A506