

DO NOT SCALE DRAWINGS

0	ISSUED FOR TENDER	2019-05-09

Revision/ Révision	Description/Description	Date/Date
Client/client		

**Fisheries & Oceans Canada**  
**Small Craft Harbours Branch**  
**Pacific Division**  
  
**200 - 401 Burrard Street**  
**Vancouver, Canada, V6C 3S4**

Project title/Titre du projet

**KLEMTU HARBOUR**

Approved by/Approuvé par  
**DB**

Designed by/Concept par  
**DJ**

Drawn by/Dessiné par  
**DJ**

PWGSC Project Manager/Administrateur de Projets TPSCG

PWGSC, Architectural and Engineering Resources Manager/  
Ressources Architectural et de Directeur d'Ingénierie, TPSCG

Client/client


Drawing title/Titre du dessin

**DEMOLITION**  
**GENERAL ARRANGEMENT**

Project No./No. du projet	Sheet/Feuille	Revision no./ La Révision no.
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**722835-001**

**001**  
OF

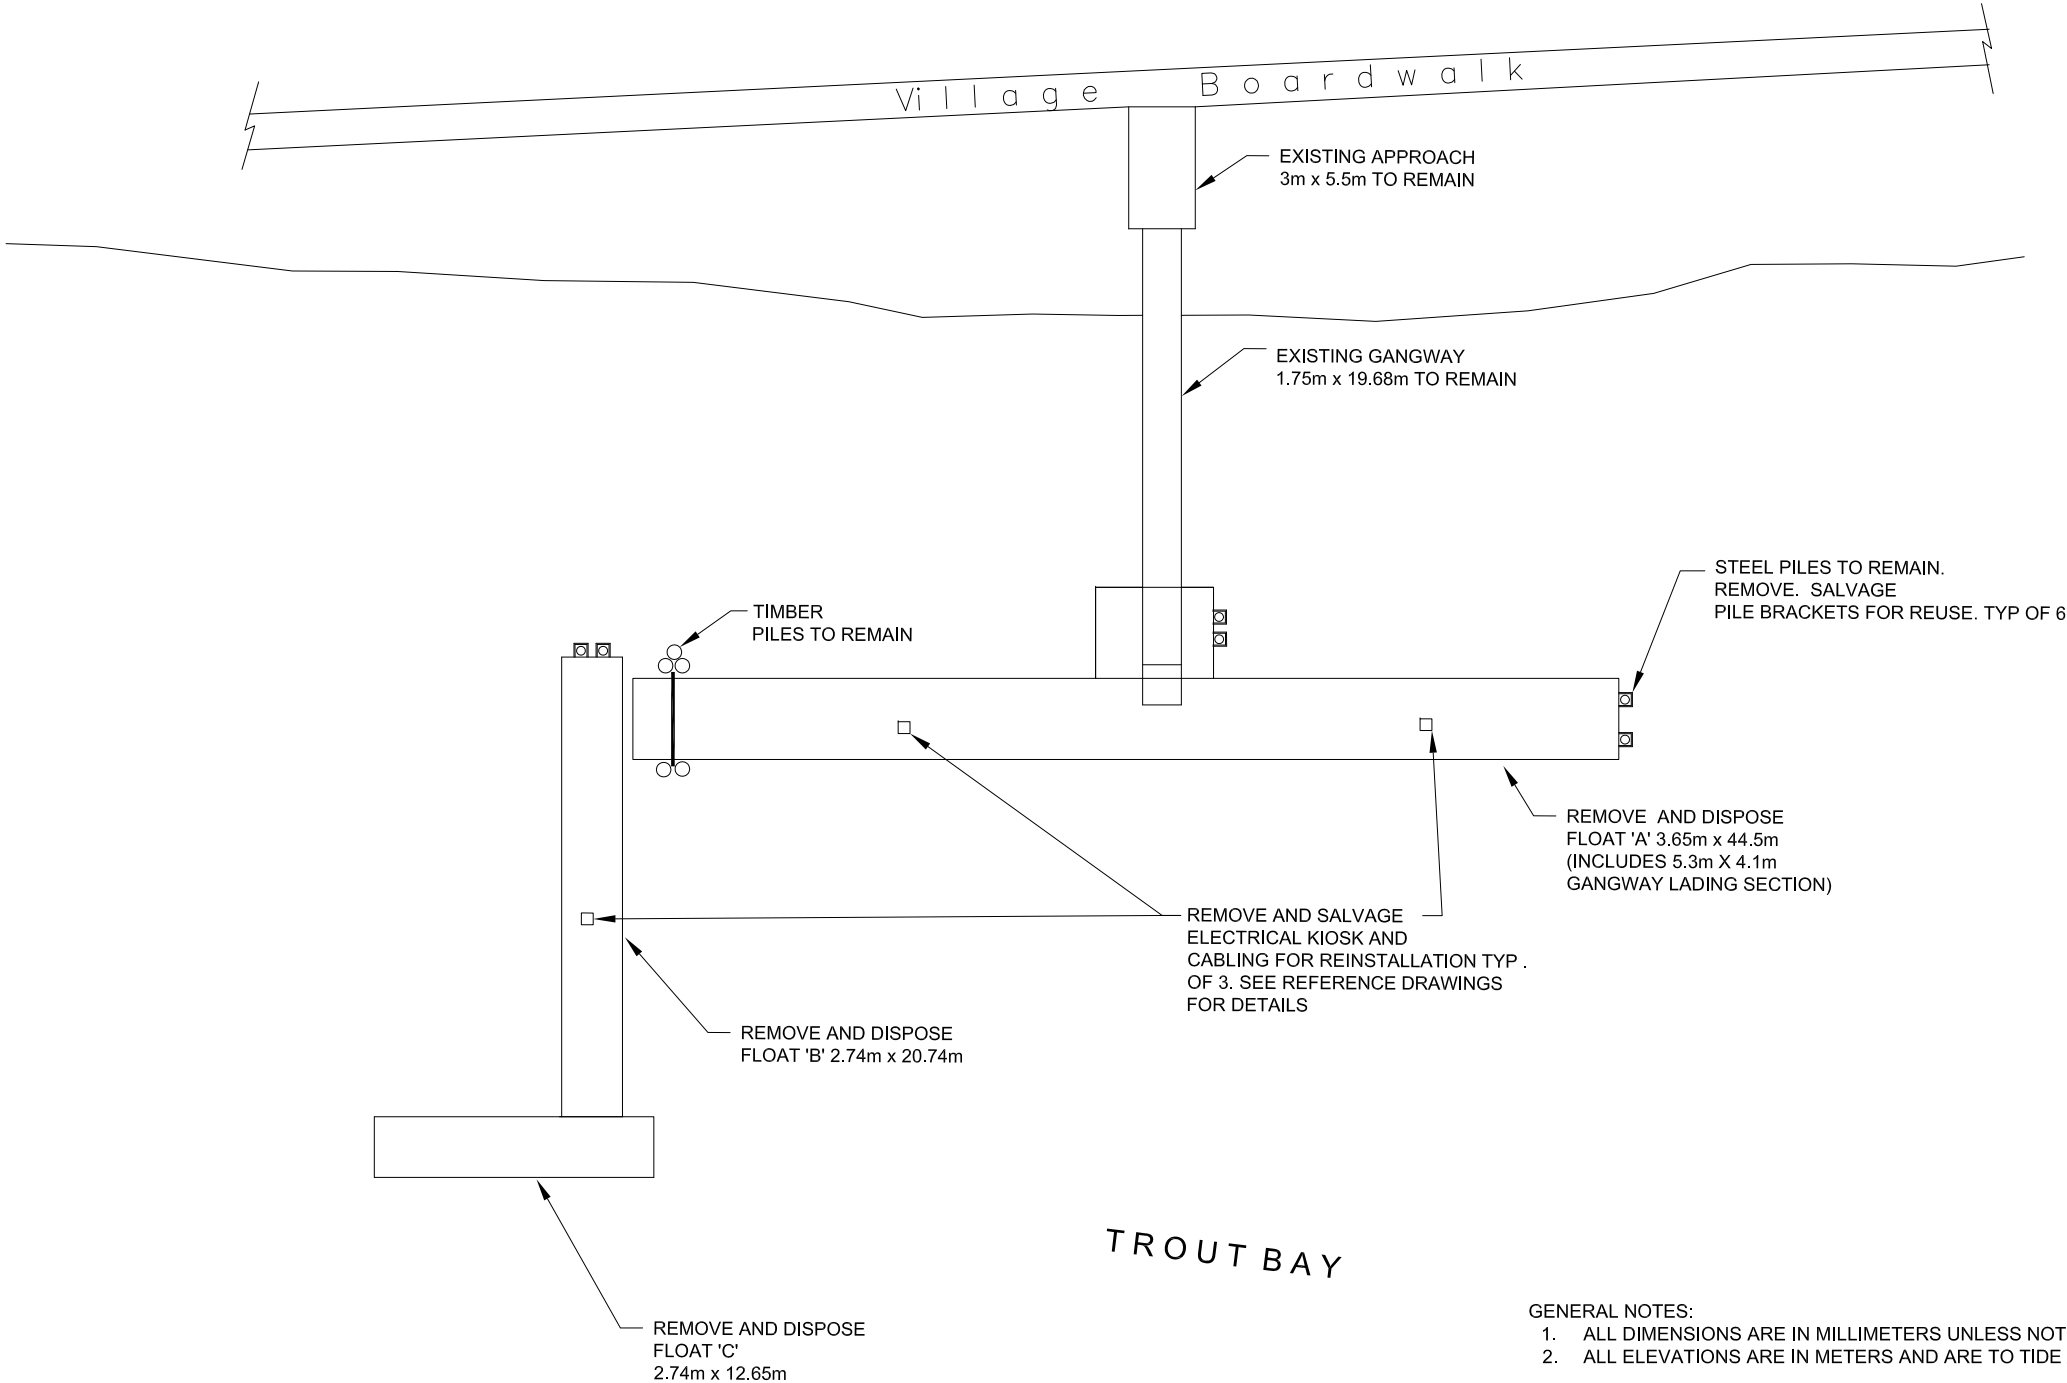

- GENERAL NOTES:
- ALL DIMENSIONS ARE IN MILLIMETERS UNLESS NOTED OTHERWISE
  - ALL ELEVATIONS ARE IN METERS AND ARE TO TIDE AND CHART DATUM.



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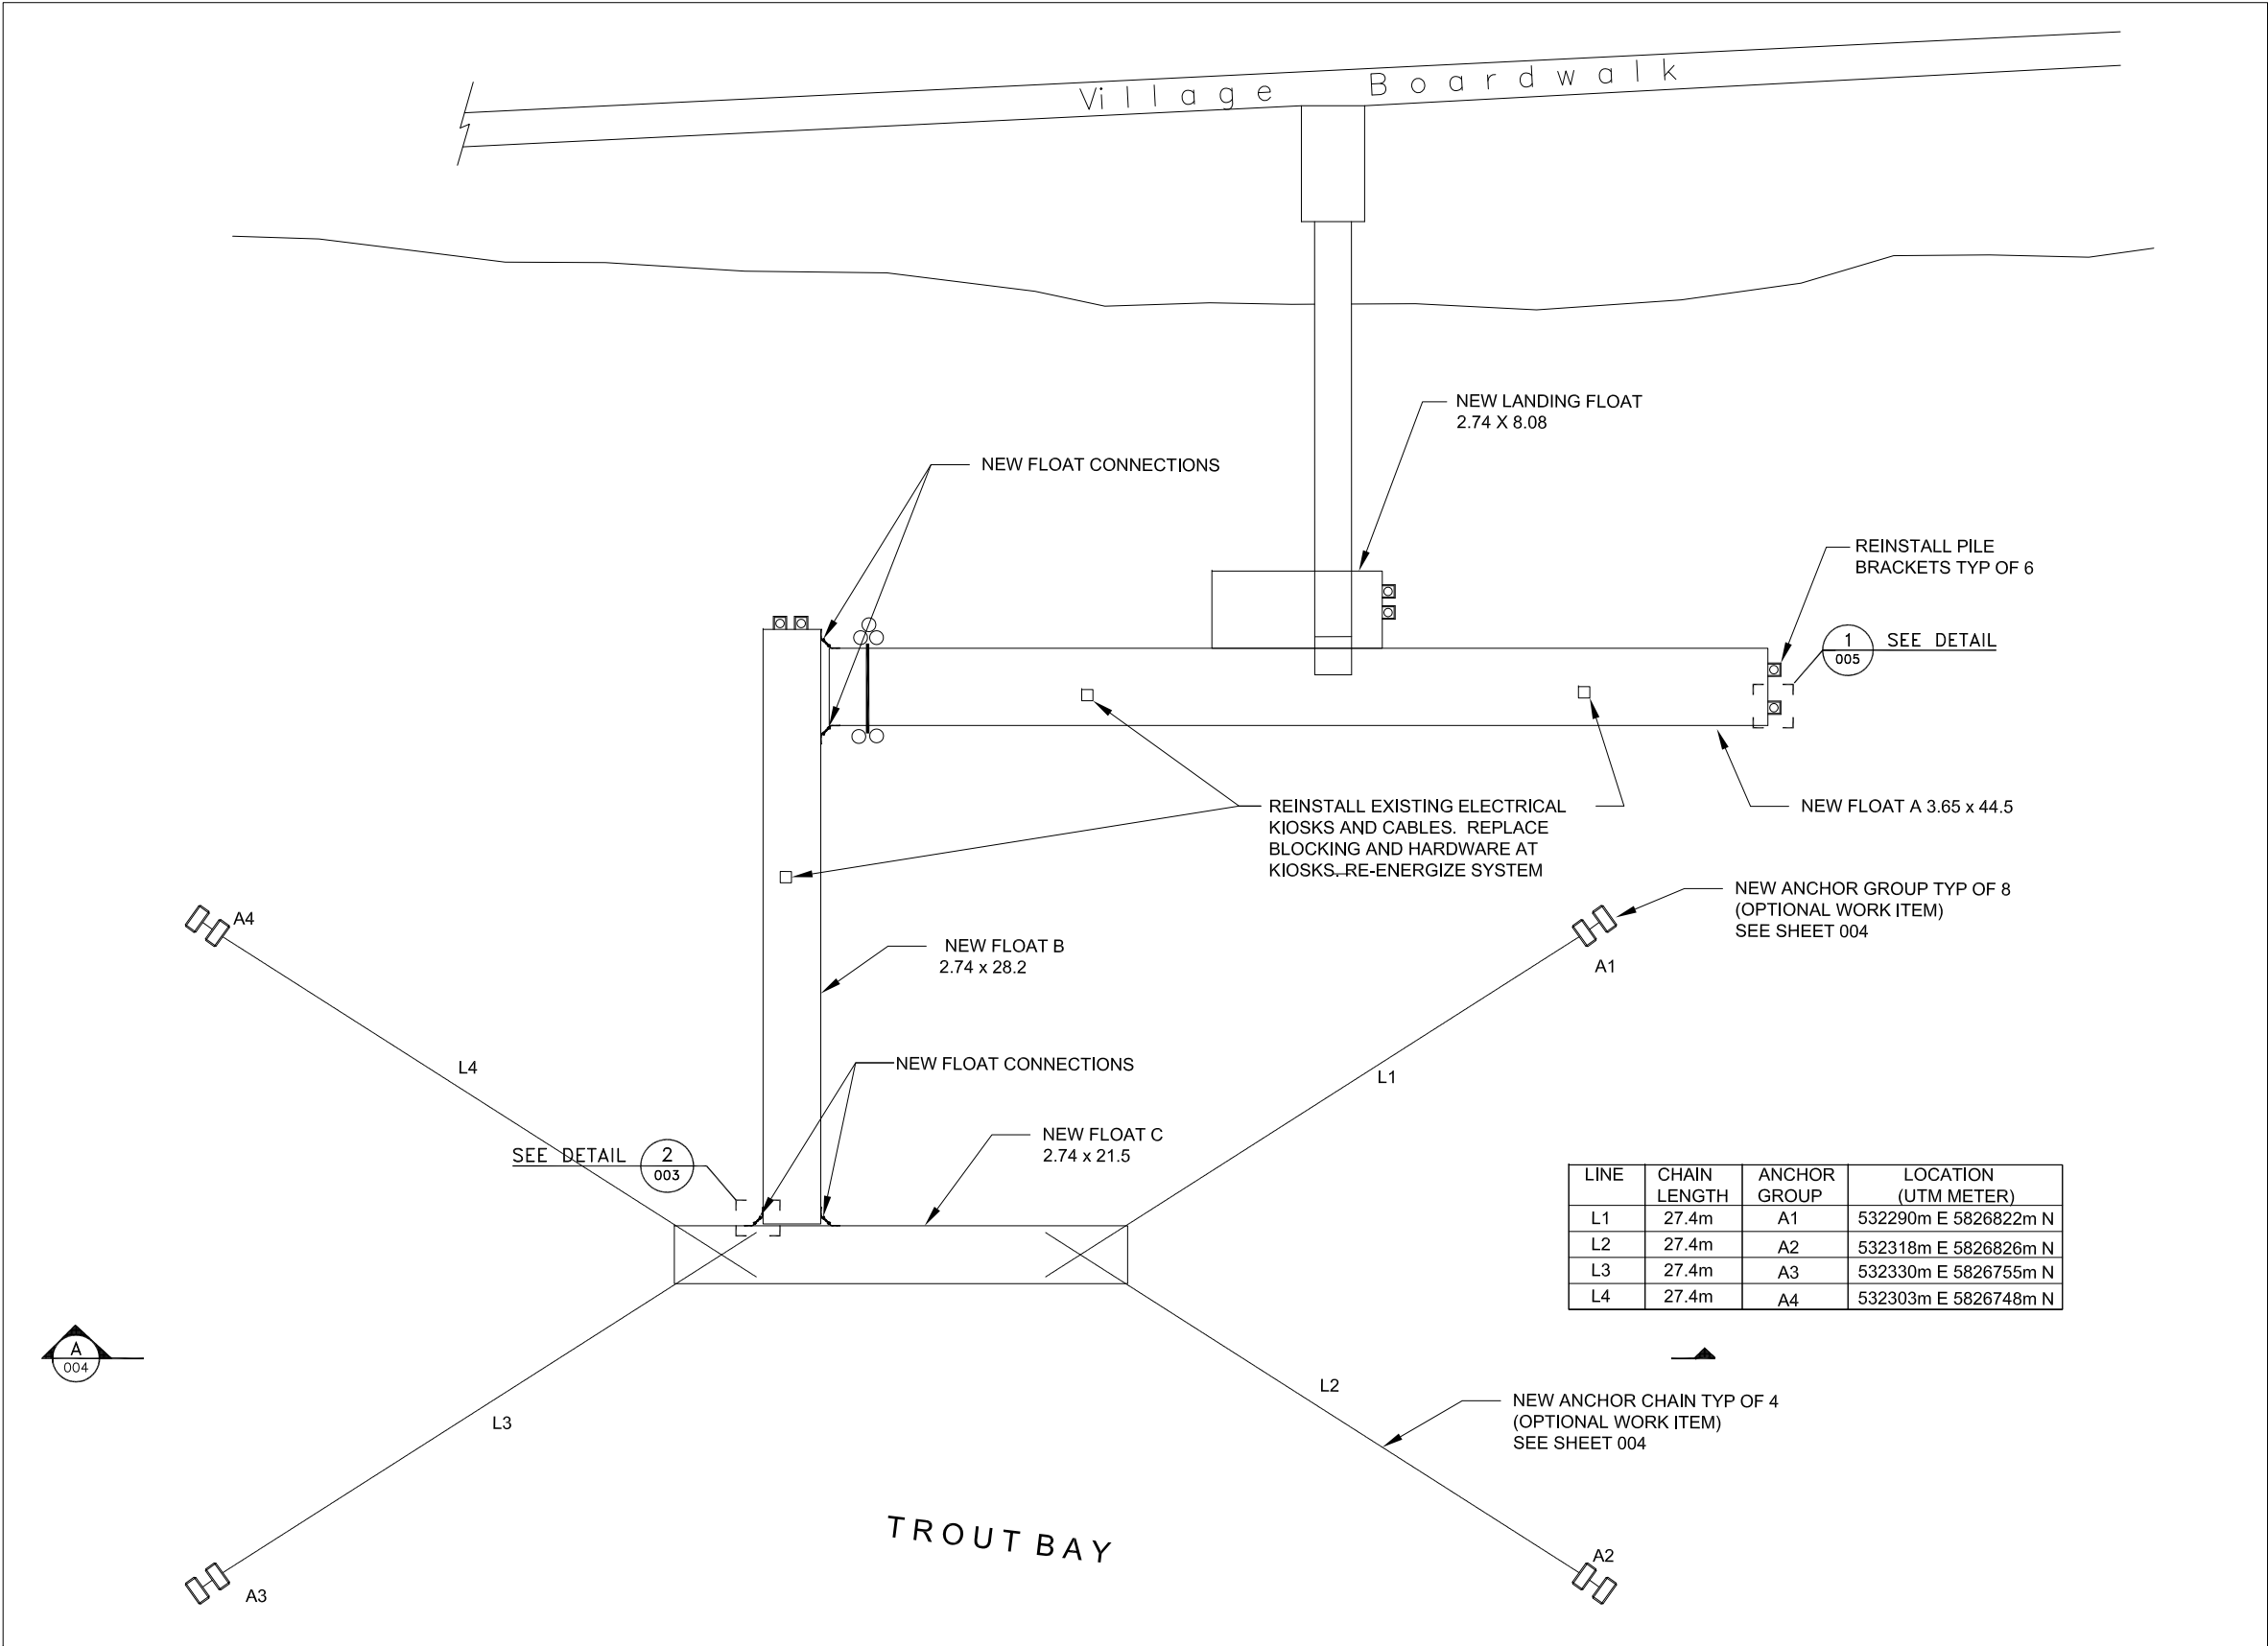
PWGSC, Architectural and Engineering Resources Manager/  
Ressources Architectural et de Directeur d'Ingénierie, TPSCG

Client/client

Drawing title/Titre du dessin

**CONSTRUCTION**  
**GENERAL ARRANGEMENT**

Project No./No. du projet	Sheet/Feuille	Revision no./ La Révision no.
<b>722835-001</b>	<b>002</b> OF	



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Small Craft Harbours Branch  
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Vancouver, Canada, V6C 3S4**

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**KLEMTU HARBOUR**

Approved by/Approuvé par  
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**DJ**

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Client/client


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**FLOAT FRAMING PLAN  
& MOORING SYSTEM ELEVATION**


Project No./No. du projet	Sheet/Feuille	Revision no./ La Révision no.
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**722835-001**


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OF




1 FLOAT A FRAMING AND FLOTATION PLAN

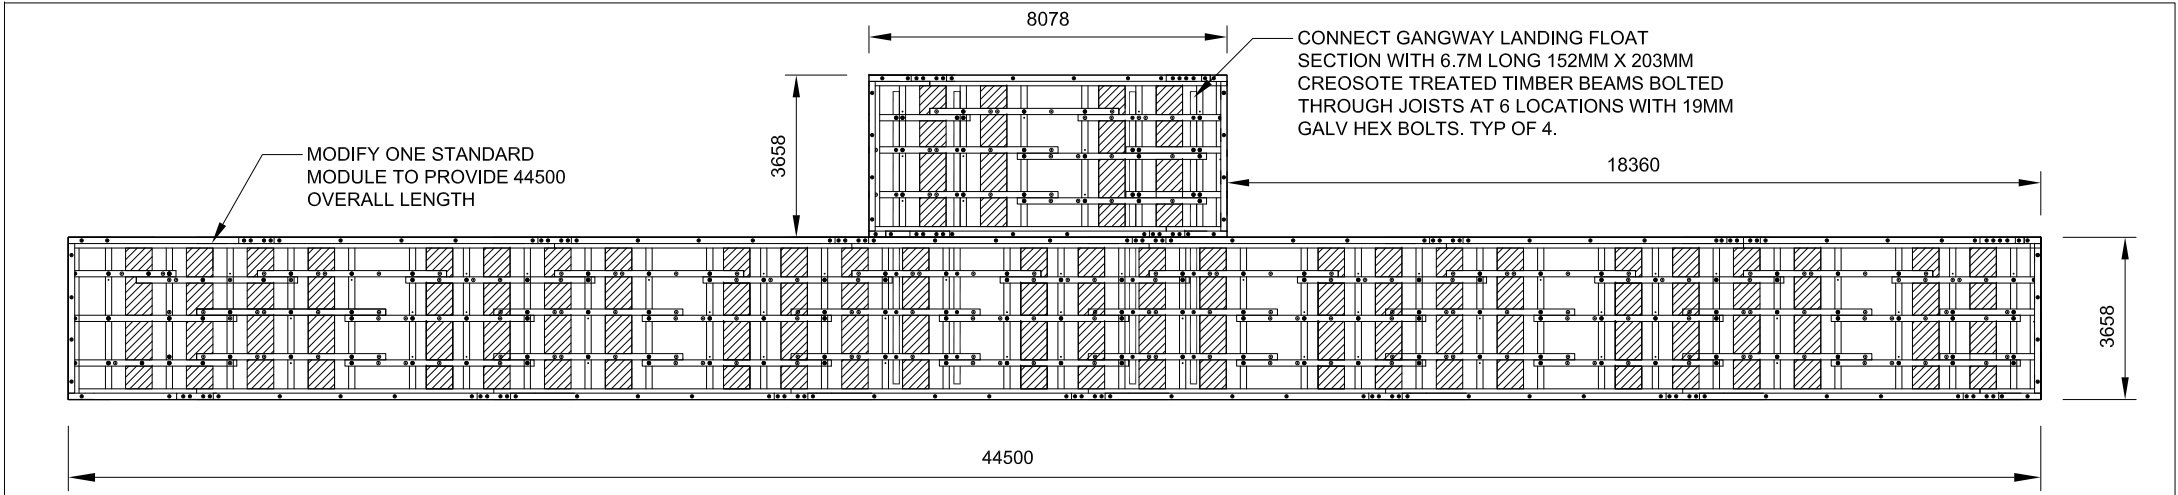

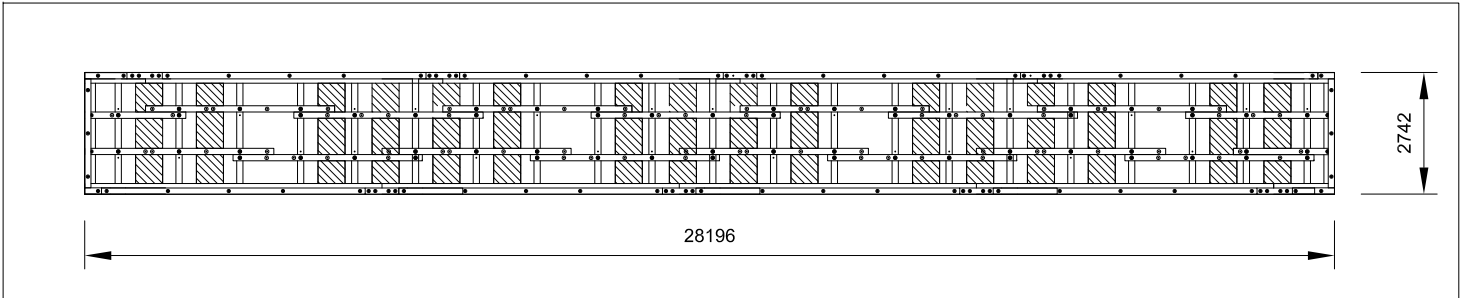2 FLOAT B FRAMING AND FLOTATION PLAN

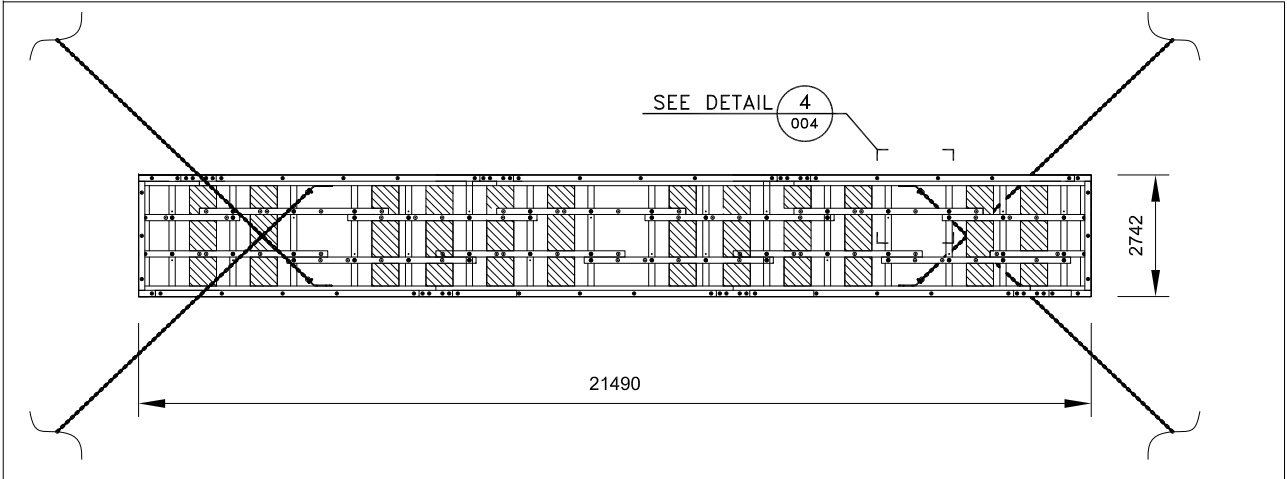


3 FLOAT C FRAMING AND FLOTATION PLAN

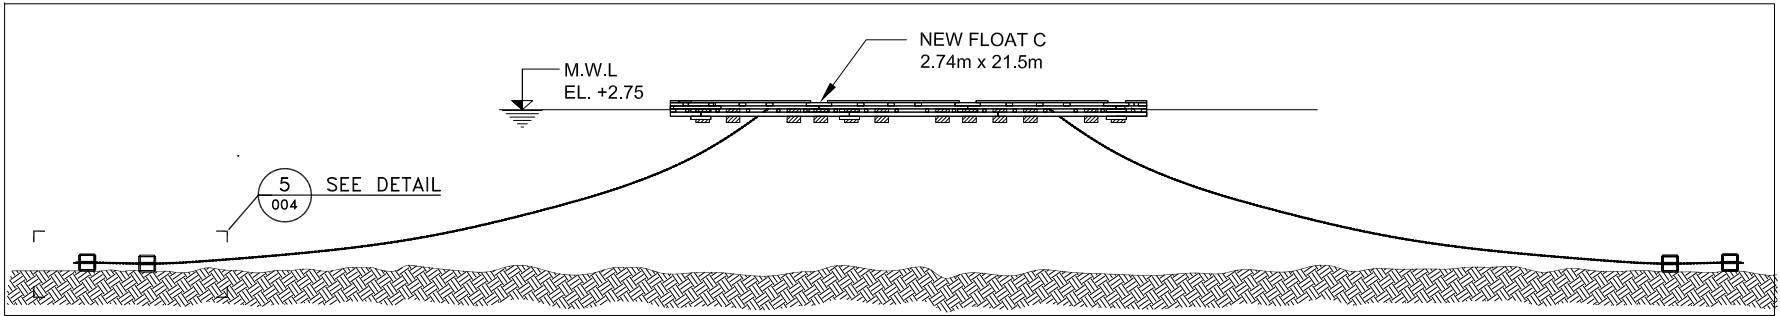


A FLOAT C ANCHORING  
001 SECTION

DRAWING NOTES:  
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CONTRACTOR MUST INSTALL DECKING ON ALL  
OWNER SUPPLIED FLOATS




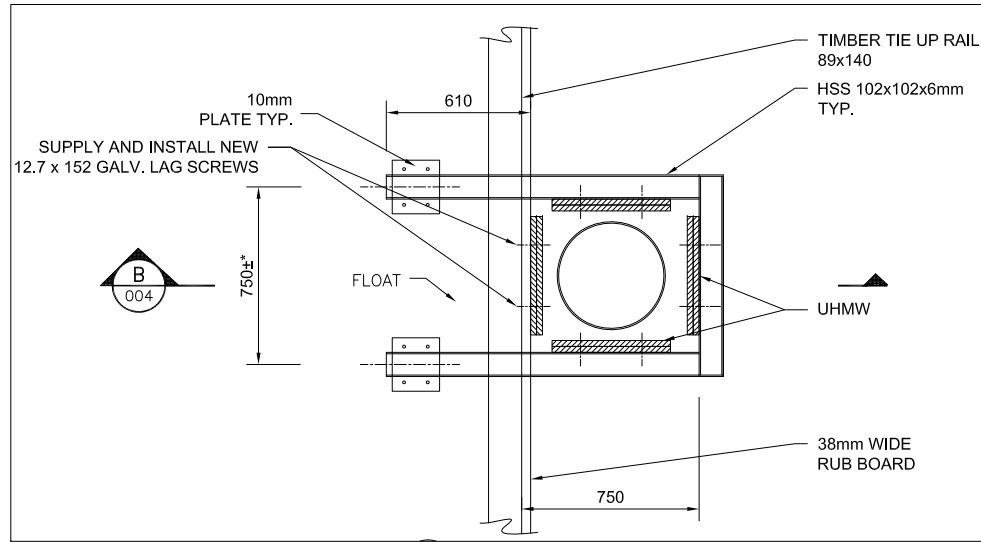


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001 MOORING PILE BRACKET  
DETAIL

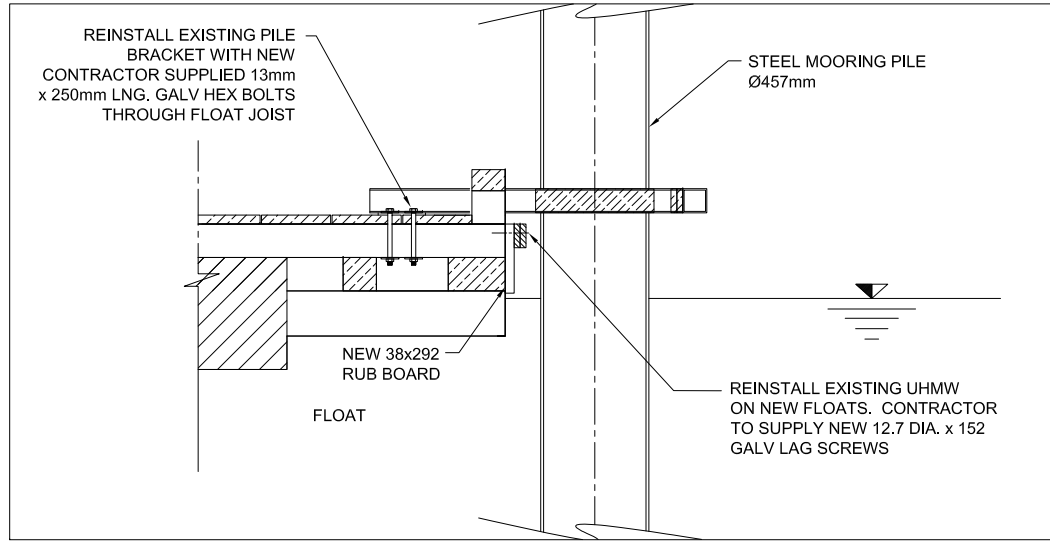


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004 MOORING PILE BRACKET  
SECTION

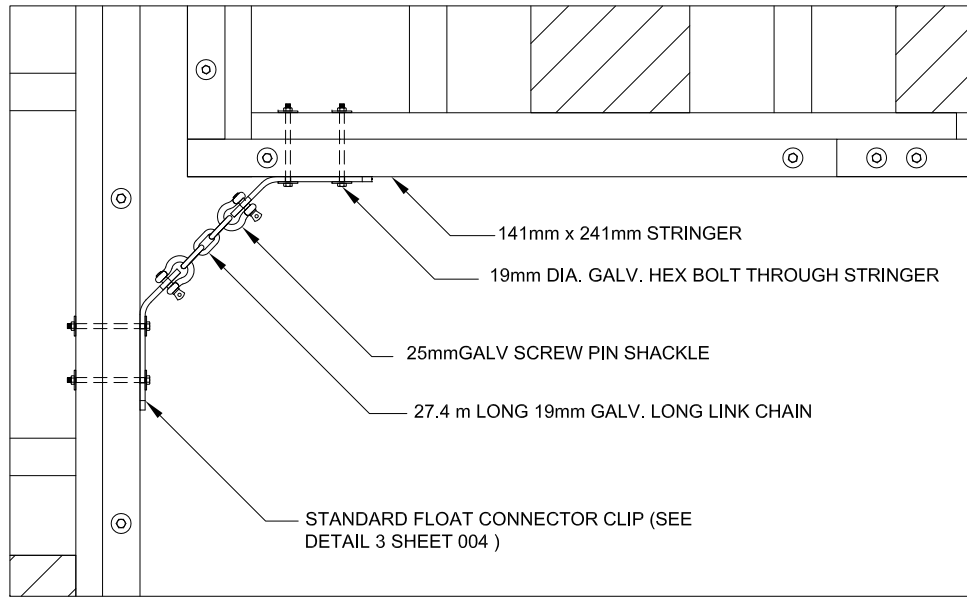


2  
003 FLOAT CONNECTION  
DETAIL

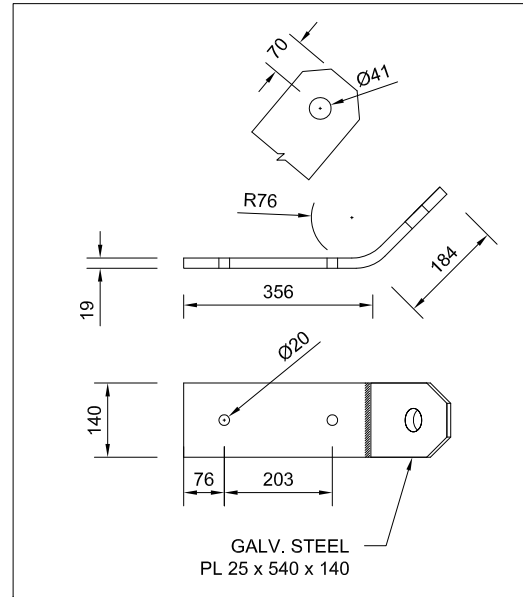

3  
004 FLOAT CONNECTOR CLIP  
DETAIL

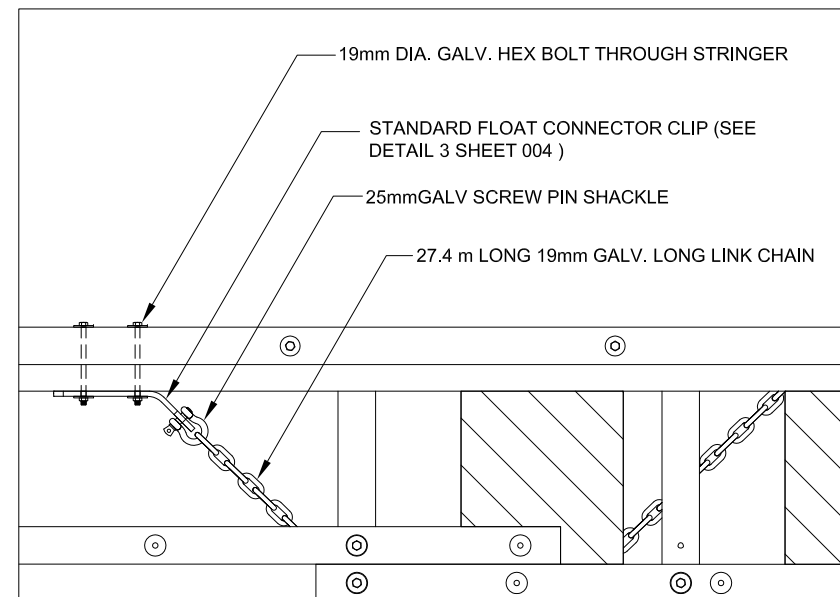

4  
003 ANCHOR CHAIN FLOAT CONNECTION  
DETAIL

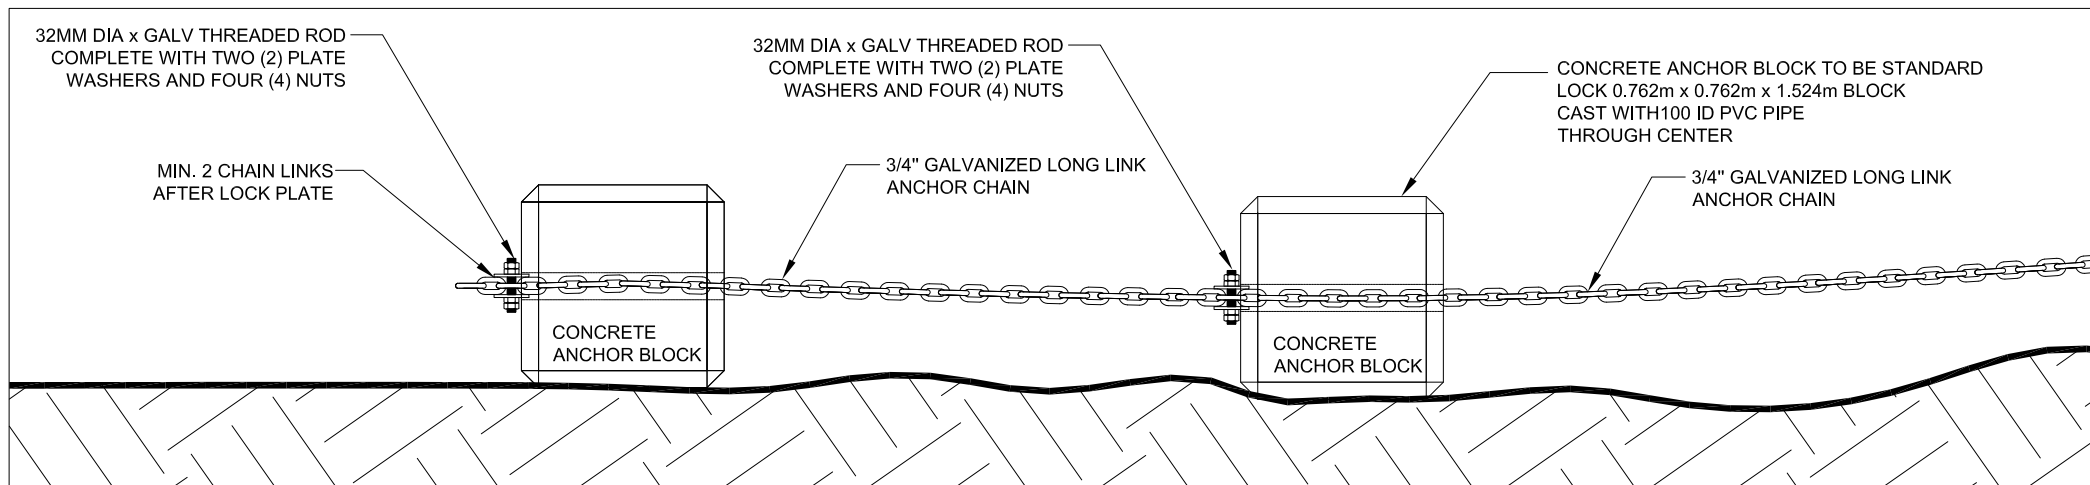

5  
003 ANCHOR CONNECTION  
DETAIL

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Revision/ Revision	Description/Description	Date/Date
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Small Craft Harbours Branch  
Pacific Division**

**200 - 401 Burrard Street  
Vancouver, Canada, V6C 3S4**

Project title/Titre du projet

**KLEMTU HARBOUR**

Approved by/Approuvé par  
**D.B.**

Designed by/Concept par  
**D.J.**

Drawn by/Dessiné par  
**D.J.**

PWGC Project Manager/Administrateur de Projets TPSC

PWGC, Architectural and Engineering Resources Manager/  
Ressources Architectural et de Directeur d'Ingénierie, TPSC


Client/client

Drawing title/Titre du dessin

**DETAILS**

Project No./No. du projet	Sheet/Feuille	Revision no./ La Révision no.
<b>722835-001</b>	<b>004</b> OF	



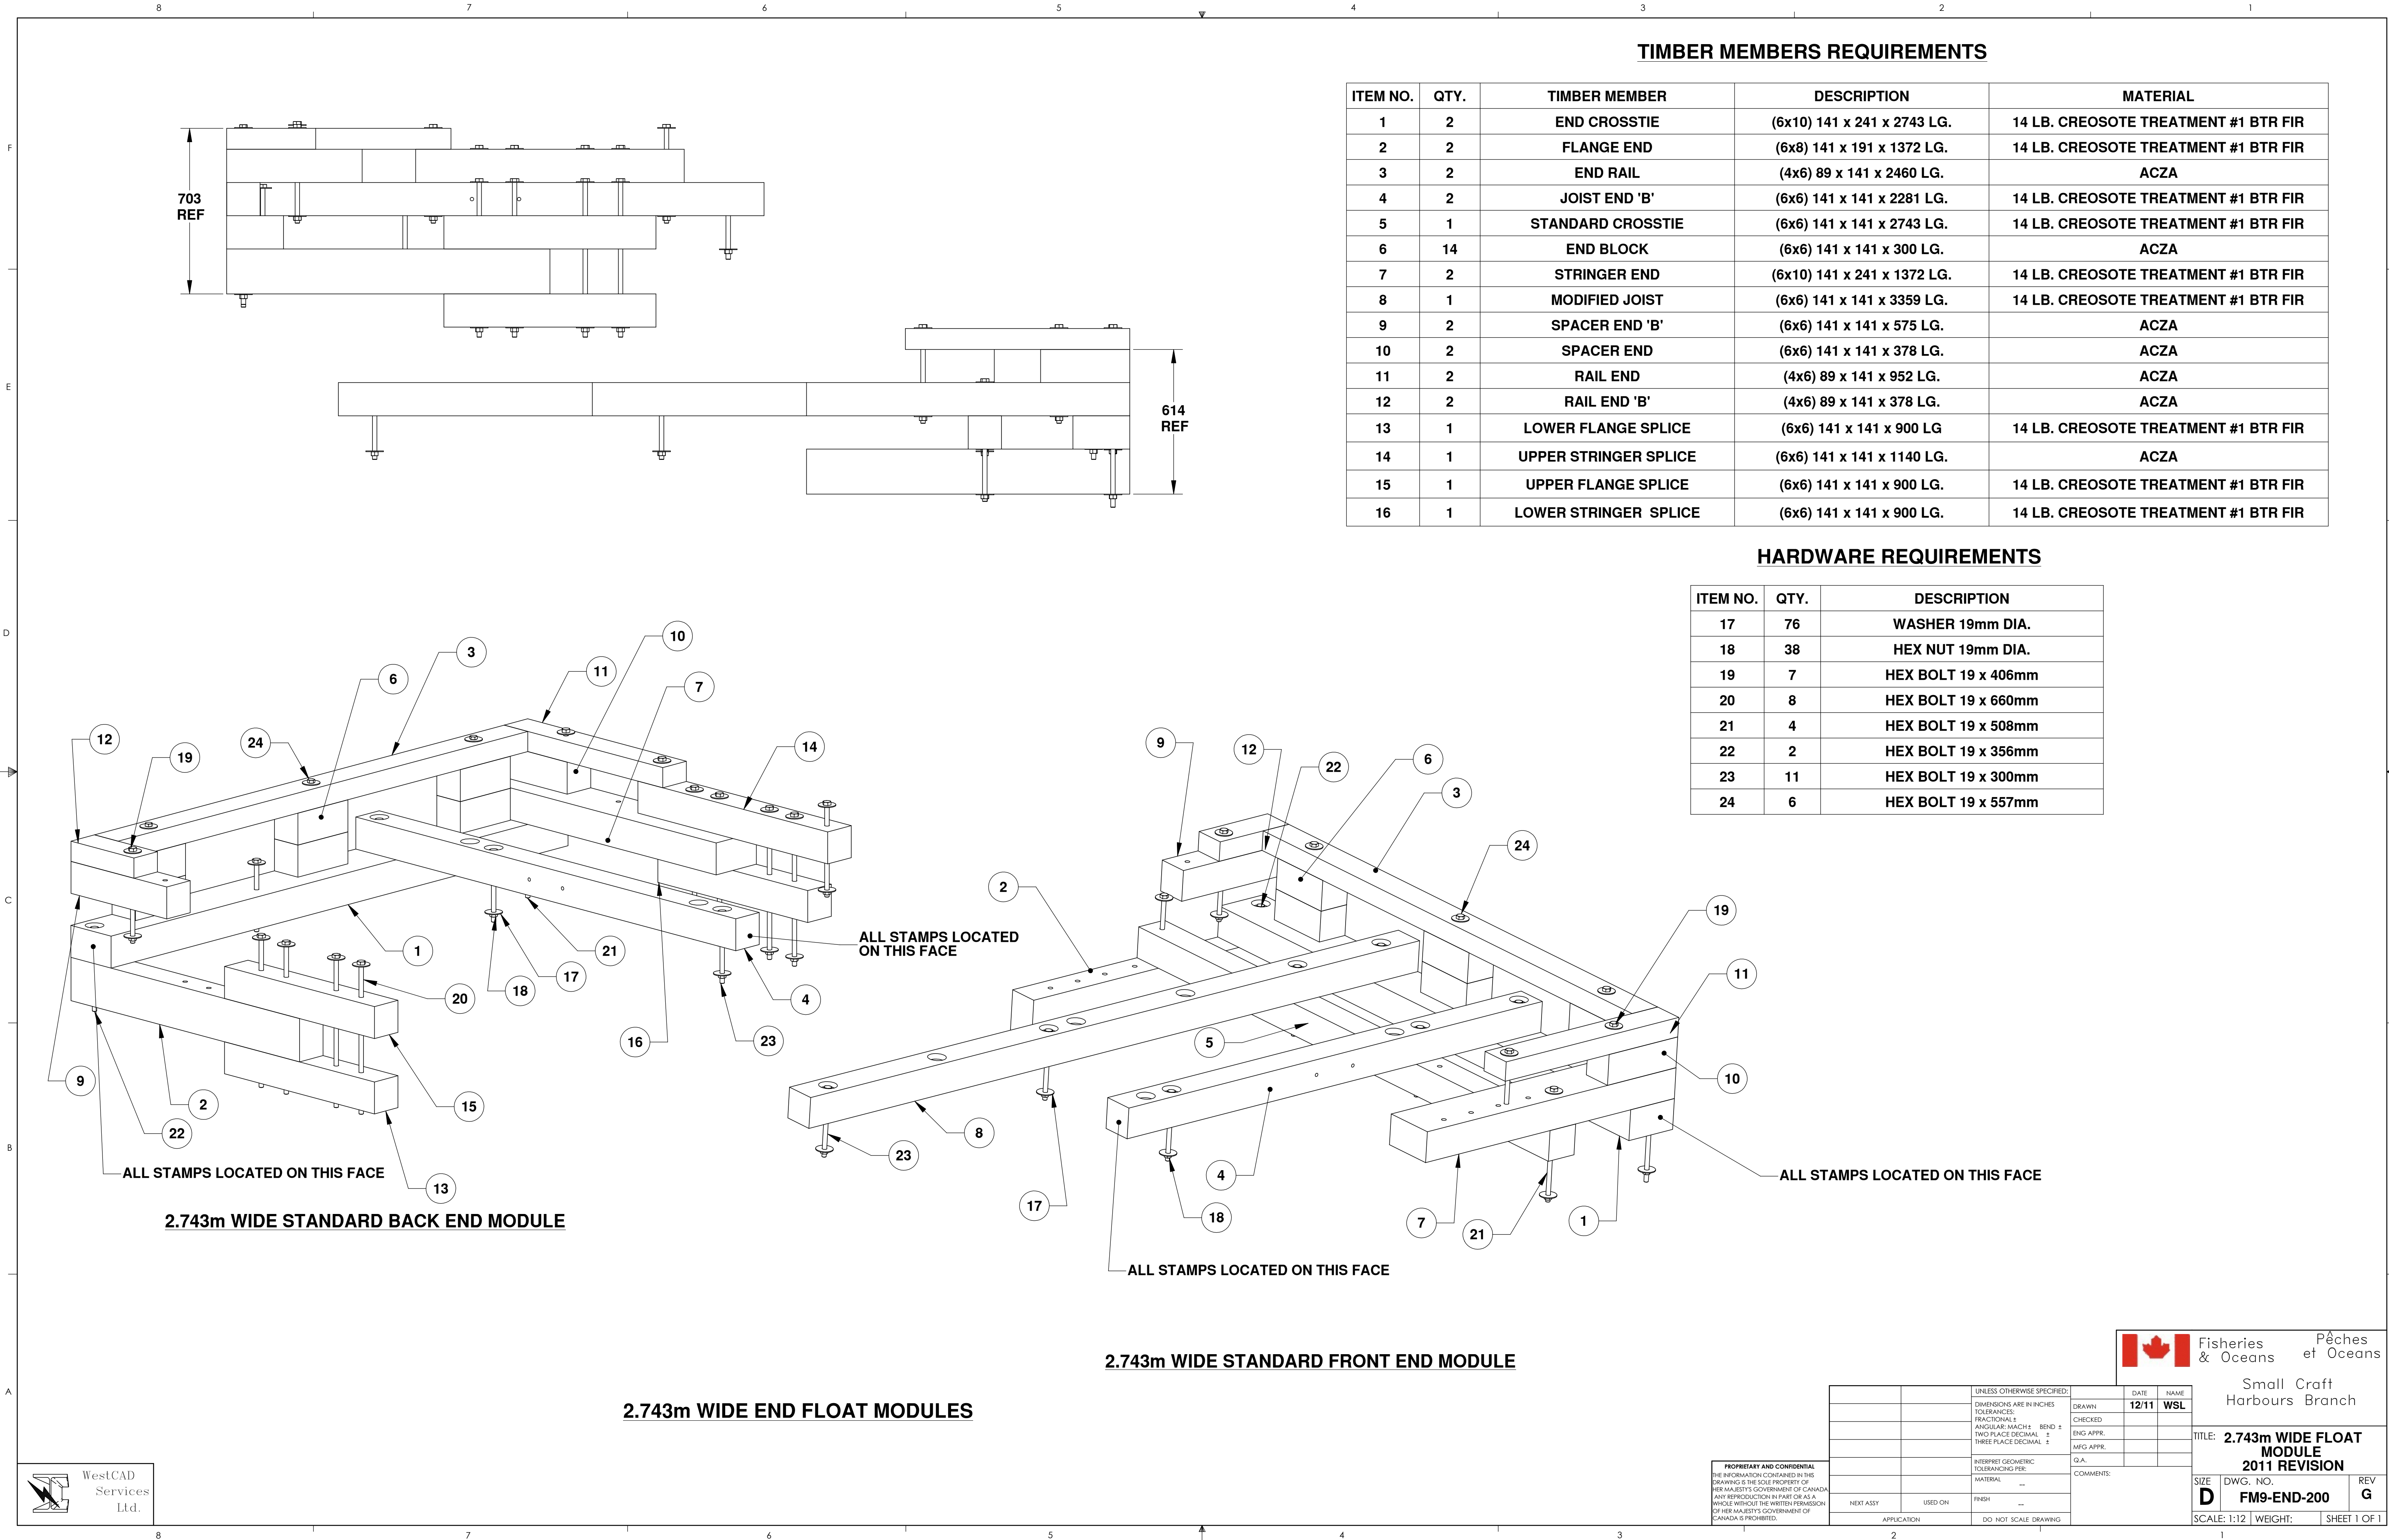


TIMBER MEMBERS REQUIREMENTS

ITEM NO.	QTY.	TIMBER MEMBER	DESCRIPTION	MATERIAL
1	2	END CROSSTIE	(6x10) 141 x 241 x 2743 LG.	14 LB. CREOSOTE TREATMENT #1 BTR FIR
2	2	FLANGE END	(6x8) 141 x 191 x 1372 LG.	14 LB. CREOSOTE TREATMENT #1 BTR FIR
3	2	END RAIL	(4x6) 89 x 141 x 2460 LG.	ACZA
4	2	JOIST END 'B'	(6x6) 141 x 141 x 2281 LG.	14 LB. CREOSOTE TREATMENT #1 BTR FIR
5	1	STANDARD CROSSTIE	(6x6) 141 x 141 x 2743 LG.	14 LB. CREOSOTE TREATMENT #1 BTR FIR
6	14	END BLOCK	(6x6) 141 x 141 x 300 LG.	ACZA
7	2	STRINGER END	(6x10) 141 x 241 x 1372 LG.	14 LB. CREOSOTE TREATMENT #1 BTR FIR
8	1	MODIFIED JOIST	(6x6) 141 x 141 x 3359 LG.	14 LB. CREOSOTE TREATMENT #1 BTR FIR
9	2	SPACER END 'B'	(6x6) 141 x 141 x 575 LG.	ACZA
10	2	SPACER END	(6x6) 141 x 141 x 378 LG.	ACZA
11	2	RAIL END	(4x6) 89 x 141 x 952 LG.	ACZA
12	2	RAIL END 'B'	(4x6) 89 x 141 x 378 LG.	ACZA
13	1	LOWER FLANGE SPLICE	(6x6) 141 x 141 x 900 LG	14 LB. CREOSOTE TREATMENT #1 BTR FIR
14	1	UPPER STRINGER SPLICE	(6x6) 141 x 141 x 1140 LG.	ACZA
15	1	UPPER FLANGE SPLICE	(6x6) 141 x 141 x 900 LG.	14 LB. CREOSOTE TREATMENT #1 BTR FIR
16	1	LOWER STRINGER SPLICE	(6x6) 141 x 141 x 900 LG.	14 LB. CREOSOTE TREATMENT #1 BTR FIR

HARDWARE REQUIREMENTS

ITEM NO.	QTY.	DESCRIPTION
17	76	WASHER 19mm DIA.
18	38	HEX NUT 19mm DIA.
19	7	HEX BOLT 19 x 406mm
20	8	HEX BOLT 19 x 660mm
21	4	HEX BOLT 19 x 508mm
22	2	HEX BOLT 19 x 356mm
23	11	HEX BOLT 19 x 300mm
24	6	HEX BOLT 19 x 557mm

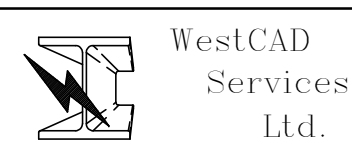



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DIMENSIONS ARE IN INCHES	DRAWN	12/11	WSL
TOLERANCES:	CHECKED		
FRACTIONAL: ±	ENG APPR.		
ANGULAR: MATCH ±	MFG APPR.		
BEND: ±			
TWO PLACE DECIMAL: ±			
THREE PLACE DECIMAL: ±			
INTERPRET GEOMETRIC TOLERANCING PER:	COMMENTS:		
MATERIAL: --			
FINISH: --			
NEXT ASSY:	USED ON:		
APPLICATION	DO NOT SCALE DRAWING		

 Fisheries & Oceans Pêches et Océans  
Small Craft Harbours Branch


TITLE: 2.743m WIDE FLOAT MODULE 2011 REVISION			
SIZE: D	DWG. NO. FM9-END-200	REV: G	
SCALE: 1:12	WEIGHT:	SHEET 1 OF 1	



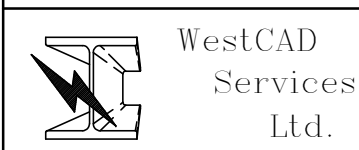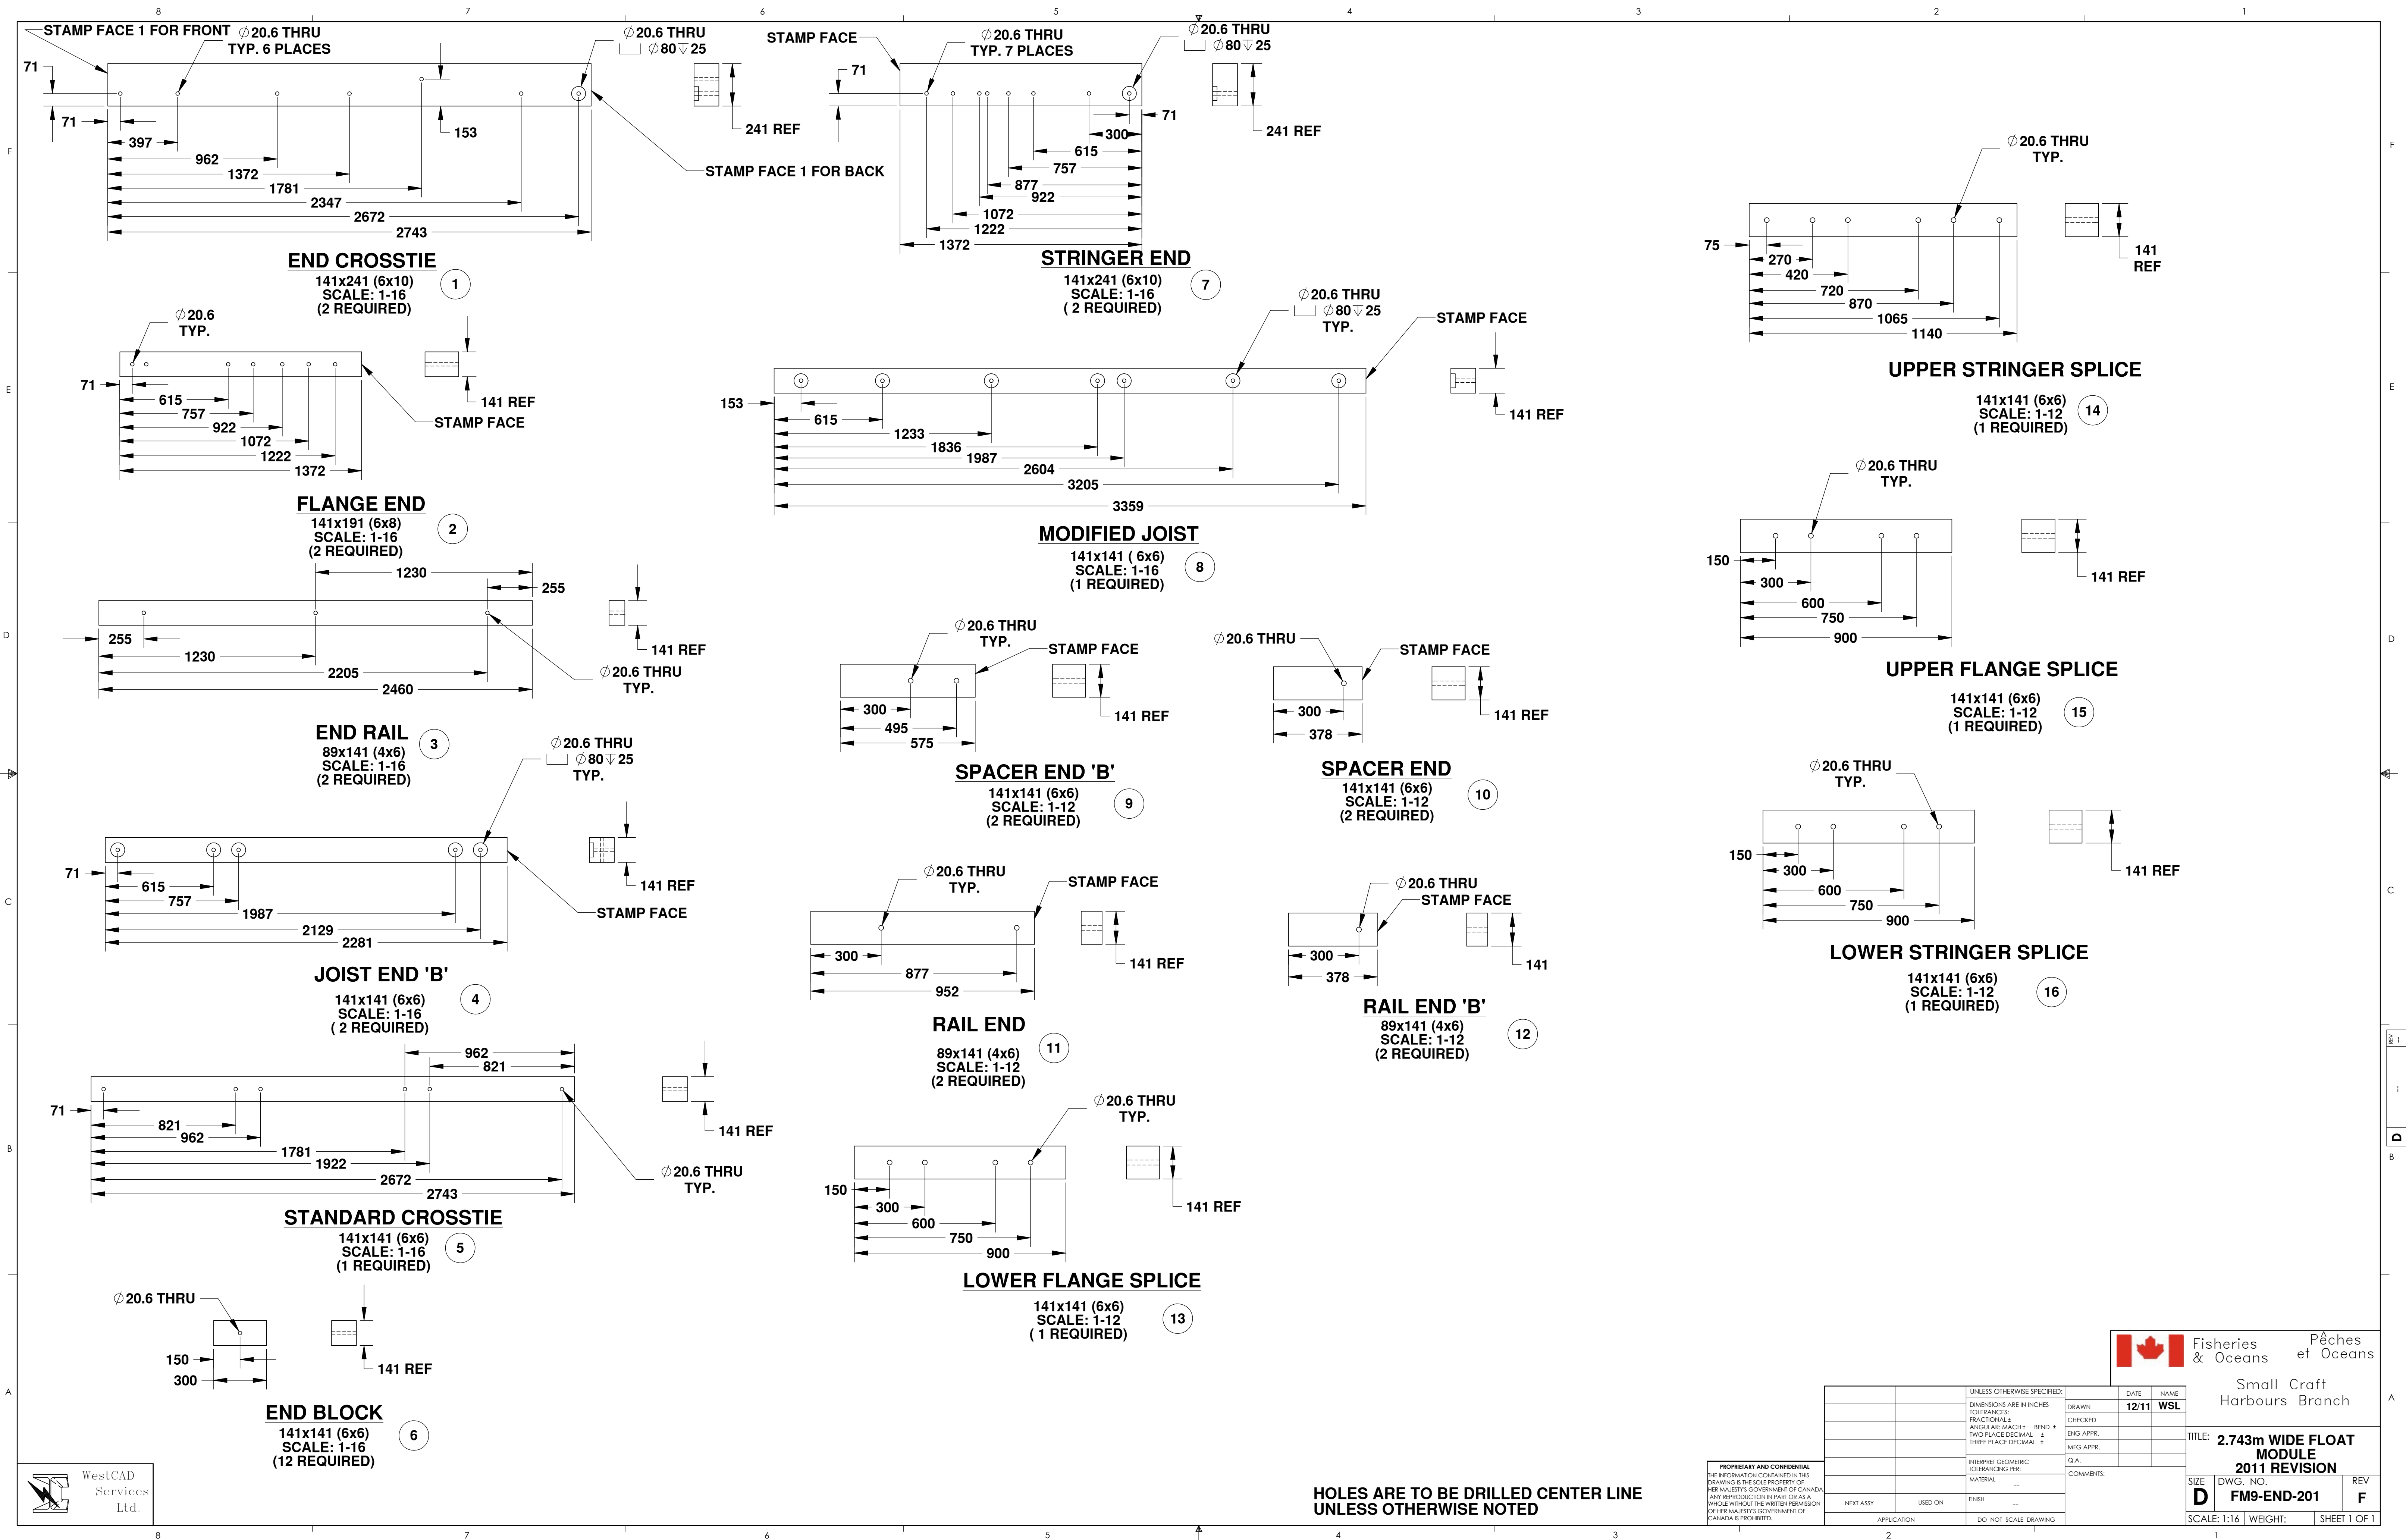


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TOLERANCES:	CHECKED		
FRACTIONAL: ±	ENG APPR.		
ANGULAR: MATCH ±	MFG APPR.		
BEND ±			
TWO PLACE DECIMAL ±			
THREE PLACE DECIMAL ±			
INTERPRET GEOMETRIC TOLERANCING PER:	COMMENTS:		
MATERIAL: --			
FINISH: --			
NEXT ASSY:	USED ON:		
APPLICATION:	DO NOT SCALE DRAWING		

 Fisheries & Oceans  
Pêches et Océans  
Small Craft Harbours Branch

TITLE: 2.743m WIDE FLOAT MODULE 2011 REVISION		
SIZE: D	DWG. NO.: FM9-END-201	REV: F
SCALE: 1:16	WEIGHT:	SHEET 1 OF 1

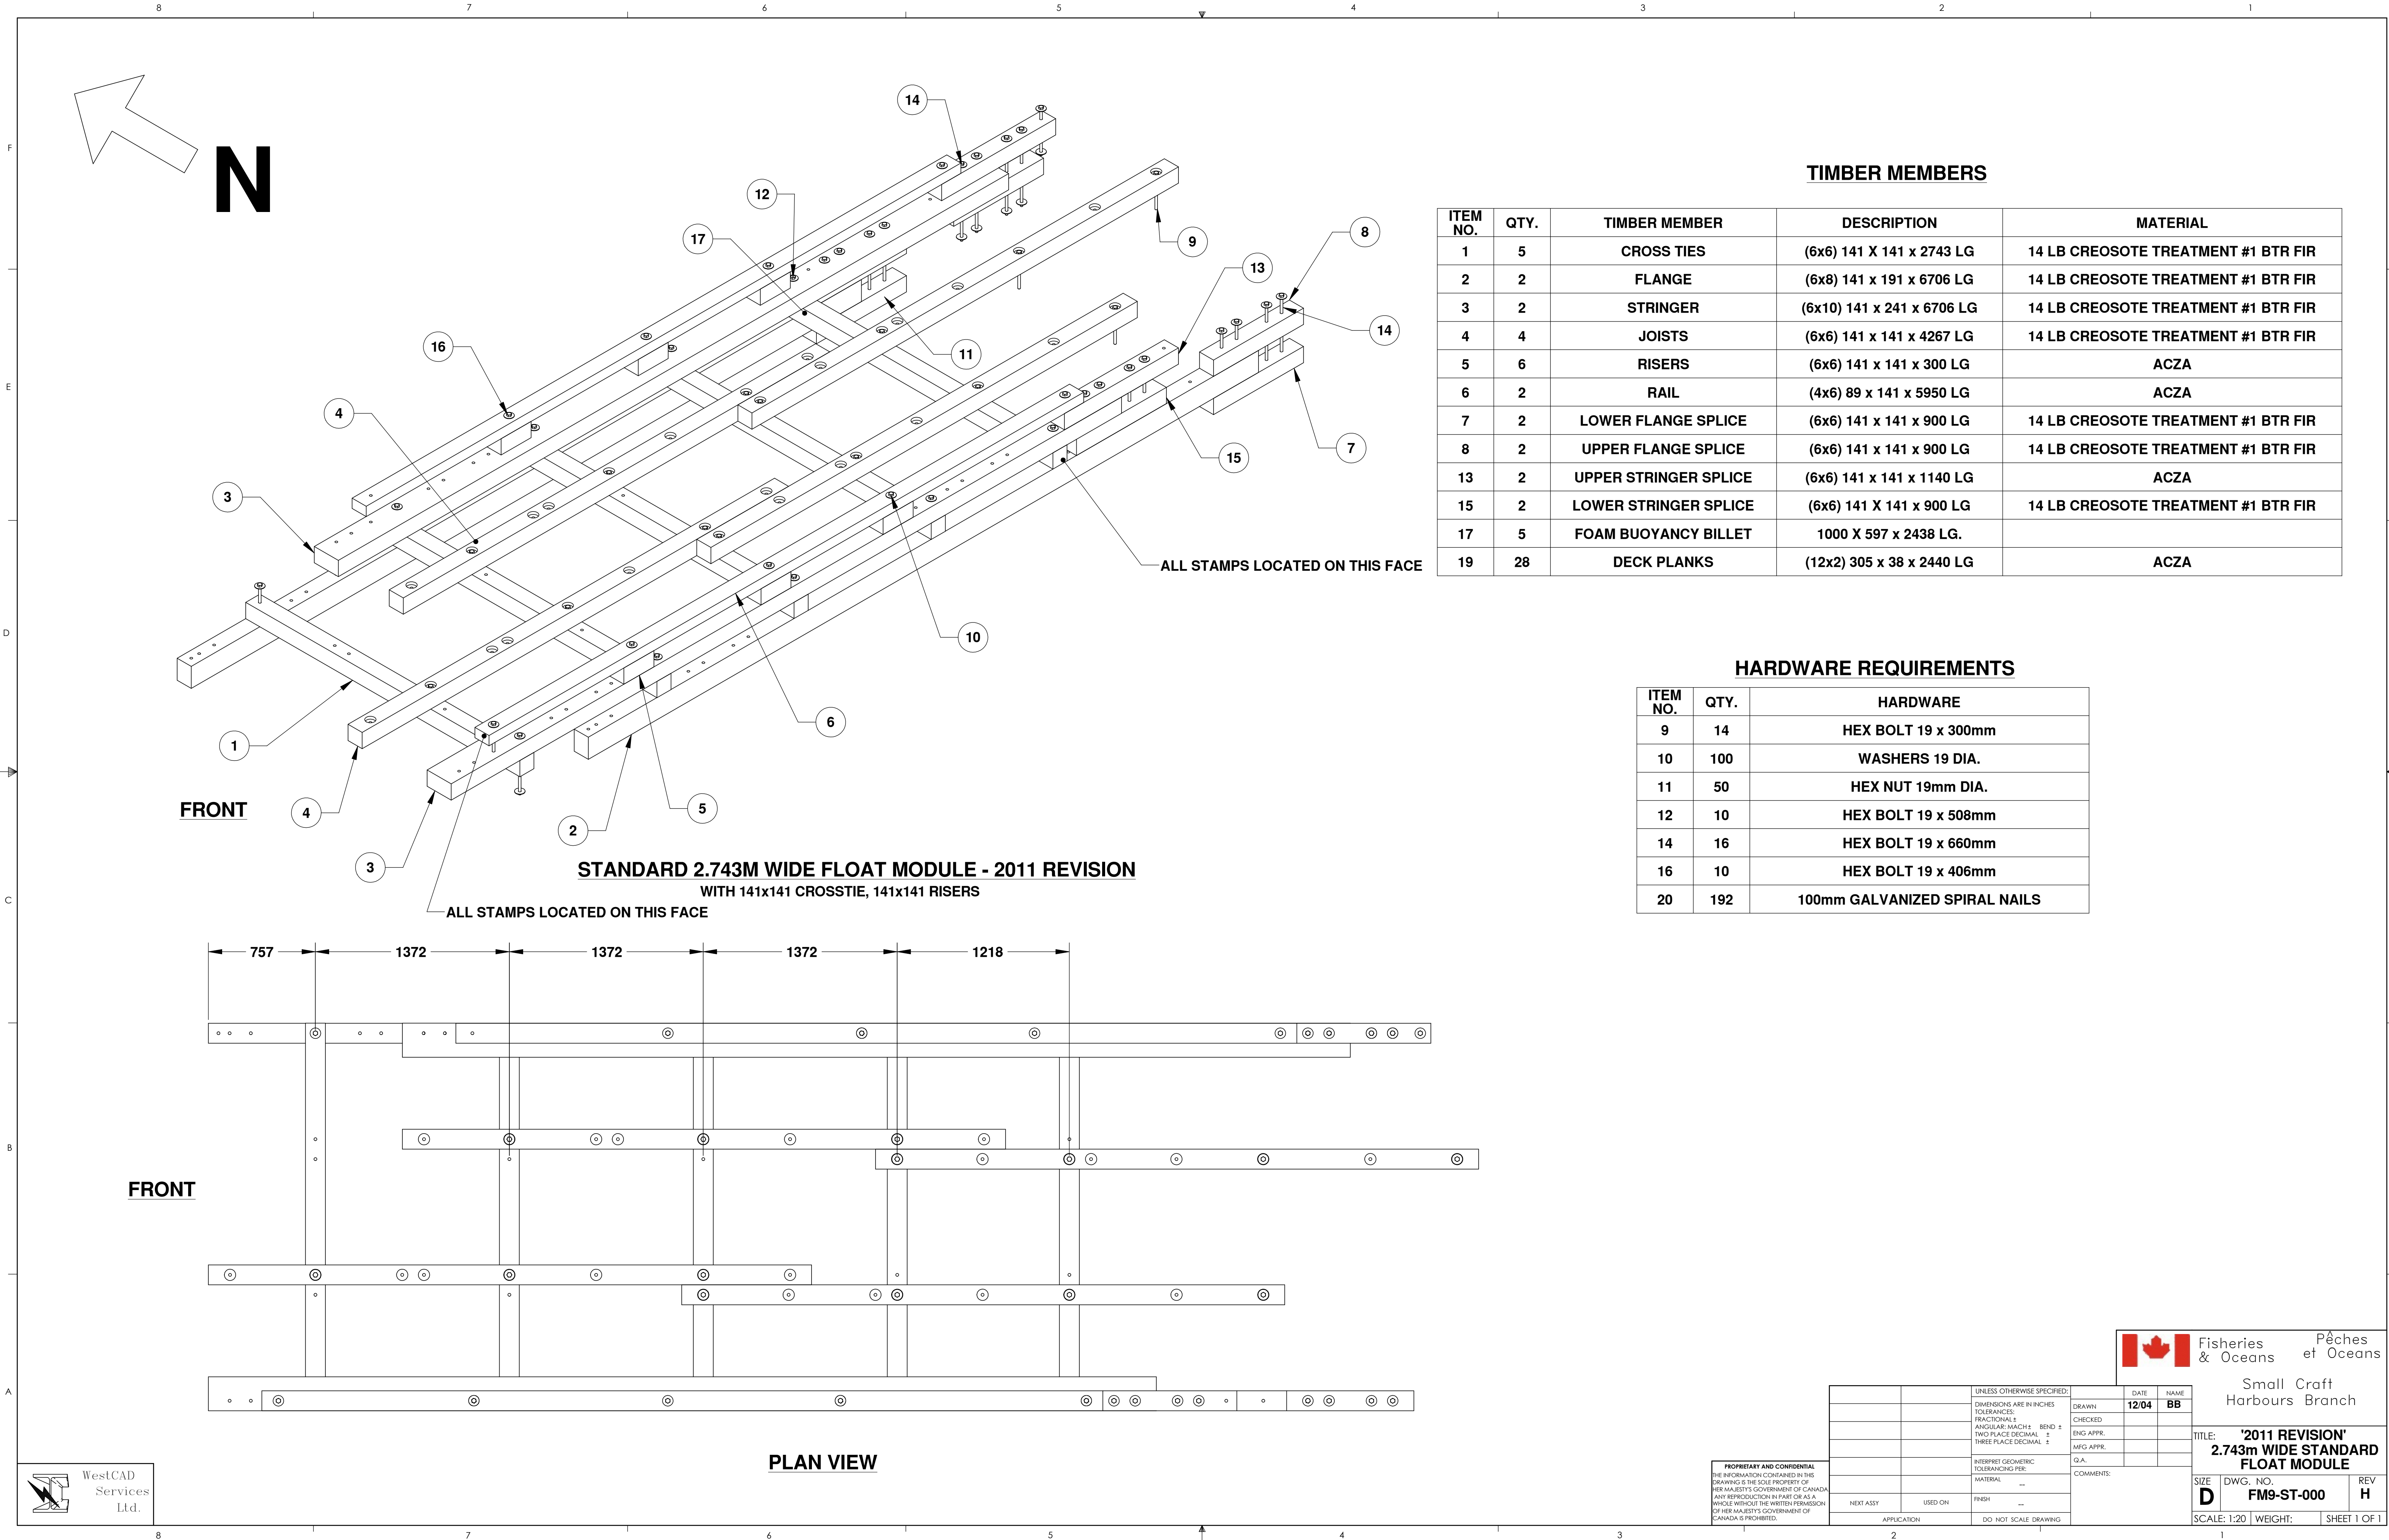


TIMBER MEMBERS

ITEM NO.	QTY.	TIMBER MEMBER	DESCRIPTION	MATERIAL
1	5	CROSS TIES	(6x6) 141 X 141 x 2743 LG	14 LB CREOSOTE TREATMENT #1 BTR FIR
2	2	FLANGE	(6x8) 141 x 191 x 6706 LG	14 LB CREOSOTE TREATMENT #1 BTR FIR
3	2	STRINGER	(6x10) 141 x 241 x 6706 LG	14 LB CREOSOTE TREATMENT #1 BTR FIR
4	4	JOISTS	(6x6) 141 x 141 x 4267 LG	14 LB CREOSOTE TREATMENT #1 BTR FIR
5	6	RISERS	(6x6) 141 x 141 x 300 LG	ACZA
6	2	RAIL	(4x6) 89 x 141 x 5950 LG	ACZA
7	2	LOWER FLANGE SPLICE	(6x6) 141 x 141 x 900 LG	14 LB CREOSOTE TREATMENT #1 BTR FIR
8	2	UPPER FLANGE SPLICE	(6x6) 141 x 141 x 900 LG	14 LB CREOSOTE TREATMENT #1 BTR FIR
13	2	UPPER STRINGER SPLICE	(6x6) 141 x 141 x 1140 LG	ACZA
15	2	LOWER STRINGER SPLICE	(6x6) 141 X 141 x 900 LG	14 LB CREOSOTE TREATMENT #1 BTR FIR
17	5	FOAM BUOYANCY BILLET	1000 X 597 x 2438 LG.	
19	28	DECK PLANKS	(12x2) 305 x 38 x 2440 LG	ACZA


HARDWARE REQUIREMENTS

ITEM NO.	QTY.	HARDWARE
9	14	HEX BOLT 19 x 300mm
10	100	WASHERS 19 DIA.
11	50	HEX NUT 19mm DIA.
12	10	HEX BOLT 19 x 508mm
14	16	HEX BOLT 19 x 660mm
16	10	HEX BOLT 19 x 406mm
20	192	100mm GALVANIZED SPIRAL NAILS

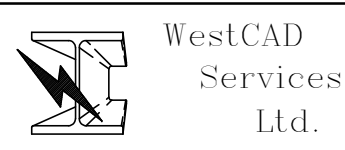

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		UNLESS OTHERWISE SPECIFIED: DIMENSIONS ARE IN INCHES TOLERANCES: FRACTIONAL ± ANGULAR: MAX ± 1/2 DEG TWO PLACE DECIMAL ± THREE PLACE DECIMAL ±	DRAWN CHECKED ENG APPR. MFG APPR.	DATE 12/04	NAME BB
		INTERPRET GEOMETRIC TOLERANCING PER: MATERIAL: -- FINISH: --			
NEXT ASSY	USED ON				
APPLICATION		DO NOT SCALE DRAWING			



Fisheries & OceansPêches et Océans

Small Craft Harbours Branch

TITLE:

'2011 REVISION'

2.743m WIDE STANDARD FLOAT MODULE

SIZE: D

DWG. NO.: FM9-ST-000

REV: H

SCALE: 1:20


WEIGHT:

SHEET 1 OF 1








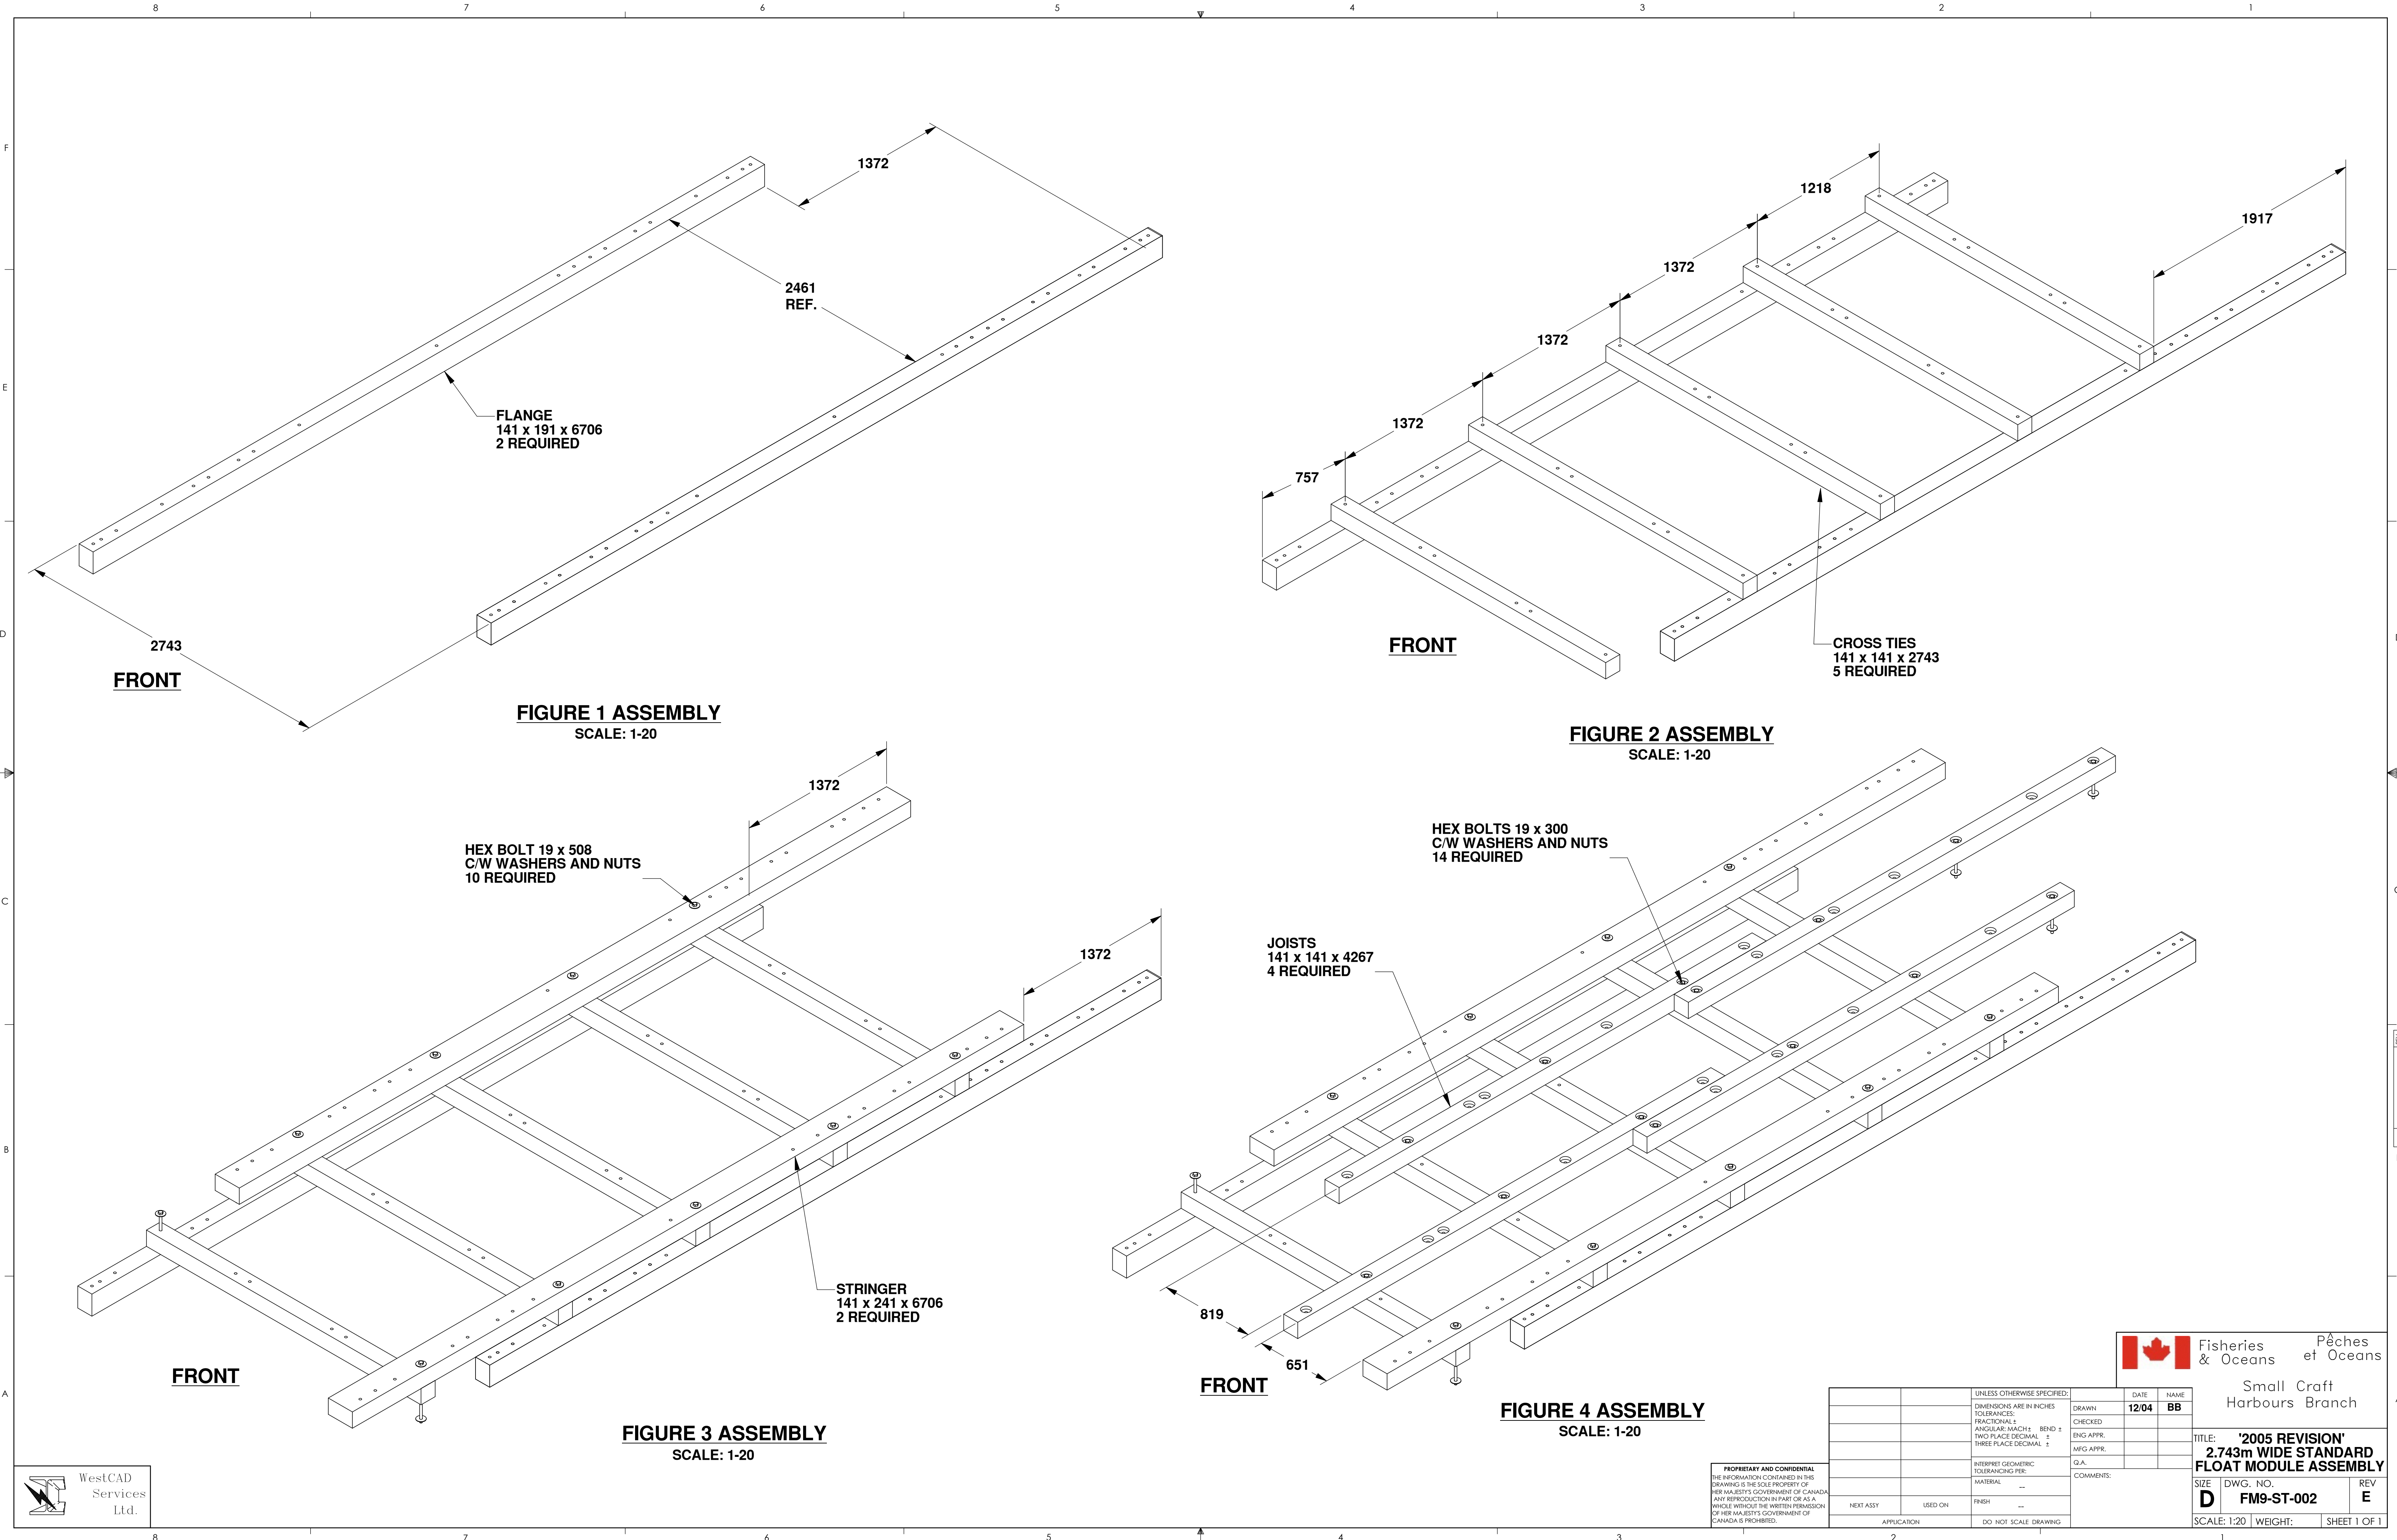


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		INTERPRET GEOMETRIC TOLERANCING PER: MATERIAL FINISH			
NEXT ASSY	USED ON	APPLICATION			
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		UNLESS OTHERWISE SPECIFIED:	DATE	NAME
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		TOLERANCES:		
		FRACTIONAL ±	CHECKED	
		ANGULAR: MACH ±	ENG APPR.	
		TWO PLACE DECIMAL ±	MFG APPR.	
		THREE PLACE DECIMAL ±	G.A.	
		INTERPRET GEOMETRIC	COMMENTS:	
		TOLERANCING PER:		
		MATERIAL		
		FINISH		
NEXT ASSY	USED ON	APPLICATION		
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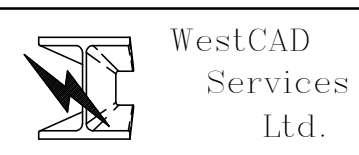
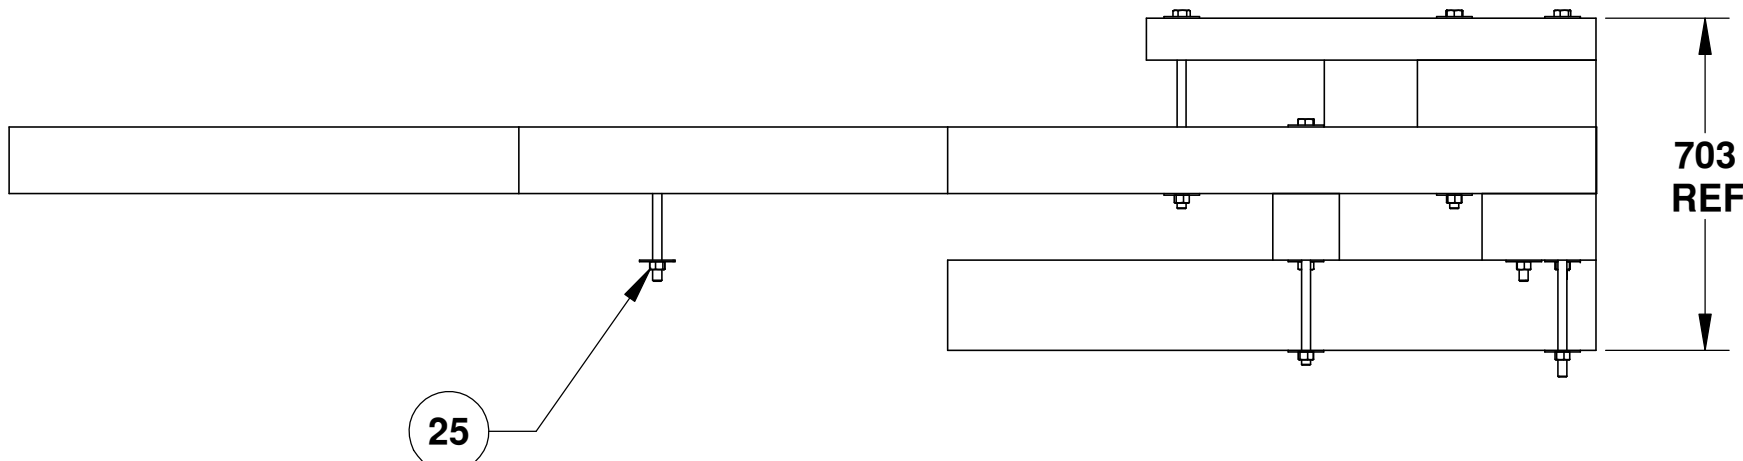
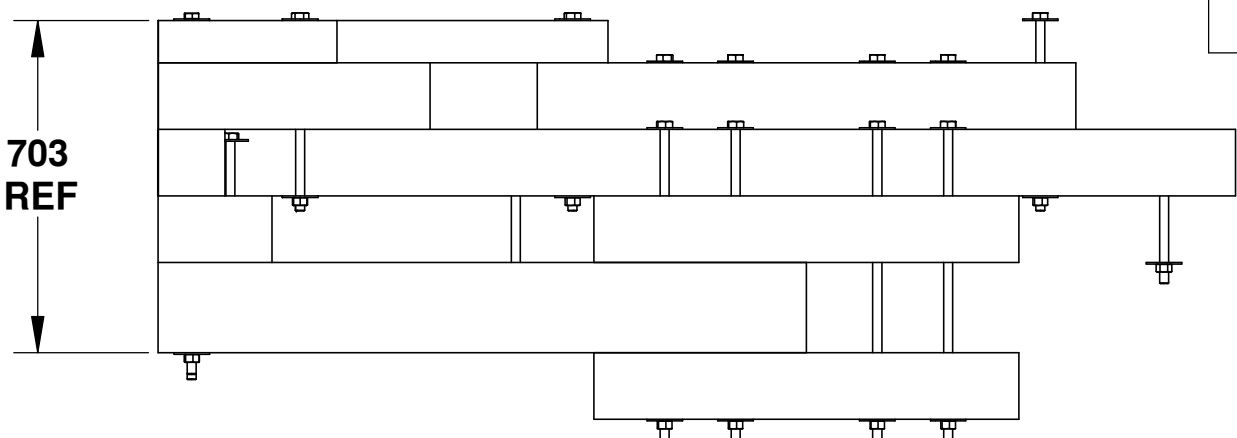
3.65m WIDE FLOAT END MODULES

TIMBER MEMBER REQUIREMENTS

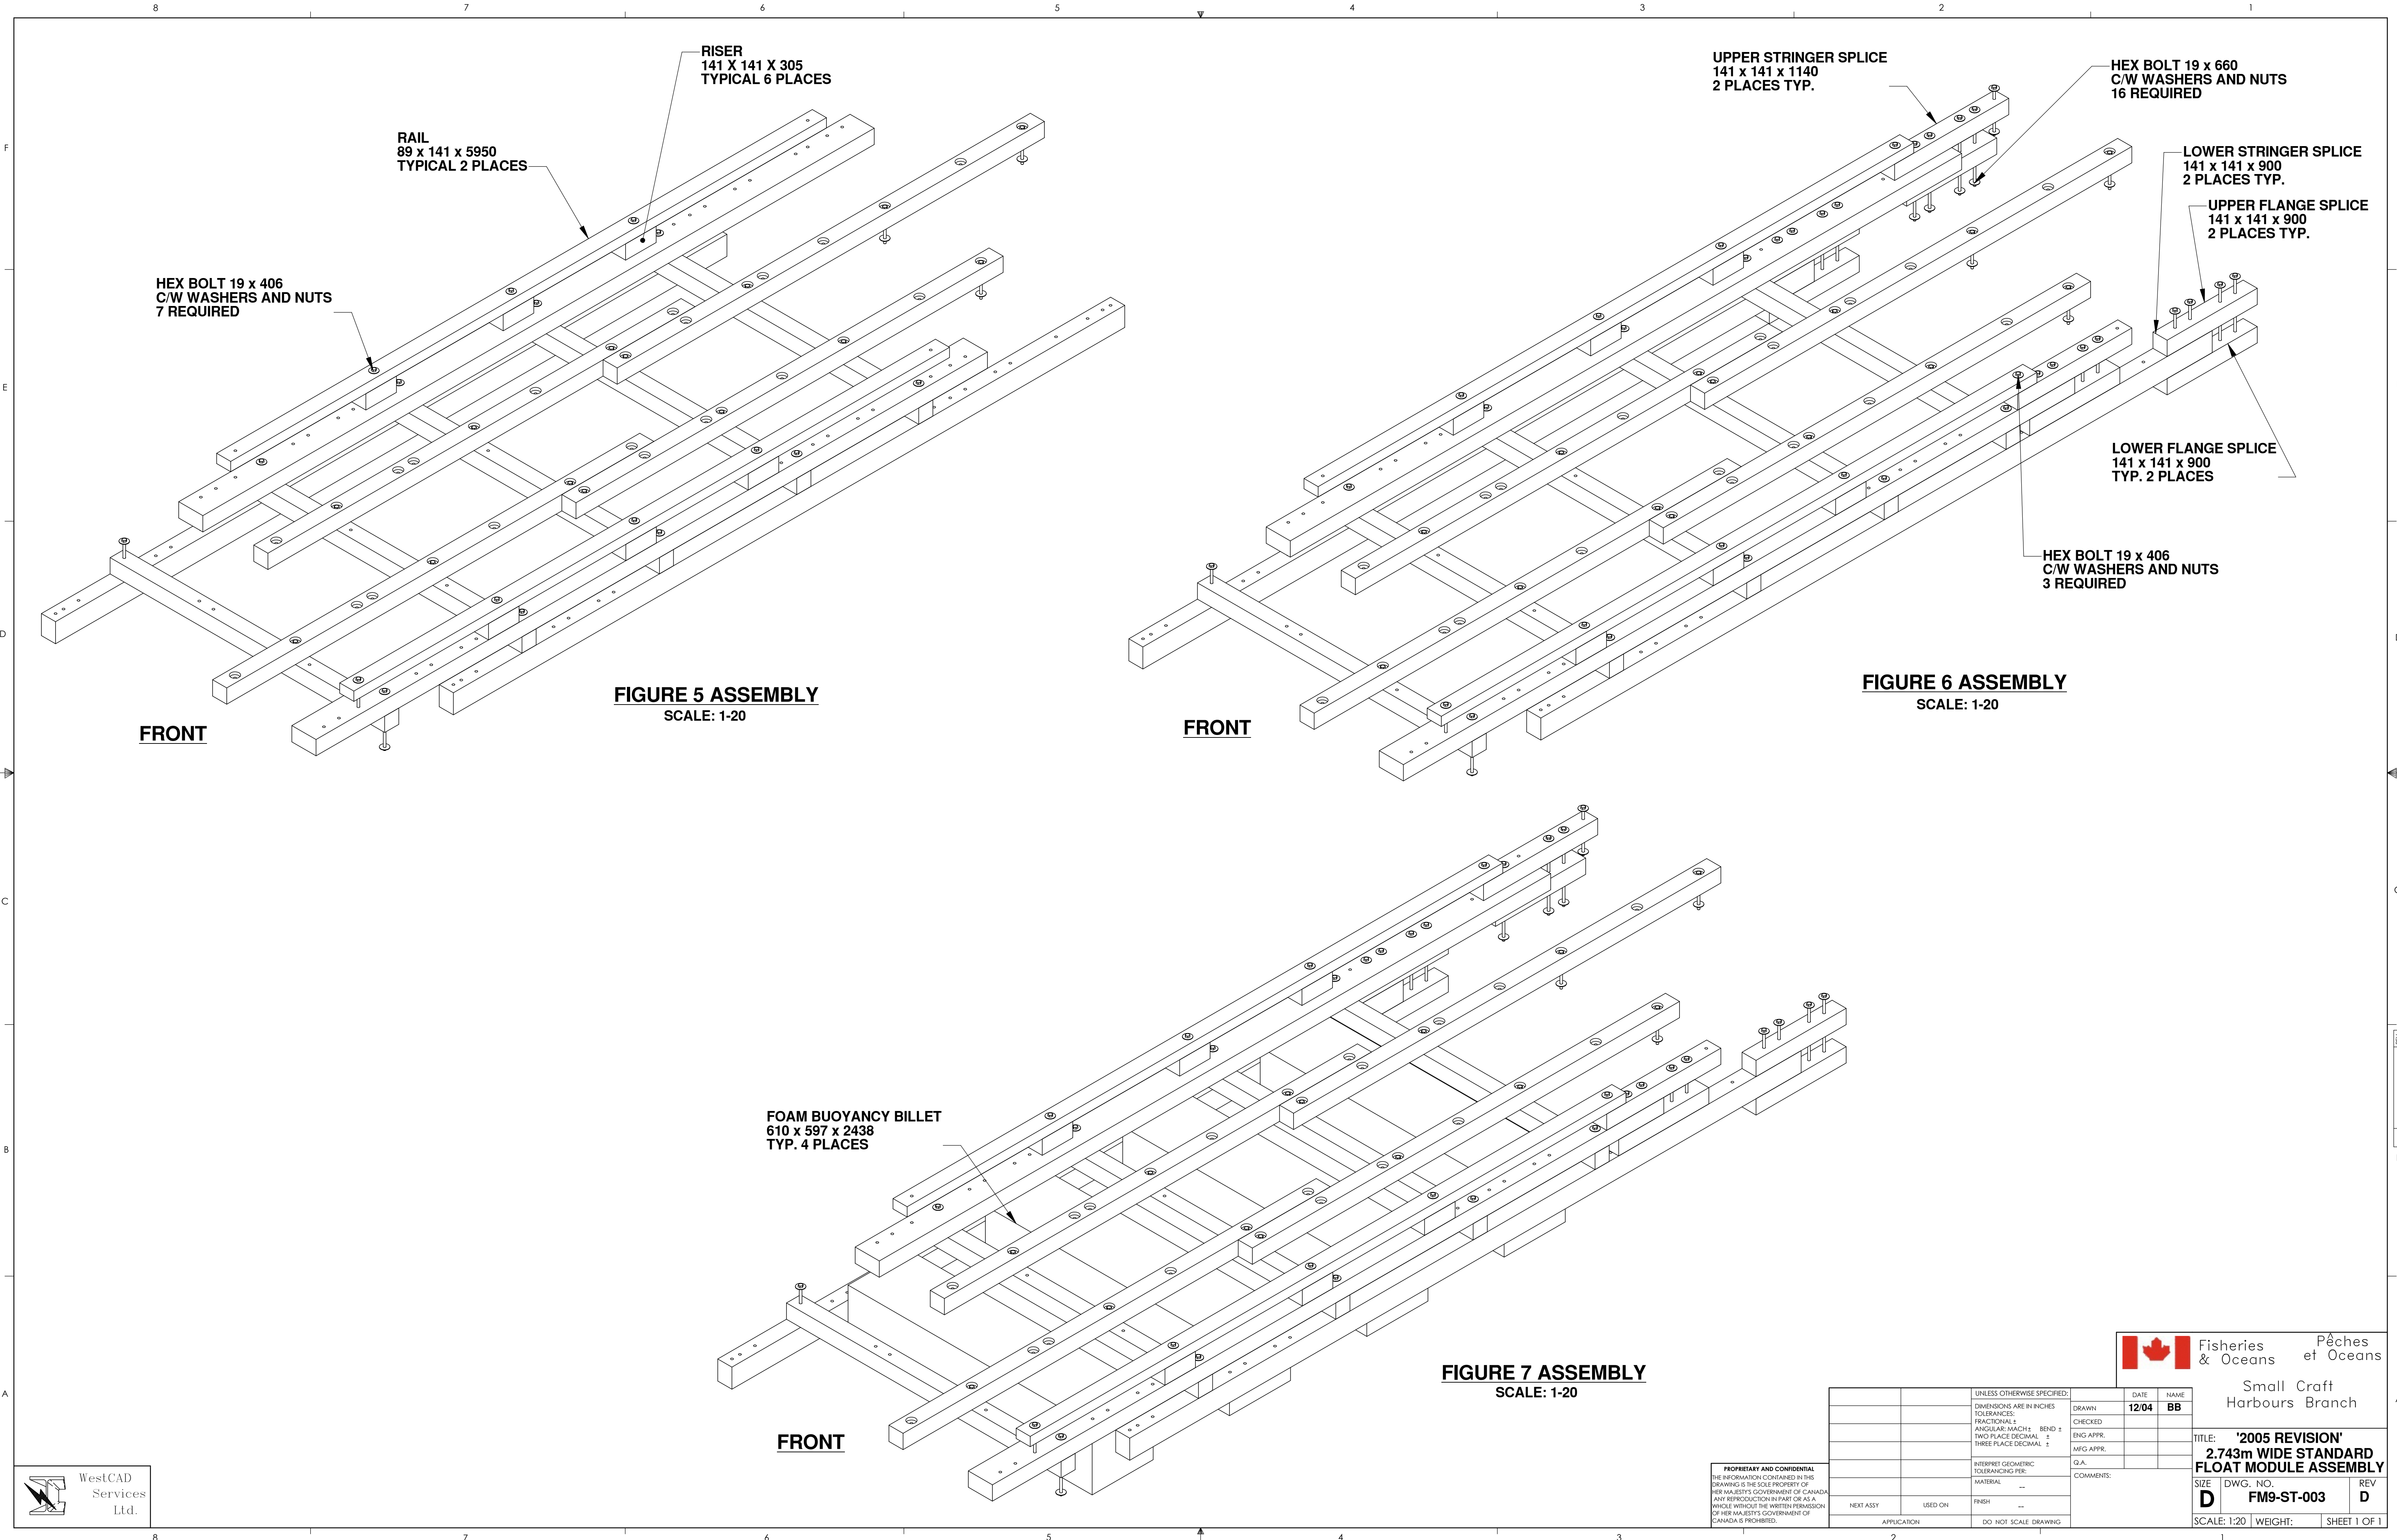ITEM NO.	QTY.	TIMBER MEMBER	DESCRIPTION	MATERIAL
1	2	END CROSSTIE	(6x10) 141 x 241 x 3658 LG.	14 LB. CREOSOTE TREATMENT #1 BTR FIR
2	2	FLANGE END	(6x8) 141 x 191 x 1372 LG.	14 LB. CREOSOTE TREATMENT #1 BTR FIR
3	2	END RAIL	(4x6) 89 x 141 x 3374 LG.	ACZA
4	3	JOIST END 'B'	(6x6) 141 x 141 x 2281 LG.	14 LB. CREOSOTE TREATMENT #1 BTR FIR
5	1	STANDARD CROSSTIE	(6x6) 141 x 141 x 3658 LG.	14 LB. CREOSOTE TREATMENT #1 BTR FIR
6	16	END BLOCK	(6x6) 141 x 141 x 300 LG.	ACZA
7	2	STRINGER END	(6x10) 141 X 241 x 1372 LG.	14 LB. CREOSOTE TREATMENT #1 BTR FIR
8	1	MODIFIED JOIST	(6x6) 141 x 141 x 3359 LG.	14 LB. CREOSOTE TREATMENT #1 BTR FIR
9	2	SPACER END 'B'	(6x6) 141 x 141 x 575 LG.	ACZA
10	2	SPACER END	(6x6) 141 x 141 x 378 LG.	ACZA
11	2	RAIL END	(4x6) 89 x 141 x 952 LG.	ACZA
12	2	RAIL END 'B'	(4x6) 89 x 141 x 378 LG.	ACZA
13	1	LOWER FLANGE SPLICE	(6x6) 141 x 141 x 900 LG.	14 LB. CREOSOTE TREATMENT #1 BTR FIR
14	1	UPPER STRINGER SPLICE	(6x6) 141 x 141 x 1140 LG.	ACZA
15	1	UPPER FLANGE SPLICE	(6x6) 141 x 141 x 900 LG.	14 LB. CREOSOTE TREATMENT #1 BTR FIR
16	1	LOWER STRINGER SPLICE	(6x6) 141 x 141 x 900 LG.	14 LB. CREOSOTE TREATMENT #1 BTR FIR

HARDWARE REQUIREMENTS

ITEM NO.	QTY.	DESCRIPTION
18	7	HEX BOLT 19 x 406mm
19	2	HEX BOLT 19 x 356mm
20	13	HEX BOLT 19 x 300mm
21	8	HEX BOLT 19 x 557mm
22	4	HEX BOLT 19 x 508mm
23	84	WASHER 19mm DIA.
24	8	HEX BOLT 19 x 660mm
25	42	HEX NUT 19mm DIA.


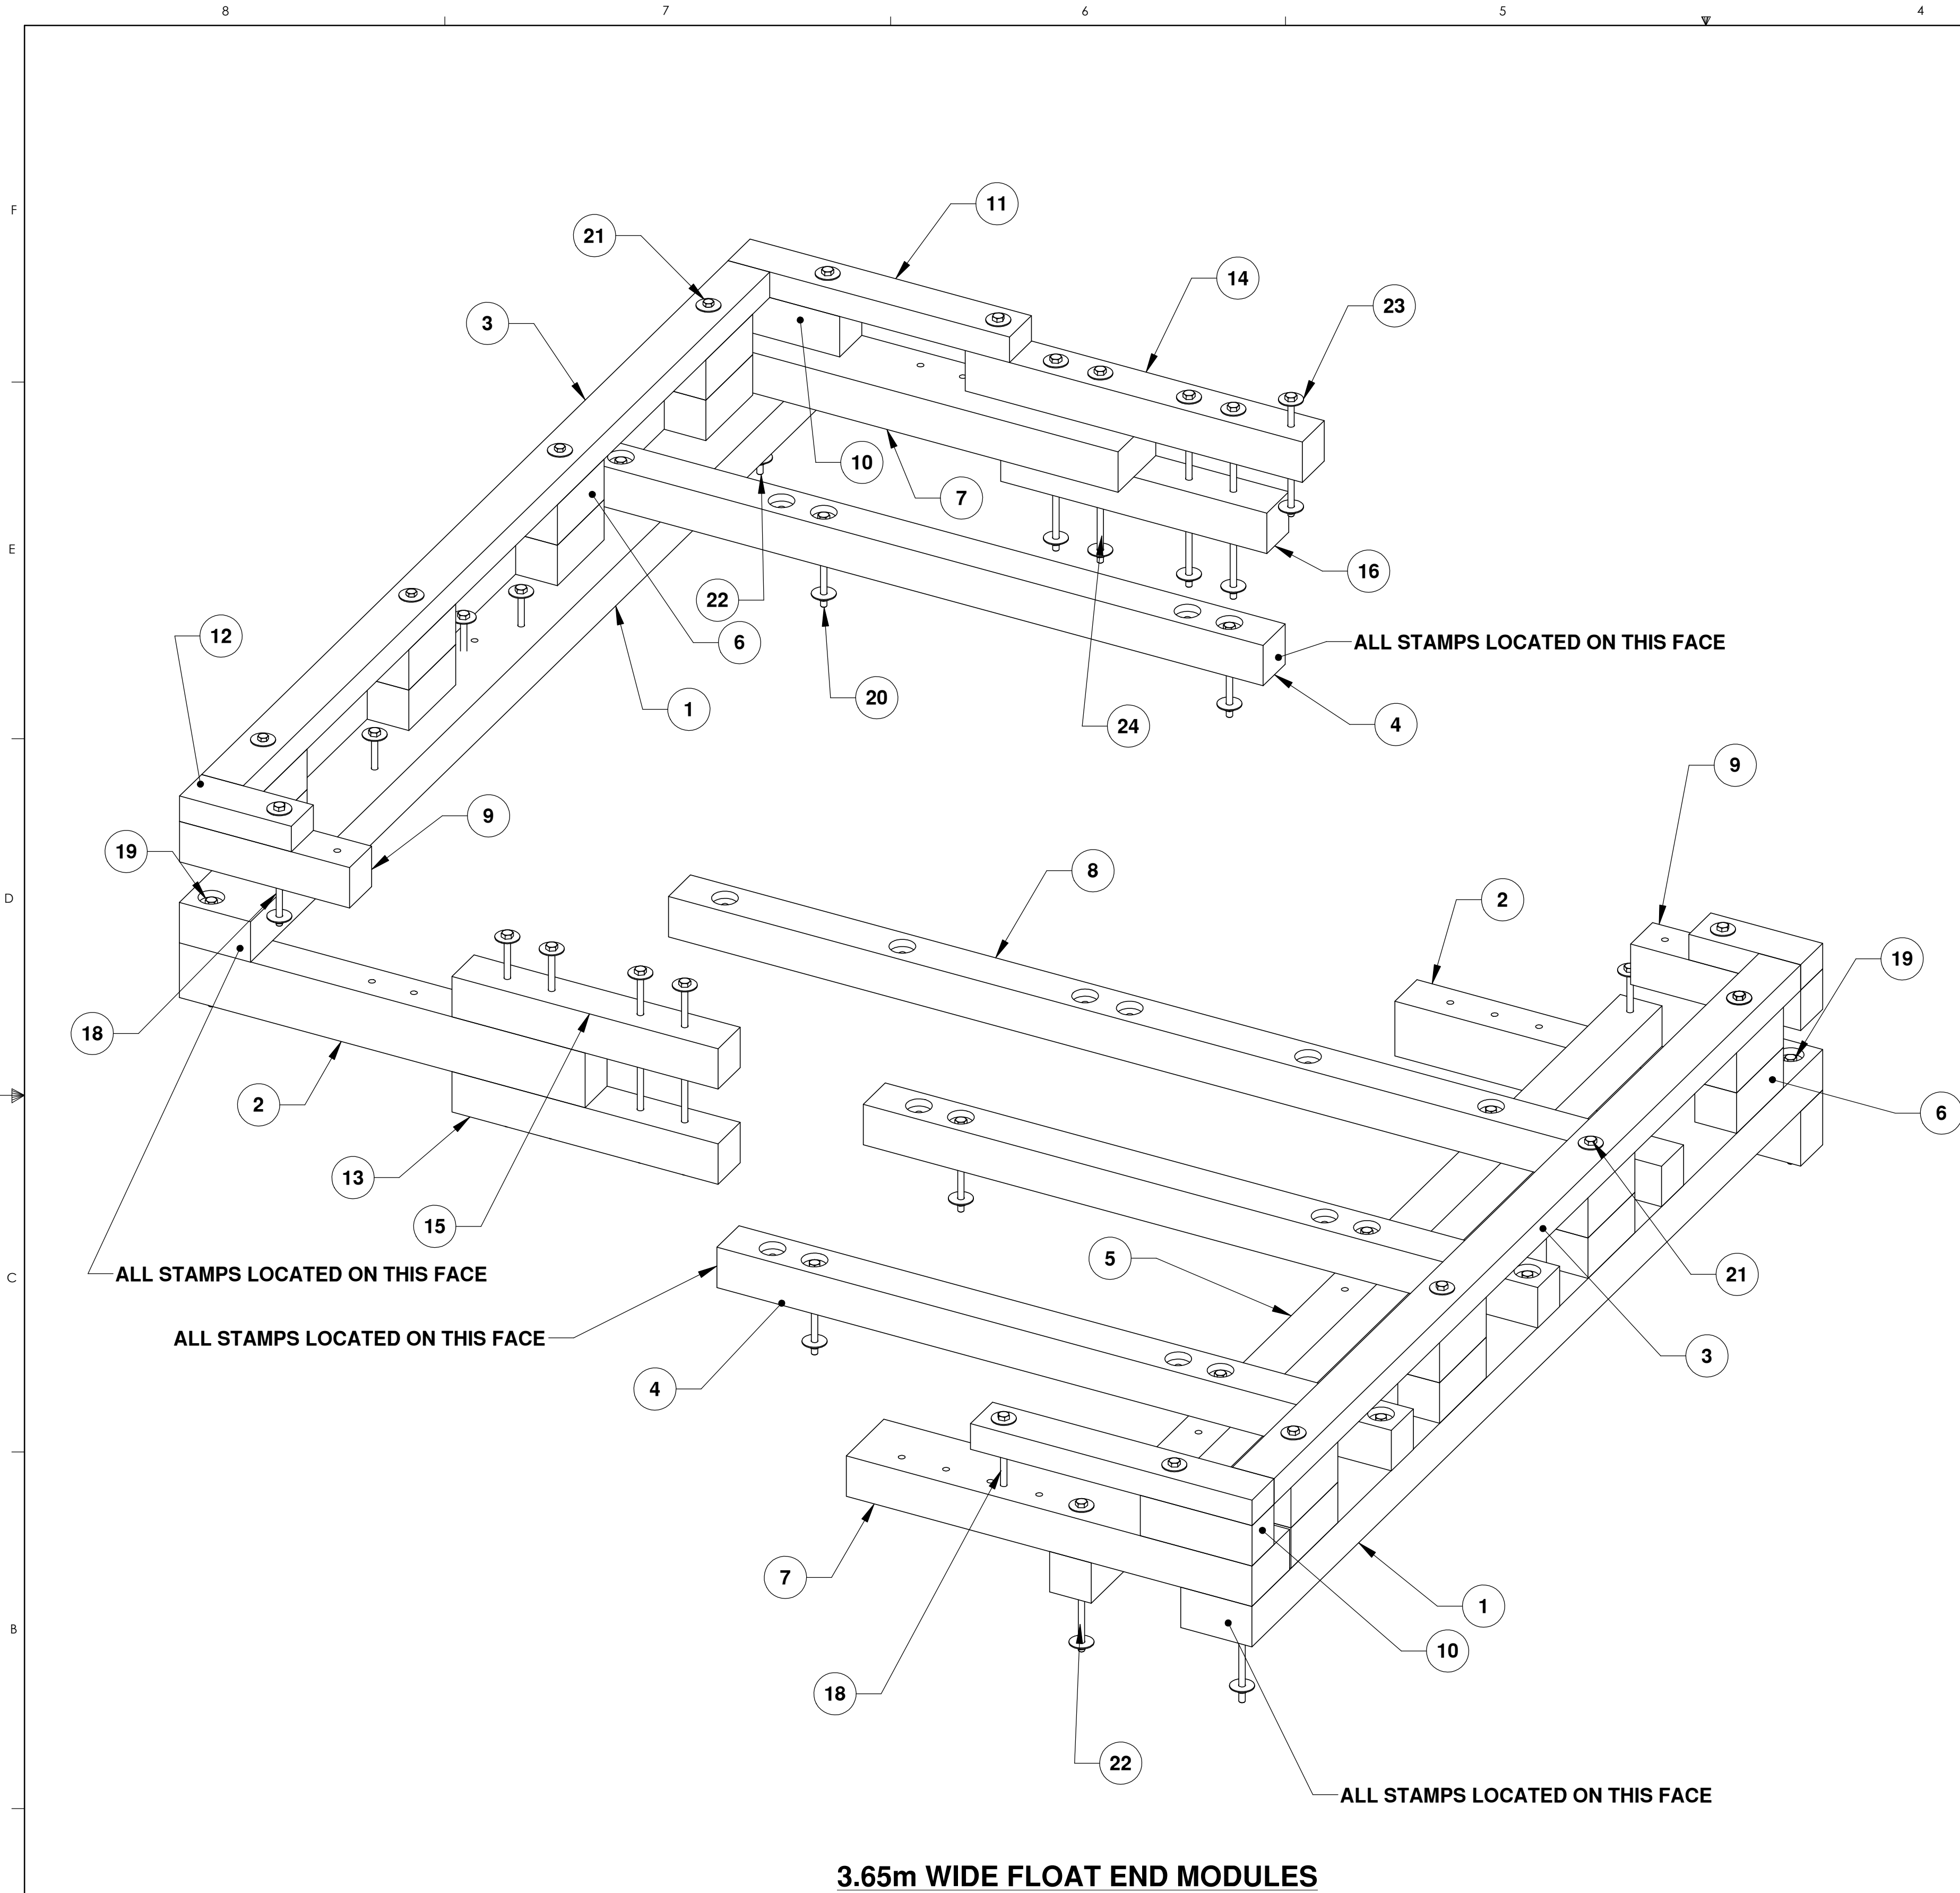


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FRACTIONAL: ±	ENG APPR.		
ANGULAR: MAX ± 1/2	MFG APPR.		
TWO PLACE DECIMAL: ±			
THREE PLACE DECIMAL: ±			
INTERPRET GEOMETRIC TOLERANCING PER:	Q.A. COMMENTS:		
MATERIAL: --			
FINISH: --			
NEXT ASSY:	USED ON:		
APPLICATION		DO NOT SCALE DRAWING	


Fisheries & Oceans / Pêches et Océans  
Small Craft Harbours Branch

TITLE: 3.65m WIDE FLOAT MODULE 2011 REVISION		
SIZE: D	DWG. NO. FM12-END-200	REV J
SCALE: 1:12	WEIGHT:	SHEET 1 OF 1

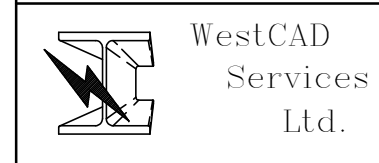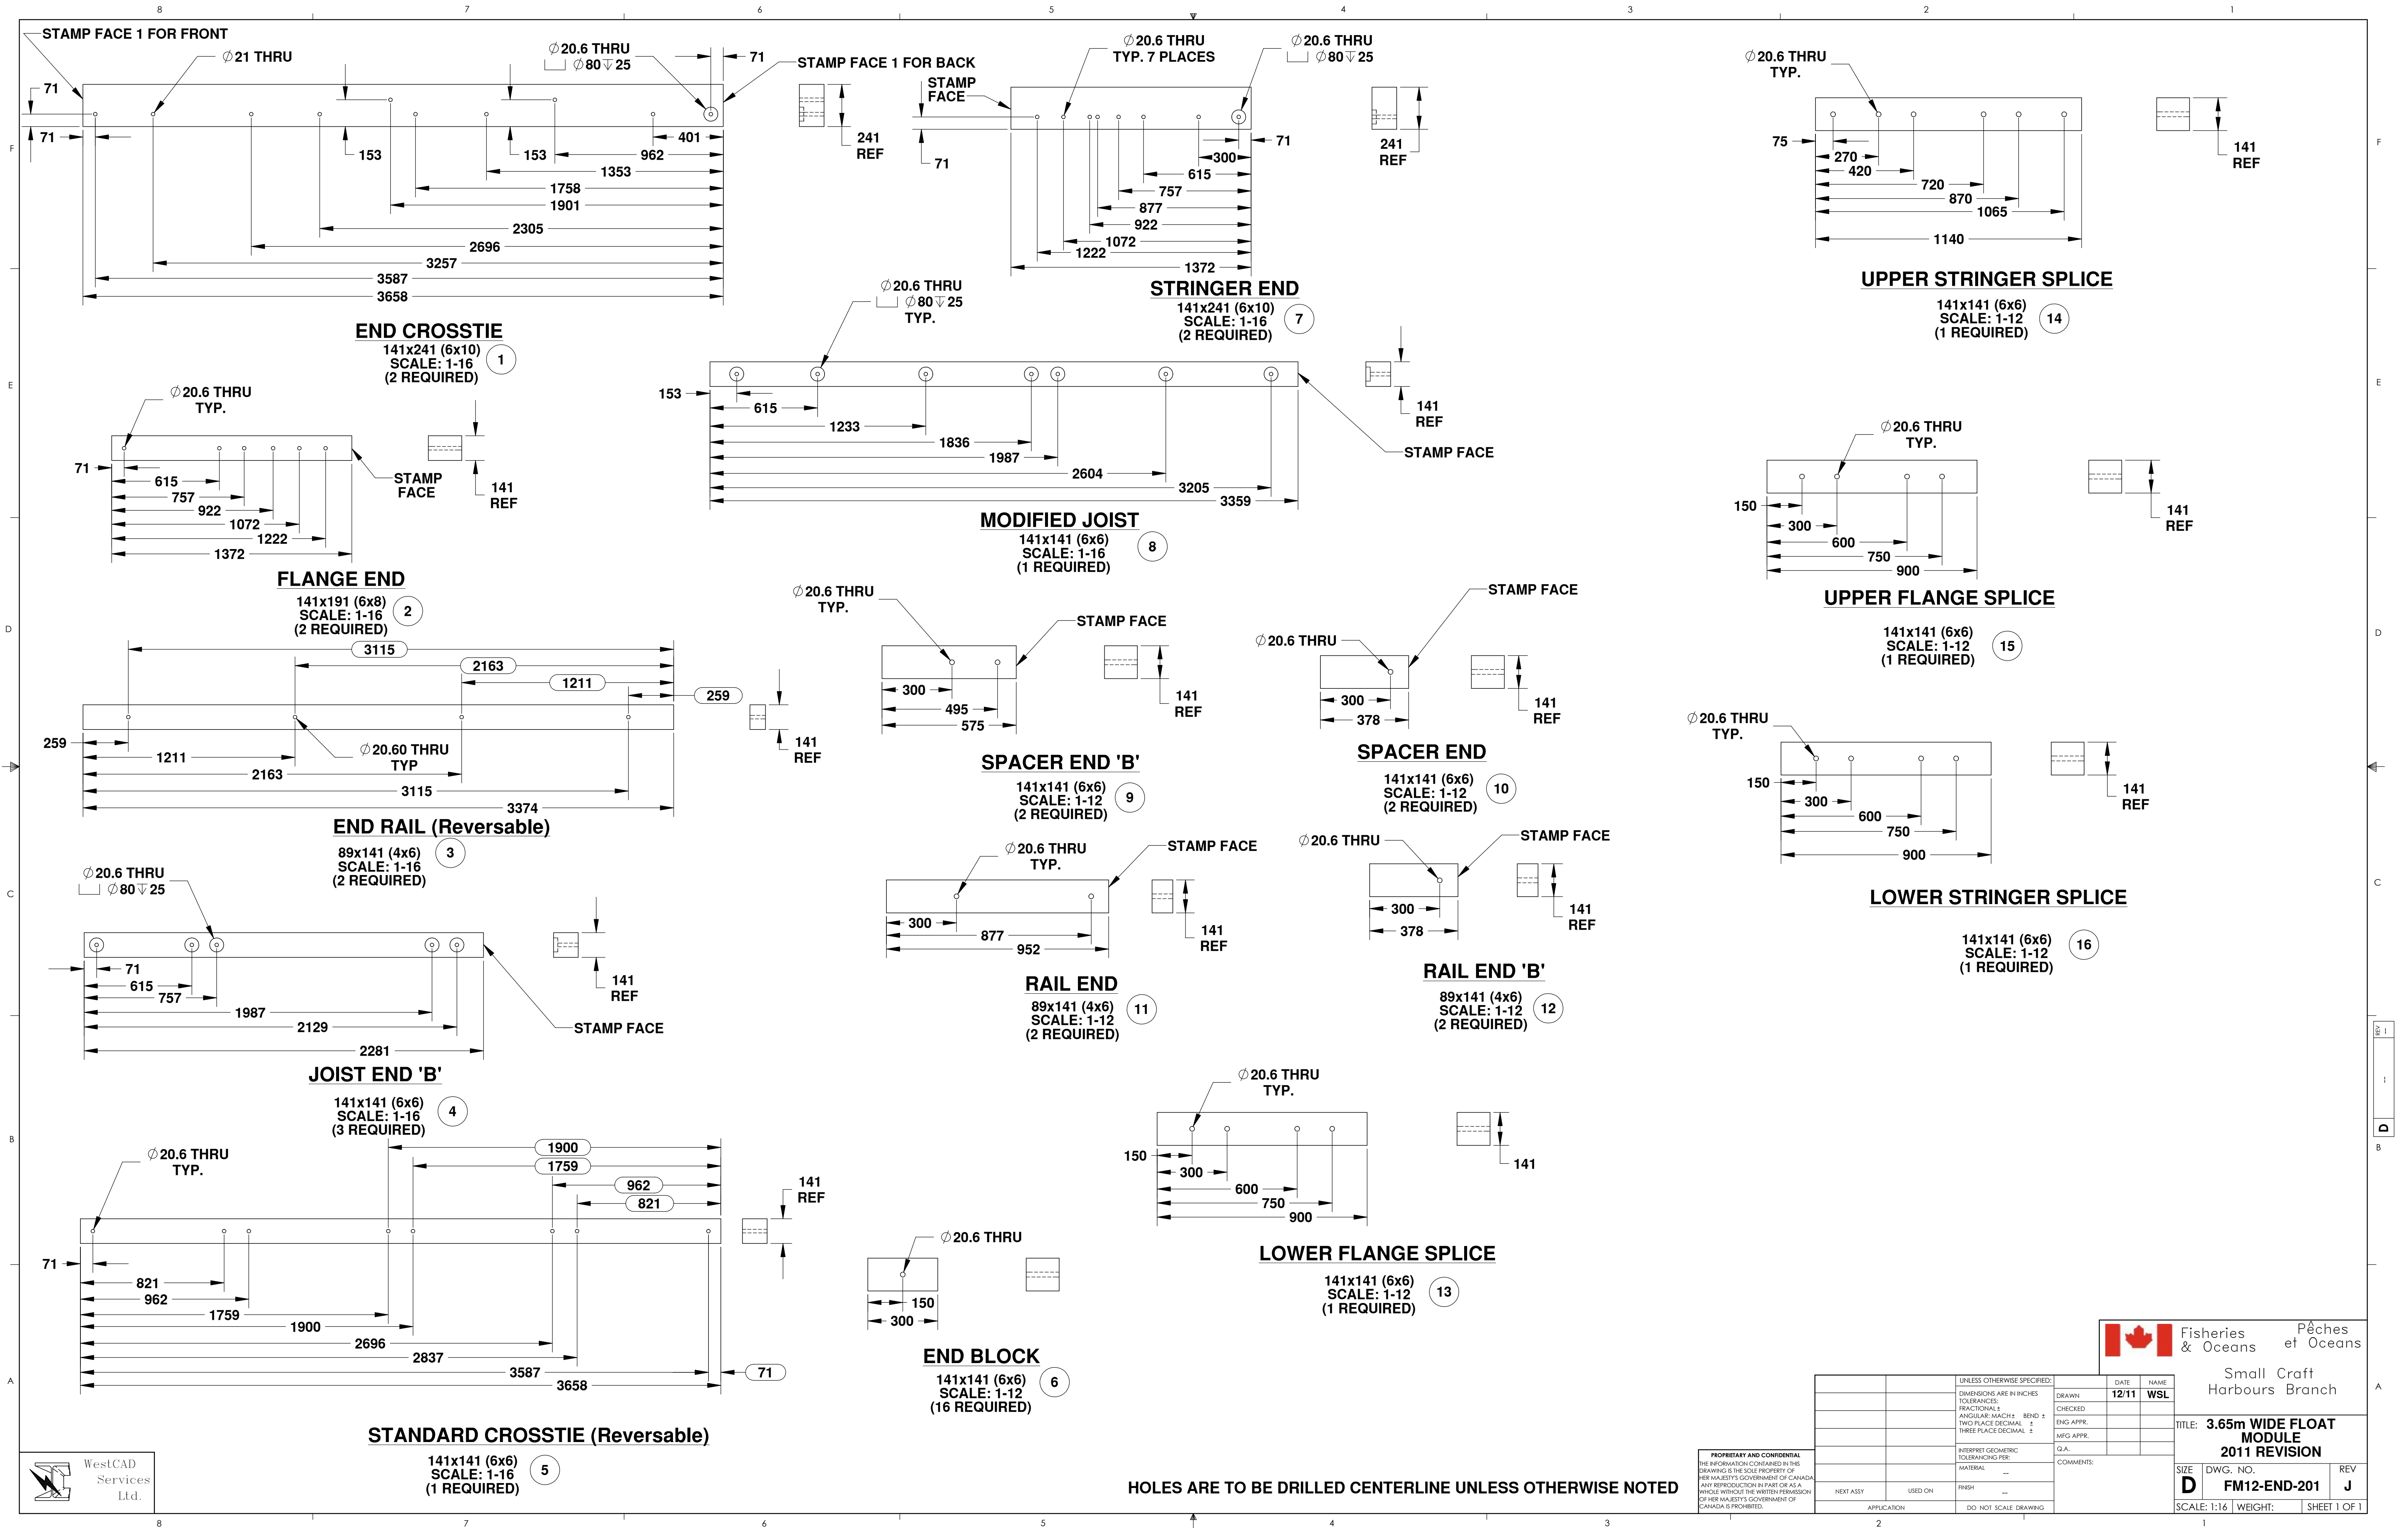

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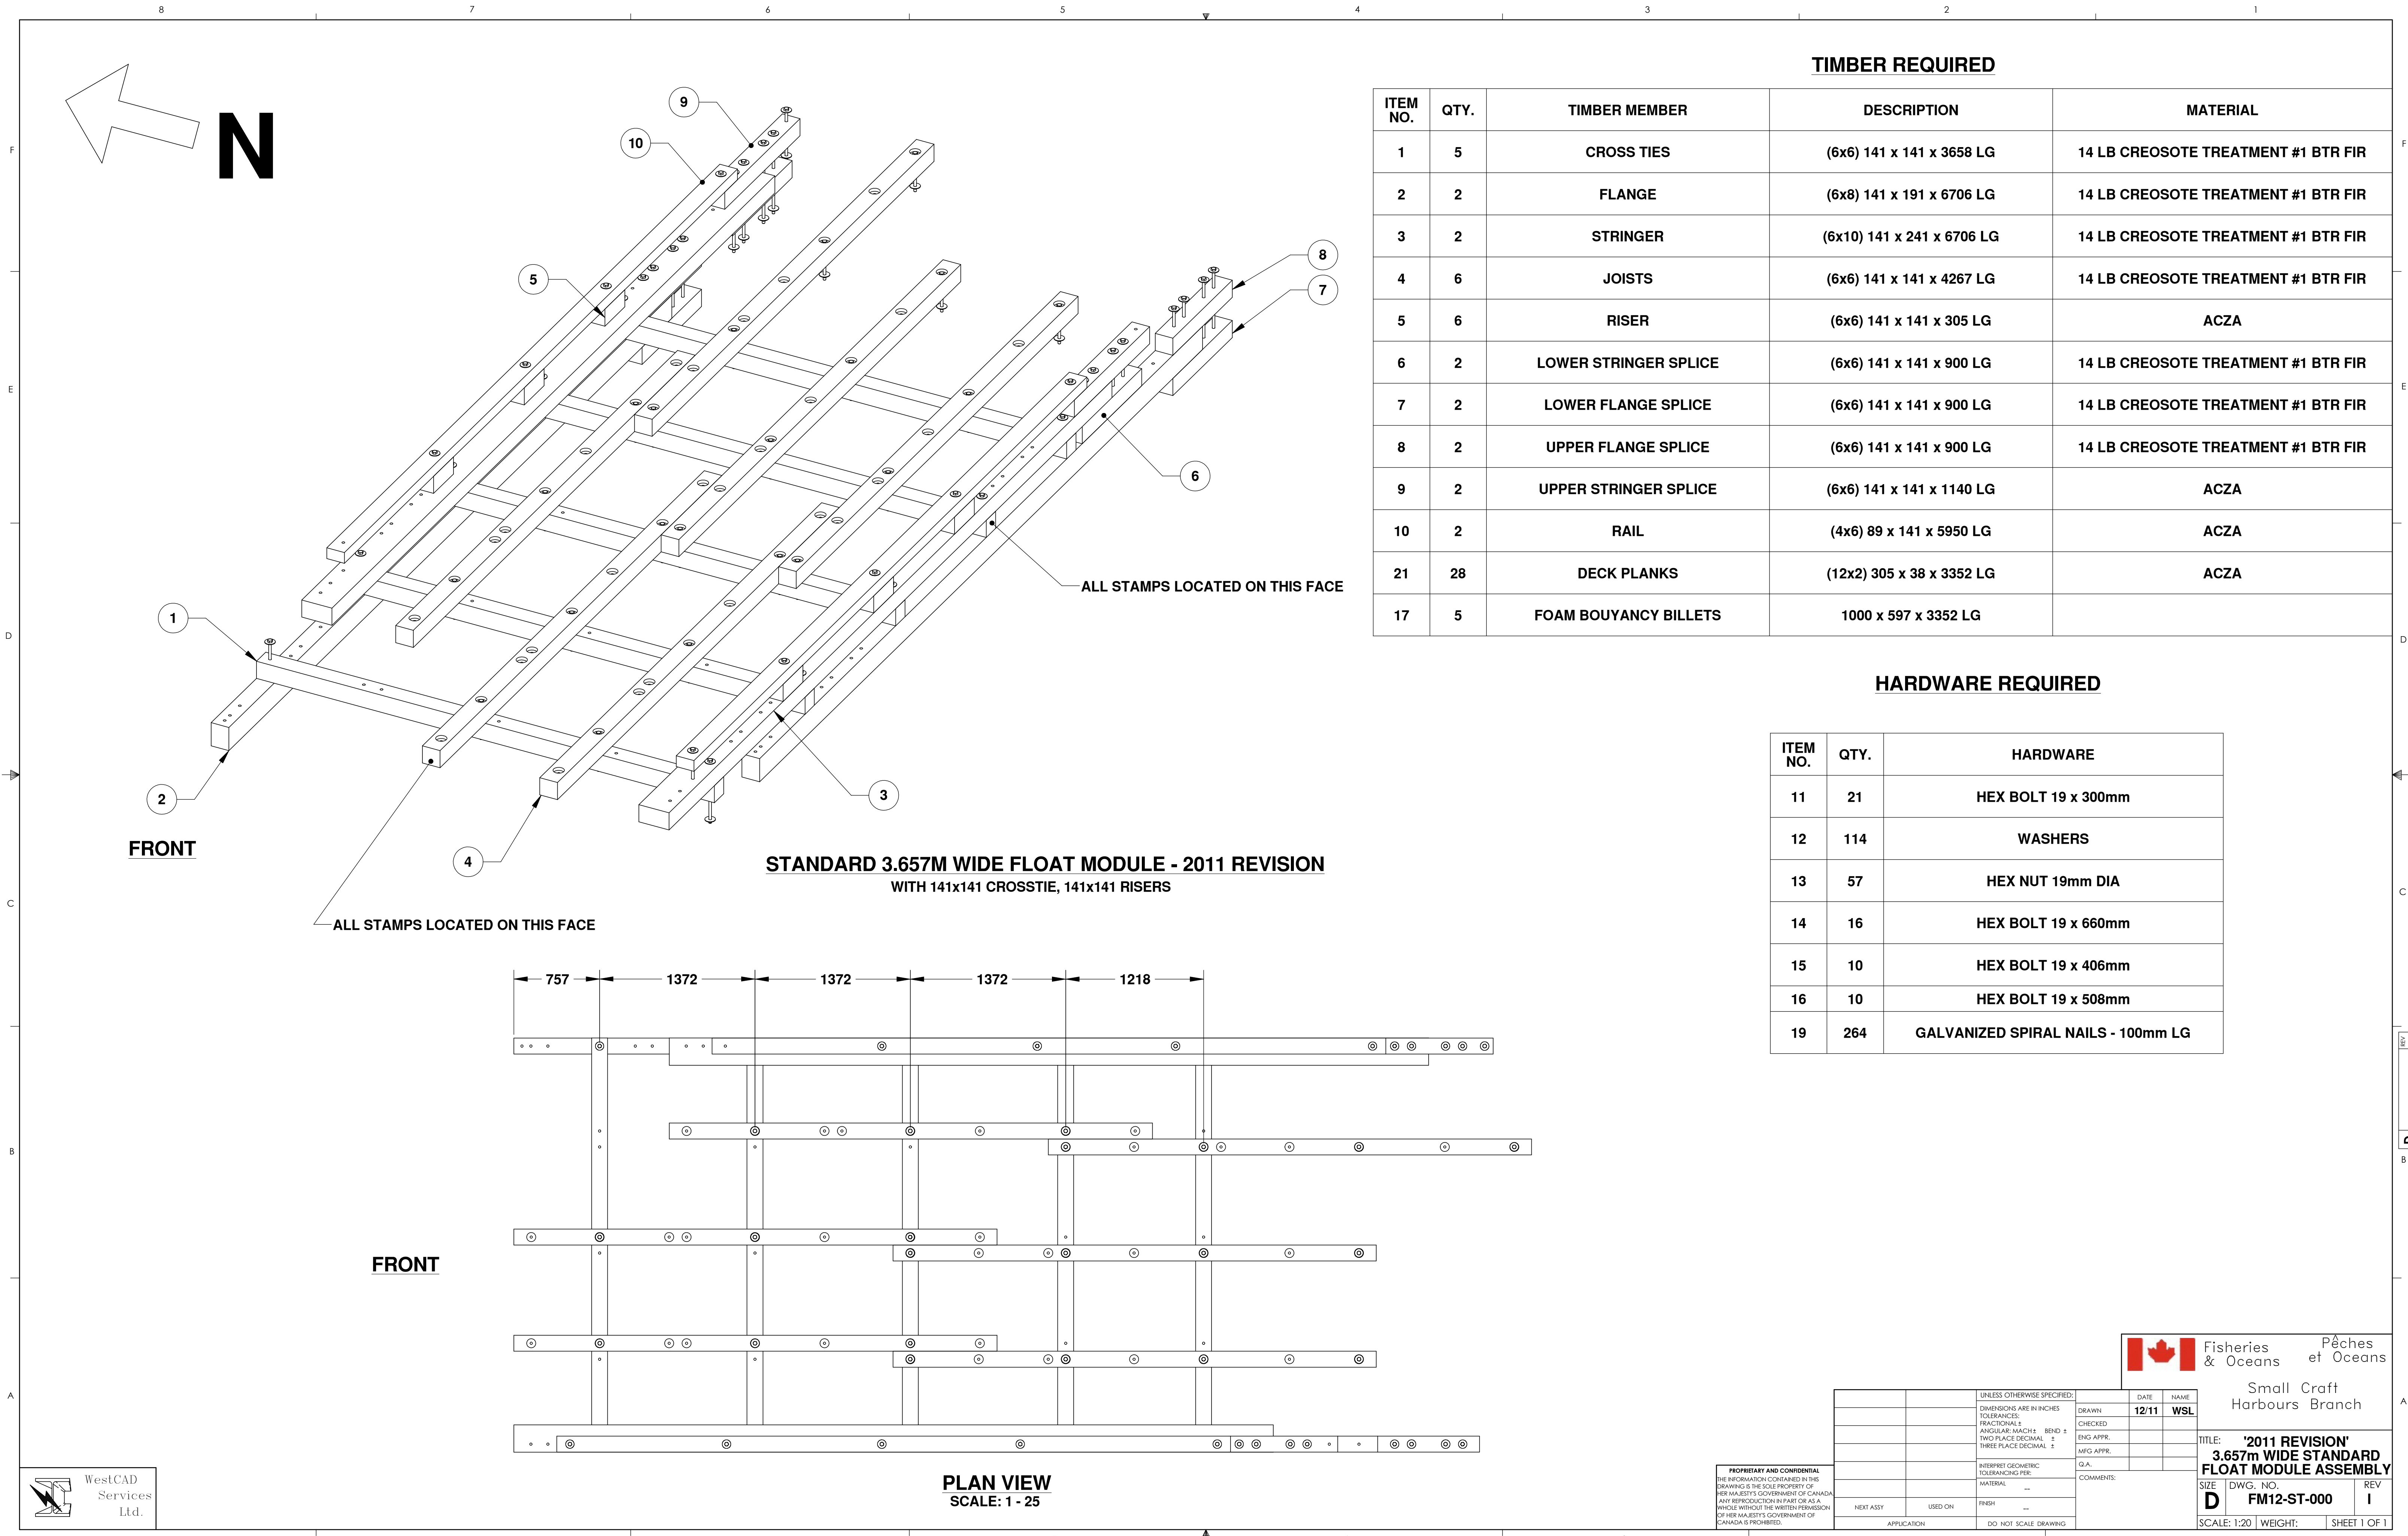
UNLESS OTHERWISE SPECIFIED:		DATE	NAME
DIMENSIONS ARE IN INCHES		12/11	WSL
TOLERANCES:		DRAWN	CHECKED
FRACTIONAL: ±		ENG APPR.	ENG APPR.
ANGULAR: MATCH ±		MFG APPR.	MFG APPR.
TWO PLACE DECIMAL: ±		Q.A.	Q.A.
THREE PLACE DECIMAL: ±		COMMENTS:	
INTERPRET GEOMETRIC TOLERANCING PER:			
MATERIAL: --			
FINISH: --			
NEXT ASSY: USED ON:			
APPLICATION		DO NOT SCALE DRAWING	

 Fisheries & Oceans Pêches et Océans  
Small Craft Harbours Branch

TITLE: **3.65m WIDE FLOAT MODULE 2011 REVISION**

SIZE	DWG. NO.	REV
D	FM12-END-201	J
SCALE: 1:16	WEIGHT:	SHEET 1 OF 1






ITEM NO.	QTY.	TIMBER MEMBER	DESCRIPTION	MATERIAL
1	5	CROSS TIES	(6x6) 141 x 141 x 3658 LG	14 LB CREOSOTE TREATMENT #1 BTR FIR
2	2	FLANGE	(6x8) 141 x 191 x 6706 LG	14 LB CREOSOTE TREATMENT #1 BTR FIR
3	2	STRINGER	(6x10) 141 x 241 x 6706 LG	14 LB CREOSOTE TREATMENT #1 BTR FIR
4	6	JOISTS	(6x6) 141 x 141 x 4267 LG	14 LB CREOSOTE TREATMENT #1 BTR FIR
5	6	RISER	(6x6) 141 x 141 x 305 LG	ACZA
6	2	LOWER STRINGER SPLICE	(6x6) 141 x 141 x 900 LG	14 LB CREOSOTE TREATMENT #1 BTR FIR
7	2	LOWER FLANGE SPLICE	(6x6) 141 x 141 x 900 LG	14 LB CREOSOTE TREATMENT #1 BTR FIR
8	2	UPPER FLANGE SPLICE	(6x6) 141 x 141 x 900 LG	14 LB CREOSOTE TREATMENT #1 BTR FIR
9	2	UPPER STRINGER SPLICE	(6x6) 141 x 141 x 1140 LG	ACZA
10	2	RAIL	(4x6) 89 x 141 x 5950 LG	ACZA
21	28	DECK PLANKS	(12x2) 305 x 38 x 3352 LG	ACZA
17	5	FOAM BOUYANCY BILLETS	1000 x 597 x 3352 LG	

## HARDWARE REQUIRED

ITEM NO.	QTY.	HARDWARE
11	21	HEX BOLT 19 x 300mm
12	114	WASHERS
13	57	HEX NUT 19mm DIA
14	16	HEX BOLT 19 x 660mm
15	10	HEX BOLT 19 x 406mm
16	10	HEX BOLT 19 x 508mm
19	264	GALVANIZED SPIRAL NAILS - 100mm LG

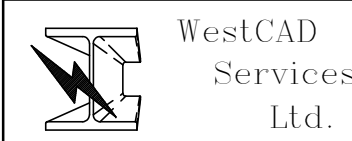

		UNLESS OTHERWISE SPECIFIED:		DATE	NAME
		DIMENSIONS ARE IN INCHES		DRAWN	WSL
		TOLERANCES:		CHECKED	
		FRACTIONAL: 1		ENG APPR:	
		ANGULAR: MACH 1			
		BEND 1			
		TWO PLACE DECIMAL 1			
		THREE PLACE DECIMAL 1			
				Q.A.	
		INTERPRET GEOMETRIC TOLERANCING PER:		COMMENTS:	
		MATERIAL --			
NEXT ASSY	USED ON	FINISH --			
APPLICATION		DO NOT SCALE DRAWING			




Fisheries & Oceans      Pêches et Océans


Small Craft  
Harbours Branch

**TITLE: '2011 REVISION'**  
**3.657m WIDE STANDARD**  
**FLOAT MODULE ASSEMBLY**


SIZE <b>D</b>	DWG. NO. <b>FM12-ST-000</b>	REV <b>I</b>
SCALE: 1:20	WEIGHT:	SHEET 1 OF 1

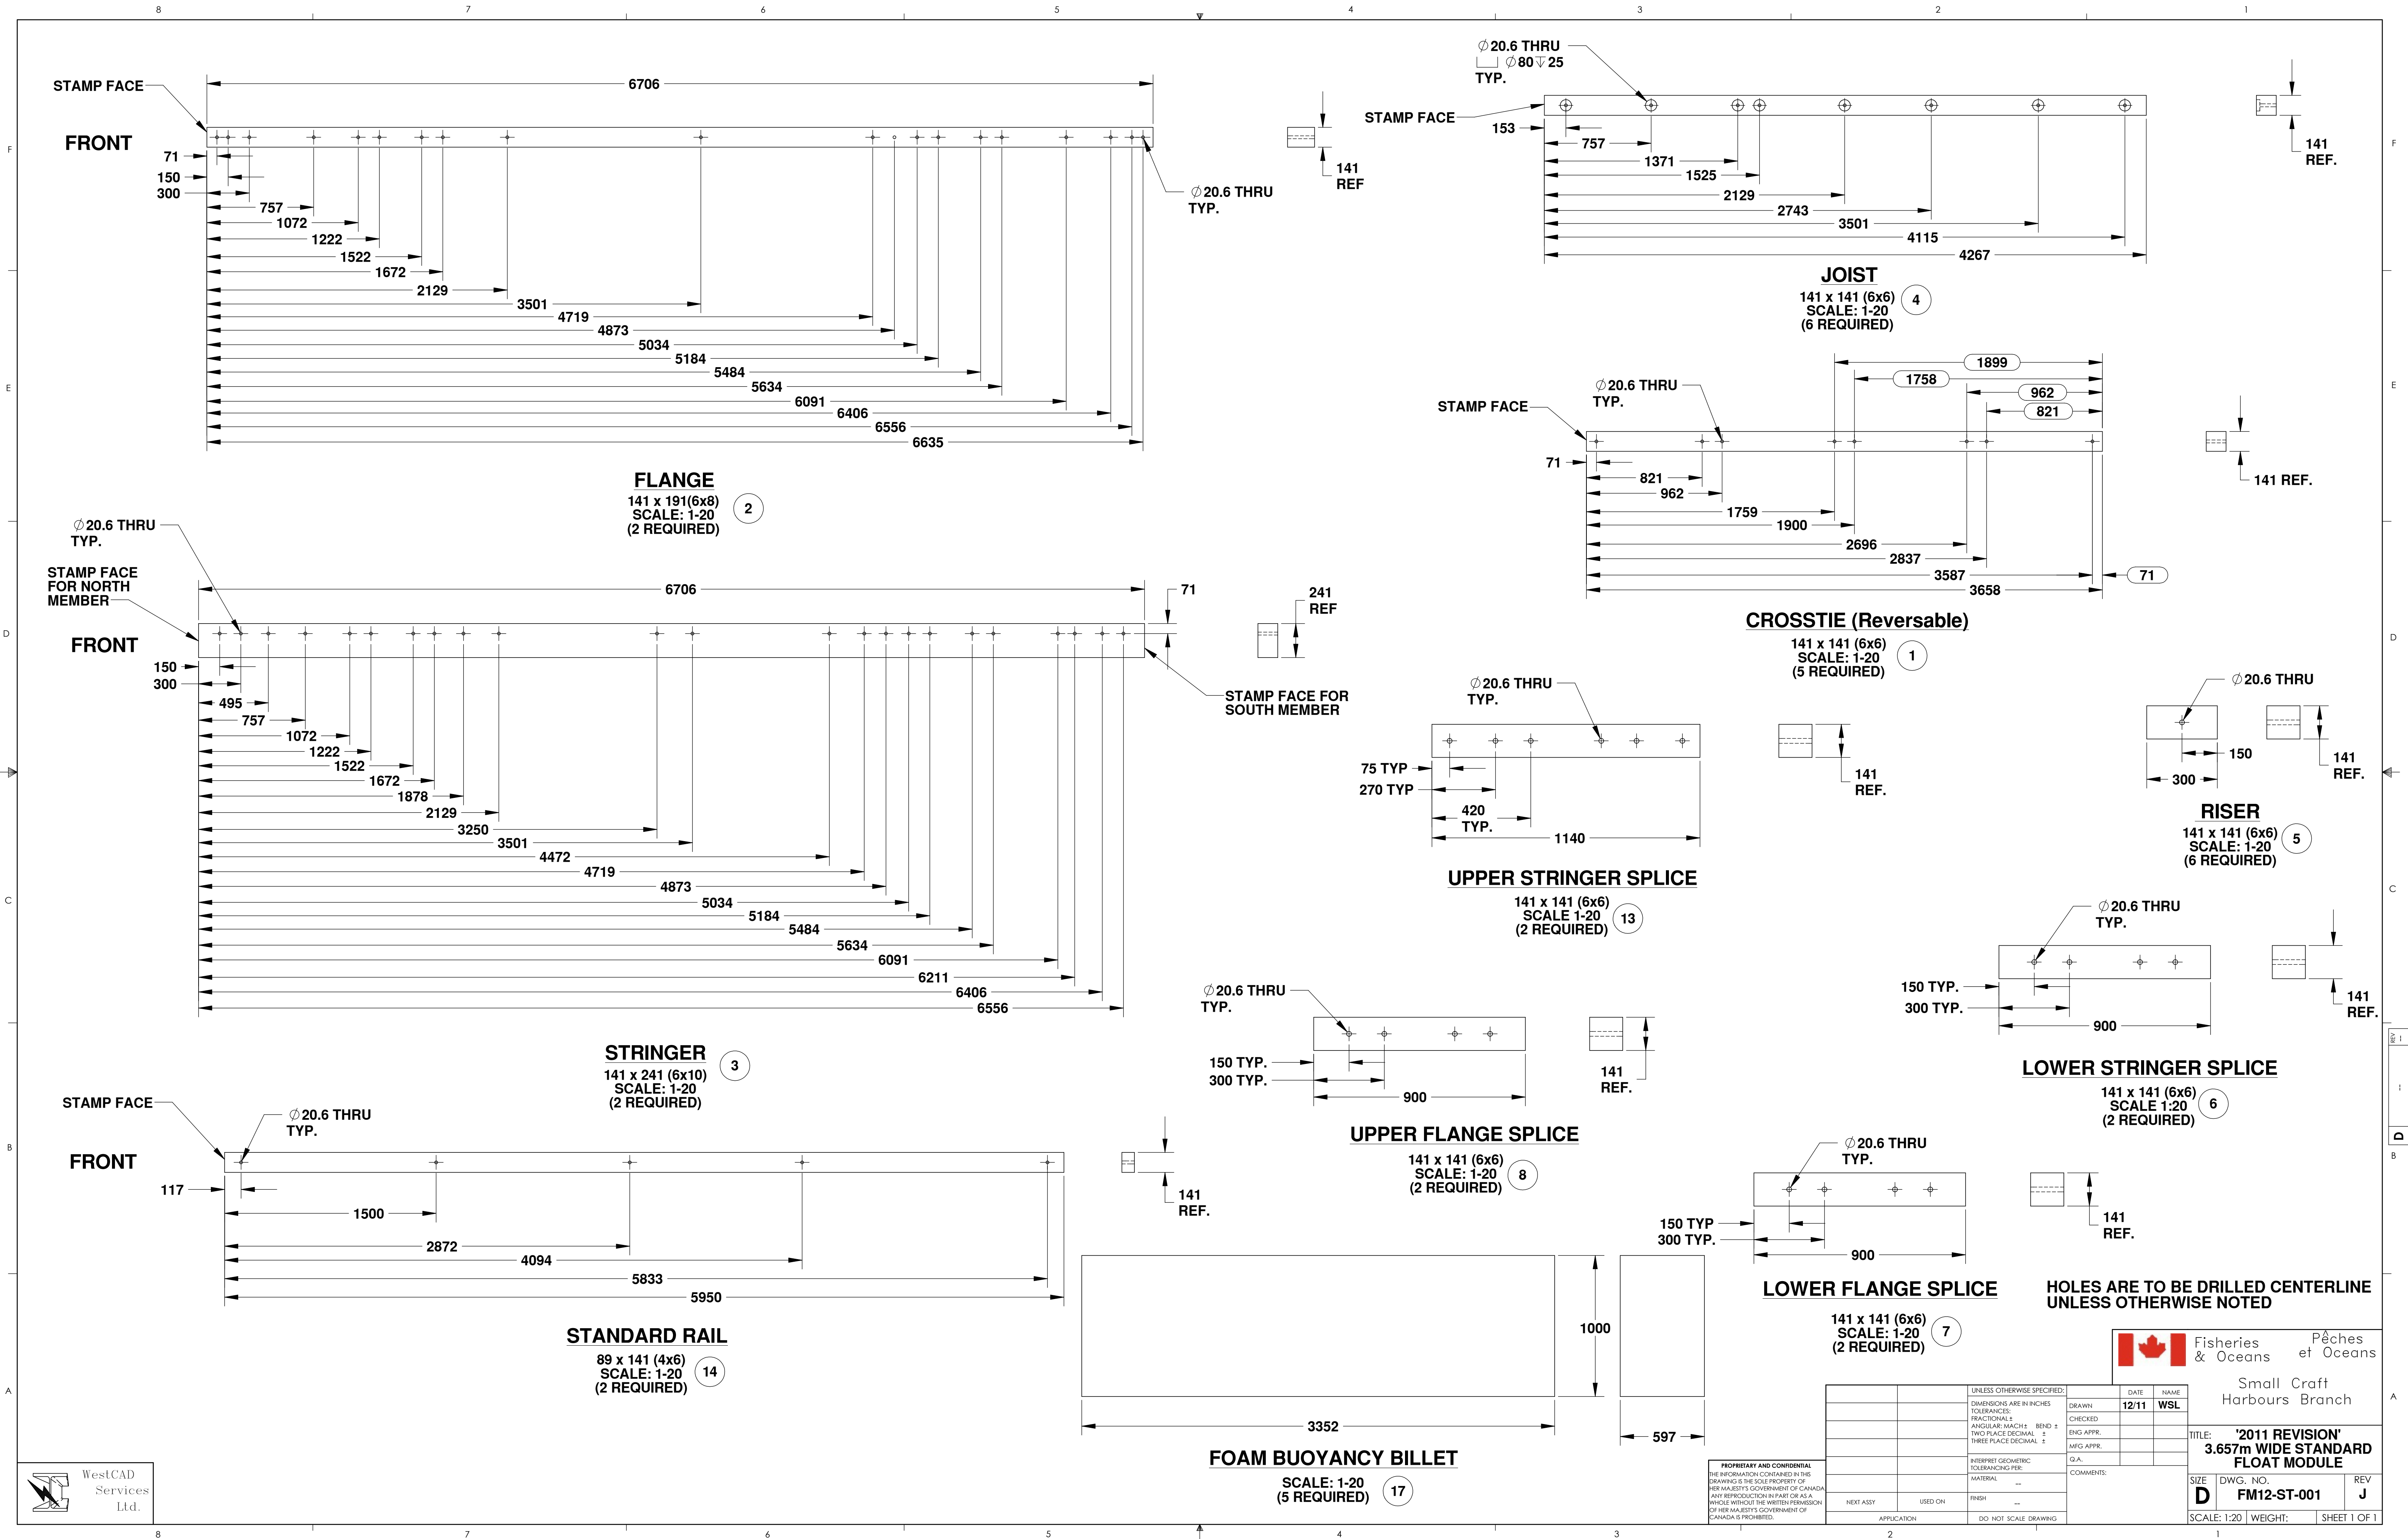



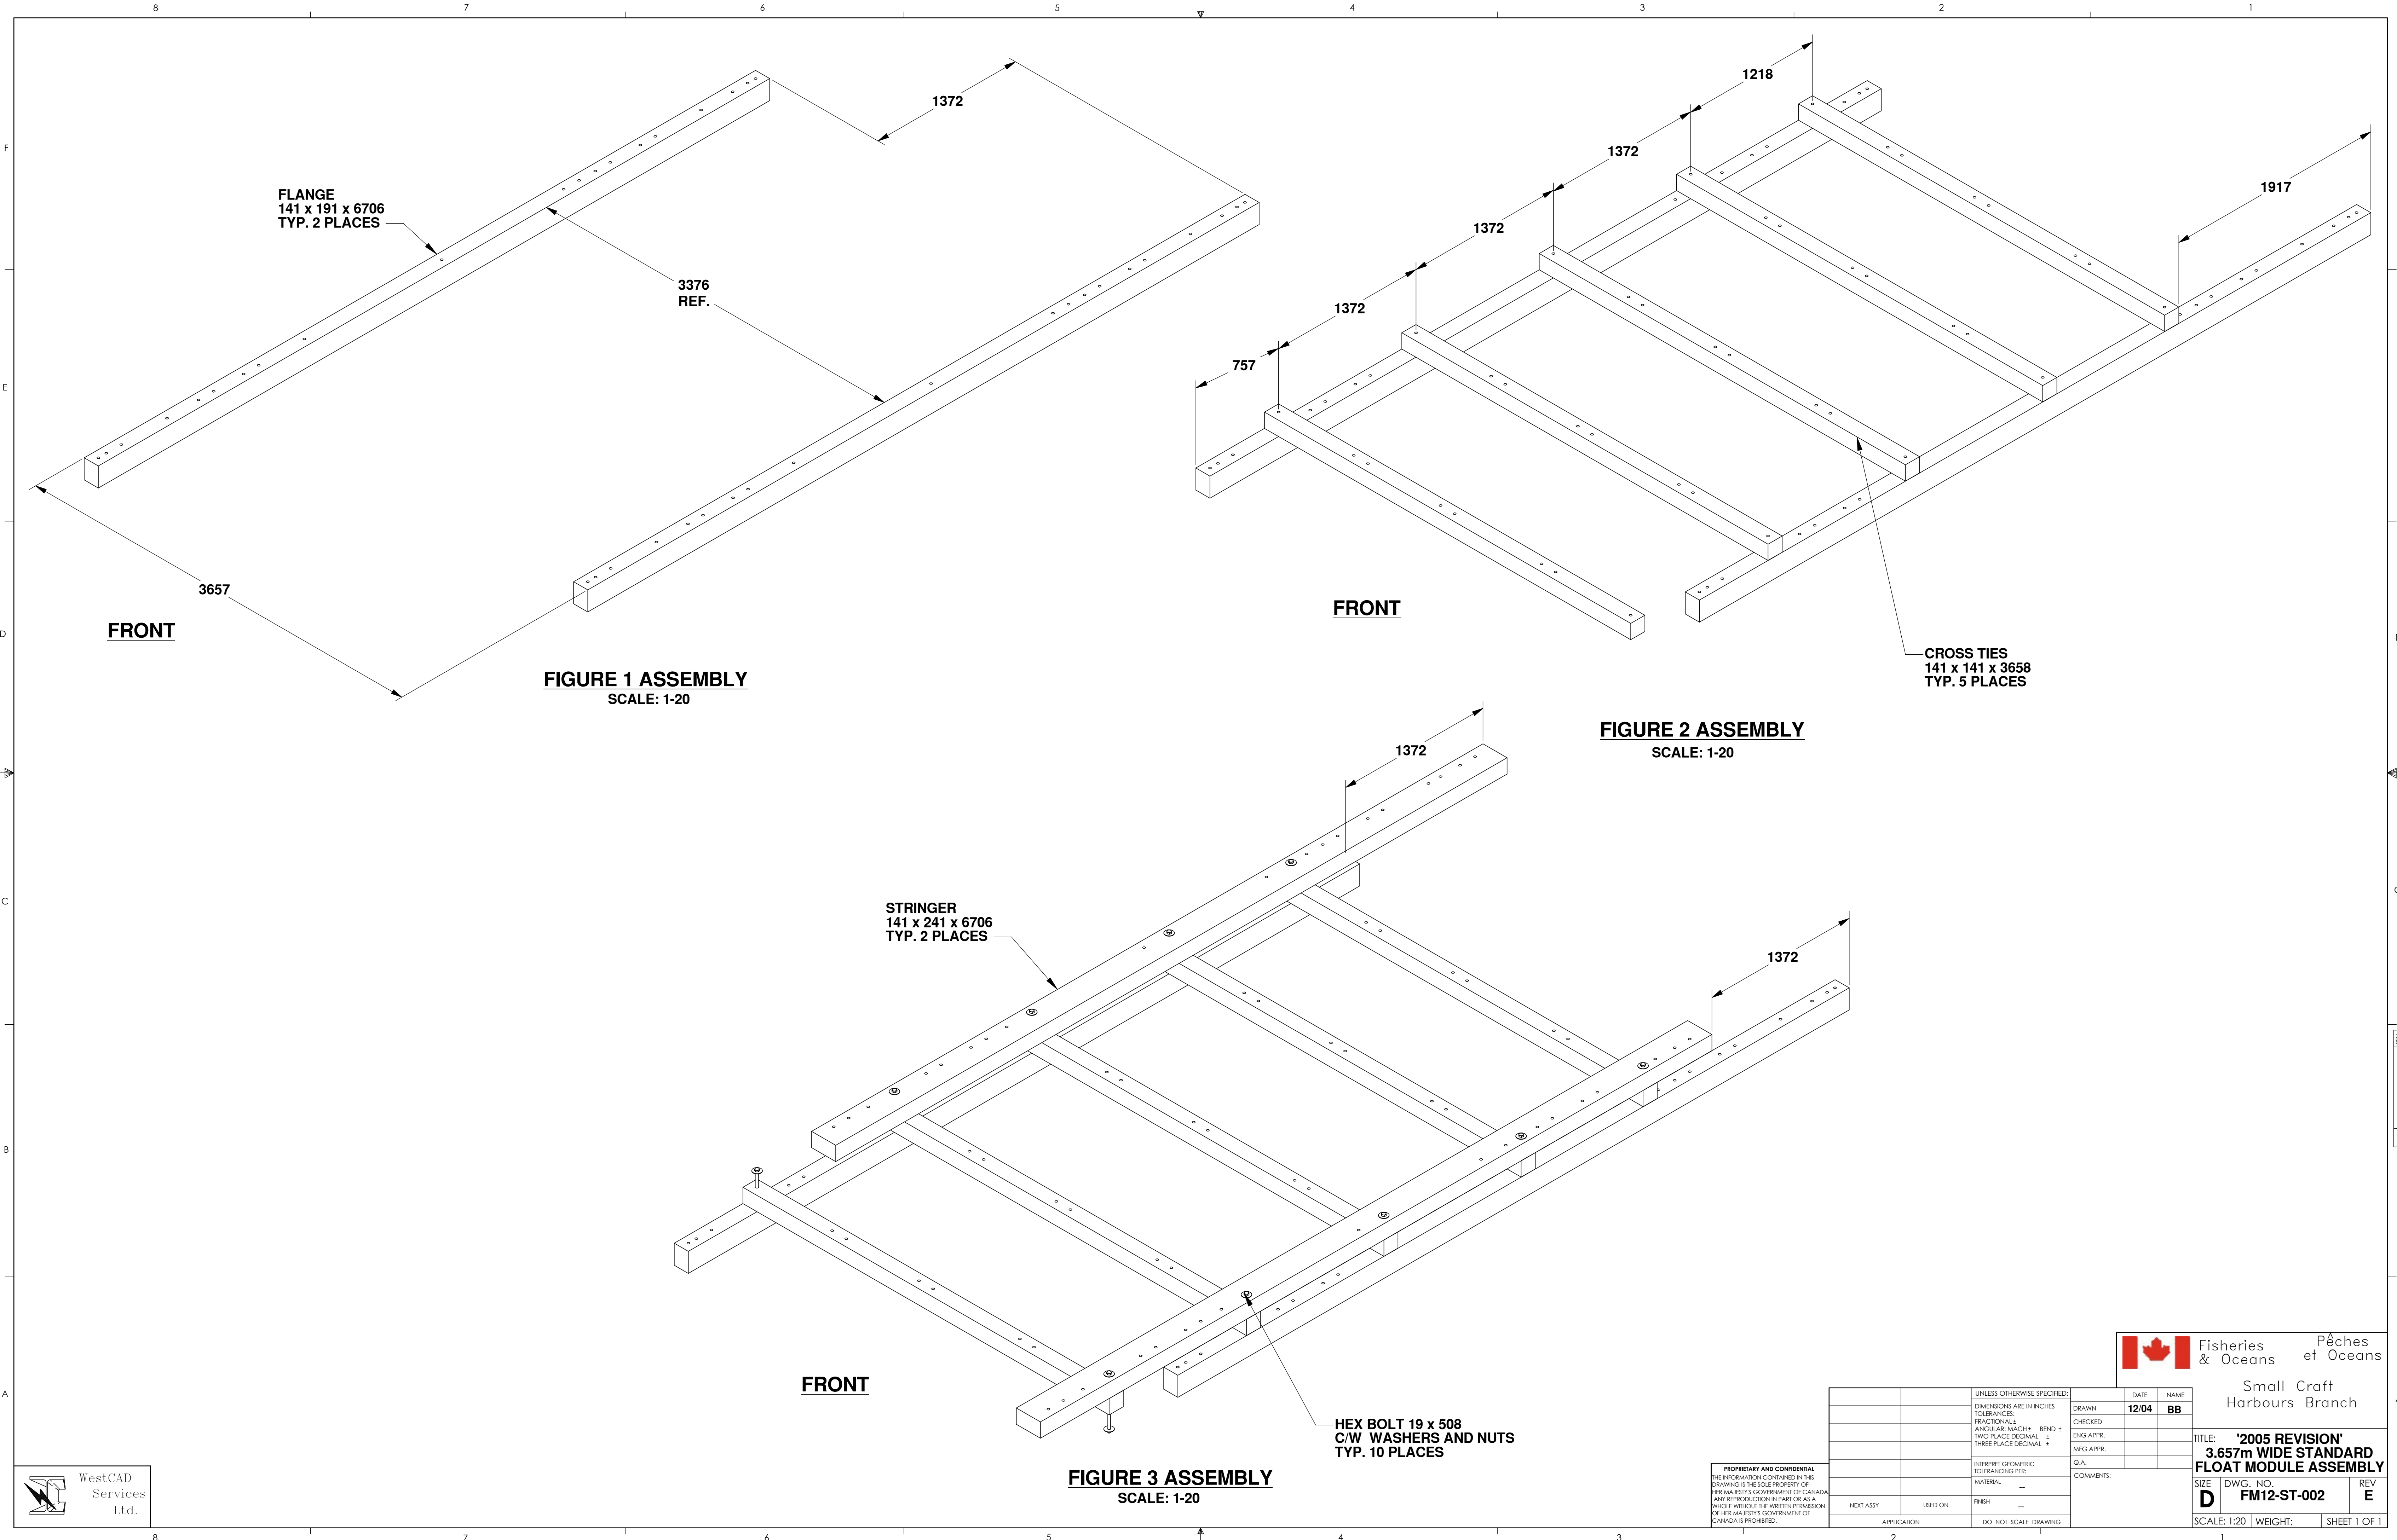

		UNLESS OTHERWISE SPECIFIED: DIMENSIONS ARE IN INCHES TOLERANCES: FRACTIONAL ± ANGULAR: MACH ± TWO PLACE DECIMAL ± THREE PLACE DECIMAL ±	DRAWN CHECKED ENG APPR. MFG APPR. G.A.	DATE 12/04	NAME BB
		INTERPRET GEOMETRIC TOLERANCING PER: MATERIAL --	COMMENTS:		
NEXT ASSY	USED ON	FINISH --			
APPLICATION		DO NOT SCALE DRAWING			

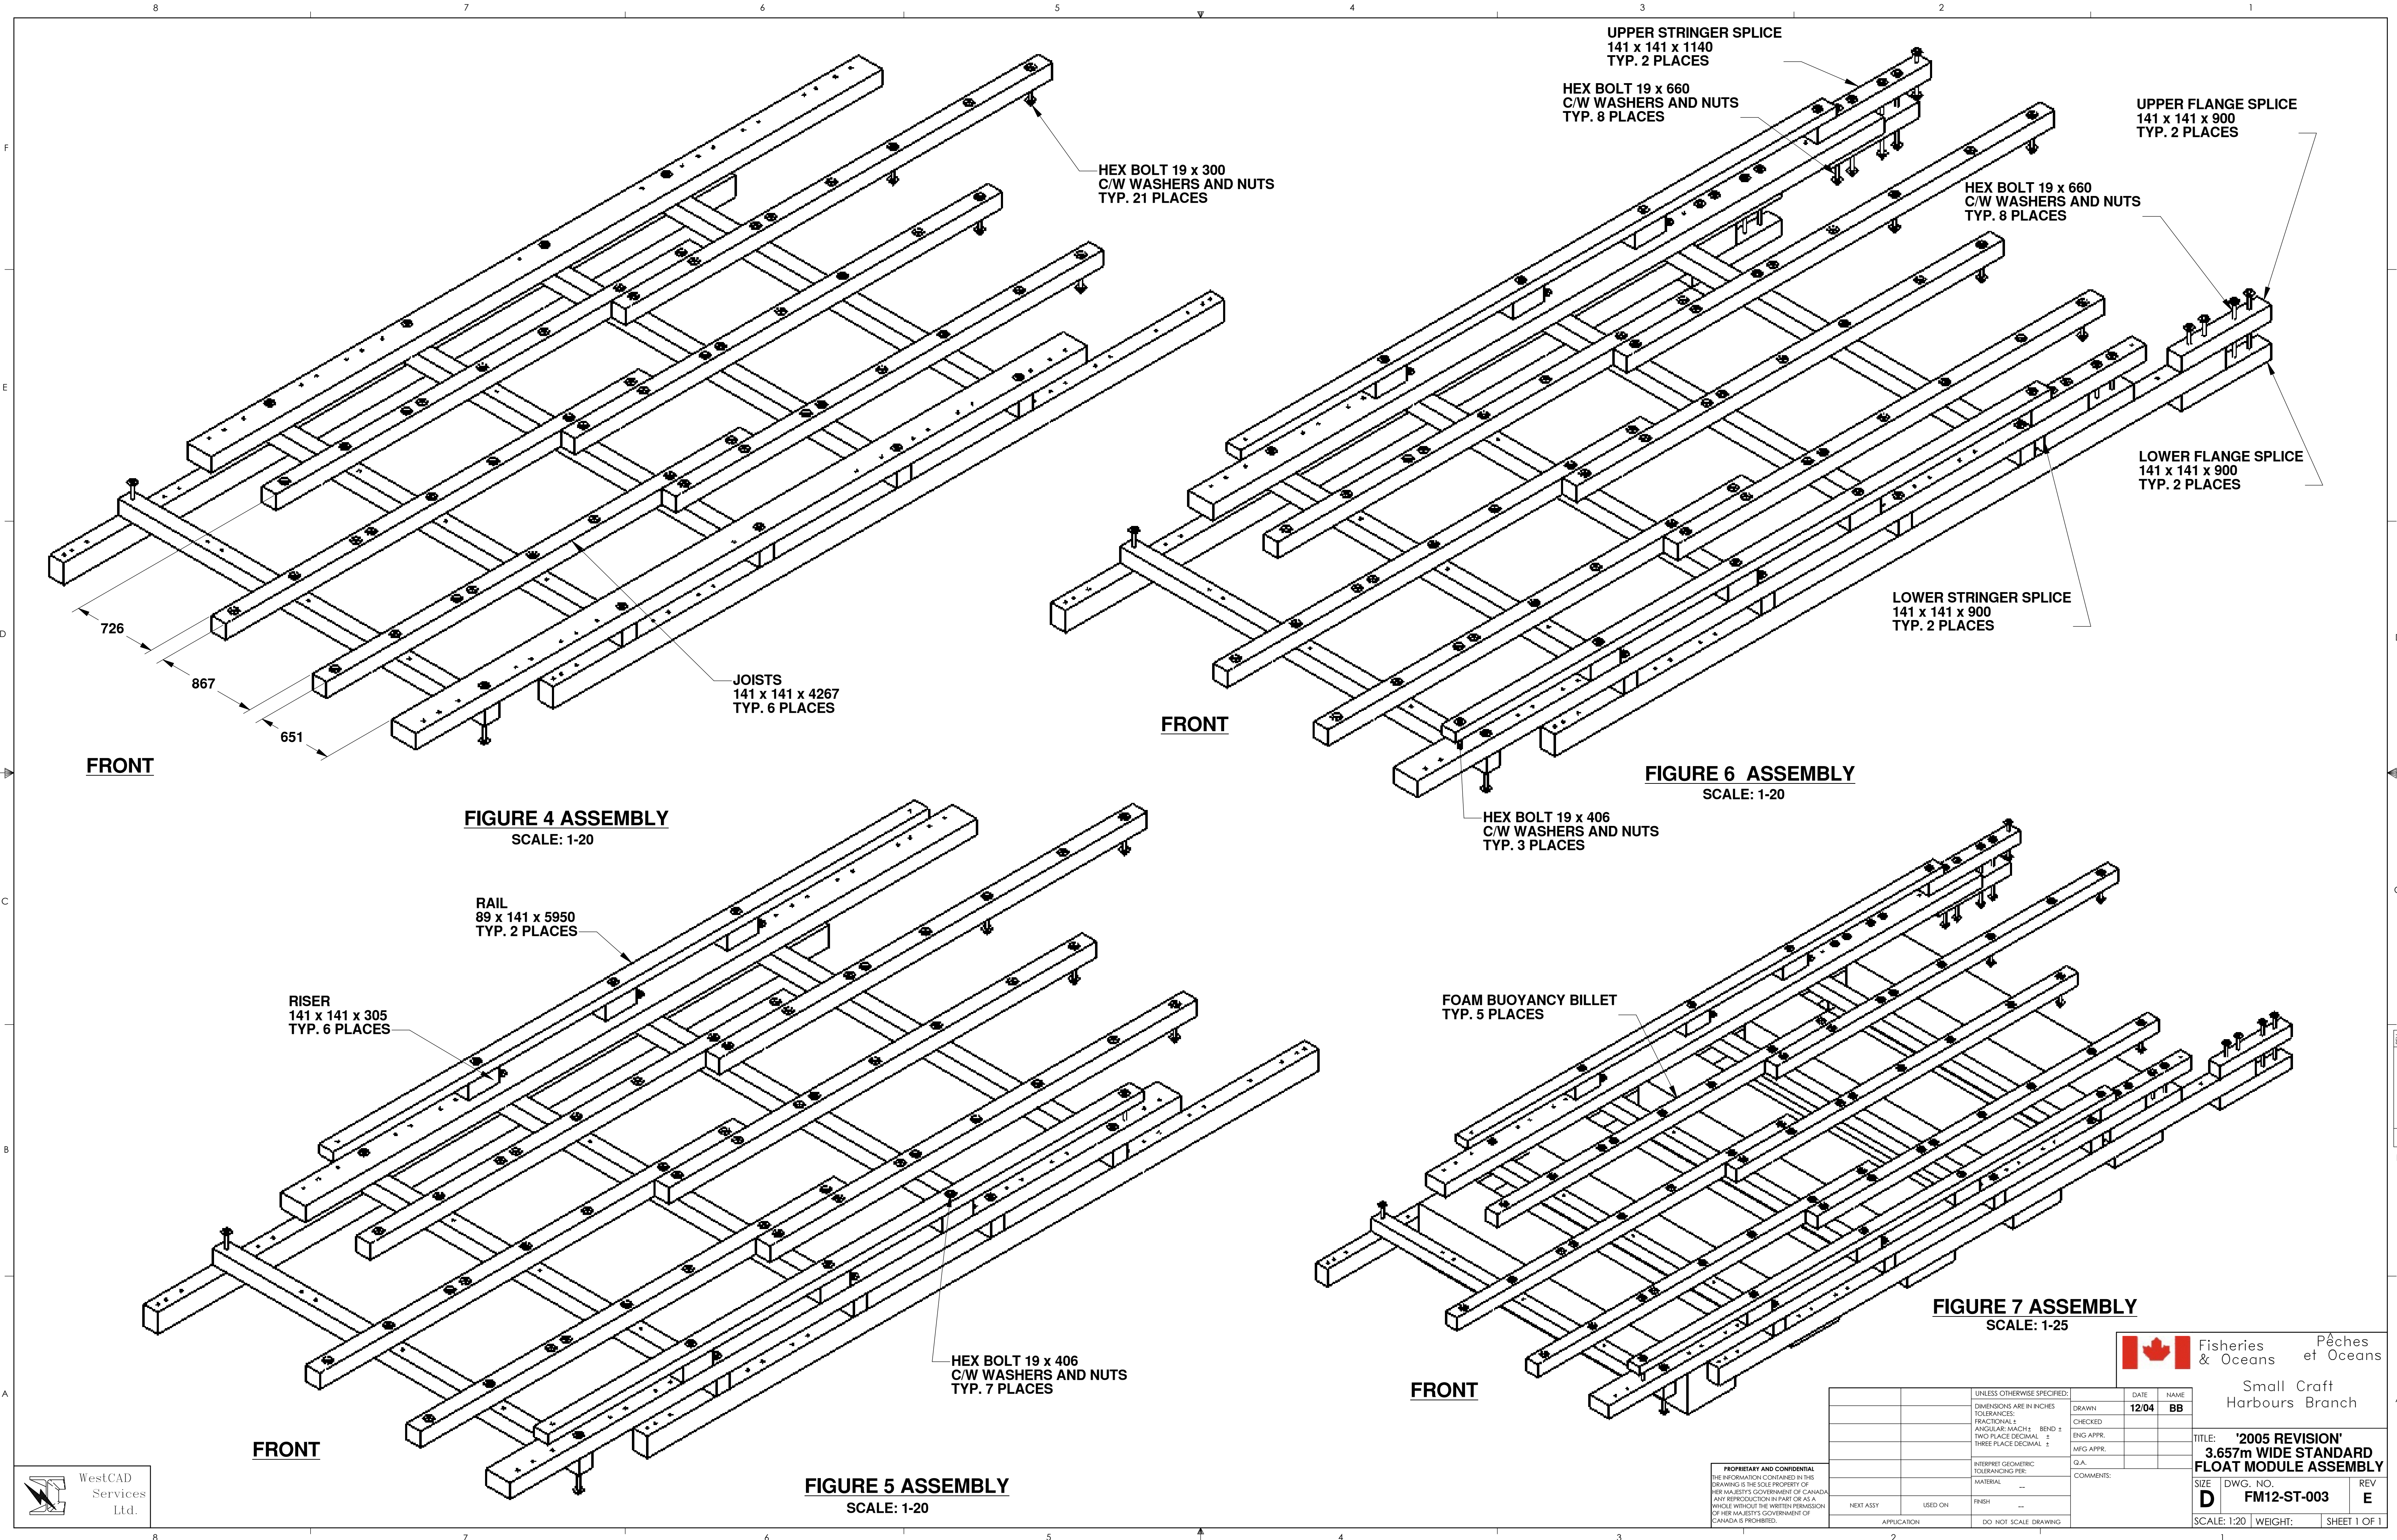

FRONT

**FIGURE 4 ASSEMBLY**  
SCALE: 1-20

RAIL  
89 x 141 x 5950  
TYP. 2 PLACES

RISER  
141 x 141 x 305  
TYP. 6 PLACES

FRONT

**FIGURE 5 ASSEMBLY**  
SCALE: 1-20

HEX BOLT 19 x 406  
C/W WASHERS AND NUTS  
TYP. 7 PLACES

FRONT

**FIGURE 6 ASSEMBLY**  
SCALE: 1-20

HEX BOLT 19 x 406  
C/W WASHERS AND NUTS  
TYP. 3 PLACES

FOAM BUOYANCY BILLET  
TYP. 5 PLACES

FRONT

**FIGURE 7 ASSEMBLY**  
SCALE: 1-25

UPPER STRINGER SPLICE  
141 x 141 x 1140  
TYP. 2 PLACES

HEX BOLT 19 x 660  
C/W WASHERS AND NUTS  
TYP. 8 PLACES

UPPER FLANGE SPLICE  
141 x 141 x 900  
TYP. 2 PLACES

HEX BOLT 19 x 660  
C/W WASHERS AND NUTS  
TYP. 8 PLACES

LOWER FLANGE SPLICE  
141 x 141 x 900  
TYP. 2 PLACES

LOWER STRINGER SPLICE  
141 x 141 x 900  
TYP. 2 PLACES

 Fisheries & Oceans / Pêches et Océans  
Small Craft Harbours Branch

TITLE: '2005 REVISION'  
3.657m WIDE STANDARD  
FLOAT MODULE ASSEMBLY


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D	FM12-ST-003	E

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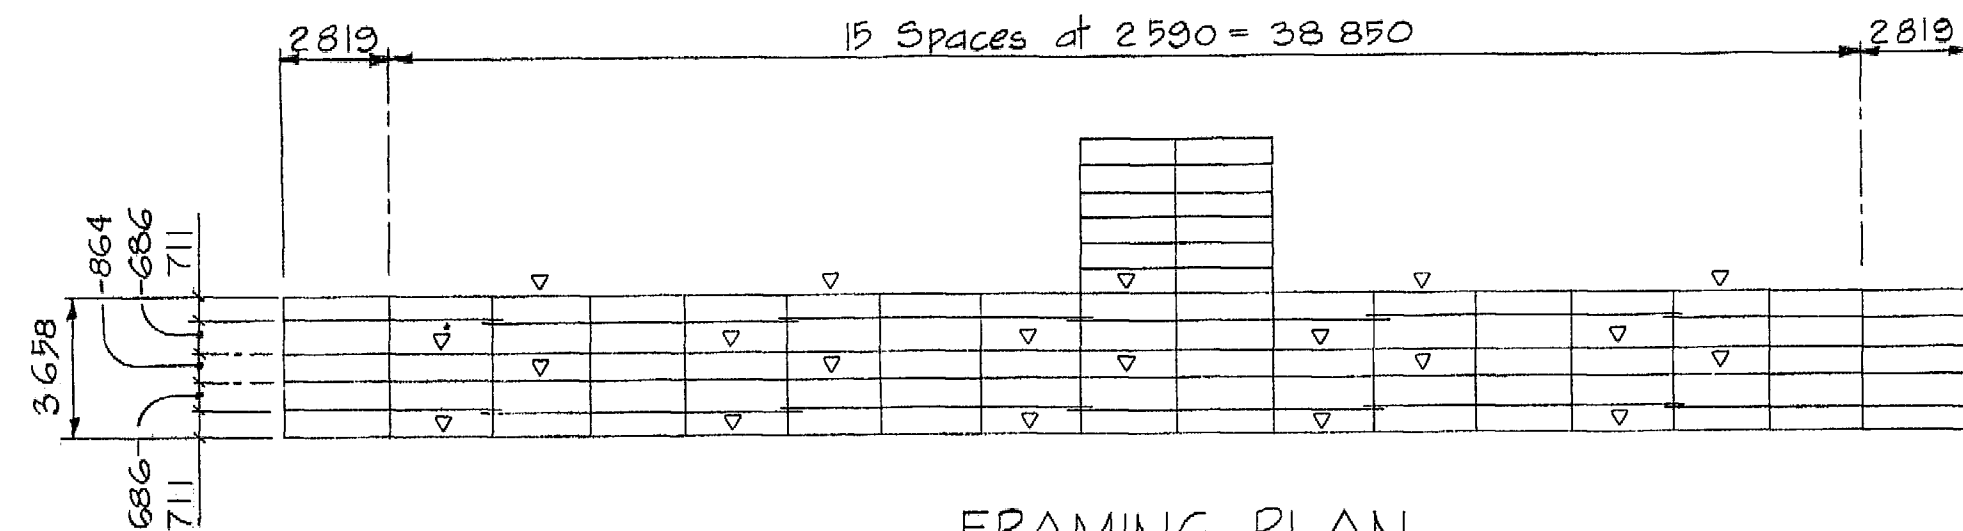
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UNLESS OTHERWISE SPECIFIED:		DATE	NAME
DIMENSIONS ARE IN INCHES		12/04	BB
TOLERANCES:			
FRACTIONAL ±			
ANGULAR: MAX ±			
TWO PLACE DECIMAL ±			
THREE PLACE DECIMAL ±			
INTERPRET GEOMETRIC TOLERANCING PER:			
MATERIAL			
FINISH			
APPLICATION			
DO NOT SCALE DRAWING			
NEXT ASSY			
USED ON			
COMMENTS:			







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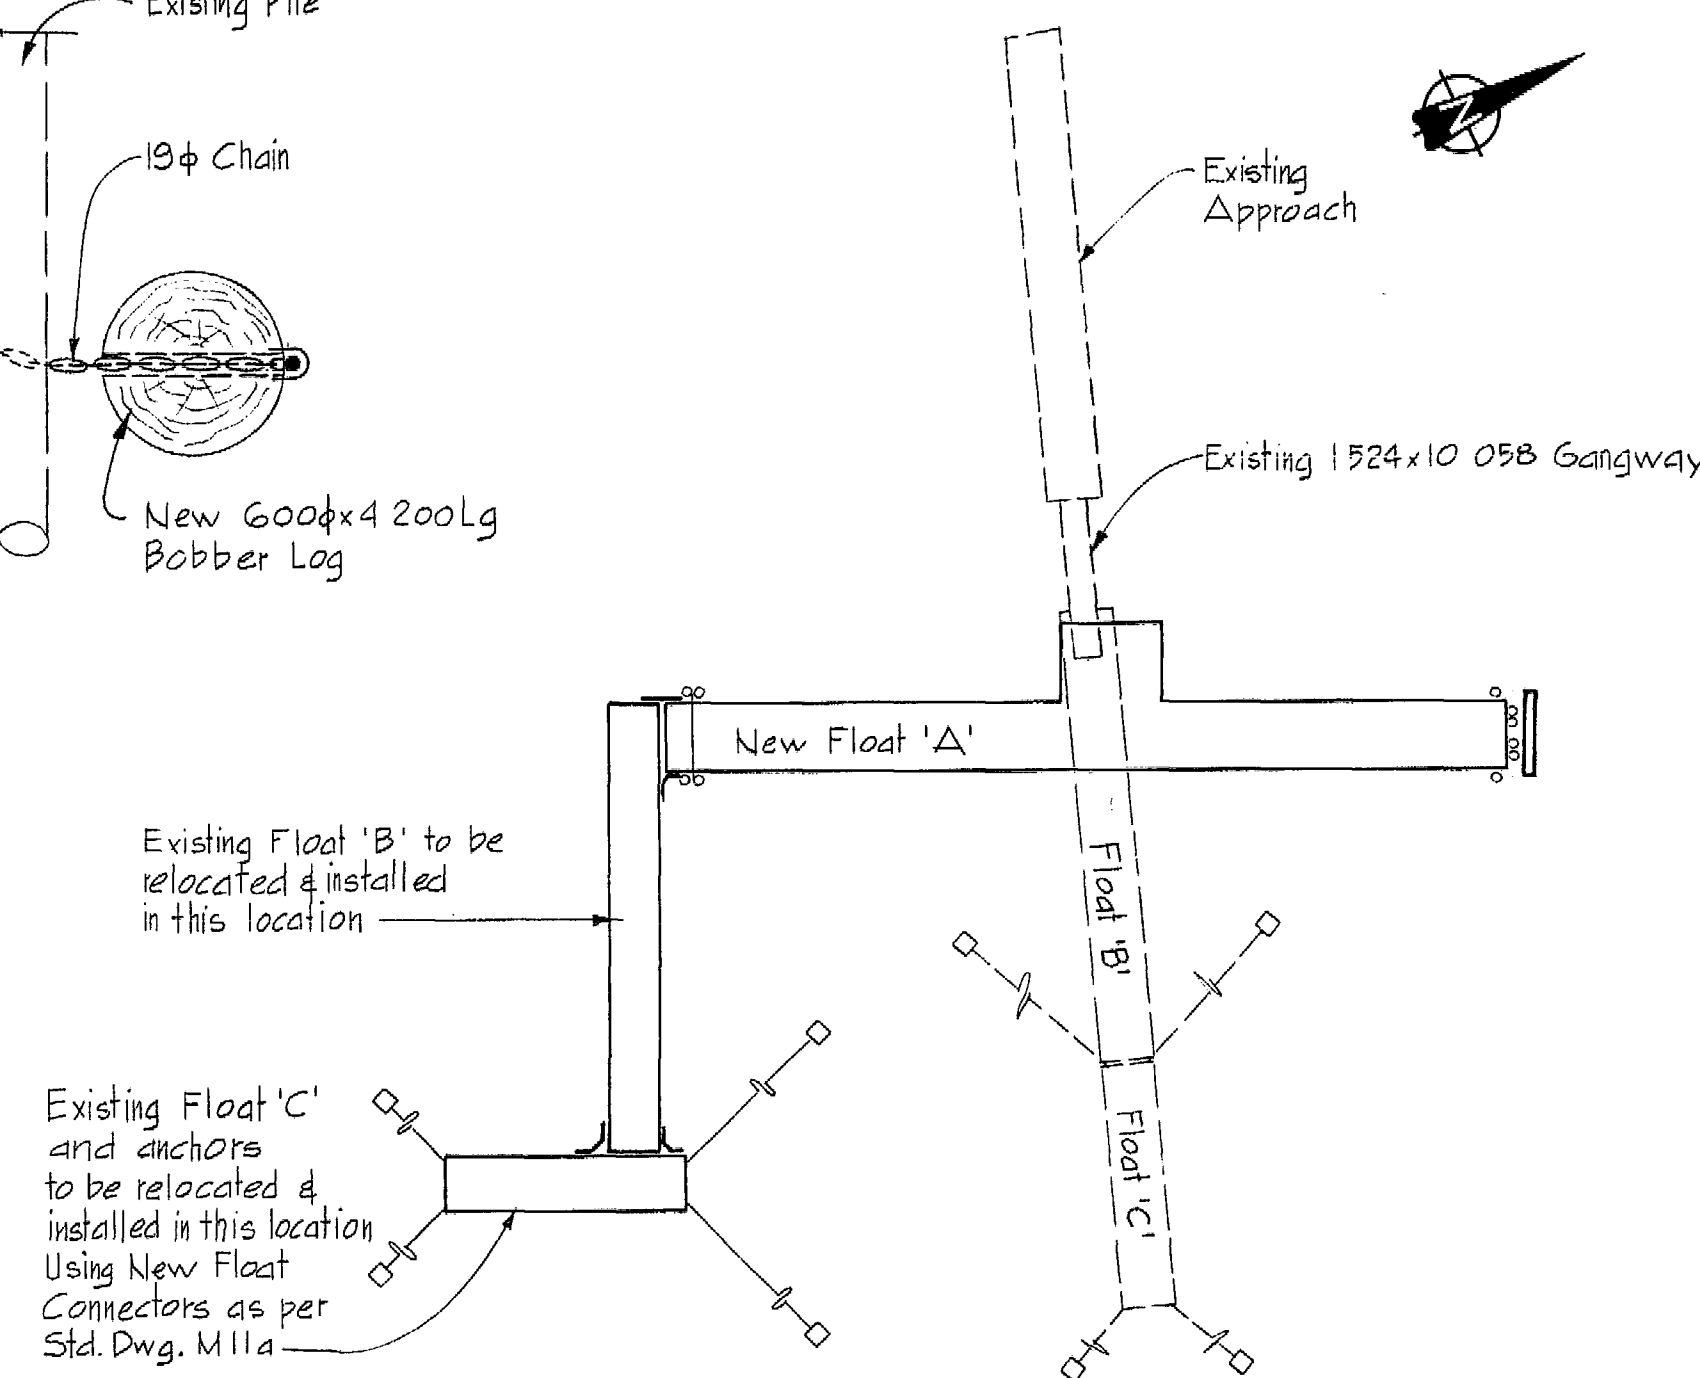
FRAMING PLAN  
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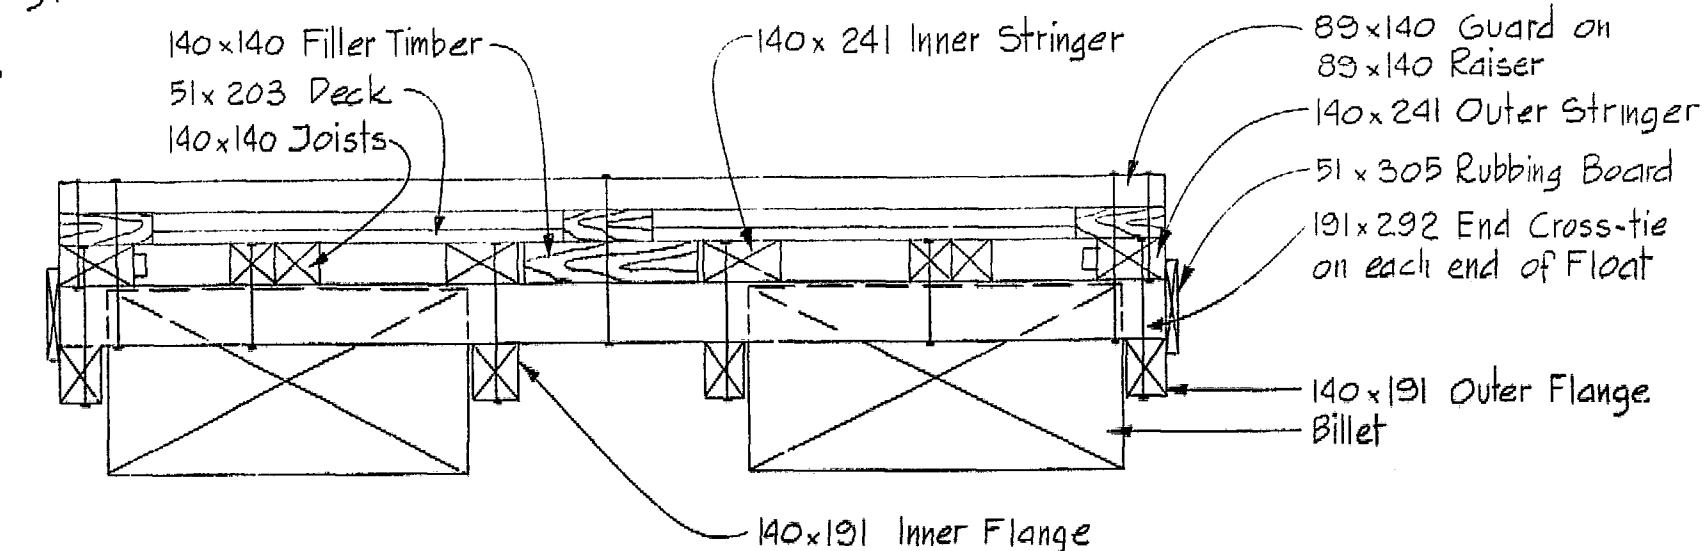
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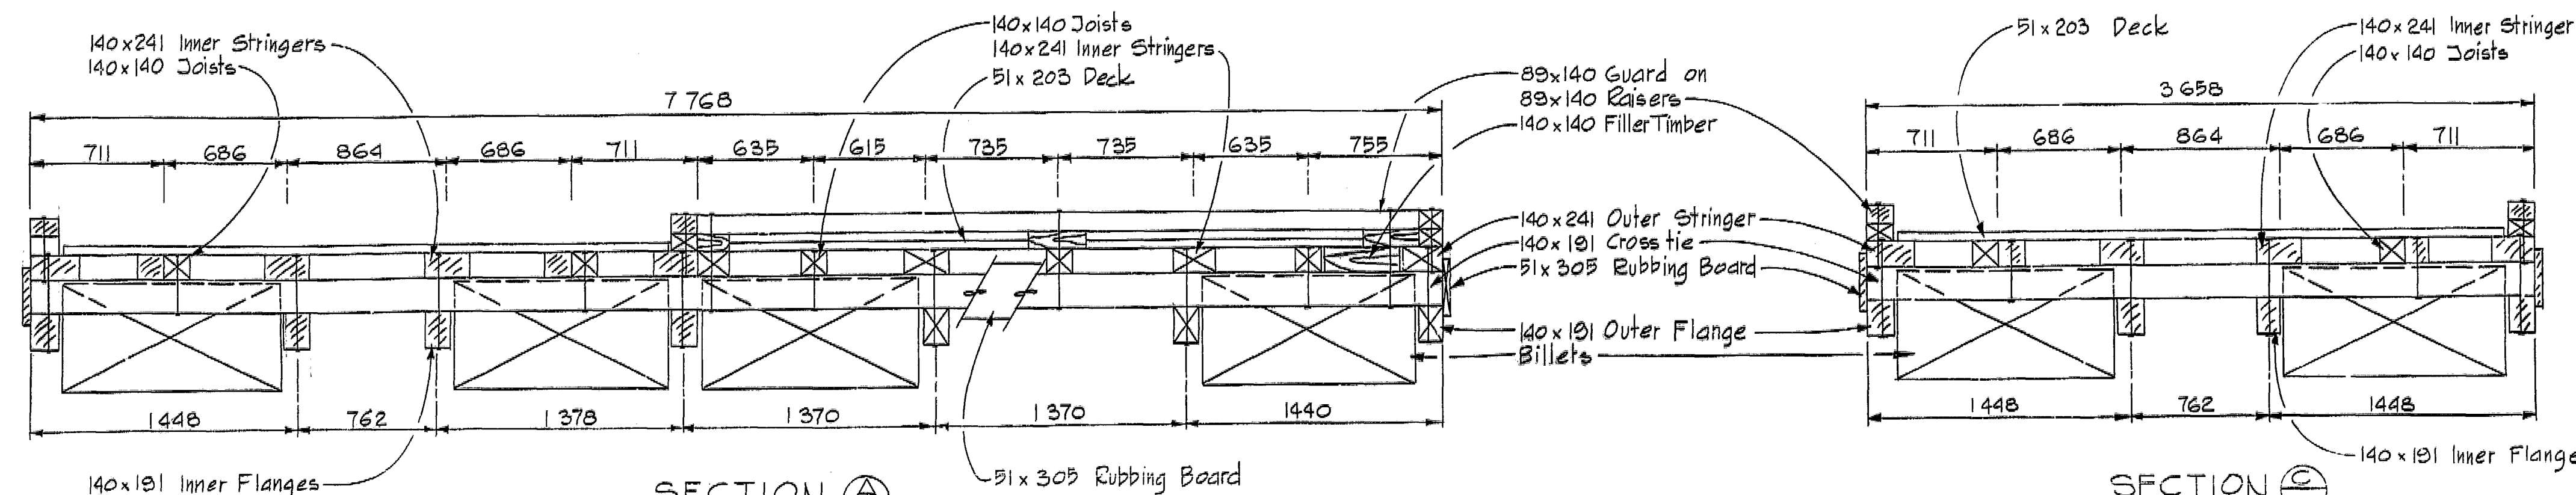
SECTION P  
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LAYOUT PLAN  
1:400

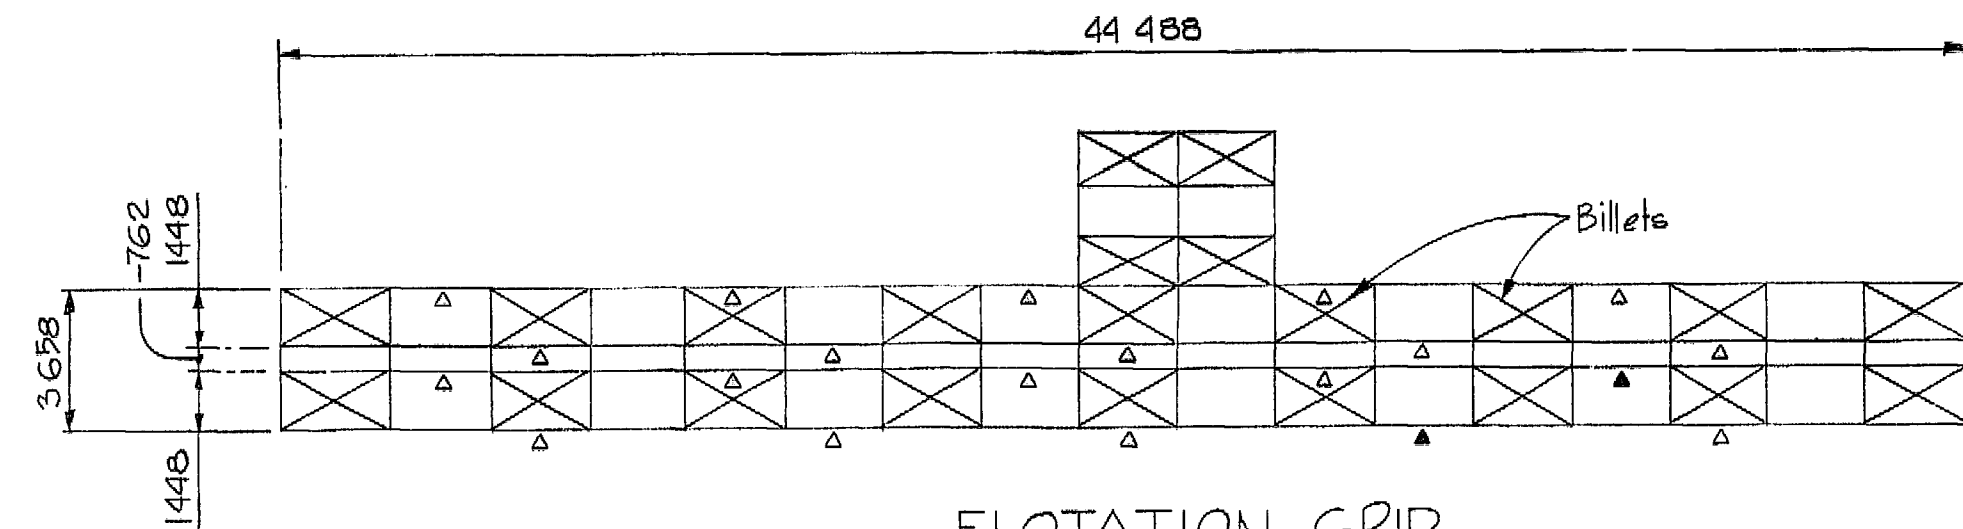


END VIEW B  
1:25

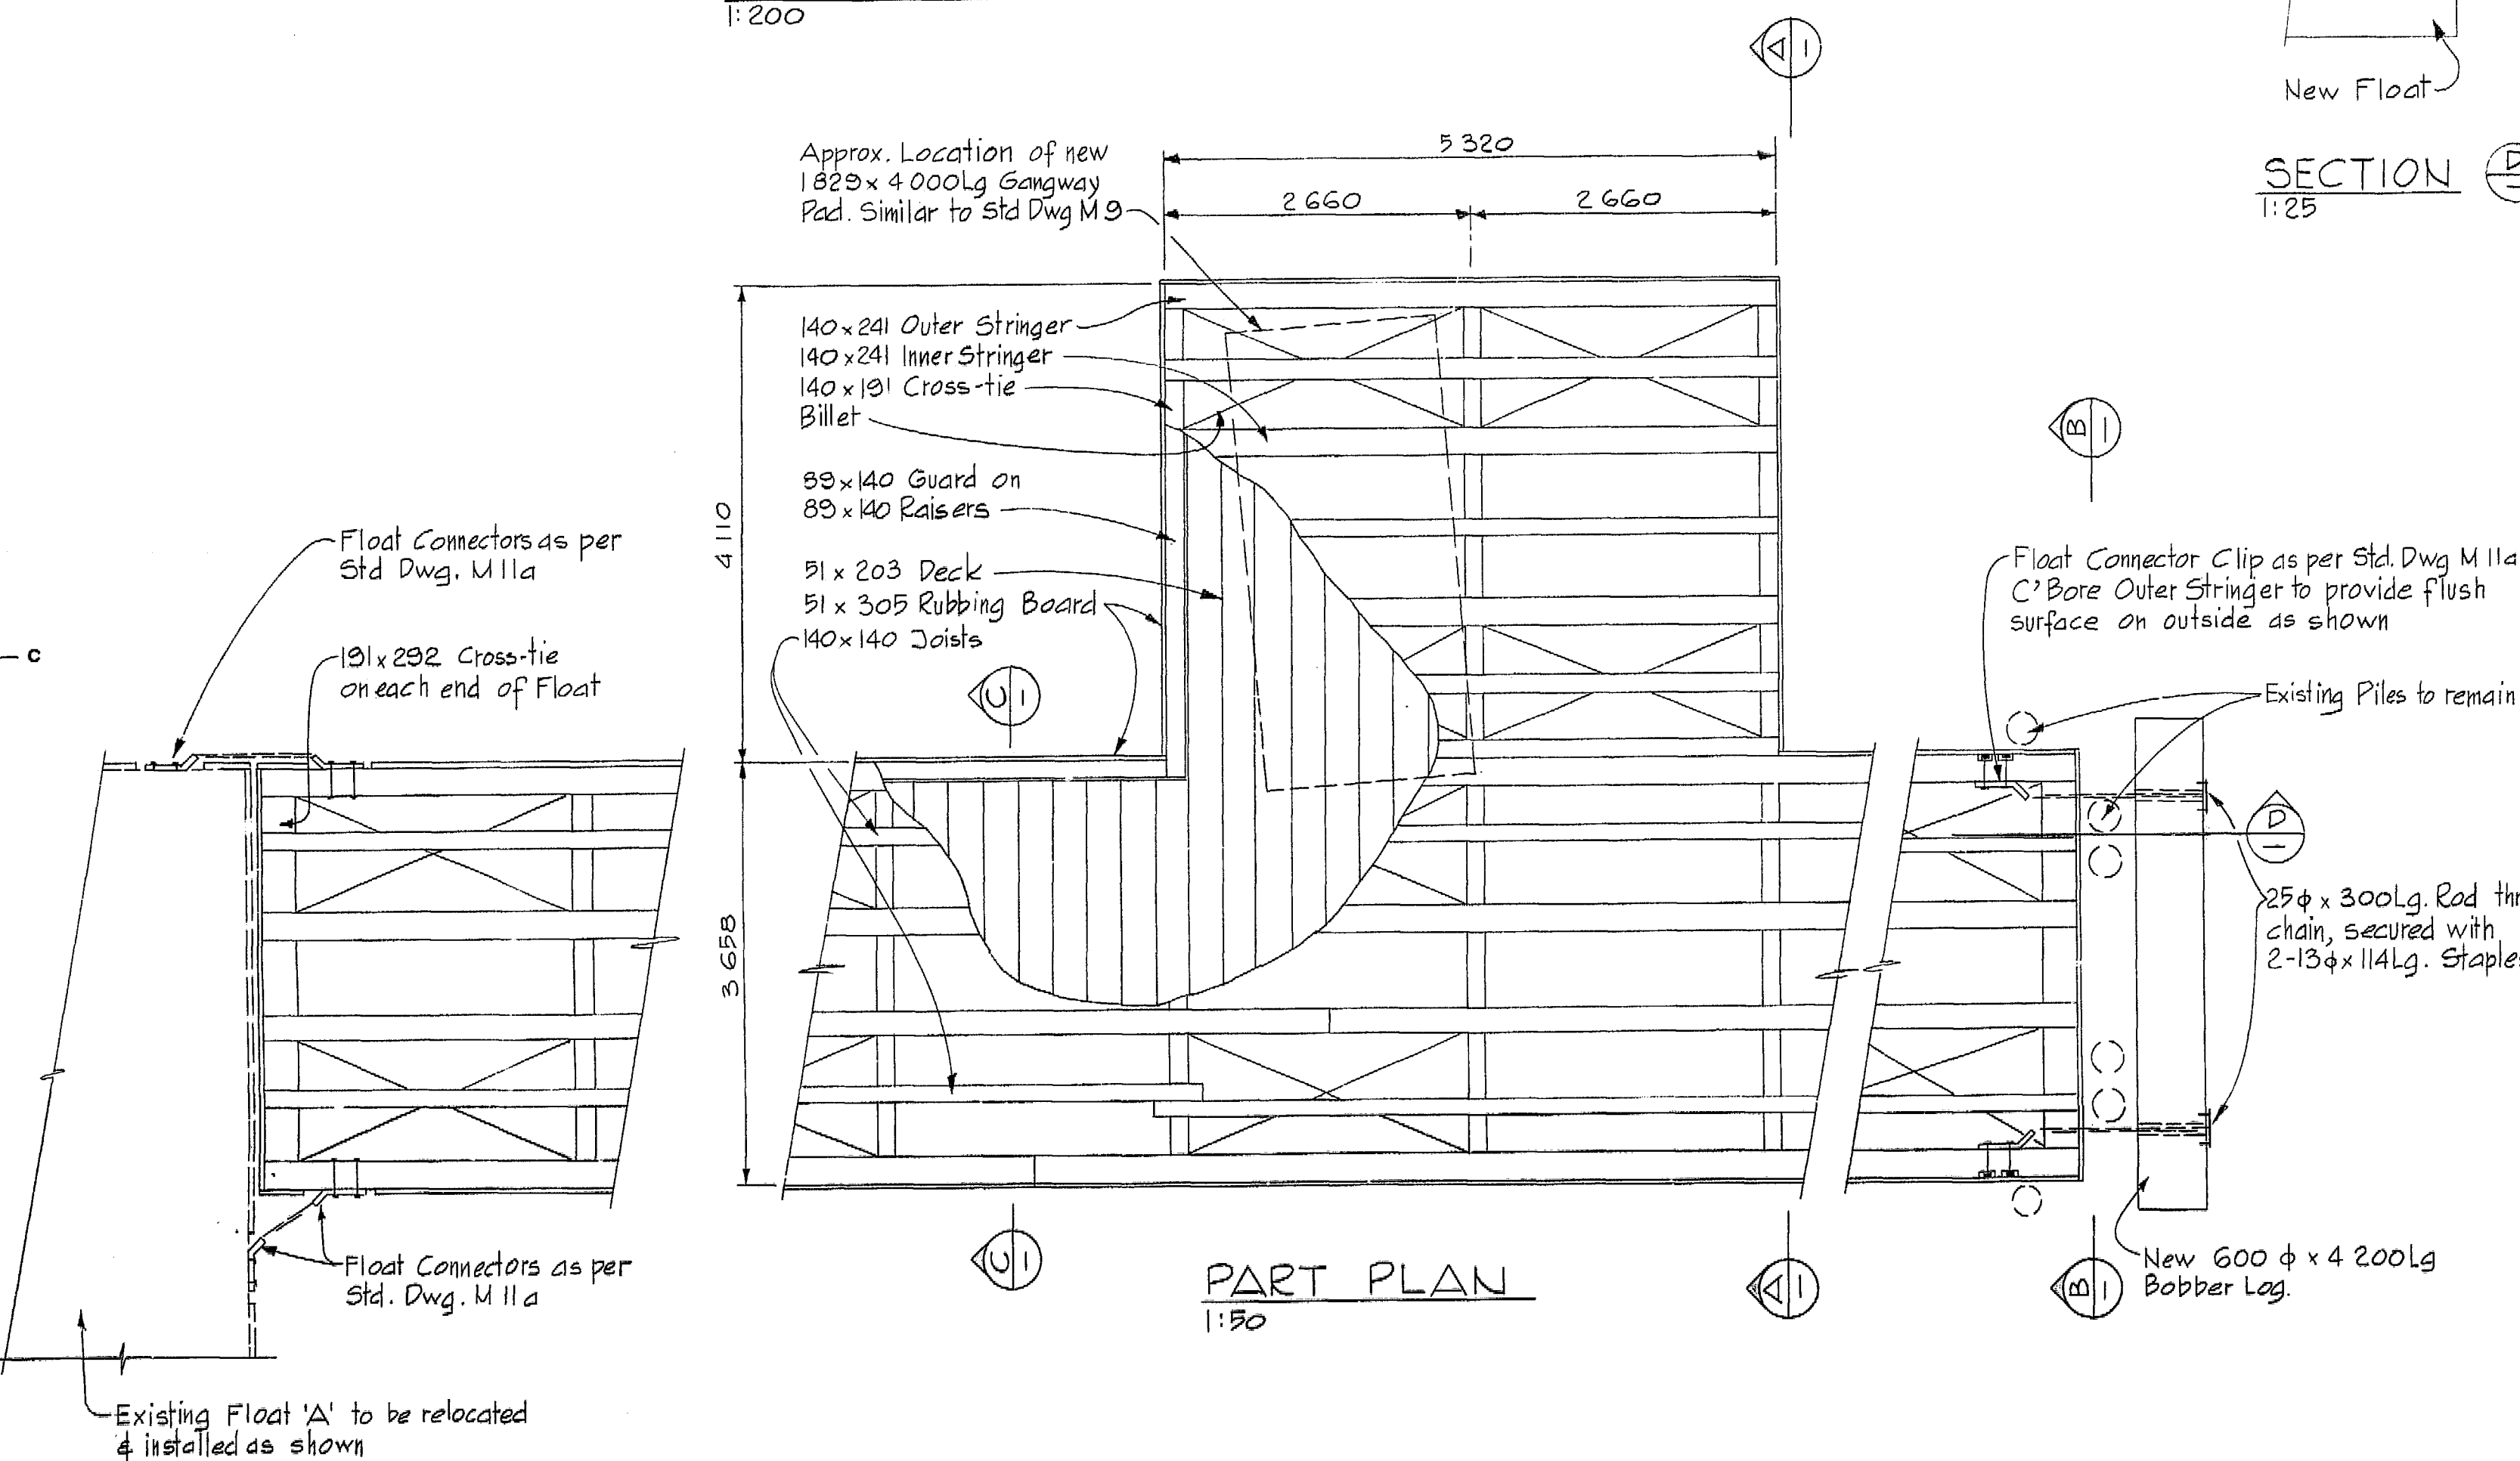

SECTION A  
1:25

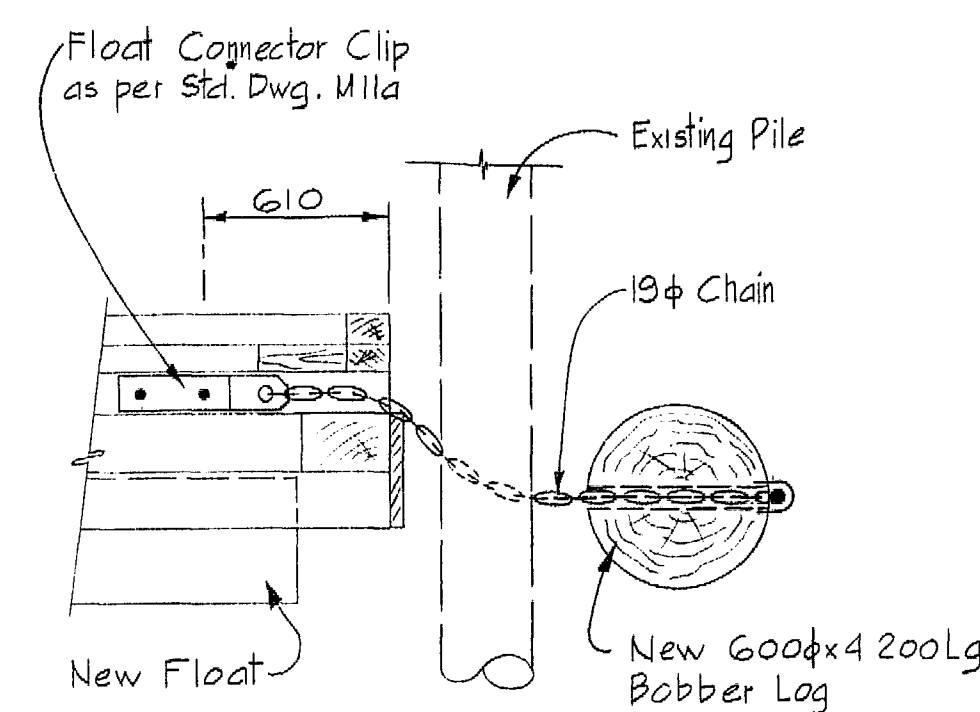SECTION C  
1:25

- LEGEND**
- △ Indicates Location of Outer & Inner Flange Splice See Std. Dwg. M 8 d & M 8 e
  - ▽ Indicates Location of Outer & Inner Stringer Splice See Std. Dwg. M 8 d & M 8 e
  - ⊠ Indicates Location of 610 x 1220 x 2440 Lg. Billets

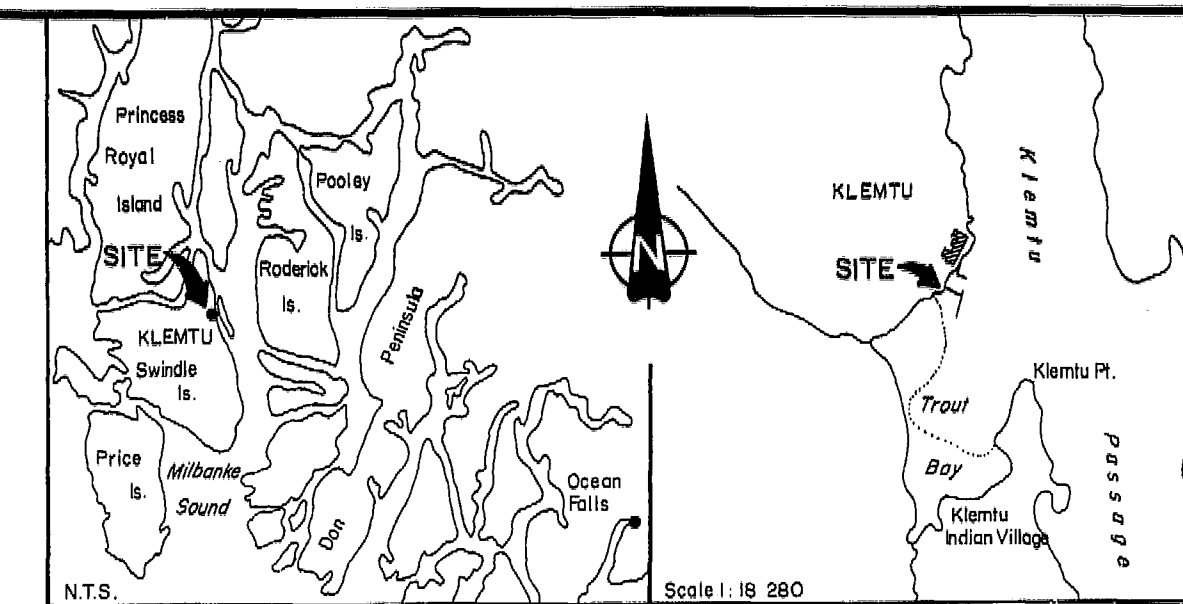


LOCATION CHARTS

Public Works Canada  
Travaux publics Canada

Pacific Region

Fisheries and Oceans  
Canada

revisions date

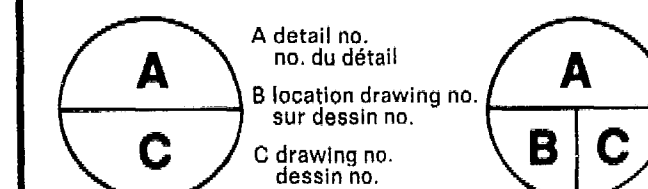

project project

KLEMTU, B.C.  
FLOAT  
CONSTRUCTION

drawing dessin

CONSTRUCTION  
DETAILS

designed D.T. conçu

date

drawn M.D.K. dessiné

date JUNE, 1981.

reviewed examiné

date 25 June 1981

approved approuvé

date

Tender Soumission


PWC Project Manager Administrateur de projets TPC






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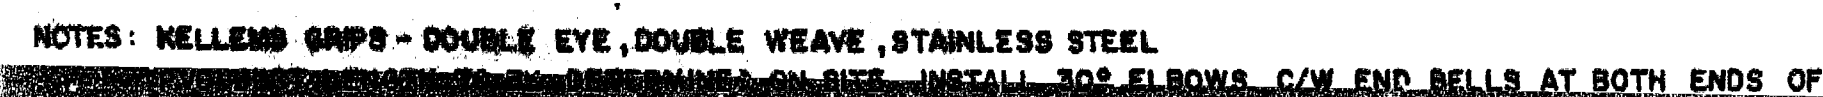
1 of 1

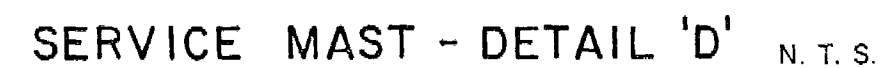

-  RECEPTACLE CABINET & L.P.S, LUMINAIRE  
 DISTRIBUTION CABINET  
 TREATED TIMBER MAST - 200 x 200 x 4877 mm  
 EXISTING WOOD POLE  
 DISTRIBUTION TRANSFORMER

## NOTES

- A. RECEPTACLE CABINETS ARE SUPPLIED BY P.W.C.(AS SHOWN IN DETAIL 'C' CONTRACTOR SHALL SUPPLY LUMINAIRES & LIGHTING MASTS AS SPECIFIED.
- B. DISTRIBUTION CABINET IS SUPPLIED BY P.W.C. CONTRACTOR SHALL SUPPLY A NEW PANEL AS SHOWN WITH A NEW 16 ga. STAINLESS STEEL FACEPLATE TO PROVIDE "DEAD FRONT" CONSTRUCTION.
- C. CONTRACTOR SHALL SUPPLY TRANSFORMER AS SPECIFIED IN DETAIL TO MEET NCPA ENGINEERING STANDARDS AND C. E. CODE REQUIREMENTS.
- D. INSTALL GROUNDING AS SPECIFIED.



GANGWAY WIRING - DETAIL 'A'  
N. T. S.

