


1 Mezzanine Plan
M400
SCALE 1:400

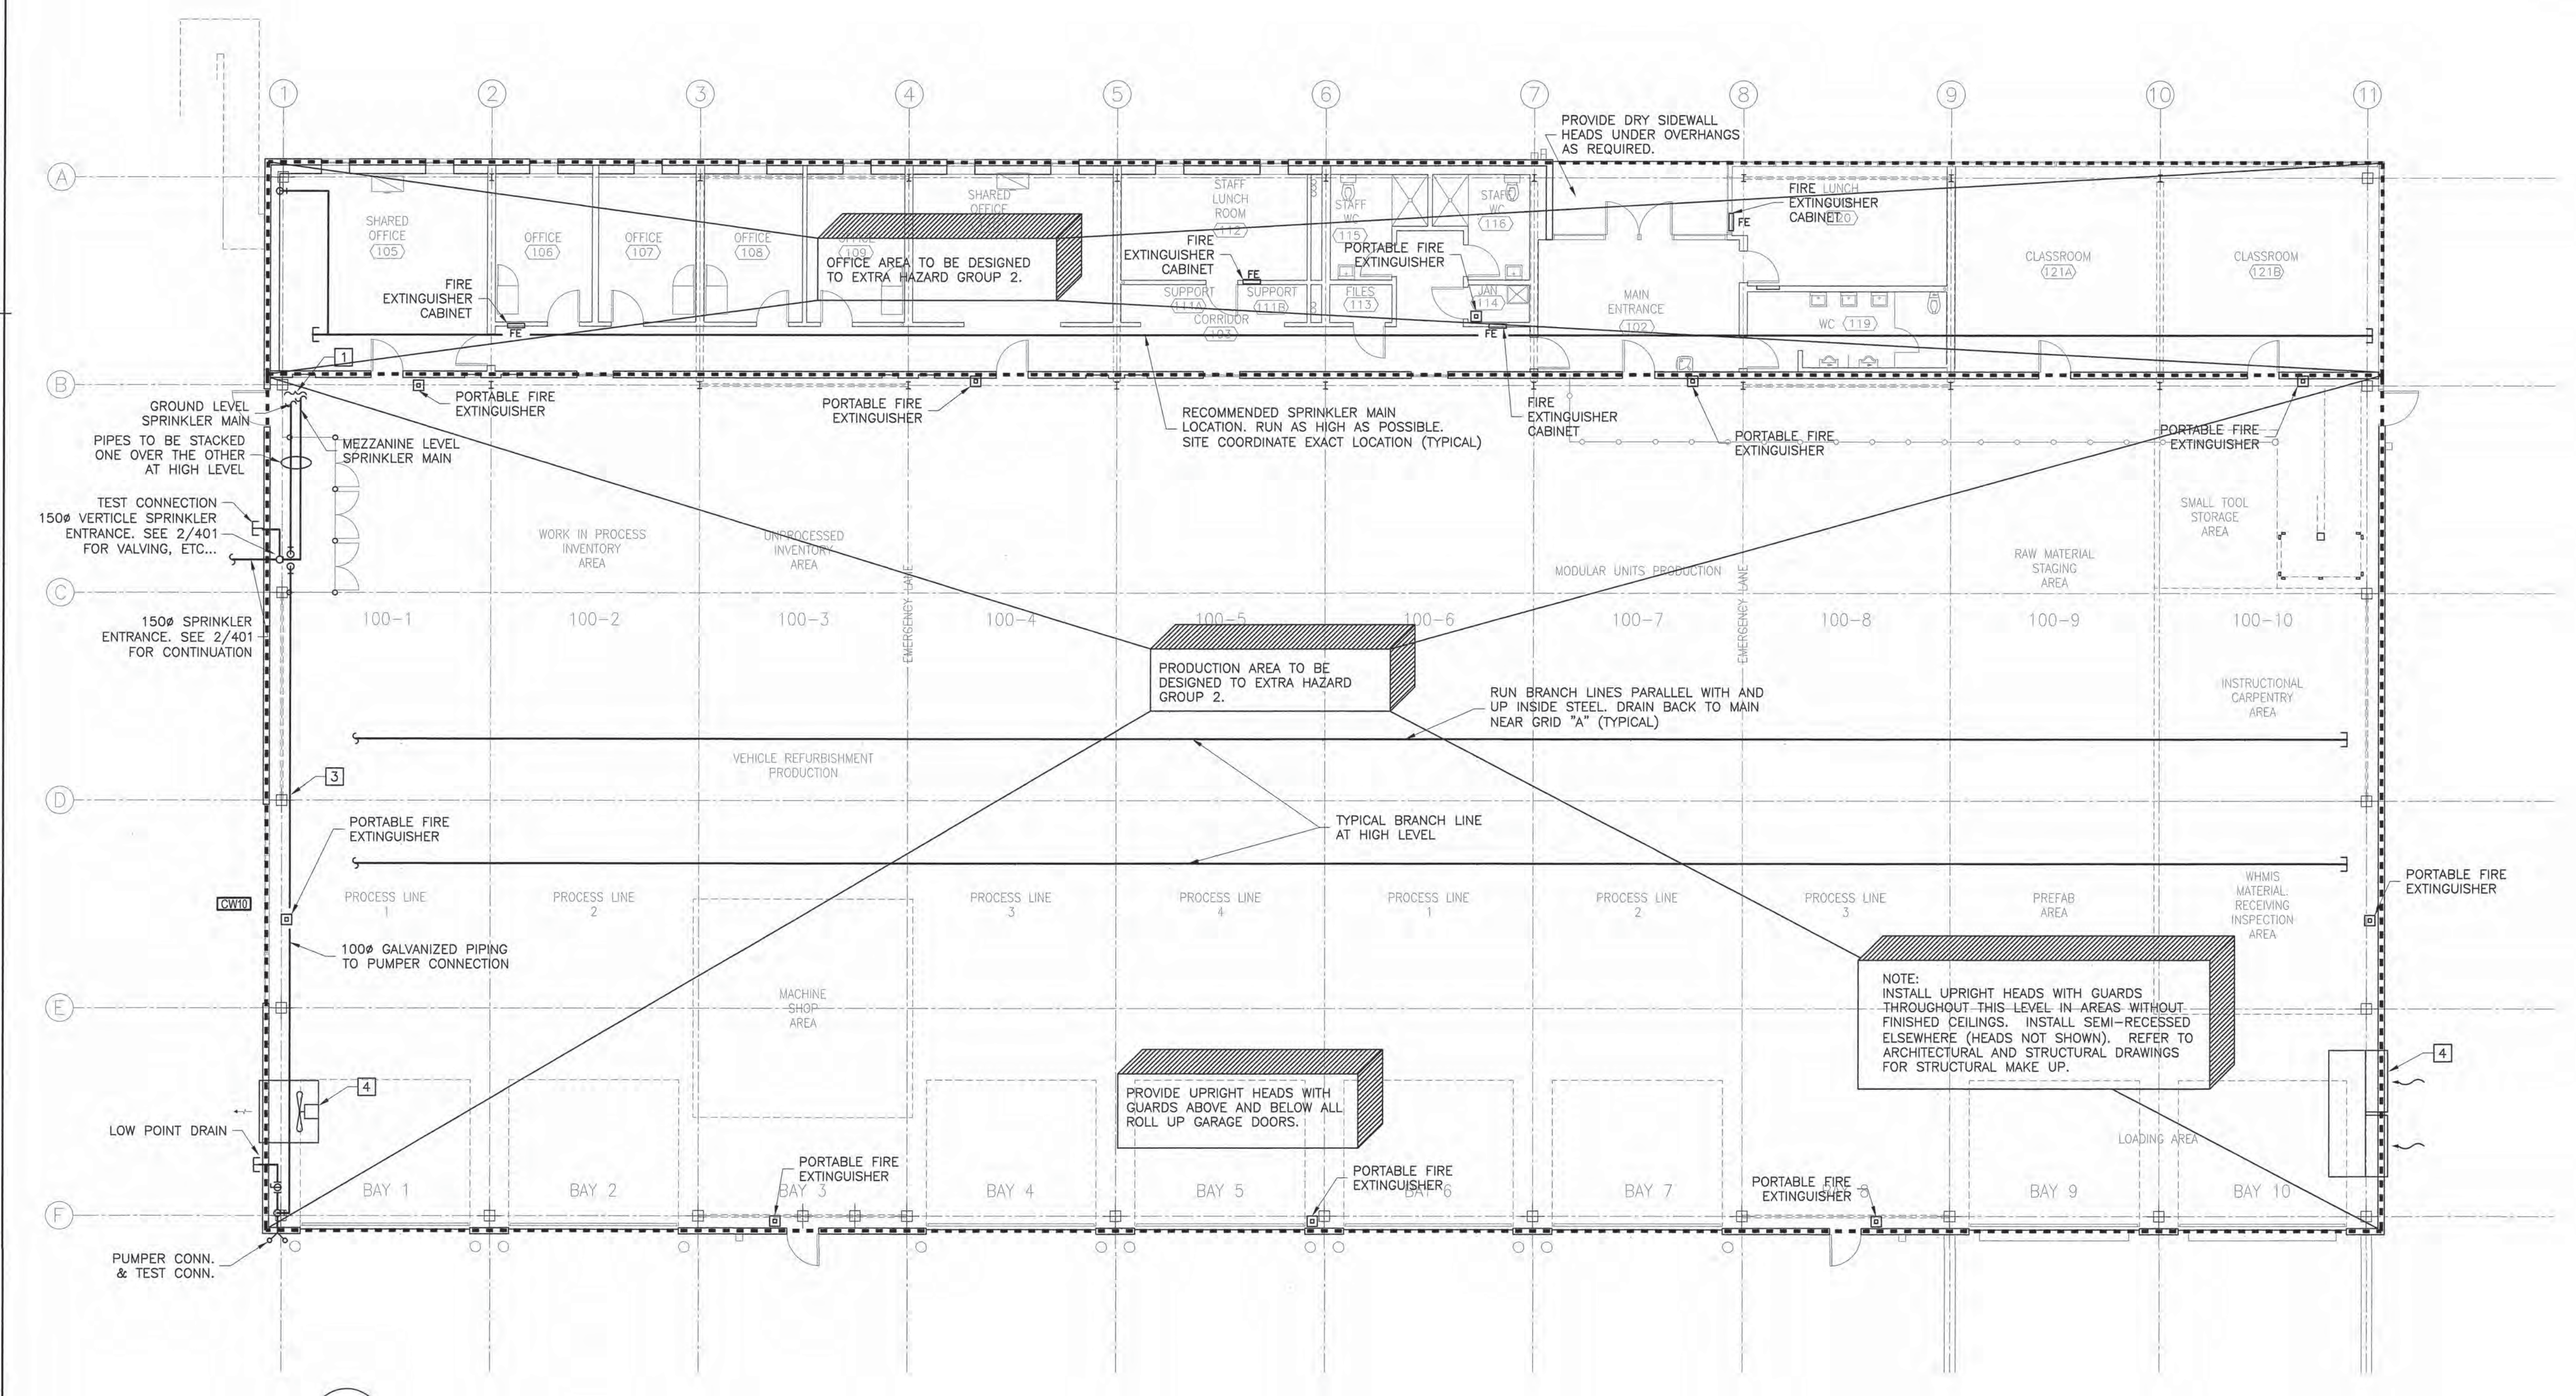

2 Main Floor Plan
M400
SCALE 1:400

- LEGEND:**
- SPRINKLER MAIN
 - BALL VALVE
 - CHECK VALVE
 - FIRE EXTINGUISHER
 - FIRE EXTINGUISHER CABINET
 - SIAMESE CONNECTION
 - GATE VALVE
 - CONTROL VALVE W/ SUPERVISORY SWITCH
 - PRESSURE GAUGE
 - FLOW SWITCH
 - INSPECTOR'S TEST CONNECTION
 - FIRE PROTECTION ZONE LIMIT

- REFERENCE NOTES:**
- 1 GROUND FLOOR MAIN AND MEZZANINE ZONE MAIN SHALL RUN ABOVE MEZZANINE. SEE 1/M400 FOR CONTINUATION.
 - 2 GROUND FLOOR MAIN AND MEZZANINE ZONE MAIN SHALL RUN IN PRODUCTION AREA CEILING SPACE BACK TO SPRINKLER ENTRANCE. SEE 2/M400 AND 2/401 FOR CONTINUATION.
 - 3 RUN ALL PIPING IN PRODUCTION AREA AS HIGH AS POSSIBLE. COORDINATE WITH OTHER TRADES AND OFFSET WHERE REQUIRED TO AVOID SERVICES. INSTALL LOW POINT DRAINS AS REQUIRED. (TYPICAL)
 - 4 PROVIDE UPRIGHT HEAD UNDER MECHANICAL EQUIPMENT/DUCTWORK WIDER THAN 1200mm AS REQUIRED.

Public Works and Government Services Canada / Travaux publics et Services gouvernementaux Canada

Real Property Operations Branch
Real Property Operations Solutions
Direction générale des opérations immobilières
Solutions - Opérations immobilières

Project Delivery & Professional and Technical Services
Exécution de projets et Services experts/consils techniques

Watson MacEwen Teramura Architects
400-116 Lisgar Street
Ottawa, ON K2P 0G2
1-613-232-0330
1-613-232-6263

Structural Engineers
Halsell Associates
4001-210 Gladstone Avenue
Ottawa, ON K2P 0Y6
613.237.2462

Mechanical / Electrical Eng.
-bpa
100-1960 Robertson Road
Ottawa, ON K2H 5B9
613.596.6454

Civil Engineers
WSP Group
201-124 Gardiners Road
Kingston, Ontario K7P 0G2
613.634.7373

IT-Telecommunications
The Altam Group
208-1860 Woodward Drive
Ottawa, ON K2C 3R7
613.739.9424

key plan plan-06

01	ISSUED FOR TENDER	2015/03/26
revision	description	date
A	A detail no. du detail	A
B	B location drawing no. sur dessin no.	B
C	C drawing no. dessin no.	C

project project

CSC MULTI-PURPOSE BUILDING
CBI MINIMUM INSTITUTION (FRONTENAC)
KINGSTON, ONTARIO


drawing dessin

FIRE PROTECTION PLANS

designed	M.L.W.	conçu
date	2014/05/06	(yyyy/mm/dd)
drawn	C.B.	dessiné
date	2014/05/06	(yyyy/mm/dd)
reviewed	M.L.W.	examiné
date	2014/05/06	(yyyy/mm/dd)
approved	M.L.W.	approuvé
date	2014/05/06	(yyyy/mm/dd)
Tender	DUNCAN PARKER	Soumission
Project Manager	Administrateur de projets	
project no.	no. du projet	
	R.055776.001	
drawing no.	no. du dessin	
	M400	

07.04.2014

07.04.2014

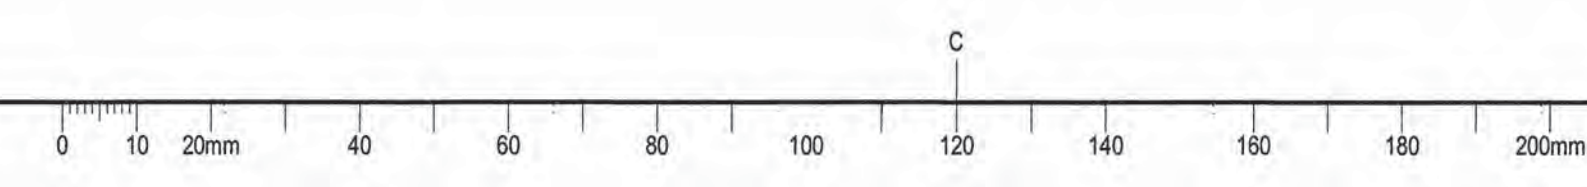



revision	description	date
01	ISSUED FOR TENDER	2015/03/26

A	A
C	B

A detail no.
no. du détail
B location drawing no.
sur dessin no.
C drawing no.
dessin no.

project projet
CSC MULTI-PURPOSE BUILDING
CBI MINIMUM INSTITUTION (FRONTENAC)
KINGSTON, ONTARIO


drawing dessin
FIRE PROTECTION DETAILS

designed	M.L.W.	conçu
date	2014/05/06	(yyyy/mm/dd)
drawn	C.B.	dessiné
date	2014/05/06	(yyyy/mm/dd)
reviewed	M.L.W.	examiné
date	2014/05/06	(yyyy/mm/dd)
approved	M.L.W.	approuvé
date	2014/05/06	(yyyy/mm/dd)
Tender	DUNCAN PARKER	Soumission


Project Manager Administrateur de projets

project no. no. du projet
R.055776.001


drawing no. no. du dessin
M401

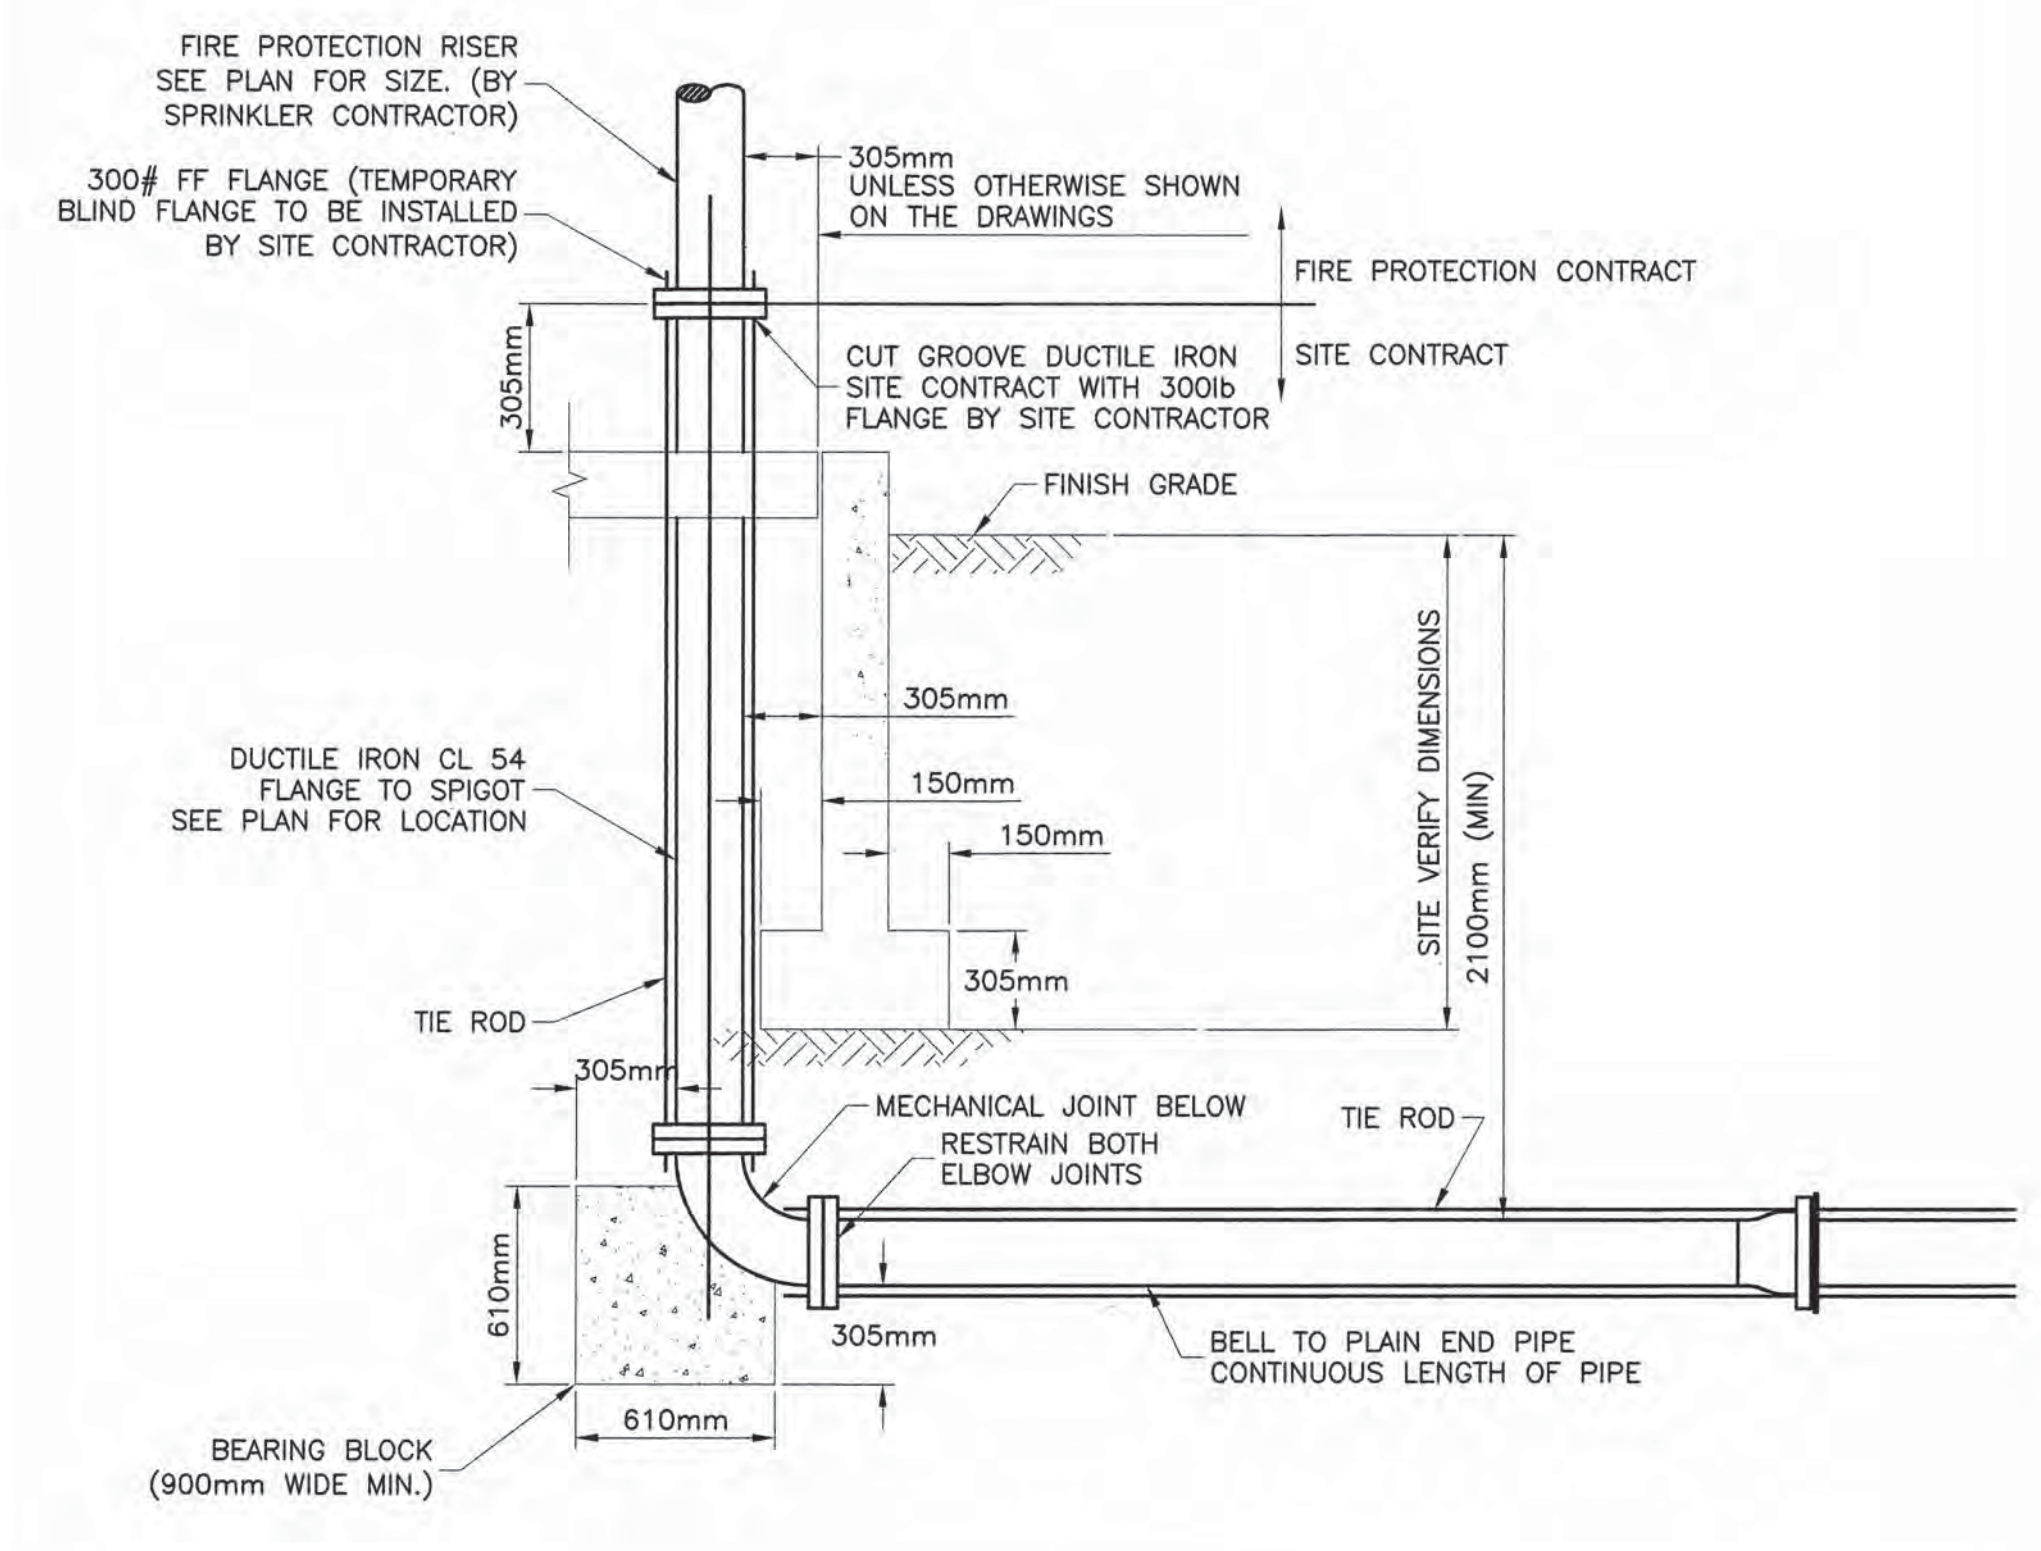

1 Fire Main Entrance
M401
SCALE : N.T.S.

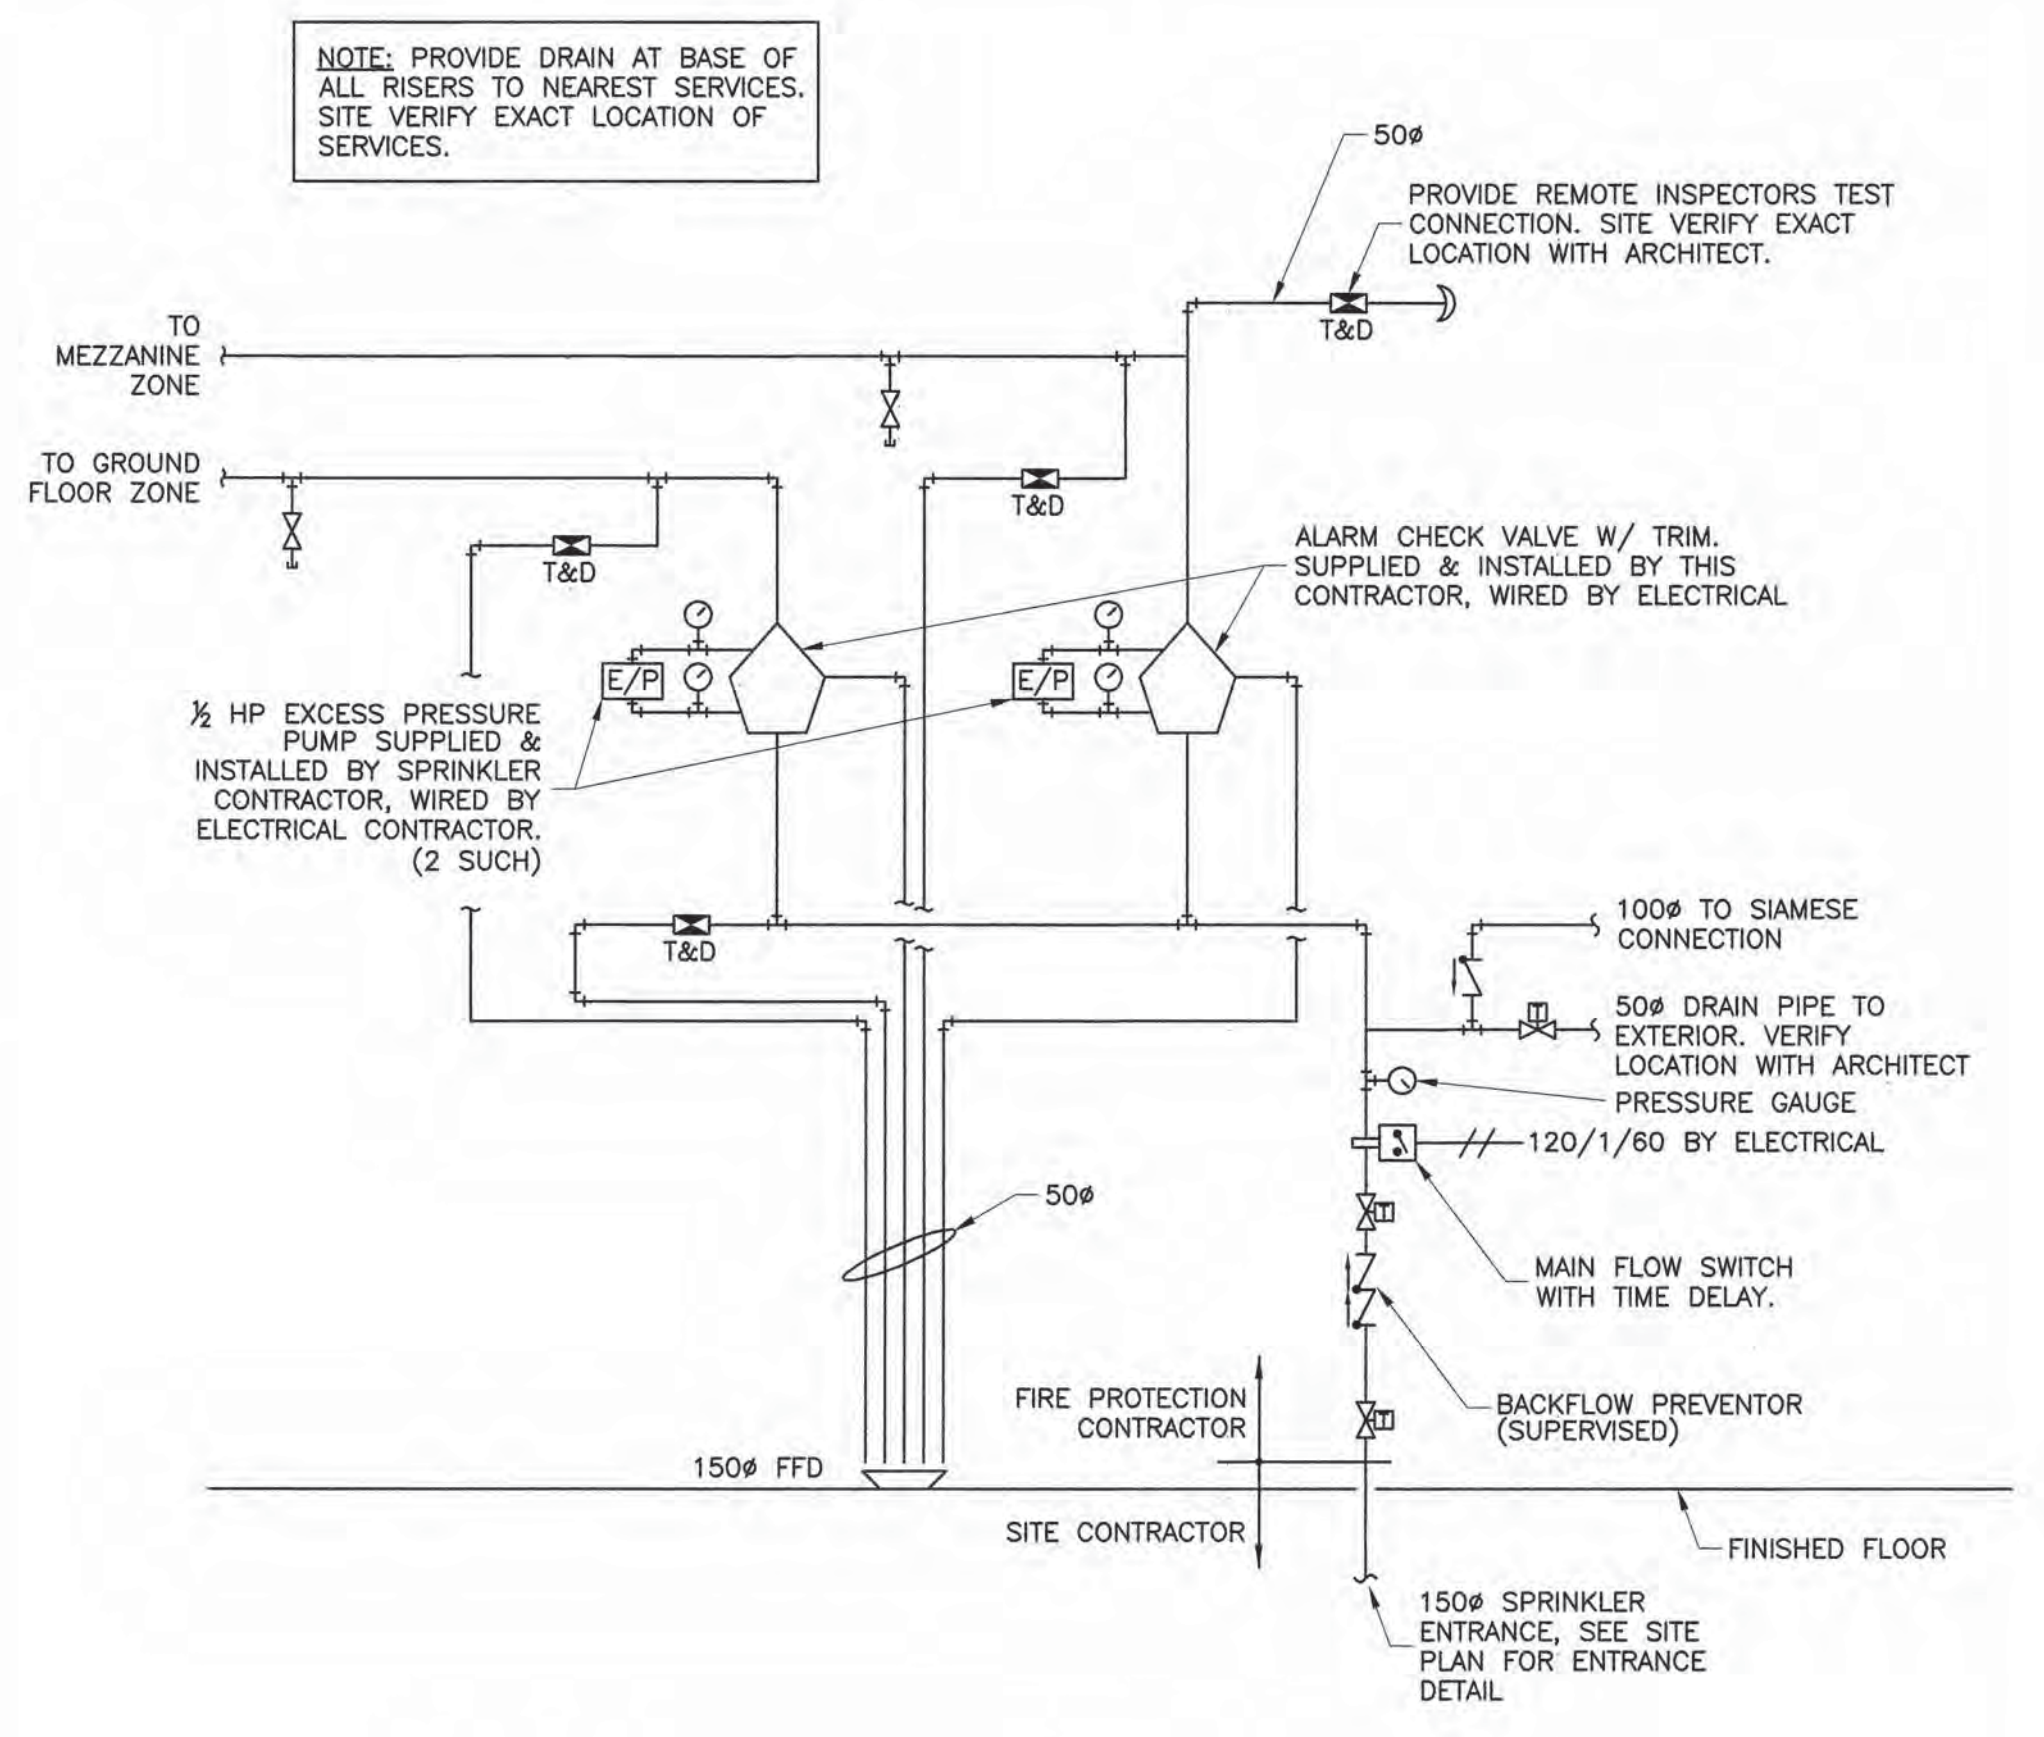

2 Sprinkler Entrance Schematic
M401
SCALE : N.T.S.

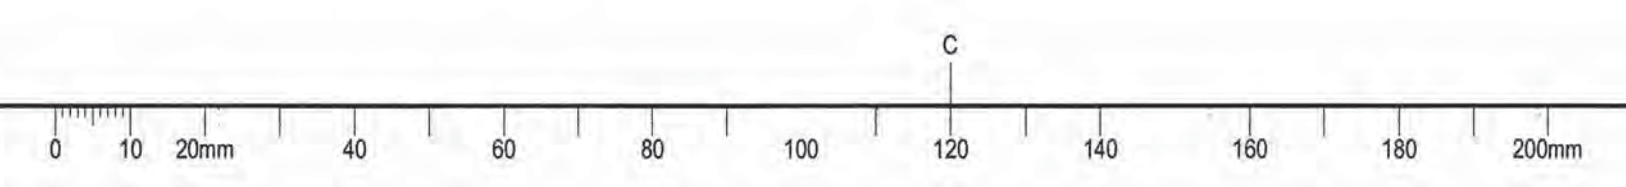

07.04.2014