


1
S02

FRAMING PLAN — WATER TANK PLATFORM

SCALE : 1:20

0mm 500mm 1000mm 1500mm 2000mm 2500mm

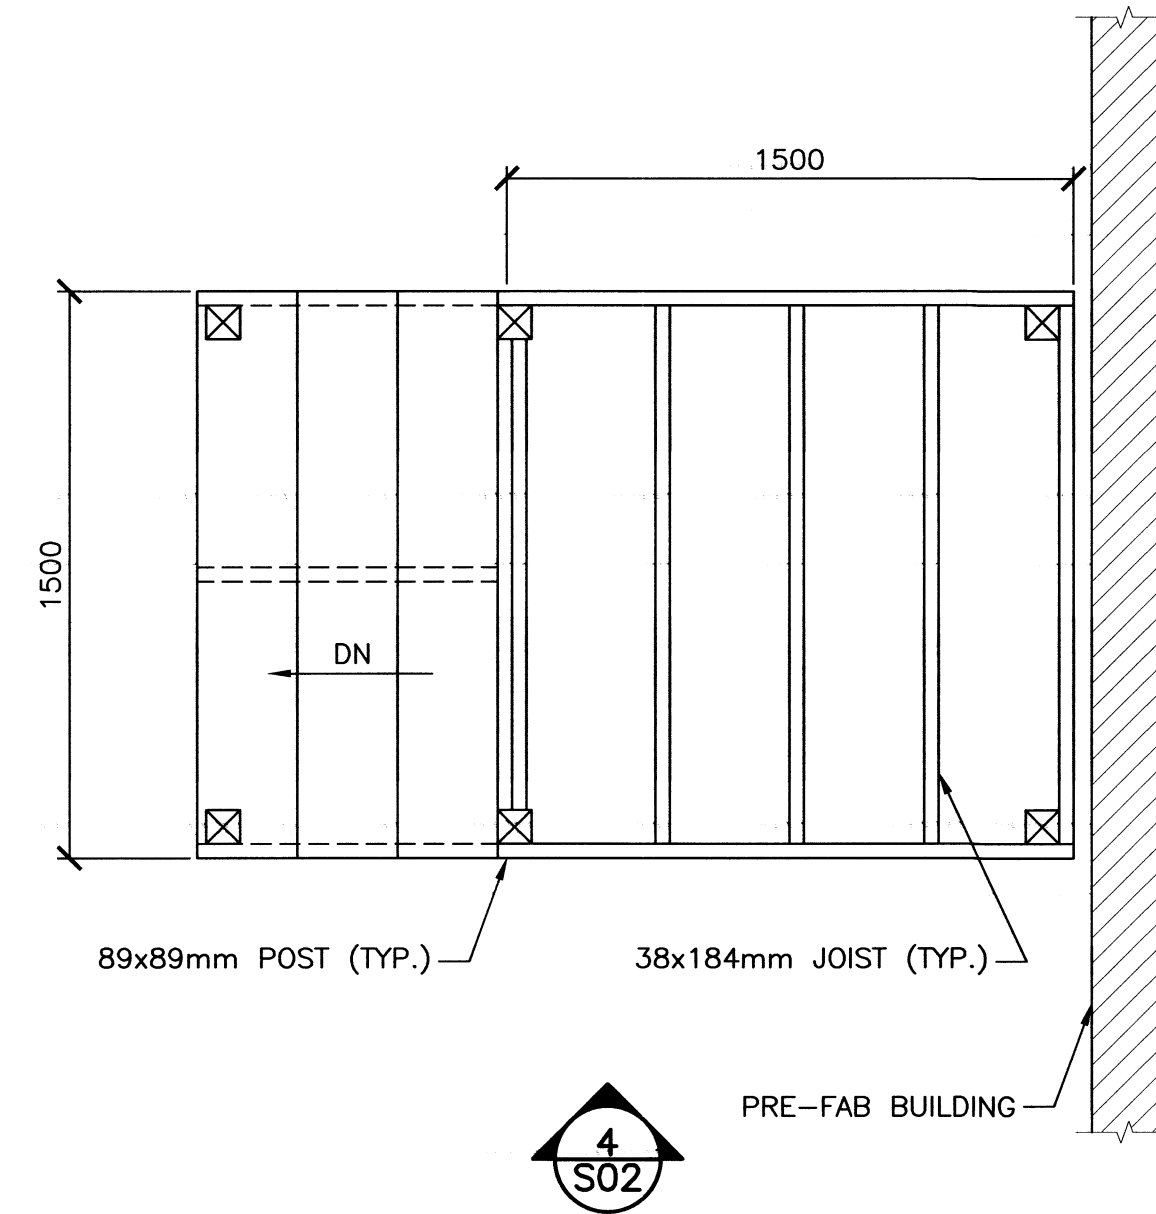


3
S02

FRAMING PLAN — EXTERIOR STAIRS

SCALE : 1:20

0mm 500mm 1000mm 1500mm 2000mm 2500mm

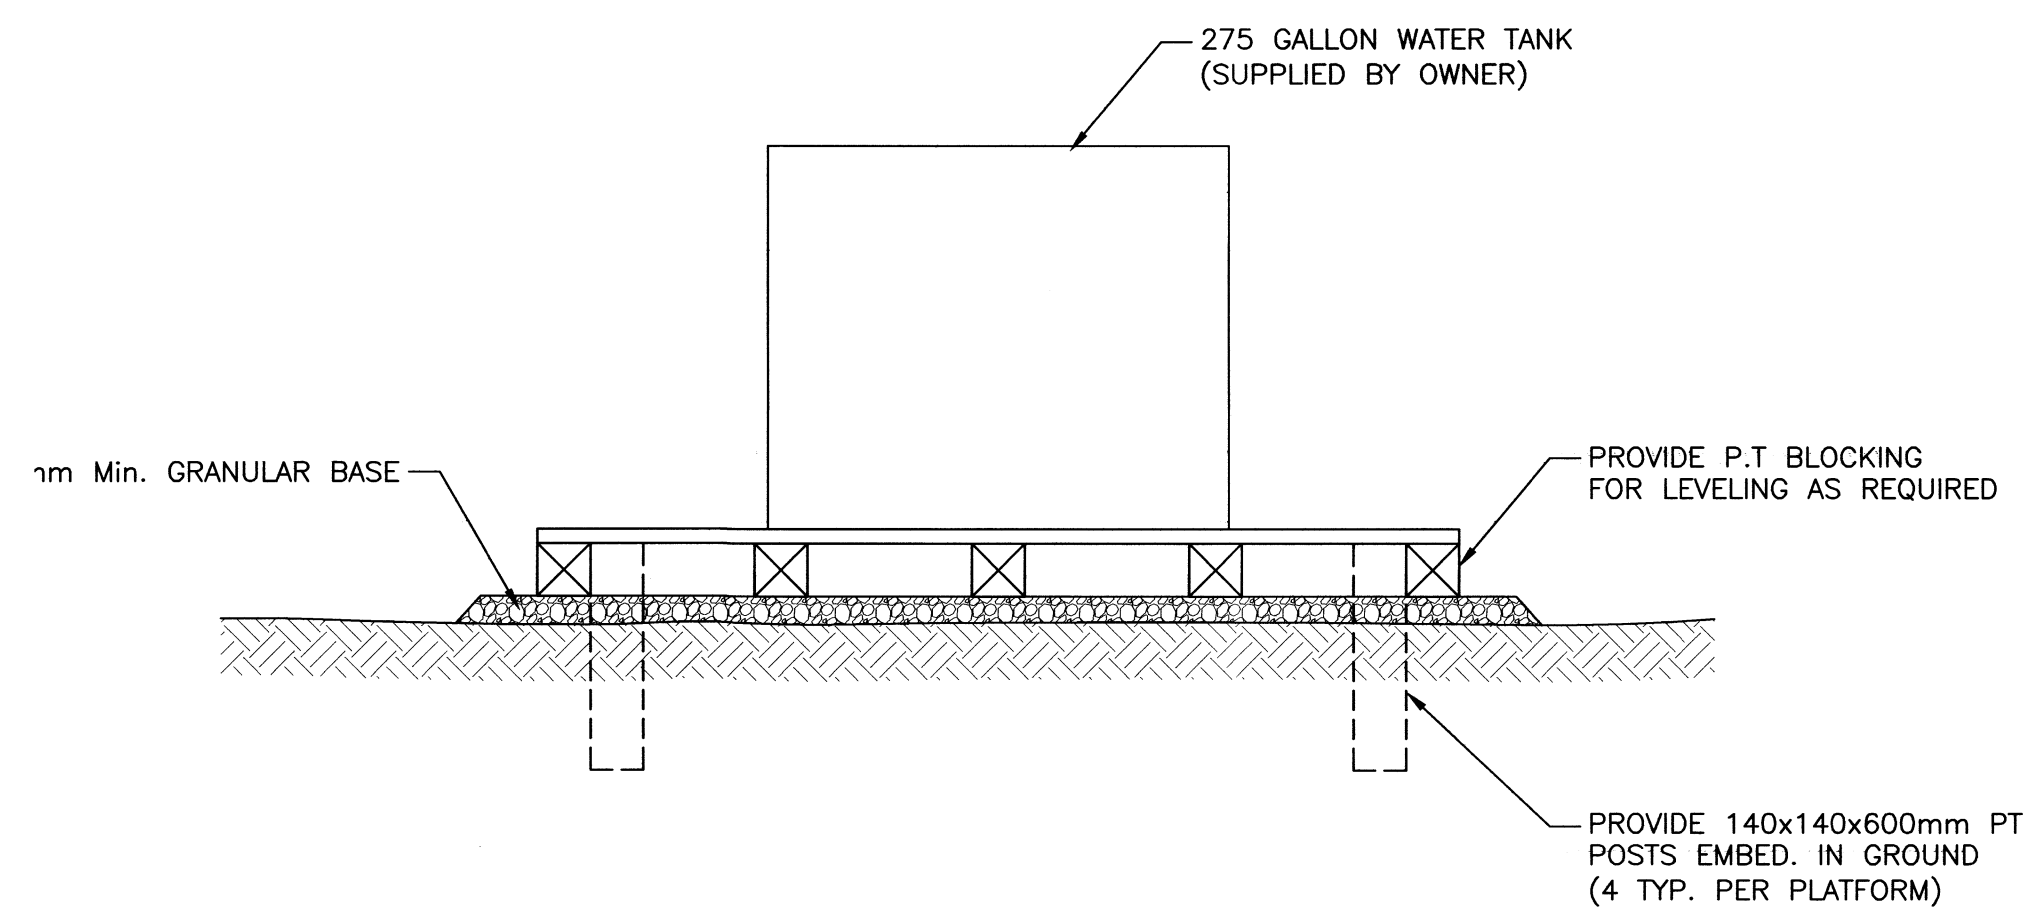


2
S02

SECTION — THRU PLATFORM

SCALE : 1:20

0mm 500mm 1000mm 1500mm 2000mm 2500mm

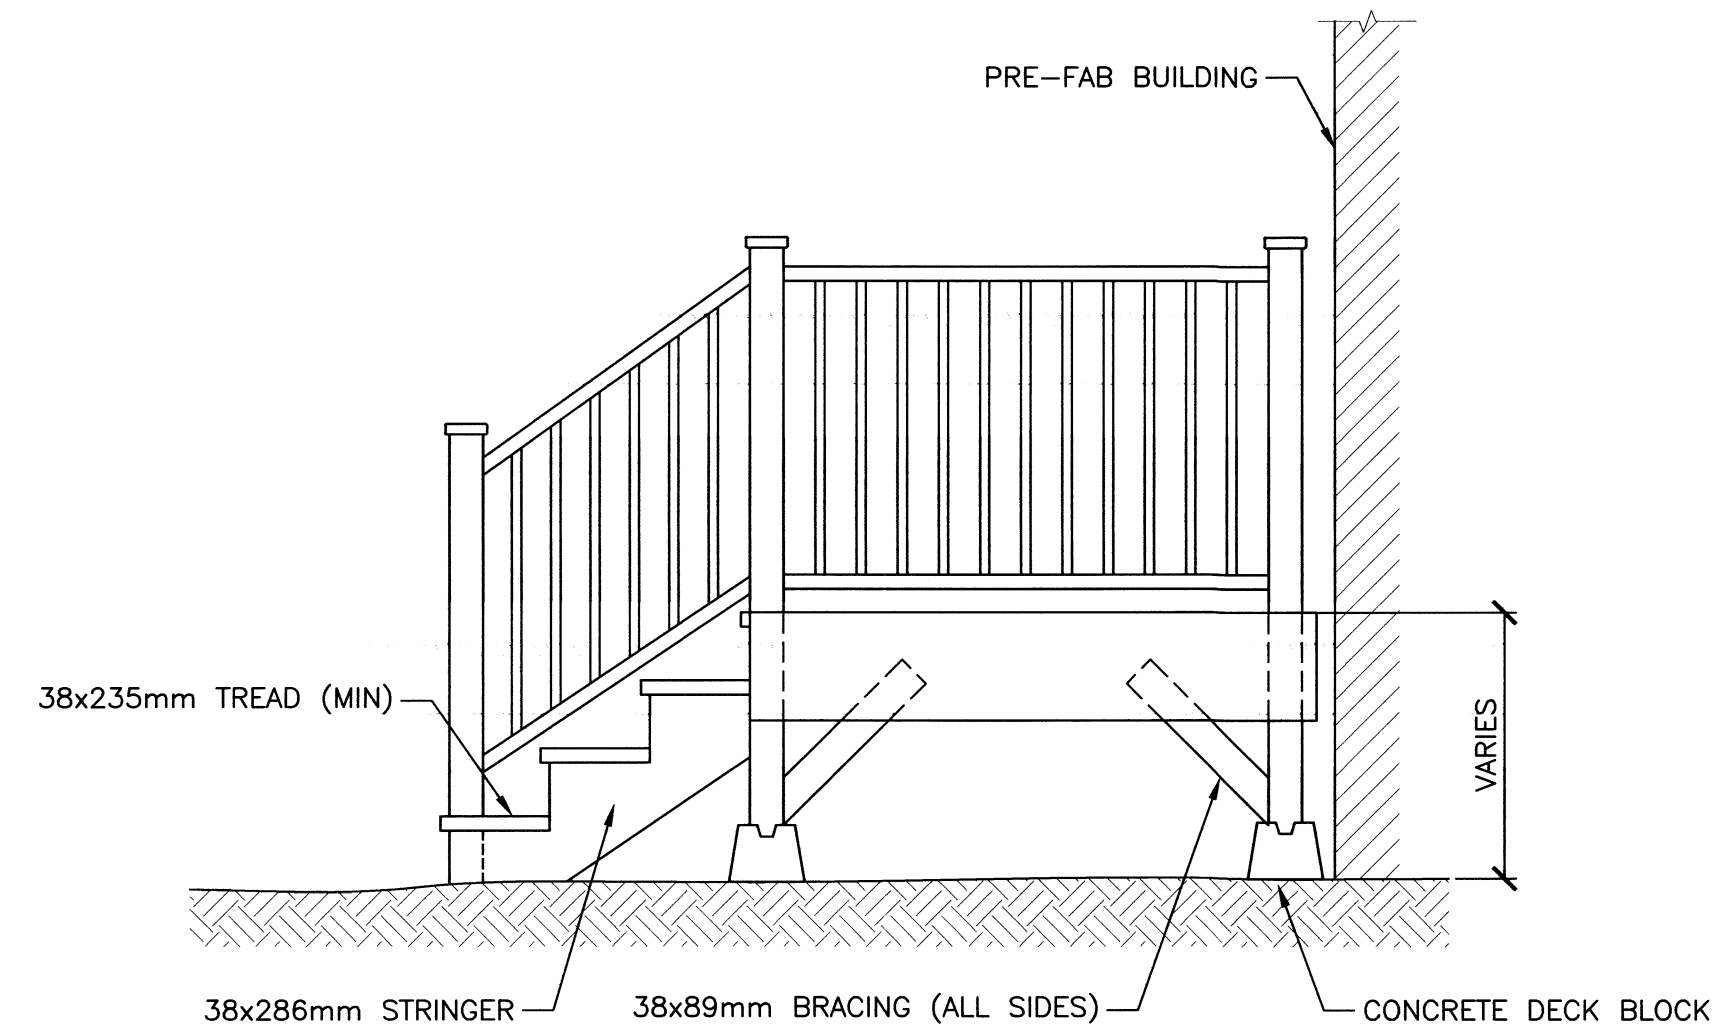

4
S02

ELEVATION — @ EXTERIOR STAIRS

SCALE : 1:20

0mm 500mm 1000mm 1500mm 2000mm 2500mm

TIMBER NOTES:

- ALL MATERIALS & WORKMANSHIP SHALL COMPLY WITH THE REQUIREMENTS OF THE CURRENT EDITIONS OF THE FOLLOWING STANDARDS:
 - CODE FOR ENGINEERING DESIGN IN WOOD CSA 086, LATEST EDITION
 - NATIONAL BUILDING CODE OF CANADA, PART 4
- ALL NAILS, SPIKES & STAPLES SHALL BE IN ACCORDANCE NBCC CLAUSE 9.23.3.
- LUMBER FOR LOAD BEARING STUD WALLS, POSTS, JOISTS OR LINTELS SHALL BE NO. 1/NO. 2 SPF. (PRESSURE TREATED).



PROVINCE OF NEWFOUNDLAND AND LABRADOR

PEGA PERMIT HOLDER

Newfoundland and Labrador This Permit Allows

RENEWABLE RESOURCES

CBCL LIMITED

Member in Responsible Charge:

TODD PUDDICOMBE, P.Eng. No. 08215

To practice Professional Engineering in Newfoundland and Labrador.

Permit No. as issued by PEGNL D0178 which is valid for the year 2018.

0	ISSUED FOR TENDER	AUG 8 2018
revisions		date
project		project

PRE-FABRICATED BUILDING — ASSEMBLY AND CONSTRUCTION PASS ISLAND, NL

EXTERIOR STAIRS AND WATER TANK PLATFORM PLANS AND SECTIONS

designed	TODD PUDDICOMBE	conçu
date	MARCH 2018	
drawn	BRAD CROCKER	dessiné
date	MARCH 2018	
approved		approuvé
date		

Tender / Soumission

PWGSC Project Manager / Administrateur de projets TPSGC

project number / no. du projet

F6879-194003

drawing no. / no. du dessin

S02