


1 S02 FRAMING PLAN — WATER TANK PLATFORM

SCALE : 1:20


0mm 500mm 1000mm 1500mm 2000mm 2500mm

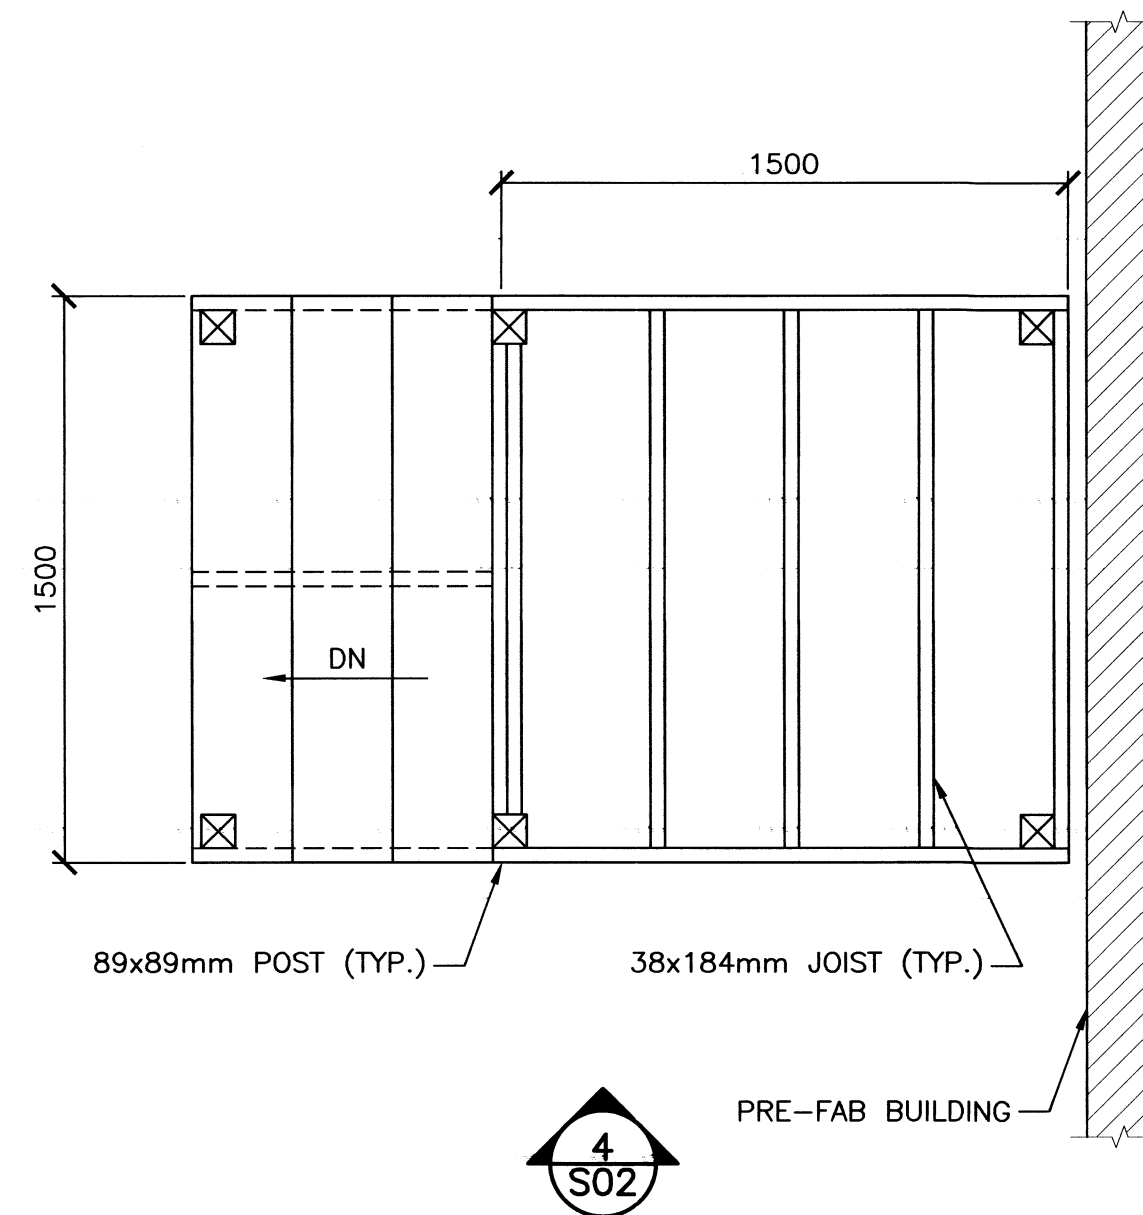

3 S02 FRAMING PLAN — EXTERIOR STAIRS

SCALE : 1:20


0mm 500mm 1000mm 1500mm 2000mm 2500mm

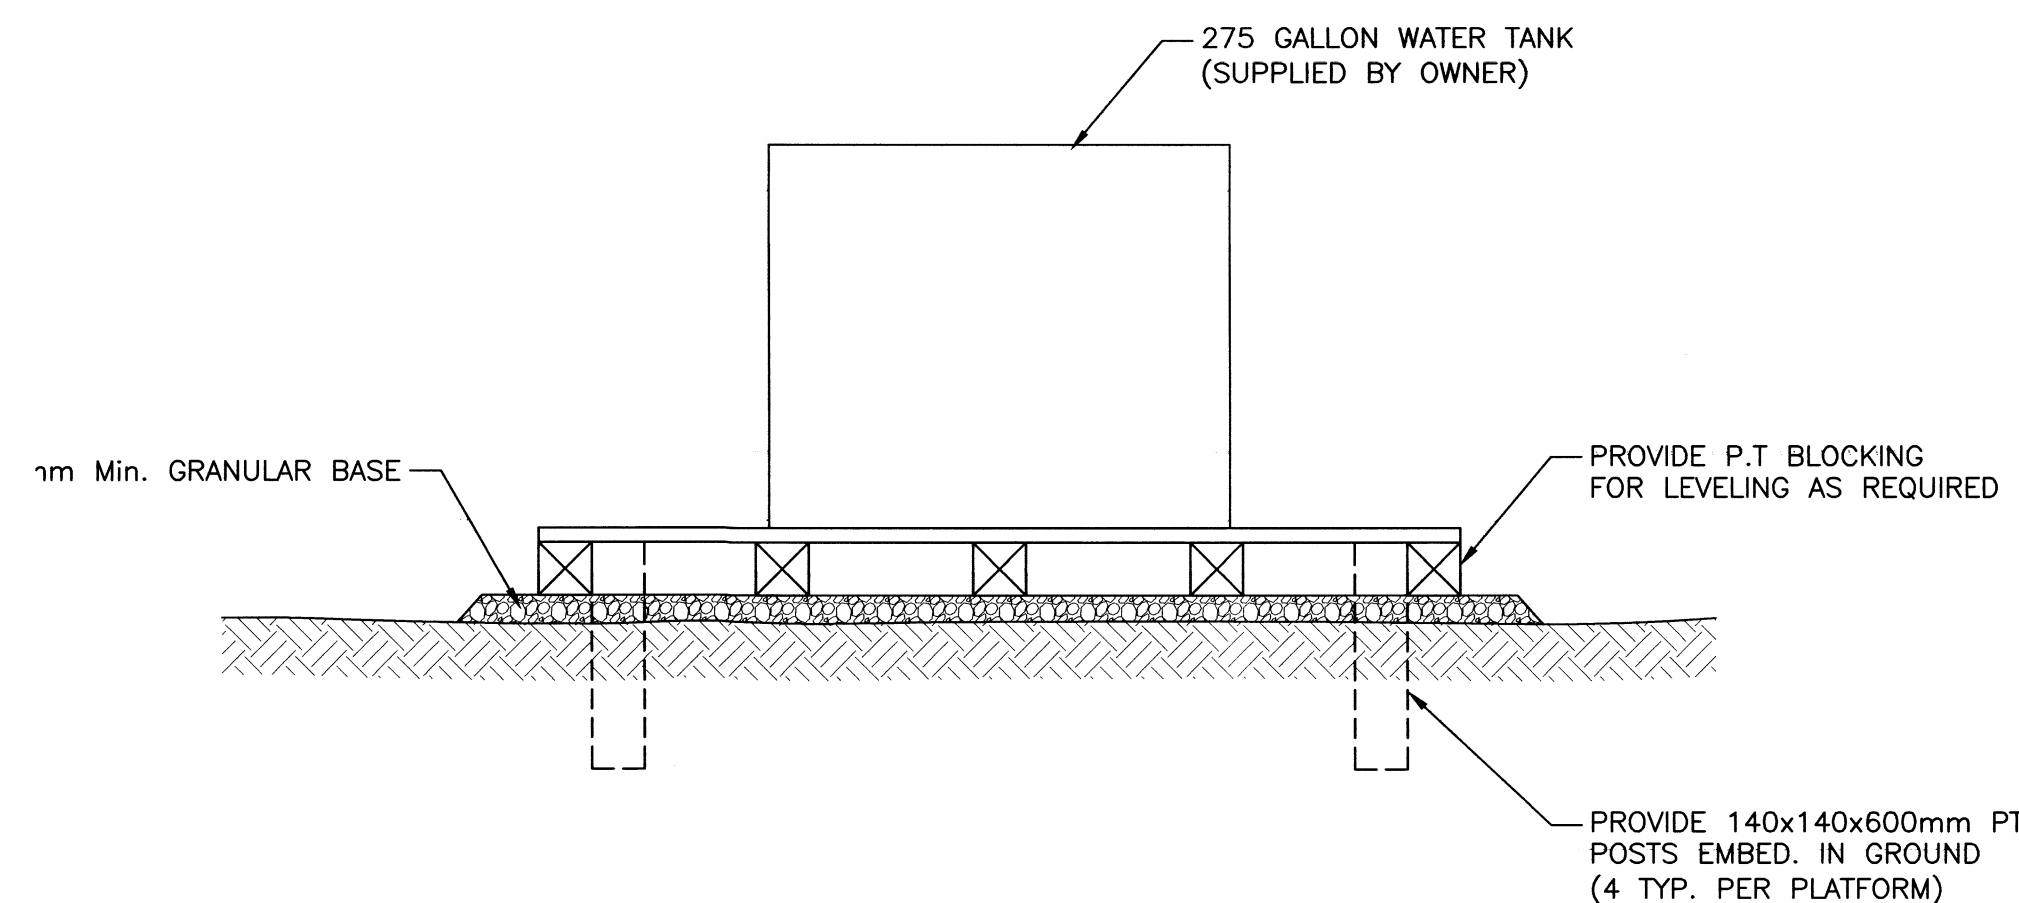

2 S02 SECTION — THRU PLATFORM

SCALE : 1:20

0mm 500mm 1000mm 1500mm 2000mm 2500mm

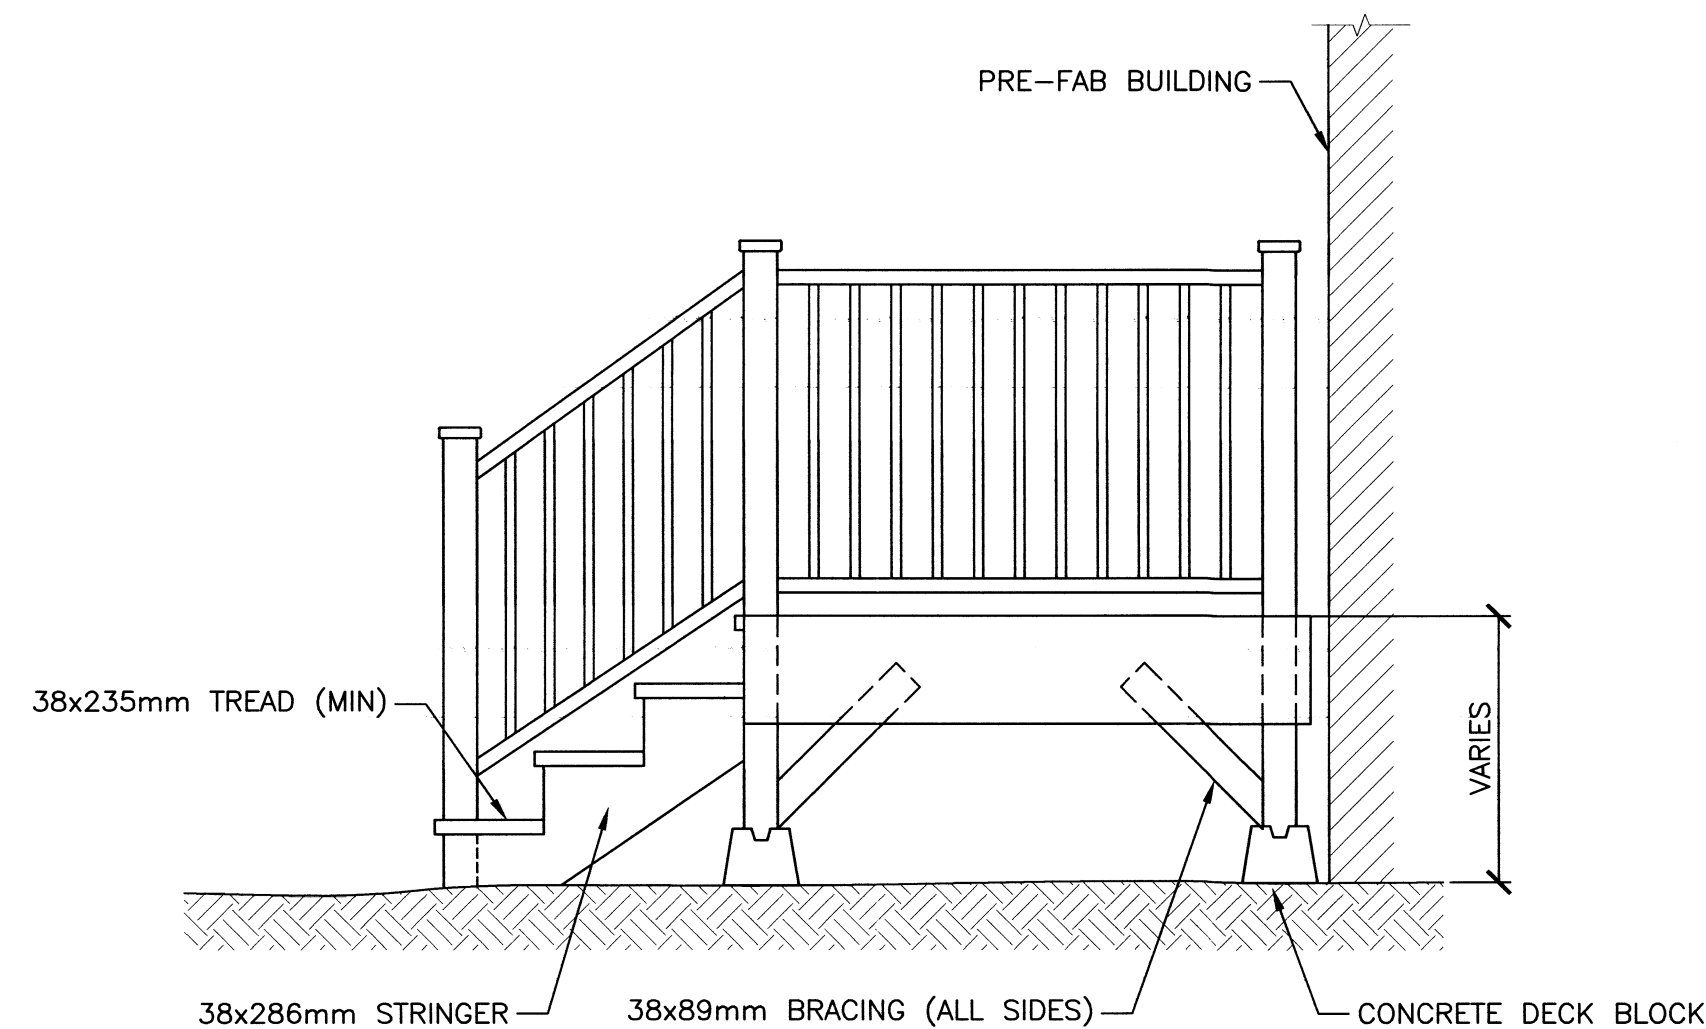


4 S02 ELEVATION — @ EXTERIOR STAIRS

SCALE : 1:20

0mm 500mm 1000mm 1500mm 2000mm 2500mm

TIMBER NOTES:

- ALL MATERIALS & WORKMANSHIP SHALL COMPLY WITH THE REQUIREMENTS OF THE CURRENT EDITIONS OF THE FOLLOWING STANDARDS:
 - CODE FOR ENGINEERING DESIGN IN WOOD CSA 086, LATEST EDITION
 - NATIONAL BUILDING CODE OF CANADA, PART 4
- ALL NAILS, SPIKES & STAPLES SHALL BE IN ACCORDANCE NBCC CLAUSE 9.23.3.
- LUMBER FOR LOAD BEARING STUD WALLS, POSTS, JOISTS OR LINTELS SHALL BE NO. 1/NO. 2 SPF. (PRESSURE TREATED).

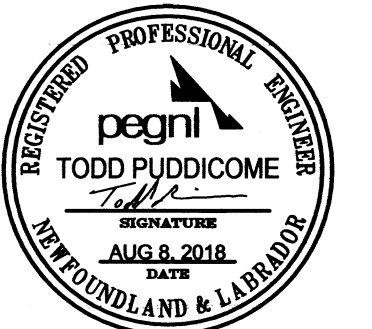

PROVINCE OF NEWFOUNDLAND AND LABRADOR

PEGNI PERMIT HOLDER

Newfoundland and Labrador This Permit Allows

REGULATED WORKS IN EXISTING

CBCL LIMITED

Member in Responsible Charge:

TODD PUDDICOMBE, P.Eng. No. 08215

To practice Professional Engineering in Newfoundland and Labrador.

Permit No. as issued by PEGNL D0178 which is valid for the year 2018.

0	ISSUED FOR TENDER	AUG 8 2018
revisions		date

project

PRE-FABRICATED BUILDING — ASSEMBLY AND CONSTRUCTION GREEN ISLAND (FB), NL

drawing

EXTERIOR STAIRS AND WATER TANK PLATFORM PLANS AND SECTIONS

designed TODD PUDDICOMBE conçu

date MARCH 2018

drawn BRAD CROCKER dessiné

date MARCH 2018

approved approuvé

date

Tender 28 June 2017 Soumission

PWGSC Project Manager Administrateur de projets TPSGC

project number no. du projet

F6879-194004

drawing no. no. du dessin

S02