Al	AIR HANDLING UNITS SCHEDULE-GAS FIRED MAKE UP AIR														
TAG	SERVICE	LOCATION	MAKE	MODEL	TYPE	FLOW (L/S)	SUPPLY FA ESP (PA)	AN FAN MOTOR (HP)	INPUT (KW)	HEATING C OUTPUT (KW)	APACITY FAN MOTOR (HP)		TRICAL MCA	WEIGHT (KG)	NOTES
AHU-3	PAINT ROOM	I ROOF	ENGINEERED AIR	HE401/0/MV	DIRECT FIRED	17,940	120	25	735	2511	120	575/3/60	35	2400	1

1. 3 SPEED CONTROL AND BACNET INTERFACE, HERESITE COATING, INTAKE HOOD, BURNER

HEA	HEAT PUMP SPLIT SYSTEM - OUTDOOR UNIT SCHEDULE													
TAG	SERVICE	LOCATION	MAKE	MODEL	TYPE	COOLING	HEATING		ELECT	TRICAL			WEIGHT	NOTEC
17.0	SLIVICE	LOCATION	WANE	WOOLL		CAPACITY (KW)	CAPACITY (KW)	V/PH/Hz	KW	MOP	MCA	EER	(KG)	NOTES
HP-100	FC-1a & FC-1b	ROOF	FUJITSU	AOU45RLXFZ	MULTI ZONE	15.5	16.5	208/1/60	4.28	30	28.9		93	1
HP-200	FC-2	ROOF	FUJITSU	24RCL	MULTI ZONE	7.9	7	208/1/60	2	30	28.9		93	1

1. INSTALL IN ACCORDANCE WITH MANUFACTURER'S RECOMMENDATIONS. SINGLE POINT ELECTRICAL CONNECTION, FUSED DISCONNECT SWITCH, AMBIENT CONTROL FOR OPERATION DOWN TO 0°F

PROVIDE CONTROL WIRING FROM INDOOR UNIT TO OUTDOOR UNIT. PROVIDE EXTENDED 5 YEAR WARRANTY ON COMPRESSOR. REFRIGERANT 410A. C/W MOUNTING BASE.

HEAT PUMP SPLIT SYSTEM — INDOOR UNIT SCHEDULE													
TAG	SERVICE	LOCATION	MAKE	MODEL	TYPE	TVDI		X COIL		EL	ECTRICAL	WEIGHT	NOTEO
170	SERVICE	LOCATION	WANE	MODEL	111 💆	VOLUME (L/S)	ESP (PA)	COOLING (KW)	HEATING (KW)	W	V/PH/Hz	(KG)	NOTES
FC-1a	NE AREA	CEILING	FUJITSU	ARU24RLF	SLIM DUCT	390	88.36	5.2	5.8	73	208/1/60	23	1
FC-1b	INTERIOR	CEILING	FUJITSU	ARU24RLF	SLIM DUCT	390	88.36	5.2	5.8	73	208/1/60	23	1
FC-2	NW AREA	CEILING	FUJITSU	ARU24RLF	SLIM DUCT	390	88.36	5.2	5.8	73	208/1/60	23	1

1. PROVIDE CONDENSATE DRAIN PUMP, PIPED TO DRAIN. C/W DISCONNECTED SWITCH.

GL	GLYCOL HEATING HEAT PUMP SCHEDULE-GLYCOL SYSTEM											
TAG	SERVICE	LOCATION	MAKE	MODEL	TYPE	WATER FLOW RATE (L/S)	MCA	ELECTRICA MOP	V/PH/Hz	WEIGHT (KG)	DIMENSIONS (MM)	NOTES
HP-H	V UNIT HEATERS	ROOF	TRANE	ARP015XNIIC2RS0AAASN	AIR SOURCE	2.5	38	60	575/3/60	3100	81x210x190	1

SINGLE POINT ELECTRICAL CONNECTION. AMBIENT CONTROL FOR OPERATION DOWN TO 0°F (-18°C) WITH FREEZE STAT. PROVIDE EXTENDED 5 YEAR WARRANTY ON COMPRESSOR. REFRIGERANT 410A.

PRIMARY LOOP, TWO PIPE 2.5 L/S (40 GPM) AT 43 FT HEAD., 3x3x6 PUMPS, 5HP. BUILT—IN MINI GLYCOL FEEDER WITH 8 GAL EXPANSION TANK. VFD ON FANS STAINLESS STEEL INLET HEADER AND HEAT EXCHANGER. 5 YEARS COMPRESSOR WARRANTY AND ELECTRONIC LOAD CONTROL.

HE	HEAT RECOVERY VENTILATOR SCHEDULE										
TAG	LOCATION	MAKE	MODEL	EXHAUST AIR FLOW(L/S)	O/A INTAKE AIRFLOW (L/S)	MCA	ELECTRICAL MOP	V/PH/Hz	WEIGHT (KG)	DIMENSIONS (MM)	NOTES
HRV-1	ROOF	LIFE BREATH	1500E-ECM	570	570	22.8	30	240/1/60	109	1702L x 1118W x 1041H	

1. AIR INTAKE SHUT-OFF FOR DEFROST. ALUMINUM CORE (2 CORES). WASHABLE FOAM FILTERSACCESS DOOR LOCATED FOR EASY MAINTENANCE. OPERATE ON PRE-SET SCHEDULE, DDC CONTROLLER, USER ADJUSTABLE

CONTR	POL DAMPER	SCHEDULE						NOTES		
CONTROL DAMPER SCHEDULE										
TAG	SERVICE	LOCATION	MAKE	MODEL	SIZE cmxcm	AIR FLOW (L/S)	TYPE			
MD-AHU 3A	SUPPLY AIR TO P.R.	ROOF	TAMCO	9000	3300x1500	12,000	PARALLEL BLADE	1		
MD-AHU 3B	RELIEF AIR	ROOF	TAMCO	9000	1500x400	5,000	PARALLEL BLADE	1		
MD-AHU 3C	SUPPLY AIR	ROOF	TAMCO	9000	1100x800	6,000	PARALLEL BLADE	1		

1. SITE CONFIRM CONNECTION SIZE IN LINE DUCTED. C/W SALT WATER RESISTANCE OPTION. POSITION BLADES TO DIRECT AIR FLOW DOWN. C/W MODULATING, SPRING RETURN ACTUATORS (MIN 4 ACTUATORS FOR MD-AHU3A AND 2 FOR MD-AHU3C)

UNIT HEATER SCHEDULE- HOT WATER/GLYCOL										
TAG	MAKE	MODEL	HEATING CAPACITY KW (MBH)	FLOW RATE L/S (GPM)	EWT F (C°)	LWT F (C°)	HP	LECTRICAL V/PH/Hz	WEIGHT (KG)	NOTES
UH-1	TRANE	P-252	46 (160)	0.63 (10)	93 (200)	76 (170)	1/4	120/1/60	80	1
UH-2	TRANE	P-252	46 (160)	0.63 (10)	93 (200)	76 (170)	1/4	120/1/60	80	1
UH-3	TRANE	P-252	46 (160)	0.63 (10)	93 (200)	76 (170)	1/4	120/1/60	80	1
UH-4	TRANE	P-252	46 (160)	0.63 (10)	93 (200)	76 (170)	1/4	120/1/60	80	1

1. C/W LOCAL DISCONNECT AND BAFFLES.

GLYCOL STORAGE TANK SCHEDULE										
TAG	MAKE	TYPE	CAPACITY (LITRES)	DIMENSIONS DIA xH (cm)	MATERIAL	NOTES				
ST-1	AO SMITH	VERTICAL HW STORAGE	450	90 ×200	STAINLESS STEEL	1				
ST-1	AO SMITH	VERTICAL HW STORAGE	450	90 x200	STAINLESS STEEL	1				

DWG. NO.

1. C/W MIN 50mm THICK FOAM INSULATION, PAINTED SHEET METAL JACKET, 50ø (2"ø) GLYCOL S & R CONNECTIONS, HIGH/LOW + 20ø DRAIN CONNECTIONS ON BOTTOM/TOP + 20 25ø T & P TAPPING. SUITABLE FOR WORKING PRESSURE AT 6900 KPA (100PSI\ AT 95° C). ASME RATED

EXPANS	EXPANSION TANK SCHEDULE									
TAG	SERVICE	MAKE	TYPE	CAPACITY (LITRES)	DIMENSIONS DIA xH (cm)	WEIGHT (KG)	NOTES			
ET-1	HW SYSTEM GLYCOL	AMTROL	DIAPHRAGM TYPE	30	31 x50	10	1			

saving you energy

NOTES

1. PRE CHARGED TO 80 KPA. SUITABLE FOR USE WITH GLYCOL SYSTEM.

DRAWING REFERENCES

(CONTROLS LEGEND
SYMBOL	DESCRIPTION
\bigcirc_{pr}	TEMPERATURE - PROGRAMMABLE
\bigcirc_{t}	TEMPERATURE SENSOR (DDC)
品	3-WAY CONTROL VALVE
M	2-WAY CONTROL VALVE
ъ	WELL
⊤	TEMPERATURE SENSOR
Ŧ	TEMPERATURE SENSOR- STRAP ON
P	PRESSURE SENSOR
FS 1	FLOW SWITCH
\$	SWITCH - AS NOTED
T	DDC ROOM TEMPERATURE SENSOR
DP	DIFFERENTIAL PRESSURE SENSOR

SYMBOL	DESCRIPTION
X-X-X	EQUIPMENT TAG
#	DRAWING NOTE
ADJ.	ADJACENT
AFF	AFF ABOVE FINISHED FLOOR
CIE	CONNECT INTO EXISTING
DN	DOWN
EX	EXISTING
FA	FROM ABOVE
FB	FROM BELOW
GC	GENERAL CONTRACTOR
RE	REMOVE EXISTING
RL	RELOCATE EXISTING
SS	STAINLESS STEEL
TR	TO REMAIN
TYP	TYPICAL
U/G	UNDERGROUND

BUOY — MAINTENANCE BUILDING		
		Frank III
	The same of the sa	
22		

PIPING	LEGEND GENERAL
SYMBOL	DESCRIPTION
\bowtie	PRESSURE REDUCING VALVE
\bowtie	ISOLATION/SHUT OFF VALVE
	GLOBE VALVE
Ы	CIRCUIT BALANCING VALVE
\blacksquare	3-WAY MIXING VALVE
译	PRESSURE RELIEF VALVE
$\stackrel{\smile}{\vdash}$	STRAINER
	CHECK VALVE
E	CAP OFF
♦	BALANCING VALVE
1 1	UNION
\$	PIPE BREAK
C	PIPE DOWN
<u> </u>	PIPE UP
-=-	TIE INTO EXISTING PIPING
\sim	PIPE SLEEVE
~~	FLEXIBLE JOINT
\rightarrow	PIPE SECTION
	PUMP
□A	AIR VENT/AUTOMATIC AIR VENT
) Ø	PRESSURE GAUGE
įτ	TEMPERATURE GAUGE
	NEW PIPE
	EXISTING PIPE TO REMAIN
<i></i>	EXISTING PIPE TO BE REMOVED
	SUPPLY
-	RETURN
	SLOPE

	======================================
'///,	DEMOLITION
## ₩	NEW DUCTWORK
<i>च्य</i> रुस	ACOUSTICALLY INSULATED DUCT
$\not \sqsubseteq \not \sim$	EXISTING DUCTWORK TO REMAIN
* * *	EXISTING DUCTWORK TO BE REMOVED
⊠ ♦	SUPPLY AIR DUCT RISER — UP
	RETURN AIR DUCT RISER — UP
	SUPPLY AIR DUCT RISER — DOWN
	RETURN AIR DUCT RISER — DOWN
	SUPPLY AIR GRILLE - NEW
	RETURN/EXHAUST AIR GRILLE — NEW
	SUPPLY AIR GRILLE - EXISTING
	RETURN/EXHAUST AIR GRILLE - EXISTING
_U/C -	DOOR UNDERCUT
>	DOOR GRILLE
r _r	TURNING VANES
AH AH	ACCESS HATCH
AP	ACCESS PANEL
lll	HEAT TRACE CABLE
	EXHAUST FAN - CEILING MTD.
	EXHAUST FAN - INLINE
─ ◀	FIRE DAMPER - NEW
─	FIRE DAMPER - EXISTING
—— ∢ SD	SMOKE DAMPER - NEW
—— ⊲ SD	SMOKE DAMPER - EXISTING
M-	MOTORIZED DAMPER
_	BALANCING DAMPER
BDD-	BACK DRAFT DAMPER
X	AIR FLOW (CFM/1/5)
A 24×24	145 DIFFUSER/GRILLE TAG
L TYPE L SIZ	ZE(in/mm) AIR FLOW (CFM/1/s)
E/A	EXHAUST AIR
G/E O/A	GENERAL EXHAUST OUTSIDE AIR
,	PRIMARY AIR
R/A	RETURN AIR
S/A	SUPPLY AIR
T/E	TOILET EXHAUST
CE	CONNECT TO EXISTING
I F	PIPING LEGEND

SHEET METAL LEGEND

SYMBOL DESCRIPTION

	PIPING	LEGEND
SYMBOL	DESC	RIPTION
—— GLS —	— GLYC	OL SUPPLY
—— GLR —	- — GLYC	OL RETURN
—— GAS —	NATU	IRAL GAS PIPING
	REFR	IGERANT LIQUID
	— REFR	IGERANT VAPOR

	DRAWING LIS	
<u>DWG NO.</u> ME-1	DESCRIPTION LEGENDS, SITE PLAN, SCHEDULES AND DRAWING LIST	SCALE NTS NTS
ME-2 ME-3	GROUND FLOOR PLAN-DEMO GROUND FLOOR PLAN-NEW	1:100 1:100
ME-4 ME-5 ME-6	ROOF PLANS—DEMO AND NEW SCHEMATIC DIAGRAMS SECTIONS AND DETAILS	AS SHOWN NTS NTS

Project No: 2018446	4 05/27/2019	ISSUED FOR TENDER
Drices	3 03/11/2019	ISSUED FOR TENDER REVIEW
Prísm	2 11/28/2018	ISSUED FOR TENDER REVIEW

TRUE NORTH

CANADIAN COAST GUARD VICTORIA BASE BUOY MAINTENANCE BUILDING HVAC UPGRADES LEGENDS, SITE PLAN, SCHEDULES AND DRAWING LIST

CHECKED

ISSUED FOR TENDER REVIEW

ISSUED FOR PROGRESS REVIEW

REVISIONS

1 11/22/2018

0 11/05/2018

NO. DATE

RECOMMENDED


APPROVED PW

FISHERIES AND OCEANS CANADA

REAL PROPERTY AND SAFETY AND SECURITY DATE MARCH 7, 2019 DRAWING NUMBER ME-1

DRAWING NOTES

- REMOVE S/A , R/A AND E/A DUCTWORK AND MECHANICAL SERVICES/EQUIPMENT AS INDICATED. REFER TO DWG ME-3 FOR NEW LAYOUT. REMOVE ALL REDUNDANT ELECTRICAL AND MECHANICAL SERVICES AND CONNECTIONS. RETAIN EXISTING FIRE DAMPERS.
- THE OFFICE AND WORKSHOP AREAS ARE TO BE KEPT IN OPERATION DURING DEMOLITION AND CONSTRUCTION. SHORT SERVICE OUTAGES (1-30 MINUTES) SHALL BE ALLOWED DURING OFFICE HOURS IF AND WHEN COORDINATED WITH THE BASE OPERATIONS MANAGER.
- 3. OUTAGES SHALL BE PRE—PLANNED AND AT LEAST 96 HOURS OF NOTICE PROVIDED BEFORE THE OUTAGE. ALLOW FOR AFTER HOUR CONSTRUCTION AND CLEAN UP BEFORE OFFICE HOURS RESUME IN EACH MORNING. CONSTRUCTION WORK ON WEEKENDS WILL BE ALLOWED, SUBJECT TO THE BASE OPERATIONS MANAGER'S APPROVAL. ANY SERVICE OUTAGES WHICH AFFECT THE OPERATIONS OF THE COMPUTER SERVERS MUST BE PRE—APPROVED AND THE DURATION OF THE OUTAGE MINIMIZED. MEASURES SHALL BE TAKEN TO PROTECT COMPUTER, ELECTRONICS AND PERSONAL EQUIPMENT IN THE FACILITY.
- 4. CEILING TILES MAY BE REMOVED AT THE START OF DEMOLITION AND LEFT OPEN UNTIL THE CONSTRUCTION WORK IS COMPLETE.

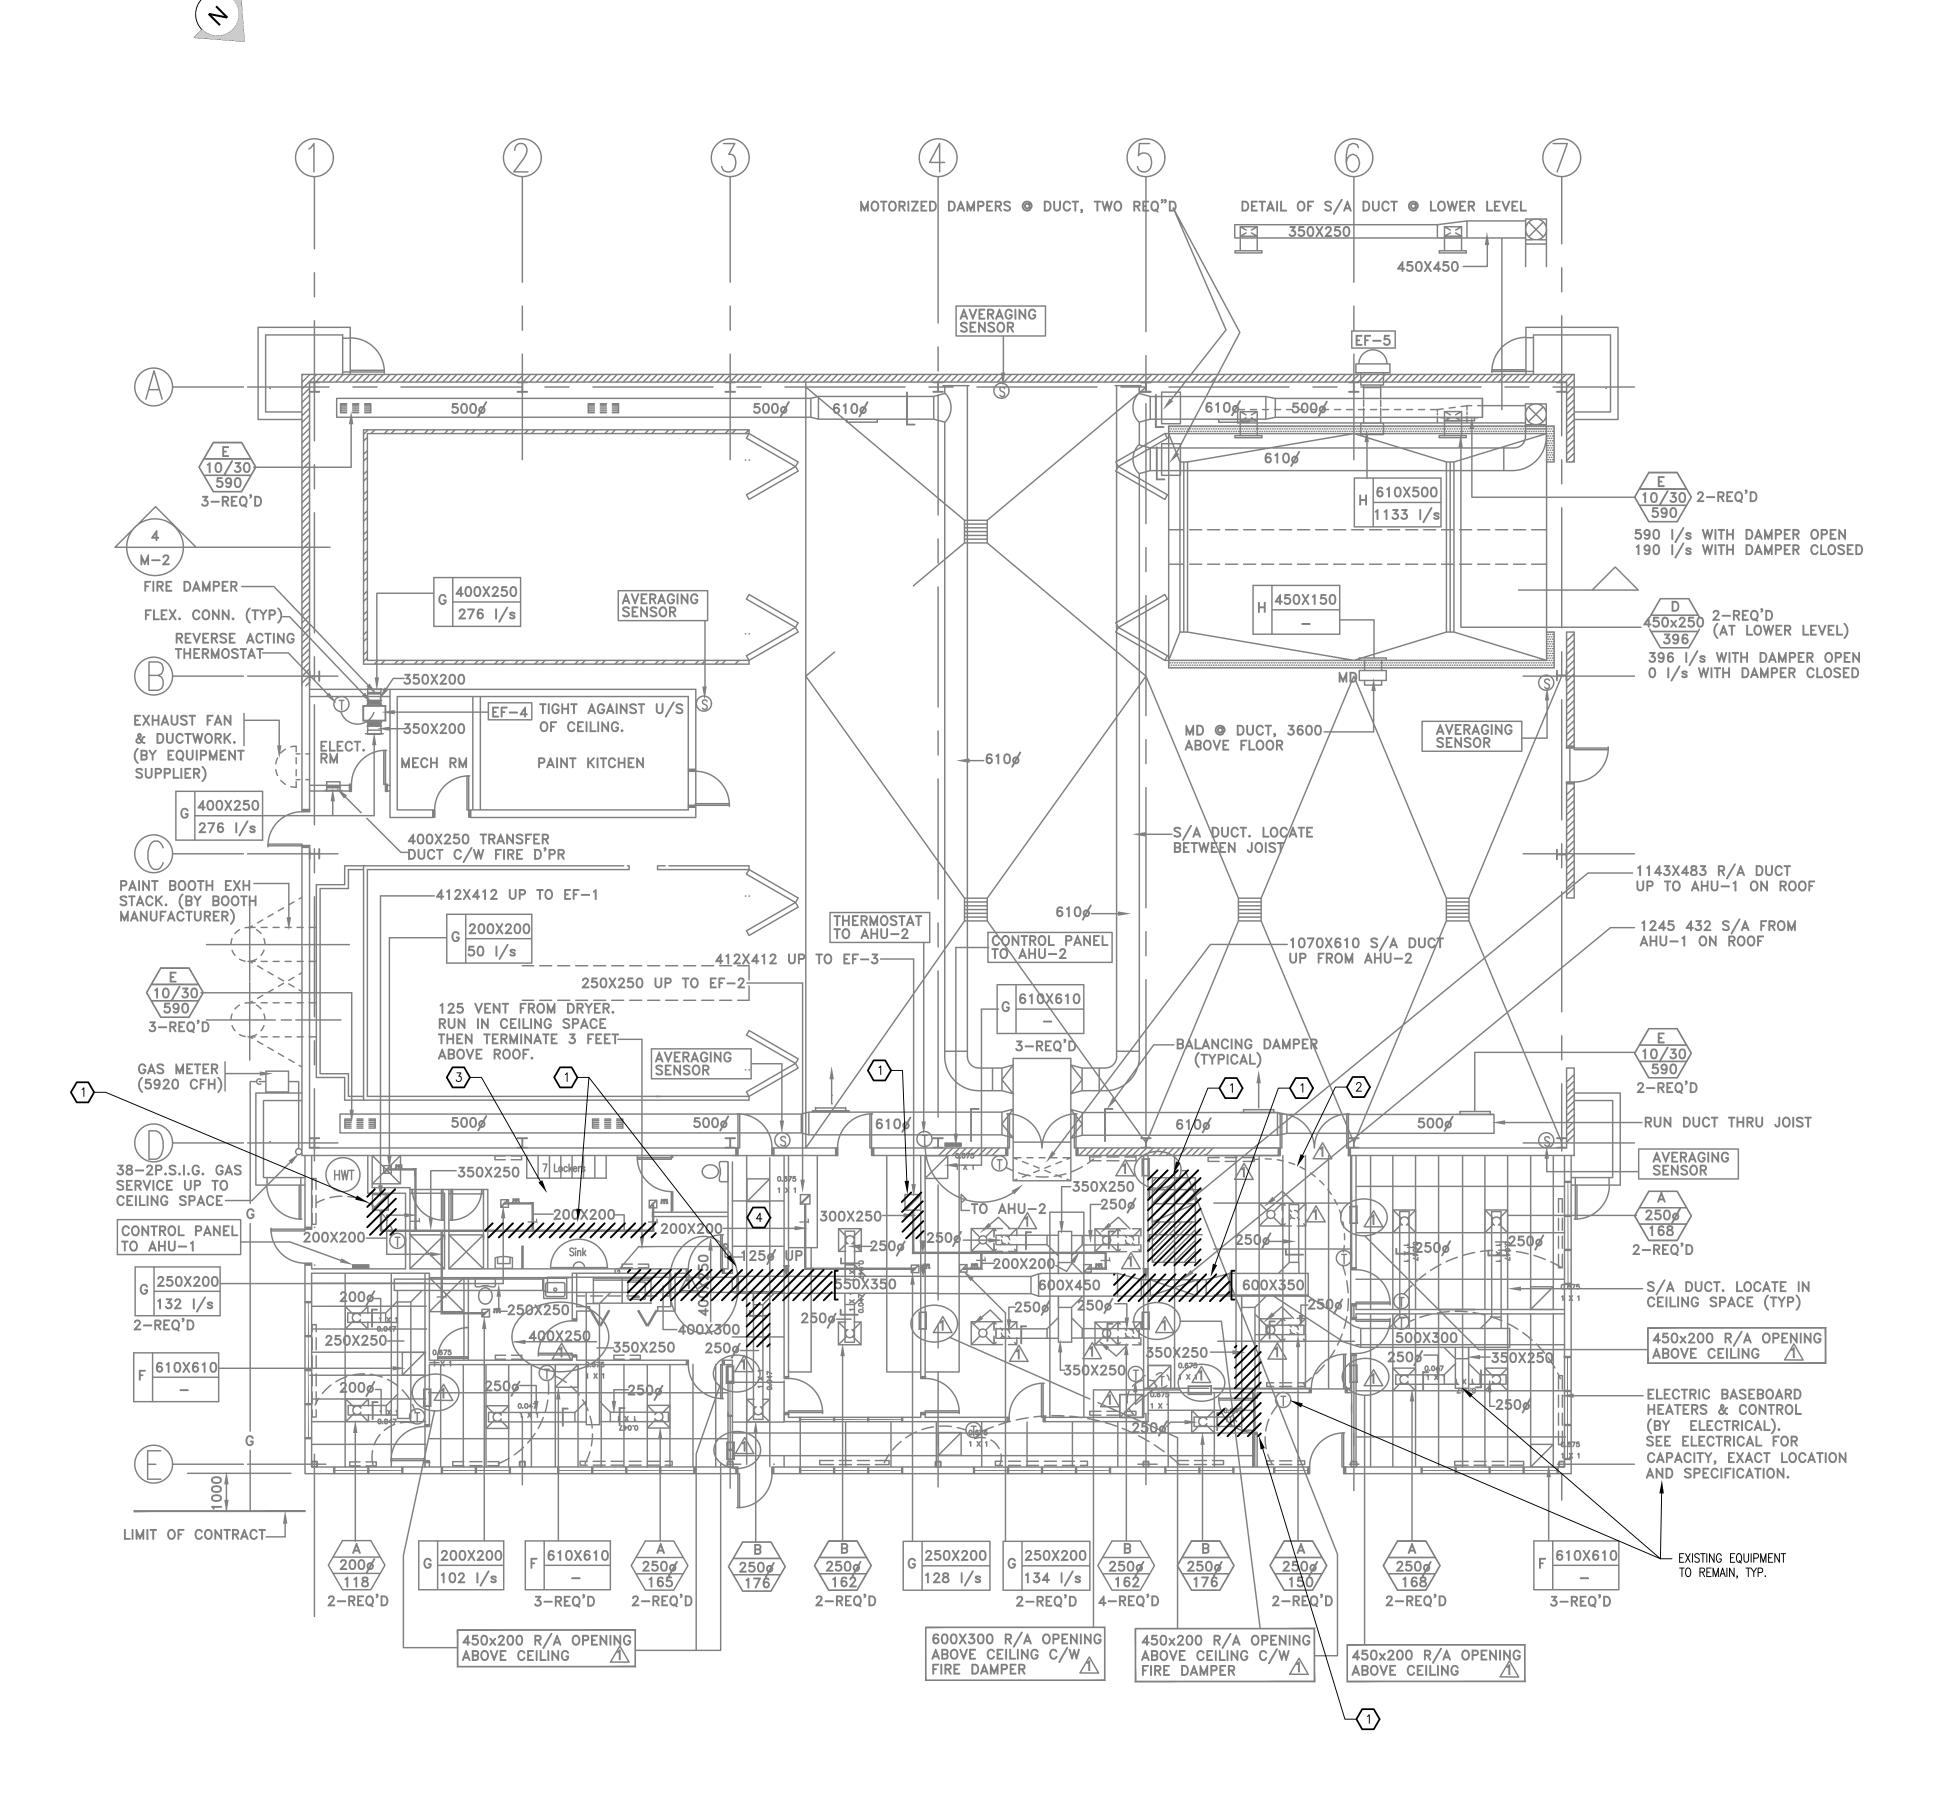

1 GROUND FLOOR PLAN-DEMO
- SCALE: 1:100

Project No: 2018446	4 05/27/2019	I ISSUED FUR LENDER	DESIGNED PW	
	3 03/11/2019	ISSUED FOR TENDER REVIEW	DRAWN PAN	
ENGINEERING	2 11/28/2018	ISSUED FOR TENDER REVIEW	CHECKED DS	В
saving you energy		ISSUED FOR TENDER REVIEW	RECOMMENDED	
Saving you onergy	0 11/05/2018	ISSUED FOR PROGRESS REVIEW	APPROVED PW	ے ا
DWG. NO. DRAWING REFERENCES NOTES	NO. DATE	REVISIONS		

REAL PROPERTY AND SAFETY AND SECURITY

CANADIAN COAST GUARD

VICTORIA BASE

BUOY MAINTENANCE BUILDING

SCALE

1:100

DATE


MARCH 7, 2019

FISHERIES AND OCEANS CANADA

HVAC UPGRADES GROUND FLOOR PLAN DEMO

CALE	
:100	
ATE	
ARCH 7, 2019	
RAWING	NUMBER
ME-2	
•	



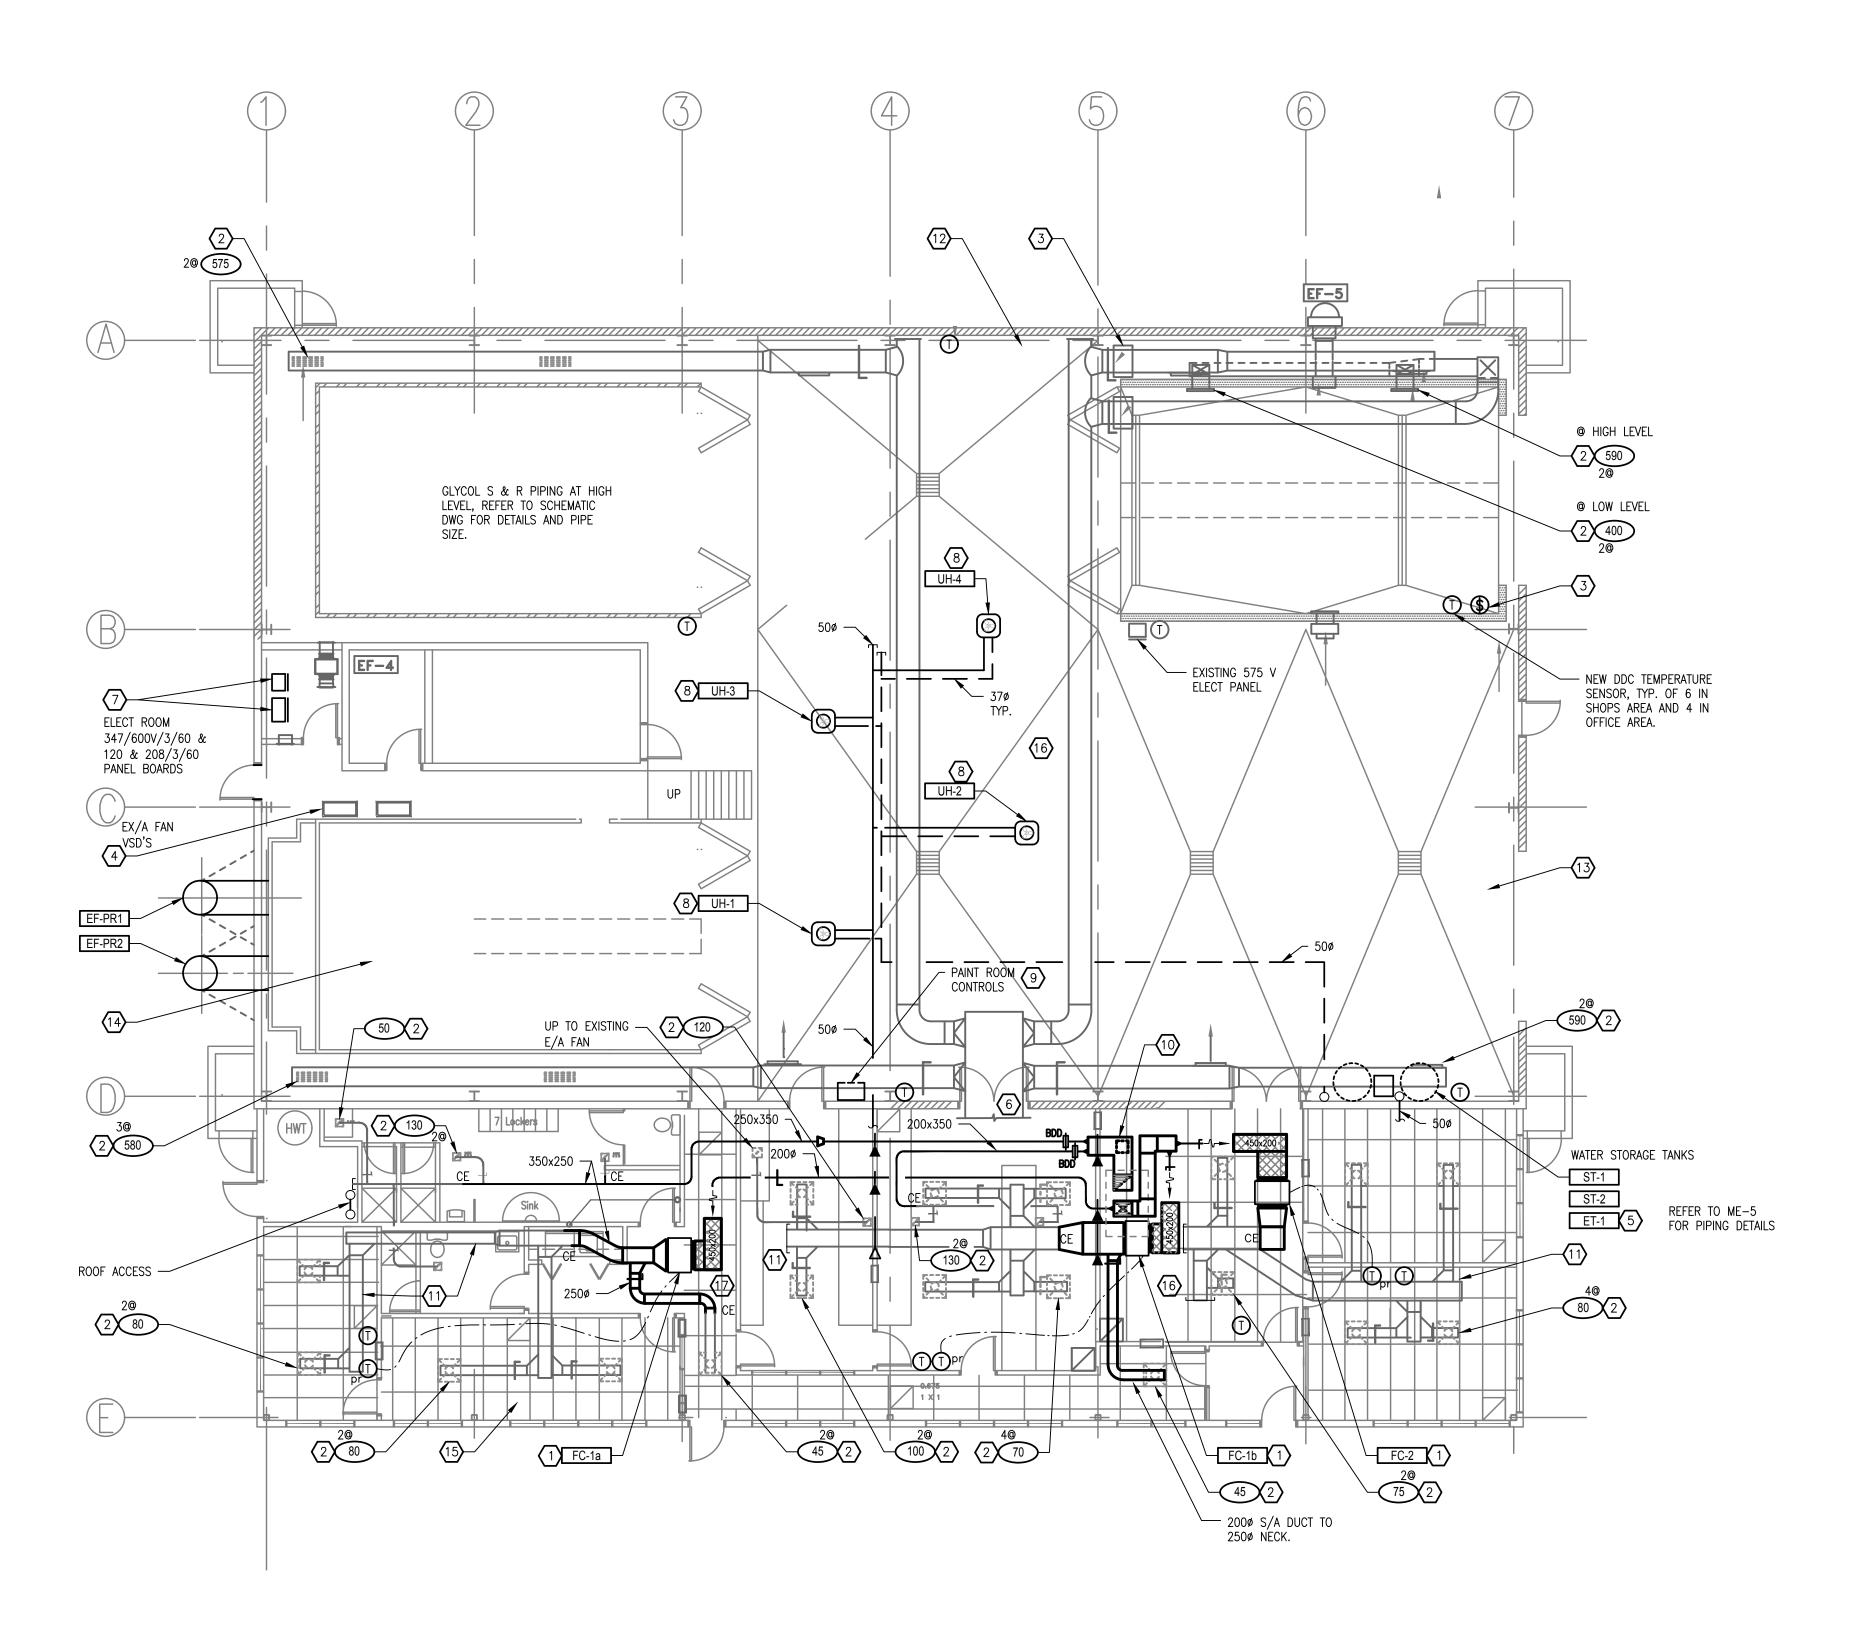

						│ ■ ′
		Project No: 2018446	4 05/27/2019	ISSUED FOR TENDER	DESIGNED PW	
	Prism ENGINEERING saving you energy		3 03/11/2019		DRAWN PAN	1
			2 11/28/2018	ISSUED FOR TENDER REVIEW	CHECKED DS	
			1 11/22/2018	SSUED FOR TENDER REVIEW	RECOMMENDED	
		Saving you onergy	0 11/05/2018	ISSUED FOR PROGRESS REVIEW	APPROVED PW	
DWG.NO.	DRAWING REFERENCES	NOTES	NO. DATE	REVISIONS		

DRAWING NOTES

- HEAT PUMP FAN COIL MOUNTED IN CEILING SPACE AND CONNECTED TO EXISTING DUCTWORK AS INDICATED. PROVIDE REFRIGERATION PIPING, POWER 150 (UNO) AND RETURN DUCT TO BE RETURN CONNECTION SIZE. RETURN BOOT TO BE C/W 12 MM CONTROLS SYSTEM. THICK ACOUSTIC INSULATION. PROVIDE PUMPED UP THROUGH ROOF TO OUTDOORS. ALL ROOF PENETRATIONS TO BE HORIZONTAL, THROUGH SIDE OF ROOF CAP, COMPLETE WITH FLASHING AND SEALING WATER-TIGHT. CONDENSATE AND REFRIGERANT PIPING NOT SHOWN. REFER TO ME-4 AND ME-5.
- 2. RE-BALANCE EXISTING AIR TERMINAL TO THE AIR FLOW INDICATED IN L/S.
- PROVIDE NEW TIMER SWITCH (30, 60, 120 MIN & OFF) IN NEMA 4X ENCLOSURE TO CONTROL EXISTING SUPPLY AIR DAMPERS. PROVIDE LAMACOID LABEL TO INDICATE: "SET TIMER FOR LOW LEVEL SUPPLY AIR". REFER TO SEQUENCES OF CONTROL.
- 4. ON THE EXISTING MEZZANINE LEVEL, PROVIDE NEW 5 HP, 575/3/60 VARIABLE SPEED DRIVES FOR EF-PR1 AND EF-PR2. MOUNT VSD'S AND LINE FILTERS ON WELDED, PRIME AND PAINTED STEEL SUPPORT STAND FASTENED TO FLOOR. MAINTAIN SERVICE ACCESS TO PAINT ROOM LIGHTS AND DO NOT BLOCK REMOVABLE 11. CLEAN EXISTING SUPPLY AIR DUCTWORK BEFORE FLOOR PLATE. MAINTAIN 1 M CLEARANCE IN FRONT OF VSD'S. RE-USE THE NEWER FAN MOTOR AND TO REPLACE THE OLDER EXHAUST FAN MOTOR (ON IN OPERATION DURING DEMOLITION AND THE NORTH FAN). PROVIDE POWER SUPPLY FROM PAINT ROOM CONTROL PANEL, TO VSD'S AND TO EXHAUST FANS. PROVIDE CONTROL WIRING AS REQUIRED. REFER TO SEQUENCES OF CONTROL AND OPERATIONS MANAGER. PAINT ROOM CONTROL DETAILS. REPAIR CONNECTIONS TO EXISTING FILTER P-GAUGE.
- PROVIDE PRIMED AND PAINTED STEEL SUPPORT/PROTECTION CAGE FOR THE TWO STORAGE TANKS, THE EXPANSION TANK AND THE GLYCOL MIXING TANK. HEATING GLYCOL LOOP TO BE FILLED THE PRESSURE AT THE STORAGE TANKS DROPS TO FLOOR. SITE CONFIRM BEST LOCATION FOR PIPING RISERS.
- 6. SUPPLY AIR DUCT FROM ROOF LEVEL FROM AHU-3. REFER TO DRAWING ME-4.
- 100 AMP. 120/208V. 3 PHASE. 4 WIRE. REMOVE EXISTING 600 BREAKERS AND POWER SUPPLY SERVING EXISTING AHU-1 AND AHU-2. REMOVE ALL CONTROL WIRING AND POWER WIRING BACK TO NEAREST INDOOR JUNCTION BOX. RE-USE EXISTING 70 BREAKER AND ELECTRICAL SERVICE TO THE PAINT ROOM CONTROL PANEL SERVING AHU-3 AND EHAUST FANS EF-PR1 AND EF-PR2. PROVIDE NEW 15. CONTRACTOR SHALL MODIFY/RELOCATE/REPLACE THE PAINT ROOM CONTROL DETAIL AND SEQUENCES OF CONTROL. PROVIDE NEW 600V/60 AMPS 3P BREAKER AND ROUTE 3-#6+1-#8 GRN GRD, 25 mm CONDUIT TO EQUIPMENT TO SERVE HEATING WATER HEAT PUMP HP-HW.

IN PANEL A, PROVIDE TWO NEW, 208/30 AMP 2P BREAKER AND ROUTE 2-#10+1-#12 GRN GRD, 20 mm CONDUITS TO HP-100 AND HP-200. EXTEND 16. ALL EQUIPMENT SUPPLIED MUST PROVIDE CLEARANCE 208/1/60 POWER SUPPLY FROM HP-100 AND HP-200 TO INDOOR FAN COILS. IF FAN COIL UNITS REQUIRE SEPARATE POWER SUPPLY, THE CONTRACTOR SHALL PROVIDE THE ADDITIONAL BREAKERS AND POWER CONNECTIONS.


PROVIDE NEW 208/30 AMP 2P BREAKER AND ROUTE TO SERVE GLYCOL MIXING TANK, PROVIDE NEW 120V,


- 1 PHASE BREAKER, 15 AMP AND POWER SUPPLY TO SERVE UNIT HEATERS UH-1, UH-2, UH-3 AND
- PROVIDE NEW 120V, 1 PHASE, 1P BREAKER, 15 AMP SUPPLY, CONTROLS WIRING FROM THE OUTDOOR UNIT AND POWER SUPPLY TO SERVE CONTROL DAMPERS TO THE INDOOR FAN COIL (NOT SHOWN FOR CLARITY). MD-AHU3A, MD-AHU3B, MD-AHU3C AND ROOF TOP DISCHARGE DUCT FROM FAN COILS TO BE 1000 X GFI RECEPTACLE. PROVIDE NEW 120V, 1 PHASE BREAKER, 15 AMP AND POWER SUPPLY TO SERVE
- CONDENSATE, 12 MM DIAM. FROM COIL DRAIN PAN, 8. MOUNT UNIT HEATER AS HIGH AS POSSIBLE, IN JOIST SPACE. ENSURE ALL PIPING AND WIRING IS CLEAR OF THE OVERHEAD CRANE. PROVIDE DIFFUSER & LOCAL DISCONNECT SWITCH BESIDE EACH UNIT HEATER. FANS TO BE CONTROLLED BY DDC SYSTEM. REFER TO SEQUENCES OF CONTROL.
 - 9. REPLACE/MODIFY EXISTING PAINT ROOM HVAC CONTROLS TO PROVIDE CONTROL DEVICES A INDICATED IN THE PAINT ROOM DETAIL ON DRWG ME-7 AND SEQUENCES OF CONTROL INDICATED IN THE SPECIFICATIONS. PROVIDE CONTROL DISPLAY SCREEN AND NEMA 1 ENCLOSURE(S).
 - 10. PROVIDE NEW 400 X 350 SUPPLY AND EXHAUST AIR DUCTS AND TRANSITION AS REQUIRED TO CONNECT TO INLET AND OUTLET OF HRV-1. BALANCE O/A FLOW TO EACH FAN COIL AT 140L/S. TERMINATE EACH O/A DUCT WITHIN 200 OF FAN COIL RETURN PLENUM. HRV-1 ON ROOF. REFER TO ME-5 FOR
- PROVIDE A NEW HIGH EFFICIENCY, ELECTRIC MOTOR 12. THE OFFICE AND WORKSHOP AREAS ARE TO BE KEPT CONSTRUCTION. SHORT SERVICE OUTAGES (1-30 MINUTES) SHALL BE ALLOWED DURING OFFICE HOURS IF AND WHEN COORDINATED WITH THE BASE
- 13. OUTAGES SHALL BE PRE-PLANNED AND AT LEAST 96 HOURS OF NOTICE PROVIDED BEFORE THE OUTAGE. ALLOW FOR AFTER HOUR CONSTRUCTION AND CLEAN UP BEFORE OFFICE HOURS RESUME IN EACH MORNING. CONSTRUCTION WORK ON WEEKENDS WILL BE ALLOWED, SUBJECT TO THE BASE OPERATIONS AUTOMATICALLY FROM THE GLYCOL MIXING TANK WHEN MANAGER'S APPROVAL. ANY SERVICE OUTAGES WHICH AFFECT THE OPERATIONS OF THE COMPUTER SERVERS BELOW 30 207 KPA (30 PSI). SEISMICALLY ANCHOR MUST BE PRE-APPROVED AND THE DURATION OF THE OUTAGE MINIMIZED. MEASURES SHALL BE TAKEN TO PROTECT COMPUTER, ELECTRONICS AND PERSONAL EQUIPMENT IN THE FACILITY. CEILING TILES MAY BE REMOVED AT THE START OF DEMOLITION AND LEFT OPEN UNTIL THE CONSTRUCTION WORK IS COMPLETE.
- EXISTING 500 AMP, 600/3/60 PANEL AND PANEL A; 14. EQUIPMENT LOCATIONS SHOWN ARE APPROXIMATE AND THE CONTRACTOR SHALL CONFIRM BEST EXACT LOCATIONS TO SUIT SITE CONDITIONS. THE CONTRACTOR IS TO RESUPPORT AND RE-CONNECT FLEXIBLE DUCTWORK FOR APPROXIMATELY FOUR OF THE EXISTING DIFFUSERS WHICH HAVE BECOME DISCONNECTED
- CONTROLS AND INTERFACE DEVICES AS INDICATED IN EXISTING CEILING, LIGHT FIXTURE, DUCTWORK AND PIPING SUPPORTS AND MISC WIRING, AND ELECT. CONDUIT 20 MM DIAM AND LESS AS REQUIRED TO INSTALL THE NEW EQUIPMENT. THE CONTRACTOR LIGHTING FIXTURES TO ADJACENT LOCATIONS TO ALLOW FOR BETTER SERVICE ACCESS TO EQUIPMENT. LOCATE ACCESS PANELS TO PROVIDE THE BEST SERVICE ACCESS.
 - FOR THE OVERHEAD CRANE AND OTHER SHOP EQUIPMENT. THE CONTRACTOR SHALL CONFIRM THAT ALL EQUIPMENT IS CLEAR OF THE CRANE BY TRAVERSING THE CRANE THROUGH IT'S FULL
- 2-#10+1-#12 GRN GRD, 20 mm CONDUITS TO 17. ALL NEW EQUIPMENT SHALL BE INSTALLED C/W SERVE HEAT RECOVERY VENTILATOR HRV-1. PROVIDE LOCAL, SAFETY ISOLATION SWITCH. INDOOR HEAT NEW 120V, 15 AMP 1P BREAKER AND POWER FEEDS PUMPS TO BE COMPLETE WITH VIBRATION ISOLATION HANGERS, SEISMIC RESTRAINT AND FLEX CONNECTIONS ON S/A AND R/A DUCTWORK CONNECTIONS.


FISHERIES AND OCEANS CANADA REAL PROPERTY AND SAFETY AND SECURITY

CANADIAN COAST GUARD VICTORIA BASE BUOY MAINTENANCE BUILDING HVAC UPGRADES GROUND FLOOR PLAN NEW


MARCH 7, 2019 DRAWING NUMBER ME-3

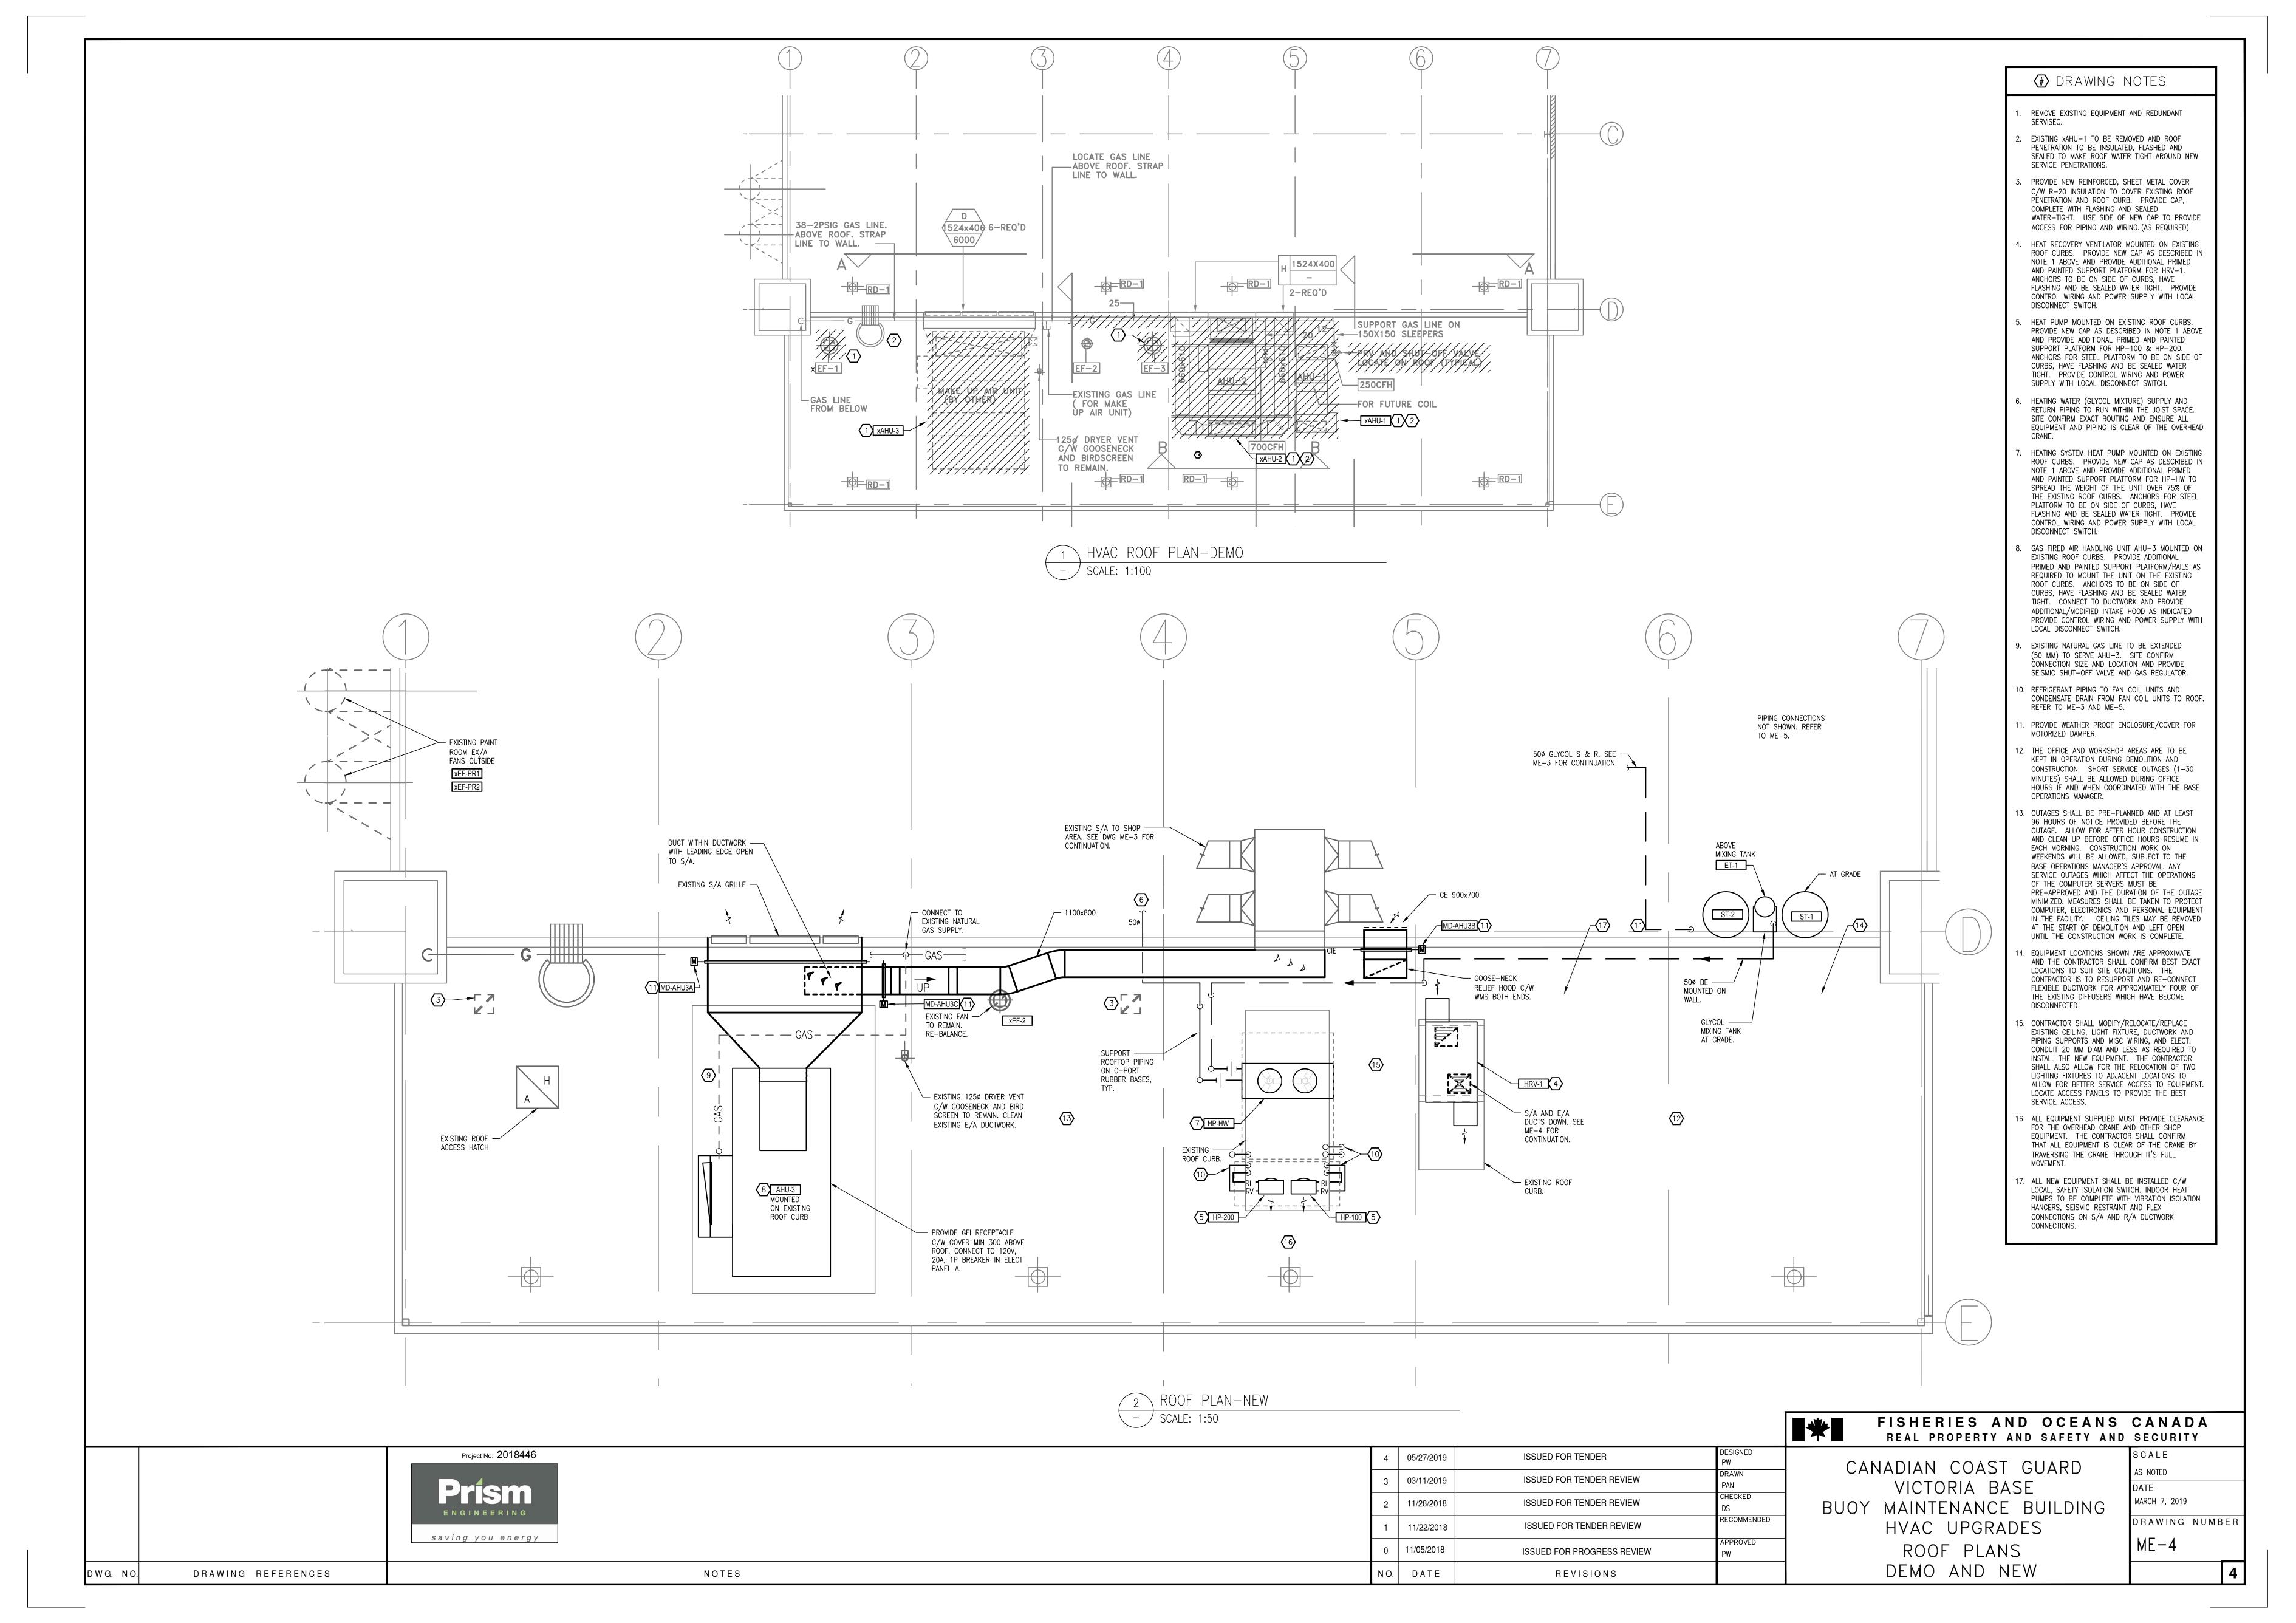

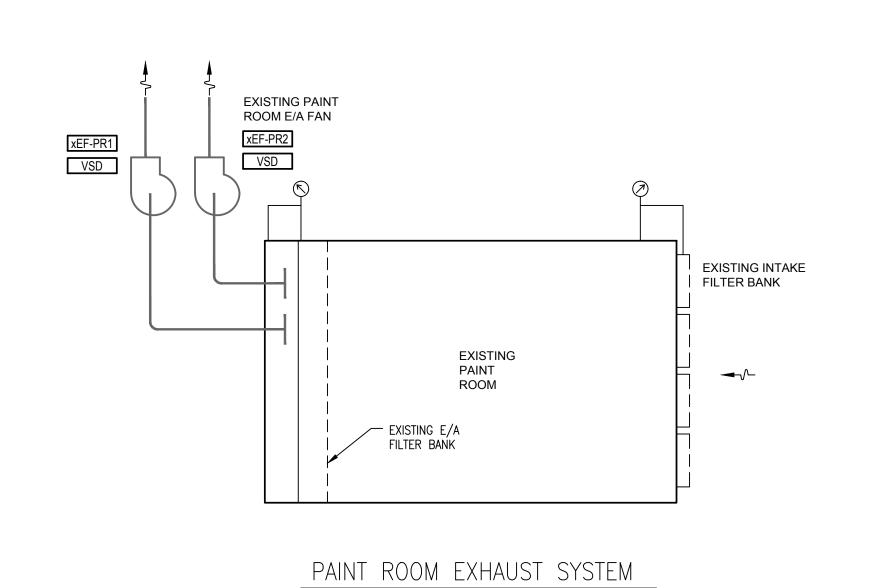


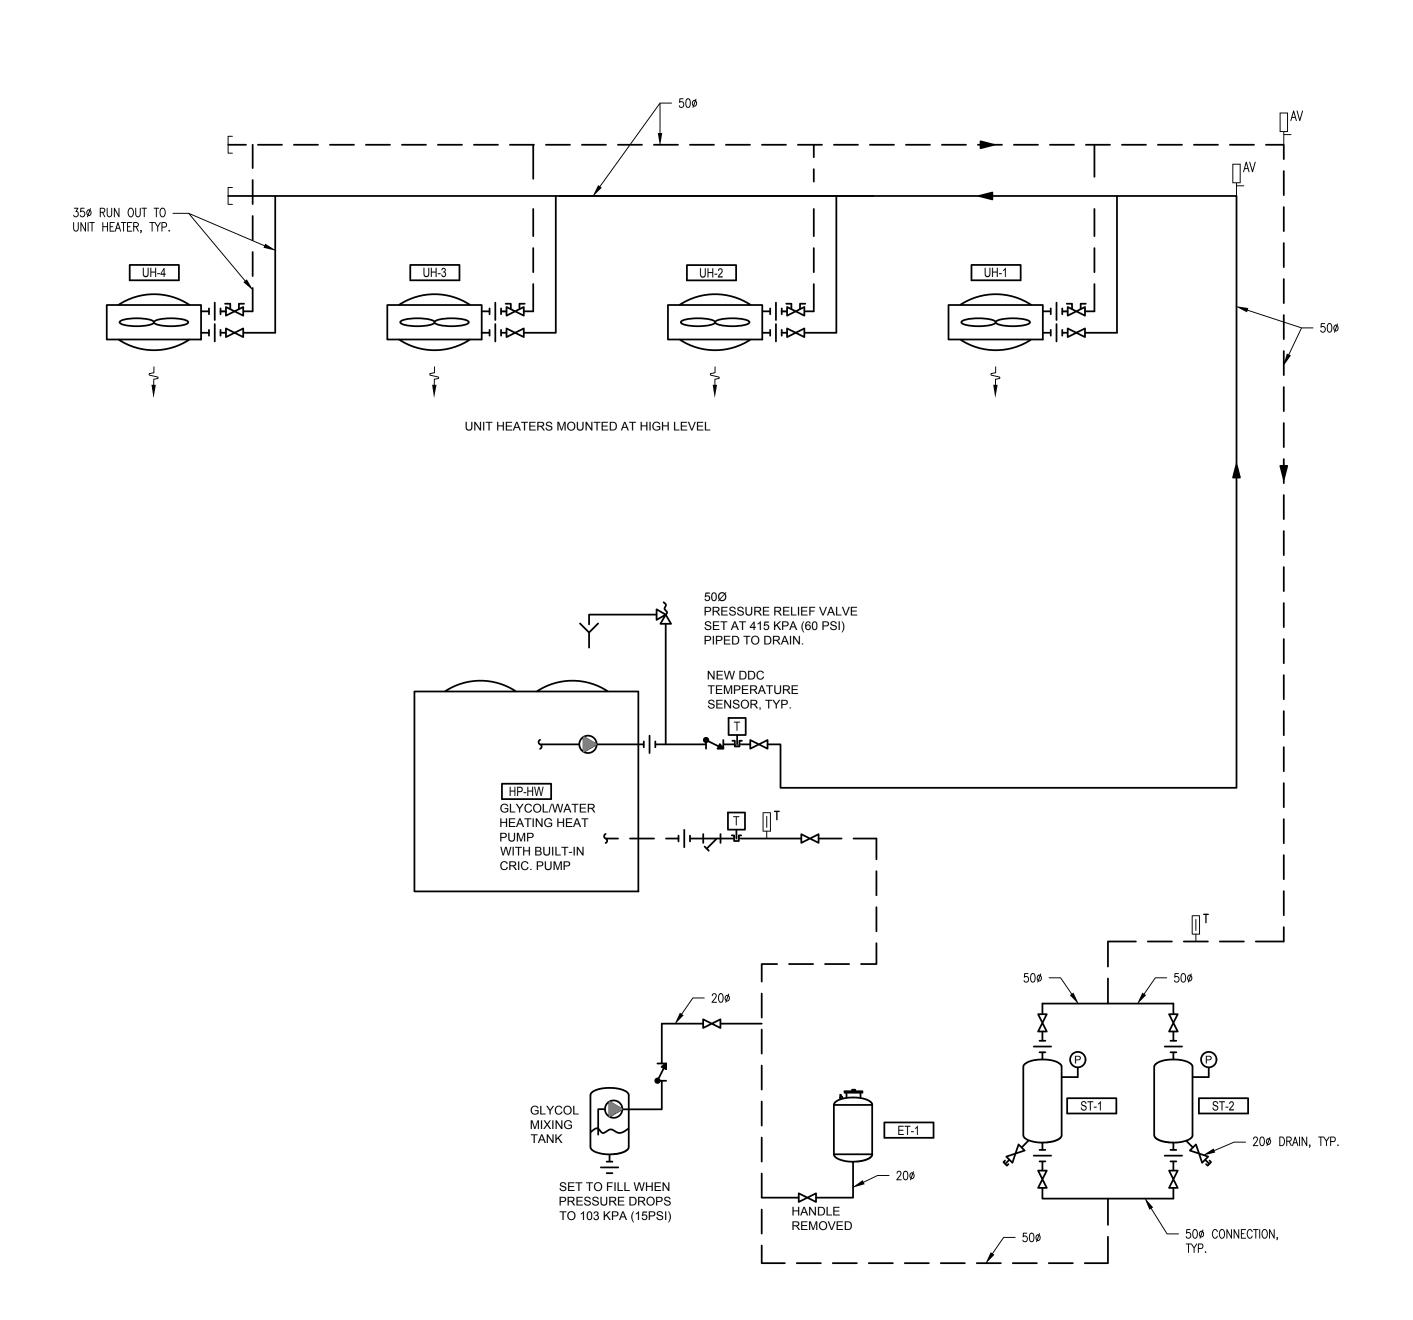


SUPPLEMENTAL HEAT PUMP GLYCOL HEATING SYSTEM

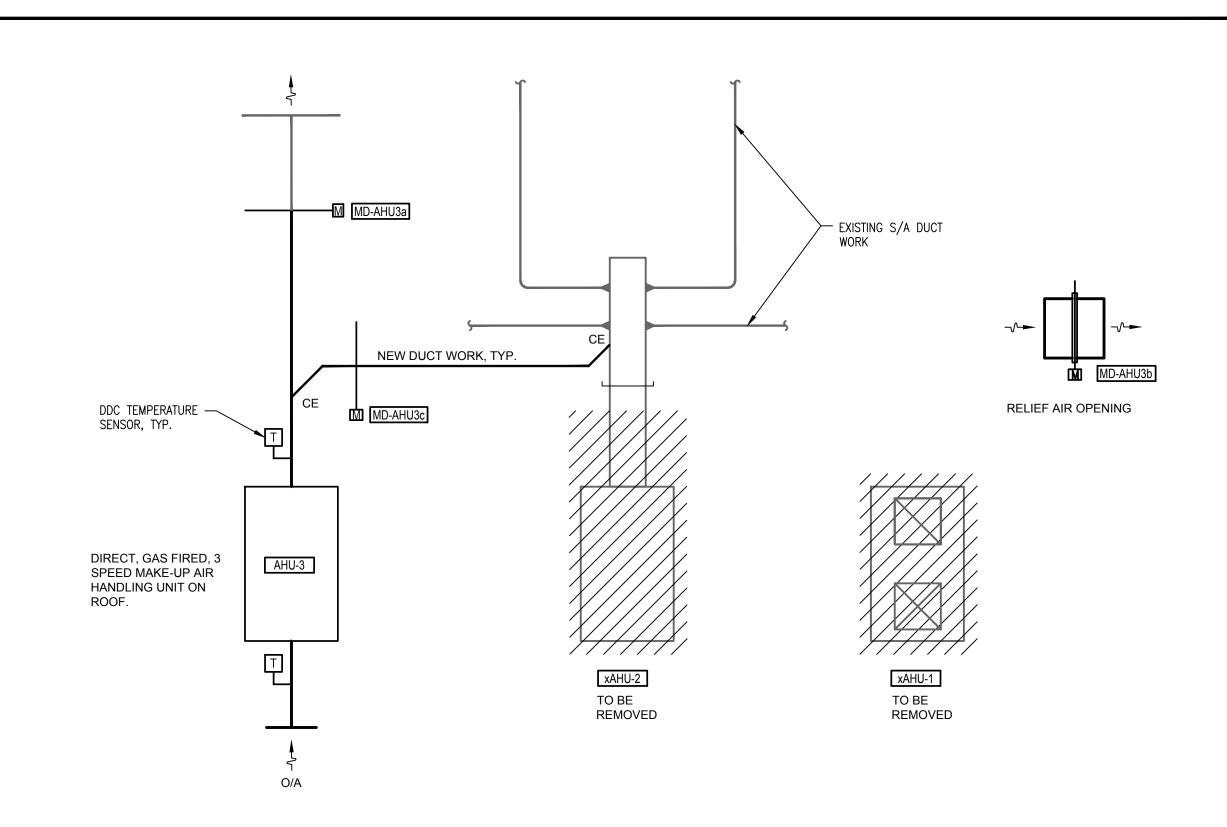

PAINT BOOTH MAKE-UP AIR

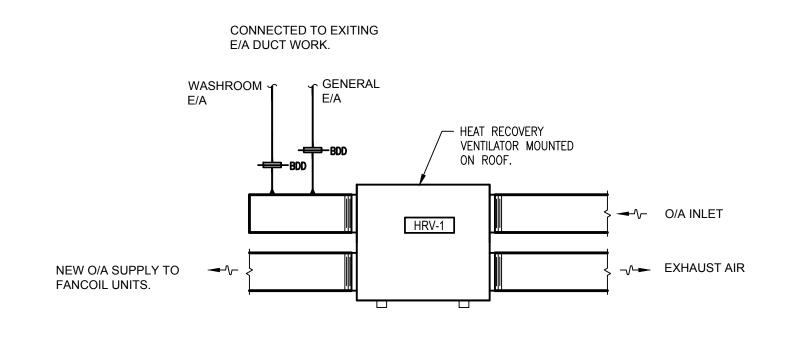


HEAT RECOVERY VENTILATOR

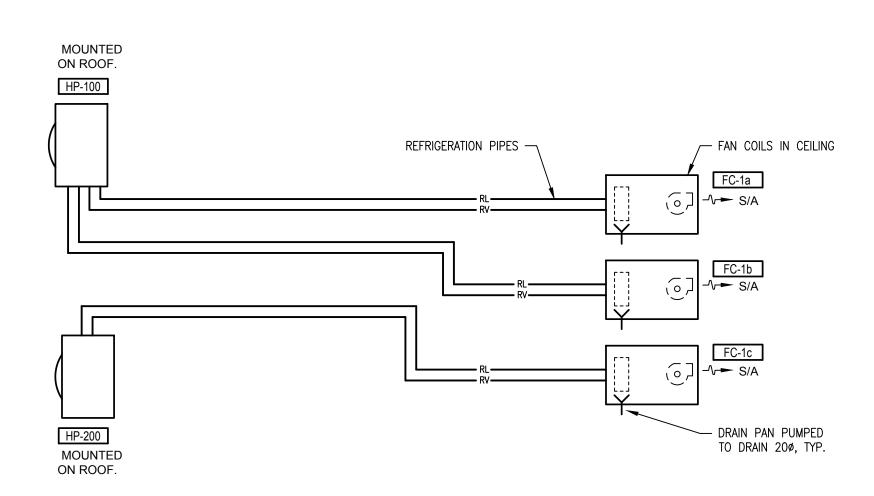


OFFICE HEAT PUMPS

				FISHERIES AND OCEANS REAL PROPERTY AND SAFETY AND	
	Project No: 2018446	4 05/27/2019	ISSUED FOR TENDER DESIGNED PW	CANADIAN COAST GUARD	SCALE
	Prism ENGINEERING .	3 03/11/2019	ISSUED FOR TENDER REVIEW PAN	VICTORIA BASE	DATE
		2 11/28/2018	ISSUED FOR TENDER REVIEW CHECKED DS	BUOY MAINTENANCE BUILDING	MARCH 7, 2019
		1 11/22/2018	ISSUED FOR TENDER REVIEW	HVAC UPGRADES	DRAWING NUMBEI
saving you energy		0 11/05/2018	ISSUED FOR PROGRESS REVIEW APPROVED PW		ME-5
DWG. NO. DRAWING REFERENCES	NOTES	NO. DATE	REVISIONS	SCHEMATIC DIAGRAMS	[4

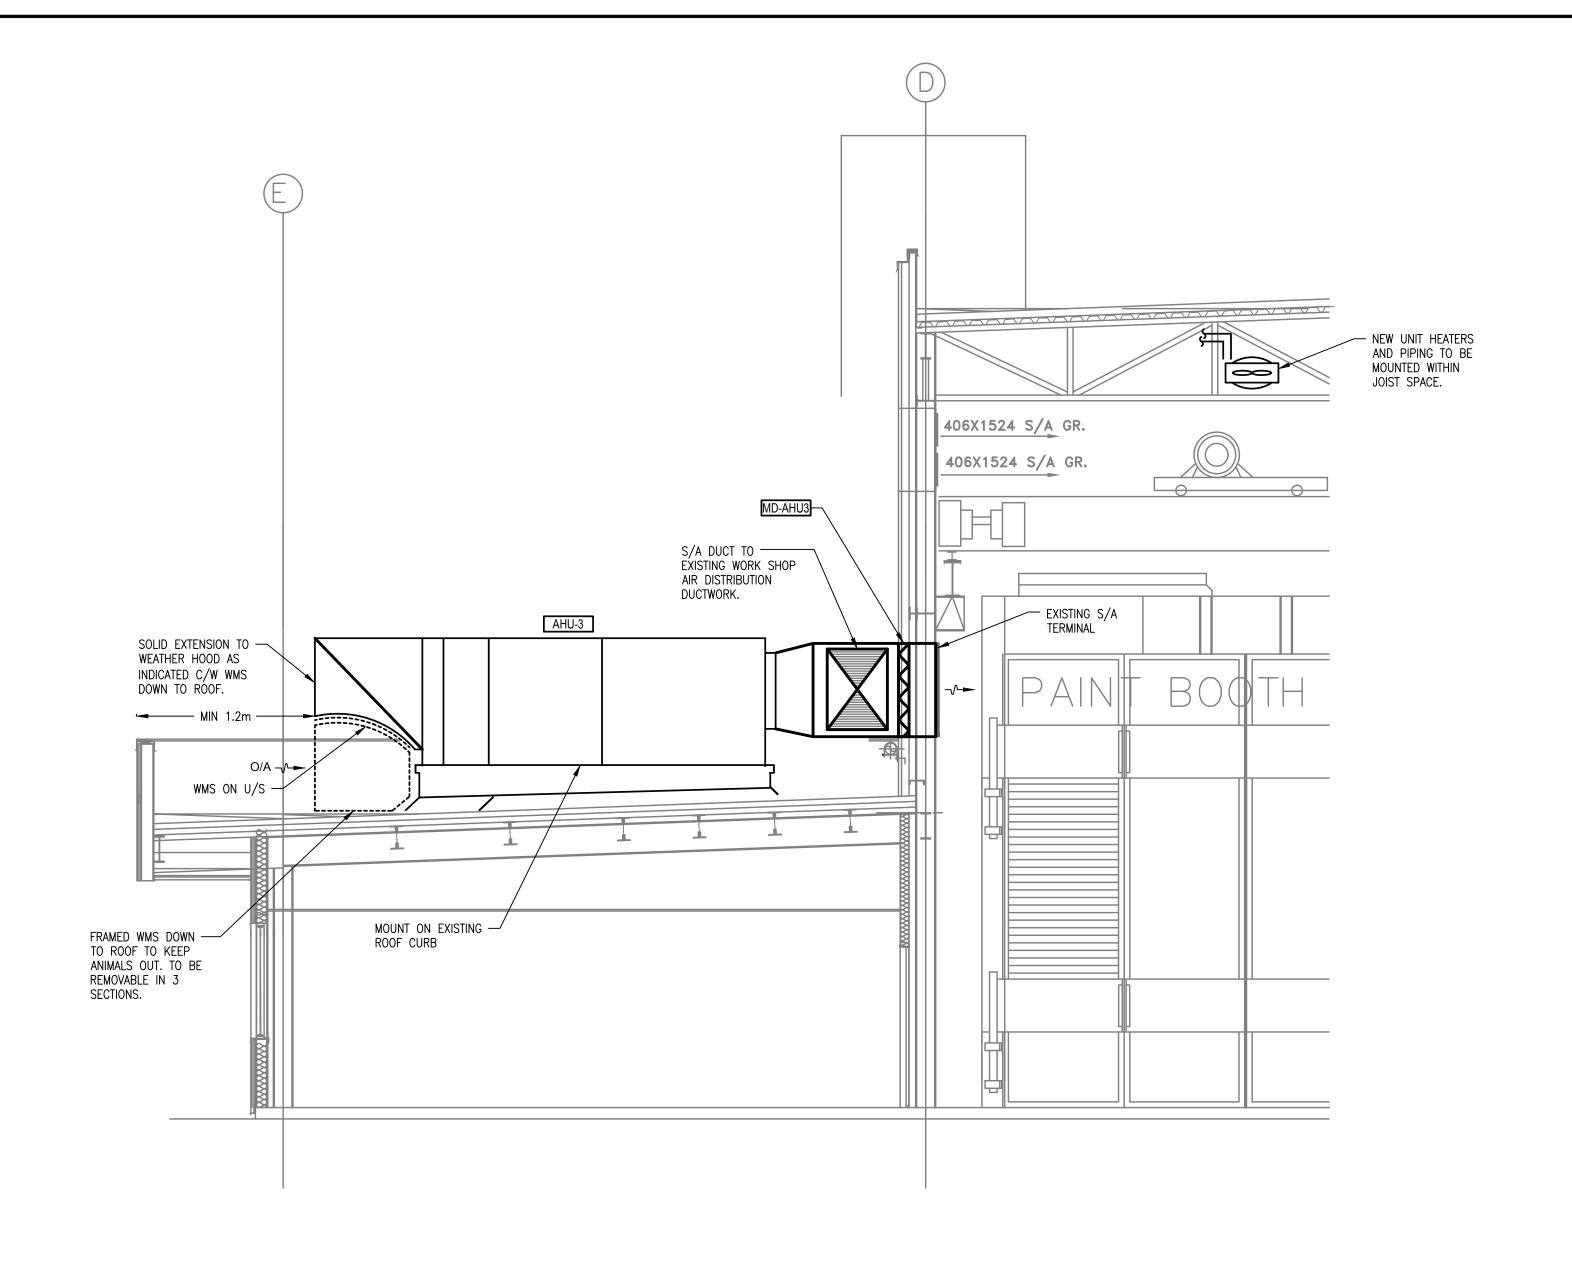

1 SECTION - SCALE: NTS

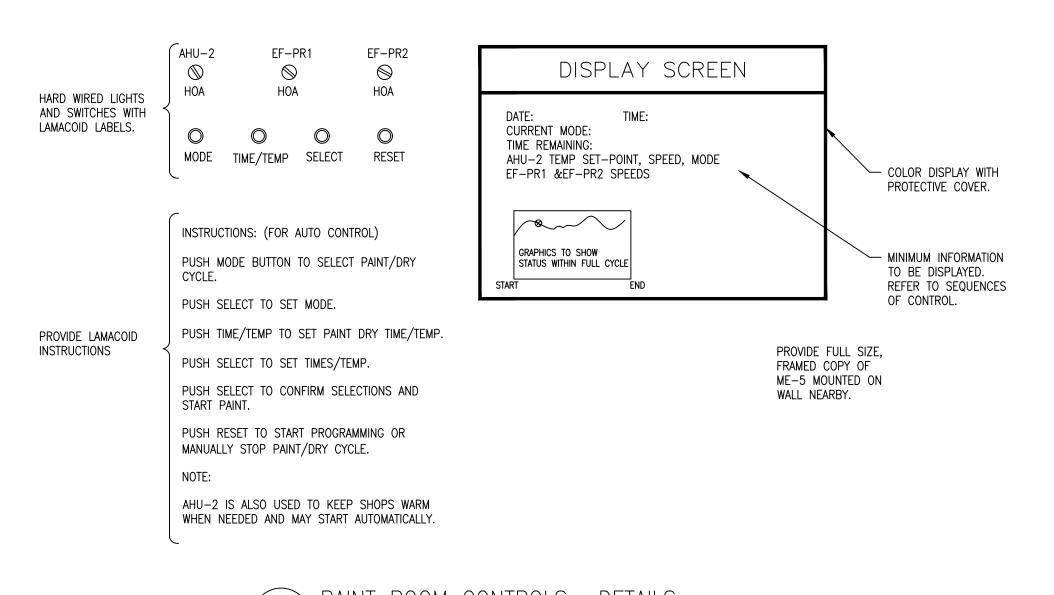

PAINT ROOM CONTROLS- DETAILS - SCALE: NTS

							— T
		Project No: 2018446	4 05	5/27/2019	ISSUED FOR TENDER	DESIGNED PW	
		3 03	3/11/2019	ISSUED FOR TENDER REVIEW	DRAWN PAN		
		ENGINEERING	2 1	1/28/2018	ISSUED FOR TENDER REVIEW	CHECKED DS	
			1 1	1/22/2018	ISSUED FOR TENDER REVIEW	RECOMMENDED	
		saving you energy	0 11	/05/2018	ISSUED FOR PROGRESS REVIEW	APPROVED PW	
WG. NO.	DRAWING REFERENCES	NOTES	NO.	DATE	REVISIONS		

REAL PROPERTY AND SAFETY AND SECURITY CANADIAN COAST GUARD
VICTORIA BASE
BUOY MAINTENANCE BUILDING
HVAC UPGRADES

FISHERIES AND OCEANS CANADA

SECTIONS AND DETAILS

DATE MARCH 7, 2019 DRAWING NUMBER ME-6