


DOOR SCHEDULE


DOOR No.	DIMENSIONS			DOOR					FRAME						REMARKS
	W	H	Th.	Elev.	Type	Fin.	Hdwe.	Misc.	Elev.	Type	Jamb	Fin.	Misc.	Fire Rating	
101X	915	2134	45	2	IHM	P	X01	-	1	PS	E	P	-	1.5 HR	GLAZING TO BE FIRE-RATED.
101A	915	2134	45	2	HM	P	H01	-	1	PS	B	P	-	-	
102	800±	2134±	45	1	HM	P	H08	-	1	PS	C	P	-	1.5 HR	CONFIRM ACTUAL ROUGH OPENING ON SITE.
103A	EX	EX	EX	EX	EX	P	EX	-	EX	EX	EX	P	-	-	
104	2-750±	2134±	45	3	HM	P	H09	-	2	PS	C	P	-	1.5 HR	CONFIRM ACTUAL ROUGH OPENING ON SITE.
105	950±	2134±	45	1	HM	P	H02	-	1	PS	C	P	-	1.5 HR	CONFIRM ACTUAL ROUGH OPENING ON SITE.
106	950±	2134±	45	1	HM	P	H08	-	1	PS	C	P	-	1.5 HR	CONFIRM ACTUAL ROUGH OPENING ON SITE.
107X	4300	4572	50	5	RUR	P	-	-	4	SP	D	P	-	-	HARDWARE BY DOOR MANUFACTURER
107	915	2134	45	1	HM	P	H03	-	1	PS	C	P	-	1.5 HR	
108X	915	2134	45	1	IHM	P	X01	-	1	PS	E	P	-	-	
108A	915	2134	45	2	HM	P	H02	-	1	PS	C	P	-	1.5 HR	GLAZING TO BE FIRE-RATED.
109	915	2134	45	1	HM	P	H05	-	1	PS	C	P	-	1.5 HR	
111	EX	EX	EX	EX	EX	P	EX	-	EX	EX	EX	P	-	-	
112	EX	EX	EX	EX	EX	P	EX	-	EX	EX	EX	P	-	-	
112X	610, 450	2134	45	3	IHM	P	X03	-	2	PS	E	P	-	1.5 HR	
113	EX	EX	EX	EX	EX	P	EX	-	EX	EX	EX	P	-	-	
114	900±	2134±	45	1	HM	P	H03	-	1	PS	C	P	-	1.5 HR	CONFIRM ACTUAL ROUGH OPENING ON SITE.
115A	EX	EX	EX	EX	EX	P	EX	-	EX	EX	EX	P	-	-	
115B	800±	2134±	45	1	HM	P	H03	-	1	PS	C	P	-	1.5 HR	CONFIRM ACTUAL ROUGH OPENING ON SITE.
116	900±	2134±	45	1	HM	P	H03	-	1	PS	C	P	-	1.5 HR	CONFIRM ACTUAL ROUGH OPENING ON SITE.
117AX	4300	4572	50	5	RUR	P	-	-	4	SP	D	P	-	-	HARDWARE BY DOOR MANUFACTURER
117BX	5350	4572	50	4	RUR	P	-	-	3	SP	D	P	-	-	HARDWARE BY DOOR MANUFACTURER
117CX	5350	4572	50	4	RUR	P	-	-	3	SP	D	P	-	-	HARDWARE BY DOOR MANUFACTURER
117DX	5350	4572	50	4	RUR	P	-	-	3	SP	D	P	-	-	HARDWARE BY DOOR MANUFACTURER
118X	4330	4572	50	5	RUR	P	-	-	4	SP	D	P	-	-	HARDWARE BY DOOR MANUFACTURER
118A	EX	EX	EX	EX	EX	P	-	-	EX	EX	EX	P	-	-	
118B	915	2134	45	1	HM	P	H03	-	1	PS	E	P	-	-	
119X	4330	4572	50	5	RUR	P	-	-	4	SP	D	P	-	-	HARDWARE BY DOOR MANUFACTURER
119	915	2134	45	1	HM	P	H03	-	1	PS	C	P	-	-	
120X	4330	4572	50	5	RUR	P	-	-	4	SP	D	P	-	-	HARDWARE BY DOOR MANUFACTURER
121AX	4330	4572	50	5	RUR	P	-	-	4	SP	D	P	-	-	HARDWARE BY DOOR MANUFACTURER
121BX	915	2134	45	2	IHM	P	X02	-	1	PS	E	P	-	-	
201A	950±	2134±	45	2	HM	P	H02	-	1	PS	C	P	-	1.5 HR	GLAZING TO BE FIRE-RATED
202	860	2134	45	1	HM	P	H06	-	1	PS	C	P	-	-	
203	EX	EX	EX	EX	EX	P	EX	-	EX	EX	EX	P	-	-	
204	813	2134	45	1	HM	P	H04	-	1	PS	A	P	-	-	
205	813	2134	45	1	HM	P	H05	-	1	PS	A	P	-	-	
207	915	2134	45	1	HM	P	H07	-	1	PS	A	P	-	-	
207X	915	2134	45	2	HM	P	X02	-	5	PS	E	P	-	1.5 HR	GLAZING TO BE FIRE-RATED.

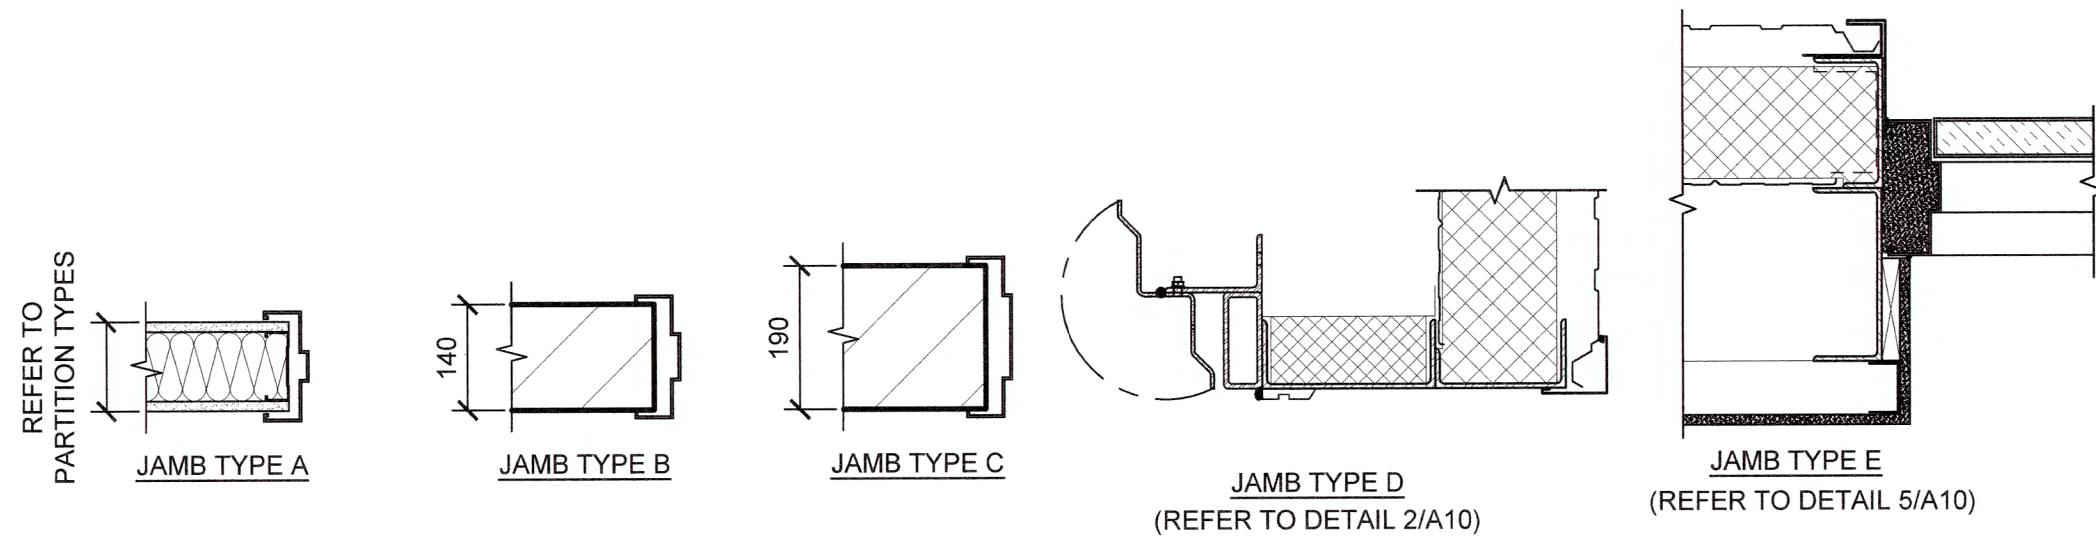

DOOR JAMB DETAILS

SCALE: 1:10

0mm 100 200 300 400 500 600 700 800 900 1000mm

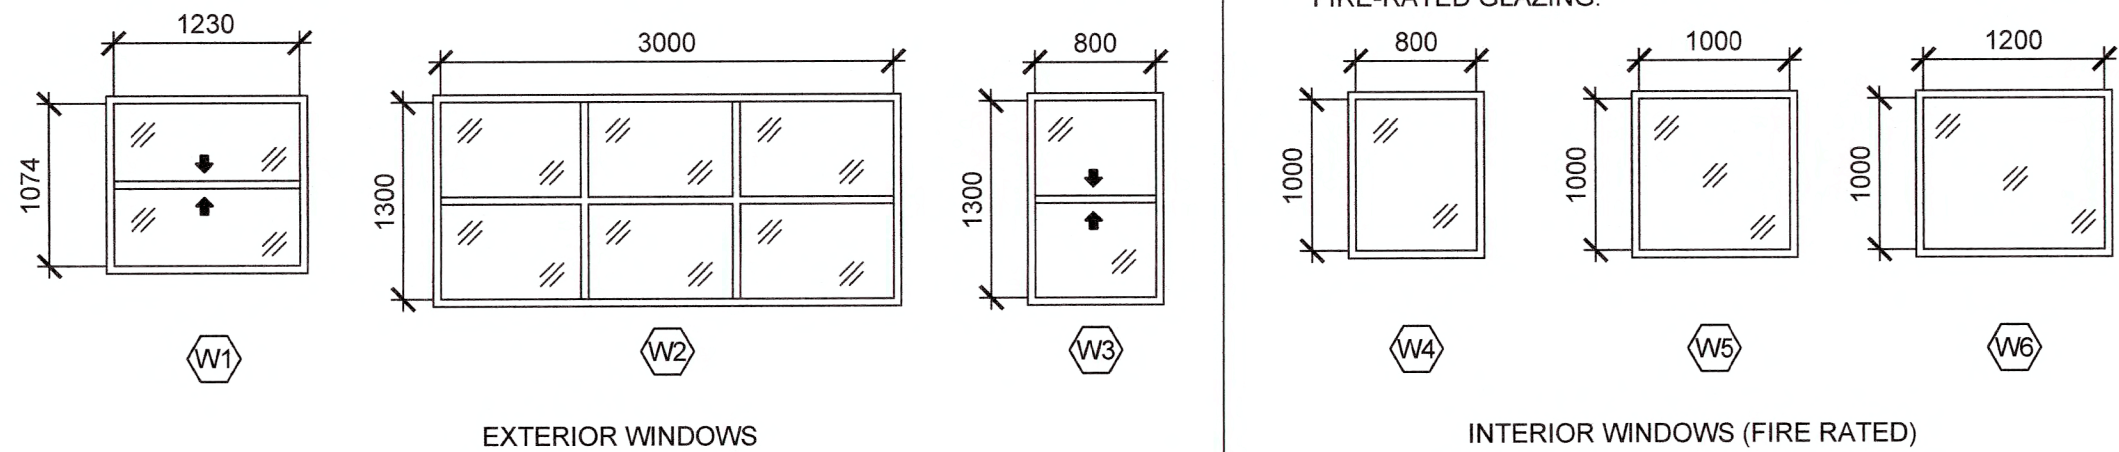3
A14

WINDOW ELEVATIONS


SCALE: 1:50

0m 1m 2m 3m 4m 5m

4
A14

ROOM FINISH SCHEDULE


ROOM NAME	ROOM No.	FLOOR		BASE		WALLS								CEILING			REMARKS
		MAT.	FIN.	MAT.	FIN.	NORTH		SOUTH		EAST		WEST		MAT.	FIN.	HGT.	
						MAT.	FIN.	MAT.	FIN.	MAT.	FIN.	MAT.	FIN.				
VESTIBULE	101	EX	EP*	R	-	EX	P	EX	P	EX	P	EX	P	GB	P	EX	*EPOXY PAINT c/w BROADCAST SILICA SAND BETWEEN COATS.
DIESEL ROOM	102	EX	EX	-	-	EX	P	EX	P	GB	FRP/P	EX	P	EX	-	EX	FRP TO 2400mm ABOVE FLOOR.
CORRIDOR	103	EX	EP*	R	-	EX	P	EX	-	EX	P	EX	P	ACT	-	EX	*EPOXY PAINT c/w BROADCAST SILICA SAND BETWEEN COATS.
TELEPHONE EQUIPMENT	103A	EX	EP*	R	-	EX	P	EX	P	EX	P	EX	P	GB	P	EX	*EPOXY PAINT c/w BROADCAST SILICA SAND BETWEEN COATS.
FIELD LIGHTING REGULATOR & SWITCH GEAR ROOM	104	EX	EX	-	-	EX	P	EX	P	GB	FRP/P	EX	P	EX	-	EX	FRP TO 2400mm ABOVE FLOOR.
CORRIDOR	105	EX	EP*	R	-	EX	P	EX	P	EX/GB	P	EX	P	ACT	-	EX	*EPOXY PAINT c/w BROADCAST SILICA SAND BETWEEN COATS.
MECHANICAL ROOM	106	EX	EX	-	-	EX	P	EX	P	GB	FRP/P	EX	P	EX	-	EX	FRP TO 2400mm ABOVE FLOOR.
A.E.S. VEHICLE	107	EX	EX	-	-	EX	P	EX	P	GB	FRP/P	EX	P	EX	-	EX	FRP TO 2400mm ABOVE FLOOR.
VESTIBULE	108	EX	EP*	R	-	EX	P	EX	P	EX/GB	P	EX	P	GB	P	EX	*EPOXY PAINT c/w BROADCAST SILICA SAND BETWEEN COATS.
WASHROOM	109	EX	EP*	R	-	CB	P	EX/CB	P	EX	P	EX	P	GB	P	EX	*EPOXY PAINT c/w BROADCAST SILICA SAND BETWEEN COATS.
ALCOVE	110	EX	EP*	R	-	GB	P	EX	P	EX	P	EX	P	ACT	-	EX	*EPOXY PAINT c/w BROADCAST SILICA SAND BETWEEN COATS.
ELECTRICIAN'S AREA	111	EX	EX	-	-	EX	P	EX	P	EX	P	EX	P	ACT	-	EX	
MAINTENANCE HANDYMAN	112	EX	EX	-	-	EX	P	EX	P	EX	P	EX	P	ACT	-	EX	
FIELD TOOLS & MATERIALS	113	EX	EX	-	-	EX	P	EX	P	EX	P	EX	P	ACT	-	EX	
VEHICLE PARTS & TOOL STORAGE	114	EX	EX	-	-	EX	P	EX	P	EX	P	EX	P	ACT	-	EX	
TRADE STORAGE	115	EX	EX	-	-	EX	P	EX	P	EX	P	EX	P	ACT	-	EX	
OIL & GREASE DISPENSARY	116	EX	EX	-	-	EX	P	EX	P	EX	P	EX	P	ACT	-	EX	
MAINTENANCE GARAGE	117	EX	EP*	-	-	EX	P	EX	P	EX	P	GB	FRP/P	-	-	-	*EPOXY PAINT c/w BROADCAST SILICA SAND BETWEEN COATS. FRP TO 2400mm ABOVE FLOOR.
MAINTENANCE BAY	117A	EX	EP*	-	-	EX	P	EX	P	EX	P	GB	FRP/P	-	-	-	*EPOXY PAINT c/w BROADCAST SILICA SAND BETWEEN COATS. FRP TO 2400mm ABOVE FLOOR.
MAINTENANCE BAY	117B	EX	EP*	-	-	EX	P	EX	P	EX	P	EX	P	-	-	-	*EPOXY PAINT c/w BROADCAST SILICA SAND BETWEEN COATS.
MAINTENANCE BAY	117C	EX	EP*	-	-	EX	P	EX	P	EX	P	EX	P	-	-	-	*EPOXY PAINT c/w BROADCAST SILICA SAND BETWEEN COATS.
MAINTENANCE BAY	117D	EX	EP*	-	-	EX	P	EX	P	EX	P	EX	P	-	-	-	*EPOXY PAINT c/w BROADCAST SILICA SAND BETWEEN COATS.
UREA STORAGE	118	EX	EX	-	-	EX	P	EX	P	EX	P	EX	P	-	-	-	
SAND STORAGE	119	EX	EX	-	-	EX	P	EX	P	EX	P	EX	P	-	-	-	
VEHICLE STORAGE BAY	120	EX	CHS	-	-	EX	P	EX	P	EX	P	EX	P	-	-	-	
VEHICLE STORAGE BAY	121	EX	CHS	-	-	EX	P	EX	P	EX	P	EX	P	-	-	-	
STAIR #1	101	EX	EX	-	-	EX	P	EX	P	EX	P	EX	P	EX	P	EX	NEW RUBBER TREADS AND RISERS.
CORRIDOR	201A	EX	RSF	R	-	EX	P	-	-	EX	P	EX	P	ACT	-	2235	
CORRIDOR	201B	EX	RSF	R	-	-	-	EX	P	EX	P	EX	P	ACT	-	2235	
OFFICE	202	EX	RSF	R	-	EX	P	EX	P	EX	P	EX	P	ACT	-	-	
N.D.B.	203	EX	RSF	-	-	EX	P	EX	P	EX	P	EX	P	ACT	-	2235	
WASHROOM	204	EX	PT	PT	-	EX	CT1	EX	CT1	EX	CT1	EX	CT1	GB	P	2235	
LOCKER ROOM	205	EX	RSF	R	-	EX	P	EX	P	EX	P	EX	P	ACT	-	2235	
MULTIPURPOSE ROOM	206	EX	RSF	R	-	GB/GB	P	GB	P	CB	P	EX	P	ACT	-	2235	
KITCHEN	207	EX	RSF	R	-	E/GB	P/CT2	EX	P	CB	P/CT2	EX	P/CT2	ACT	-	2235	CT2 BACK SPLASH. REFER TO ELEVATIONS.

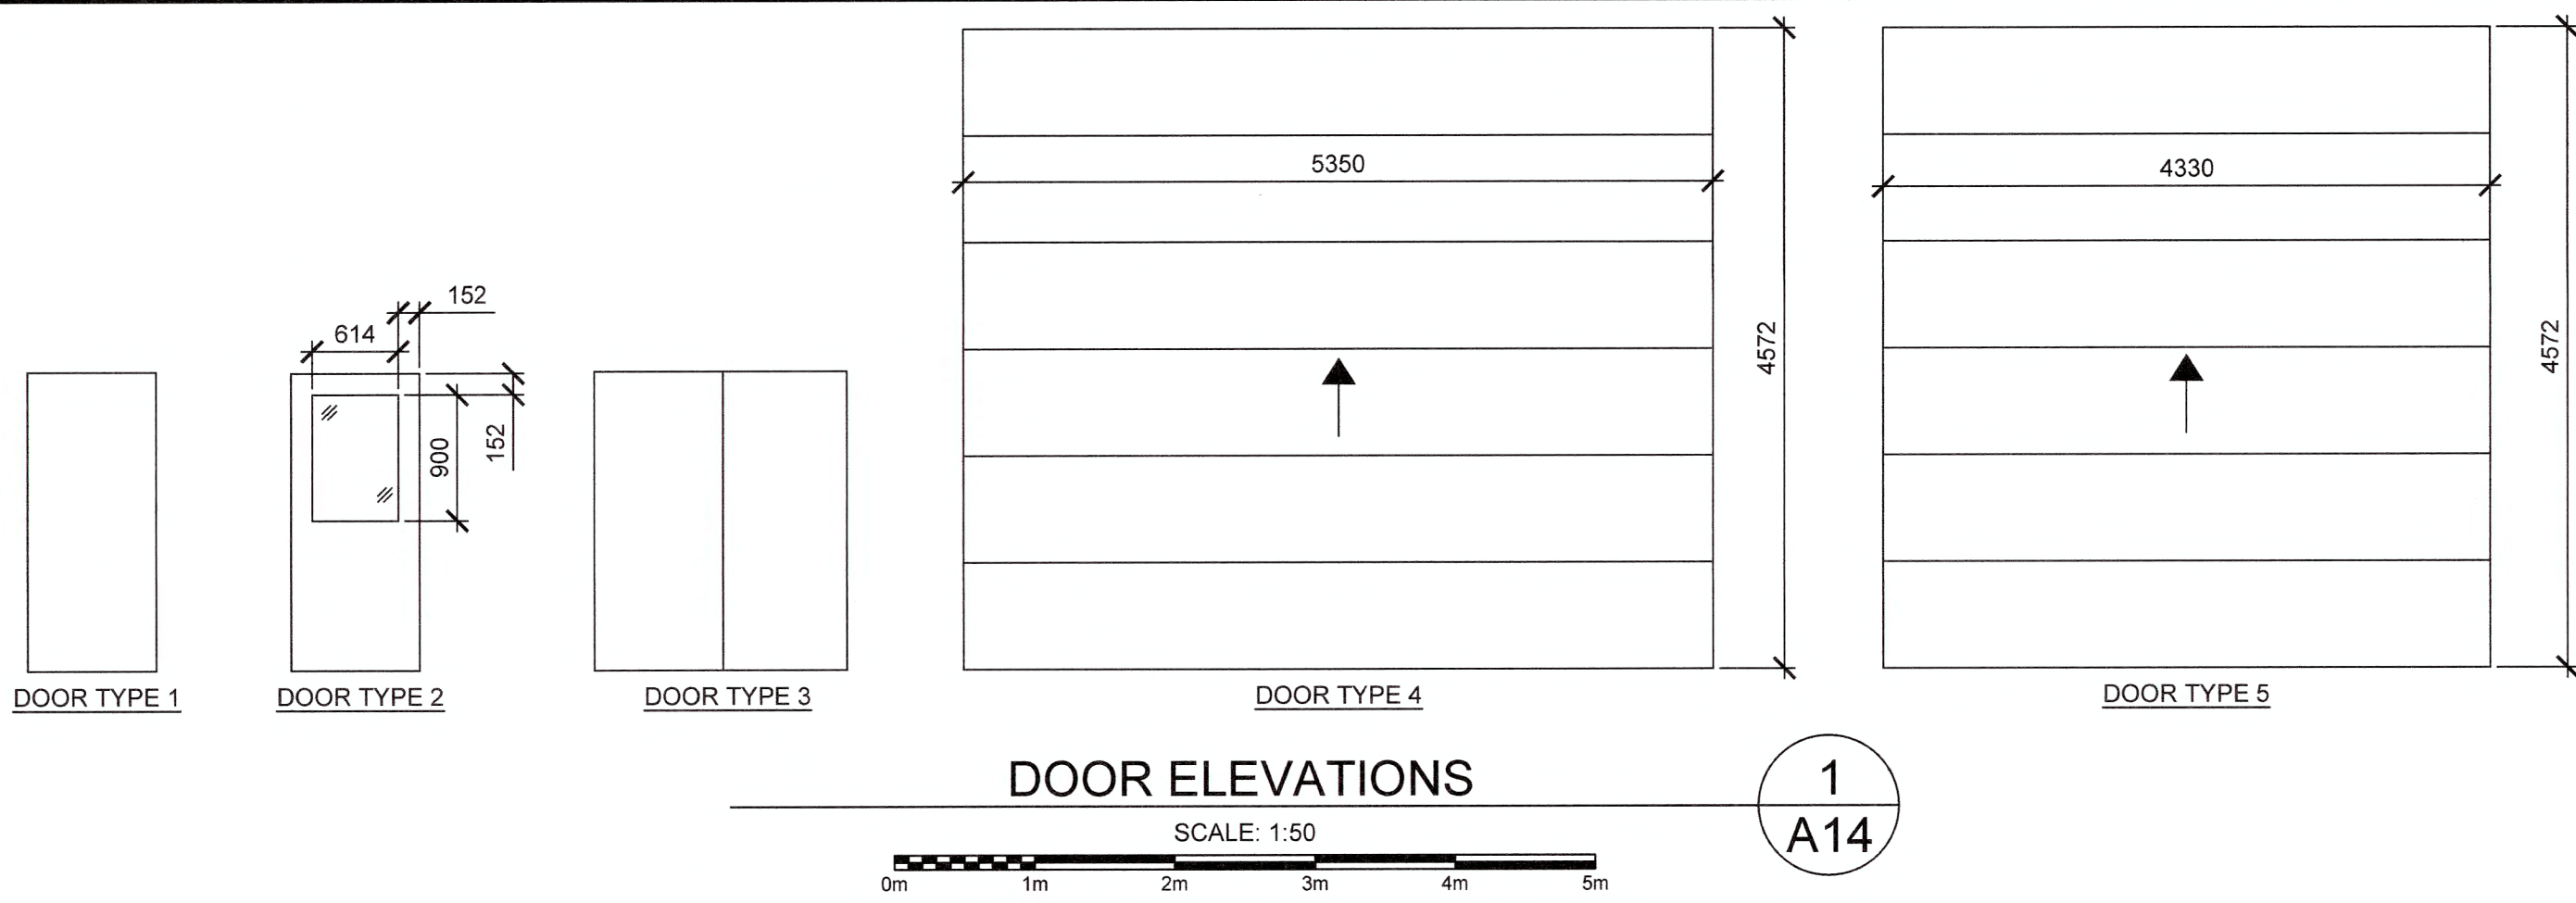

DOOR ELEVATIONS

SCALE: 1:50

0m 1m 2m 3m 4m 5m

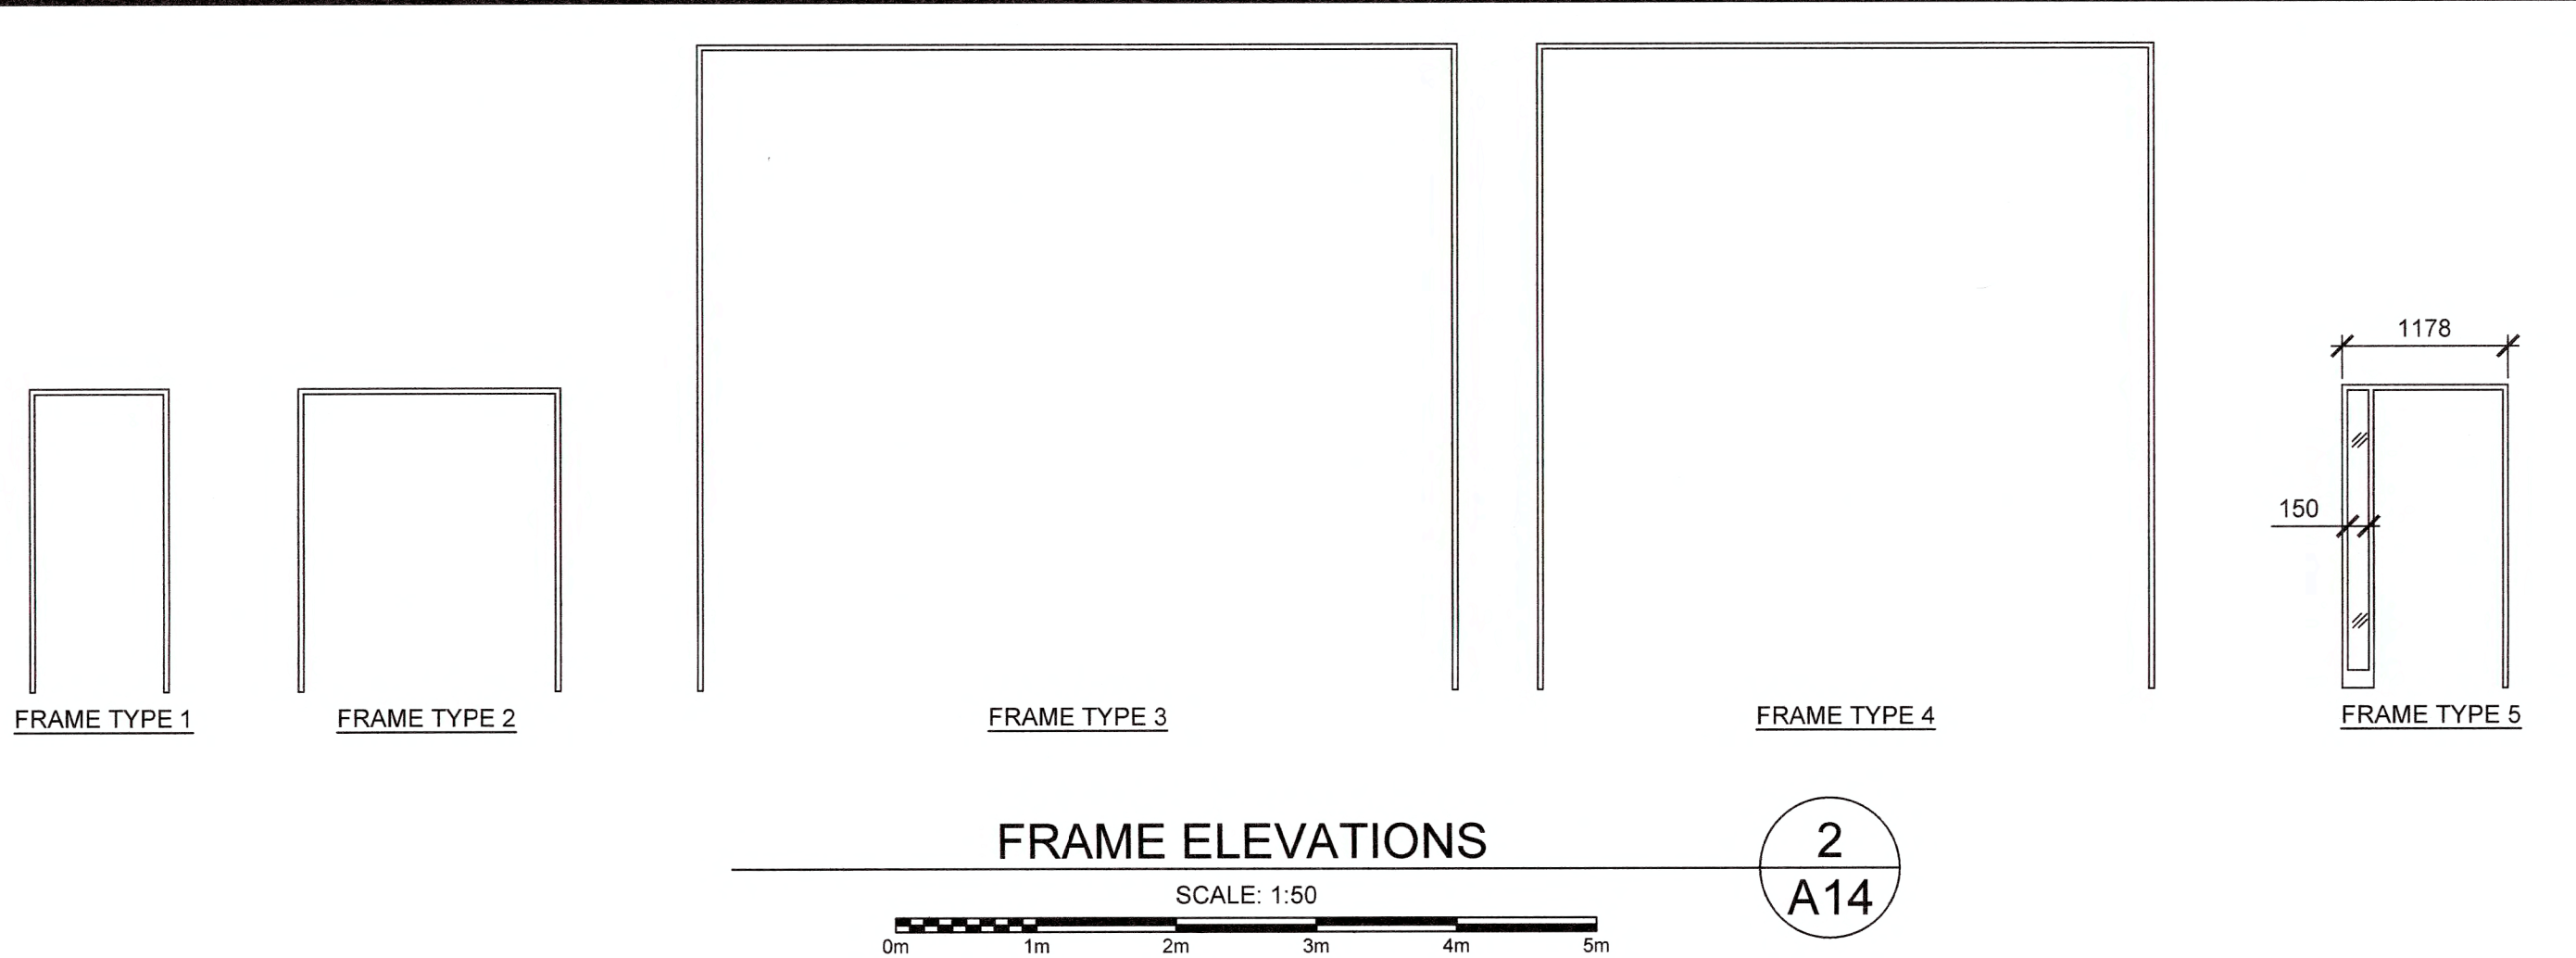1
A14

FRAME ELEVATIONS

SCALE: 1:50

0m 1m 2m 3m 4m 5m

2
A14

LEGEND

- ACT ACOUSTIC CEILING TILE
- CB CONCRETE BLOCK
- CHS CONCRETE HARDENER/SEALER
- CT CERAMIC TILE
- EP EPOXY PAINT
- EX EXISTING MATERIAL OR FINISH
- FRP FIBREGLAS REINFORCED PANEL
- GB GYPSUM BOARD
- HM HOLLOW METAL
- IHM INSULATED HOLLOW METAL
- PT PORCELAIN TILE
- P PAINT
- PS PRESSED STEEL
- R RUBBER
- RSF RESILIENT SHEET FLOORING
- RUR ROLL UP RUBBER
- SP STEEL PLATE (GALV.)



C02	ISSUED FOR TENDER	02/14 2019
C01	ISSUED FOR TENDER	09/28 2018
revisions		date

project

MAINTENANCE GARAGE
REHABILITATION
ST. ANTHONY AIRPORT

drawing

SCHEDULES
AND
MISCELLANEOUS DETAILS

designed N.S.

date 2016.11.22

drawn A.M.

date 2016.11.22

approved K.S.

date 2016.11.22

Tender

PWGSC Project Manager

project number

R.077269.001

drawing no.

A14