
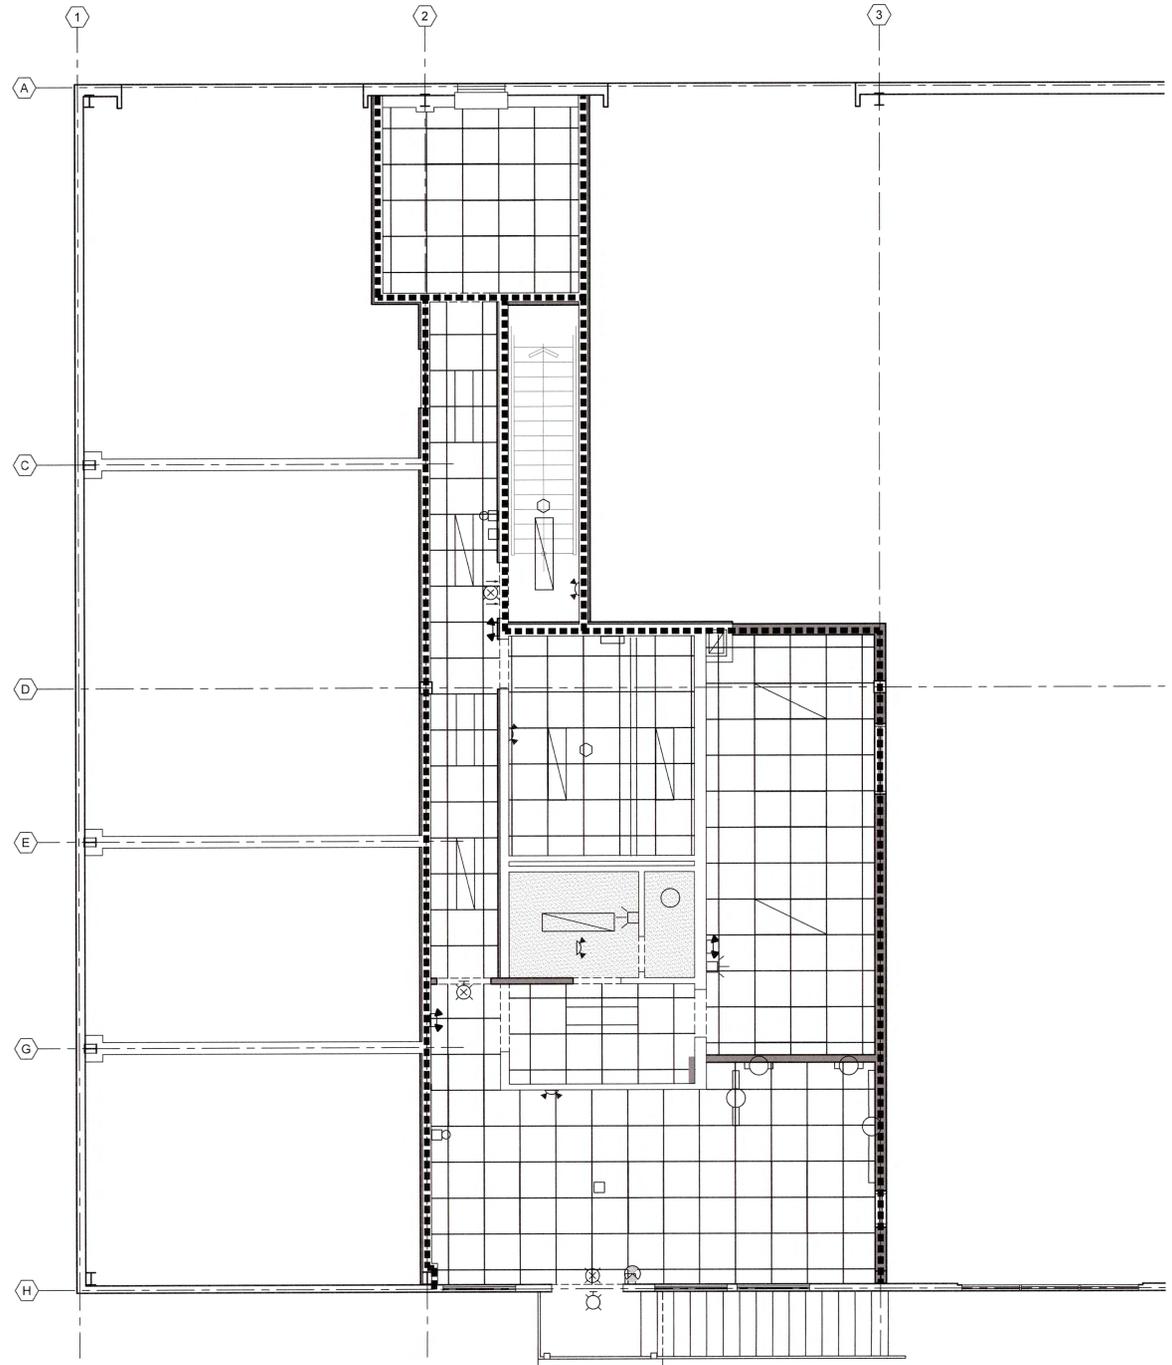


CONSTRUCTION LEGEND:

	DENOTES ROOM NUMBER
	610x610 CEILING TILE
	16mm TYPE 'X' GYPSUM BOARD
	EXISTING CEILING TO REMAIN OR OPEN TO STRUCTURE ABOVE

- GENERAL NOTES:**
1. CEILING SPACES BELOW LEVEL 2 TO RECEIVE SPRAY FIRE PROOFING, WHETHER EXPOSED OR ABOVE FINISHED CEILINGS. (REFER TO SPECIFICATION).
 2. CEILING GRIDS/TILES TO BE CENTERED IN ALL ROOMS UNLESS NOTED OTHERWISE. PARTIAL TILES AT ROOM PERIMETERS SHALL NOT BE LESS THAN 100mm IN EITHER DIMENSION.
 3. ALL SINGLE CEILING ELEMENTS (I.E. LIGHTS, DIFFUSERS, EXIT SIGNS, SMOKE DETECTORS, MISCELLANEOUS DEVICES, ETC.) TO BE PLACED IN CENTER OF CEILING OR CENTER OF GYPSUM BOARD CEILING AREA UNLESS NOTED OTHERWISE. ALIGN MULTIPLE ITEMS CENTRE OR EDGES.
 4. SEE ELECTRICAL DRAWINGS FOR THE LOCATIONS OF CEILING MOUNTED SMOKE DETECTORS, EXIT SIGNAGE, FIRE ALARM DEVICES, ETC. ALSO SEE ELECTRICAL FOR LOCATIONS FOR WALL MOUNTED EXIT LIGHTS.
 5. SEE MECHANICAL DRAWINGS FOR EXTENT OF EXPOSED DUCTWORK IN EXPOSED STRUCTURE AREAS. PAINT ALL EXPOSED DUCTWORK, PIPING, HANGERS, ETC.
 6. INSTALL ACCESS PANELS IN NON-ACCESSIBLE TYPE CEILINGS WHERE SERVICE OR ADJUSTMENT TO MECHANICAL, PLUMBING, OR ELECTRICAL ITEMS MAY BE REQUIRED. ACCESS PANELS SHALL BE EQUAL TO THE RATING OF THE WALL OR CEILING IN WHICH THEY OCCUR.
 7. 450mm MINIMUM VERTICAL CLEARANCE SHALL BE MAINTAINED BETWEEN THE BOTTOM OF THE EXTENDED SPRINKLER HEADS AND THE TOP OF ANY FILES, SHELVING, LOCKERS, ETC.
 8. SEE ROOM FINISH SCHEDULE FOR CEILING HEIGHTS IN EACH ROOM/AREA. FOR ROOM/AREAS DENOTED AS 'EX', NEW CEILING TO BE INSTALLED AT SAME HEIGHT AS EXISTING.

- FIRE-SEPARATION LEGEND:**
- 2-HR FIRE-SEPARATION (WALLS AND FLOOR)
- FIRE-SEPARATION NOTES:**
1. IN EXISTING FIRE-SEPARATION WALLS, FIRE SEPARATION CONTRACTOR TO PROVIDE 2-HR FIRE STOPPING TO ALL UNPROTECTED OPENINGS AND PENETRATIONS.
 2. APPLY SPRAY-APPLIED FIRE PROOFING TO UNDERSIDE OF ENTIRE SECOND FLOOR STRUCTURE BETWEEN GRIDS '2' AND '3' TO ACHIEVE 2 HOUR FIRE RESISTANCE RATING.

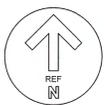

REFLECTED CEILING PLAN LEVEL 2
SCALE: 1:50
1
A16



CO2	ISSUED FOR TENDER	02/14 2019
CO1	ISSUED FOR TENDER	09/28 2018
revisions		date
project		projet

MAINTENANCE GARAGE REHABILITATION ST. ANTHONY AIRPORT

REFLECTED CEILING PLAN AND FIRE-SEPARATION PLAN LEVEL 2

designed	N.S.	conçu
date	2016.11.22	
drawn	A.M.	dessiné
date	2016.11.22	
approved	K.S.	approuvé
date	2016.11.22	

Tender	<i>[Signature]</i>	Submission
PWGSC Project Manager	Administrateur de projets TPSCG	
project number		no. du projet
	R.077269.001	
drawing no.		no. du dessin
	A16	