



PP-11944  
29/10/2019

**NORR**

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NORR ARCHITECTS ENGINEERS PLANNERS  
A Partnership of Limited Companies

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Revision	Description	Date
4	ISSUED FOR CONSTRUCTION	2019/10/29
3	ISSUED FOR 90% REVIEW	2019/08/29
2	ISSUED FOR 60% REVIEW	2019/05/09
1	ISSUED FOR 30% REVIEW	2019/03/14

PSPC

10025 JASPER AVE  
EDMONTON, ALBERTA, T5J 1S6  
PH. 780-919-9445

Project Title: JASPER STAFF HOUSING CONSTRUCTION

5 PLEX

902 PATRICIA STREET,  
JASPER, AB, T0E 1E0

Designed by: H.Sun / Conçu par: H.Sun

Drawn by: D.Kuang / Dessiné par: D.Kuang


Approved by: A.Elshafey / Approuvé par: A.Elshafey

Project Manager: ROB HAFER / Administrateur de Projets: ROB HAFER

Drawing Title: 2ND FLOOR & ROOF FRAMING PLAN / Titre du dessin: 2ND FLOOR & ROOF FRAMING PLAN

2ND FLOOR & ROOF FRAMING PLAN

Project no./No. du projet	Drawing no./No. du dessin	Revision no.
R.100429.001	S3.2	4

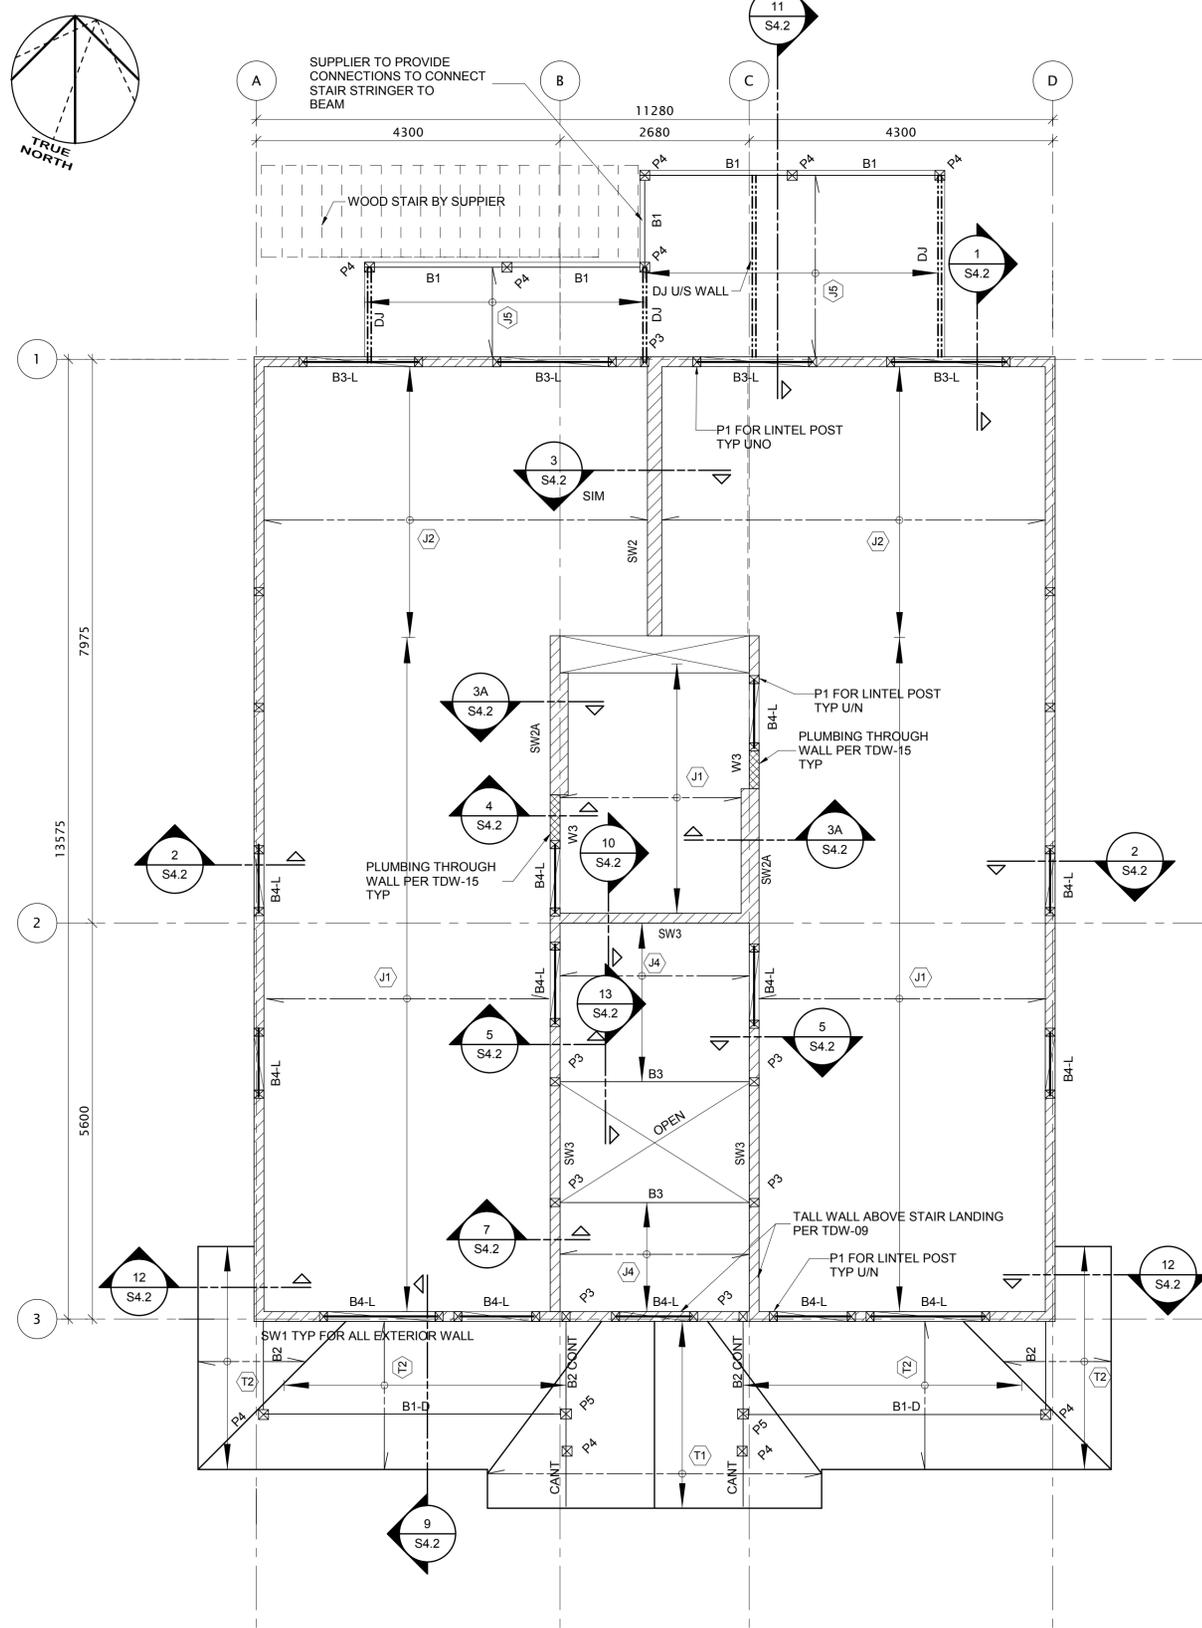


**1**  
S3.2  
2ND FLOOR FRAMING PLAN  
SCALE: 1:50

**FLOOR DESIGN LOADS:**  
DEAD LOAD = 0.72 kPa (SELF-WEIGHT)  
= 0.72 kPa (DECK & BALCONY)  
SUPERIMPOSED PARTITION LOAD = 0.5 kPa  
SUPERIMPOSED COUNTERTOP LOAD = 1.0 kPa  
(SEE ARCH FOR LOCATION)  
SUPERIMPOSED BATHTUB LOAD = 0.5 kPa  
(SEE ARCH FOR LOCATION)  
LIVE LOAD = 1.9 kPa (INSIDE UNITS)  
= 4.8 kPa (COMMON AREAS)  
= 2.4 kPa (DECK & BALCONY)

**CANOPY DESIGN LOADS:**  
DEAD LOAD = 0.72 kPa  
SNOW LOAD = 2.5 kPa

**NOTE:**  
JOIST SUPPLIER TO REVIEW MECHANICAL DWGS  
AND COORDINATE ALL PENETRATION AS NECESSARY

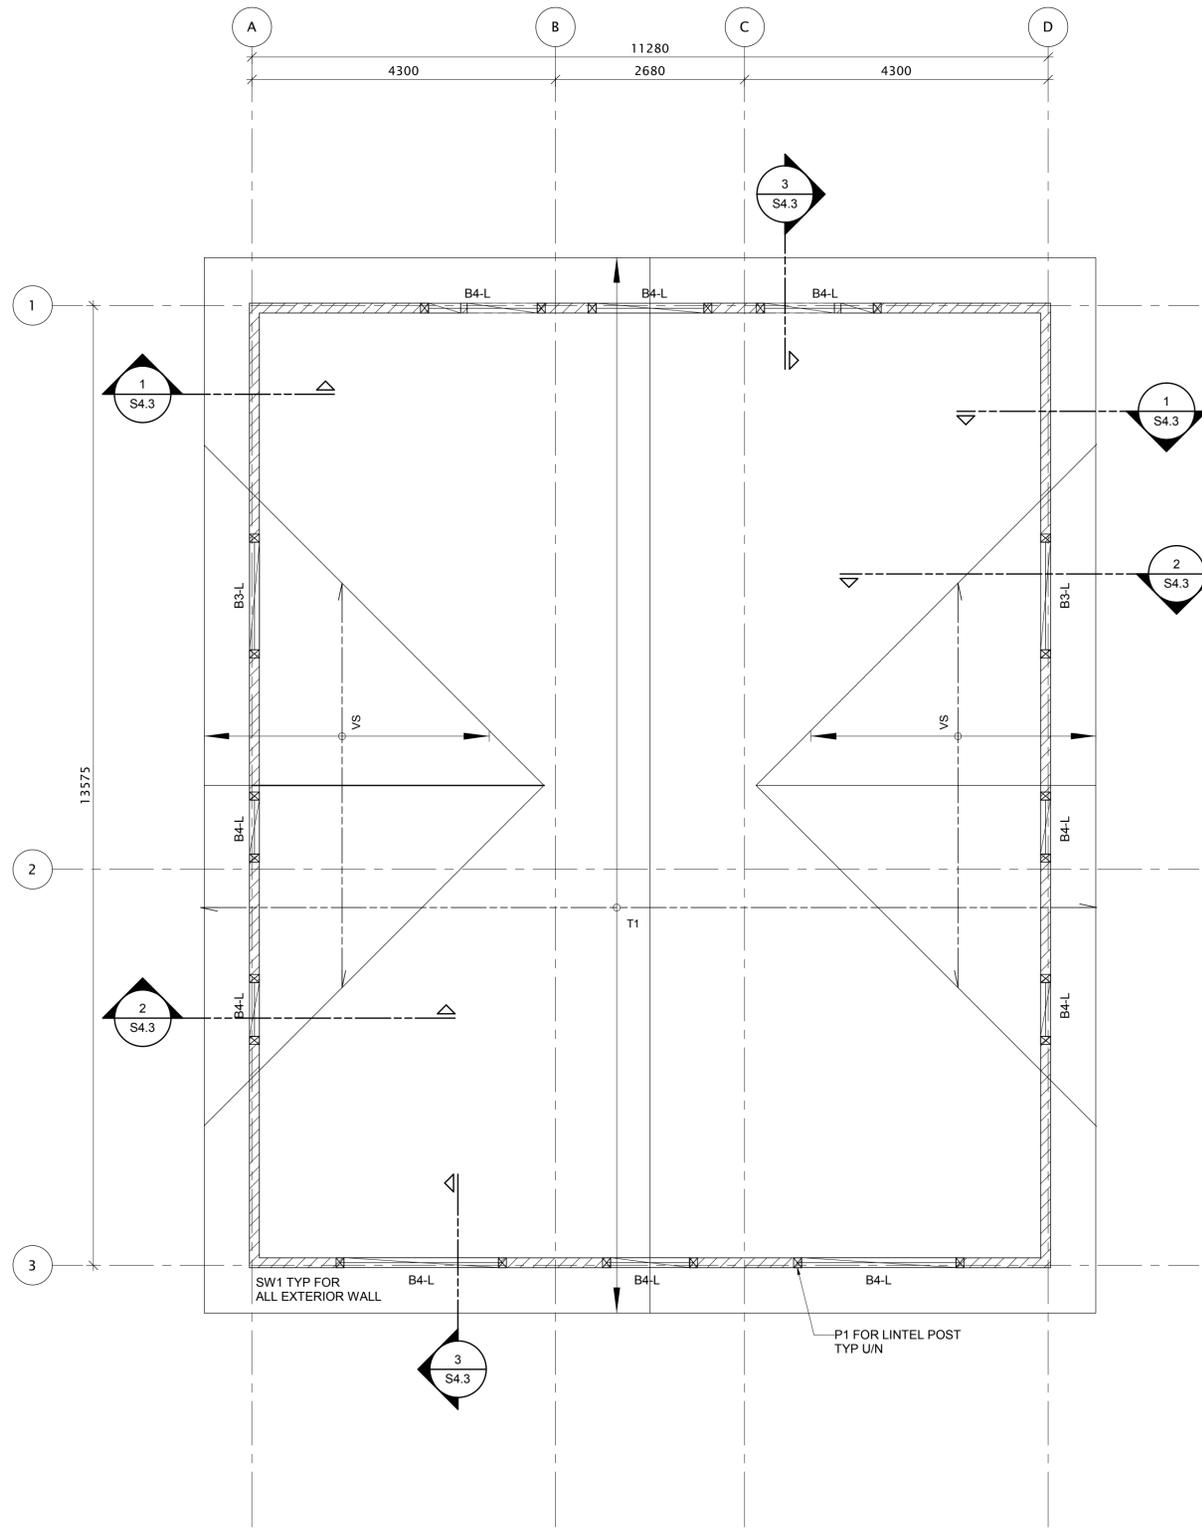

**2**  
S3.2  
ROOF FRAMING PLAN  
SCALE: 1:50

