



DEMOLITION ROOF PLAN
SCALE : 1:50
0m 1m 2m 3m 4m 5m

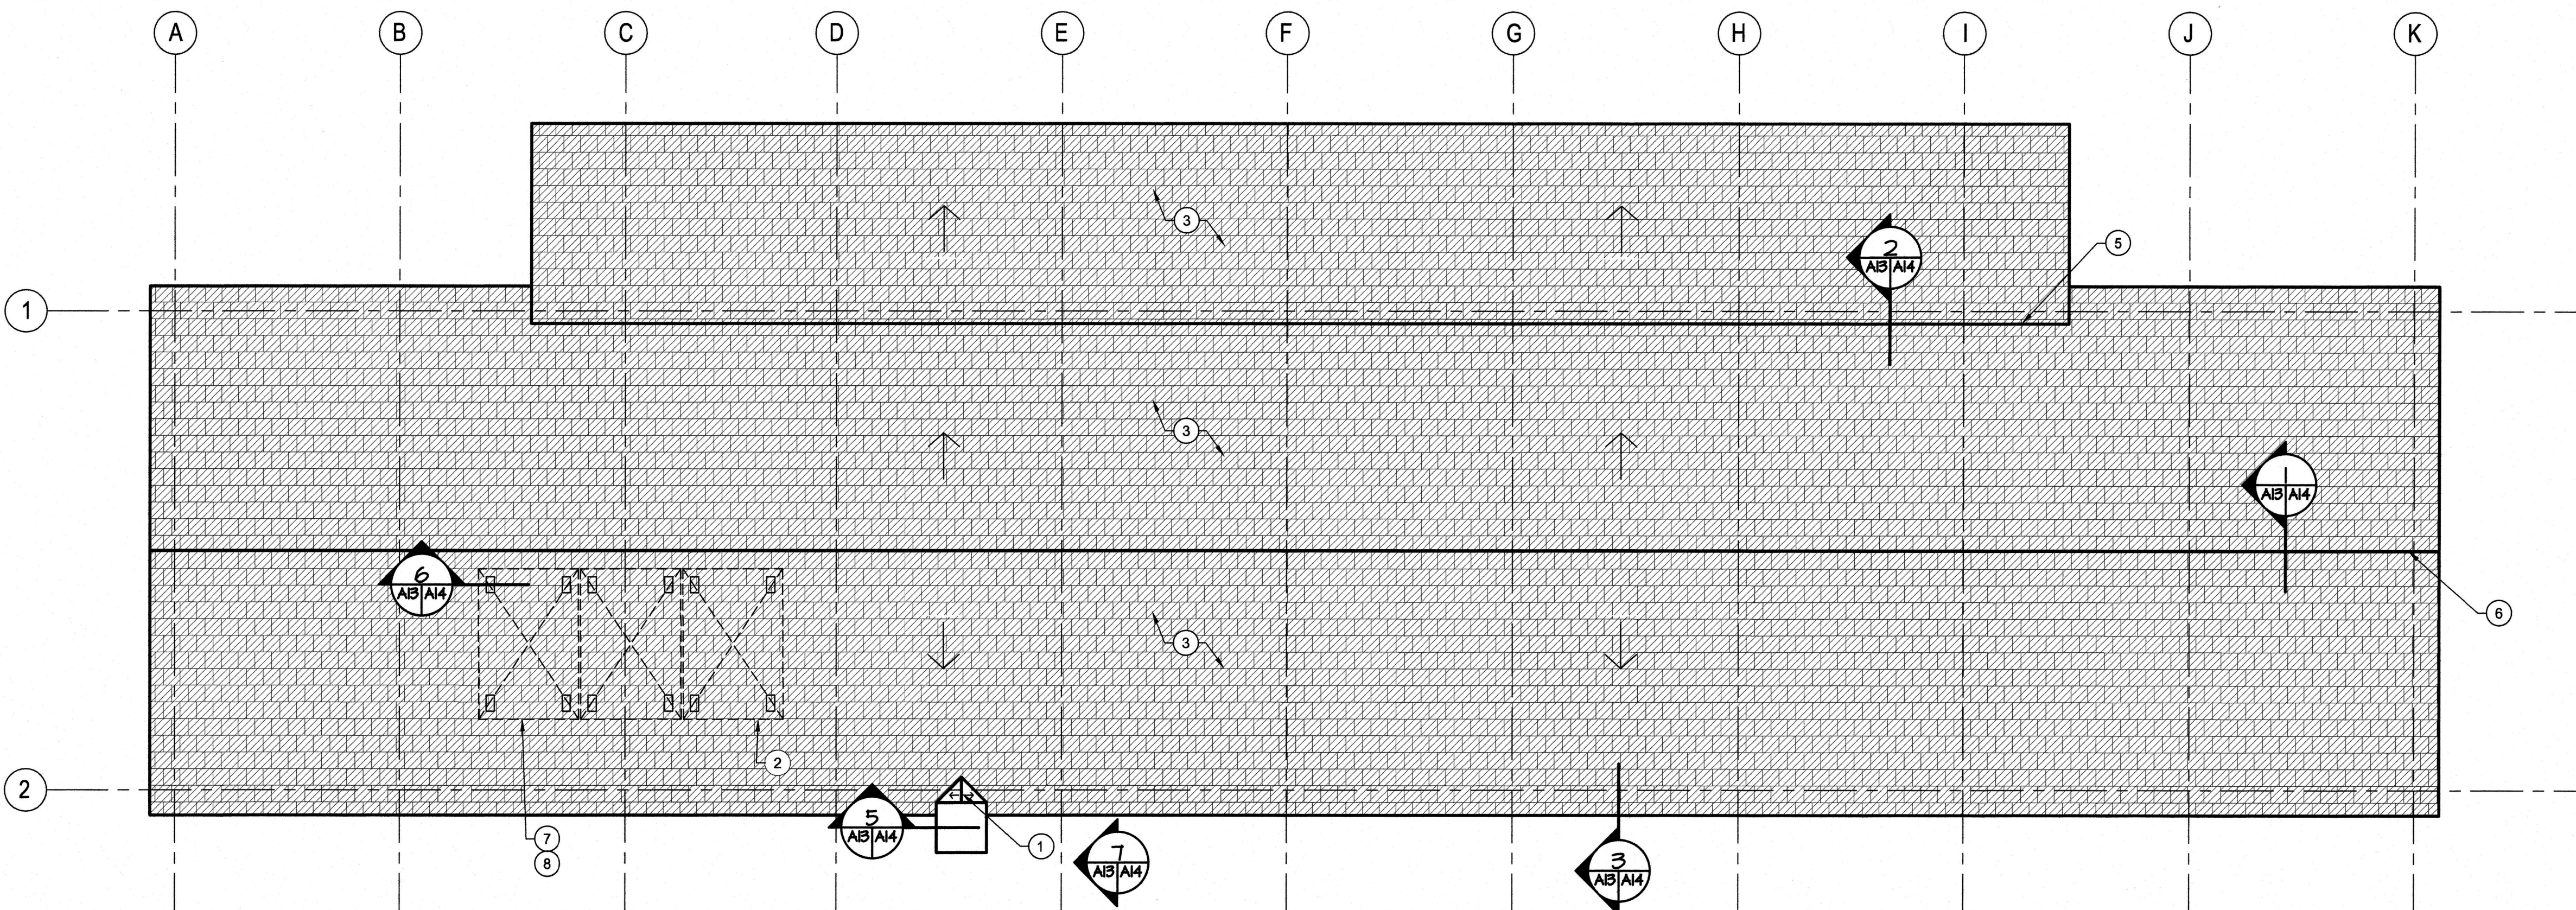

NEW ROOF PLAN
SCALE : 1:50
0m 1m 2m 3m 4m 5m

DEMOLITION NOTES:

- 1 REMOVE EXISTING CEDAR SHINGLE ROOF, FLASHING, AND UNDERLAYMENTS.
- 2 PATCH ROOF SUBSTRATE AS REQUIRED WHERE VENT PIPE OPENINGS THROUGH ROOF BECOME REDUNDANT. MAKE WEATHER TIGHT PRIOR TO INSTALLATION OF NEW ROOF FINISH. REFER TO MECHANICAL DRAWING FOR MORE INFORMATION.
- 3 CAREFULLY REMOVE EXISTING SOLAR PANELS COMPLETE WITH MOUNTING STRUTS AND SUPPORTS STORE IN A SAFE, DRY LOCATION FOR THE DURATION OF CONSTRUCTION FOR RE-INSTALLMENT CAP SERVICES AS REQUIRED.
- 4 REPLACE ROTTING AND OR DAMP ROOF SHEATHING WHERE REQUIRED PRIOR TO INSTALLATION OF NEW ROOF FINISH.
- 5 REMOVE ELECTRICAL ROUGH-IN FLASHING AND PREP FOR NEW WORK AS REQUIRED.
- 6 REMOVE EXISTING CHIMNEY FLASHING AS REQUIRED AND PREP MASONRY AND ADJACENT ROOF DECK FOR NEW WORK AS REQUIRED.
- 7 REMOVE EXISTING FASICA BOARDS. PREP ROOF EDGE TO RECEIVE NEW AS REQUIRED.
- 8 CAREFULLY REMOVE EXISTING VENT STACK COLLAR AND RETAIN FOR RE-USE. STORE IN A SAFE, DRY LOCATION UNTIL READY FOR RE-INSTALLMENT.

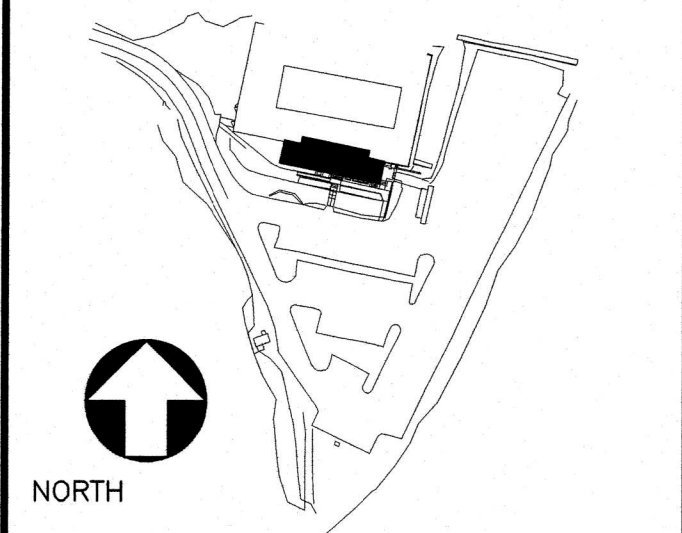

LEGEND

- VS VENT STACK
- EXTENT OF NEW SELF ADHESIVE ROOFING MEMBRANE

CONSTRUCTION NOTES:

- 1 PROVIDE NEW CRICKET AT REAR OF CEDAR ROOF 4:12 SLOPE MINIMUM. WITH SELF ADHESIVE MEMBRANE. CAP WITH LEAD CAP FLASHING.
- 2 CAREFULLY RE-INSTALL SOLAR PANEL MOUNTING STRUTS TO ROOF DECK AND FLASH INTO NEW SELF ADHESIVE ROOFING MEMBRANE. REFER TO DETAILS ON A-14.
- 3 INSTALL NEW CEDAR SHINGLES, FLASHING, AND UNDERLAYMENTS. SHINGLES TO BE PRE-FINISHED PRIOR TO INSTALLATION WITH TINTED STAIN. COORDINATE COLOUR WITH DEPARTMENTAL REPRESENTATIVE. SHINGLE PATTERN TO BE DOUBLE COURSE EVERY THIRD ROW. REFER TO DETAILS FOR ADDITIONAL INFORMATION. COORDINATE NEW VENT STACK LOCATIONS WITH MECHANICAL.
- 4 PROVIDE NEW LEAD FLASHING AT CHIMNEY; REFER TO DETAILS FOR ADDITIONAL INFORMATION.
- 5 PROVIDE NEW METAL VALLEY FLASHING WHERE ROOFS INTERSECT. REFER TO DETAILS FOR ADDITIONAL INFORMATION. COLOUR TO BE COORDINATED WITH DEPARTMENTAL REPRESENTATIVE.
- 6 PROVIDE NEW CONTINUOUS PREFORMED METAL RIDGE CAP AT RIDGE. REFER TO DETAILS FOR ADDITIONAL INFORMATION. COORDINATE COLOUR WITH DEPARTMENTAL REPRESENTATIVE.
- 7 RE-INSTALL SALVAGED SOLAR PANEL MOUNTING STRUTS AND FLASH INTO NEW SELF ADHESIVE MEMBRANES PRIOR TO RE-INSTALLATION OF PANELS. REFER TO DETAILS FOR MORE INFORMATION.
- 8 RE-INSTALL SALVAGED SOLAR PANELS RECONNECT TO EXISTING SERVICE ROUGH-IN AS REQUIRED.



0	ISSUED FOR TENDER	NOV 08 2019
revisions		date
project	REHABILITATION BATH HOUSE FUNDY NATIONAL PARK ALMA, NB ALBERT COUNTY	projet

ROOF PLAN

designed MJW	conçu
drawn BAB	dessiné
date 1/21/2018	date
approved	approuvé
date	date
Tender	Soumission
PWGC Project Manager	Administrateur de projets TPSC
project number	no. du projet
R.087633.001	
drawing no.	no. du dessin
A-13	