

LEGEND:

- EXISTING WALLS TO REMAIN
- EXISTING TO BE DEMOLISHED / REMOVED
- MORTAR BED TO BE REMOVED
- CONCRETE FLOOR TO BE FILLED
- FLOOR DRAIN
- LINEAR DRAIN
- 45 MIN. FIRE RESISTANCE RATING
- PERIMETER OF DEMOLITION
- PARTITION TYPE, SEE PARTITIONS SCHEDULE A.4.4

NOTE:
INTERIOR DIMENSIONS FROM TO EXISTING
BEING FROM TO FACE OF NEW FINISHED
SURFACES.



revision	description	date
1	ADDENDUM 03	JAN 09
0	ISSUED FOR TENDER	2020
		2019

**REHABILITATION
BATH HOUSE
FUNDY NATIONAL PARK
ALMA, NB
ALBERT COUNTY**

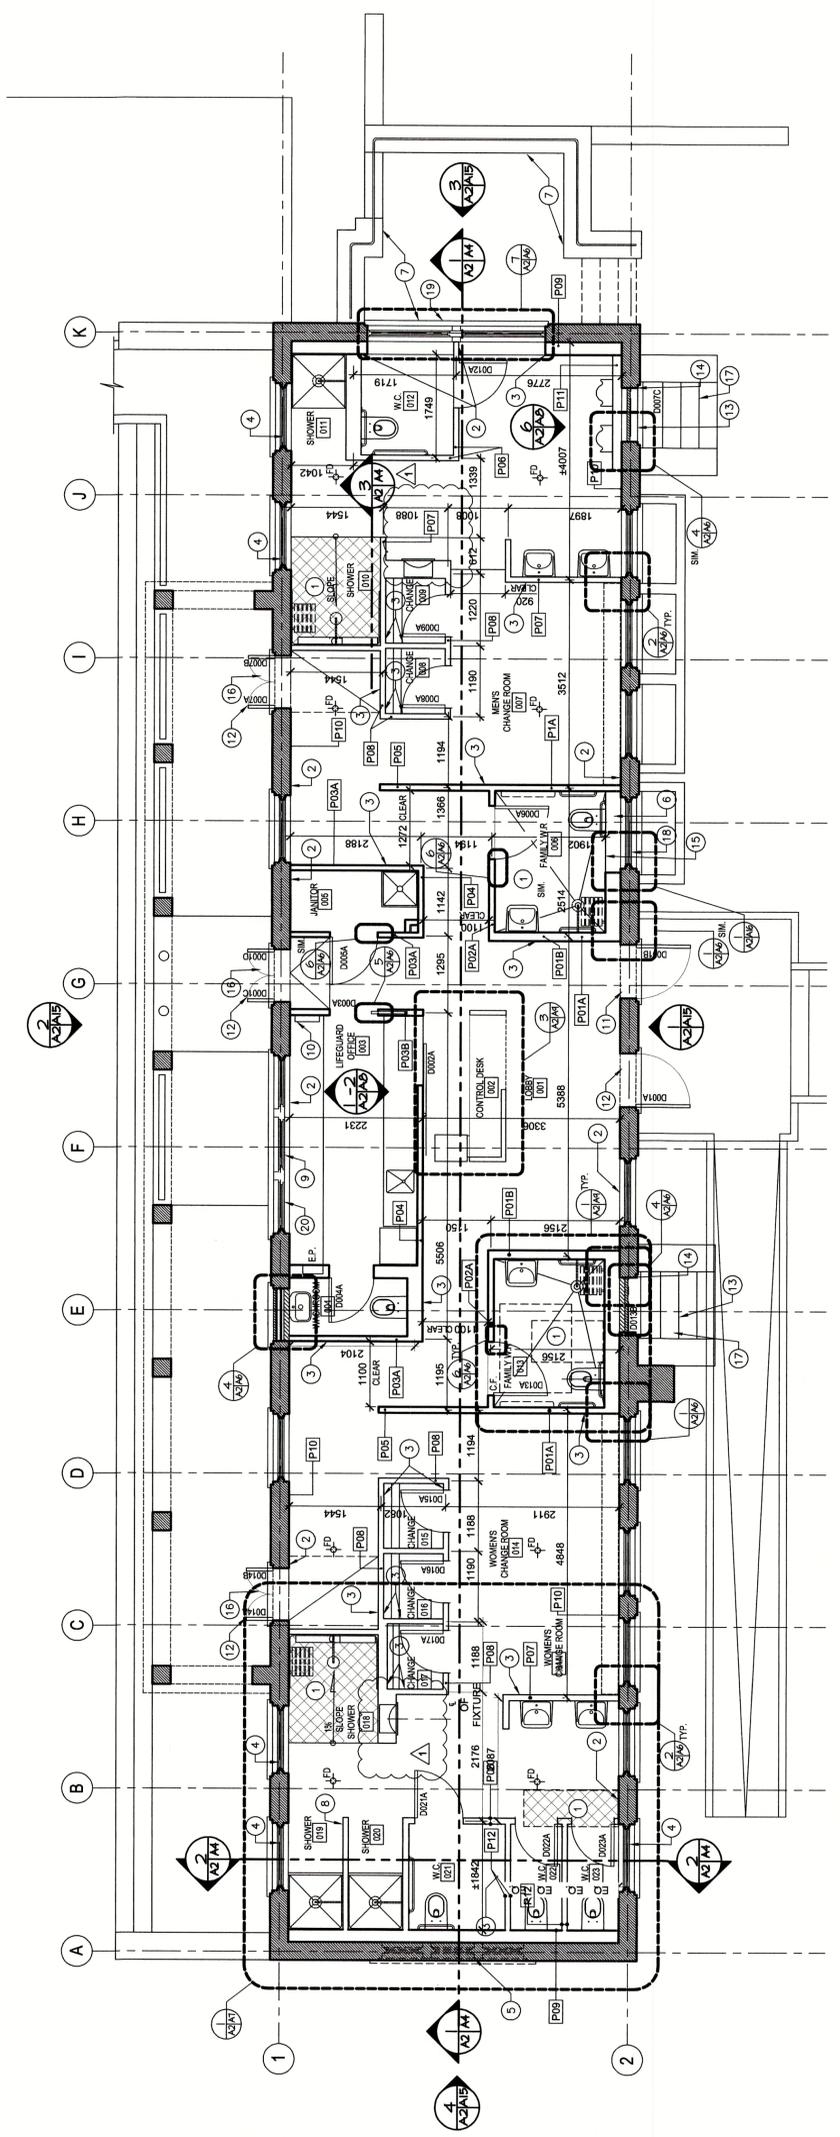
**MAIN LEVEL
NEW CONSTRUCTION
PLAN**

designer: M/J/J

drawn: BAB
date: 1/21/2019
approved: [Signature]
date: [Signature]
Tender: [Signature]

Project Manager: [Signature]
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drawing no.: A-2
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A2/1 MAIN LEVEL NEW CONSTRUCTION PLAN
SCALE: 1:50
0m 1m 2m 3m 4m 5m

CONSTRUCTION NOTES:

- 1) INFILL EXISTING NEW FLOOR RECESS WITH MORTAR GROUT. PRODUCT TO BE COMPATIBLE WITH EXISTING MORTAR BED AND SLOPE TO NEW DRAIN AS INDICATED. U.N.O.
- 2) PATCH, REPAIR AND MAKE GOOD ALL EXISTING HISTORIC WALLS AND CEILINGS, WHERE REPAIRS ARE REQUIRED TO MATCH EXISTING MATERIALS TO BE REPAIRED. REPAIRS AND TRANS TO MATCH EXISTING. DAMAGE TO HISTORIC WALL AS A RESULT OF FASTENERS, AND PREFABRICATED TOILET CHANGING ROOM PARTITIONS TO BE PATCHED AND FILLED AS REQUIRED TO ACCEPT NEW PAINT FINISH.
- 3) ALIGN WOOD GRAIN ACROSS CONSECUTIVE PANELS. GRAIN DIRECTION TO BE COORDINATED WITH DEPARTMENTAL REPRESENTATIVES PRIOR TO INSTALLATION.
- 4) PROVIDE COMMERCIAL GRADE TRANSLUCENT WINDOW FILM ON INTERIOR OF WINDOW. PROVIDE INFORMATION, SUBMITTALS AND DRAWINGS TO DEPARTMENTAL REPRESENTATIVES IN ACCORDANCE WITH SPECIFICATIONS.
- 5) PATCH, REPAIR AND MAKE GOOD EXTERIOR HERITAGE MASONRY WALLS WHERE EXISTING ELECTRICAL ENTRANCE IS MOVED (SEE ELECTRICAL DRAWINGS). REPAIRS TO BE SUBJECT TO CONSERVATION METHODS PER "STANDARDS AND UNDERLINES FOR THE CONSERVATION OF HISTORICAL PLACES IN CANADA" (4.5.3. MASONRY).
- 6) NEW FULL HEIGHT PARTITION / PLUMBING CHASE TO CUT AWAY EXISTING WINDOW OPENING. REFER TO ELEVATION FOR ADDITIONAL INFORMATION ASAP.
- 7) PROVIDE PROTECTION TO EXISTING, HERITAGE AND MASONRY PORCH AND STONE EXTERIOR WALLS AND SILLS.
- 8) WING WALL BETWEEN SHOWERS TO BE WRAPPED WITH 12mm MARINE GRADE DOUGLAS FIR PLYWOOD WITH SEMI TRANSPARENT STAIN.
- 9) PROVIDE NEW SOLID WOOD SILL AT WINDOW PROFILE AND THICKNESS TO MATCH EXISTING REMOVED. PROVIDE NEW PAINT FINISH.
- 10) RE-INSTALL SALVAGED AED UNIT AND SUNSCREEN DISPENSER ON WALL ABOVE DESK. COORDINATE MOUNTING HEIGHT WITH DEPARTMENTAL REPRESENTATIVE.
- 11) REVERSE EXISTING DOOR SWING AND RE-INSTALL IN DOOR FRAME. PATCH AND REPAIR EXISTING DOOR FRAME, DOOR STOP AND DOOR PANEL WHERE HINGES AND DEAD BOLT REMOVED AS REQUIRED. PREP DOOR FRAME FOR NEW HINGE AND HARDWARE LOCATIONS. REFER TO DOOR SCHEDULE DOOR ELEVATIONS FOR EXTENT OF CONSERVATION WORK.
- 12) RE-INSTALL SALVAGED AND CONSERVED DOORS. REFER TO DOOR SCHEDULE DOOR ELEVATIONS FOR EXTENT OF CONSERVATION WORK.
- 13) REPLACE WINDOW PANEES IN EXISTING DOOR. TRIM NEW TRANSLUCENT GLAZING. REFER TO DOOR ELEVATIONS FOR MORE INFORMATION.
- 14) SCARF EXISTING DOOR FRAME AND TRIMS TO REMOVE ROTTED AREAS AT SANDSTONE SILL AND SCAB IN NEW PATCH MATERIAL. NEW PATCH MATERIAL TO BE HARDWOOD. REMOVE EXISTING DOOR FRAME AND TRIMS TO MATCH EXISTING NEW PAINT FINISH TO MATCH EXISTING. CUT TO MATCH EXISTING DOOR STOP TRIMS WITH THE PATCH AND REPAIR EXISTING DOOR FRAME AND SALVAGED DOOR STOP TRIMS WITH WOOD REPAIR SYSTEM AS REQUIRED BY DAMAGE AND REDUNDANT SCREW AND NAIL HOLES. RE-INSTALL SALVAGED AND CONSERVED DOOR STOP MATERIAL TO SUIT REVERSED DOOR OPERATION.
- 15) PROVIDE NEW SOLID WOOD JAMBES, HEAD AND SILL TRIMS AT GLASS BLOCK WINDOW WITH GYPSUM BOARD SOLID SURFACE FINISH. PROVIDE VINYL SHADOW REVEAL MOLDING AT ALL FOUR SIDES. PAINT COLOURS TO BE COORDINATED WITH DEPARTMENTAL REPRESENTATIVE.
- 16) INFILL EXISTING NEW FLOOR RECESS WITH MORTAR GROUT. PRODUCT TO BE COMPATIBLE WITH NEW EPOXY FLOOR SYSTEM. MAKE FLUSH WITH EXISTING ADJACENT MORTAR BED AND SLOPE TO MEETING EXISTING HERITAGE SANDSTONE INSTALLATION. MAINTAIN 6mm CONTINUOUS GAP BETWEEN NEW MORTAR GROUT MATERIAL, AND SILL. PROVIDE BACKER ROD AND SEALANT COMPATIBLE WITH NEW EPOXY FLOOR SYSTEM.
- 17) RE-INSTALL CONSERVED DOOR PANEL IN NEW POSITION AS INDICATED BY DRAWING AND FIX IN PLACE. SEE DETAIL A4-8 FOR ADDITIONAL INFORMATION.
- 18) INSTALL NEW SINGLE GLAZED WOOD HOPPER STYLE WINDOW TO MATCH ADJACENT EXISTING WINDOW. TYPE TO SUIT EXISTING FRAMED OPENING. PATCH, REPAIR AND CONSERVE EXISTING FRAME AND TRIMS WITH WOOD REPAIR SYSTEM PRIOR TO INSTALLING NEW WINDOW. PREP CONSERVED FRAME AND TRIMS WITH WOOD OPENING PATCH. REFER TO WINDOW SCHEDULE FOR ADDITIONAL INFORMATION.
- 19) INSTALL NEW SINGLE GLAZED DOUBLE HUNG WOOD WINDOWS TO SUIT EXISTING FRAMED OPENING. PATCH, REPAIR AND CONSERVE EXISTING FRAME AND TRIMS WITH WOOD REPAIR SYSTEM PRIOR TO INSTALLING NEW WINDOWS. PREP CONSERVED FRAME AND TRIMS WITH WOOD OPENING PATCH. REFER TO WINDOW SCHEDULE FOR ADDITIONAL INFORMATION.
- 20) PROVIDE NEW SOLID WOOD SILL REPLACEMENT WHERE PARTITION REMOVED. PROFILE, SPECIES, DIMENSIONS AND GENERAL APPEARANCE TO MATCH EXISTING SILL. PREP FOR NEW PAINT FINISH.
- 21) INSTALL WATER BOTTLE FILLING STATION. SEE MECHANICAL DRAWINGS FOR ADDITIONAL INFORMATION.