



SANITARY KEY NOTES

- ① RETAIN EXISTING SECTIONS OF 100Ø PVC SANITARY PIPE FOR RE-USE, INCLUDING (2) PVC CONNECTIONS NEAR SANITARY EXIT THROUGH CONCRETE WALL. CONNECT NEW SANITARY PIPING TO EXISTING PVC CONNECTIONS.
- ② ROUTE NEW SANITARY THROUGH VAULT WALL AND SEAL WITH FIRE STOP CAULKING.
- ③ ROUTE SANITARY PIPING IN FLOOR JOIST SPACE WHERE PRACTICAL. TYPICAL FOR ALL SANITARY PIPING IN BASEMENT.
- ④ INSTALL CO-2 CLEANOUT BELOW URINALS.

SANITARY GENERAL NOTES

1. PLUMBING CONTRACTOR TO THOROUGHLY REVIEW EXISTING CONDITIONS ON SITE PRIOR TO SUBMITTING BID. EXISTING POOL EQUIPMENT IN BASEMENT IS TO REMAIN AS IS, THEREFORE, NEW WORK WILL BE IMPLEMENTED AROUND EXISTING POOL PIPING AND EQUIPMENT.
2. PIPE SIZE SERVING FIXTURE TO BE PER MANUFACTURER RECOMMENDATION.
3. ALL SANITARY PIPING TO BE SLOPED PER THE LATEST EDITION OF THE NATIONAL PLUMBING CODE OF CANADA.
4. SANITARY VENTING TO BE CONDUCTED PER THE LATEST EDITION OF THE NATIONAL PLUMBING CODE OF CANADA. ALL VENT PIPING TO BE CONCEALED IN WALLS AND PARTITIONS TO ELIMINATE VISIBILITY WITHIN OCCUPIED SPACES.
5. ALL FLOOR PENETRATIONS TO BE FIRESTOPPED AS REQUIRED BY RATED FLOOR ASSEMBLY. REFER TO ARCHITECTURAL.
6. KITCHEN SINK AND PEDESTAL SINKS ARE TO INCLUDE CLEANOUT WITHIN TRAP ASSEMBLY. URINALS ARE TO INCLUDE CLEANOUT IN WALL BELOW URINAL. ALL REMAINING CLEANOUTS ARE TO BE END OF PIPE TYPE IN BASEMENT. IF SITE CONDITIONS REQUIRE THE USE OF FLOOR OR WALL CLEANOUT(S), COORDINATE WITH CONSULTANT PRIOR TO ROUGH-IN.
7. LOCATIONS OF NEW ROOF VENTS TO BE COORDINATED WITH CONSULTANT, PRIOR TO INSTALLATION.

SANITARY DEMOLITION NOTES

1. ALL EXISTING MAIN FLOOR PLUMBING FIXTURES AND FLOOR DRAINS ARE TO BE REMOVED, INCLUDING ASSOCIATED SANITARY PIPING, VENT PIPING, HANGERS ETC. ON BOTH LEVELS, EXCEPT WHERE NOTED OTHERWISE ON THE DRAWINGS.
2. ALL OPENINGS IN FLOOR RESULTING FROM REMOVED PIPING ARE TO BE REPAIRED AND SEALED TO MEET STANDARD OF NEW RATED FLOOR ASSEMBLY.
3. WHERE EXISTING VENT PIPE OPENINGS THROUGH ROOF BECOME REDUNDANT, REMOVE PIPING, AND PATCH ROOF WEATHER TIGHT. ROOF PATCHING FINISH TO MATCH EXISTING (BY GENERAL CONTRACTOR).

LEGEND

- FD-1 FLOOR DRAIN
- LD-1 LINEAR DRAIN
- SH-1 SHOWER - REGULAR
- SH-2 SHOWER - BARRIER FREE
- L-1 LAVATORY SINK - BARRIER FREE
- L-2 LAVATORY SINK - STANDARD
- JS-1 JANITOR SINK - FLOOR TYPE
- KS-1 KITCHEN SINK
- TP-1 TRAP PRIMER STATION
- HS-1 HYDRATION STATION
- WC-1 WATER CLOSET
- U-1 URINAL - STANDARD
- U-2 URINAL - BARRIER FREE
- CO-1 END OF PIPE CLEANOUT
- CO-2 CLEANOUT IN WALL
- DCW DOMESTIC COLD WATER
- DHW DOMESTIC HOT WATER
- DHWR DOMESTIC HOT WATER RE-CIRC.
- WHA WATER HAMMER ARRESTOR
- ⊘ ISOLATION VALVE
- ⊘ DHWR BALANCING VALVE
- L-1 CHECK VALVE




1	BOTTLE FILLING STATIONS	JAN.8 2020
0	ISSUED FOR TENDER	NOV.08 2019
revisions		date

project
**REHABILITATION
 POOL BATH HOUSE
 FUNDY NATIONAL PARK
 ALMA, NB
 ALBERT COUNTY**
 drawing
 project

SANITARY

designed	AJB	conçu
date		
drawn	AJB	dessiné
date	NOV.08/2019	
approved		approuvé
date		
Tender		Soumission
PWGC Project Manager	Administrateur de projets TPSCC	
project number		no. du projet
	R.087633.001	
drawing no.		no. du dessin
	M-2	

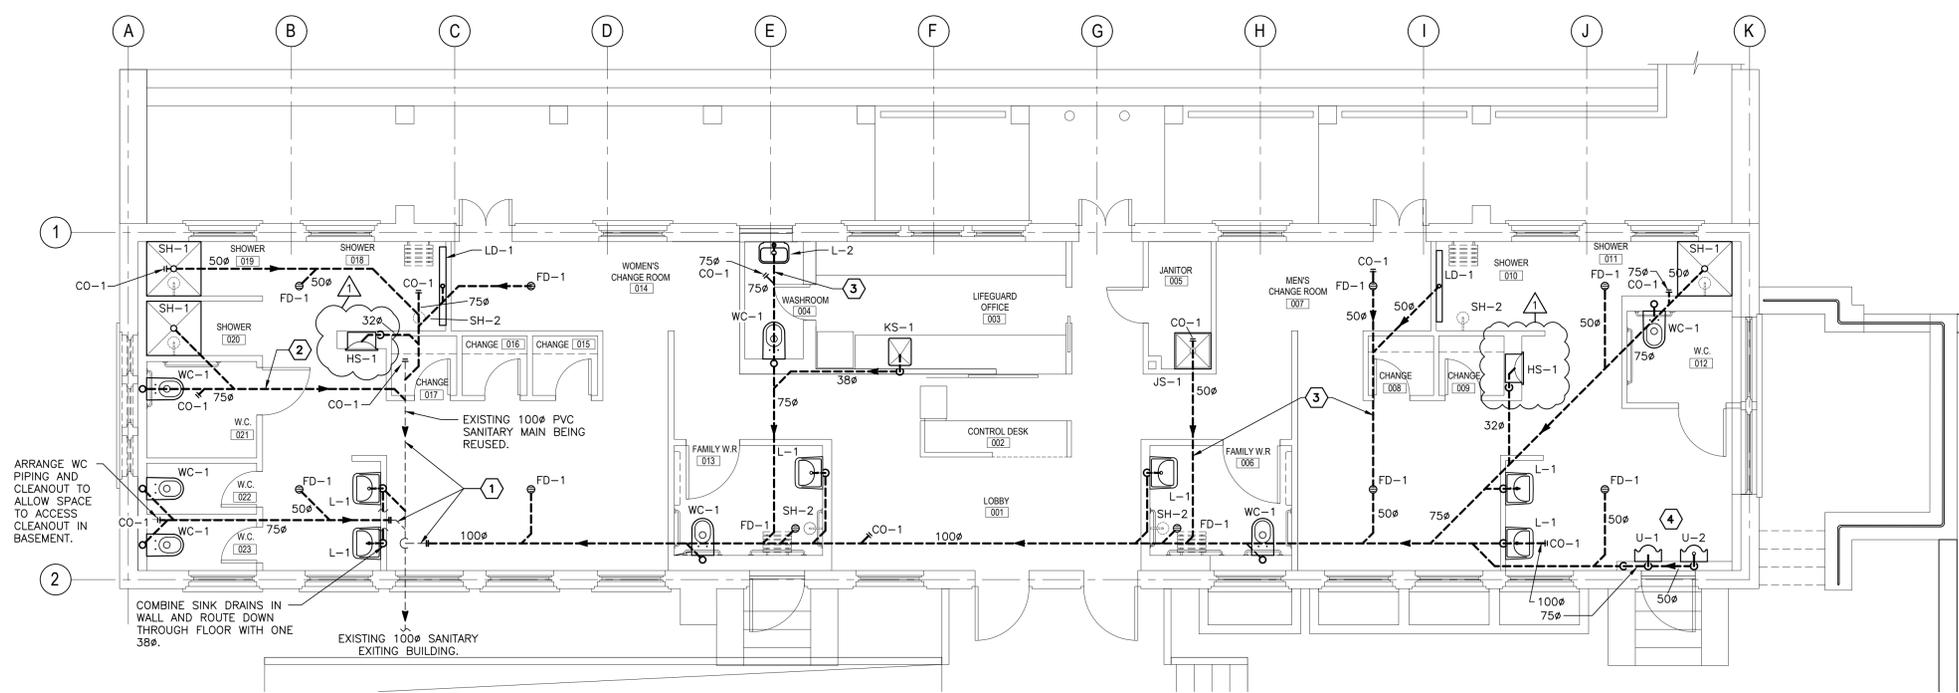

1 SANITARY - MAIN LEVEL
 SCALE : 1:50
 0m 1m 2m 3m 4m 5m