

- LEGEND:**
- EXISTING WALLS TO REMAIN
  - EXISTING TO BE DEMOLISHED / REMOVED
  - MORTAR BED TO BE REMOVED
  - CONCRETE FLOOR TO BE WILLED
  - FLOOR DRAIN
  - LINEAR DRAIN
  - 45 MIN. FIRE RESISTANCE RATING
  - PERIMETER OF DEMOLITION
  - PARTITION TYPE, SEE PARTITIONS SCHEDULE A.4.4

**NOTE:**  
INTERIOR DIMENSIONS FROM TO EXISTING  
SURFACES UNLESS NOTED OTHERWISE  
BEING FROM TO FACE OF NEW FINISHED  
SURFACES.




revision	date
1	JAN 09
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	2020
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	2022

**REHABILITATION  
BATH HOUSE  
FUNDY NATIONAL PARK  
ALMA, NB  
ALBERT COUNTY**

**MAIN LEVEL  
NEW CONSTRUCTION  
PLAN**

designed	MLW	checked	
drawn	BAB	designed	
date	1/21/2019	approved	
date		approved	
Tender		Submission	
Project Manager	Administrateur de projet TPSC	Project number	R.087633.001
drawing no.	A-2	no. du dessin	

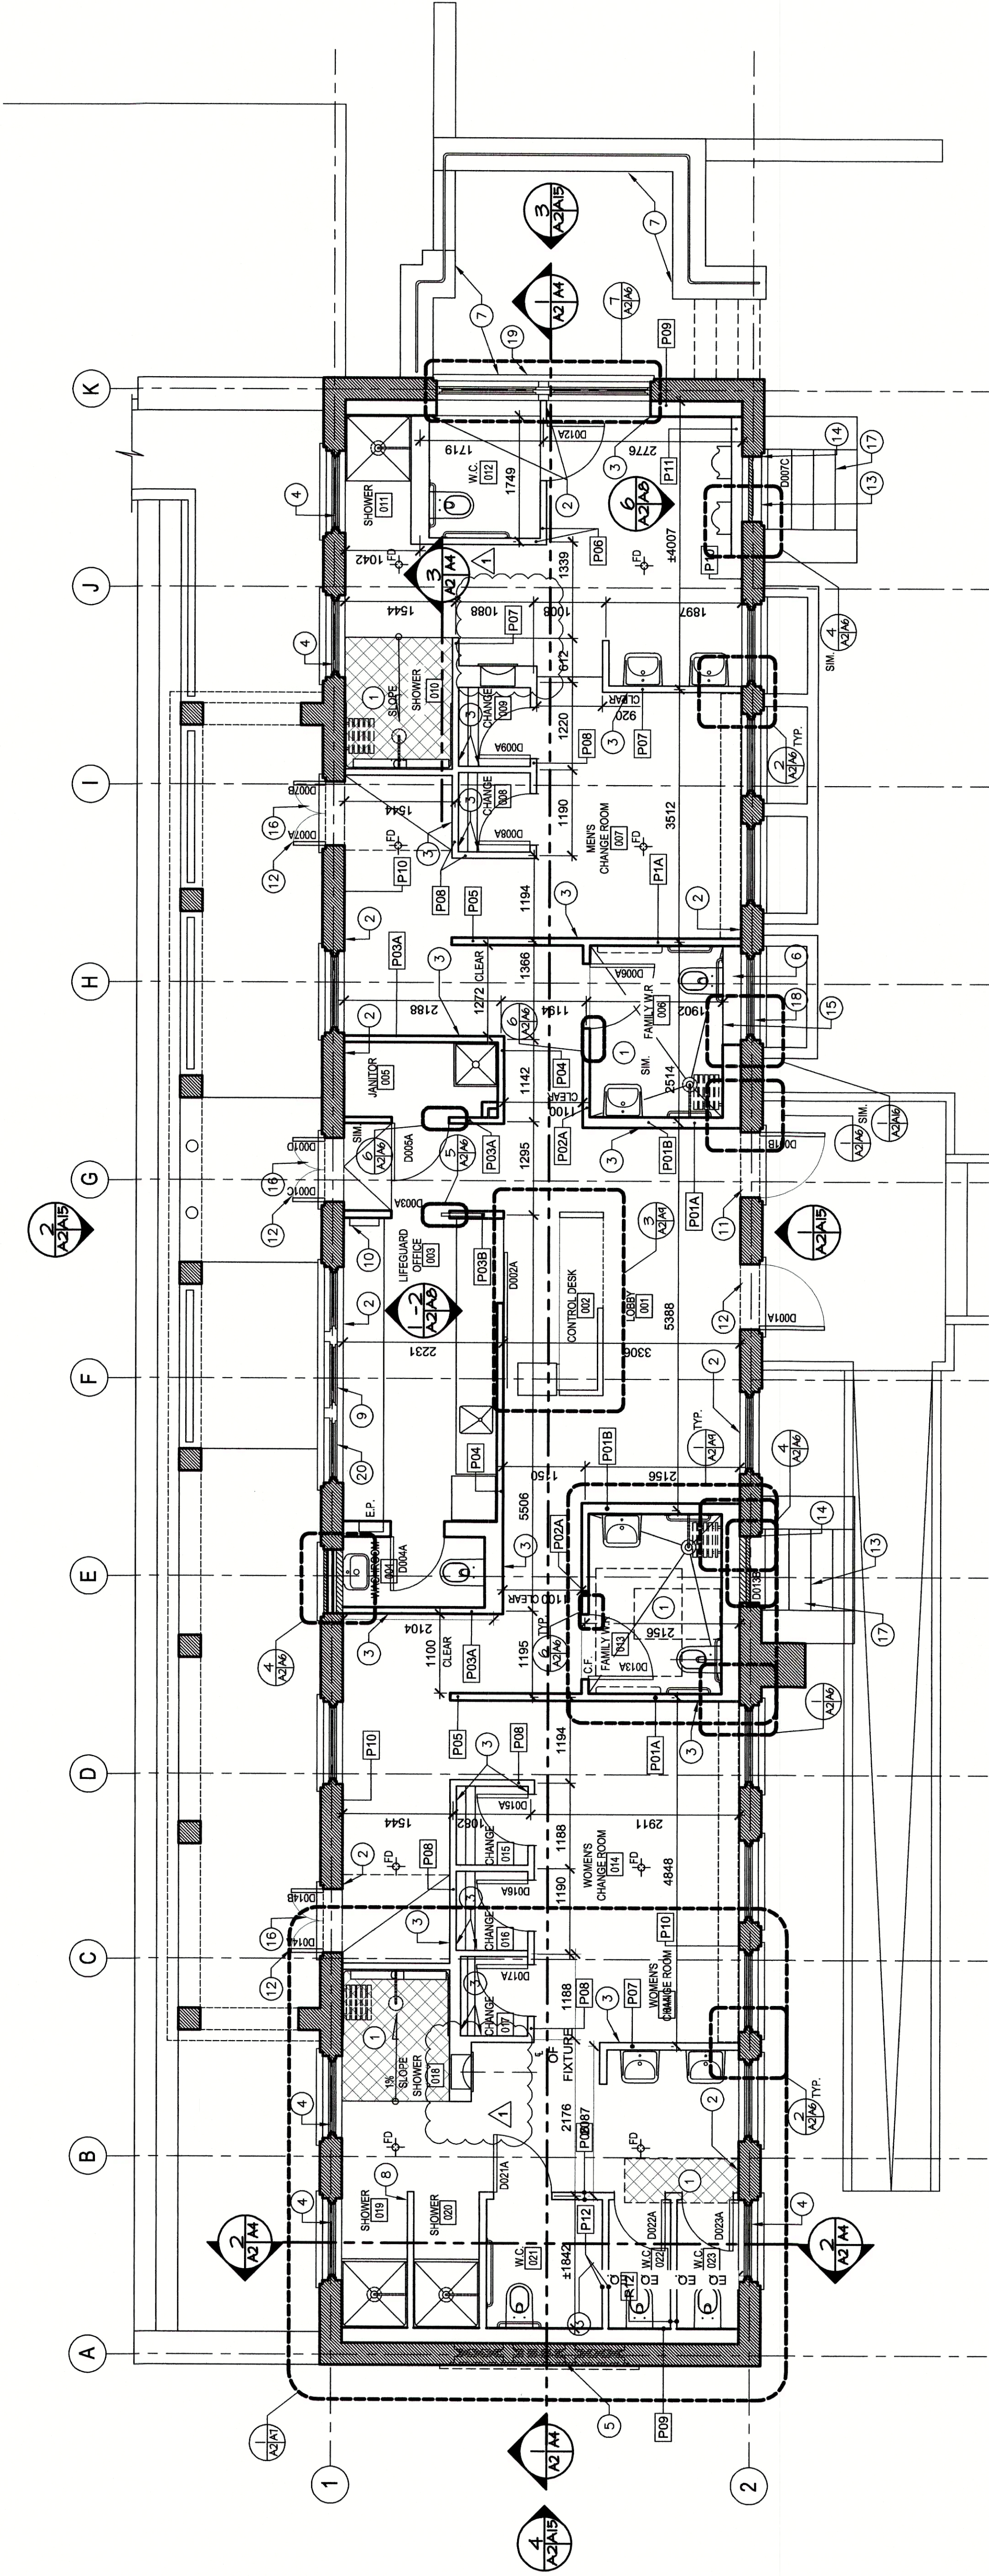

**MAIN LEVEL NEW CONSTRUCTION PLAN**

SCALE : 1:50



**CONSTRUCTION NOTES:**

1. INFILL EXISTING / NEW FLOOR RECESS WITH MORTAR GROUT. PRODUCT TO BE COMPATIBLE WITH EXISTING MORTAR. MAKE FLUSH WITH EXISTING ADJACENT MORTAR BED. PROVIDE VINYL SHADOW REVEAL MOLDING AT ALL FOUR SIDES. PAINT COLOURS TO BE COORDINATED WITH DEPARTMENTAL REPRESENTATIVE.
2. PATCH, REPAIR AND MAKE GOOD ALL EXISTING HISTORIC WALLS AND CEILINGS, WHERE REMOVED OR DAMAGED. REPAIRS TO BE MADE IN ACCORDANCE WITH DEPARTMENTAL REPRESENTATIVE. DAMAGE TO HISTORIC WALL AS A RESULT OF FASTENERS, AND PREFABRICATED TOILET / CHANGING ROOM PARTITIONS TO BE PATCHED AND FILLED AS REQUIRED TO ACCEPT NEW PAINT FINISH.
3. ALIGN WOOD GRAIN ACROSS CONSECUTIVE PANELS. GRAIN DIRECTION TO BE COORDINATED WITH DEPARTMENTAL REPRESENTATIVE PRIOR TO INSTALLATION.
4. PROVIDE COMMERCIAL GRADE TRANSLUCENT WINDOW FILM ON INTERIOR OF WINDOW. PROVIDE INFORMATION, SUBMITTALS AND DRAWINGS TO DEPARTMENTAL REPRESENTATIVE IN ACCORDANCE WITH SPECIFICATIONS.
5. PATCH, REPAIR AND MAKE GOOD EXISTING MASONRY WALLS WHERE EXISTING ELECTRICAL ENTRANCE IS MOVED (SEE ELECTRICAL SCHEDULE A.4.3). WORK SHALL BE SUBJECT TO CONSERVATION METHODS PER "STANDARDS AND UNDERLINES FOR THE CONSERVATION OF HISTORICAL PLACES IN CANADA" (4.6.3. MASONRY).
6. NEW FULL HEIGHT PARTITION / PLUMBING CHASE TO CUT AWAY EXISTING WINDOW OPENING. REFER TO ELEVATION FOR ADDITIONAL INFORMATION AS REQUIRED.
7. PROVIDE PROTECTION TO EXISTING, HERITAGE AND MASONRY PORCH AND STONE EXTERIOR WALLS AND SILLS.
8. WING WALL BETWEEN SHOWERS TO BE WRAPPED WITH 12mm MARINE GRADE DOUGLAS FIR PLYWOOD WITH SEMI TRANSPARENT STAIN.
9. PROVIDE NEW SOLID WOOD SILL AT WINDOW PROFILE AND THICKNESS TO MATCH EXISTING REMOVED. PROVIDE NEW PAINT FINISH.
10. RE-INSTALL SALVAGED AED UNIT AND SUNSCREEN DISPENSER ON WALL ABOVE DESK. COORDINATE MOUNTING HEIGHT WITH DEPARTMENTAL REPRESENTATIVE.
11. REVERSE EXISTING DOOR SWING AND REINSTATE IN DOOR FRAME. PATCH AND REPAIR EXISTING DOOR FRAME, DOOR STOP AND DOOR PANEL WHERE HINGES AND DEAD BOLT REMOVED AS REQUIRED. PREP DOOR FRAME FOR NEW HINGE AND HARDWARE LOCATIONS. REFER TO DOOR SCHEDULE DOOR ELEVATIONS FOR EXTENT OF CONSERVATION WORK.
12. RE-INSTALL SALVAGED AND CONSERVED DOORS. REFER TO DOOR SCHEDULE DOOR ELEVATIONS FOR EXTENT OF CONSERVATION WORK.
13. REPLACE WINDOW PANES IN EXISTING DOOR. TRIM NEW TRANSLUCENT GLAZING. REFER TO DOOR ELEVATIONS FOR MORE INFORMATION.
14. SCARF EXISTING DOOR FRAME AND TRIMS TO REMOVE ROTTED AREAS AT SANDSTONE SILL AND SCAB IN NEW PATCH MATERIAL. NEW PATCH MATERIAL TO BE HARDWOOD. PATCH EXISTING DOOR FRAME TO MATCH EXISTING DOOR FRAME. PROVIDE NEW PAINT FINISH TO MATCH EXISTING DOOR FRAME. PATCH AND REPAIR EXISTING DOOR FRAME AND SALVAGED DOOR STOP TRIMS WITH WOOD REPAIR SYSTEM AS REQUIRED BY DAMAGE AND REDUNDANT SCREW AND NAIL HOLES. RE-INSTALL SALVAGED AND CONSERVED DOOR STOP MATERIAL TO SUIT REVERSED DOOR OPERATION.

15. PROVIDE NEW SOLID WOOD JAMBS, HEAD AND SILL TRIMS AT GLASS BLOCK WINDOW OPENING. PROVIDE INFORMATION, SUBMITTALS AND DRAWINGS TO DEPARTMENTAL REPRESENTATIVE. WITH GYPSUM BOARD SOLID SURFACE FINISH. PROVIDE VINYL SHADOW REVEAL MOLDING AT ALL FOUR SIDES. PAINT COLOURS TO BE COORDINATED WITH DEPARTMENTAL REPRESENTATIVE.
16. INFILL EXISTING NEW FLOOR RECESS WITH MORTAR GROUT. PRODUCT TO BE COMPATIBLE WITH NEW EPOXY FLOOR SYSTEM. MAKE FLUSH WITH EXISTING ADJACENT MORTAR BED AND SLOPE TO MEETING EXISTING HERITAGE SANDSTONE INSTALLATION. MAINTAIN 6mm CONTINUOUS GAP BETWEEN NEW MORTAR GROUT MATERIAL AND SILL. PROVIDE BACKER ROD AND SEALANT COMPATIBLE WITH NEW EPOXY FLOOR SYSTEM.
17. RE-INSTALL CONSERVED DOOR PANEL IN NEW POSITION AS INDICATED BY DRAWING AND FIX IN PLACE. SEE DETAIL 4A-8 FOR ADDITIONAL INFORMATION.
18. INSTALL NEW SINGLE GLAZED WOOD HOPPER STYLE WINDOW TO MATCH ADJACENT EXISTING WINDOW. TYPE TO SUIT EXISTING FRAMED OPENING. PATCH, REPAIR AND CONSERVE EXISTING FRAME AND TRIMS WITH WOOD REPAIR SYSTEM PRIOR TO INSTALLING NEW WINDOW. PREP CONSERVED FRAME AND TRIMS WITH WOOD FINISH. SEE WINDOW SCHEDULE FOR ADDITIONAL INFORMATION.
19. INSTALL NEW SINGLE GLAZED DOUBLE HUNG WOOD WINDOWS TO SUIT EXISTING FRAMED OPENING. PATCH, REPAIR AND CONSERVE EXISTING FRAME AND TRIMS WITH WOOD REPAIR SYSTEM PRIOR TO INSTALLING NEW WINDOWS. PREP CONSERVED FRAME AND TRIMS WITH WOOD FINISH. SEE WINDOW SCHEDULE FOR ADDITIONAL INFORMATION.
20. PROVIDE NEW SOLID WOOD SILL REPLACEMENT WHERE PARTITION REMOVED. PROFILE, SPECIES, DIMENSIONS AND GENERAL APPEARANCE TO MATCH EXISTING SILL. PREP FOR NEW PAINT FINISH.
21. INSTALL WATER BOTTLE FILLING STATION. SEE MECHANICAL DRAWINGS FOR ADDITIONAL INFORMATION.