


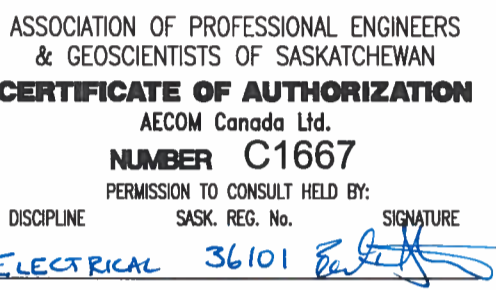

TENDER
NOT FOR CONSTRUCTION



Client _____

Project Title	
---------------	--

Designed by _____

B. Stewart

T. Shruafi

Abbreviations

Approved by _____

PWGSC Project Manager



Drawing Title

Package 1 - NTBU43 - Tunnel


Electrical

New Tunnel Electrical Plans

Project no.	Drawing no.	Revision no.
1004259	E1.21	E

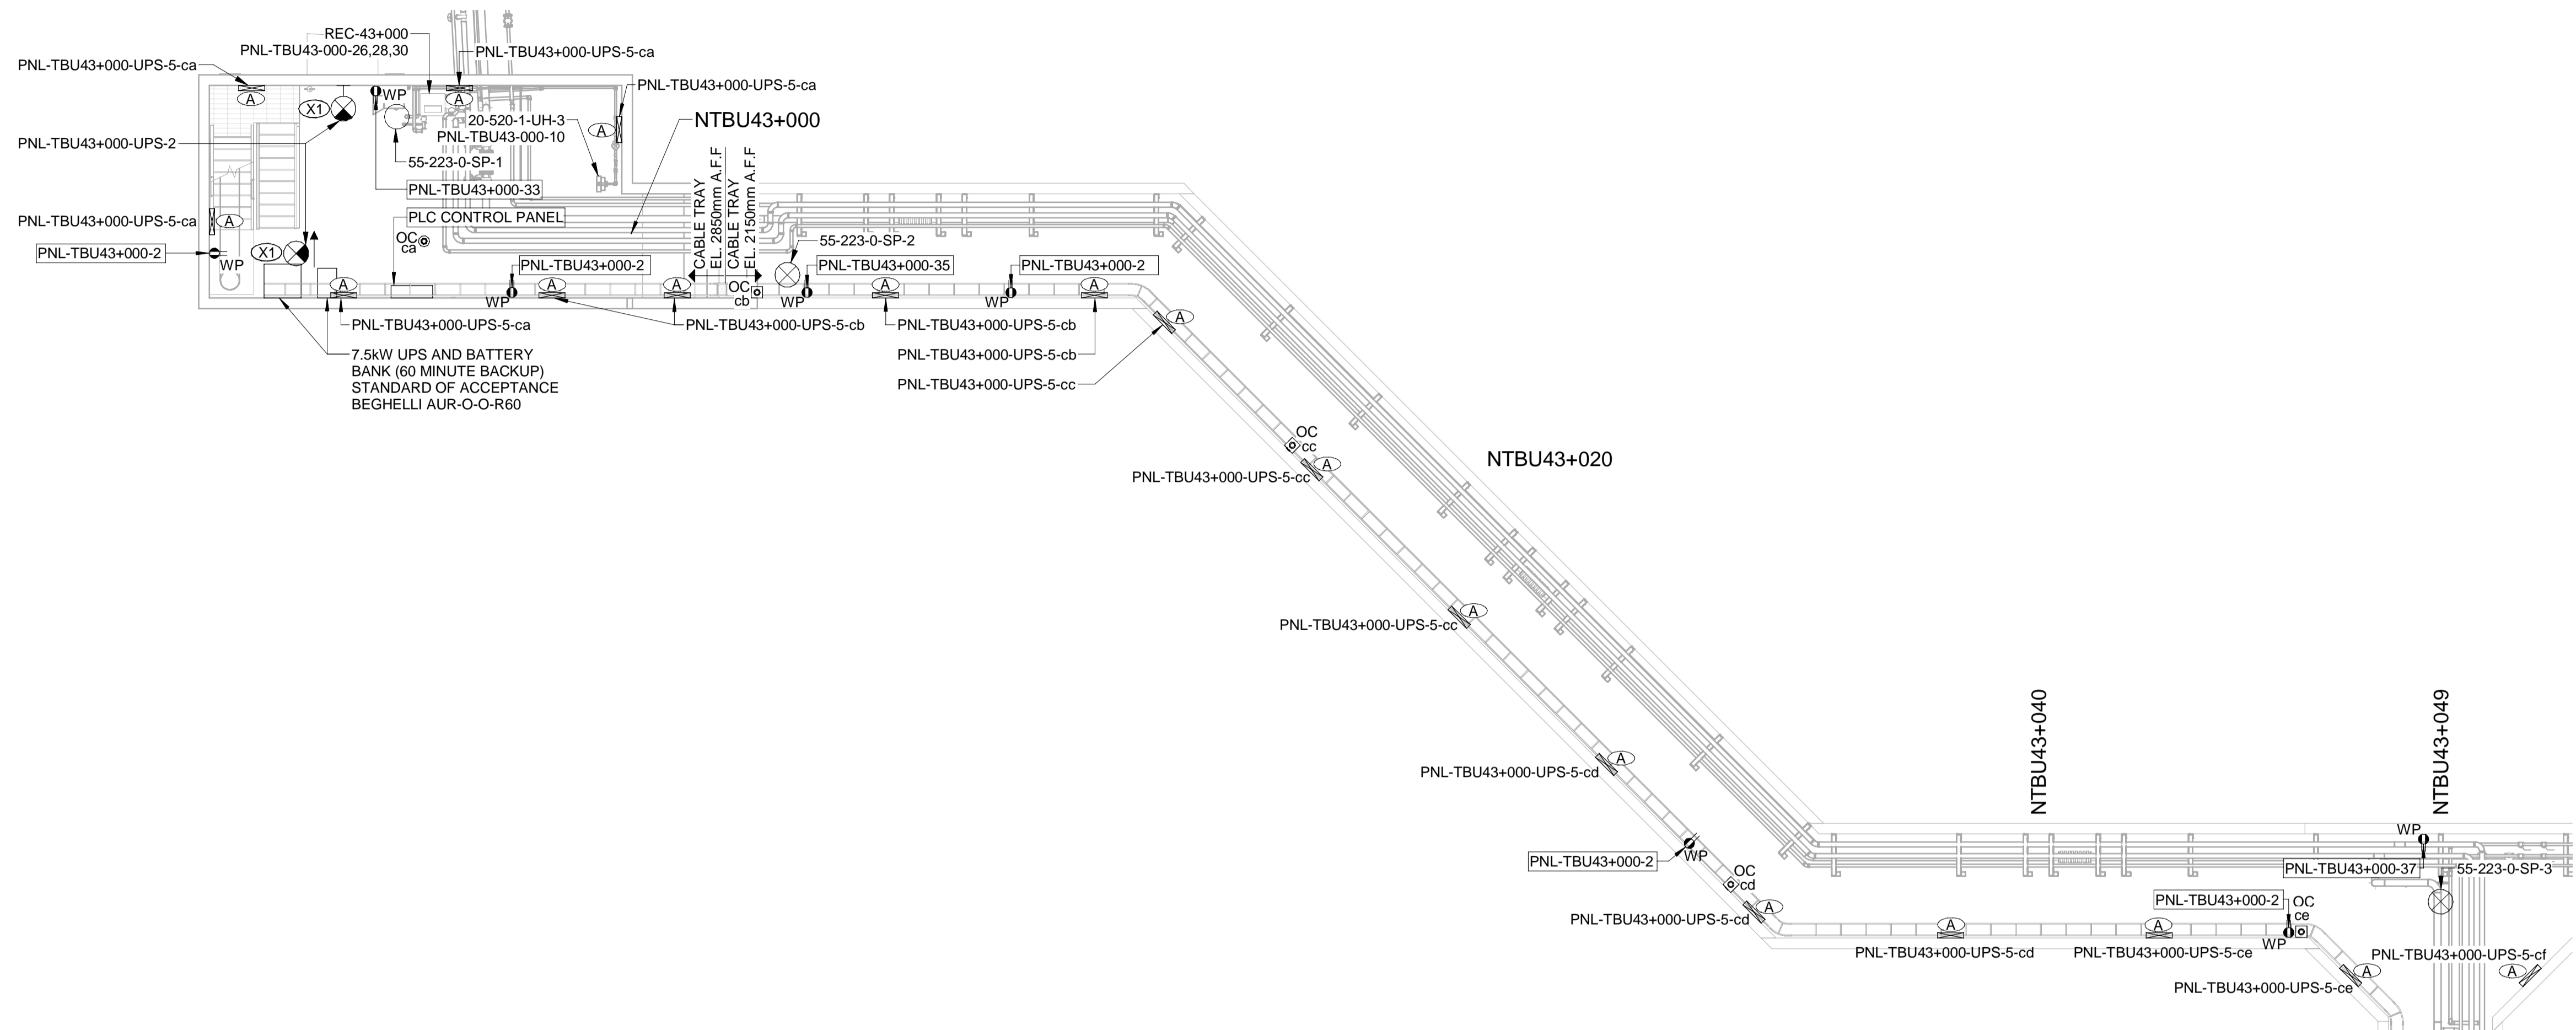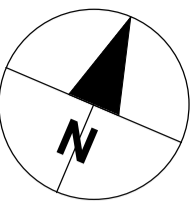

E1.20 Scale: 1 : 100

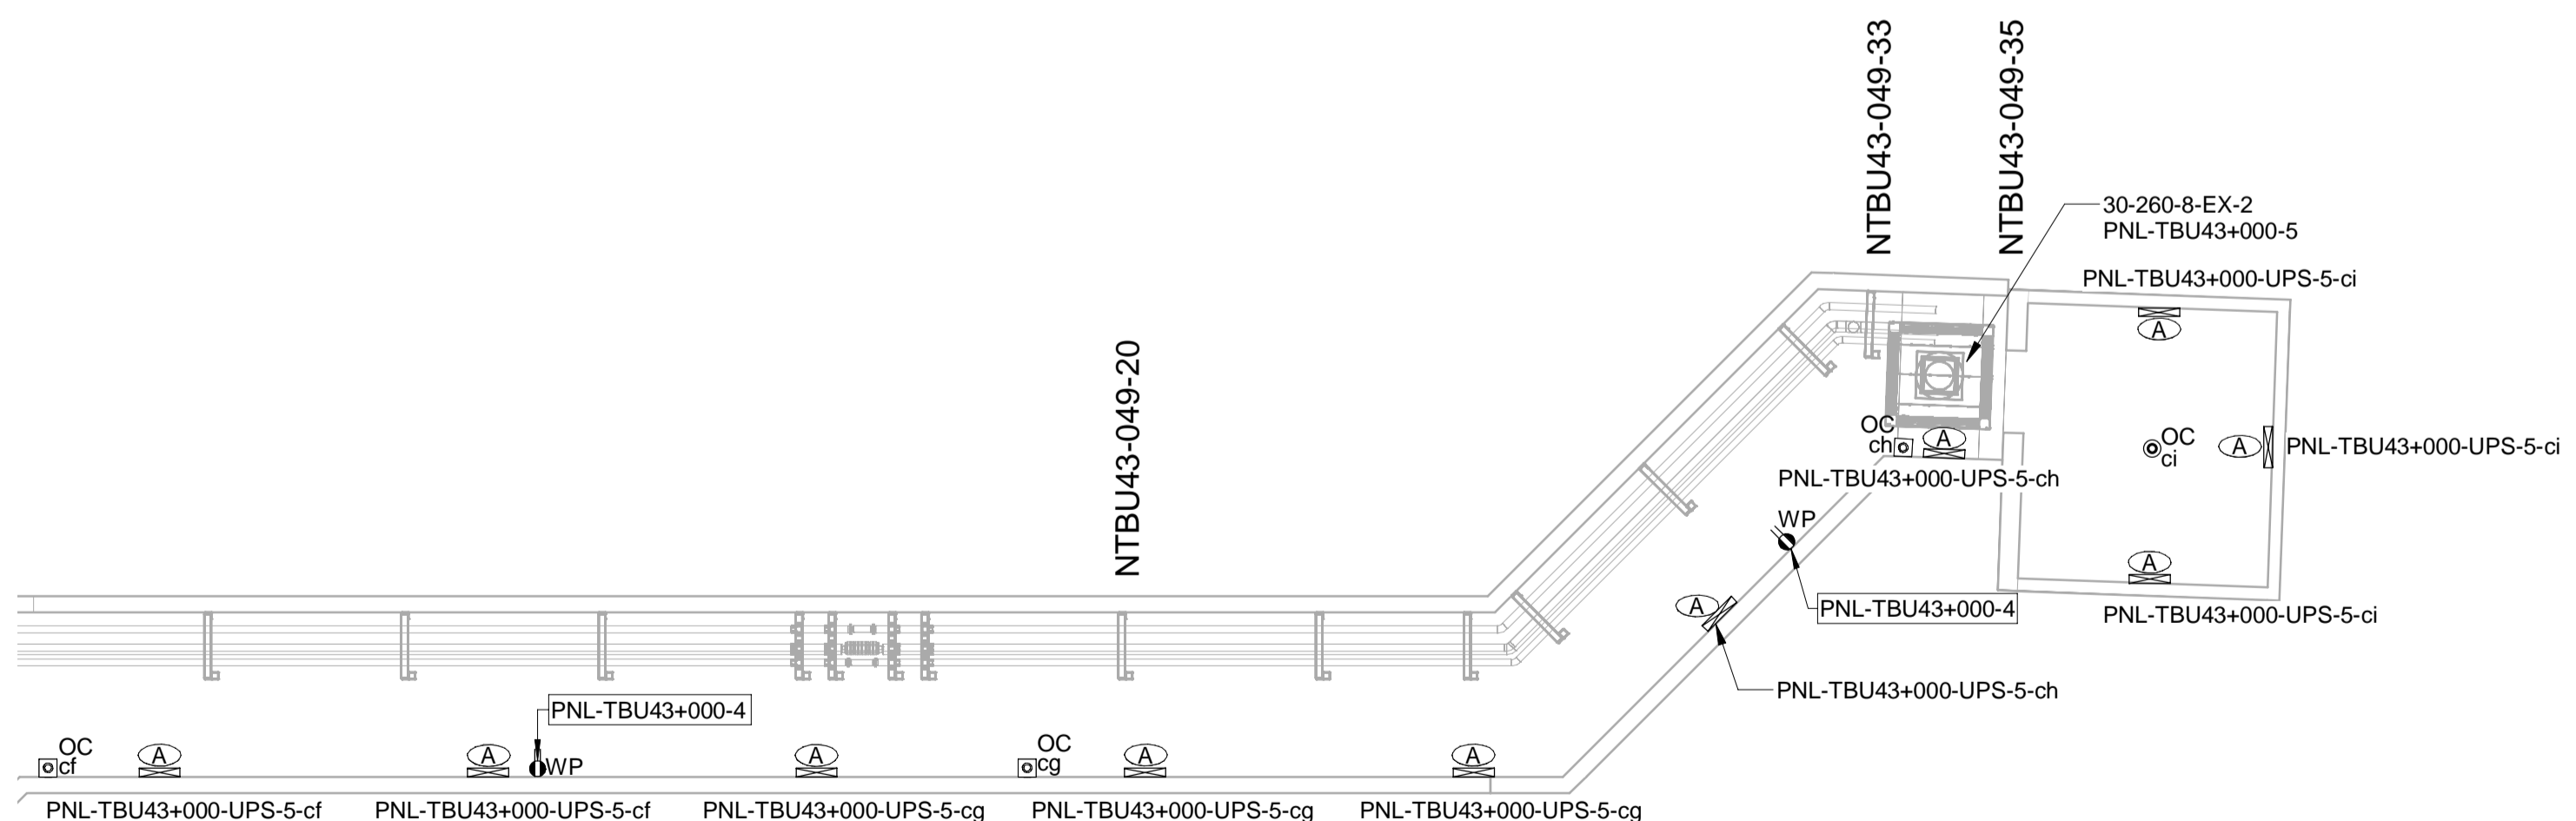

E1.20 Scale: 1 : 100

1. SUPPLY POWER TO EXIT SIGNS FROM NEAREST LUMINAIRE. EXIT SIGNS TO HAVE 60 MINUTE BATTERY BACKUP.
2. MOUNT EXIT SIGNS AT A HEIGHT THAT ENSURES VISIBILITY AND IS NOT OBSTRUCTED BY OTHER WORKS.
3. EXIT SIGNS TO BE MOUNTED ON A SWIVEL.
4. INSTALL LUMINAIRES BELOW CABLE TRAY.
5. MOUNT CABLE TRAY ABOVE LUMINAIRES WITH A MINIMUM VERTICAL CLEARANCE OF 300mm TO CEILING.
6. PROVIDE CABLE TRAY SUPPORTS EVERY 1.5 METERS AS CLOSE AS PRACTICAL TO THE CABLE TRAY QUARTER SPAN.
7. FIRE CODE REQUIREMENTS APPLY. BE BINDING IN ACCORDANCE TO THE LATEST EDITION OF THE CANADIAN ELECTRICAL CODE AND LOCAL AMENDMENTS.
8. SEPARATE POWER AND COMMUNICATIONS CABLES IN CABLE TRAY WITH APPROPRIATE PARTITION.
9. FIRE ALARM HORN / STROBE TO BE CONNECTED TO ADJACENT BUILDING FIRE ALARM SYSTEM.
10. PROVIDE AND INSTALL SIGN: (DO NOT ENTER WHILE HORN / STROBE IS ACTIVE).

