


## 1 MAKE-UP AIR AT TBU43+520 - FLOOR PLAN

Scale: 1 : 25


### NOTES:

1. REFER TO DRAWINGS S1.00 FOR STRUCTURAL NOTES
2. CONTRACTOR TO VERIFY ALL DIMENSIONS AND ELEVATIONS PRIOR TO CONSTRUCTION
3. REFER TO DRAWINGS S1.22 FOR TYPICAL DETAILS
4. 200 SLAB REINFORCING
  - 10M AT 300oc TOP (SHORT)
  - 10M AT 500oc TOP (LONG)
  - 15M AT 500oc BOTTOM (LONG)
  - 15M AT 300oc BOTTOM (SHORT)
  - ALL SLAB REINFORCING TO BE CONTINUOUS.
  - PROVIDE STANDARD 180 DEGREE HOOK FOR TOP REINFORCING AT OPENING
5. MECHANICAL FLOOR OPENING. REFER TO MECHANICAL DRAWINGS FOR LOCATION
6. SUMP PIT. REFER TO DRAWINGS S1.22 FOR TYPICAL DETAILS

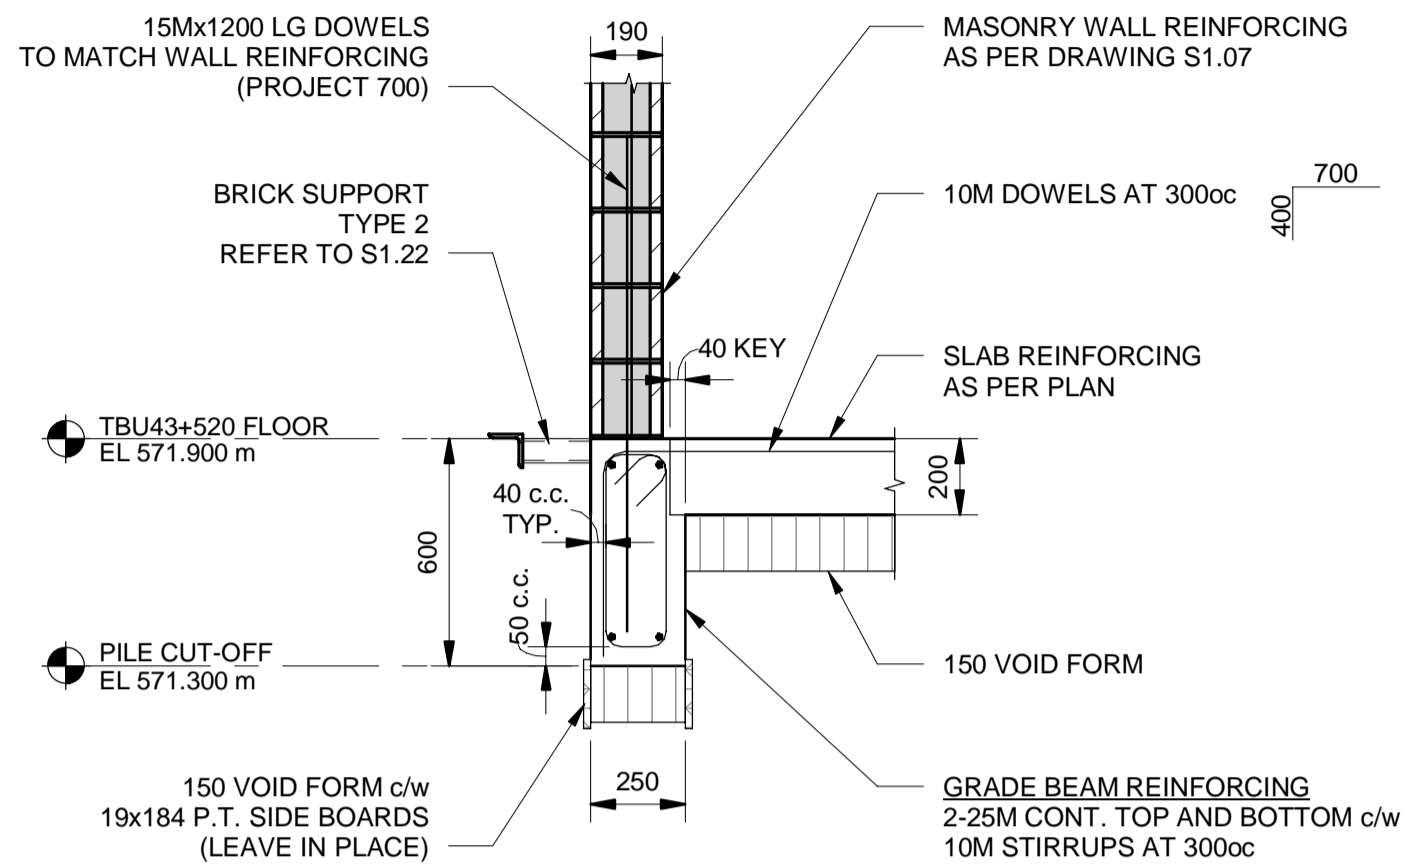

## 2 DETAIL

S1.06 Scale: 1 : 20

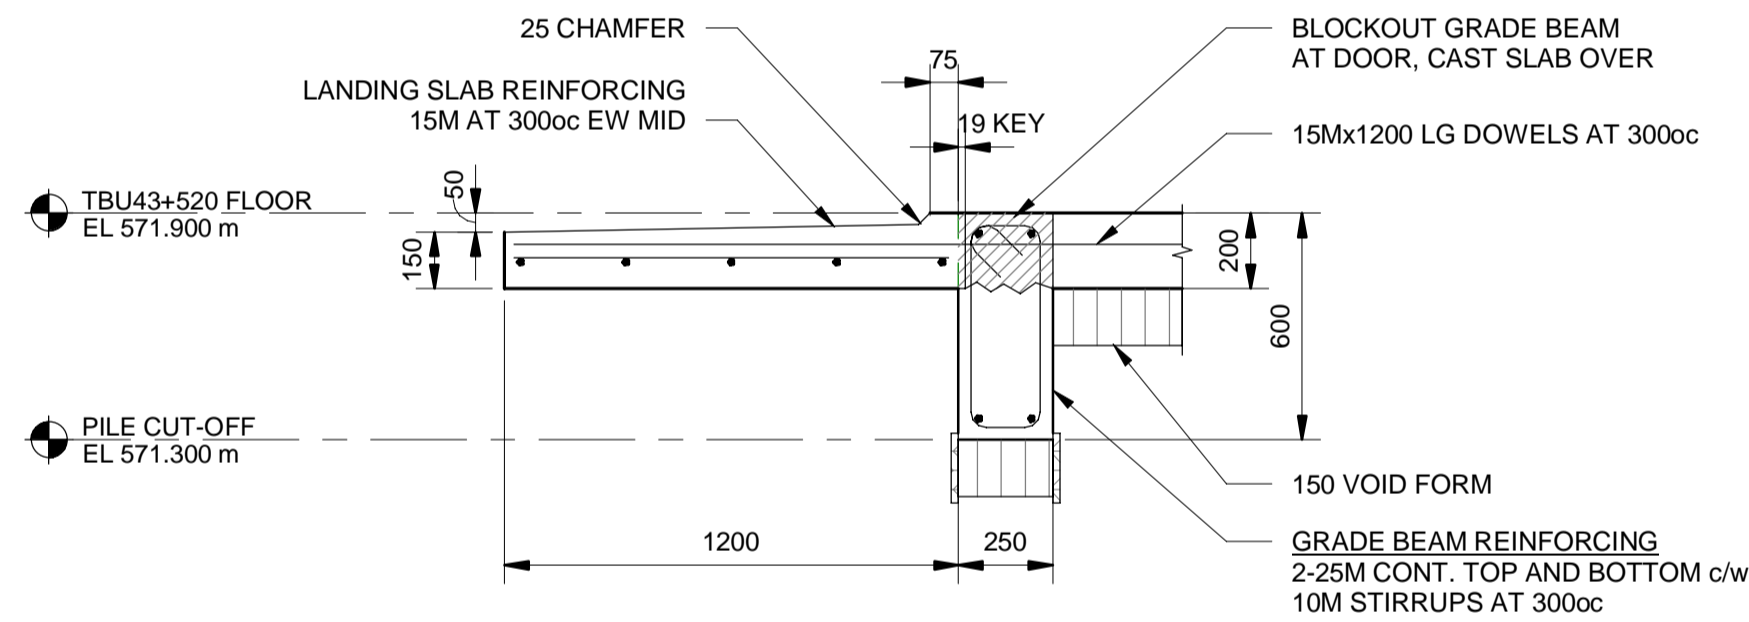


## 3 DETAIL


S1.06 Scale: 1 : 20

# TENDER

## NOT FOR CONSTRUCTION

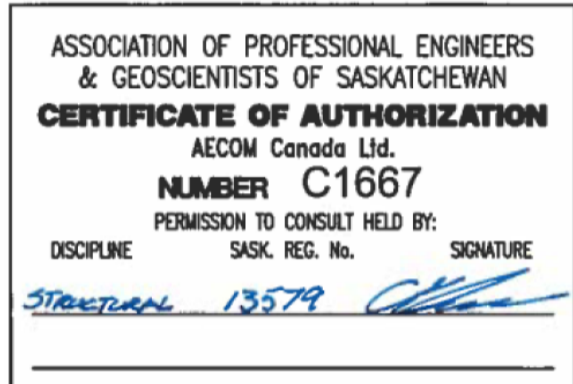

Key Plan

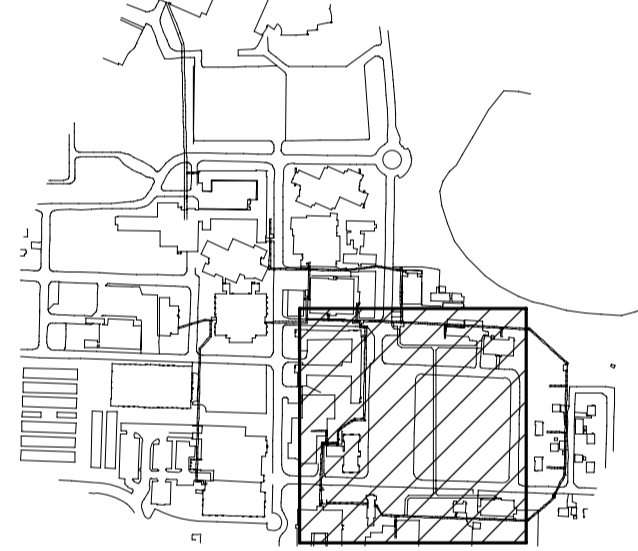

Revision	Description	Date
E	Issued For Tender	19/09/30
D	Issued For 99% Review	19/06/21
C	Issued For 85% Review	19/03/15
B	Issued For 50% Review	18/11/13
A	Not Issued	-

Client  
**Public Works and Government Services Canada**

Project Title  
**Tunnel Revitalization**

Designed by  
**C. Klemmer**  
Drawn by  
**O. Muaz**  
Approved by  
**B. Wolfater**  
PWGSC Project Manager  
**J. Dayman**

Drawing Title  
**Package 1-TBU 43 - Building Structural Plan And Details**

Project no.	Drawing no.	Revision no.
1004259	S1.06	E