


TENDER

NOT FOR CONSTRUCTION



ASSOCIATION OF PROFESSIONAL ENGINEERS & GEOSCIENTISTS OF SASKATCHEWAN
CERTIFICATE OF AUTHORIZATION
AECOM Canada Ltd.
NUMBER C1667
PERMISSION TO CONSULT HELD BY:
DISCIPLINE: SASK. REG. No. SIGNATURE: [Signature]

Key Plan

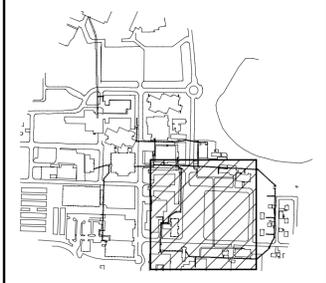

Revision	Description	Date
E	Issued For Tender	19/09/30
D	Issued For 99% Review	19/06/21
C	Issued For 85% Review	19/03/15
B	Issued For 50% Review	18/11/13
A	Not Issued	-

Public Works and Government Services Canada







Project Title

Tunnel Revitalization






Designed by: C. Klemmer
Drawn by: O. Muaz
Approved by: B. Wolfater
RWGSC Project Manager: J. Dayman
Drawing Title

Package 1-TBU43 - Building Structural Plans, Section, And Details

Project no.	Drawing no.	Revision no.
1004259	S1.11	E

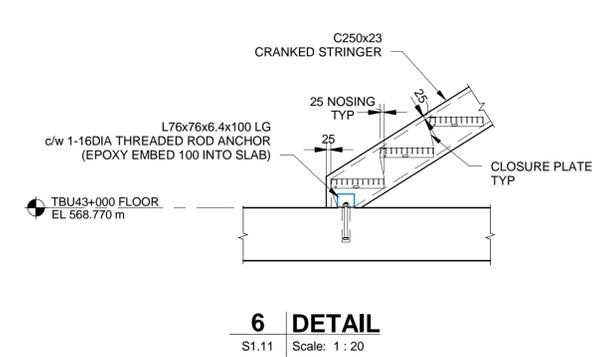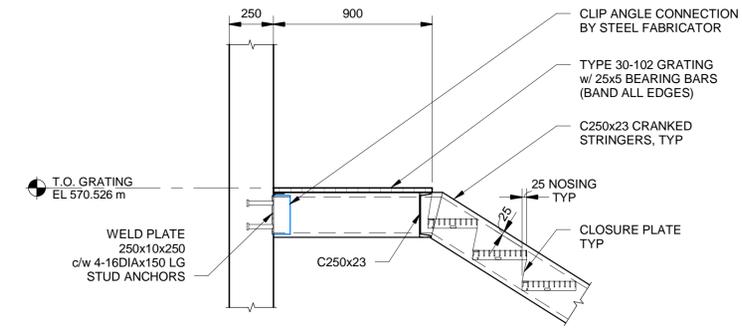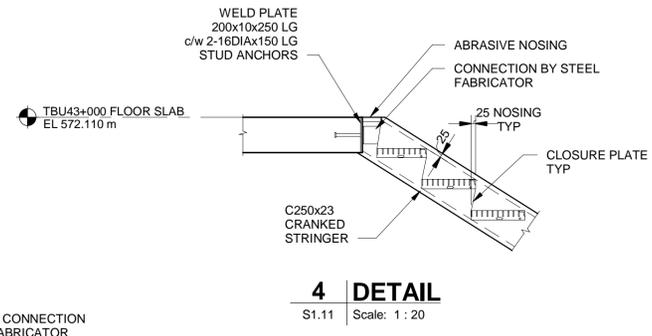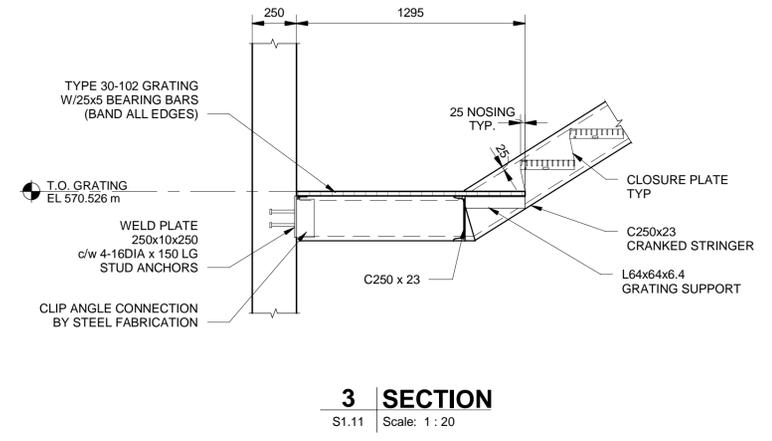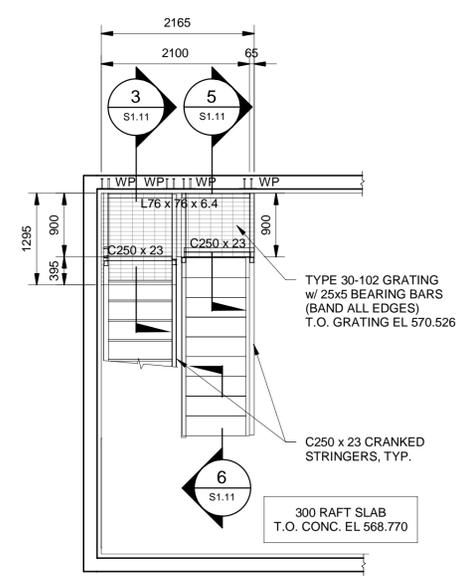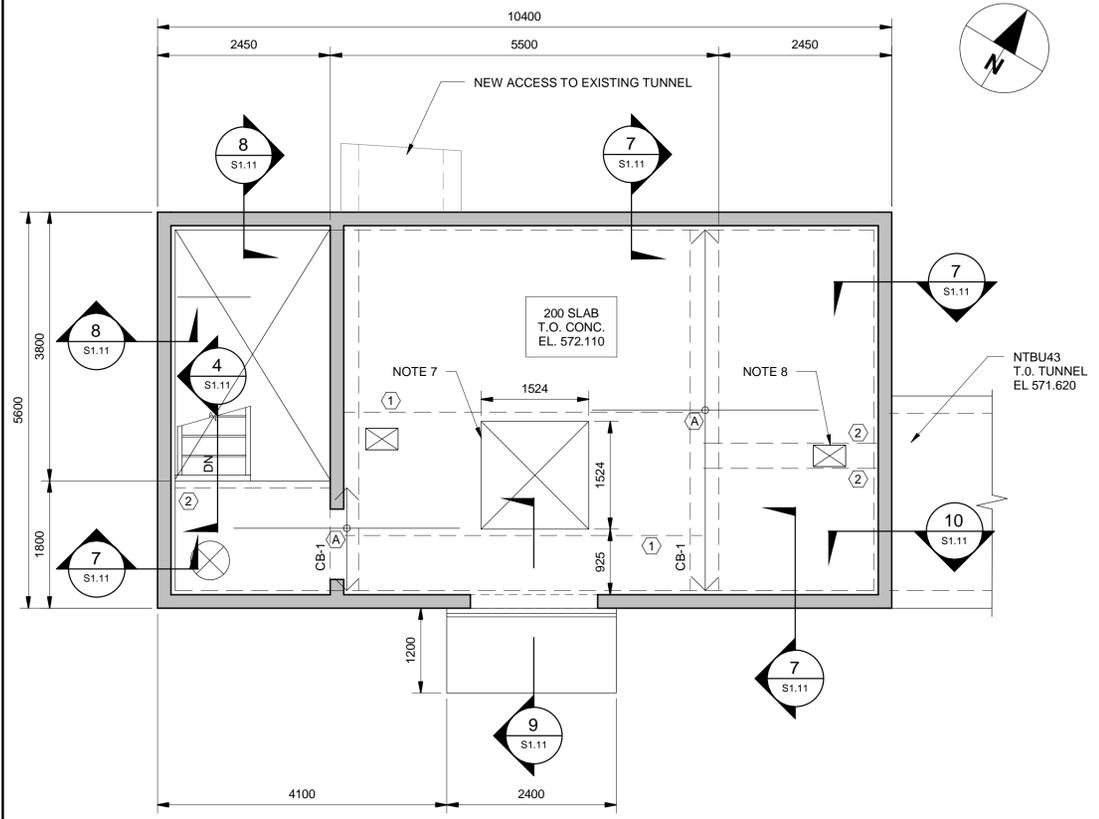

- 1 MAKE-UP AIR AT TBU43+000 - FLOOR PLAN**
S1.11 Scale: 1:50
- NOTES:**
- REFER TO DRAWING S1.00 FOR STRUCTURAL NOTES
 - CONTRACTOR TO VERIFY ALL DIMENSIONS AND ELEVATIONS PRIOR TO CONSTRUCTION
 - REFER TO DRAWING S1.22 FOR TYPICAL DETAILS
 - 200 SLAB REINFORCING (25 c.c. TOP, 25 c.c. BOTTOM)
10M AT 300 c.c. EW TOP
15M AT 300 c.c. EW BOTTOM
PLUS ADDITIONAL REINFORCING NOTED ON PLAN
 - ADDITIONAL SLAB REINFORCING MATS
① ADD 2-20M x 5000 LG AT 100cc BOTTOM
② ADD 2-20M x 2500 LG AT 100cc BOTTOM
③ ADD 15M x 3200 LG AT 300cc TOP
 - CB-1 DENOTES CONCRETE BEAM, REFER TO DETAIL ON THIS DRAWING
 - ACCESS HATCH FLOOR OPENING. REFER TO ARCHITECTURAL DRAWINGS FOR HATCH DETAILS. CAST FRAME INTO SLAB
 - MECHANICAL FLOOR OPENINGS. REFER TO MECHANICAL DRAWINGS FOR SIZES AND LOCATIONS

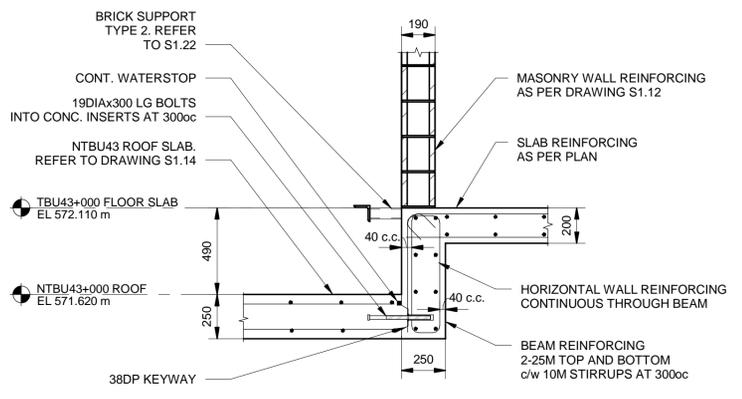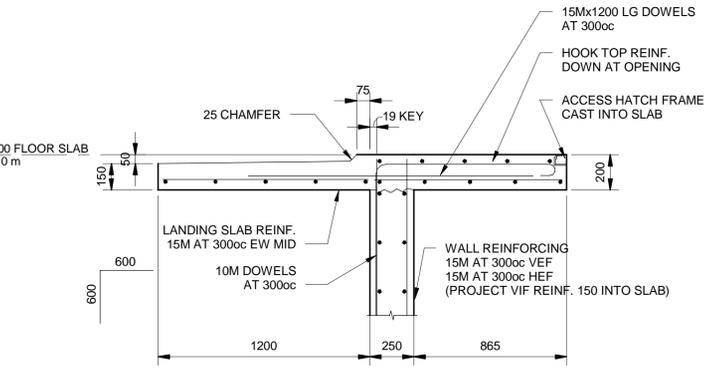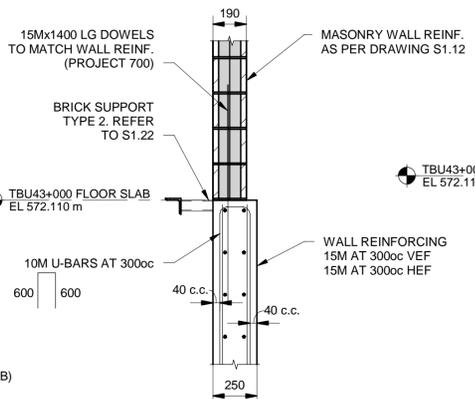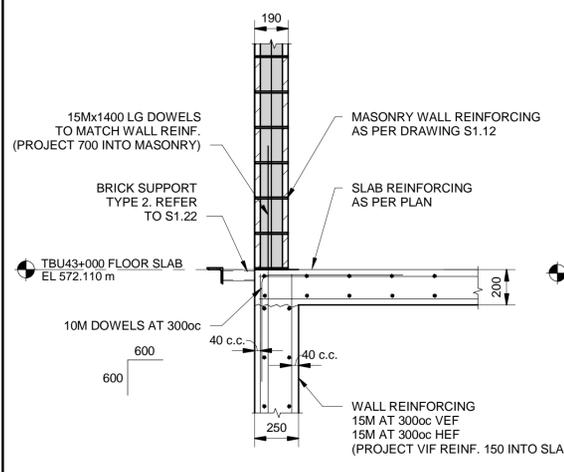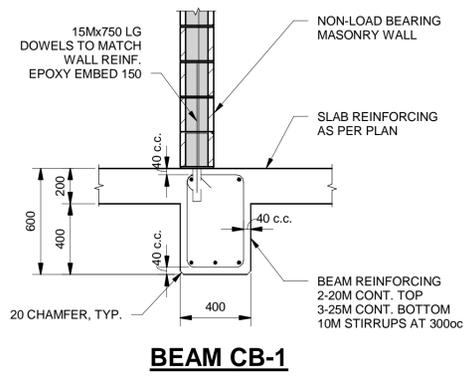

7 DETAIL
S1.11 Scale: 1:20

8 DETAIL
S1.11 Scale: 1:20

9 DETAIL
S1.11 Scale: 1:20

10 DETAIL
S1.11 Scale: 1:20