
# RCMP ANAHIM LAKE HOUSING RENOVATIONS


6661 CHRISTENSEN ROAD, ANAHIM LAKE, B.C.

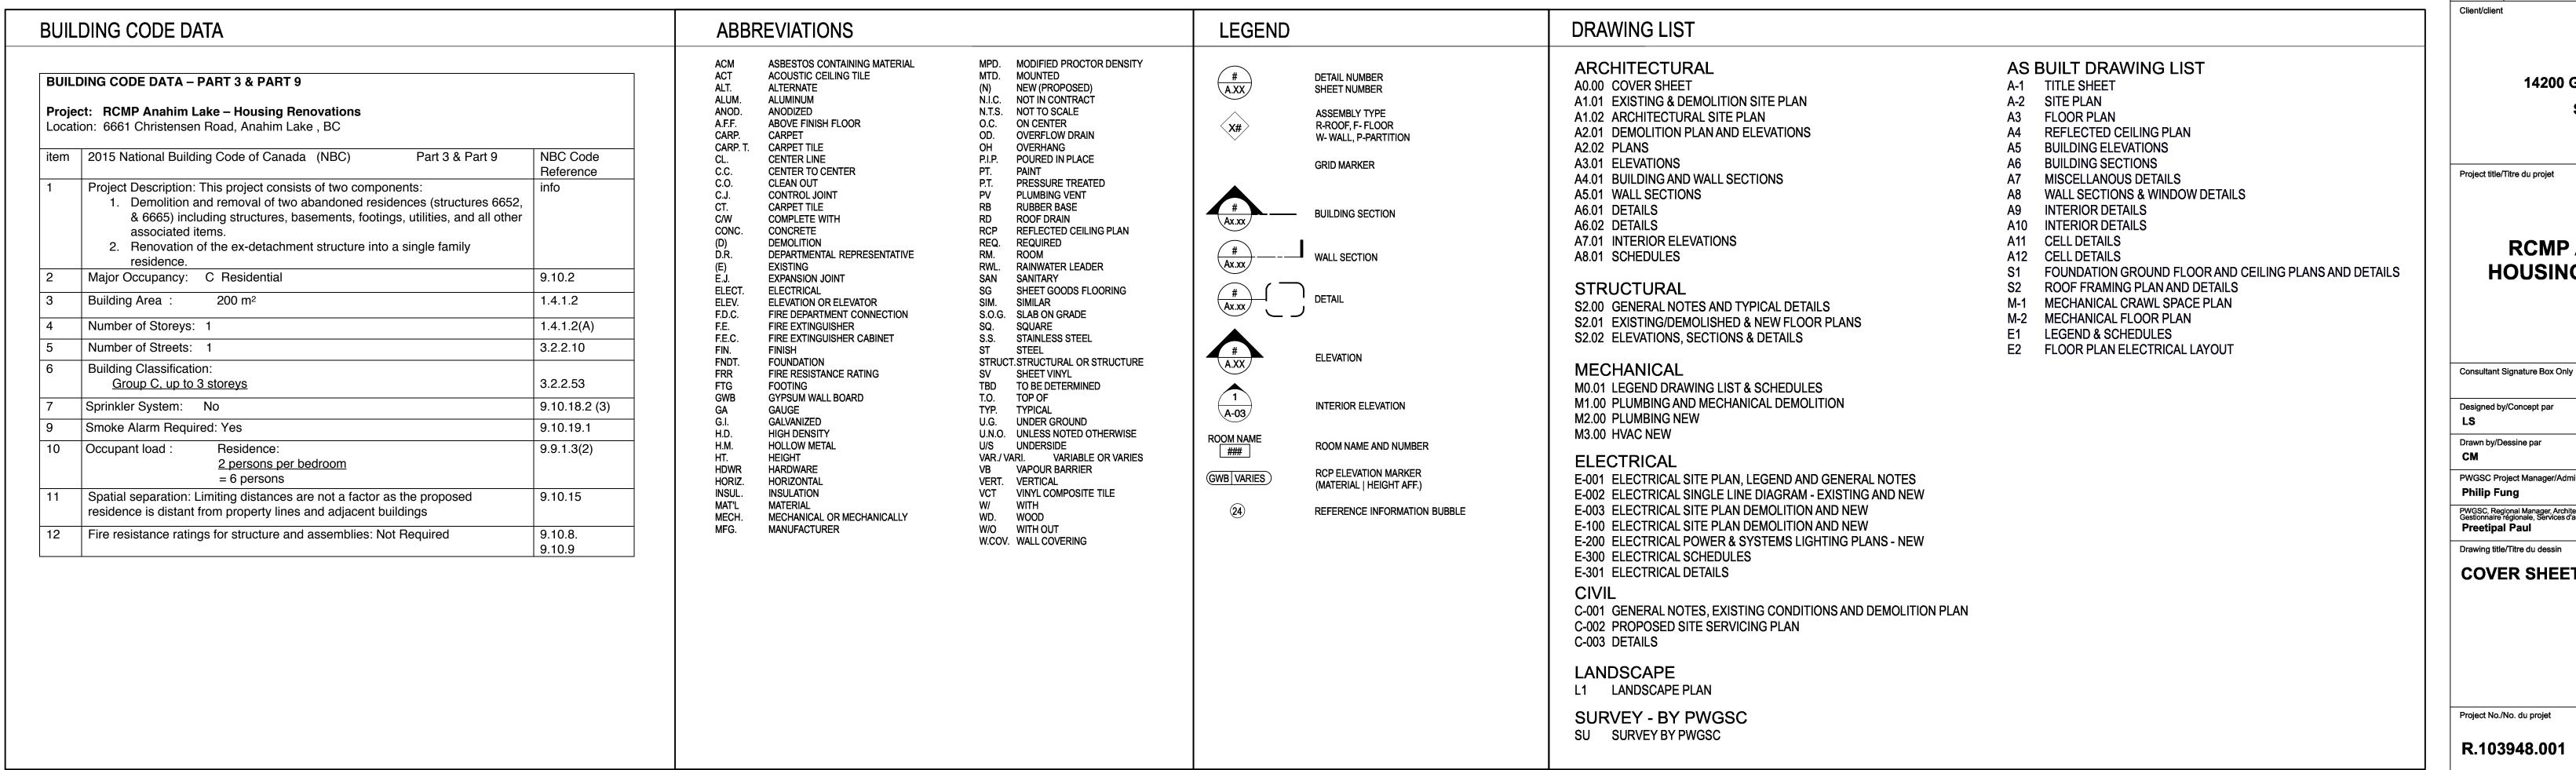







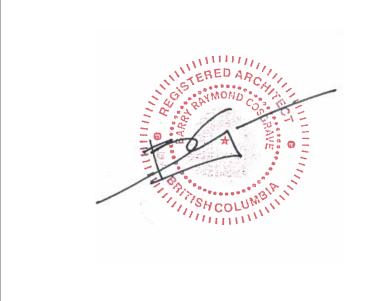

0	ISSUED FOR TENDER	2019 12 09
В	99% REVIEW SUBMISSION	2019 10 25
A	50% REVIEW SUBMISSION	2019 09 13
Revision/ Revision	Description/Description	Date/Date

**RCMP** 14200 Green Timbers Way

Surrey, B.C.

RCMP ANAHIM LAKE **HOUSING RENOVATIONS** 


Drawn by/Dessine par PWGSC Project Manager/Administrateur de Projets TPSGC PWGSC, Regional Manager, Architectural and Engineering Services/ Gestionnaire régionale. Services d'architectural et de génie, TPSGC Preetipal Paul


Drawing title/Titre du dessin **COVER SHEET** 


R.103948.00



0 10 20 30 40 50 60 70 80 90 100mm

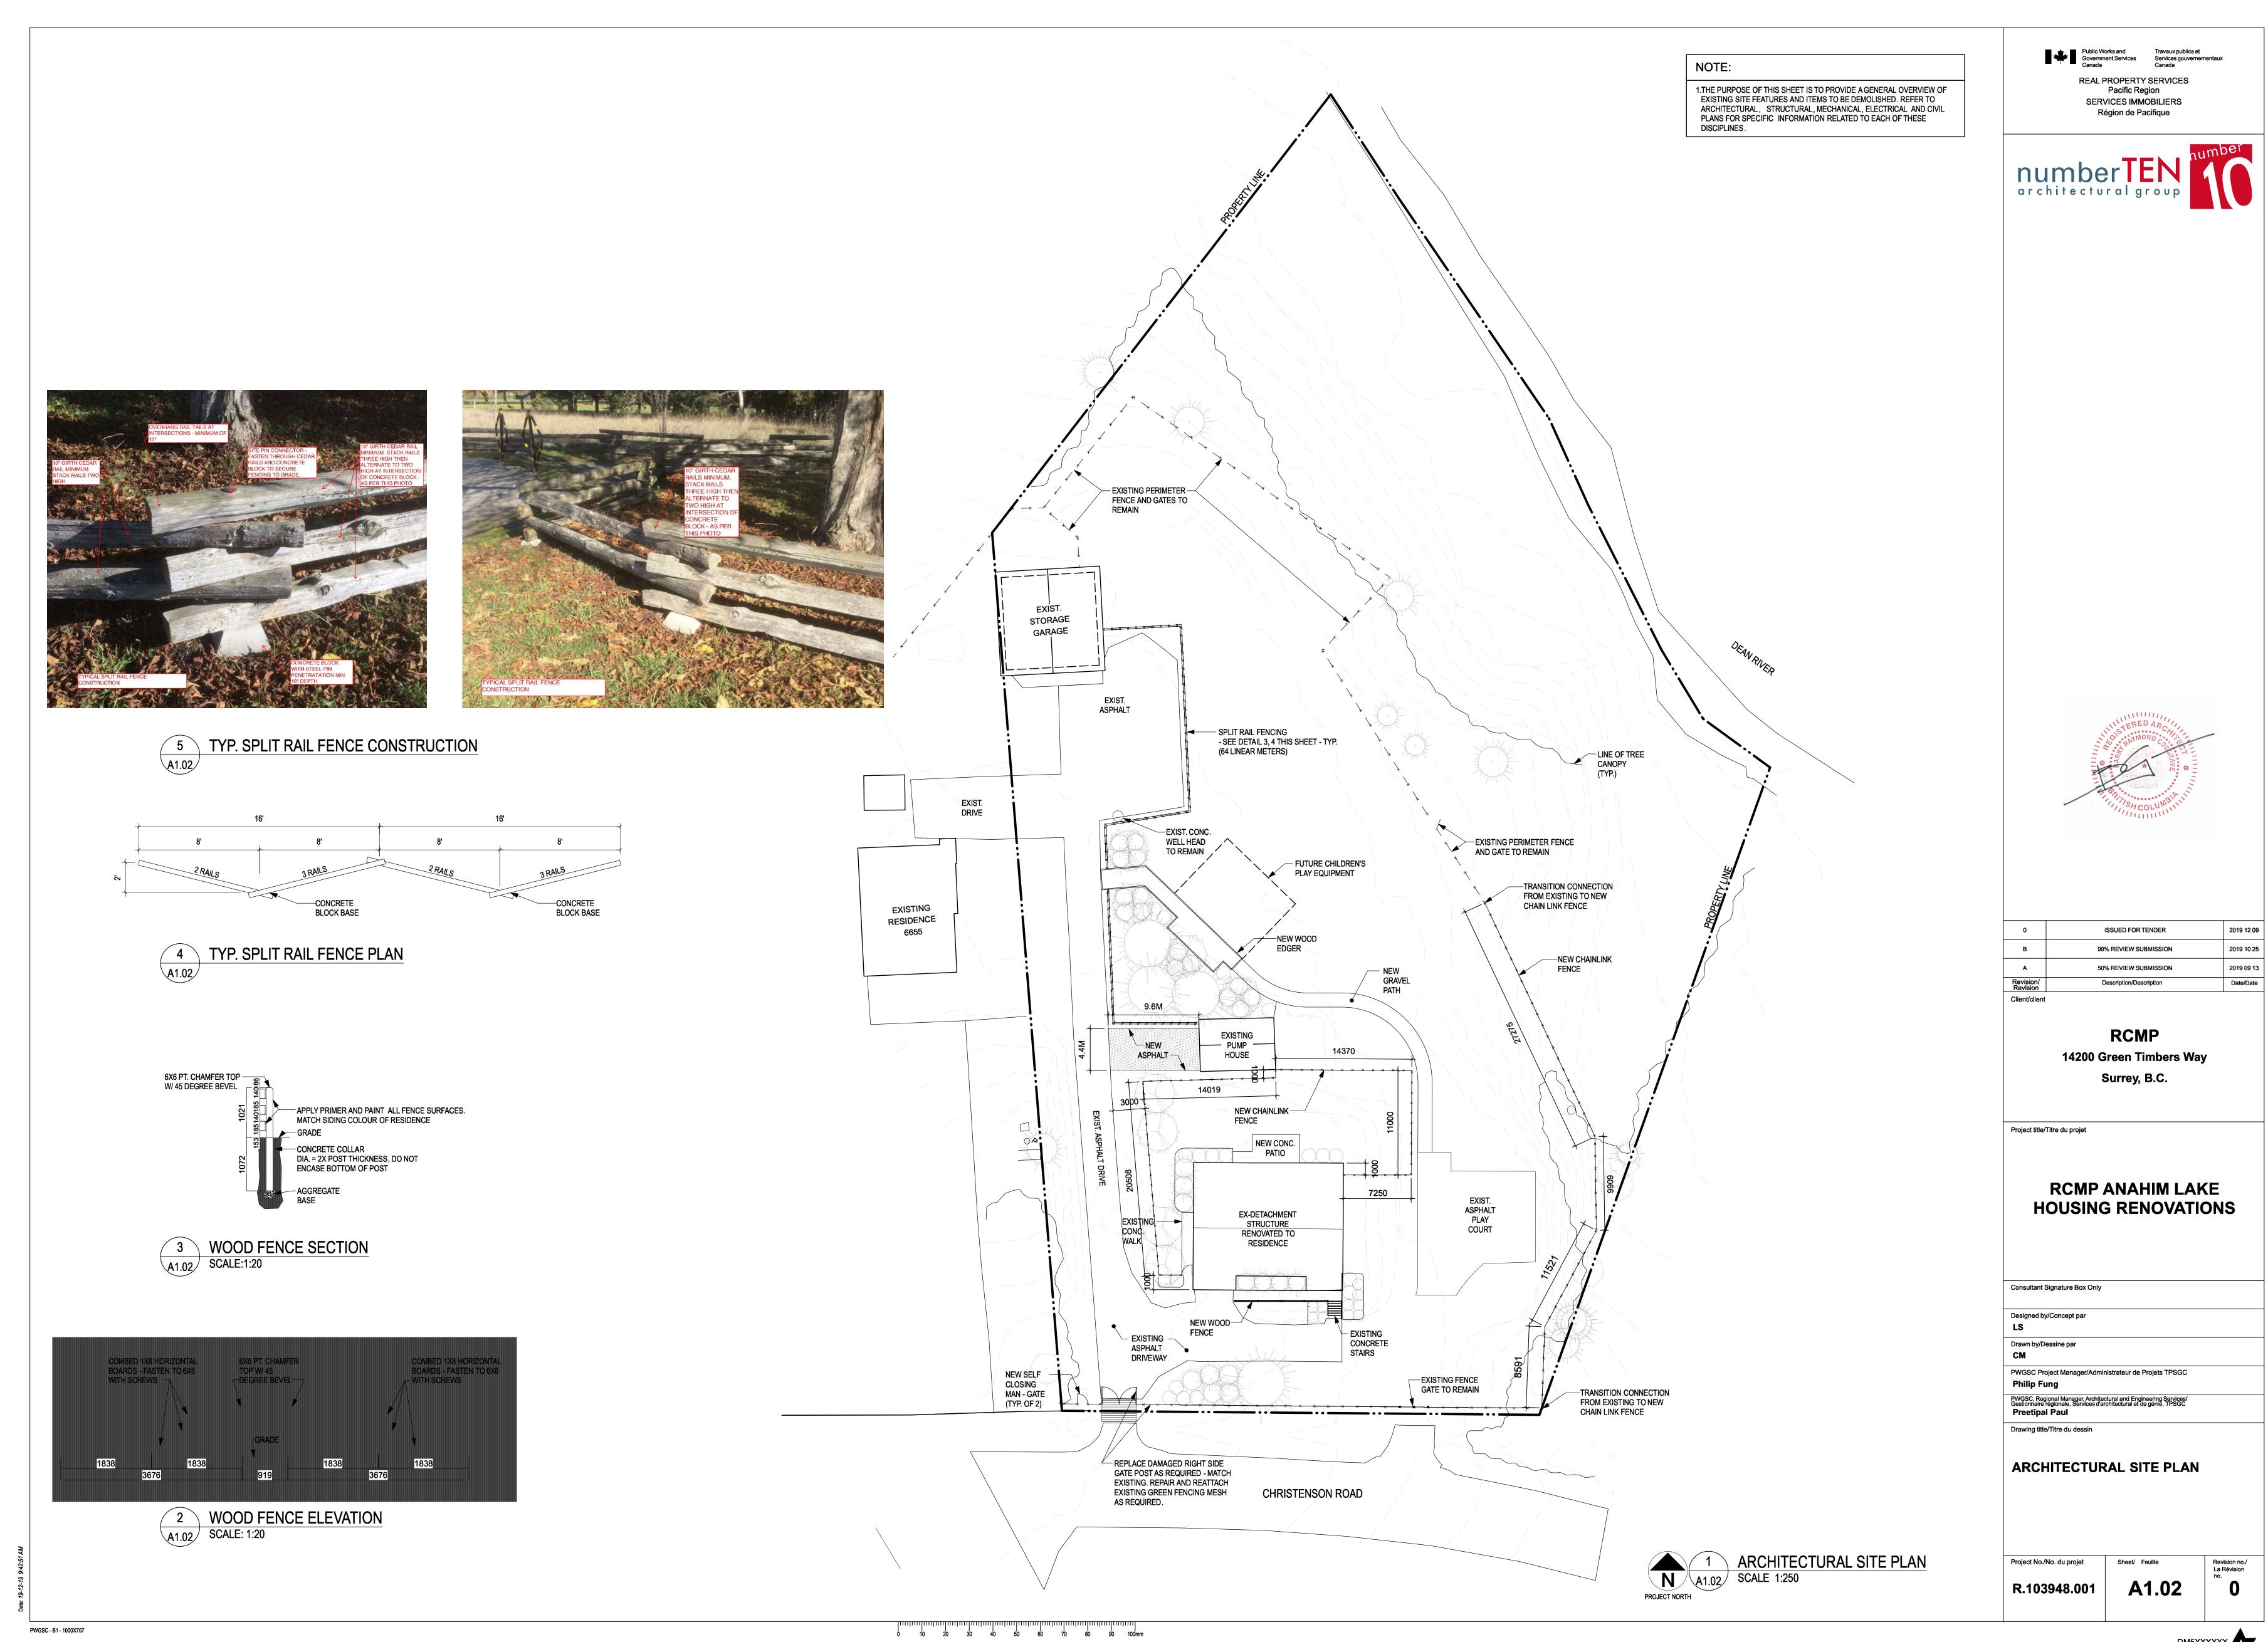


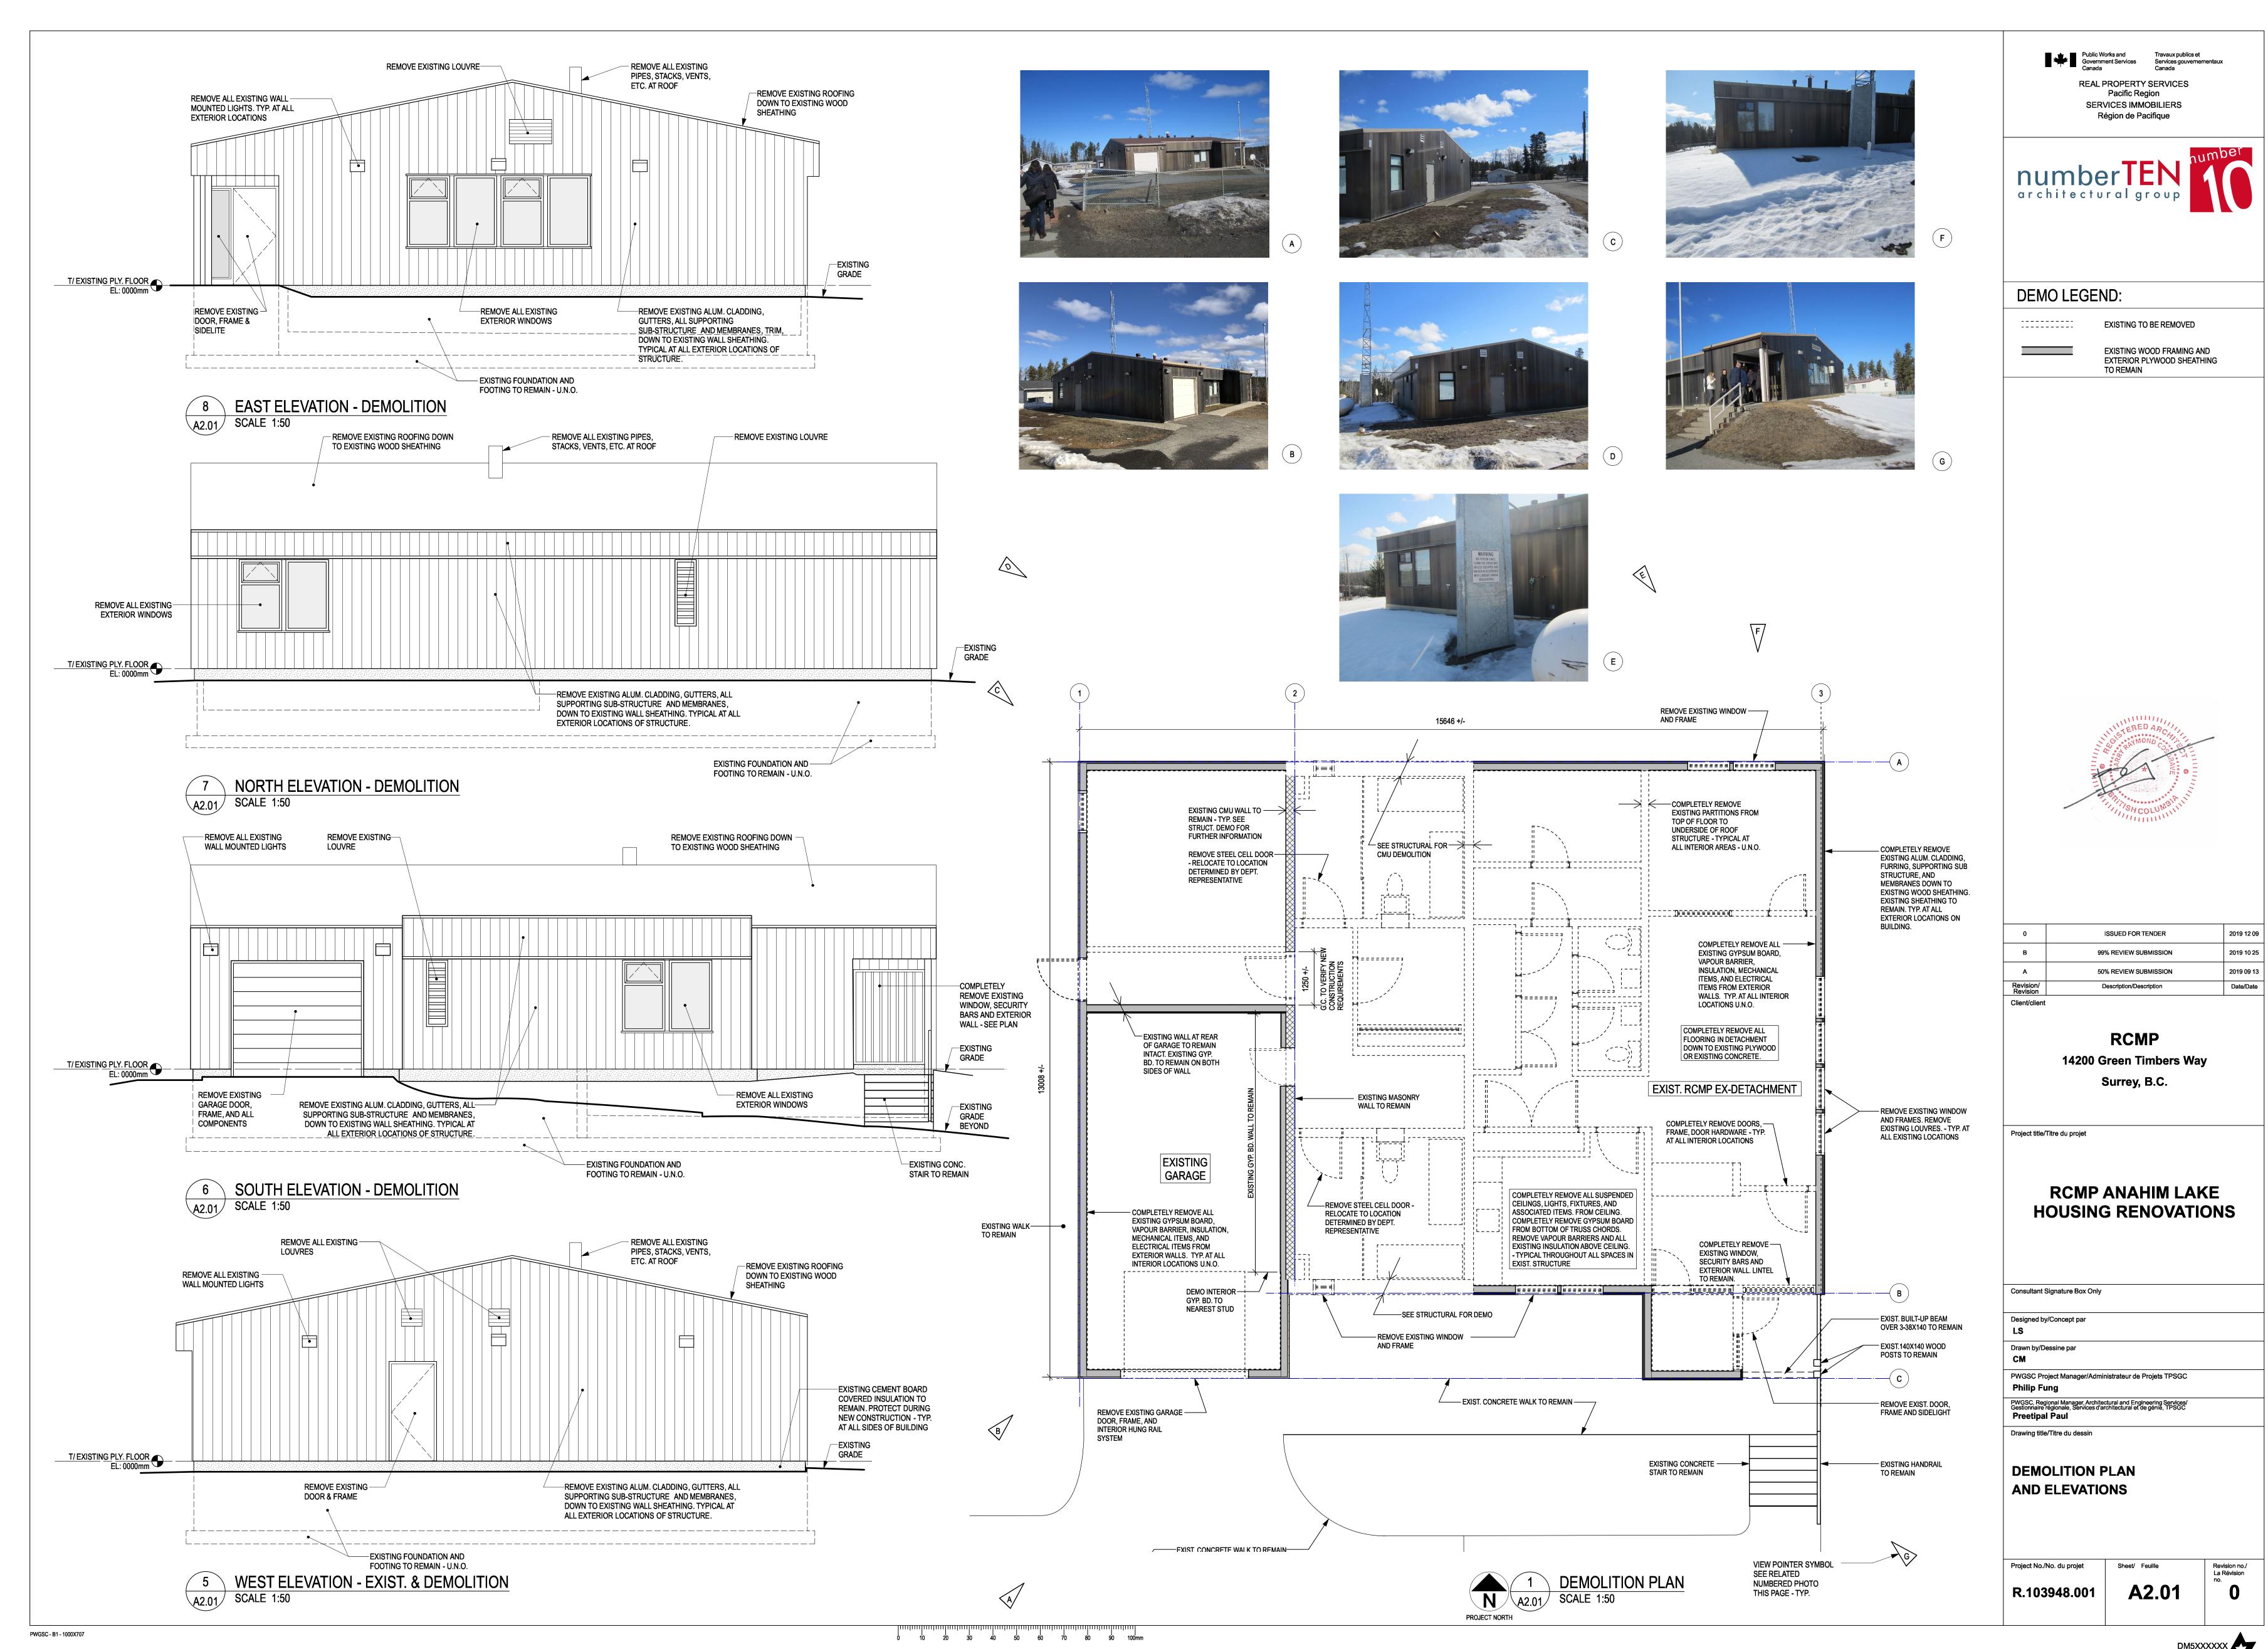


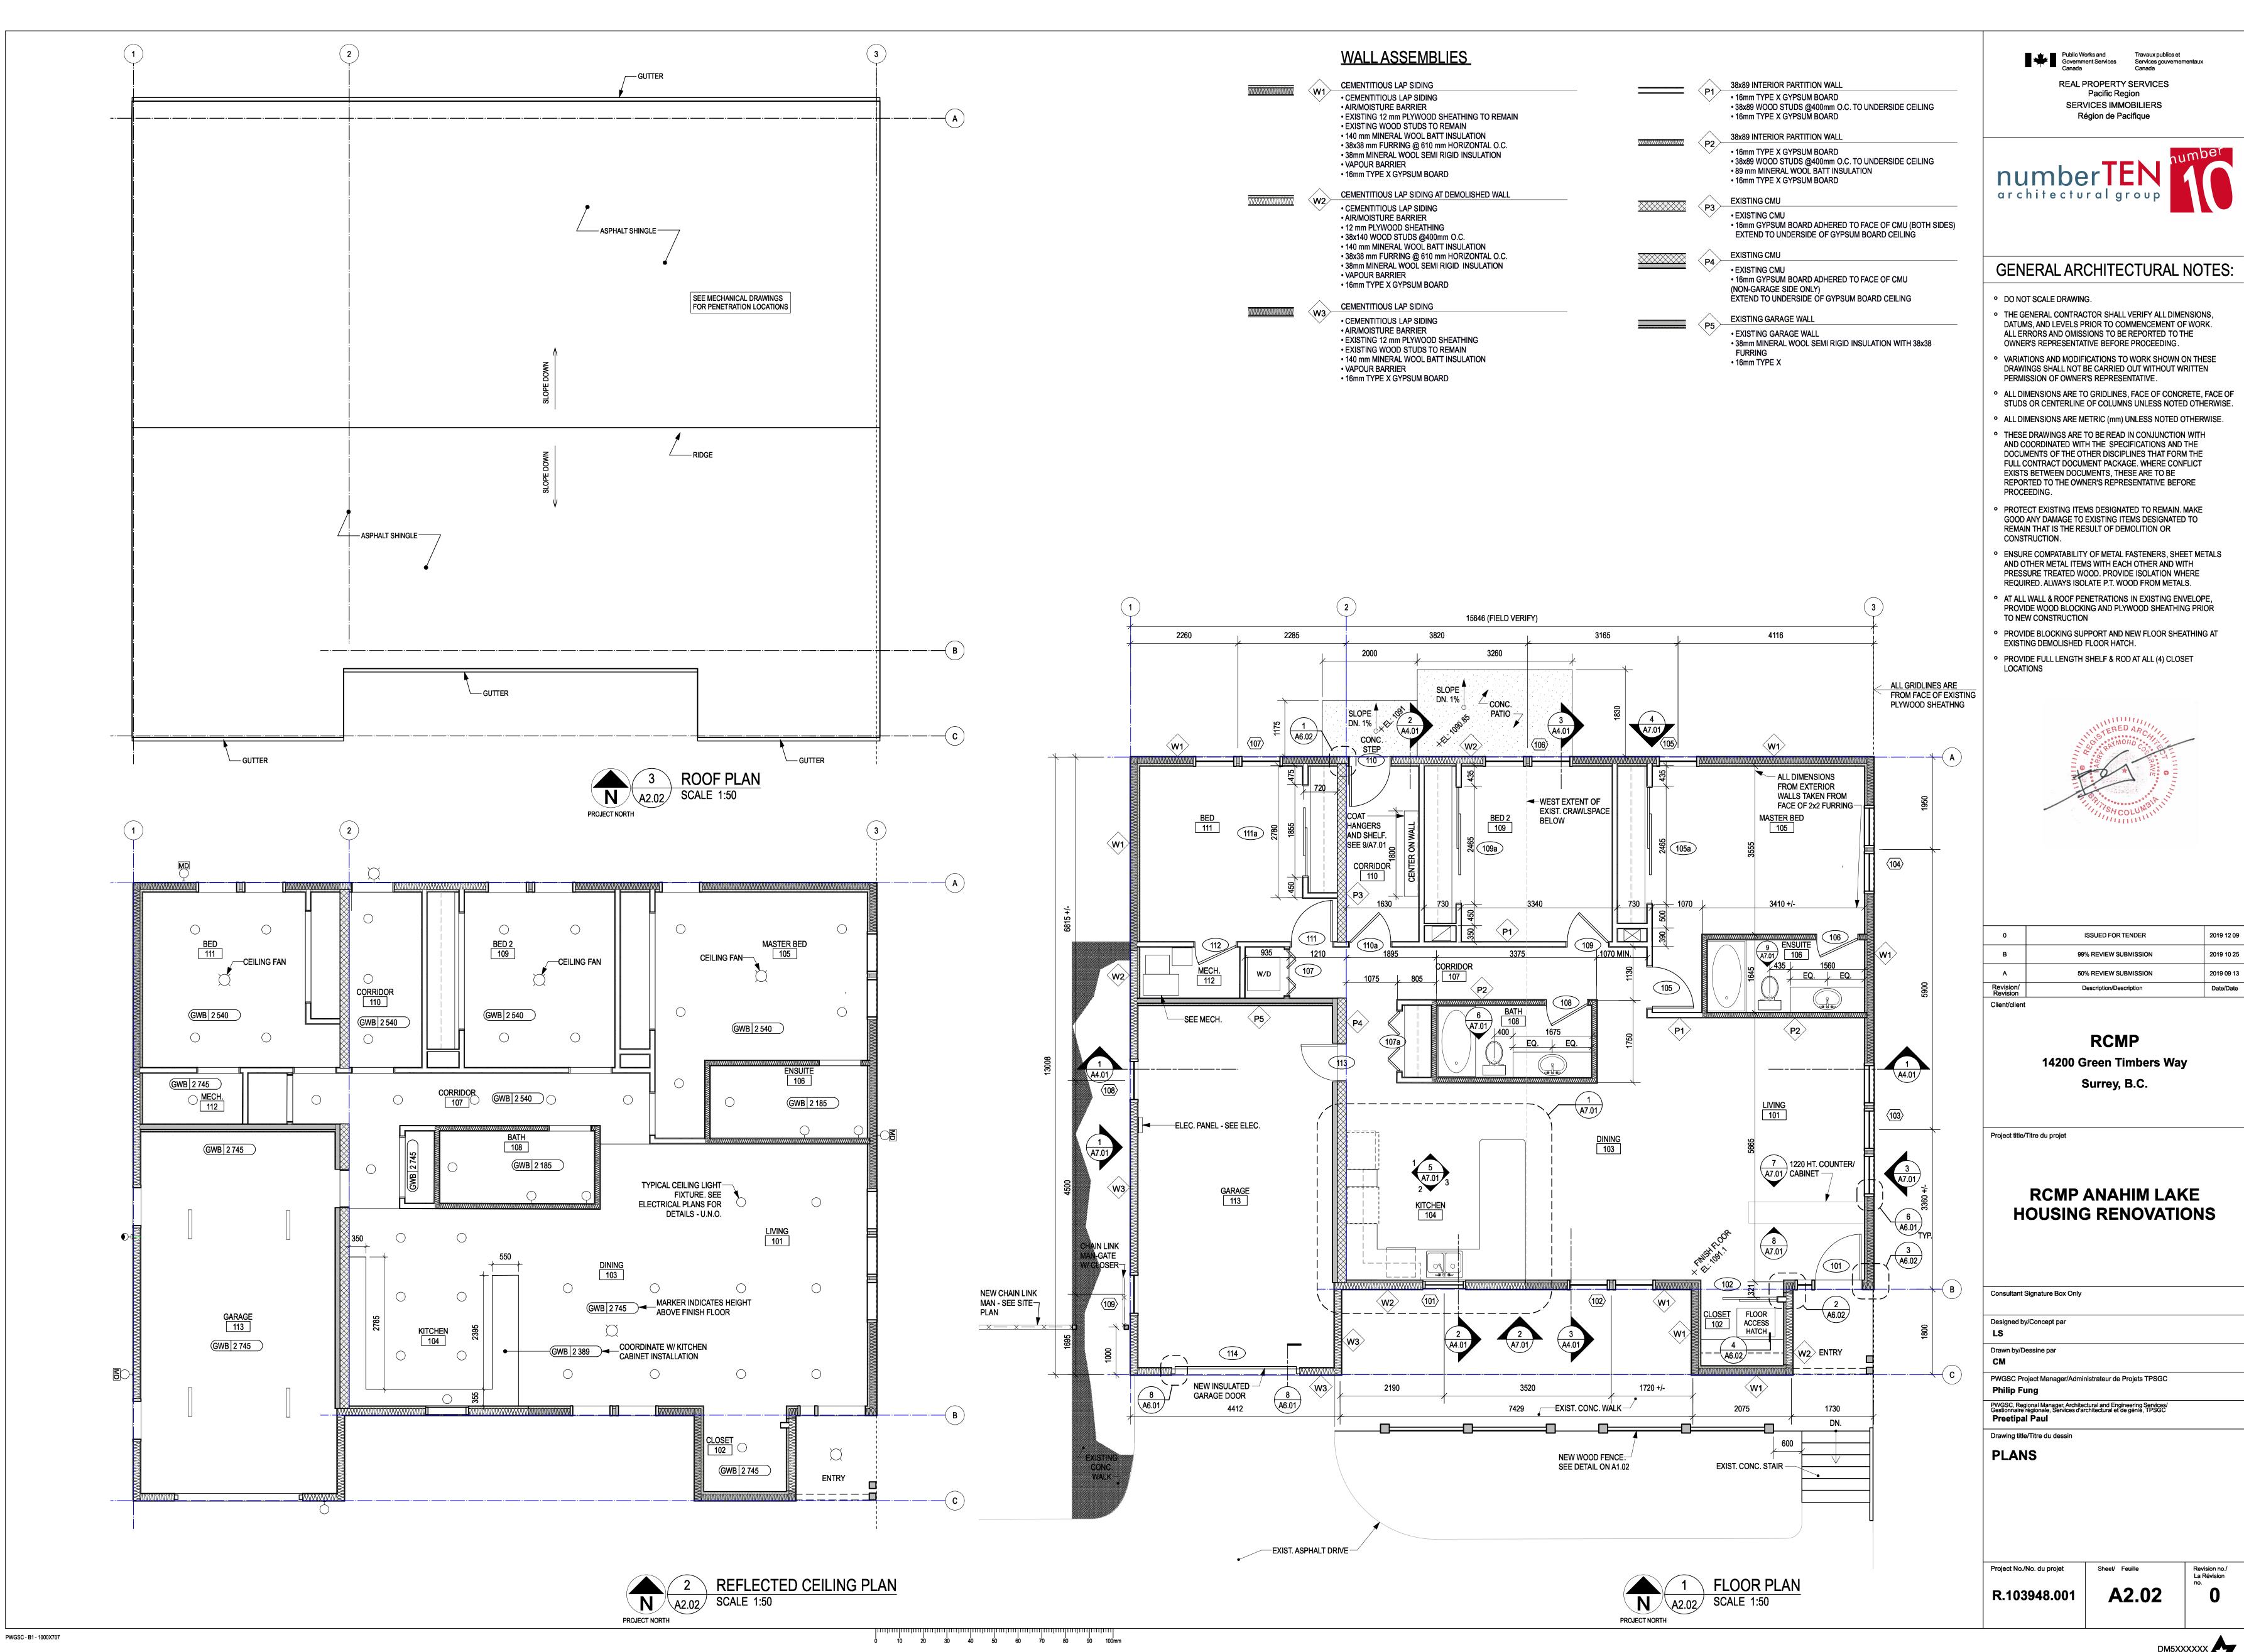







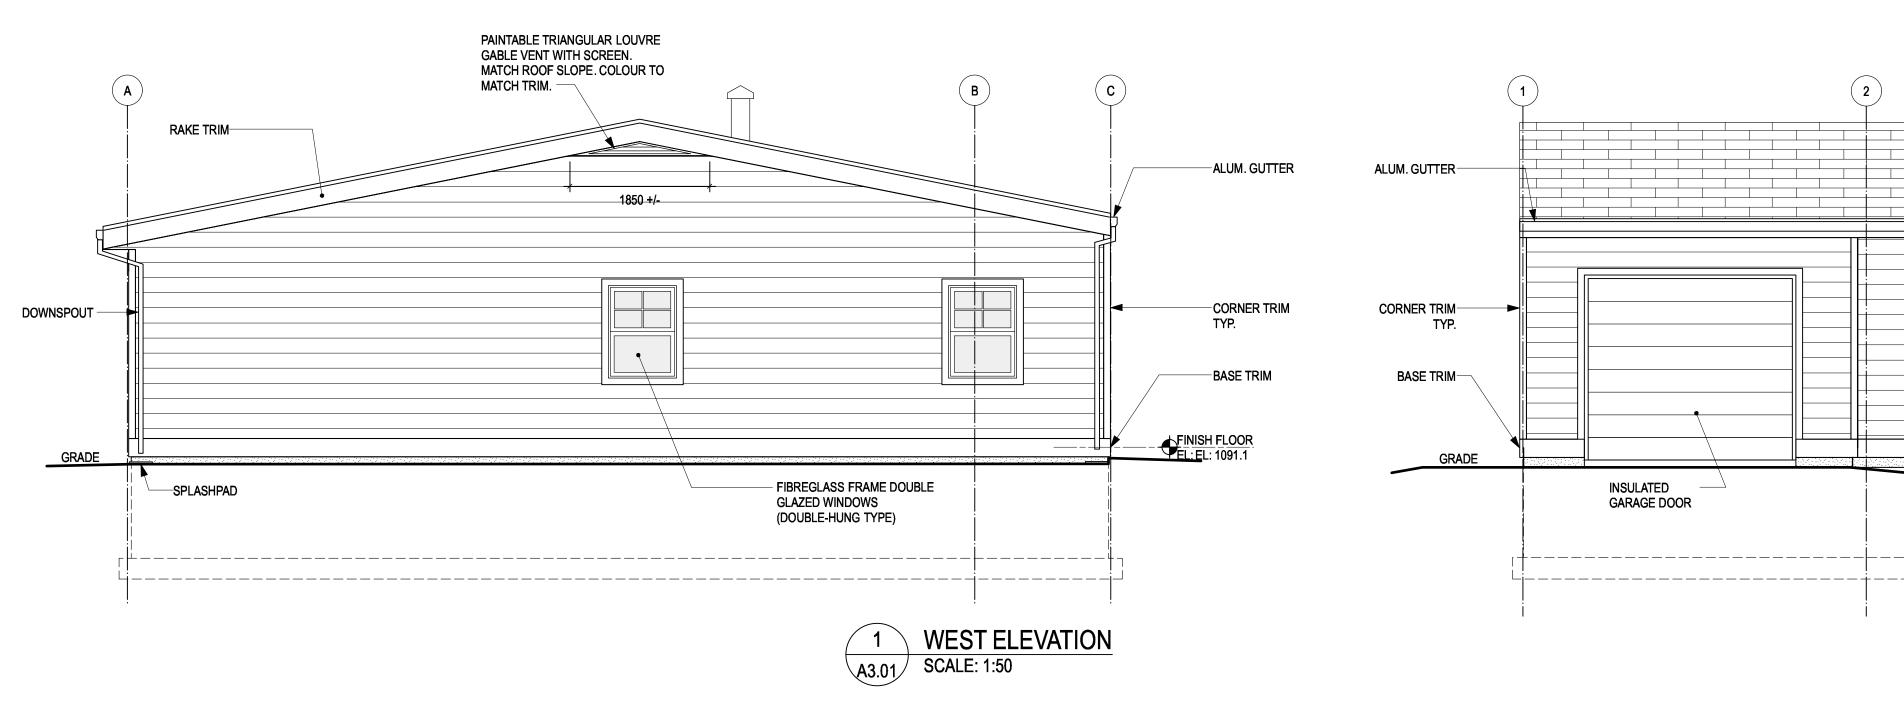

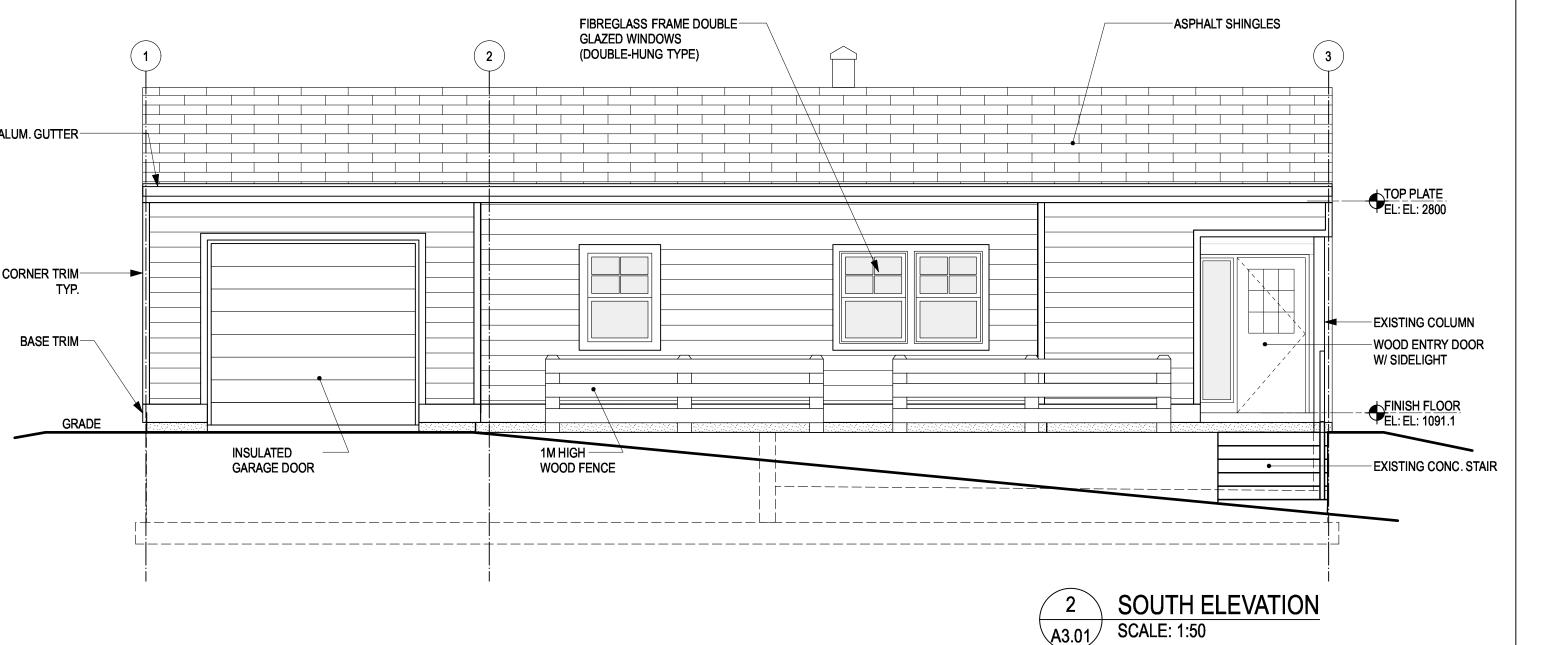

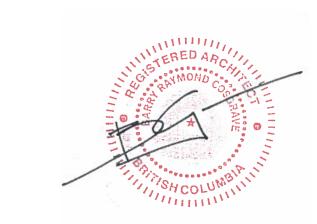

ALUM.— GUTTER	ASPHALT SHINGLES  1	
CORNER TRIM— TYP. BASE TRIM— TYP.		FIBREGLASS FRAME DOUBLE GLAZED WINDOWS (DOUBLE-HUNG TYPE)  FINISH FLOOR EL: 0000mm
-	INSULATED REAR DOOR  3 EAST ELEVATION A3.01 SCALE: 1:50	→ EL: UUUUMM

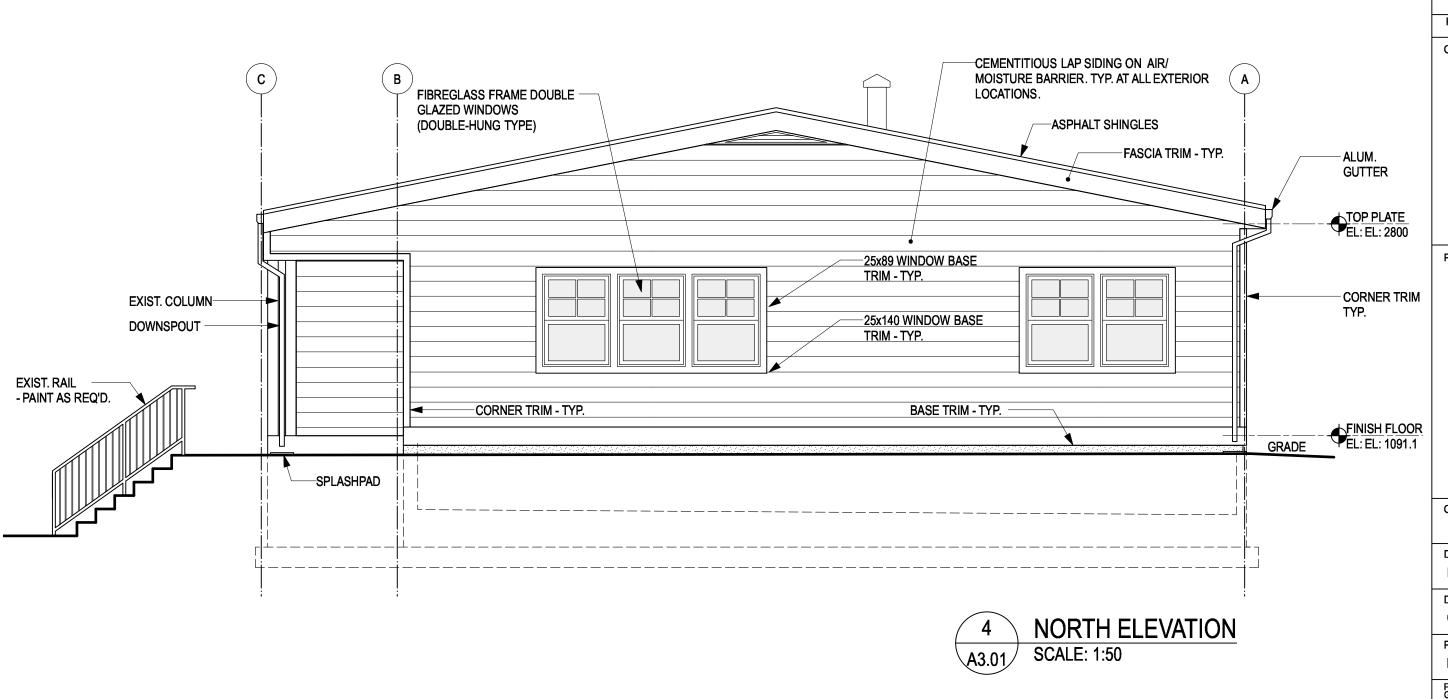

0	ISSUED FOR TENDER	2019 12 09
В	99% REVIEW SUBMISSION	2019 10 25
Α	50% REVIEW SUBMISSION	2019 09 13
Revision/ Revision	Description/Description	Date/Date
Client/client		
	B  A  Revision/ Revision	B 99% REVIEW SUBMISSION  A 50% REVIEW SUBMISSION  Revision/ Description/Description

### RCMP 14200 Green Timbers Way Surrey, B.C.

Project title/Titre du projet

# RCMP ANAHIM LAKE HOUSING RENOVATIONS

Designed by/Concept par
LS

Drawn by/Dessine par
CM

PWGSC Project Manager/Administrateur de Projets TPSGC
Philip Fung

PWGSC, Regional Manager, Architectural and Engineering Services/
Gestionnaire régionale, Services d'architectural et de génie, TPSGC
Preetipal Paul

Drawing title/Titre du dessin


ELEVATIONS


Project No./No. du projet


R.103948.001


A3.01

A3.01

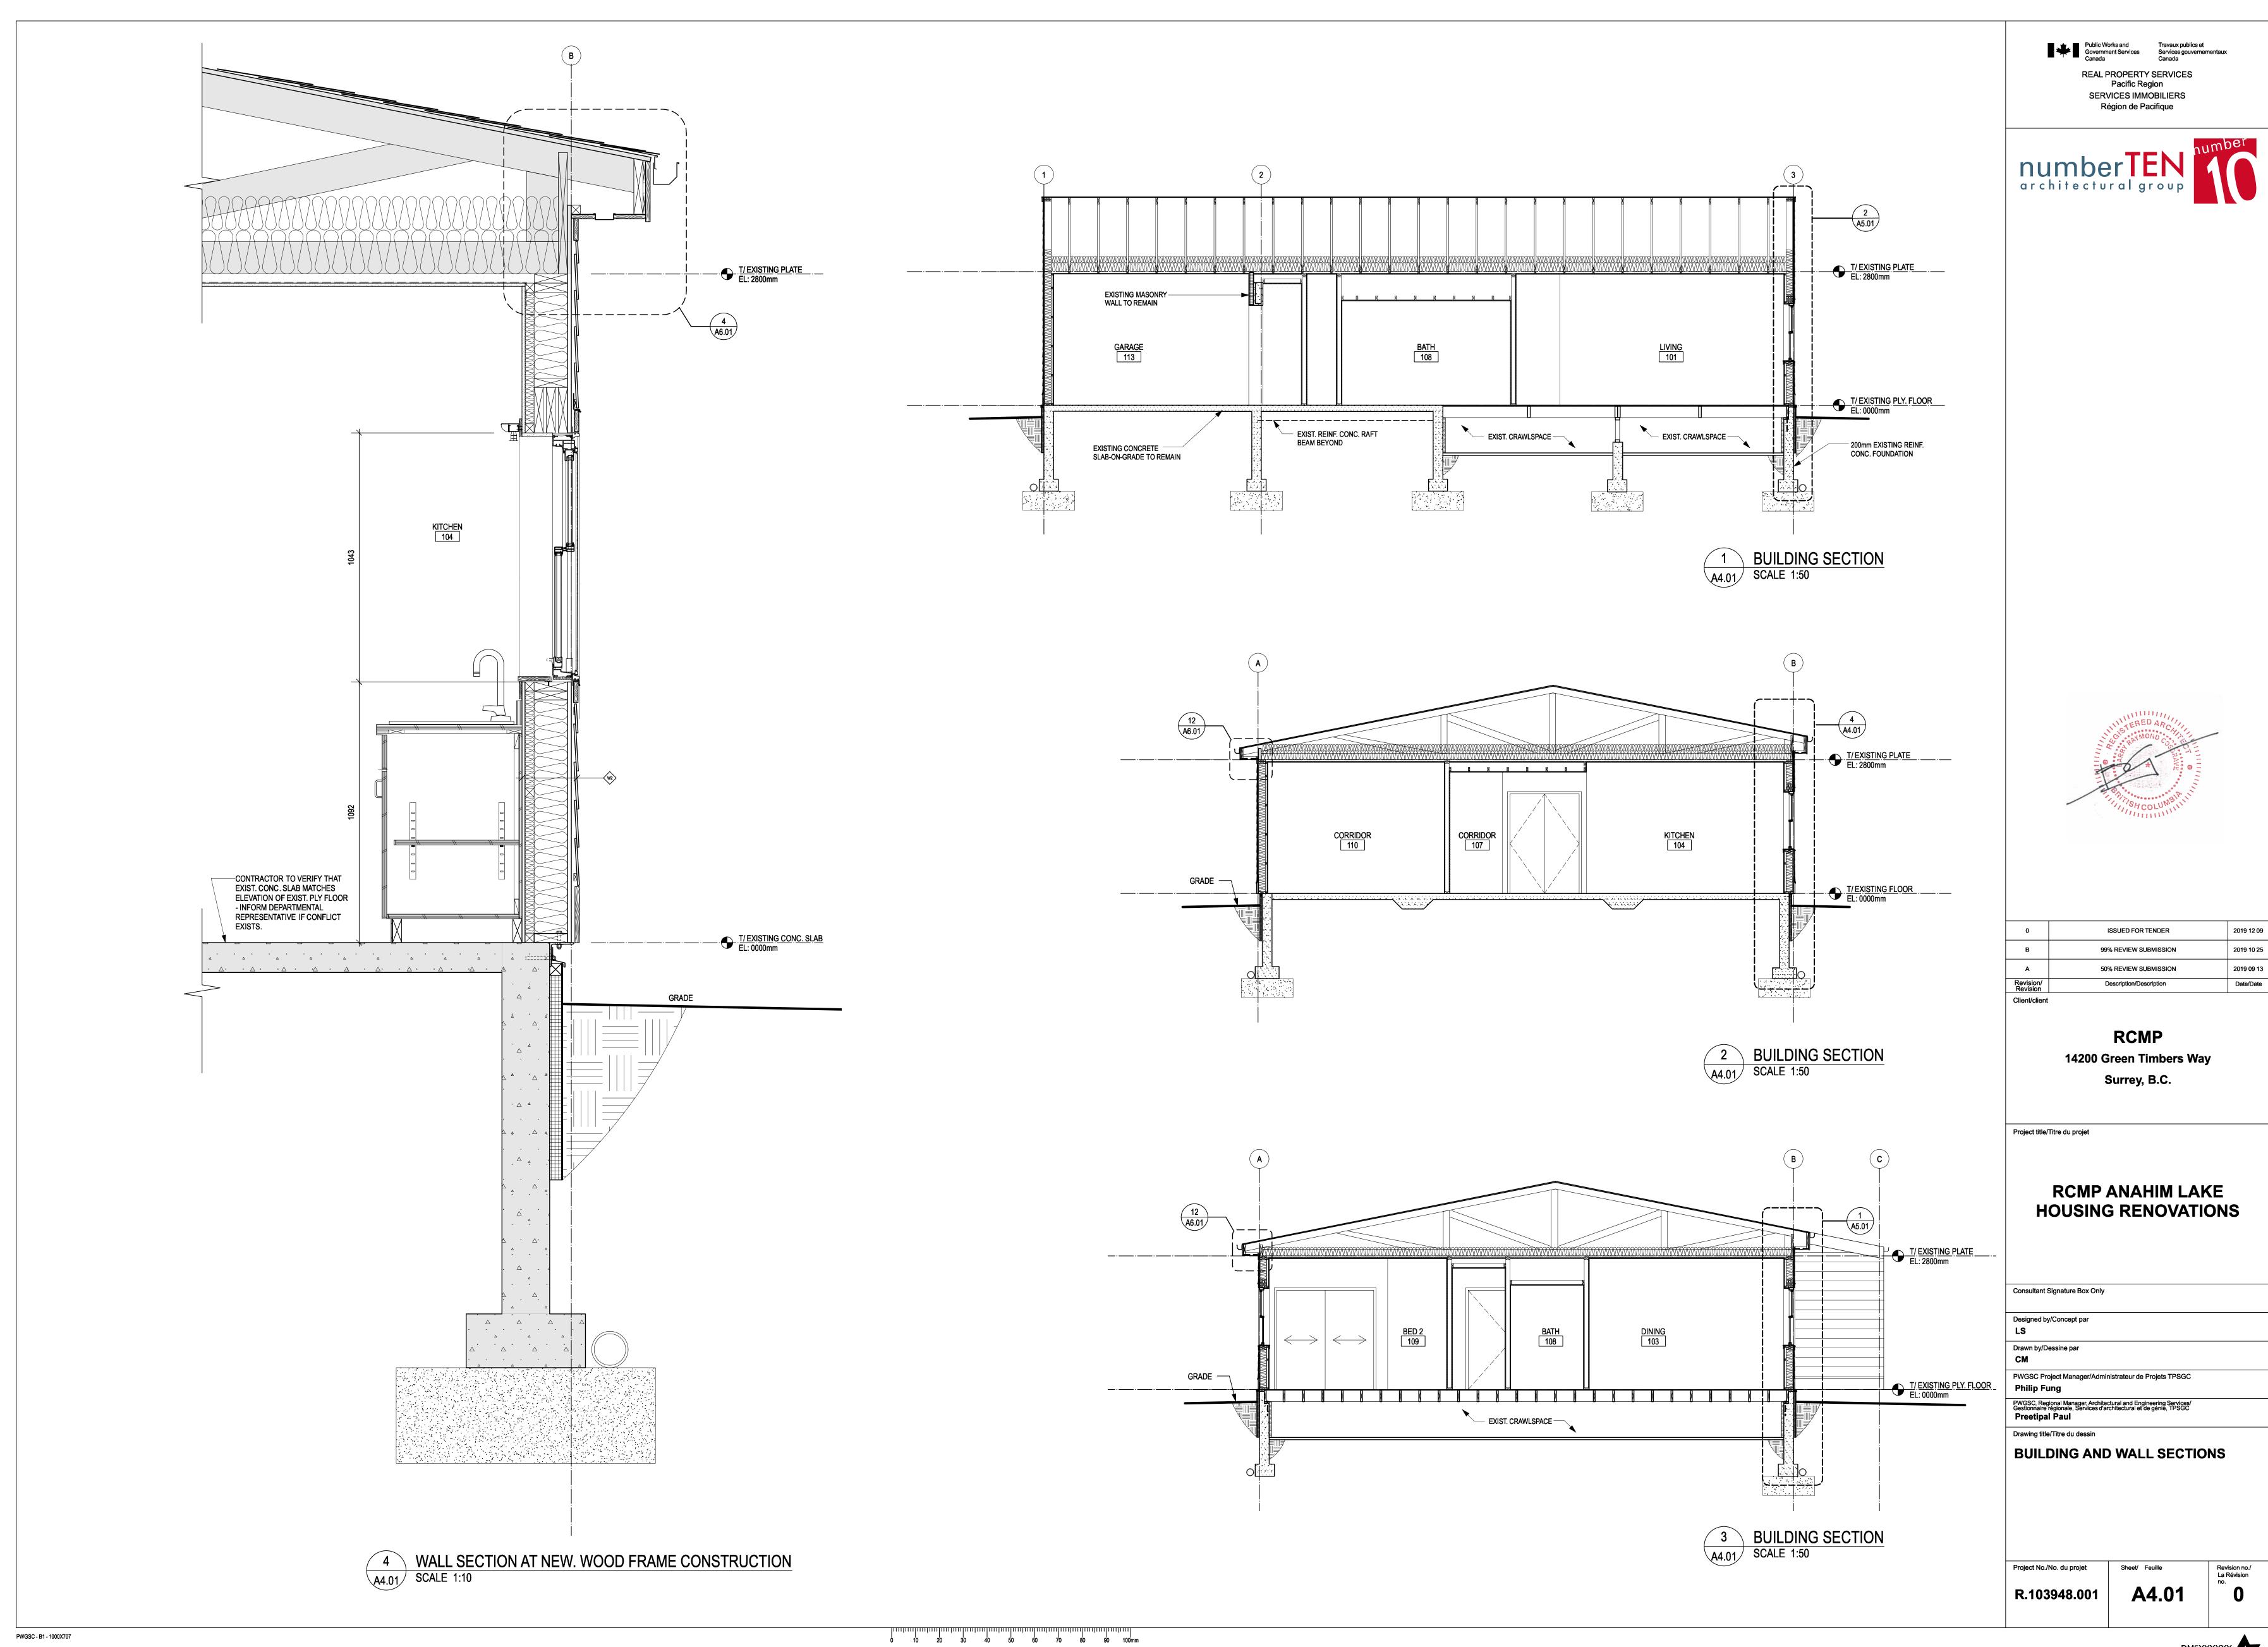


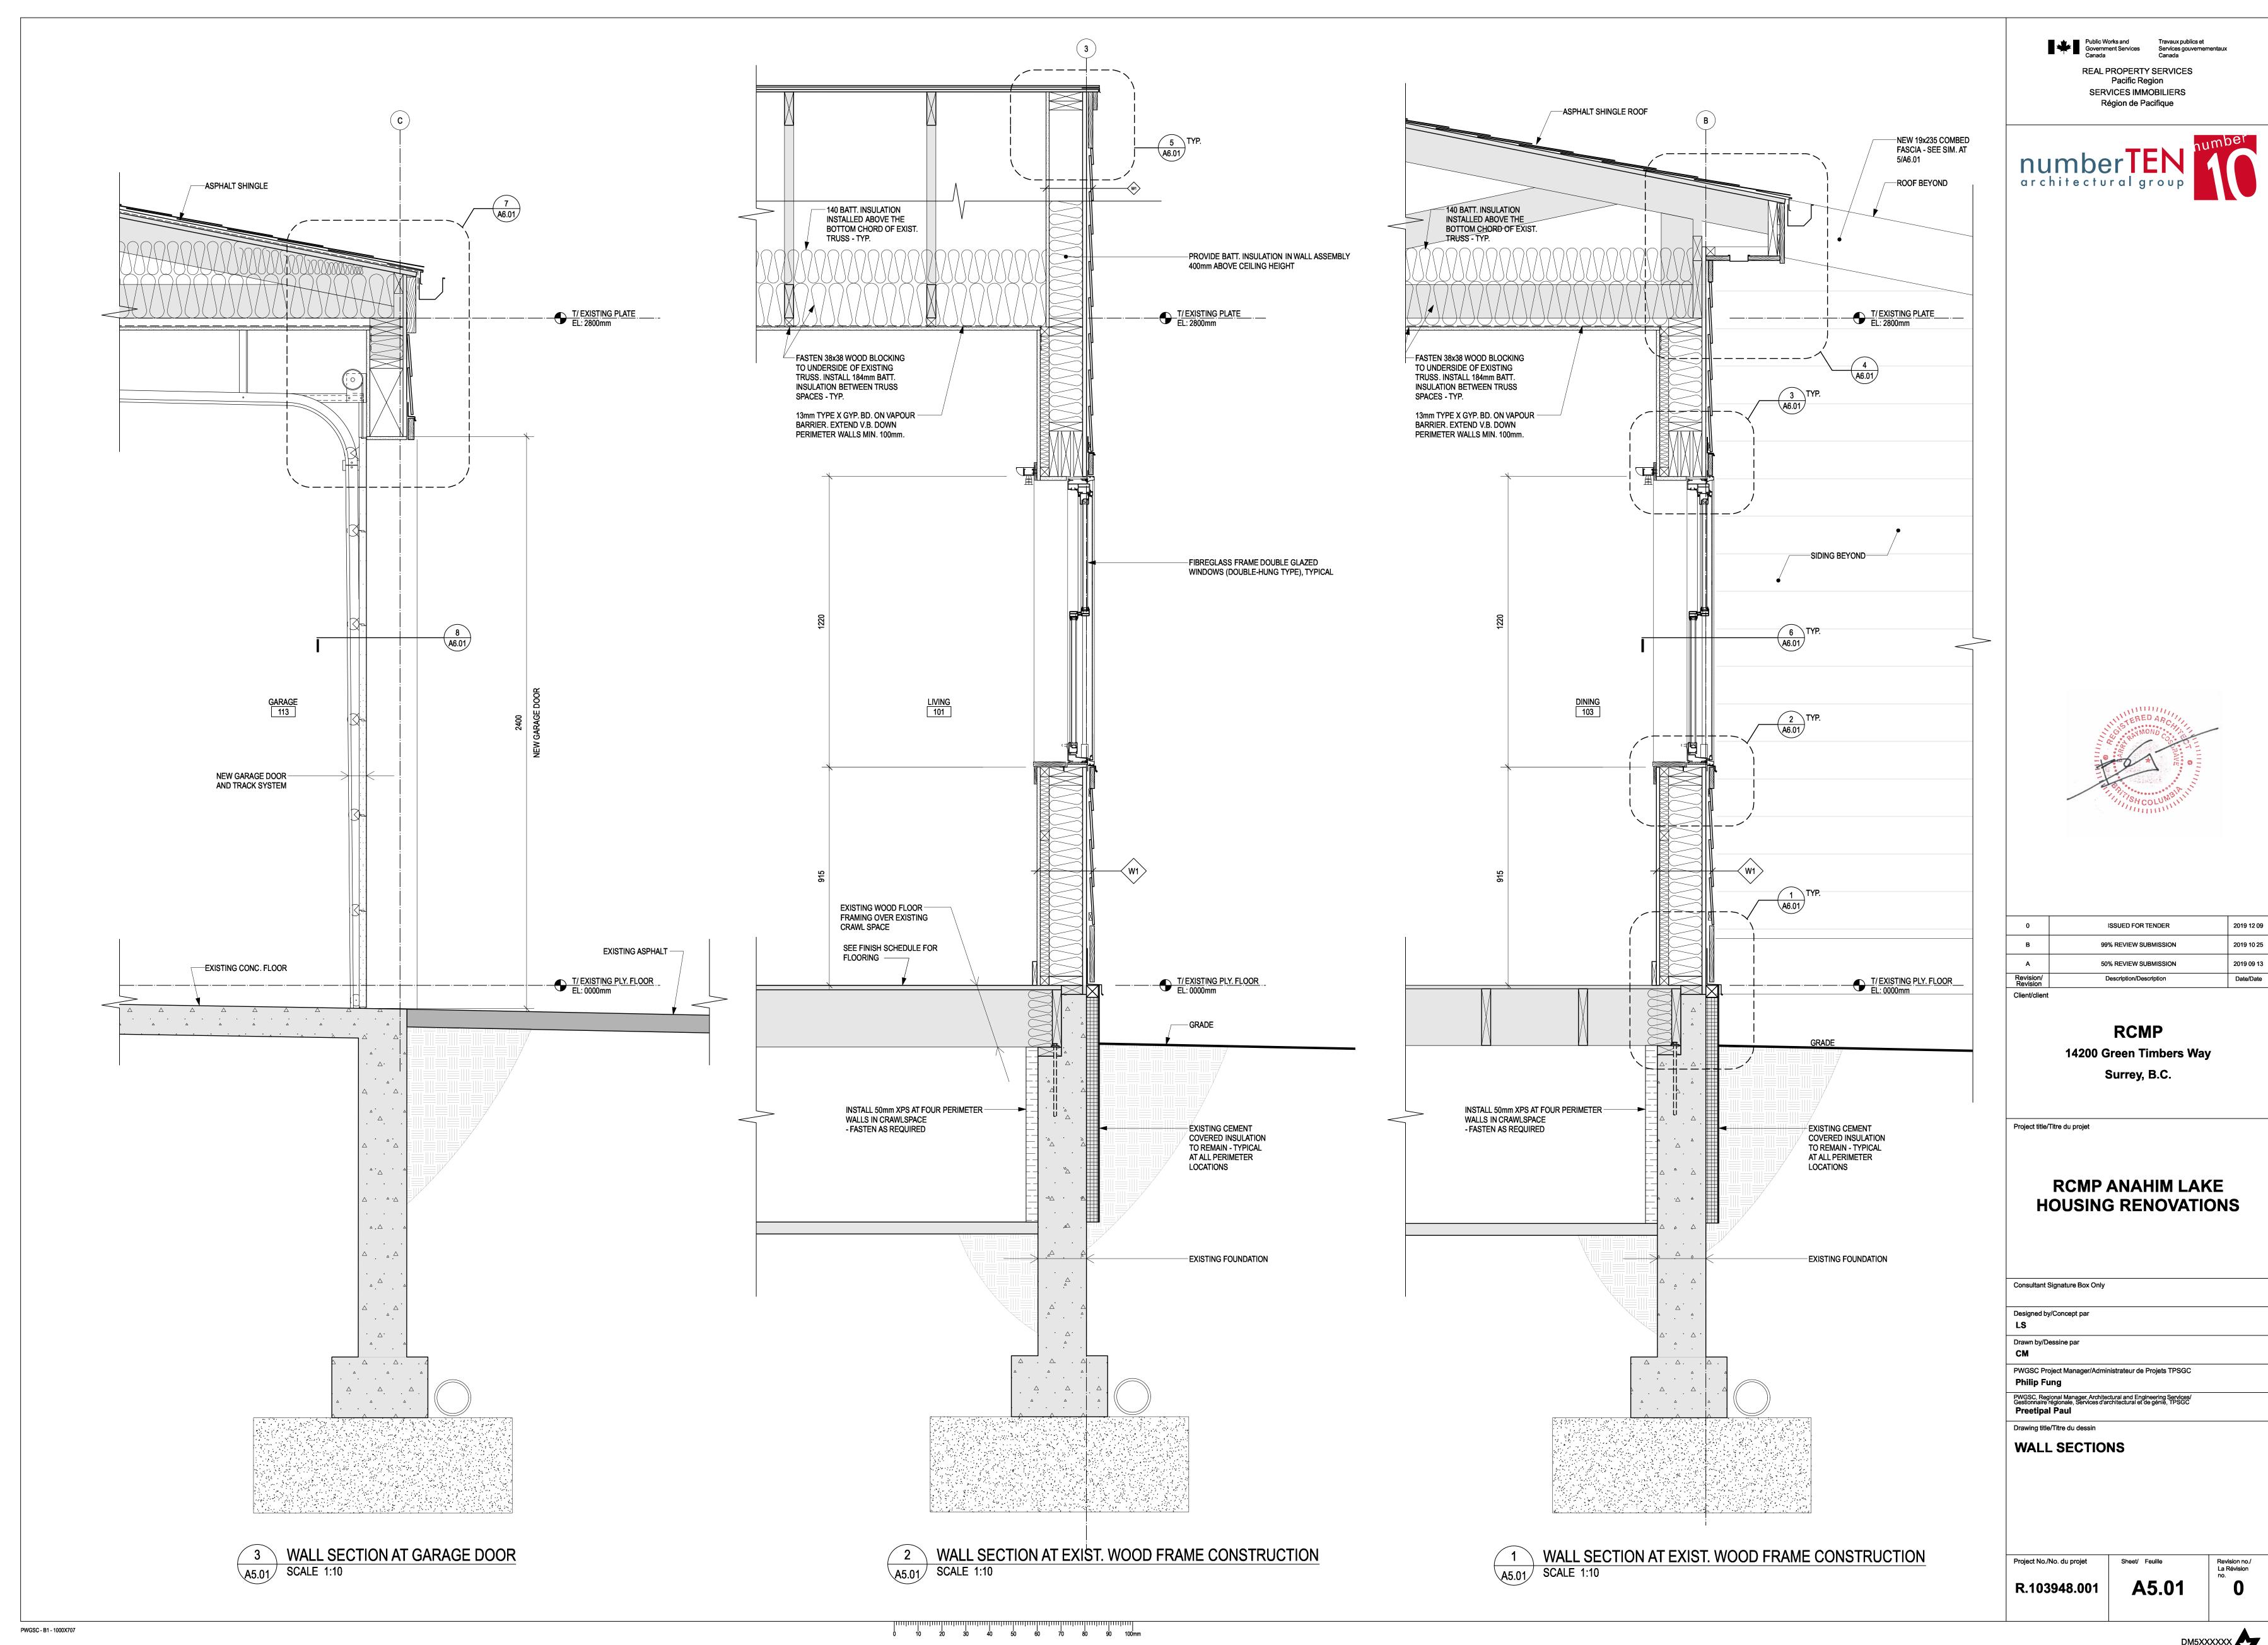


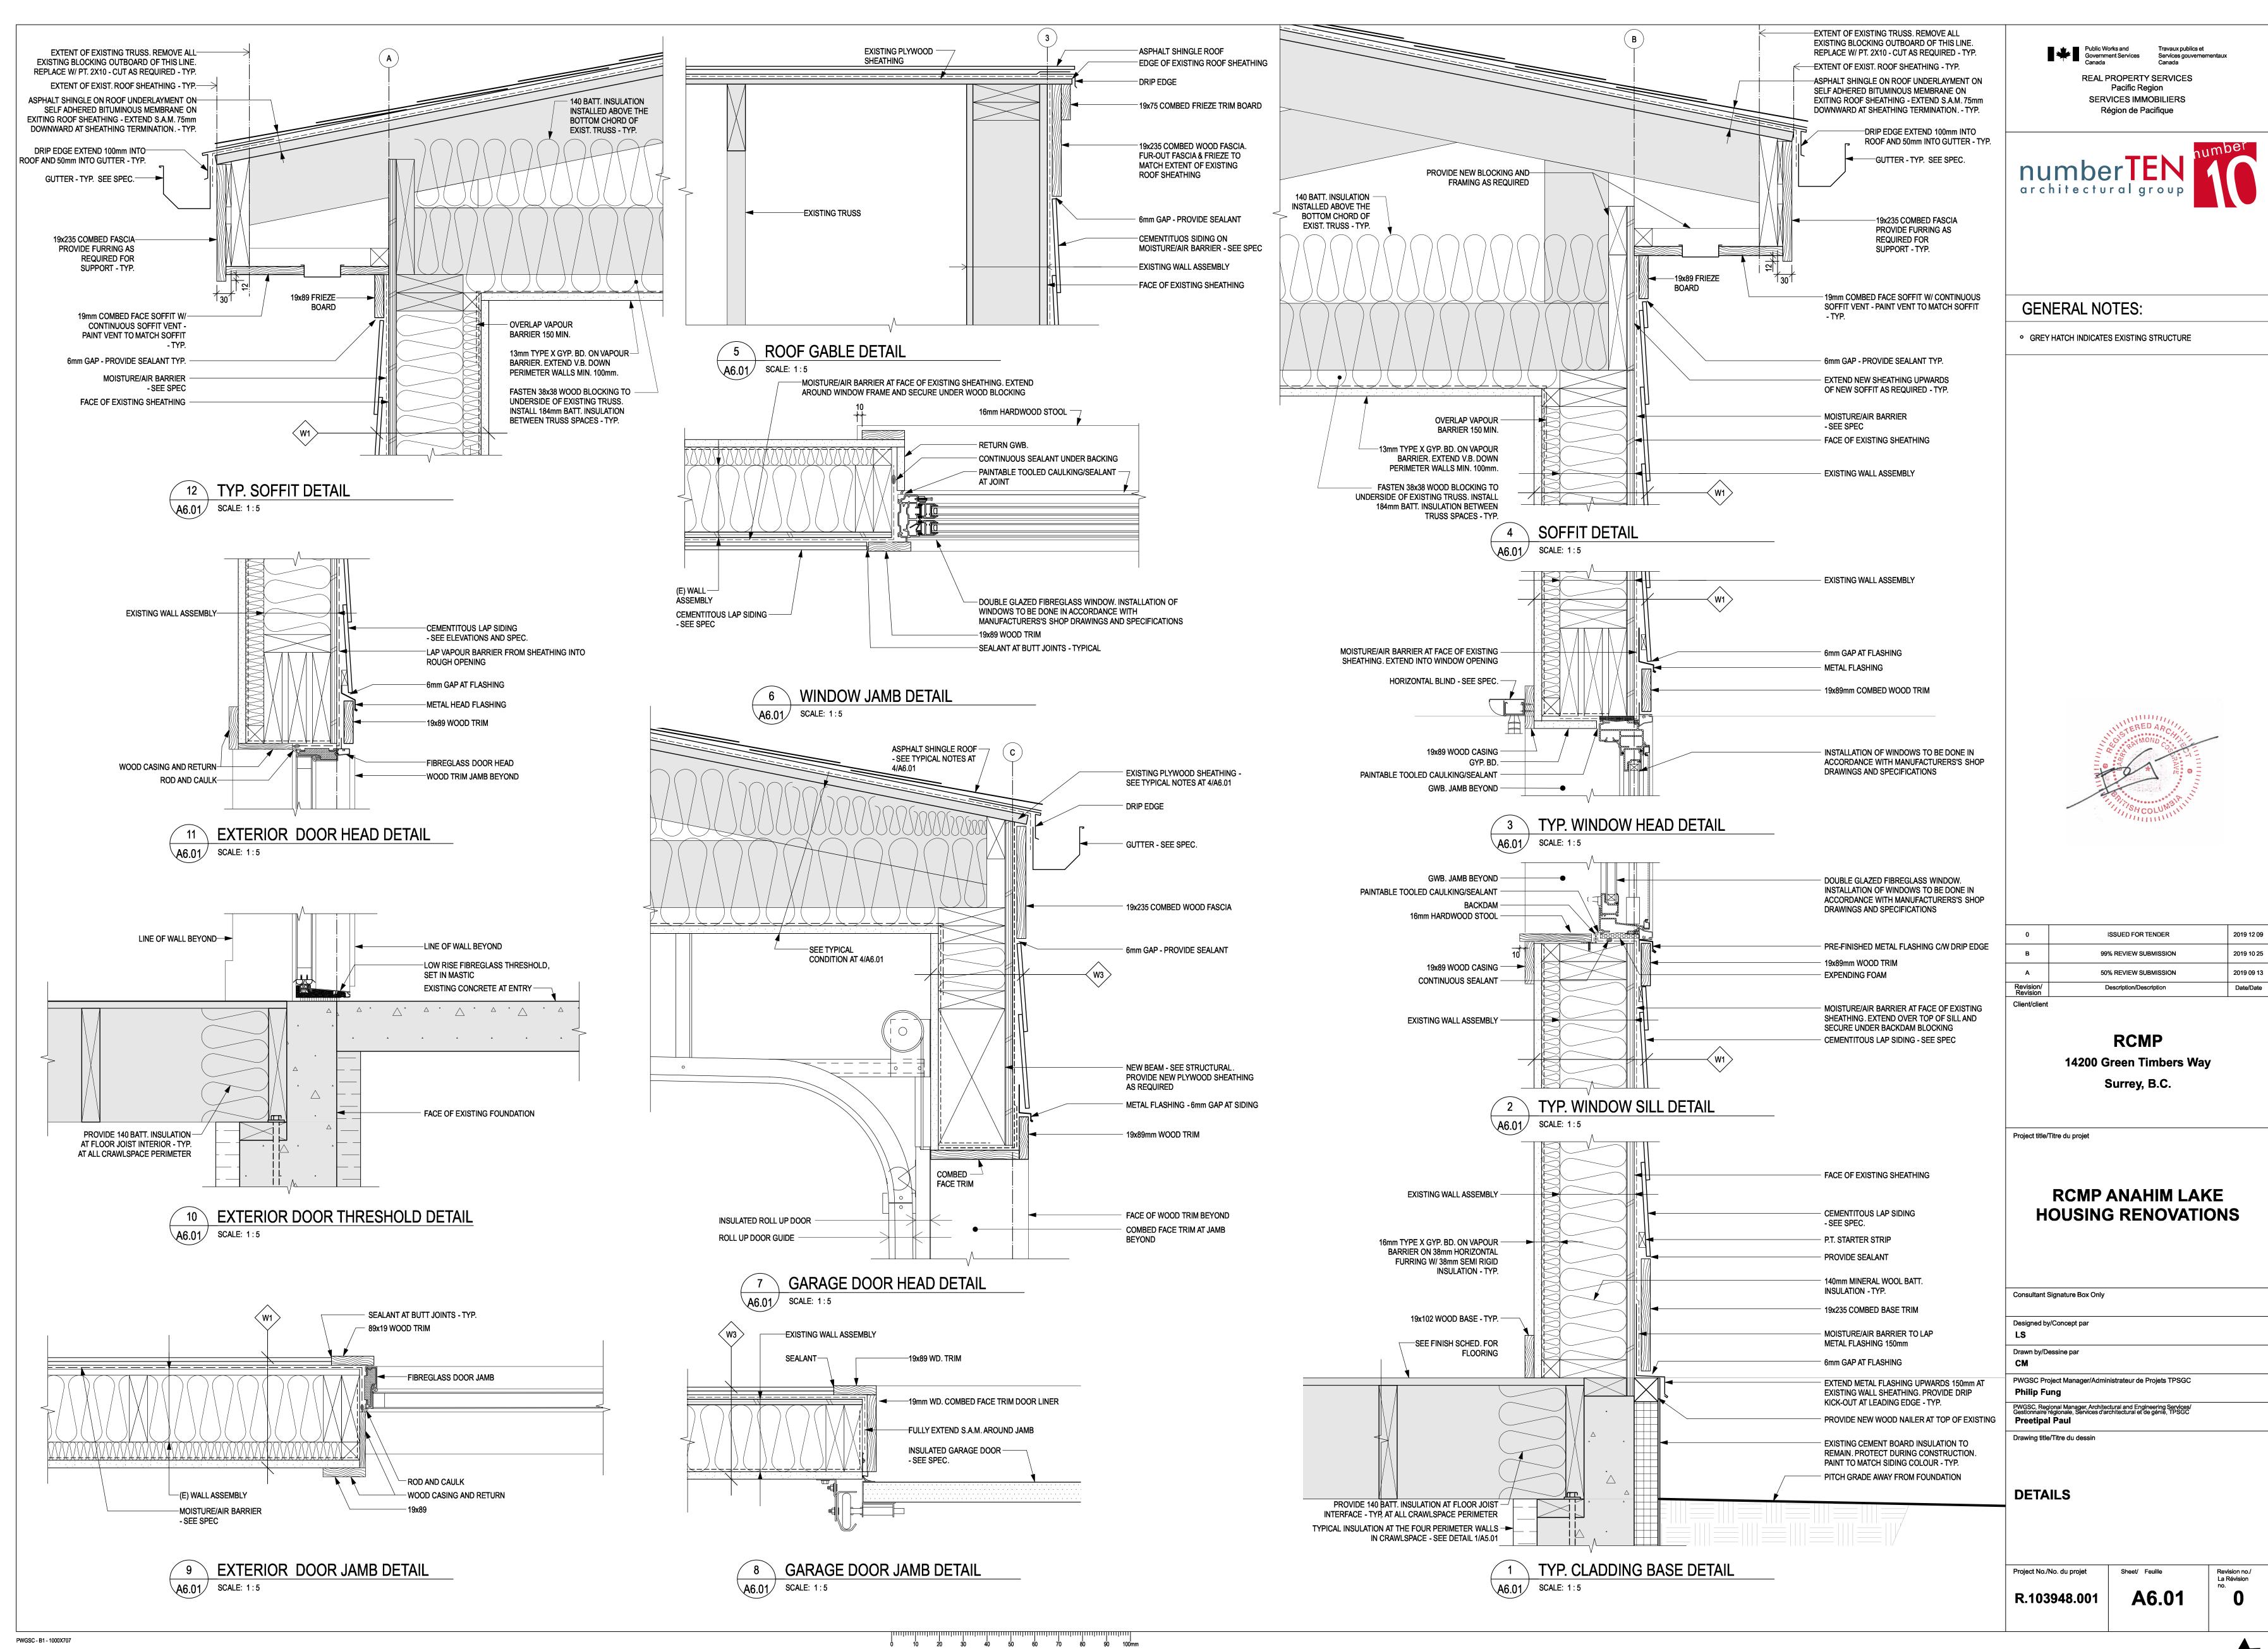

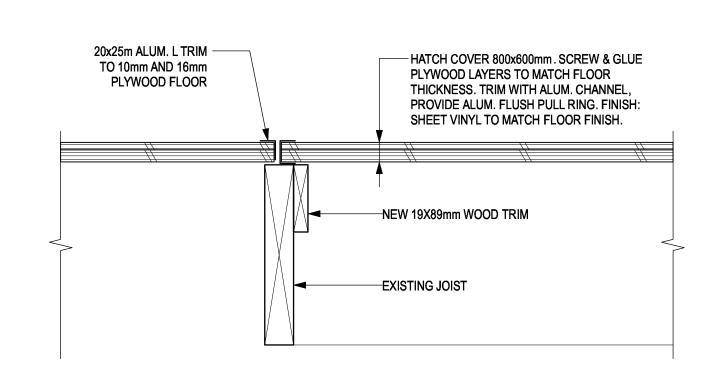




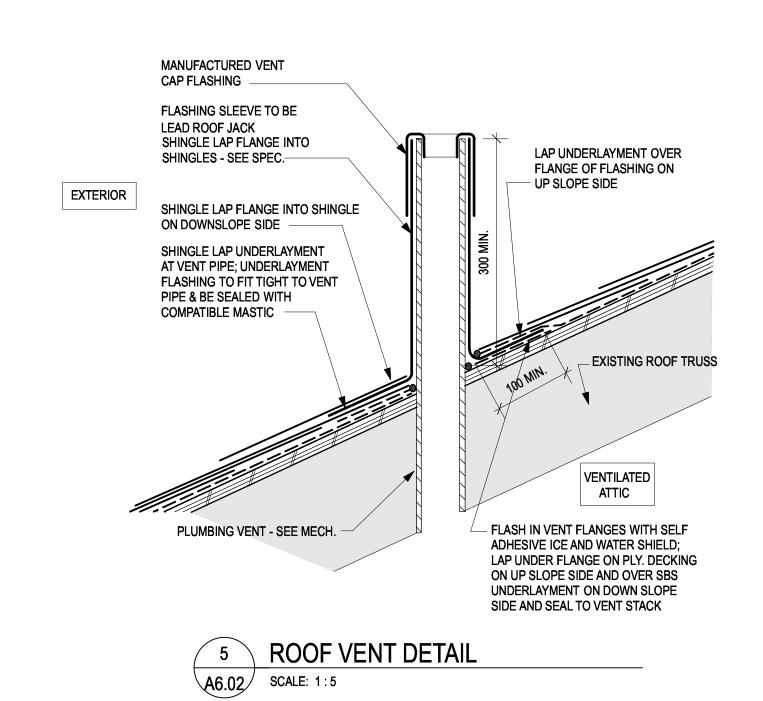


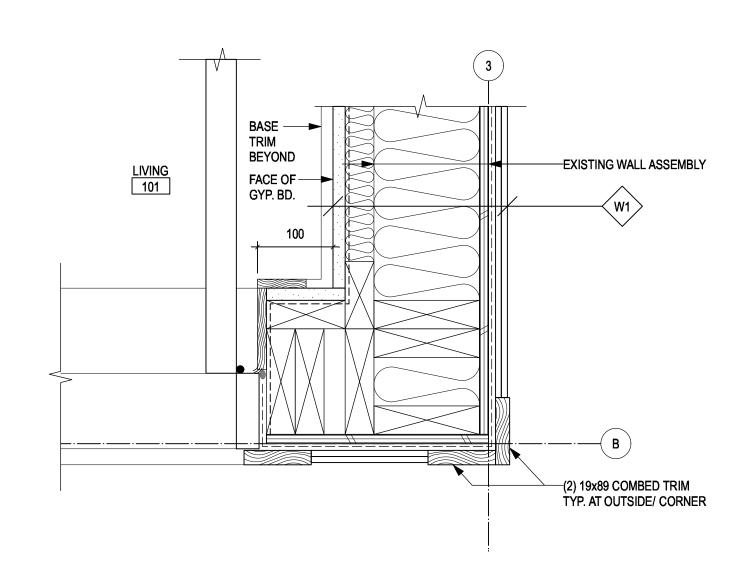



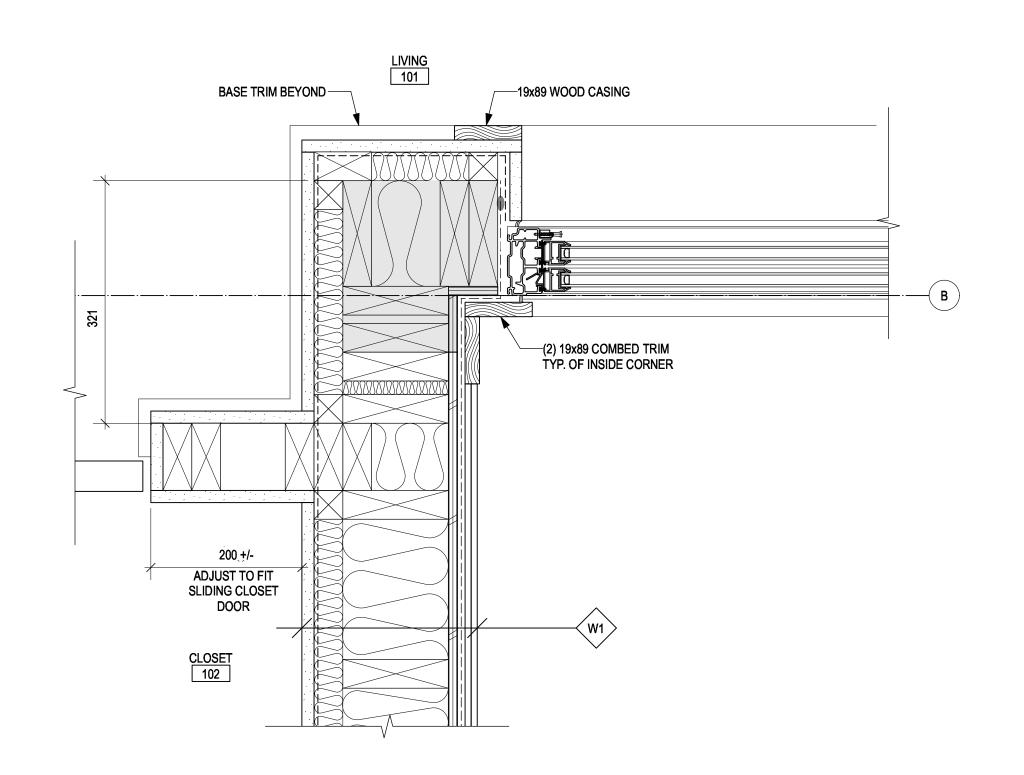




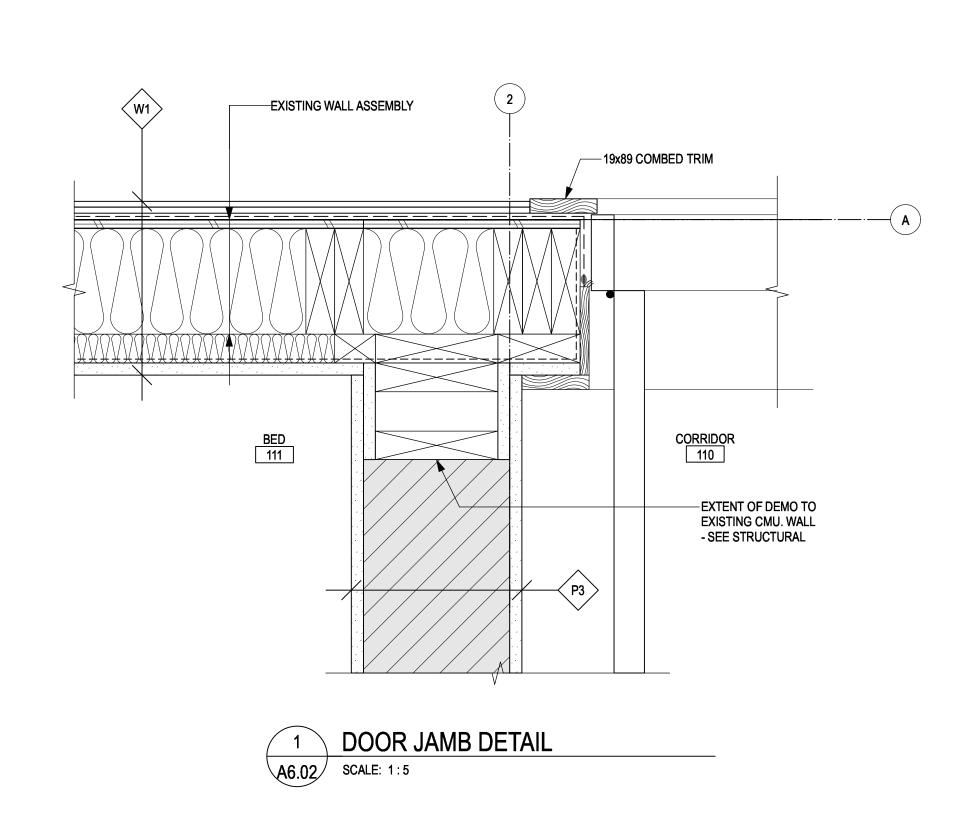





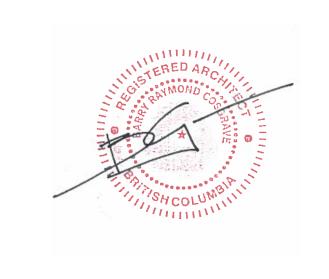

0	ISSUED FOR TENDER	2019 12 09
В	99% REVIEW SUBMISSION	2019 10 25
Α	50% REVIEW SUBMISSION	2019 09 13
Revision/ Revision	Description/Description	Date/Date
Client/client		

### **RCMP** 14200 Green Timbers Way Surrey, B.C.


Project title/Titre du projet

Consultant Signature Box Only

### RCMP ANAHIM LAKE **HOUSING RENOVATIONS**


PWGSC Project Manager/Administrateur de Projets TPSGC  Philip Fung  PWGSC, Regional Manager, Architectural and Engineering Services/ Sestionnaire régionale, Services d'architectural et de génie, TPSGC  Preetipal Paul	LS	
Philip Fung  PWGSC, Regional Manager, Architectural and Engineering Services/ Gestionnaire régionale, Services d'architectural et de génie, TPSGC  Preetipal Paul	Drawn by/Dessine par CM	
PWGSC, Regional Manager, Architectural and Engineering Services/ Sestionnaire régionale, Services d'architectural et de génie, TPSGC Preetipal Paul	WGSC Project Manager/Administrateur de Projets TPSGC	
Preetipal Paul	Philip Fung	
Drawing title/Titre du dessin	Prawing title/Titre du dessin	
	DETAILS	


Project No./No. du projet	Sheet/ Feuille
P 103048 001	L AR NO

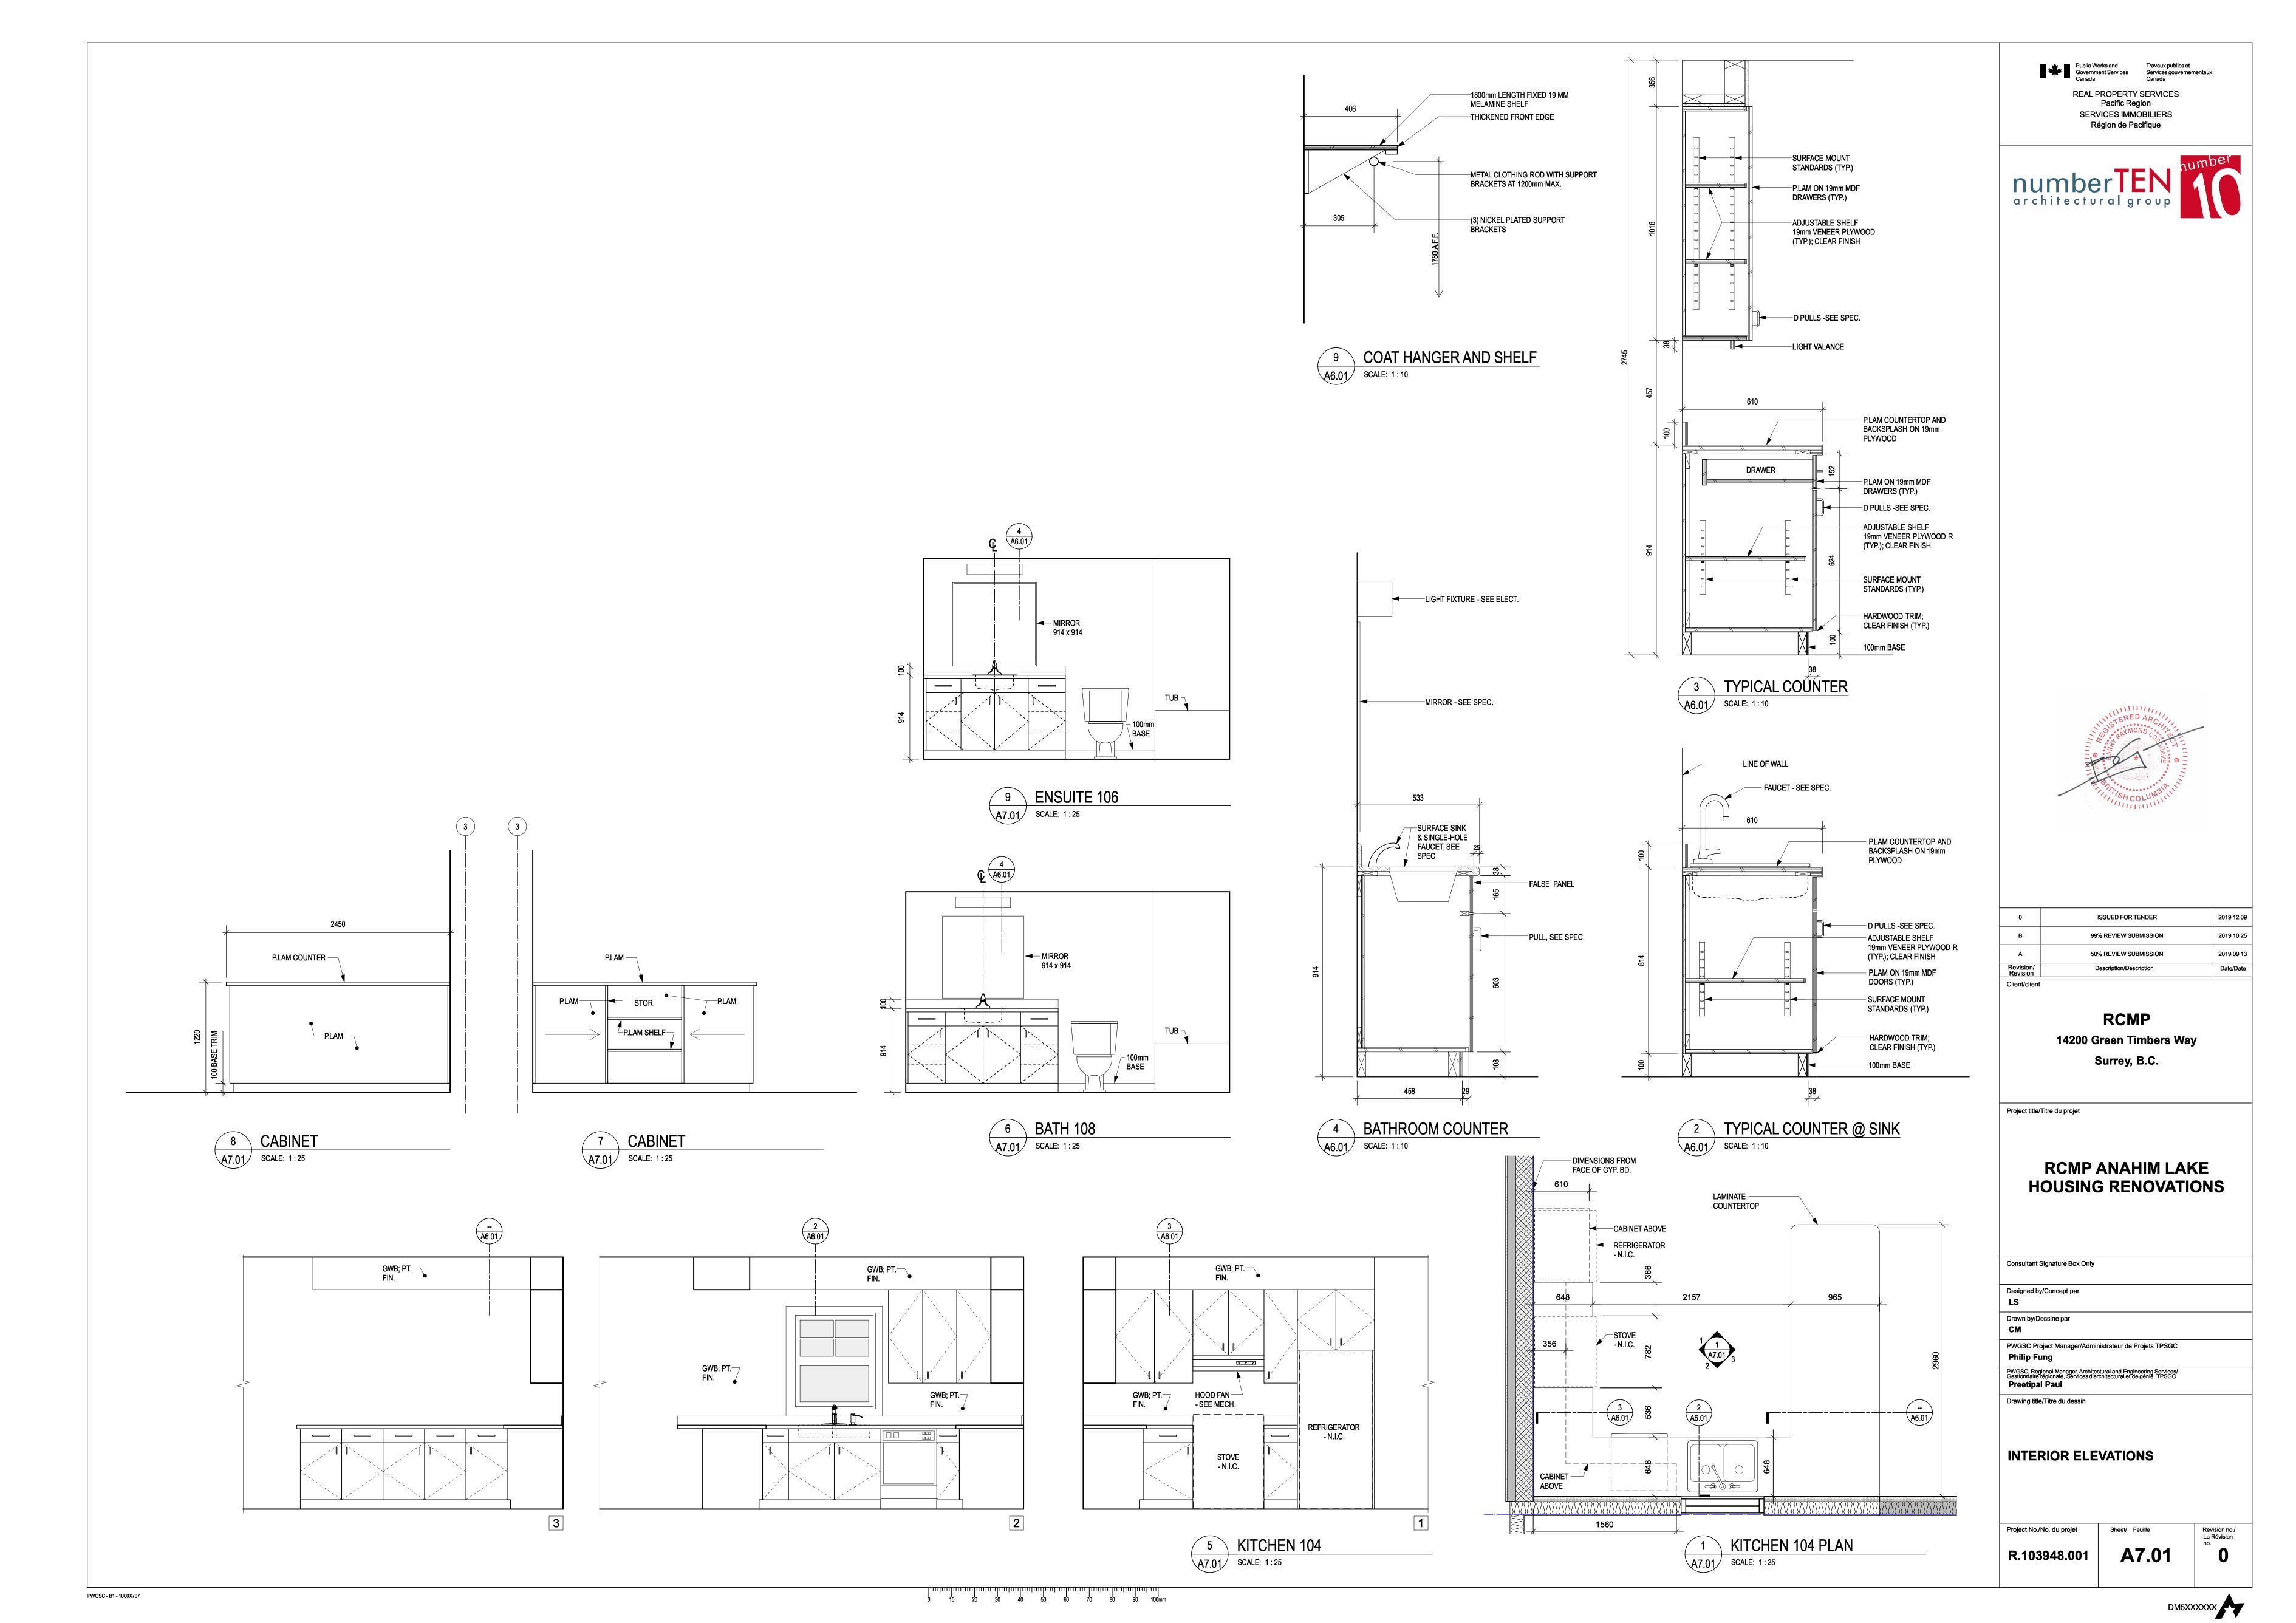


Public Works and Government Services Services gouvernementaux Canada REAL PROPERTY SERVICES Pacific Region SERVICES IMMOBILIERS Région de Pacifique



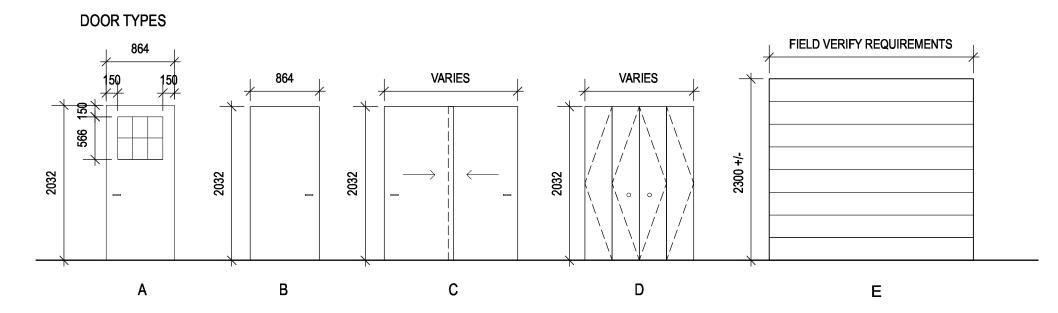

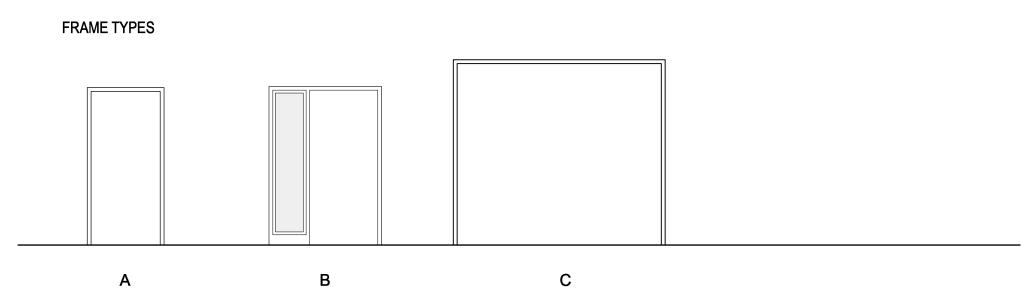

EXTE	RIOR WINDOW SO	CHEDU	LE				
WINDO	W						
NUM.	R.O. SIZE (W x H)	TYPE	FRAME MAT'L	GLAZING	FINISH	COLOUR	REMARKS
101	813x1043 mm	D	FIBREGLASS	D.G.	T.B.D.	WHITE	
102	1702x1220 mm	В	FIBREGLASS	D.G.	T.B.D.	WHITE	
103	2591x1220 mm	С	FIBREGLASS	D.G.	T.B.D.	WHITE	
104	1702x1220 mm	В	FIBREGLASS	D.G.	T.B.D.	WHITE	
105	813x1220 mm	Α	FIBREGLASS	D.G.	T.B.D.	WHITE	
106	1702x1220 mm	В	FIBREGLASS	D.G.	T.B.D.	WHITE	
107	1702x1220 mm	В	FIBREGLASS	D.G.	T.B.D.	WHITE	
108	813x1220 mm	Α	FIBREGLASS	D.G.	T.B.D.	WHITE	
109	813x1220 mm	Α	FIBREGLASS	D.G.	T.B.D.	WHITE	

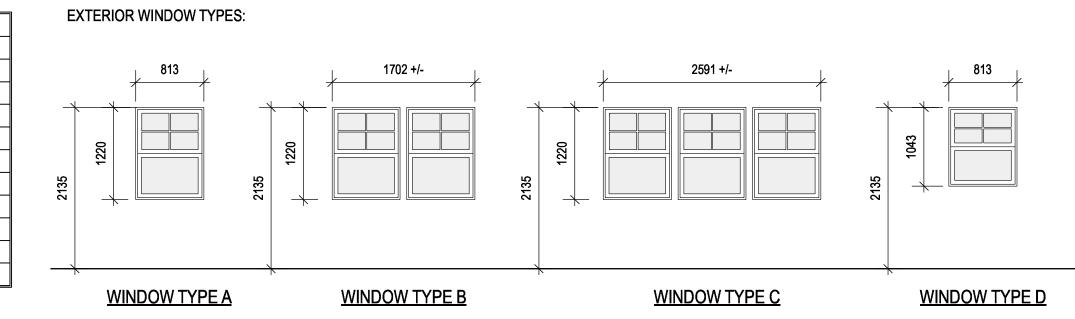

F.G. = FIBREGLASS WD. = WOOD P.F. = PRE-FINISHED T.B.D. = FROM MANUFACTURERS STANDARD RANGE

OPEN	NING		DOOR								FRAME					REMARKS
NUM.	FROM	то	SIZE (W x H x THICK)	HDWR	TYPE	MAT'L	CORE	FINISH	COLOR	GLAZ.	MAT'L	TYPE	FINISH	COLOR	GLAZ.	
101	LIVING	EXTERIOR	864 x 2030 x 44	1	Α	F.G.	INSUL.	PAINT		D.G.	F.G.	В	PAINT	-	DG.	KEYED ACCESS
102	LIVING	CLOSET 102	1524 x 2030 x 44	3	С	WD.	-	P.F.	-	-	-	-	-	-	-	BOX TRACK - SEE SPEC.
105	CORRIDOR 107	MASTER BED 105	864 x 2030 x 44	2	В	WD.	-	P.F.	-	-	WD.	Α	PAINT	-	-	-
105a	MASTER BED 105	CLOSET	2438 x 2030 x 44	3	С	WD.	-	P.F.	-	-	-	-	-	-	-	BOX TRACK - SEE SPEC.
106	MASTER BED 105	ENSUITE 106	864 x 2030 x 44	2	В	WD.	-	P.F.	-	-	WD.	Α	PAINT	-	-	-
107a	CORRIDOR 107	CLOSET	1219 x 2030 x 44	4	D	WD.	-	PAINT	-	-	-	-	-	-	-	STEEL TRACK - SEE SPEC.
107	CORRIDOR 107	LAUNDRY	1016 x 2030 x 44	4	D	WD.	-	PAINT	-	-	-	-	-	-	-	STEELTRACK - SEE SPEC.
108	CORRIDOR 107	BATH 108	864 x 2030 x 44	2	В	WD.	-	P.F.	-	-	WD.	Α	PAINT	-	-	-
109	CORRIDOR 107	BATH 108	864 x 2030 x 44	2	В	WD.	-	P.F.	-	-	WD.	Α	PAINT	-	-	-
109a	BED 2	CLOSET	2438 x 2030 x 44	3	С	WD.	-	P.F.	-	-	WD.	Α	PAINT	-	-	BOX TRACK - SEE SPEC.
110	CORRIDOR 110	EXTERIOR	864 x 2030 x 44	1	Α	F.G.	INSUL.	PAINT	-	D.G.	F.G.	Α	PAINT	-	DG.	KEY ACCESS
110a	CORRIDOR 107	CORRIDOR 110	864 x 2030 x 44	2	В	WD.	-	PF.	-	-	WD.	Α	PAINT	-	-	-
111	CORRIDOR 107	BED 111	864 x 2030 x 44	2	В	WD.	-	PF.		-	WD.	Α	PAINT	-	-	-
111a	BED 111	CLOSET	1829 x 2030 x 44	3	С	WD.	-	PF.	-	-	-	-	-	-	-	-
112	BED 111	MECH. 112	762 x 2030 x 44	2	В	WD.	_	PF.	-	-	WD.	Α	PAINT	-	-	-
113	KITCHEN 104	GARAGE 113	864 x 2030 x 44	1	В	F.G.	-	PAINT	-	-	F.G.	Α	PAINT	-	-	-
114	EXTERIOR	GARAGE 113	2700+/- x 2300+/-		Е		INSUL.	PAINT		-	_	-	-	- 1	-	FIELD VERIFY EXISTING OPENING

FINISH	SCHEDULE																					
		FLOOR		BASE			CEILING			NORTH WALL			EAST WALL			SOUTH WALL			WEST WALL			
NUM.	ROOM NAME	FINISH	COLOUR	MATERIAL	SIZE	COLOUR	MATERIAL	FINISH	COLOUR	MATERIAL	FINISH	COLOUR	MATERIAL	FINISH	COLOUR	MATERIAL	FINISH	COLOUR	MATERIAL	FINISH	COLOUR	REMARKS
101	LIVING	VINYL PLANK	T.B.D.	T.B.D.	100mm	T.B.D.	G.W.B.	PAINT	T.B.D.	GWB.	PAINT	T.B.D.	GWB.	PAINT	T.B.D.	GWB.	PAINT	T.B.D.	GWB.	PAINT	T.B.D.	-
102	CLOSET	VINYL PLANK	T.B.D.	T.B.D.	100mm	T.B.D.	G.W.B.	PAINT	T.B.D.	GWB.	PAINT	T.B.D.	GWB.	PAINT	T.B.D.	GWB.	PAINT	T.B.D.	GWB.	PAINT	T.B.D.	
103	DINING	VINYL PLANK	T.B.D.	T.B.D.	100mm	T.B.D.	G.W.B.	PAINT	T.B.D.	GWB.	PAINT	T.B.D.	-	-	T.B.D.	GWB.	PAINT	T.B.D.	-	•	T.B.D.	
104	KITCHEN	VINYL PLANK	T.B.D.	T.B.D.	100mm	T.B.D.	G.W.B.	PAINT	T.B.D.	GWB.	PAINT	T.B.D.	-	-	T.B.D.	GWB.	PAINT	T.B.D.	GWB.	PAINT	T.B.D.	
105	MASTER BED	VINYL PLANK	T.B.D.	T.B.D.	100mm	T.B.D.	G.W.B.	PAINT	T.B.D.	GWB.	PAINT	T.B.D.	GWB.	PAINT	T.B.D.	GWB.	PAINT	T.B.D.	GWB.	PAINT	T.B.D.	
106	ENSUITE	SHEET PLANK	T.B.D.	T.B.D.	100mm	T.B.D.	G.W.B.	PAINT	T.B.D.	GWB.	PAINT	T.B.D.	GWB.	PAINT	T.B.D.	GWB.	PAINT	T.B.D.	GWB.	PAINT	T.B.D.	PROVIDE TRANSITION STRIPS AS PER 11
107	CORRIDOR	SHEET PLANK	T.B.D.	T.B.D.	100mm	T.B.D.	G.W.B.	PAINT	T.B.D.	GWB.	PAINT	T.B.D.	GWB.	PAINT	T.B.D.	GWB.	PAINT	T.B.D.	GWB.	PAINT	T.B.D.	PROVIDE TRANSITION STRIPS AS PER 11
108	BATH	SHEET PLANK	T.B.D.	T.B.D.	100mm	T.B.D.	G.W.B.	PAINT	T.B.D.	GWB.	PAINT	T.B.D.	GWB.	PAINT	T.B.D.	GWB.	PAINT	T.B.D.	GWB.	PAINT	T.B.D.	PROVIDE TRANSITION STRIPS AS PER 11
109	BED 2	VINYL PLANK	T.B.D.	T.B.D.	100mm	T.B.D.	G.W.B.	PAINT	T.B.D.	GWB.	PAINT	T.B.D.	GWB.	PAINT	T.B.D.	GWB.	PAINT	T.B.D.	GWB.	PAINT	T.B.D.	
110	CORRIDOR	VINYL PLANK	T.B.D.	T.B.D.	100mm	T.B.D.	G.W.B.	PAINT	T.B.D.	GWB.	PAINT	T.B.D.	GWB.	PAINT	T.B.D.	GWB.	PAINT	T.B.D.	GWB.	PAINT	T.B.D.	
111	BEDROOM	VINYL PLANK	T.B.D.	T.B.D.	100mm	T.B.D.	G.W.B.	PAINT	T.B.D.	GWB.	PAINT	T.B.D.	GWB.	PAINT	T.B.D.	GWB.	PAINT	T.B.D.	GWB.	PAINT	T.B.D.	
112	MECH.	VINYL PLANK	T.B.D.	T.B.D.	100mm	T.B.D.	G.W.B.	PAINT	T.B.D.	GWB.	PAINT	T.B.D.	GWB.	PAINT	T.B.D.	GWB.	PAINT	T.B.D.	GWB.	PAINT	T.B.D.	
113	GARAGE	CONC.	T.B.D.	T.B.D.	100mm	T.B.D.	G.W.B.	PAINT	T.B.D.	GWB.	PAINT	T.B.D.	GWB.	PAINT	T.B.D.	GWB.	PAINT	T.B.D.	GWB.	PAINT	T.B.D.	



0	ISSUED FOR TENDER	2019 12 0
В	99% REVIEW SUBMISSION	2019 10 2
A	50% REVIEW SUBMISSION	2019 09 1
Revision/ Revision	Description/Description	Date/Date

### **RCMP** 14200 Green Timbers Way Surrey, B.C.

Project title/Titre du projet

### RCMP ANAHIM LAKE **HOUSING RENOVATIONS**

Consultant Signature Box Only
Designed by/Concept par
LS

Drawn by/Dessine par	
СМ	
PWGSC Project Manager/Administrateur de Proje	ts TPSGC
Philip Fung	
PWGSC, Regional Manager, Architectural and Engineerin Gestionnaire régionale, Services d'architectural et de gén <b>Preetipal Paul</b>	ng Services/ ie, TPSGC

Drawing title/Titre du dessin

### SCHEDULES

Project No./No. du projet	Sheet/ Feuille
R.103948.001	A8.01

### GENERAL

- THIS IS A METRIC PROJECT. UNLESS OTHERWISE NOTED, ALL DIMENSIONS ARE IN MILLIMETERS AND ALL FORCES ARE IN METRIC UNITS.
- PRIOR TO CONSTRUCTION, REVIEW STRUCTURAL DRAWINGS IN CONJUNCTION WITH DRAWINGS PROVIDED BY ALL OTHER CONSULTANTS. CONFIRM ALL DIMENSIONS, ELEVATIONS AND HEADROOM CLEARANCES, AND COORDINATE ALL OPENINGS, SLEEVES AND EMBEDDED ITEMS.
- REPORT ANY DISCREPANCIES OR CONFLICTS BEFORE PROCEEDING WITH THE
- DO NOT CUT OR DRILL ANY OPENINGS IN STRUCTURAL MEMBERS WITHOUT WRITTEN PERMISSION FROM DEPARTMENTAL REPRESENTATIVE.
- EXISTING STRUCTURAL INFORMATION IS BASED UPON DRAWINGS PREPARED FOR PUBLIC SERVICES AND PROCUREMENT CANADA (PSPC), DATED JANUARY 15, 1983.
- VERIFY EXISTING DIMENSIONS AND CONDITIONS ON SITE PRIOR TO CONSTRUCTION.
- DO NOT USE INFORMATION ON THESE DRAWINGS FOR ANY OTHER PROJECT OR WORKS.
- DO NOT SCALE THESE DRAWINGS.

WORKS.

- UNLESS OTHERWISE NOTED ON DRAWINGS, FOLLOW TYPICAL DETAILS SHOWN ON S2.00 DRAWING SERIES. TYPICAL DETAILS SHOW STRUCTURAL INTENT RATHER THAN ACTUAL CONDITIONS FOR THIS PROJECT. IF A TYPICAL DETAIL INCLUDES A CROSS REFERENCE TO ANOTHER TYPICAL DETAIL WHICH IS NOT INCLUDED IN THE DRAWING SET, THE CROSS-REFERENCED DETAIL IS NOT APPLICABLE ON THIS PROJECT.
- ALL SECTIONS, DETAILS AND STATEMENTS NOTED AS "TYPICAL" APPLY TO LIKE / SIMILAR CONDITIONS IN THE STRUCTURE.
- REFER TO ARCHITECTURAL DRAWINGS AND SPECIFICATIONS FOR WATERPROOFING, SEALERS, ETC.
- REFER TO ARCHITECTURAL / CIVIL DRAWINGS AND SPECIFICATIONS FOR ALL SOIL
- DRAWINGS SHOW COMPLETED STRUCTURE ONLY. THEY DO NOT SHOW TEMPORARY WORKS FOR WHICH THE CONTRACTOR IS RESPONSIBLE AND WHICH MAY BE REQUIRED FOR EXECUTION OF THE PROJECT. INCLUDING TEMPORARY SHORING, BRACING, GUYS AND TIE DOWNS. THE CONTRACTOR TO ESTABLISH CONSTRUCTION PROCEDURE AND SEQUENCE TO ENSURE SAFETY OF THE WHOLE STRUCTURE AND ALL ITS COMPONENTS DURING ERECTION.
- DESIGN AND CONSTRUCTION REVIEW OF ALL TEMPORARY WORKS TO BE CARRIED OUT BY A PROFESSIONAL ENGINEER RETAINED BY THE CONTRACTOR, LICENSED IN THE PLACE WHERE THE PROJECT IS LOCATED.
- ANCHOR BOLTS AND OTHER EMBEDDED ITEMS ARE DESIGNED FOR LOADS ACTING ON THE COMPLETED STRUCTURE ONLY AND ARE NOT TO BE USED OR RELIED UPON FOR TEMPORARY SUPPORT OR BRACING DURING ERECTION UNLESS REVIEWED AND APPROVED BY THE CONTRACTOR'S ENGINEER RESPONSIBLE FOR THE ERECTION PROCEDURES.
- CONSTRUCTION LOADS ON COMPLETED STRUCTURE NOT TO EXCEED DESIGN LOADS INDICATED ON DRAWINGS
- UNLESS SHOWN ON STRUCTURAL DRAWINGS, DESIGN OF NON-STRUCTURAL AND SECONDARY STRUCTURAL ELEMENTS AND THEIR CONNECTIONS TO THE PRIMARY BUILDING STRUCTURE ARE NOT WITHIN THE SCOPE OF SERVICES PROVIDED BY DEPARTMENTAL REPRESENTATIVE. SUCH ELEMENTS INCLUDE (BUT ARE NOT LIMITED TO) THE FOLLOWING:
  - MISCELLANEOUS STEEL ELEMENTS: STAIRS, RAILINGS, GUARDRAILS. PARTITIONS
  - BULKHEADS, SUSPENDED CEILINGS, INTERIOR AND EXTERIOR SIGNAGE.
  - EXTERIOR CLADDING: METAL WALL SYSTEMS AND WINDOWS
  - SUPPORTS FOR MECHANICAL AND ELECTRICAL EQUIPMENT: HANGERS, BRACES, POSTS, RACKS, SLEEPERS, SEISMIC RESTRAINTS, SUPPORT PLATFORMS AND PADS, SERVICE PLATFORMS.
  - SUPPORTS AND SEISMIC RESTRAINTS FOR OTHER EQUIPMENT.
  - LANDSCAPING ELEMENTS: WALLS, CURBS, BENCHES, PLANTERS, WATER
  - LIGHT POLES, FLAG POLES, SIGNS AND THEIR FOUNDATIONS.

DEPARTMENTAL REPRESENTATIVE WILL NOT REVIEW DESIGN, DETAILING AND INSTALLATION OF THESE ELEMENTS, FOR WHICH SUPPLIERS AND / OR SPECIALTY PROFESSIONAL ENGINEERS ARE RESPONSIBLE; THE ONLY REVIEW PROVIDED (WHERE APPLICABLE) WILL BE FOR IMPACT ON THE BASE BUILDING STRUCTURE.

- MAINTAIN A QUALITY CONTROL PLAN FOR STRUCTURAL WORK, AND MAKE IT AVAILABLE TO THE CONSULTANT UPON REQUEST. AT A MINIMUM, THE PLAN TO INCLUDE:
  - NAMES OF PERSONNEL RESPONSIBLE FOR EXECUTION OF THE PLAN.
- MEANS AND METHODS FOR CONFIRMING MATERIAL COMPLIANCE WITH SPECIFICATIONS AND ASSOCIATED DOCUMENTATION PROCEDURES.
- PROGRAM FOR CONFIRMING AND DOCUMENTING COMPLIANCE WITH REQUIRED SUB-TRADE QUALIFICATIONS AND QUALIFICATIONS OF THEIR INDIVIDUAL EMPLOYEES AND SUB-CONTRACTORS.
- PROCEDURES FOR REVIEWING FIELD COMPLIANCE WITH CONSTRUCTION DOCUMENTS, INCLUDING DOCUMENTATION OF LOCATIONS REVIEWED, PHOTOGRAPHS TAKEN AND TIMING OF REVIEW. THE CONTRACTOR'S REVIEW TO BE COMPLETED PRIOR TO REVIEW BY THE CONSULTANT
- PROCEDURES FOR RECTIFYING DEFICIENCIES NOTED BY THE CONTRACTOR, SUB-CONTRACTORS, CONSULTANTS AND INDEPENDENT INSPECTION AGENCIES.
- FOR INSPECTION AND TESTING REQUIREMENTS, REFER TO SPECIFICATIONS.
- IN CASE OF DISCREPANCY BETWEEN GENERAL NOTES. DRAWINGS AND SPECIFICATIONS, COMPLY WITH THE MOST STRINGENT REQUIREMENTS.

### FIELD REVIEW

PWGSC - B1 - 1000X707

- DEPARTMENTAL REPRESENTATIVE WILL PROVIDE PERIODIC FIELD REVIEW OF A REPRESENTATIVE SAMPLE OF THE STRUCTURAL WORKS DETAILED ON THESE DRAWINGS FOR GENERAL CONFORMANCE WITH CONTRACT DOCUMENTS. THESE REVIEWS DO NOT REPLACE THE CONTRACTOR'S RESPONSIBILITY TO IMPLEMENT AND MAINTAIN A QUALITY CONTROL PROGRAM, AND DO NOT MAKE DEPARTMENTAL REPRESENTATIVE A GUARANTOR OF THE CONTRACTOR'S WORK.
- CONSTRUCTION REVIEW REPORTS WILL OUTLINE ANY DEFICIENCIES FOUND.
- ASSIST DEPARTMENTAL REPRESENTATIVE DURING FIELD REVIEW, AND PROVIDE SAFE ACCESS TO WORK AREAS AS REQUIRED.
- CHECK THE WORK PRIOR TO FIELD REVIEW TO CONFIRM IT IS COMPLETED AND IN ACCORDANCE WITH CONTRACT DOCUMENTS
- BRING TO THE ATTENTION OF DEPARTMENTAL REPRESENTATIVE ANY DEFICIENCIES FOUND IN THE WORK TOGETHER WITH A PROPOSAL FOR REMEDY. DEPARTMENTAL REPRESENTATIVE WILL DECIDE WHAT CORRECTIVE ACTION MAY
- PROVIDE REASONABLE NOTICE TO ALLOW FOR THE FIELD REVIEW OF THE FOLLOWING:
  - WOOD FRAMING: BEFORE COVERING UP CONCRETE: BEFORE EACH POUR

BE TAKEN AND ISSUE THE NECESSARY INSTRUCTIONS.

SCHEDULE REVIEW WORK TO OCCUR DURING NORMAL BUSINESS HOURS.

### **DESIGN DATA**

COMMENTARIES.

- STRUCTURAL DESIGN IS IN ACCORDANCE WITH THE 2015 NATIONAL BUILDING CODE (NBC), SUPPLEMENTED BY THE USER'S GUIDE - NBC 2015 STRUCTURAL
- STEEL ELEMENTS ARE DESIGNED PER CSA S16-14 LIMIT STATE DESIGN OF STEEL STRUCTURES.
- SAWN LUMBER STRUCTURAL ELEMENTS ARE DESIGNED PER CSA 086-14 -ENGINEERING DESIGN IN WOOD.
- THE VALUES FOR CLIMATIC DATA USED IN THE DETERMINATION OF DESIGN LOADS HAVE BEEN OBTAINED FROM THE 2015 NBC, USING AN AVERAGE OF THE VALUES
- OBTAINED FOR THE SPECIFIC LOCATIONS OF BELLA COOLA, PRINCE GEORGE, AND WILLIAMS LAKE. BASED ON THE USE AND OCCUPANCY, THE BUILDING IS DESIGNED TO THE
- REQUIREMENTS OF A NORMAL IMPORTANCE CATEGORY. SELF WEIGHT (SWT) IS DUE TO THE WEIGHT OF THE STRUCTURE ITSELF. IT VARIES

NON-STRUCTURAL TOPPINGS, FINISHES, PARTITIONS, ROOFING MATERIALS,

- WITH THE STRUCTURAL SYSTEM. SUPERIMPOSED DEAD LOADS (SDL) ARE NON-STRUCTURAL DEAD LOADS DUE TO
- SUSPENDED EQUIPMENT, PAVERS, SOIL, ETC. DEAD LOAD (DL) IS THE SELF WEIGHT OF THE STRUCTURE PLUS THE

11. IF ONLY ONE VALUE IS GIVEN FOR A LOAD, CONSIDER IT LIVE LOAD.

LIVE LOAD (LL) REDUCTION HAS NOT BEEN USED.

SUPERIMPOSED DEAD LOAD.

- UNLESS OTHERWISE NOTED, DESIGN LOADS SHOWN ON DRAWINGS ARE SPECIFIED (UNFACTORED) LOADS, TO BE USED FOR ULS DESIGN. FOR SLS DESIGN. THESE LOADS CAN BE REDUCED BY MULTIPLYING WITH THE RATIO OF
- APPROPRIATE IMPORTANCE FACTORS Ix(SLS) / Ix(ULS) GIVEN BELOW.
- Is (SLS) = 0.9Sr = 0.4 kPaIs (ULS) = 1.0Ss = 3.4 kPa MINIMUM UNFACTORED SNOW LOAD = 3.1 kPa x Is
- LATERAL LOADS IN THIS STRUCTURE ARE RESISTED BY SHEAR WALLS, AND ARE DETERMINED BASED ON THE WIND AND SEISMIC DATA BELOW.
- WIND:

q50 = 0.37 kPa Iw (ULS) = 1.0 Iw (SLS) = 0.75**BUILDING IS: LOW RISE** 

**INTERNAL PRESSURE CATEGORY: 2** 

TERRAIN TYPE: OPEN

WIND LOAD AT GRADE LEVEL FOR DESIGN OF OVERALL BUILDING LATERAL LOAD RESISTING SYSTEM:

0.65 kPa. FACTORED BASE SHEARS & OVERTURNING MOMENTS:

V(NS) = 19 kNM(NS) = 53 kNm

V(EW) = 16 kNM(EW) = 44 kNm

SEISMIC:

IeFaSa(0.2) = 0.129Sa(0.2) = 0.129Sa(0.5) = 0.132Rd = 3.0 (WOOD), 1.5 (CMU)Sa(1.0) = 0.111Ro = 1.7 (WOOD), 1.3 (CMU)SITE CLASSIFICATION = C

(ASSUMED)

Sa(2.0) = 0.084le = 1.0

- SEISMIC FORCE RESISTING SYSTEM (SFRS):
- NORTH/SOUTH: NAILED SHEARWALLS (WOOD-BASED PANEL) - EAST/WEST:NAILED SHEARWALLS (WOOD-BASED PANEL)
- **FACTORED BASE SHEARS & OVERTURNING MOMENTS**

V(NS) = 6 kN

M(NS) = 18 kNmV(EW) = 7 kN

M(EW) = 20 kNm

### **EXISTING STRUCTURES**

- EXISTING CONDITIONS ARE ASSUMED. SURVEY THE EXISTING STRUCTURE AFTER REMOVING FINISHES AND REPORT ANY VARIATIONS TO DEPARTMENTAL REPRESENTATIVE BEFORE PROCEEDING WITH THE WORK.
- DESIGN OF STRUCTURAL WORKS RELATED TO THE EXISTING BUILDING HAS BEEN CARRIED OUT AS FAR AS PRACTICAL, GIVEN LIMITED AVAILABILITY OF THE EXISTING DRAWINGS AND LIMITED RECORDS OF THE STRUCTURAL MODIFICATIONS LIKELY TO HAVE BEEN MADE THROUGH THE LIFE OF THE BUILDING. MODIFICATIONS TO THE PROPOSED STRUCTURAL FRAMING AND / OR DETAILS MAY BE REQUIRED IF EXISTING CONDITIONS ARE FOUND TO BE DIFFERENT FROM THOSE ASSUMED AND SHOWN ON DRAWINGS.
- TAKE ALL PRECAUTIONS NECESSARY TO PROTECT EXISTING STRUCTURES DURING DEMOLITION AND NEW CONSTRUCTION.
- DISCONNECT ALL SERVICES IN THE AREAS AFFECTED BY DEMOLITION AND NEW CONSTRUCTION. REROUTE SERVICES AS REQUIRED TO KEEP THE REMAINDER OF THE BUILDING OPERATIONAL.
- SAFELY STORE ALL STRUCTURAL ELEMENTS AND OTHER PRODUCTS WHICH ARE
- TO BE RE-USED. REMOVE FROM SITE ALL OTHER STRUCTURAL ELEMENTS AND PRODUCTS WHICH
- ARE NOT INDICATED TO BE HANDED OVER TO THE OWNER. ALL DEMOLITION, SHORING AND OTHER TEMPORARY WORKS TO BE DESIGNED BY A PROFESSIONAL ENGINEER RETAINED BY THE CONTRACTOR, LICENSED IN THE PLACE WHERE THE PROJECT IS LOCATED. PREPARE DRAWINGS SIGNED AND SEALED BY THAT ENGINEER SHOWING DEMOLITION PROCEDURE AND SEQUENCE AND ALL THE NECESSARY SHORING.
- INSTALL AND AFTERWARDS REMOVE ALL TEMPORARY SHORING AND BRACING REQUIRED TO ENSURE THE INTEGRITY OF THE EXISTING STRUCTURE DURING CONSTRUCTION.
- ASSESS CAPACITY OF THE EXISTING STRUCTURE AND CONSTRUCTION LOADS APPLIED TO IT. PROVIDE ADEQUATE SHORING IF THE LOADS EXCEED THE EXISTING STRUCTURAL CAPACITY
- MAKE GOOD ALL EXISTING WORK DISTURBED BY THE SHORING OPERATIONS, DEMOLITION, EXCAVATION AND OTHER CONSTRUCTION PROCEDURES.

### STRUCTURAL STEEL

- CONFORM TO CSA S16.
- MATERIALS: TO CSA G40.21 UNLESS OTHERWISE NOTED, WITH THE FOLLOWING

W SECTIONS, CHANNELS AND ANGLES:

ASTM A992, GRADE 50 (345MPa)

PLATES, BARS:

ASTM F3125 GRADE A325M

- DO NOT CUT HOLES OR OTHERWISE MODIFY STRUCTURAL MEMBERS ON SITE. PROVIDE ALL ERECTION BRACING REQUIRED TO KEEP THE STRUCTURE STABLE
- AND IN ALIGNMENT DURING CONSTRUCTION. ALL EXTERIOR STEEL TO BE HOT-DIPPED GALVANIZED.

### CAST-IN-PLACE CONCRETE

- CONCRETE IS SPECIFIED PER ALTERNATIVE 1 PERFORMANCE SPECIFICATION, AS OUTLINED IN CSA A23.1. THE CONTRACTOR AND THE CONCRETE SUPPLIER TO MEET ALL CERTIFICATION, DOCUMENTATION, AND QUALITY CONTROL REQUIREMENTS.
- CONTRACTOR AND CONCRETE SUPPLIER TO ENSURE THAT PLASTIC AND HARDENED MIX PROPERTIES MEET SITE REQUIREMENTS FOR PLACING, FINISHING AND THE SPECIFIED PERFORMANCE REQUIREMENTS.
- CEMENT TO BE PORTLAND CEMENT TYPE GU UNLESS NOTED OTHERWISE OR REQUIRED BY EXPOSURE CLASS.
- CONCRETE TO BE NORMAL DENSITY (MIN. 2300 kg/m³) UNLESS NOTED OTHERWISE NOMINAL MAXIMUM SIZE OF COARSE AGGREGATE TO BE 20 (3/4") UNLESS NOTED
- UNLESS NOTED OTHERWISE, CONCRETE TO BE IN ACCORDANCE WITH THE

ELEMENT	COMPRESSIVE STRENGTH (MPa) AT 28 DAYS	EXPOSURE CLASS
EXTERIOR SLAB-ON-GRADE	35 MPa	C1

- REFER TO CSA A23.1 FOR THE MAXIMUM WATER/CEMENT RATIO, MINIMUM COMPRESSIVE STRENGTH, AIR CONTENT, CURING REQUIREMENTS, CHLORIDE ION PENETRABILITY AND ALTERNATE CEMENT TYPES TO MEET THE REQUIREMENTS FOR THE NOTED EXPOSURE CLASS.
- DO NOT ADD WATER TO CONCRETE ON SITE.

FOLLOWING SCHEDULE:

- CONVEY CONCRETE FROM TRUCK TO FINAL LOCATION BY METHODS WHICH WILL PREVENT SEPARATION OR LOSS OF MATERIAL. MAXIMUM FREE FALL NOT TO EXCEED 1.5m (5'-0"). CONSOLIDATE CONCRETE USING MECHANICAL VIBRATORS.
- PLACE CONCRETE AS CLOSE AS POSSIBLE TO FINAL LOCATION TO AVOID SEGREGATION. VIBRATE ALL CONCRETE.
- PROTECT CONCRETE FROM FREEZING. DO NOT PLACE CONCRETE AGAINST FROZEN GROUND. USE COLD WEATHER CONCRETING METHODS IN ACCORDANCE WITH CSA-A23.1.
- PROTECT CONCRETE FROM EXCESSIVE HEAT AND DRYING. USE HOT WEATHER CONCRETING METHODS IN ACCORDANCE WITH CSA-A23.1.

DO NOT USE STEEL TROWEL TO FINISH AIR-ENTRAINED CONCRETE.

### CONCRETE REINFORCEMENT

- REINFORCEMENT TO CONFORM TO CSA G30.18, GRADE 400R OR 400W.
- BARS MARKED CONTINUOUS TO BE TERMINATED IN STANDARD HOOKS AT ENDS AND SPLICED USING CLASS B LAPS. FOR LAP LENGTHS AND DEVELOPMENT LENGTHS, REFER TO DETAILS ON \$2.02.
- ALL REBAR HOOKS TO BE STANDARD LENGTH 90° OR 180° HOOKS. REBAR LENGTHS LISTED ON DRAWINGS DO NOT INCLUDE THE HOOK LENGTH.
- PROVIDE ADDITIONAL SUPPORT BARS AS REQUIRED TO ADEQUATELY SUPPORT AND SECURE ALL REINFORCEMENT AND PREVENT MOVEMENT WHEN PLACING
- PROVIDE SUFFICIENT CHAIRS TO REINFORCING TO MAINTAIN SPECIFIED CONCRETE COVER.
- ALL REINFORCING TO BE CLEAN, FREE OF LOOSE SCALE, OIL, DIRT, RUST, AND ANY OTHER FOREIGN COATING THAT AFFECT BONDING CAPACITY.

### WOOD FRAMING


- CONFORM TO CSA O86
- MATERIALS:
- LUMBER: GRADE MARKED TO CONFORM TO CSA 0141; KILN DRIED; SPF NO. 2 OR BETTER; MOISTURE CONTENT NOT TO EXCEED 19% AT TIME OF MANUFACTURE AND INSTALLATION: UNLESS NOTED OTHERWISE.
- PLYWOOD SHEATHING: TO CSA 0151 SOFTWOOD SPRUCE; OR CSA 0121 DOUGLAS
- PARALLEL STRAND LUMBER (PSL): MINIMUM GRADE 2.0E, 2900Fb (Fb=37MPa) OR
- NAILS: COMMON ROUND STEEL WIRE NAILS
- UNLESS NOTED OTHERWISE, ALL WOOD FRAMING DETAILS TO BE IN ACCORDANCE WITH PART 9 OF THE REFERENCED BUILDING CODE.
- PROTECT ALL WOOD PRODUCTS FROM THE ELEMENTS AS REQUIRED TO MAINTAIN THEIR INTEGRITY. PROVIDE ALL ERECTION BRACING REQUIRED TO KEEP THE STRUCTURE STABLE
- AND IN ALIGNMENT DURING CONSTRUCTION. SUBSTITUTION OF COMMON NAILS WITH POWER DRIVEN NAILS OF THE SAME LENGTH AND DIAMETER IS ACCEPTABLE. SUBSTITUTION OF POWER DRIVEN NAILS OF SMALLER DIAMETER MUST BE APPROVED IN WRITING BY DEPARTMENTAL

REPRESENTATIVE PRIOR TO USE. POWER DRIVEN NAILS NOT TO BE OVER-DRIVEN

- INTO WOOD OR SHEATHING. MEMBER SIZES INDICATED ON DRAWINGS ARE A MINIMUM AND ARE TO BE
- INCREASED AS REQUIRED TO MEET DESIGN FOLLOWING THE ORIGINAL DESIGN PROPOSED NOTCHING AND DRILLING OF FRAMING MEMBERS MUST BE SUBMITTED TO THE ENGINEER FOR REVIEW. SIGNIFICANT NOTCHES CONFORMING TO PART 9
- MAY BE REJECTED IF THEY COMPROMISE THE STRUCTURAL INTEGRITY. ALL COMPONENTS OF BUILT UP MEMBERS TO BE CONTINUOUS FOR FULL SPAN. DO NOT SPLICE OR USE BUTT JOINTS.
- UNLESS NOTED OTHERWISE, BUILT-UP TIMBER COLUMNS TO BE FASTENED AS PER TYPICAL DETAIL TW-FAST-01. UNLESS NOTED OTHERWISE ON PLAN BUILT-UP BEAMS TO BE FASTENED AS PER
- TYPICAL DETAIL TW-FAST-02. UNTREATED WOOD NOT TO BE IN DIRECT CONTACT WITH CONCRETE OR CMU, PROVIDE FOAM GASKET BETWEEN WOOD AND CONCRETE/CMU, OR USE

PRESSURE TREATED WOOD.

### **BUILT-UP COLUMN FASTENING** TW-FAST-01 WHERE POST IS PART OF A WALL AND FASTENED TO SHEATHING AT MINIMUM 300, SCREWS MAY BE 38x89(2x4) 38x140(2x6) REPLACED WITH MULTIPLE 3.25Ø NAILS INSTALLED FROM OPPOSITE 38x184(2x8) SIDES AS ABOVE. <u>3-PLY</u> <u>5-PLY</u> 3.25Ø COMMON NAIL. 5.6Øx111LG 5.6Øx150LG 5.6Øx171LG INSTALL FROM SCREW (TYP) SCREW (TYP) SCREW (TYP) OPPOSING SIDES

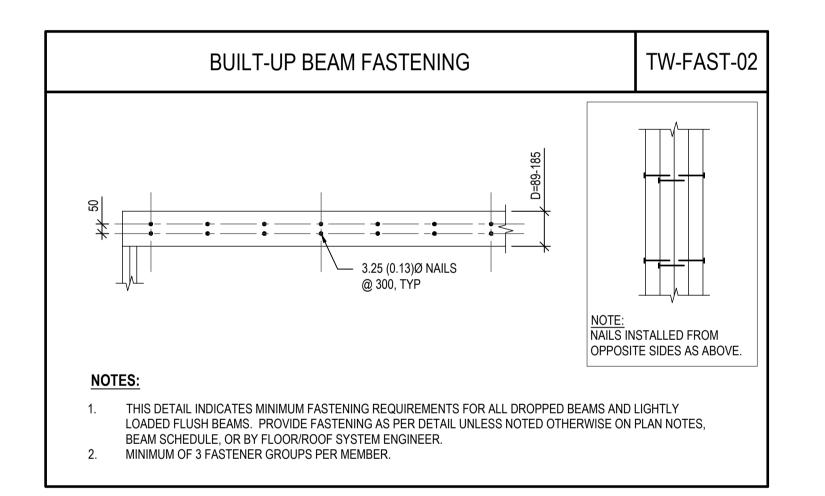

### **ABBREVIATIONS:**

REINF

REQ'D

 BOTTOM BTWN BETWEEN CRACK CONTROL JOINT CLR CLEAR CONCRETE MASONRY UNITS CMU CONC CONCRETE CONT CONTINUOUS C/W COMPLETE WITH DEEP **EXISTING** EACH **EMBEDMENT** EACH SIDE EACH WAY GALVANIZED GALV HOOK ONE END H1E HOOK BOTH ENDS H2E HDG HOT DIPPED GALVANIZED LONG NEW ON CENTER

R/W REINFORCE WITH SOG SLAB ON GRADE STAINLESS STEEL STAGGERED STAGG TOP AND BOTTOM TYPICAL UNLESS NOTED OTHERWISE U/N, UNO

REINFORCEMENT

REQUIRED

Public Works and Travaux publics et Government Services Services gouvernementaux REAL PROPERTY SERVICES Pacific Region **SERVICES IMMOBILIERS** Région de Pacifique







ISSUED FOR TENDER 2019.12.09 99% REVIEW SUBMISSION 2019.10.25 50% REVIEW SUBMISSION 2019.09.13 Description/Description Date/Date

RCMP 14200 Green Timbers Way Surrey, B.C.

Project title/Titre du projet

Philip Fung

Preetipal Paul

Client/client

RCMP ANAHIM LAKE HOUSING RENOVATIONS

Consultant Signature Box Only Designed by/Concept pa Drawn by/Dessine par PWGSC Project Manager/Administrateur de Projets TPSGC

Drawing title/Titre du dessin


AND TYPICAL DETAILS

PWGSC, Regional Manager, Architectural and Engineering Services Gestionnaire régionale, Services d'architectural et de génie, TPSGC

Project No./No. du projet

**GENERAL NOTES** 

**S2.00** R.103948.001

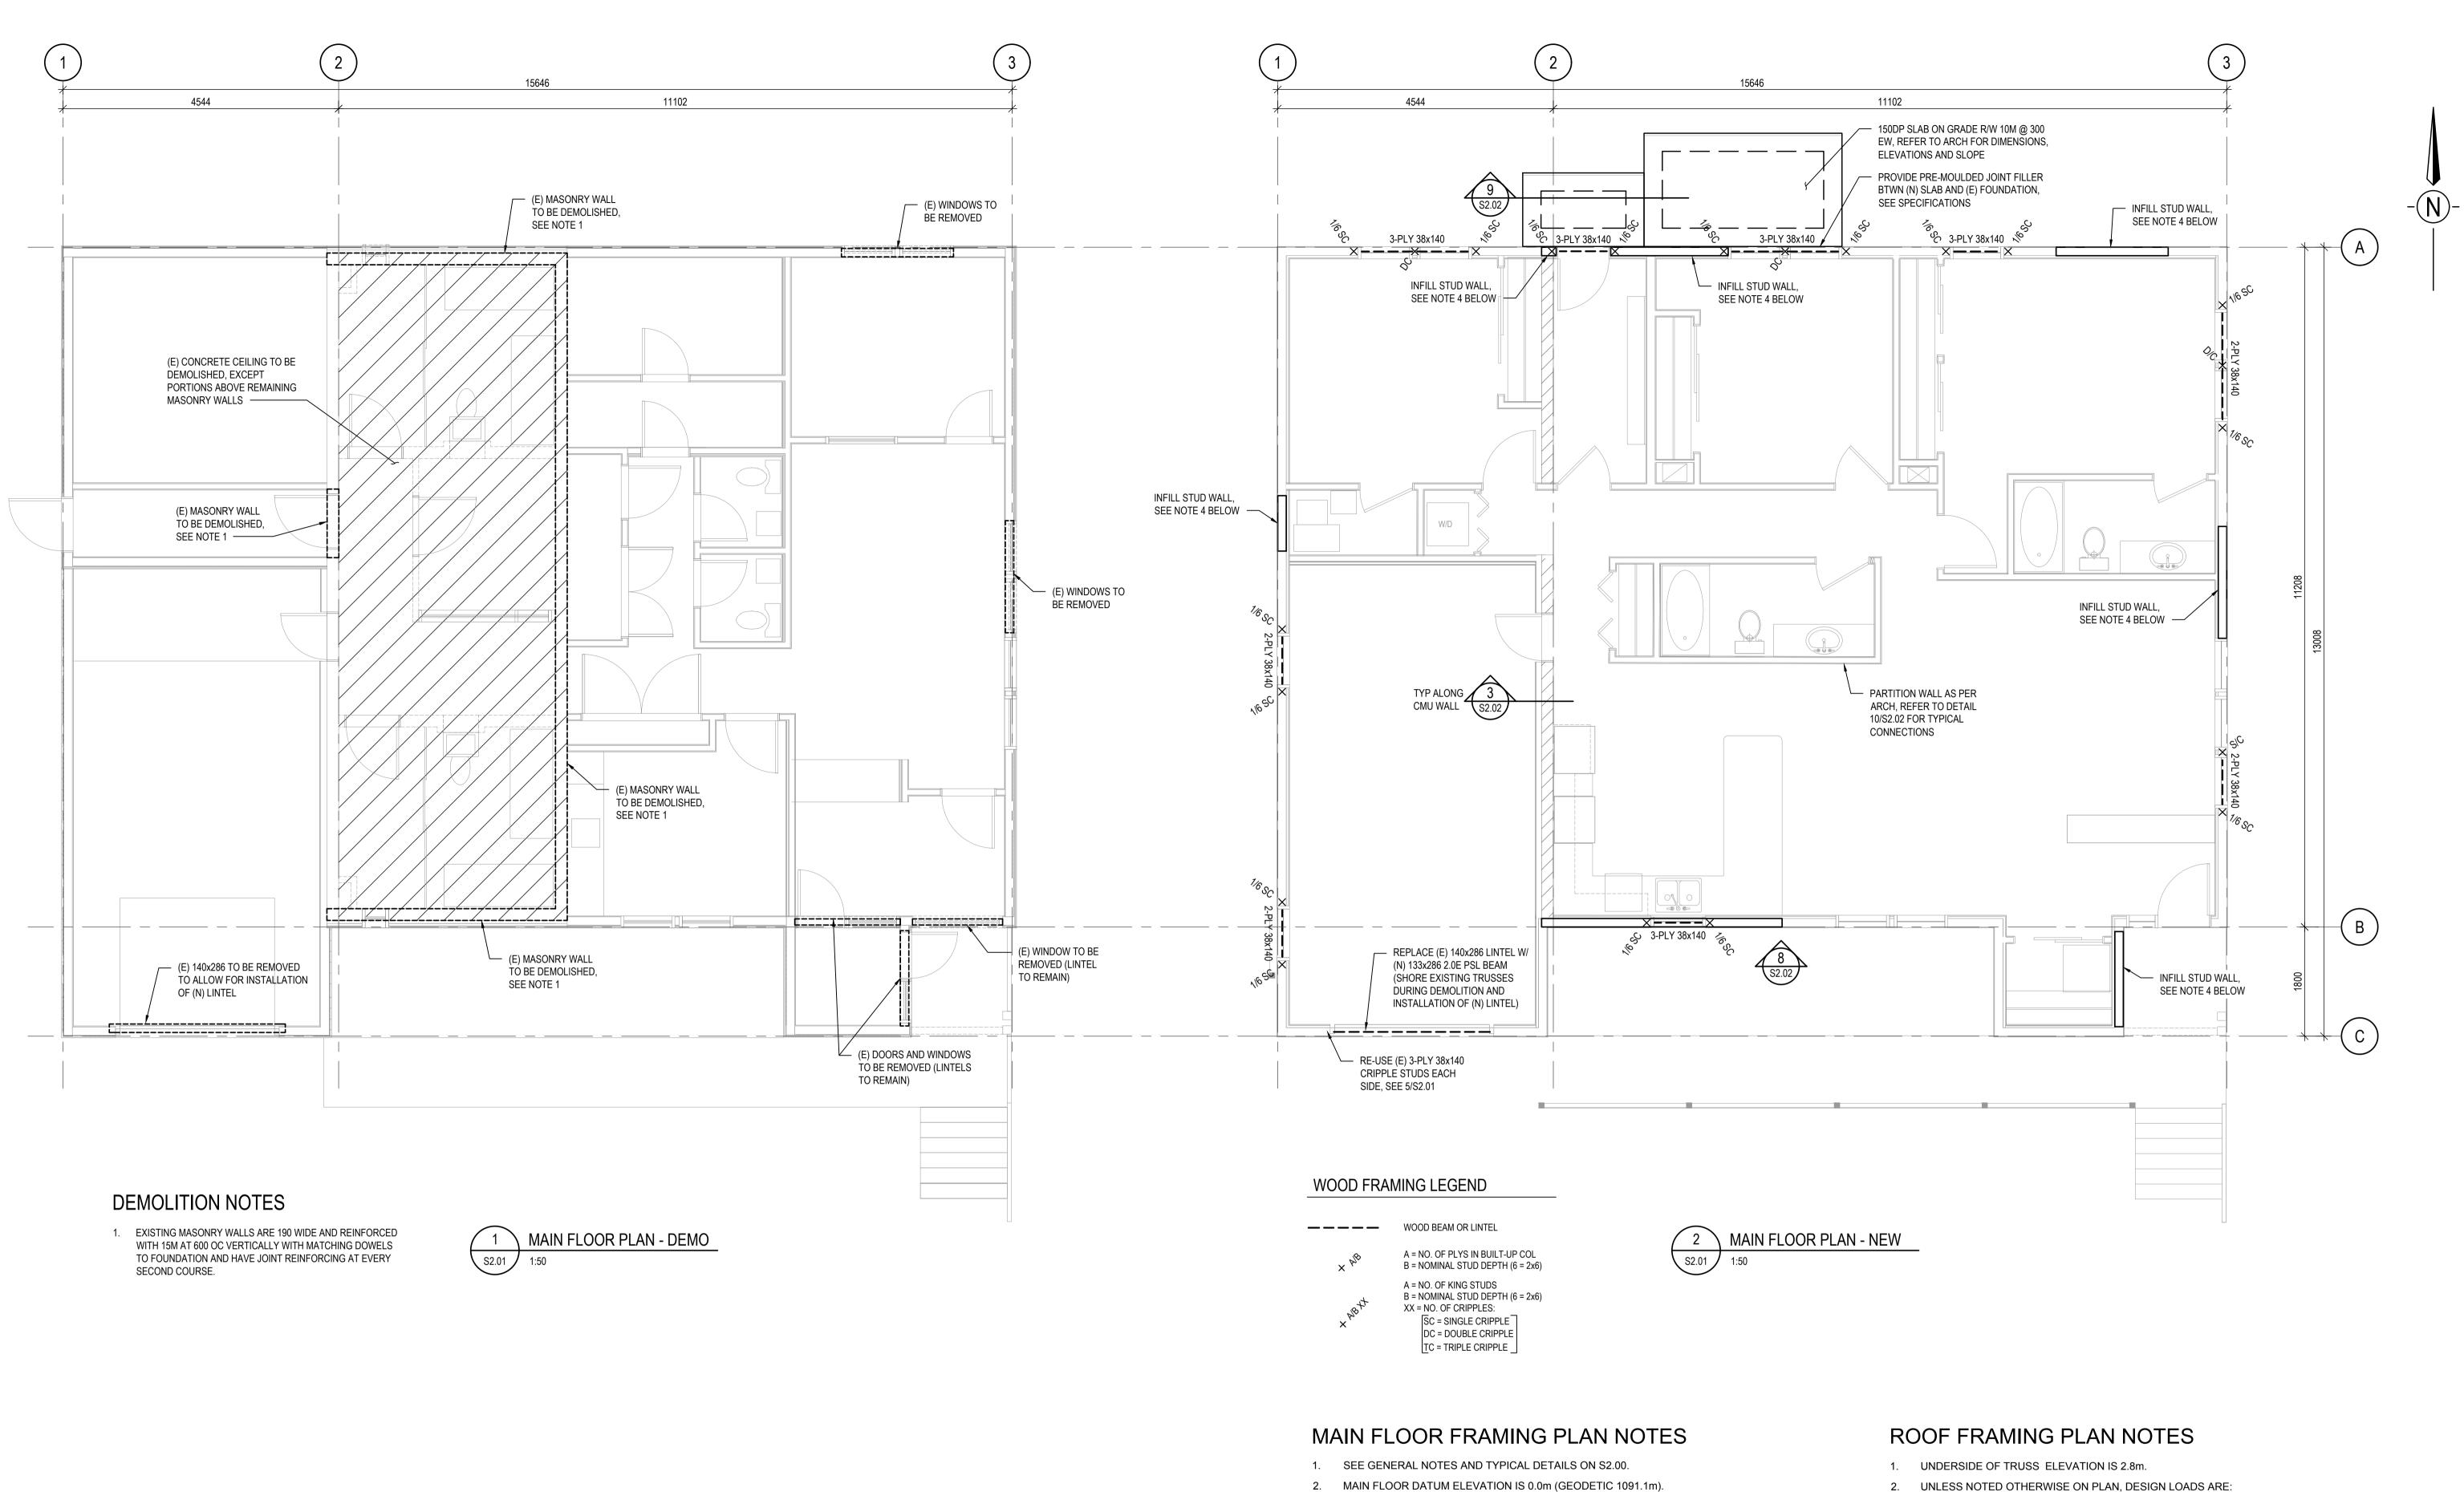

	TIE DOWN SCHEDULE										
	K GUAGE		FACTORED RESISTANCE (KN), (K <sub>D</sub> =1.15)								
MARK			D.FIR		SPF						
IVIARK		GUAGE	GUAGL	GUAGE	GUAGE	UPLIFT	LATE	ERAL	UPLIFT	LATERAL	
		UPLIFI	F1	F2	UPLIFI	F1	F2				
H1	18	3.29	3.05	1.33	3.02	2.16	0.96				

		FAC	TORED RE	SISTANCE	(KN)	
MARK	DIRECTION OF LOAD	D.I	FIR	SPF		
	LOAD	K <sub>D</sub> =1.00	K <sub>D</sub> =1.15	K <sub>D</sub> =1.00	K <sub>D</sub> =1.15	
A2	F1	4.23	4.25	3.00	3.00	
	F2	4.09	4.09	2.89	2.89	
P1	F1	3.63	3.63	2.58	2.58	
FI	F2	3.71	3.71	2.65	2.65	
F1= ALONG LENGTH F2= ALONG WI						

- MAIN FLOOR DATUM ELEVATION IS 0.0m (GEODETIC 1091.1m).
- 3. UNLESS NOTED OTHERWISE ON PLAN, DESIGN LOADS ARE: LIVE LOAD (LL) =  $4.8 \text{ kN/m}^2$ SUPERIMPOSED DEAD LOAD (SDL) = 1.0 kN/m<sup>2</sup> SELF WEIGHT (SWT) = 0.2 kN/m<sup>2</sup>
- PARTITION LOAD IS INCLUDED IN THE SDL
- 4. WOOD STUD WALLS:
  - 4.1. ONLY LOAD BEARING WALLS ARE SHOWN ON PLAN. REFER TO ARCHITECTURAL DRAWINGS FOR ALL NON-LOAD BEARING WALLS AND REQUIREMENTS.
  - 4.2. ALL NEW STUD INFILL WALLS TO BE 38x140 STUDS AT 406 OC WITH D.FIR PLYWOOD SHEATHING ON OUTSIDE FACE. SHEATHING THICKNESS TO MATCH EXISTING. FASTEN SHEATHING WITH 2.84mm DIAMETER x 51 LONG COMMON WIRE NAILS AT 150 ON CENTER ALONG PANEL EDGES AND AT 300 ON CENTER ALONG INTERMEDIATE SUPPORTS.
  - 4.3. UNLESS OTHERWISE NOTED ON PLAN OR IN SECTION, CONNECT NEW WOOD STUD WALLS TO EXISTING CONCRETE STRUCTURE BELOW WITH POST-INSTALLED 12.7mm DIAMETER SCREW ANCHORS AT A MAXIMUM SPACING OF 1200 AND A MINIMUM EMBEDMENT OF 100. LOCATE ONE ANCHOR WITHING 300 MINIMUM OF EACH END OF THE BOTTOM PLATE OF THE NEW WALL AT ALL NEW WALL LOCATIONS. MINIMUM TWO ANCHORS PER NEW WALL SEGMENT. REFER TO SPECIFICATIONS.
- 5. ALL GRIDS ARE LOCATED AT OUTSIDE FACE OF EXISTING EXTERIOR SHEATHING OR AT FACE OF EXISTING MASONRY.
- 6. WHERE MECHANICAL OR ELECTRICAL SERVICES RUN THROUGH EXISTING CONCRETE FOUNDATION WALLS OR SLABS, CORE HOLES THROUGH EXISTING CONCRETE TO ALLOW THE SERVICES TO PASS THROUGH. DO NOT CORE HOLES WITHOUT THE DEPARTMENTAL REPRESENTATIVE'S APPROVAL. SCAN CONCRETE PRIOR TO CORING TO LOCATE EXISTING REINFORCING BARS. LOCATE CORING HOLES TO AVOID EXISTING REINFORCING. IF CORE LOCATIONS CANNOT BE LOCATED TO MISS THE EXISTING REINFORCING, NOTIFY DEPARTMENTAL REPRESENTATIVE IMMEDIATELY.

LIVE LOAD (SNOW) = 3.1 kN/m<sup>2</sup> MINIMUM SUPERIMPOSED DEAD LOAD = 0.1 kN/m<sup>2</sup> (CEILING) + 0.15 kN/m<sup>2</sup> (M&E) = 0.25 kN/m<sup>2</sup> SELF WEIGHT (SWT) =  $0.37 \text{ kN/m}^2 (ROOF) + 0.2 \text{ kN/m}^2 (TRUSSES) = <math>0.57 \text{ kN/m}^2$ 

REAL PROPERTY SERVICES Pacific Region SERVICES IMMOBILIERS Région de Pacifique







0	ISSUED FOR TENDER	2019.12.09
В	99% REVIEW SUBMISSION	2019.10.25
А	50% REVIEW SUBMISSION	2019.09.13
Revision/ Revision	Description/Description	Date/Date
Client/client		

### **RCMP** 14200 Green Timbers Way Surrey, B.C.

Project title/Titre du projet


### RCMP ANAHIM LAKE **HOUSING RENOVATIONS**


Consulta	nt Signature Box Only
Designed	d by/Concept par
CP	
Drawn b	//Dessine par
GM	
PWGSC	Project Manager/Administrateur de Projets TPSGC
Philip	Fung
PWGSC,	Regional Manager, Architectural and Engineering Services/ ire régionale, Services d'architectural et de génie, TPSGC
	pal Paul
Drawing	title/Titre du dessin


### EXISTING/DEMOLISHED & NEW **FLOOR PLANS**

Project No./No. du projet La Révision **S2.01** R.103948.001


0 10 20 30 40 50 60 70 80 90 100mm

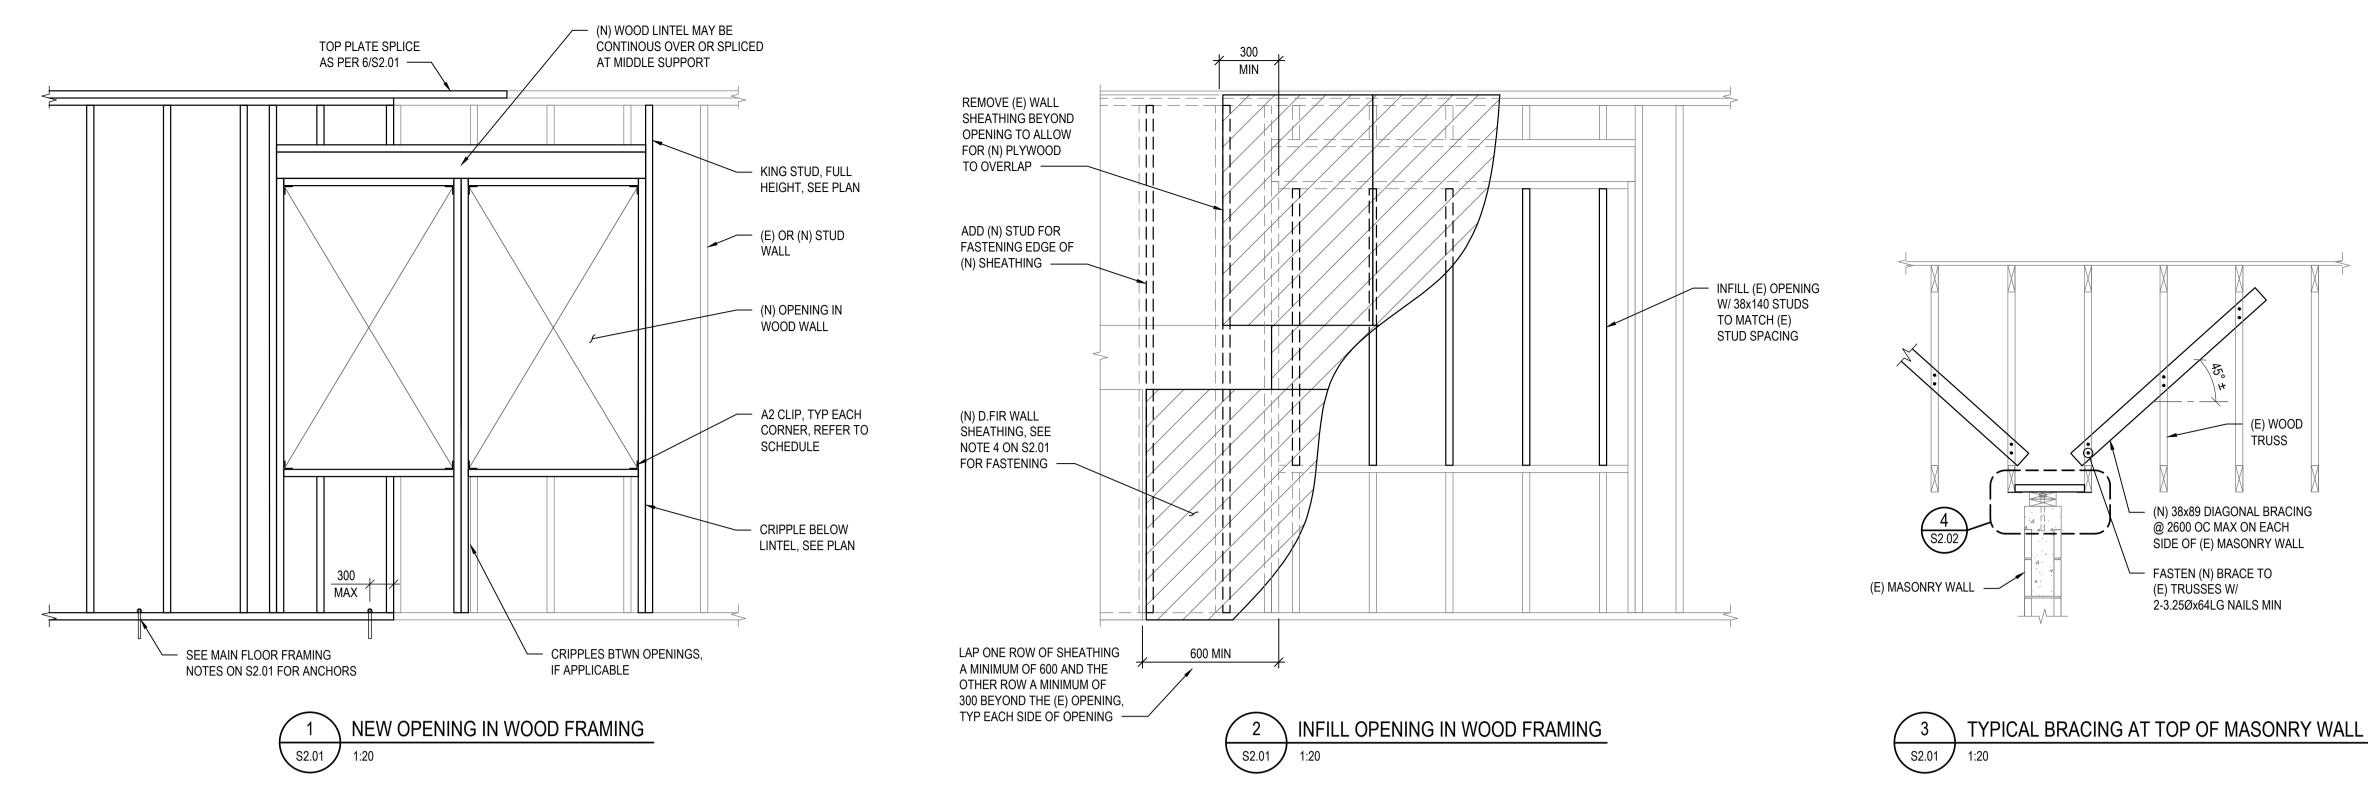

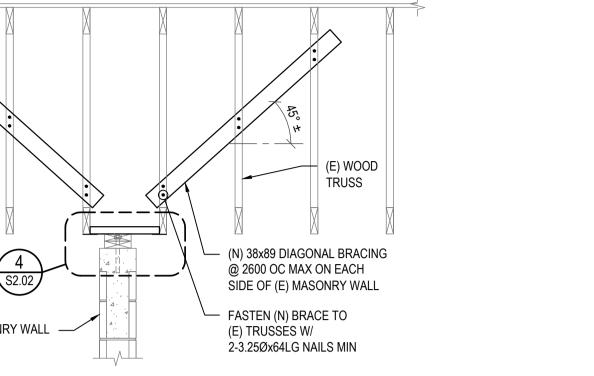


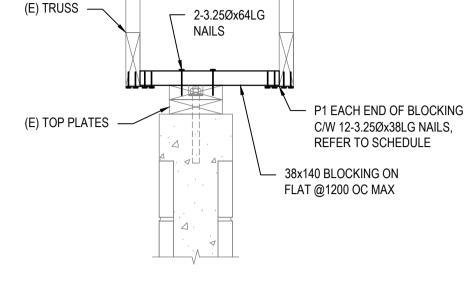





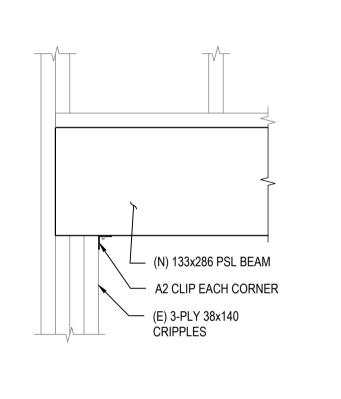



5 ELEVATION

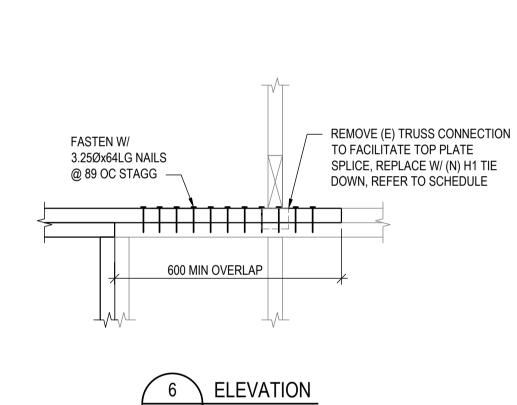

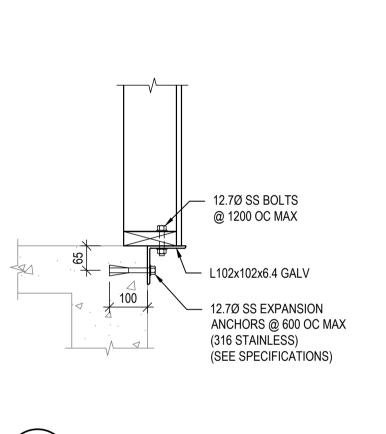


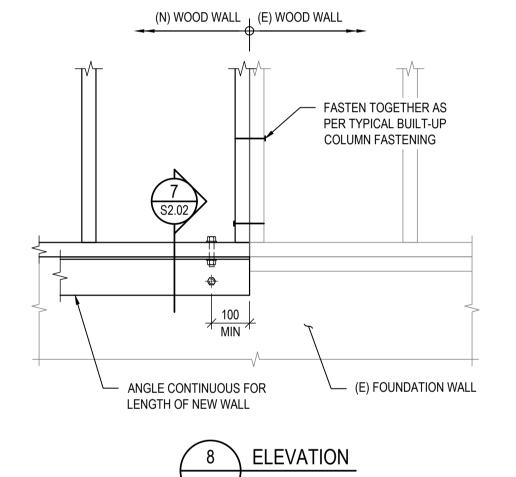


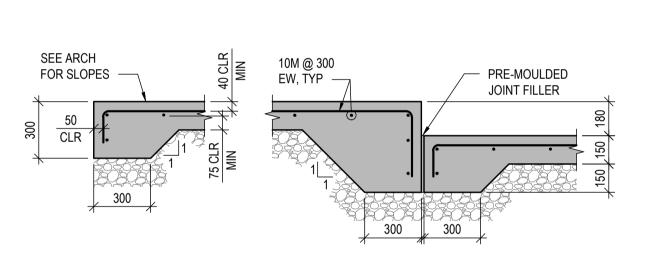


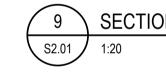



MIN HOOK LENGTH - 150 MIN REBAR LAP LENGTH - 450

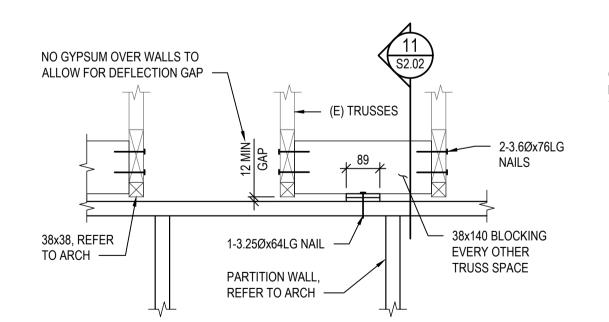

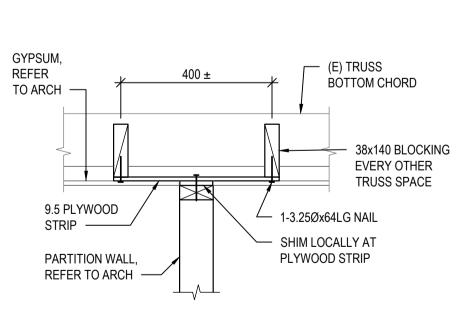

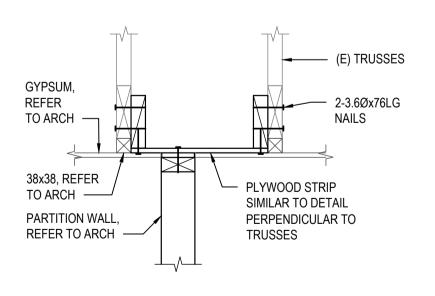

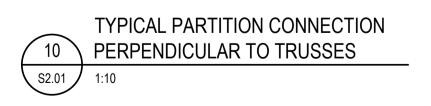

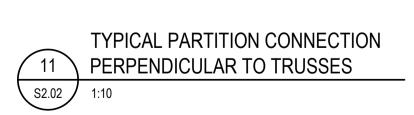



Public Works and Government Services Canada

Travaux publics et Services gouvernementaux Canada REAL PROPERTY SERVICES Pacific Region SERVICES IMMOBILIERS Région de Pacifique







0	ISSUED FOR TENDER	2019.12.09
В	99% REVIEW SUBMISSION	2019.10.25
А	50% REVIEW SUBMISSION	2019.09.13
Revision/ Revision	Description/Description	Date/Date
Client/client		

### **RCMP** 14200 Green Timbers Way Surrey, B.C.

Project title/Titre du projet

### RCMP ANAHIM LAKE **HOUSING RENOVATIONS**


Consultant Signature Box Only Designed by/Concept par CP Drawn by/Dessine par PWGSC Project Manager/Administrateur de Projets TPSGC Philip Fung PWGSC, Regional Manager, Architectural and Engineering Services/ Gestionnaire régionale, Services d'architectural et de génie, TPSGC Preetipal Paul Drawing title/Titre du dessin **ELEVATIONS, SECTIONS** 


**AND DETAILS** 

Project No./No. du projet **S2.02** R.103948.001

0 10 20 30 40 50 60 70 80 90 100mm

PWGSC - B1 - 1000X707

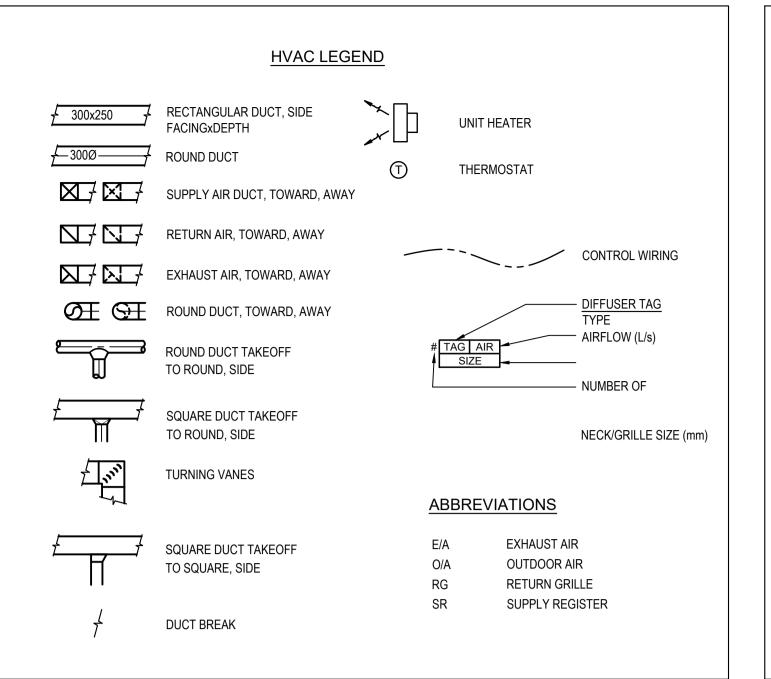

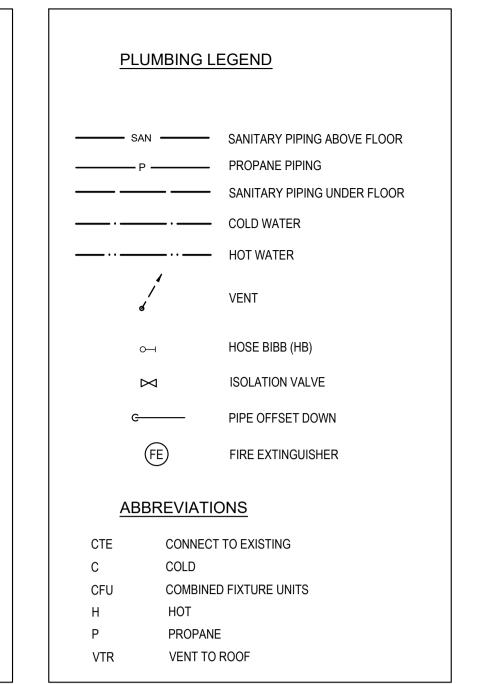

	MECHANICAL DRAWING LIST									
DRAWING NO.	DRAWING NAME	SCALE								
M0.01	M0.01 LEGEND, DRAWING LIST & SCHEDULES									
M1.00	PLUMBING AND MECHANICAL DEMOLITION	1:50								
M2.00	PLUMBING NEW	1:50								
M3.00	HVAC NEW	1:50								

GRILLE, F	GRILLE, REGISTER AND DIFFUSER SCHEDULE												
TAG	TYPE	BORDER	MATERIAL	CORE STYLE	ORIENT. DAMPER		FASTENING	FINISH					
SR1	SUPPLY REGISTER FLOOR	SURFACE	ALUMINIUM	BAR GRILLE NOTE 1	L	NO	CONCEALED	NOTE 2					
SR2	SUPPLY REGISTER CEILING / WALL	NOTE 1	ALUMINIUM	AIRFOIL DOUBLE DEFLECTION	L	YES	SCREW	NOTE 2					
RG1	RETURN GRILLE	NOTE 1	ALUMINIUM	AIRFOIL LOUVRED FIXED GRILLE	L, 45°, 20mm	NO	CONCEALED	NOTE 2					
ER1	EXHAUST REGISTER	NOTE 1	ALUMINIUM	AIRFOIL LOUVRED FIXED GRILLE	L, 45°, 20mm	YES	SCREW	NOTE 2					

NOTE:

1. BORDER/MOUNTING FRAME: ALUMINIUM FLAT FACE FOR WALL OR CEILING TO SUIT APPLICATION.
2. COLOUR TO ARCHITECTS CHOICE.

FURN.	ACE SCHEDUL	E							DIOAL	
TAG	TYPE	INPUT kW / MBH	OUTPUT kW / MBH	AFUE EFFICIENCY	AIR FLOW I/s / cfm	ESP Pa / in	MOTOR HP	_	TA PHASE	NOTES
F-1	PROPANE VERTICAL	17.6 / 60.0	17.3 / 59.0	97.4%	450 / 950	50 / 0.2	1	120	1	1, 2, 3

NOTES:

NOTES:

1. HEATING RATED AT: IAT 70°F(21.1°C), OAT 47°F(8.3°C).

2. COMPLETE WITH PROGRAMMABLE 7-DAY THERMOSTAT.3. COMPLETE WITH MERV 13 FILTERS.

HEAT R	ECOVERY V	/ENTILATOR SO	HEDULE										
			AID ELOW	EXT. STATIC				FILTER	RS	ELE	ECT DAT	A	
TAG	LOCATION	SERVICE	AIR FLOW I/s / cfm	PRESS. Pa / in	O/A EAT °C / °F	E/A EAT °C / °F	SENSIBLE EFFICIENCY	THICKNESS - NO. x SIZE	RATING	MOTOR W	VOLTS	PHASE	NOTES
HRV-1	GARAGE	OUTDOOR AIR	35 / 70	100 / 0.4	-17.8 / 0	23.9 / 75	66.0%	400x180x25	MERV 8	160	120	1	1
HKV-1	GARAGE	EXHAUST AIR	35 / 70	100 / 0.4	-17.0 / 0	23.9 / /5	00.0%	400x 160x25	IVIERVO	160	120	'	' '

### NOTE: 1. REFER TO SPECIFICATIONS

DUCT H	DUCT HEATER SCHEDULE								
TAG	SERVICE	DUCT SIZE		AIR FLOW I/s / cfm			NOTES		
		(DIA)	10			kW	VOLTS	PHASE	
EHC-1	VENTILAITON AIR	200	35	/	70	3	240	1	1

### NOTE: 1. REFER TO SPECIFICATIONS.

HEATING UNIT SCHEDULE								
TAG	TYPE	AIR FLOW	INLET	OUTLET	HEATING CAPACITY	ELECT		NOTES
	· · · · <del>-</del>	l/s / cfm			kW	VOLTS	PHASE	
UH-113	ELECTRIC UNIT HEATER	125 / 270	BACK	FRONT LOUVRE	3.0	240	1	1

NOTE:
1. CEILING MOUNTED UNIT COMPLETE WITH ALL MOUNTING AND SUSPENSION HARDWARE.

DOMESTIC HOT WATER HEATER									
TAG	TYPE	MINIMUM INPUT	MAXIMUM INPUT	DELIVER	RY TEMP.	FLOW	ELECT	DATA	NOTES
IAG	ITPE	kW / MBH	kW / MBH	MIN. °C / °F	MAX °C / °F	l/min / gpm	VOLTS	PHASE	NOTES
WH-1	TANKLESS PROPANE	5.3 / 18	58.3 / 199	26.7 / 80	60.0 / 140	10 / 2	120	1	1, 2

NOTE:
1. REFER TO SPECIFICATIONS.
2. UNIT COMPLETE CONCENTRIC VENT KIT.

HOOD SCH	EDULE						
TAG	SERVICE	AIR FLOW I/s / cfm	SONES	MOTOR HP	ELECT VOLTS		NOTES
RH-1	RANGE HOOD	140 / 300	1.5	0.65 Amp	120	1	1

NOTE: 1. HOOD COMPLETE WITH ALUMINUM ROOF CAP.

FAN SCHEDULE							
TAG	SERVICE	AIR FLOW	DIAMETER	POWER	ELECT	DATA	NOTES
TAG	SERVICE	I/s / cfm	mm / in	FOWER	VOLTS	PHASE	NOTES
CF-1	CEILING FAN	1490 / 3155	1321 / 52	18 W	120	1	1, 2
CF-2	CEILING FAN	1490 / 3155	1321 / 52	18 W	120	1	1, 2
CF-3	CEILING FAN	1490 / 3155	1321 / 52	18 W	120	1	1, 2


NOTE:
1. REFER TO SPECIFICATIONS.
2. AIRFLOW AT HIGH SPEED.

Public Works and
Government Services
Canada

REAL PROPERTY SERVICES
Pacific Region

SERVICES IMMOBILIERS
Région de Pacifique



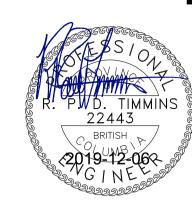

0	ISSUE FOR TENDER	2019-12-09
В	99% REVIEW SUBMISSION	2019-10-25
А	50% REVIEW SUBMISSION	2019-09-13
Revision/ Revision	Description/Description	Date/Date
Client/client		

RCMP 14200 Green Timbers Way Surrey, B.C.

Project title/Titre du projet

## RCMP ANAHIM LAKE HOUSING RENOVATIONS

Consultant Signature Box Only

Designed by/Concept par
PDT

Drawn by/Dessine par
RS

PWGSC Project Manager/Administrateur de Projets TPSGC
Philip Fung

PWGSC, Regional Manager, Architectural and Engineering Services/
Gestionnaire régionale, Services d'architectural et de génie, TPSGC
Preetipal Paul

Drawing title/Titre du dessin

LEGEND DRAWING LIST AND SCHEDULES

Project No./No. du projet


R.103948.001


Sheet/ Feuille

Revision no./
La Révision no.

0


DMENOVOO

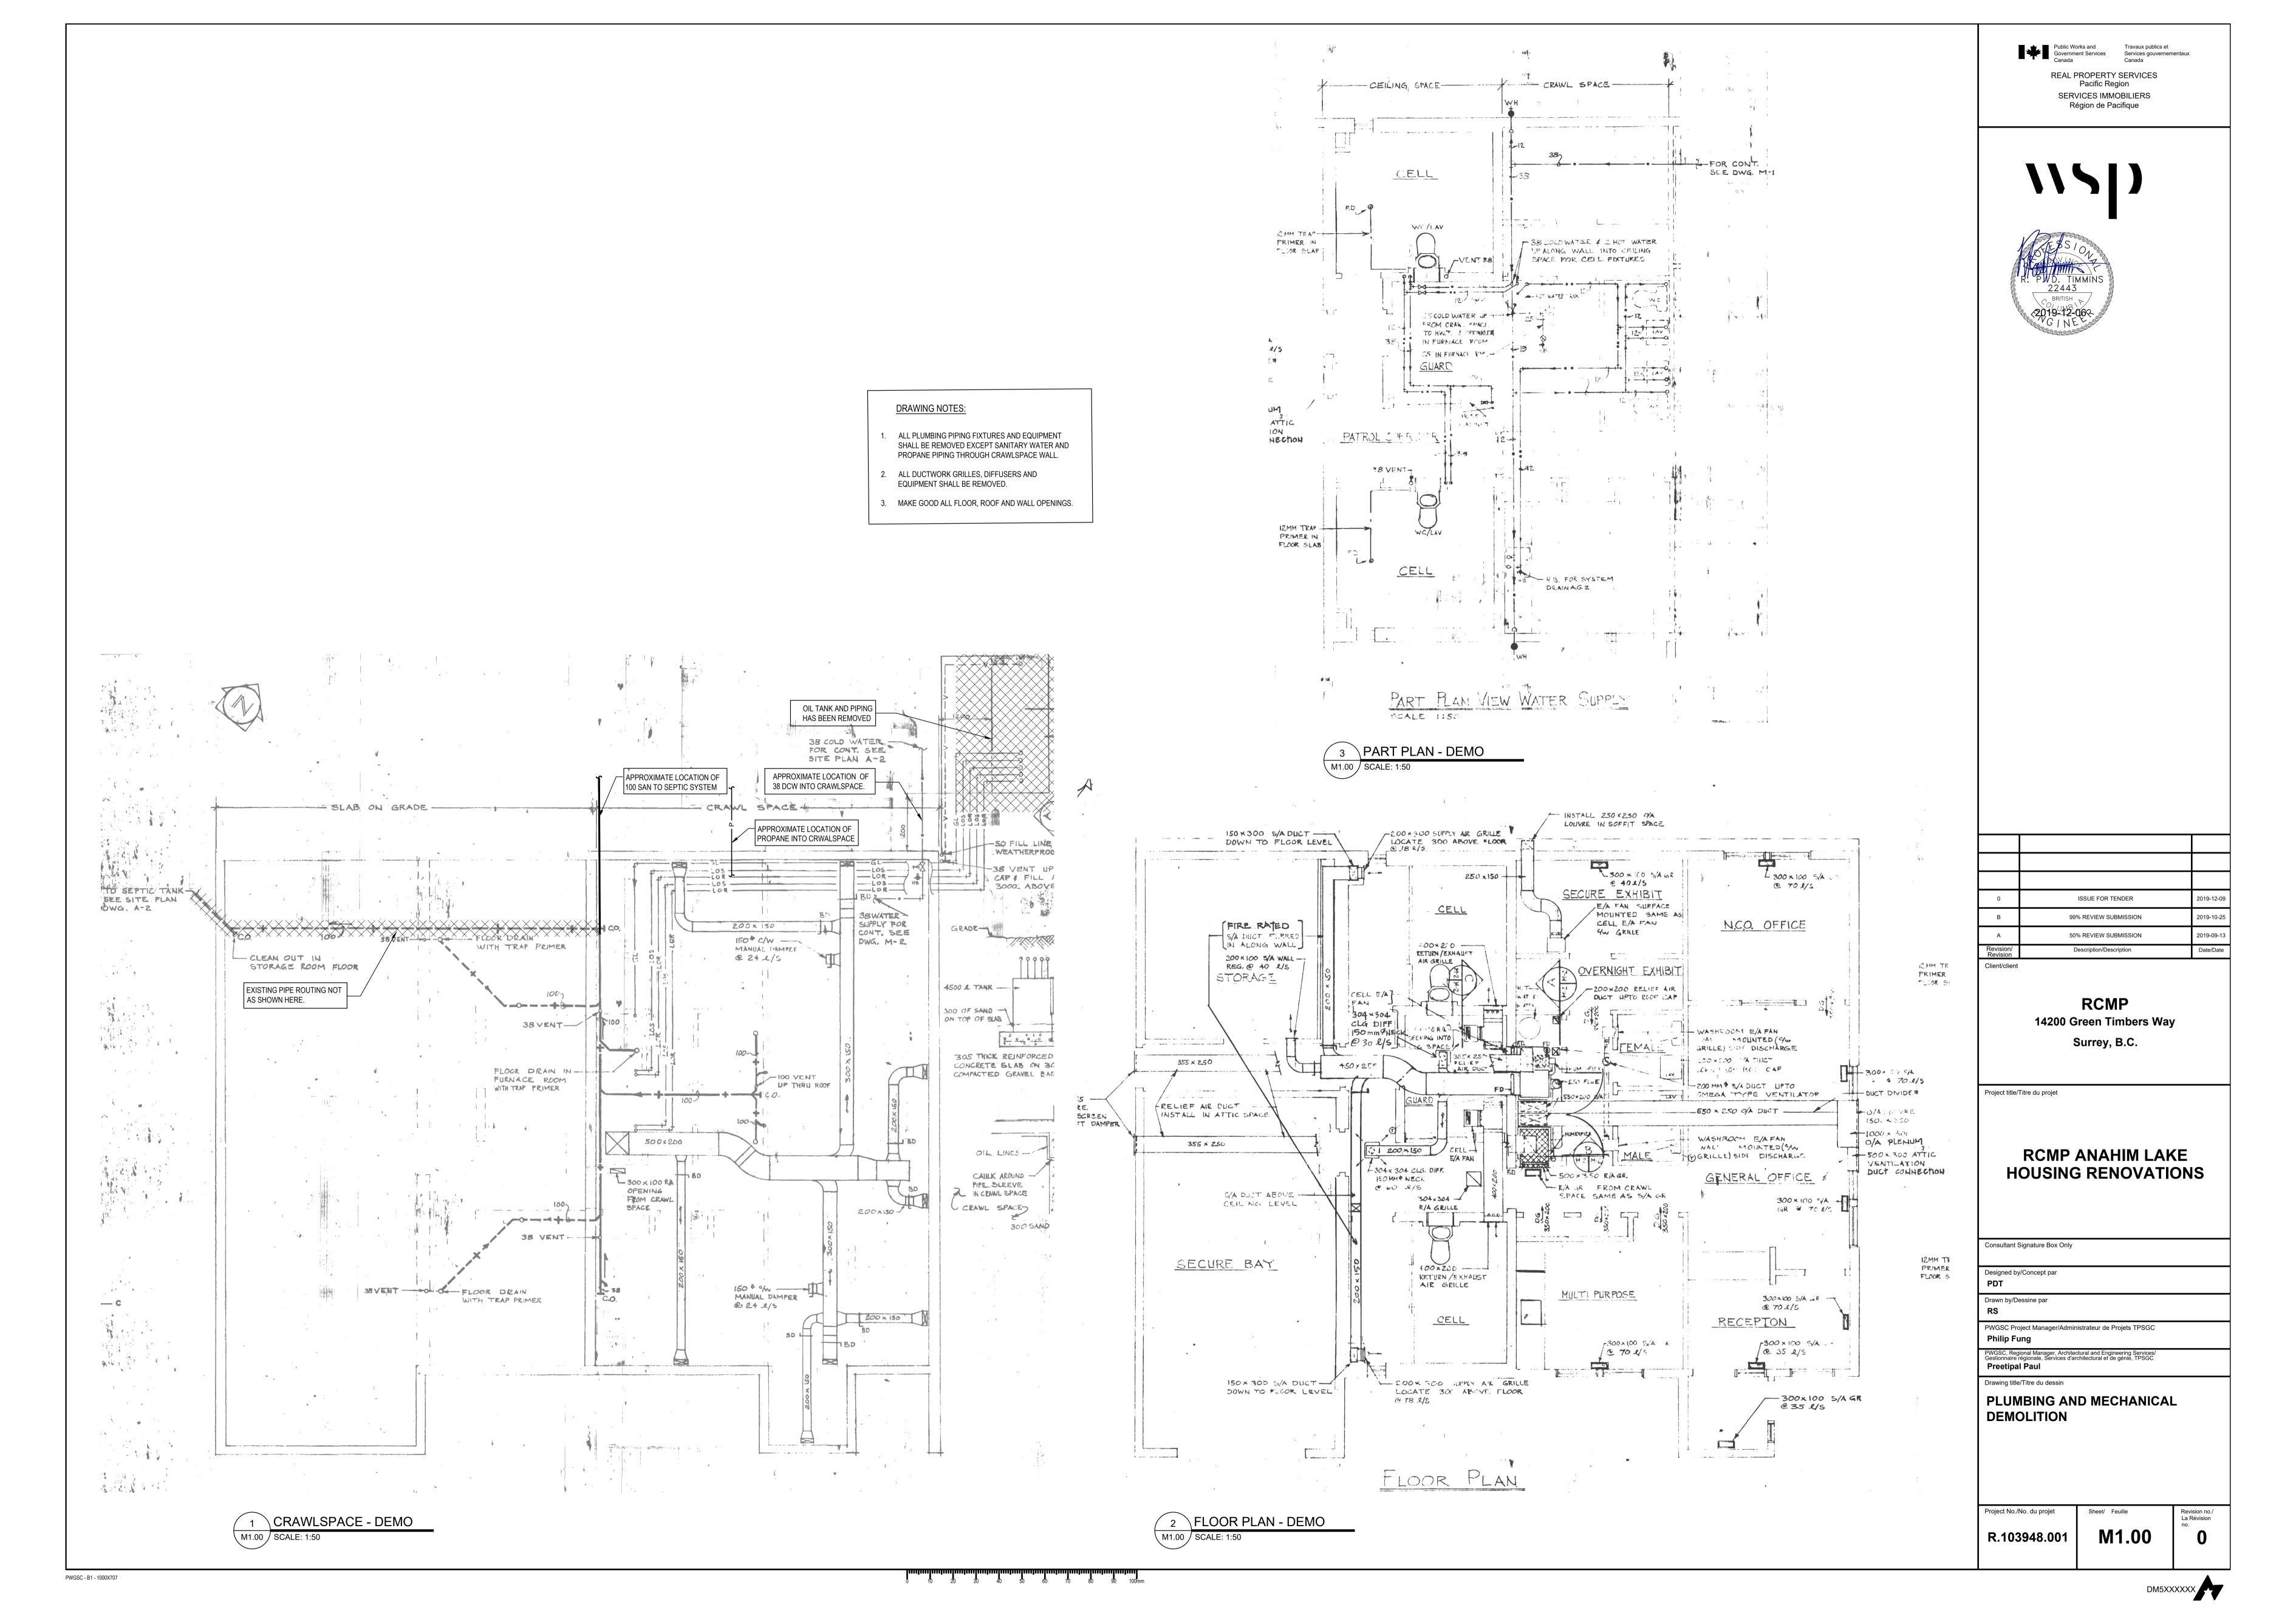

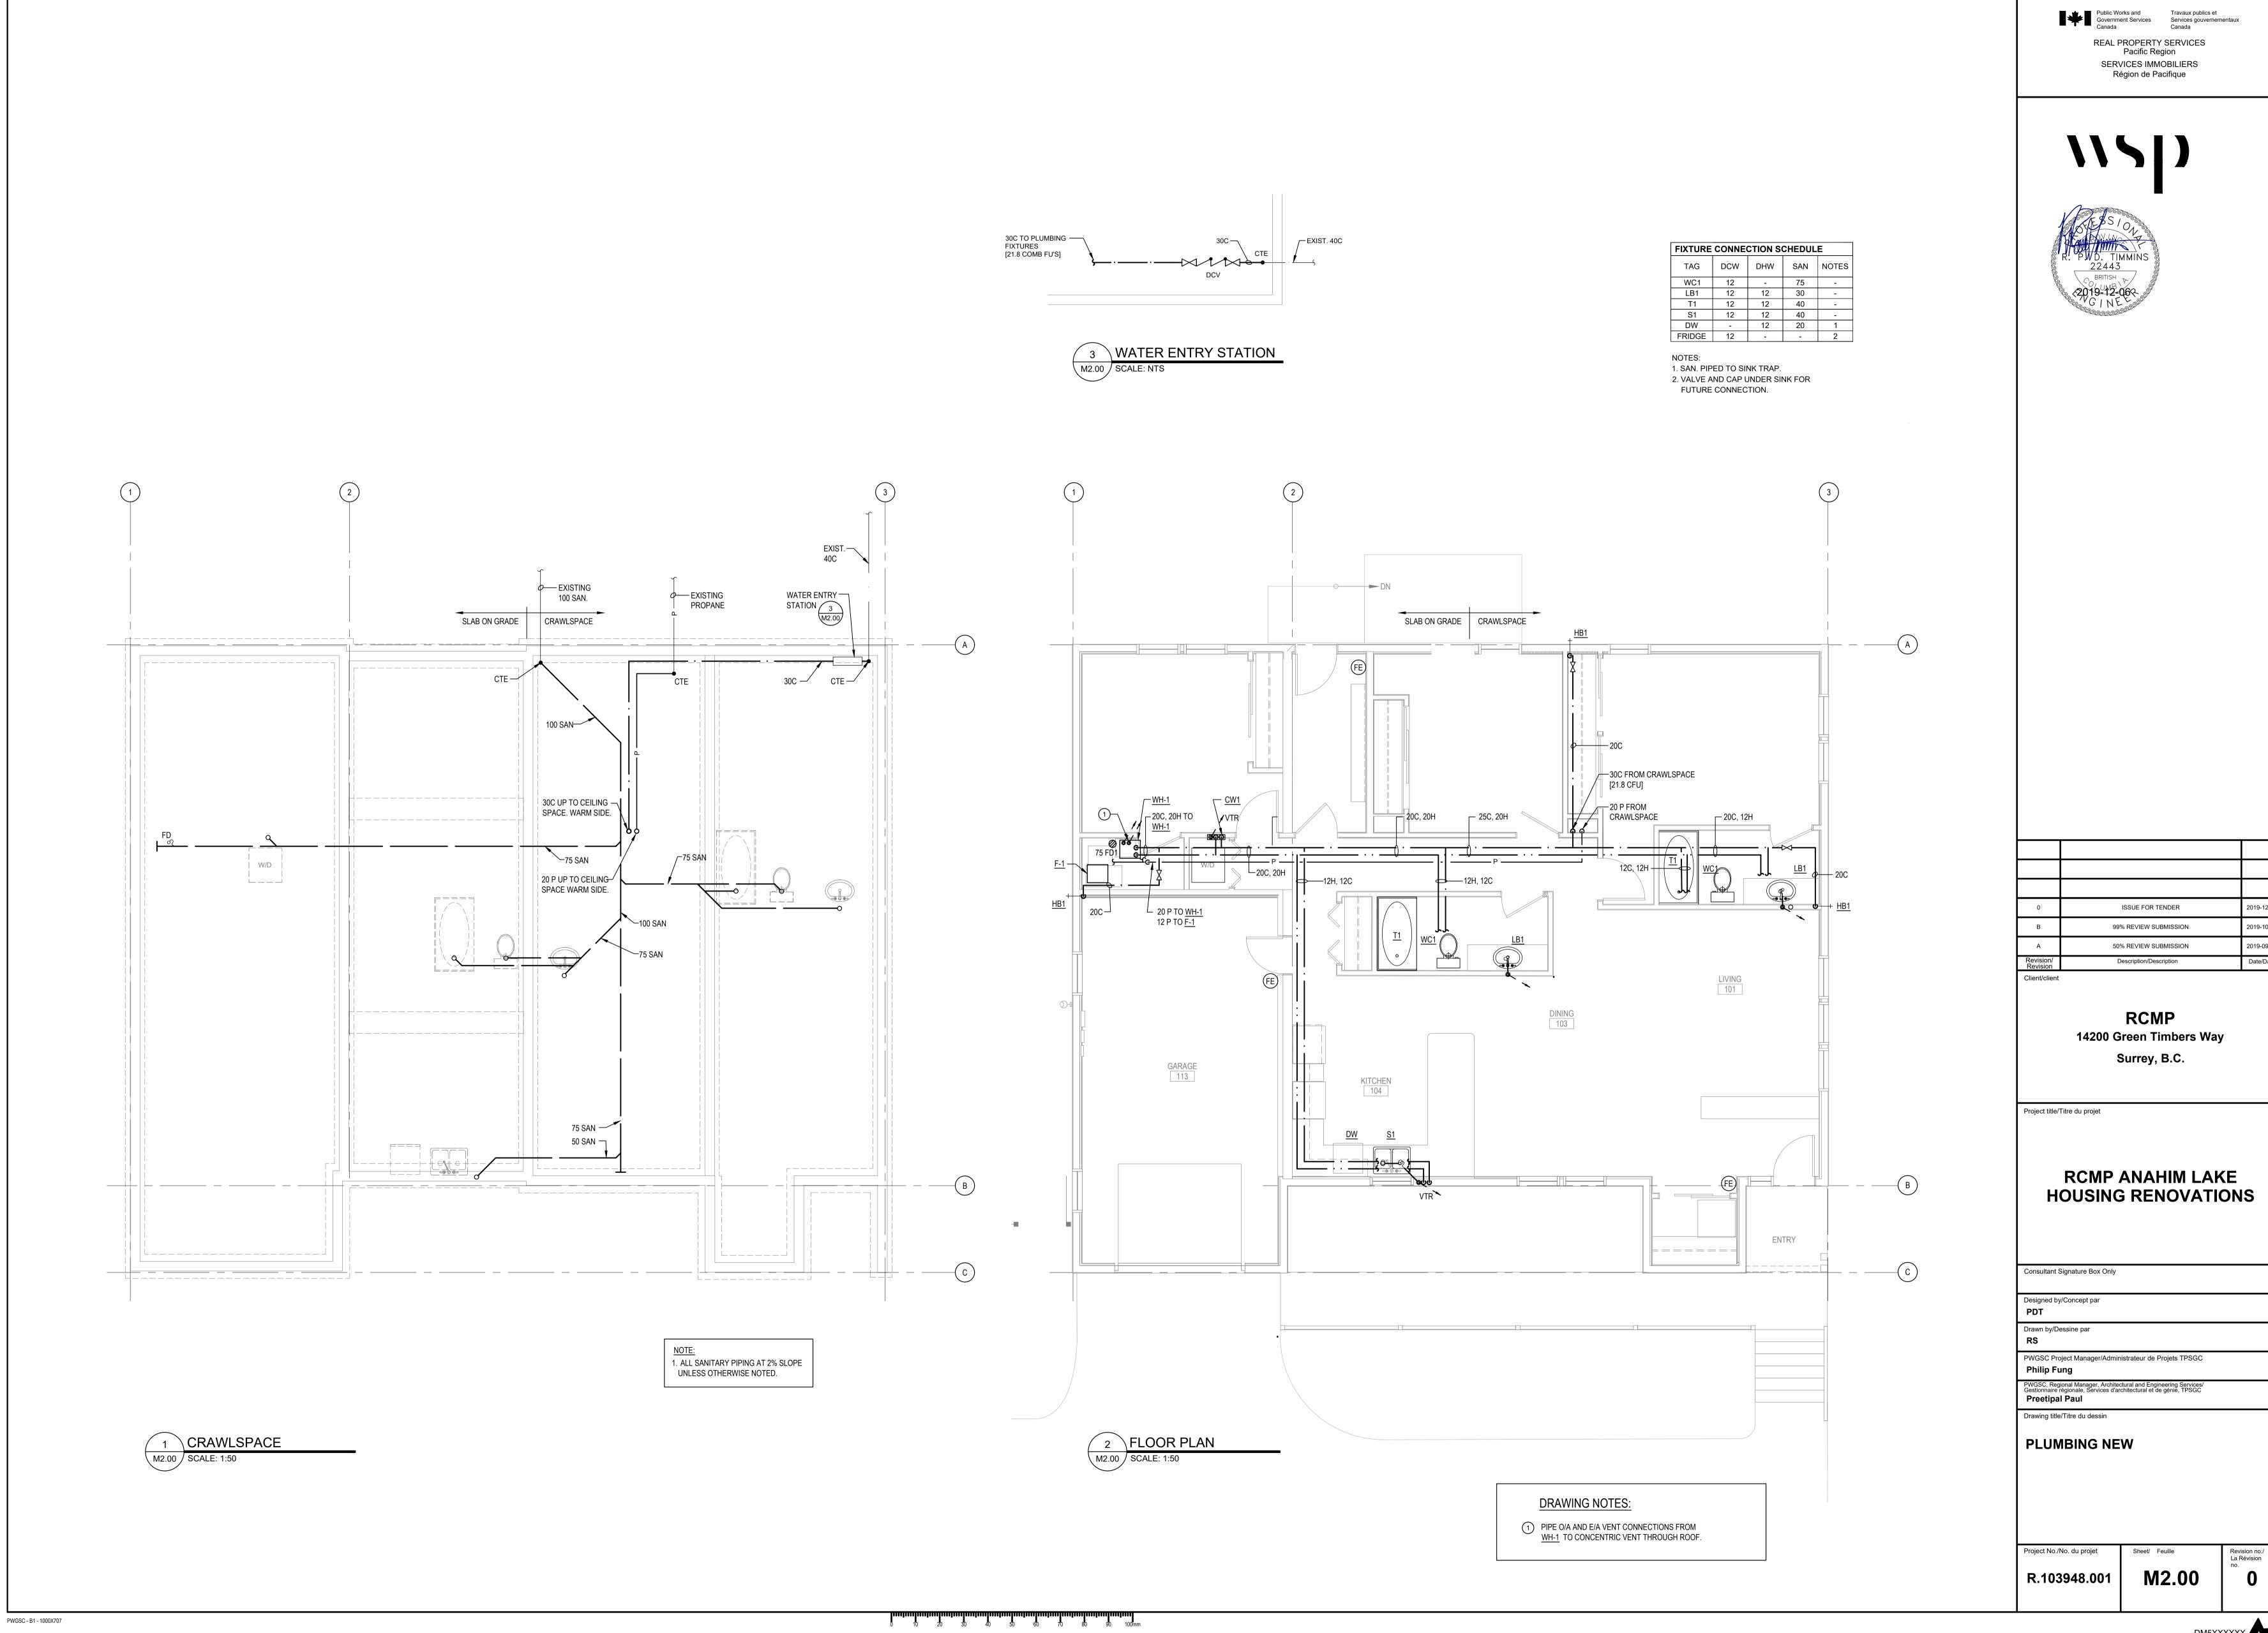

REAL PROPERTY SERVICES
Pacific Region
SERVICES IMMOBILIERS
Région de Pacifique SLAB ON GRADE CRAWLSPACE SLAB ON GRADE CRAWLSPACE ─ 300x100 150Ø ──<del>-</del> TYP. — 350x250 DOWN TO CRAWLSPACE — 400x300 DOWN TO FLOOR LEVEL 350x300 ① ¬ ALUMINUM DRYER — THROUGH ROOF 'A VENT THROUGH — 'ALL TO F-1 100Ø — A VENT THROUGH — OOF FROM F-1 ISSUE FOR TENDER 200x100 **X** 99% REVIEW SUBMISSION O/A INTAKE -WALL CAP 50% REVIEW SUBMISSION Z200Ø E/A UP
THROUGH ROOF
TO ROOF VENT 250Ø ——► LIVING 101 **RCMP** 14200 Green Timbers Way DINING 103 Surrey, B.C. 150 E/A UP THROUGH — ROOF TO ROOF VENT Project title/Titre du projet RCMP ANAHIM LAKE 300x100 —— UP └─ 300x100 **ENTRY** 1 CRAWLSPACE 2 FLOOR PLAN **DRAWING NOTES:** 1 IN TRUSS SPACE. 2 IN CEILING SPACE 0 10 20 30 40 50 60 70 80 90 100mm PWGSC - B1 - 1000X707 DM5XXXXXX


Public Works and Government Services Services gouvernementaux Canada

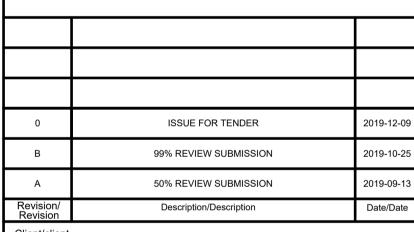

## **HOUSING RENOVATIONS**

Designed by/Conc PDT	ept par	
Drawn by/Dessine	par	
RS		
PWGSC Project M	anager/Administrateur de Projets TPSGC	
Philip Fung		
PWGSC, Regional M Gestionnaire régiona	anager, Architectural and Engineering Services/ le, Services d'architectural et de génie, TPSGC	
Preetipal Pau		
Drawing title/Titre	du dessin	

R.103948.0	001 M3.00	La Révision no.
Project No./No. du proje	et Sheet/ Feuille	Revision no

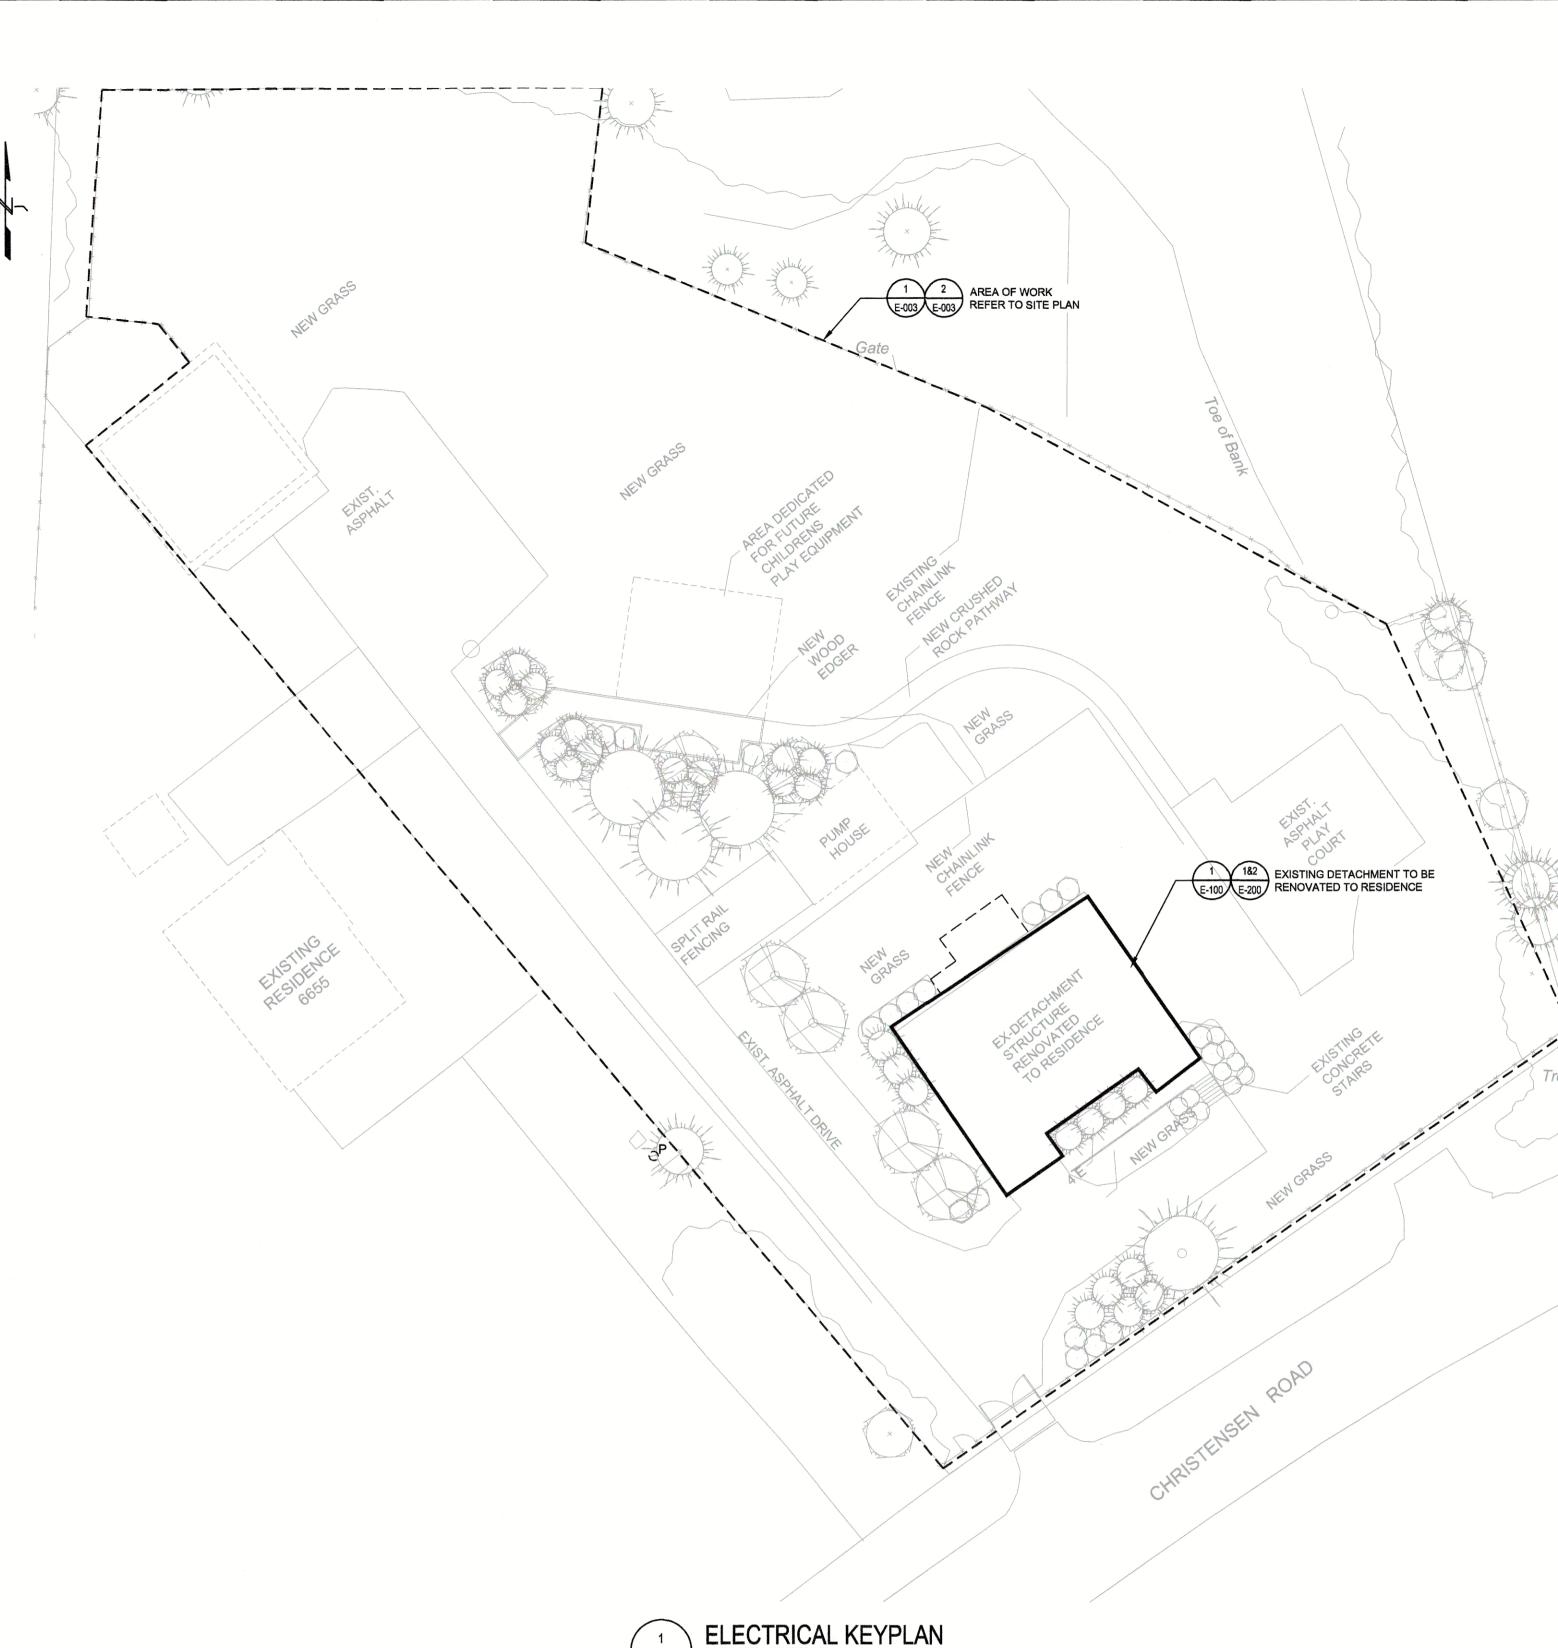

### **GENERAL NOTES:**

- CONTRACTOR SHALL READ ELECTRICAL DRAWINGS IN CONJUNCTION WITH ARCHITECTURAL, STRUCTURAL, MECHANICAL AND CIVIL DRAWINGS IN ORDER TO PROVIDE A COMPLETE AND ACCURATE
- CONTRACTOR SHALL PROVIDE ALL SEISMIC BRACING, RESTRAINTS, AND ASSOCIATED HARDWARE ENGAGE A STRUCTURAL ENGINEER TO ADVICE AND REVIEW SEISMIC ANCHORAGE AND RESTRAINT OF NEW ELECTRICAL EQUIPMENT/DEVICES.
- EXISTING INFORMATION WITHIN THESE DRAWINGS IS BASED ON INFORMATION PROVIDED BY OTHERS, EXTRACTED FROM HISTORICAL RECORDS AND SITE OBSERVATION. EXISTING INFORMATION IS PROVIDED TO FACILITATE THE CONTRACTOR IN PROVIDING A FAIR AND ACCURATE TENDER BID BY PROVIDING A GREATER UNDERSTANDING OF THE SCOPE OF WORK. BY NO MEANS SHALL THE CONTRACTOR RELY SOLELY ON THE EXISTING INFORMATION PROVIDED TO DETERMINE A COMPLETE AND FULLY ACCURATE SCOPE OF WORK AS NOT ALL ELECTRICAL EQUIPMENT, DEVICES OR ASSOCIATED EQUIPMENT THAT ARE REQUIRED TO BE RELOCATED, REMOVED OR REPLACED MAY BE NOTED. CONTRACTOR SHALL PERFORM A SITE VISIT TO DETERMINE THE EXACT SCOPE OF WORK PRIOR TO PROVIDING THEIR TENDER BID.
- WHERE IT IS REQUIRED TO REMOVE FIXTURES, ELECTRICAL DEVICES OR WIRING DEVICES BUT THE OUTLET BOX IS REQUIRED TO BE RETAINED TO MAINTAIN BRANCH CIRCUITS TO NEW DEVICES OR DEVICES TO REMAIN, CONTRACTOR SHALL PROVIDE THE NECESSARY WIRING SPLICES AND BLANK COVER PLATES. (MATCH EXISTING COLOR SCHEME). ALLOW TIME TO SITE VERIFY NOTED EXISTING CONDITIONS, CONTRACTOR SHALL NOTIFY ENGINEER OF ANY DISCREPANCIES.
- WHEN RELOCATING ELECTRICAL AND ASSOCIATED DEVICES CARE SHALL BE TAKE TO AVOID DAMAGE TO DEVICES BEING REMOVED, AND TO THE EXISTING DEVICES WITHIN BUILDING.
- MAKE GOOD ALL EXISTING SURFACES INCLUDING BUT NOT LIMITED TO DRYWALL, PAINT, CEILING TILES,
- CONTRACTOR SHALL X-RAY FLOORS/WALLS BEFORE CORING TO ACCOMMODATE NEW CONDUIT AND
- CONDUCTORS. ENGAGE A STRUCTURAL ENGINEER BEFORE CORING FLOORS. 8. ALL CONDUCTORS SHALL BE RUN IN CONDUIT SUITABLE FOR THE APPLICATION IN ACCORDANCE WITH
- CONTRACTOR TO FIELD LOCATE THE EXACT ROUTING OF ALL FEEDERS AND PROVIDE AN INSTALLATION
- THAT IS THE LEAST OBTRUSIVE AND DISRUPTIVE TO THE FACILITY.
- 10. ALL CONDUITS CROSSING A SEISMIC GAP OR EXPANSION JOINT SHALL ALLOW UP TO 150mm MOVEMENT IN ALL DIRECTIONS.

# DRAWING LIST DRAWING NUMBER | DRAWING TITLE

### ELECTRICAL KEYPLAN, LEGEND, DRAWING LIST AND GENERAL NOTES ELECTRICAL SINGLINE LINE DIAGRAM - EXISTING AND NEW ELECTRICAL SITE PLAN - EXISTING AND NEW ELECTRICAL FLOOR PLAN - DEMOLITION ELECTRICAL FLOOR PLAN POWER AND SYSTEMS, LIGHTING - NEW ELECTRICAL SCHEDULES ELECTRICAL DETAILS

### ELECTRICAL CODE LOAD

AS PER SECTION 8-200 C22.1-18 APPROXIMATE FLOOR AREA: 191m² a) SERVICE LOAD FIRST 90M2: 5000W

SECOND 90M2: 1000W III) HRV MECHANICAL LOAD: 3000W IV) ELECTRIC RANGE: 6000W

TOTAL: 23,500W @120/240V = 97.91A X 1.25 = 122.3A 200A SERVICE

### ANNOTATIONS DENOTE DESCRIPTION BOND WIRE (AS PER SPECIFICATIONS) FIRE ALARM GROUND WIRE (#6) GROUND FAULT INTERRUPTOR COMPLETE WITH SURGE PROTECTION DEVICE DISC TAMPER RESISTANT DISCONNECT RR REMOVE WEATHERPROOF EXISTING TO REMAIN WATER TIGHT EXISTING TO BE RELOCATED ABOVE FINISHED FLOOR REPLACE EXISTING WITH NEW DEVICE ABOVE FINISHED GRADE IN SAME LOCATION EXISTING DEVICE IN RELOCATED LOCATION SYMBOL DESCRIPTION MECHANICAL EQUIPMENT TAG REFERENCE NOTE (1 DENOTES SEE NOTE 1) KITCHEN EQUIPMENT TAG OWNER SUPPLIED EQUIPMENT TAG CONDUIT TAG REVISION IDENTIFICATION TAG PANEL IDENTIFICATION TAG NEW EQUIPMENT EXISTING EQUIPMENT TO REMAIN EXISTING EQUIPMENT TO BE REMOVED

### NOMENCLATURE

PANEL DESIGNATION CIRCUIT NUMBER -

### SINGLE LINE DIAGRAM SYMBOLS

1		
	SYMBOL	DESCRIPTION
		POWER TRANSFORMER.
	<b>.</b>	MOLDED CASE CIRCUIT BREAKER.
	0	UNFUSED VOLTAGE DISCONNECT SWITCH.
		FUSE DISCONNECT SWITCH.
		AUTOMATIC TRANSFER SWITCH WITHOUT MANUAL BYPASS
	M	METER
		BUSBAR
	<b>→</b>	H.V. POT HEAD
	(G)	GENERATOR
		PANELBOARD
		PANELBOARD COMPLETE WITH MAIN BREAKER

### POWER SYMBOLS

SYMBOL	DESCRIPTION
Ф	DUPLEX U-GROUND 15A, 125 VOLT, 2 POLE, 3 WIRE GROUNDING RECEPTACLE
WP GFI HK TL O/C U/C DW F W D MW	"WP" WHERE SHOWN, DENOTES DEVICE MOUNTED IN WEATHERPROOF F.S. BOX WITH WEATHERPROOF COVER "GFI" WHERE SHOWN, DENOTES GROUND FAULT INTERRUPTER TYPE DUPLEX RECEPTACLE "HK" WHERE SHOWN, DENOTES DEVICE DEDICATED TO "HOUSEKEEPING" SERVICE C/W ENGRAVED NAMEPLATE. "TL" WHERE SHOWN, DENOTES TWISTLOCK "OC" WHERE SHOWN, DENOTES OVER THE COUNTER MOUNTED "UC" WHERE SHOWN, DENOTES UNDER THE COUNTER MOUNTED "DW,F,W,D,MW" RESIDENTIAL EQUIPMENT: DISHWASHER, FRIDGE, WASHER, DRYER, MICROWAVE
₫\$	SIMILAR TO ABOVE, BUT MOUNTED APPROXIMATELY 3'-6" (1050 mm) ABOVE FINISHED FLOOR LEVEL OR ABOVE COUNTER, UNLESS OTHERWISE NOTED.
<b>₩</b>	DUPLEX U-GROUND 15A, 125V, 2P 3 WIRE GROUNDING RECEPTACLE PROTECTED BY G.F.C.I. BREAKER AT PANELBOARD. MOUNTED APPROXIMATELY 3'6" (1050 mm) ABOVE FINISHED FLOOR.
#	TWO DUPLEX U-GROUND 15A, 125 VOLT, 2 POLE, 3 WIRE GROUNDING RECEPTACLES IN COMMON FACEPLATE.
₩	SIMILAR TO ABOVE, BUT MOUNTED APPROXIMATELY 3'-6" (1050 mm) ABOVE FINISHED FLOOR LEVEL OR ABOVE COUNTER.
Ö	TAMPERPROOF (SAFETY SHUTTER) DUPLEX U-GROUND 15A, 125 VOLT, 2 POLE, 3 WIRE GROUNDING RECEPTACLE
#	15/20A, 125V, DUPLEX U-GROUND RECEPTACLE (5-20R)
<b>♦</b>	SPECIAL PURPOSE RECEPTACLE AS DENOTED
	HARDWIRED EQUIPMENT CONNECTION
PP LP	SINGLE SURFACE MOUNTED / FLUSH MOUNTED PANELBOARD, "PP" DENOTES POWER PANEL,"LP" DENOTES LIGHTING AND POWER PANEL,
LV LV	SINGLE SURFACE MOUNTED / FLUSH MOUNTED LOW VOLTAGE "LV" DENOTES LOW VOLTAGE PANEL
J	JUNCTION BOX
РВ	PULLBOX
<b>●</b> WP	FLUSH-MOUNTED PUSHBUTTON MOUNTED 4'-0" (1.2 m) ABOVE FINISHED FLOOR LEVEL. "WP" WHERE SHOWN, DENOTES WEATHERPROOF.
Ó	MOTOR
마	DISCONNECT SWITCH UNLESS NOTED OTHERWISE
	ELECTRIC BASEBOARD HEATER
Ū	THERMOSTAT
<b>•</b>	GROUND ROD

# LIGHTING SYMBOLS

SYMBOL	DESCRIPTION
	1'X4' SURFACE LUMINAIRE, LETTER "A" INDICATES LUMINAIRE TYPE AS PER LUMINAIRE SCHEDULE.
'B'	STRIP SURFACE LUMINAIRE, LETTER "F" INDICATES LUMINAIRE TYPE AS PER LUMINAIRE SCHEDULE.
,D,Q	CEILING MOUNTED RECESSED DOWNLIGHT
Δa	SURFACE MOUNTED DOWN LIGHT
©¤	CEILING MOUNTED PENDANT DOWN LIGHT
, E	WALL MOUNTED STRIP LIGHT, LETTER "E" INDICATES LUMINAIRE TYPE AS PER LUMINAIRE SCHEDULE.
,E,Q,	WALL MOUNTED LUMINAIRE, LETTER `E' INDICATES TYPE AS PER LUMINAIRE SCHEDULE.
<b>Ճ</b> 'A'	FLUSH WALL MOUNTED LUMINAIRE
<u> </u>	SURFACE MOUNTED TRACK LUMINAIRE, LENGTH AS INDICATED; NUMBER OF HEADS INDICATED
\$ \$ # \$	ONE, TWO, THREE LINE VOLTAGE TOGGLE SWITCH AND LOW VOLTAGE SWITCH MOUNTED 4'-0" (1.2m) ABOVE FINISHED FLOOR LEVEL. UNLESS OTHERWISE NOTED.
K P 3 4	"K" WHERE SHOWN, DENOTES KEY SWITCH "P" WHERE SHOWN, DENOTES SWITCH AND PILOT LIGHT "3" WHERE SHOWN, DENOTES 3-WAY SWITCH "4" WHERE SHOWN, DENOTES 4-WAY SWITCH
M DS T	"M" WHERE SHOWN, DENOTES MOTOR SWITCH "DS" WHERE SHOWN, DENOTES DOOR SWITCH "T" WHERE SHOWN, DENOTES MANUAL TIME SWITCH

\*\* - LETTER "A" INDICATES TYPE AS PER LUMINAIRE SCHEDULE - 3A-1-R1 INDICATES ALL LUMINAIRES CONNECTED TO PANEL 3A, CIRCUIT 1, RELAY 1.
- EMERGENCY SYSTEM, REFER TO LUMINAIRE SCHEDULE AND FLOOR PLANS FOR FURTHER DETAILS.
- 'NL' INDICATE NIGHT LIGHT, 24HR OPERATION

OCCUPANCY SENSOR - CEILING MOUNTED, WALL MOUNTED

"D" WHERE SHOWN, DENOTES DIMMER SWITCH

### COMMUNICATIONS SYMBOLS COMMUNICATION OUTLET (IF MULTIPLE DROPS ARE REQUIRED ADD TEXT) "2" WHERE SHOWN, DENOTES 2 DATA DROPS "4" WHERE SHOWN, DENOTES 4 DATA DROPS ANALOG TELEPHONE OUTLET. MINIMUM 4"(100mm) SQUARE BOX c/w PLASTER RING AND FACEPLATE. CABLE TELEVISION SIGNAL OUTLET. TELEPHONE/COMMUNICATIONS SIGNAL COPPER BUSS BAR (PRE-DRILLED)

	SECURITY SYMBOLS
SYMBOL	DESCRIPTION
DC	SECURITY SYSTEM DOOR ALARM CONTACTS, RECESSED IN DOOR AND FRAME.
MD	SECURITY SYSTEM MOTION DETECTOR
CR	SECURITY SYSTEM CARD READER OUTLET
K	SECURITY SYSTEM DISARMING KEYPAD
WP□□□	CEILING OR WALL MOUNTED CLOSED CIRCUIT TELEVISION CAMERA FOR SECURITY SYSTEM. "WP" DENOTES ENVIRONMENTAL HOUSING.
(INT) <sub>M</sub>	MASTER INTERCOM
<b>9</b>	SECURITY SYSTEM ALARM SPEAKER

	FIRE ALARM SYMBOLS	
SYMBOL	DESCRIPTION	
S <b>◆</b> A	COMBINATIONAL SMOKE ALARM / CARBON MONOXIDE DETECTOR (HARDWIRED CONNECTION)	

	SITE SYMBOL
SYMBOL	DESCRIPTION
<b>⊕</b> (∆)	EXTERIOR LUMINAIRE WITH POLE ASSEMBLY
<b>⊠</b> 'A'	EXTERIOR BOLLARD WITH LUMINAIRE
<b>₽</b> WP	WALL MOUNTED WEATHERPROOF PHOTOCELL
<b>●</b> ВСН	POWER POLE
<b>├</b>	UNDERGROUND POWER CONDUIT
} O/H}	OVERHEAD POWER CABLE
PB	PULL BOX (FIBRE GLASS, PVC, ETC.)



**SERVICES IMMOBILIERS** Région de Pacifique





0	ISSUED FOR TENDER	2019-12-09
В	99% REVIEW SUBMISSION	2019-10-21
Α	50% REVIEW SUBMISSION	2019-09-06
Revision/ Revision	Description/Description	Date/Date
Client/client		

RCMP 14200 Green Timbers Way Surrey, B.C.

RCMP ANAHIM LAKE **HOUSING RENOVATIONS** 

Consultant Signature Box Only		
Designed by/Concept par		
MRO		
Drawn by/Dessine par		
MRO		
PWGSC Project Manager/Administrateur de Projets TP	sgc	
Dianne Dy		
PWGSC, Regional Manager, Architectural and Engineering Ser Gestionnaire régionale, Services d'architectural et de génie, TP	vices/ SGC	

Drawing title/Titre du dessin **ELECTRICAL SITE PLAN, LEGEND AND GENERAL NOTES** 

R.103948.001 **E-001** 

KEYNOTES:

CONTRACTOR REMOVE DEMOLISH ALL EXISTING DISTRIBUTION INCLUDING CONDUCTORS, CONDUIT, JUNCTION BOXES, AT ALL ASSOCIATED ELECTRICAL DEVICES. TYPICAL OF ALL.

2 CONTRACTOR TO ABANDON DIRECT BURIED TECK CONDUCTORS IN PLACE WHERE IT IS UN FEASIBLE TO REMOVE. COIL EXISTING CONDUCTORS AT BUILDING BOUNDARY, PROVIDE LABEL INDICATING CONDUCTOR HEAD 3 CONTRACTOR TO DISCONNECT EXISTING ELECTRICAL CONNECTIONS TO GENERATOR. GENERATOR TO BE


TURNED OVER TO RCMP DEPARTMENT REPRESENTATIVE. CONTRACTOR TO DISCONNECT EXISTING ASCO 7000 SERIES AUTOMATIC TRANSFER SWITCH. ATS TO BE TURNED OVER TO RCMP DEPARTMENT REPRESENTATIVE.

5 CONNECT EXISTING GARAGE CIRCUITS TO NEW PANEL 'G' AS NOTED ON DRAWINGS.


Public Works and Travaux publics et Services gouvernementaux Canada Canada

REAL PROPERTY SERVICES Pacific Region SERVICES IMMOBILIERS Région de Pacifique



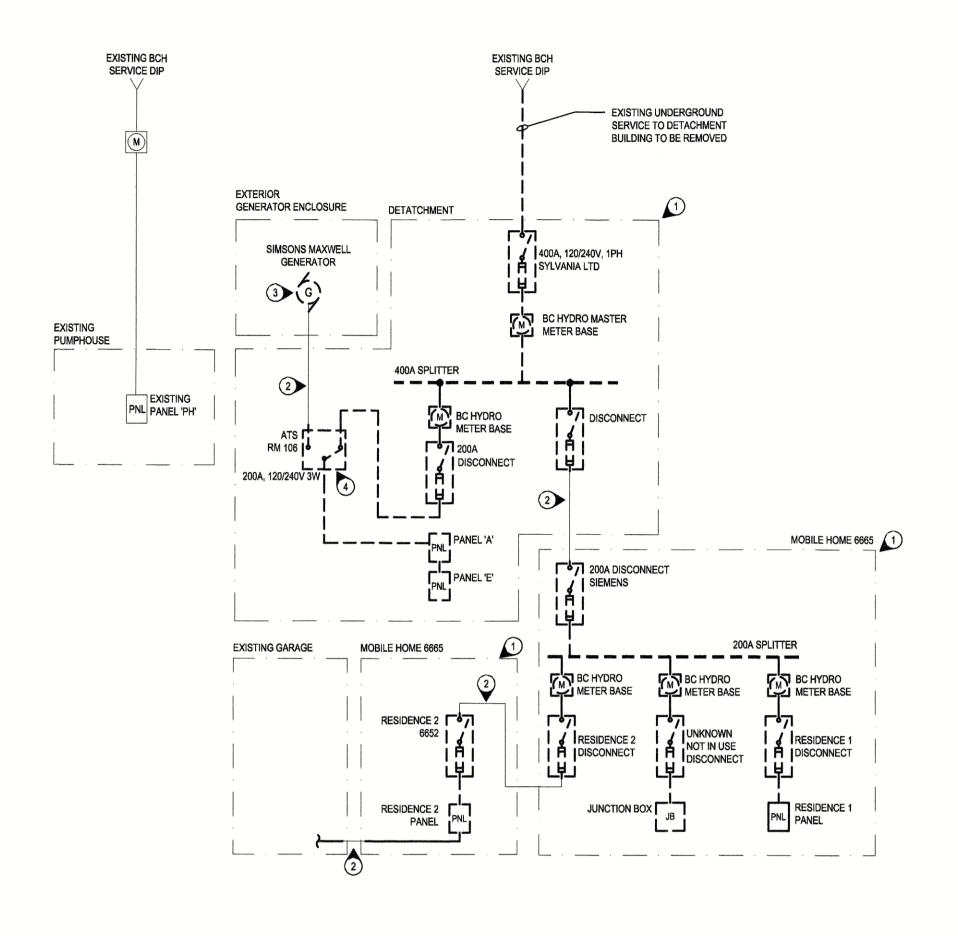

ELECTRICAL SINGLE LINE DIAGRAM - EXISTING 1 ELECTRI E-002 SCALE: NTS

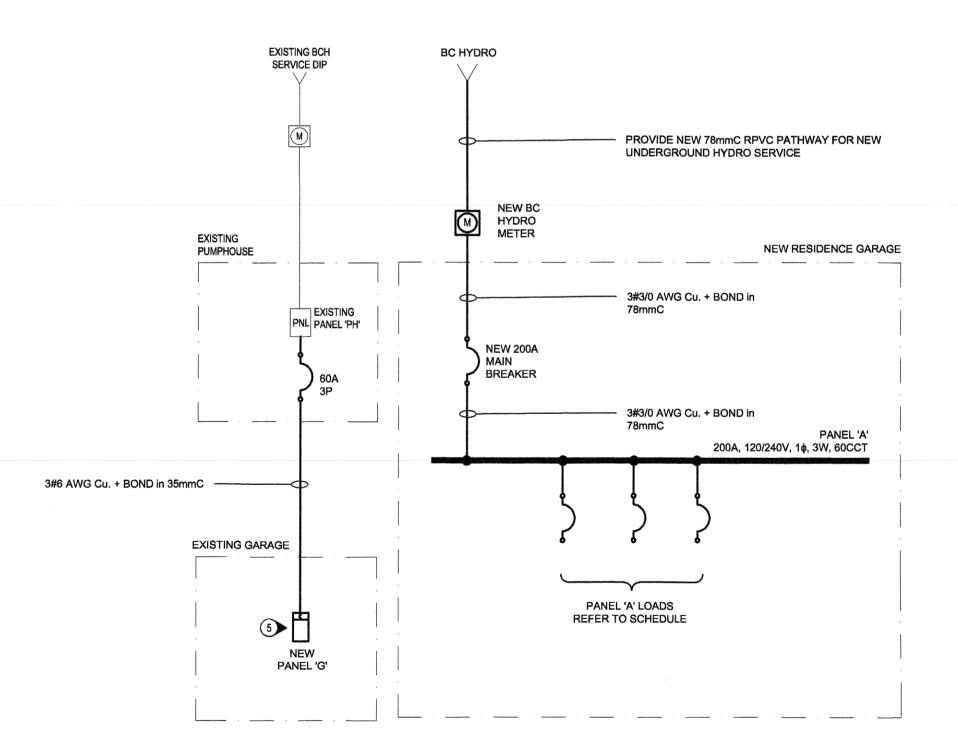

ELECTRICAL SINGLE LINE DIAGRAM - NEW

SCALE: NTS



0	ISSUED FOR TENDER	2019-12-09
В	99% REVIEW SUBMISSION	2019-10-21
Α	50% REVIEW SUBMISSION	2019-09-06
Revision/ Revision	Description/Description	Date/Date
Client/client		

**RCMP** 14200 Green Timbers Way

Surrey, B.C.

Project title/Titre du projet


### **RCMP ANAHIM LAKE HOUSING RENOVATIONS**

Consultant Signature Box Only Designed by/Concept par PWGSC Project Manager/Administrateur de Projets TPSGC Dianne Dy PWGSC, Regional Manager, Architectural and Engineering Services/ Gestionnaire régionale, Services d'architectural et de génie, TPSGC Philip Fung Drawing title/Titre du dessin **ELECTRICAL SINGLE LINE** DIAGRAM - EXISTING AND NEW

Revision no./ La Révision no. R.103948.001 **E-002** 

PWGSC - B1 - 1000X707

0 10 20 30 40 50 60 70 80 90 100mm

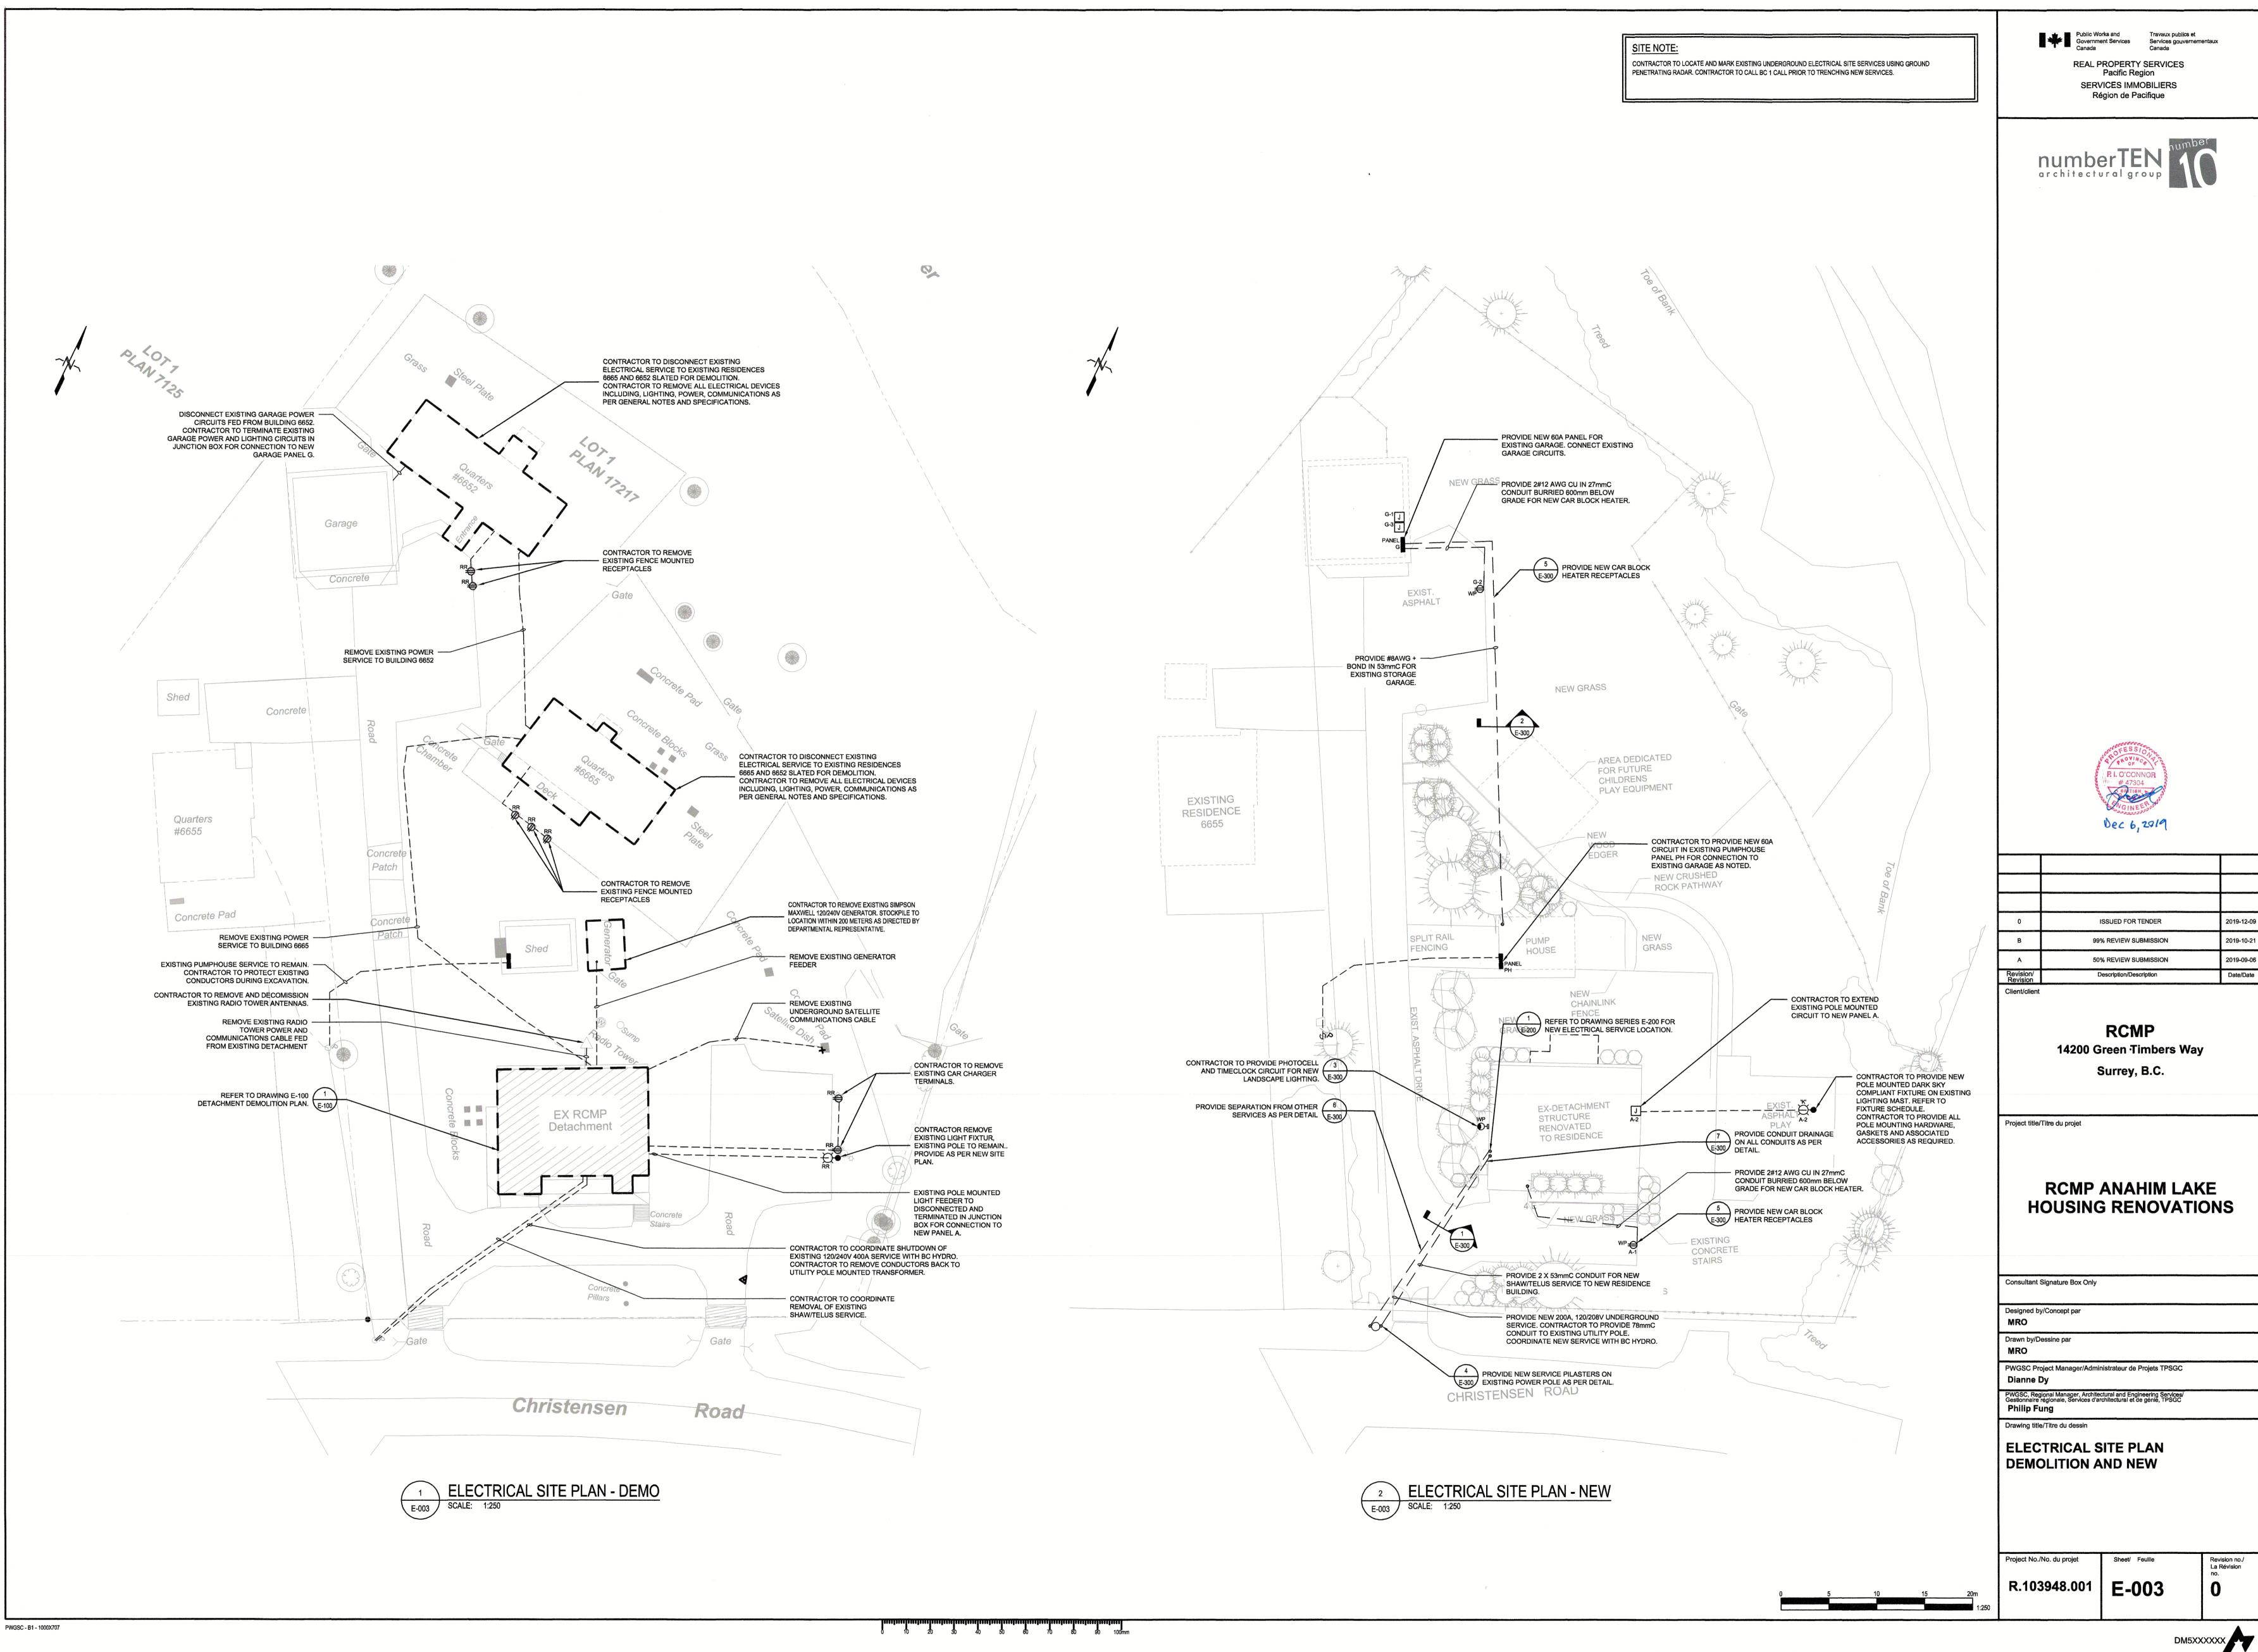


### **DEMOLITION NOTE:**

1. CONTRACTOR TO NOTE THAT THE SCOPE OF DEMOLITION INCLUDES REMOVAL OF ALL ELECTRICAL AND COMMUNICATIONS DEVICES INCLUDING BUT NOT LIMITED TO LIGHTING, RECEPTACLES, DISTRIBUTION, JUNCTION BOXES, LOW VOLTAGE CONTROLS, CONDUIT, COVE AND SECURITY AND ASSOCIATED ELECTRICAL EQUIPMENT. CONTRACTOR TO ATTEND SITE ASSESSMENT TO CONFIRM FULL SCOPE OF DEMOLITION, ANY CLARIFICATION REQUIRED TO BE BROUGHT TO THE ATTENTION OF THE CONSULTANT FOR CLARIFICATION DURING TENDER. ADDITIONAL DEMOLITION SCOPE IDENTIFIED BY THE CONTRACTOR AFTER TENDER WILL BE THE SOLE RESPONSIBILITY OF THIS CONTRACTOR AT NO ADDITIONAL COST TO THE CLIENT.

2. ALL SERVICES FEEDING EXISTING RESIDENCES 6655 AND 6652 TO BE DISCONNECTED AND REMOVED AS PER

- CONTRACTOR TO COORDINATE SHUTDOWN OF EXISTING SERVICE AND REMOVAL OF EXISTING SERVICE CONDUCTORS. CONTRACTOR TO REMOVE EXISTING WIREWAY, DISCONNECT, CONDUIT, CT CABINET AND METER
- 2 CONTRACTOR TO REMOVE EXISTING DISTRIBUTION AND ELECTRICAL DEVICES INCLUDING EXISTING SUB ANALOG METERING, DISCONNECTS, SPLITTERS, PANELS AND ALARM CONTACTORS.
- 3 CONTRACTOR TO DISCONNECT EXISTING GENERATOR ATS AND HANDOVER TO OWNERS FORCES. 4 CONTRACTOR TO REMOVE EXISTING MECHANICAL ROOM ELECTRICAL DEVICES INCLUDING CONTACTORS,
- RELAYS, TIMECLOCKS, ISOLATION TRANSFORMERS AND ASSOCIATED. CONTRACTOR TO DISCONNECT ALL MECHANICAL EQUIPMENT.
- 5 CONTRACTOR TO COORDINATE WITH SHAW/TELUS TO REMOVE EXISTING SERVICE PULLBOX AND ASSOCIATED
- 6 CONTRACTOR TO REMOVE EXISTING WALL MOUNTED COMMUNICATIONS AND ASSOCIATED NETWORK EQUIPMENT INCLUDING SATELITE ROUTER AND NETWORK PATCH PANELS.
- (7) CONTRACTOR TO EXISTING CCTV 2 POST RACK, PULLBOX, CONDUIT AND WIRING.

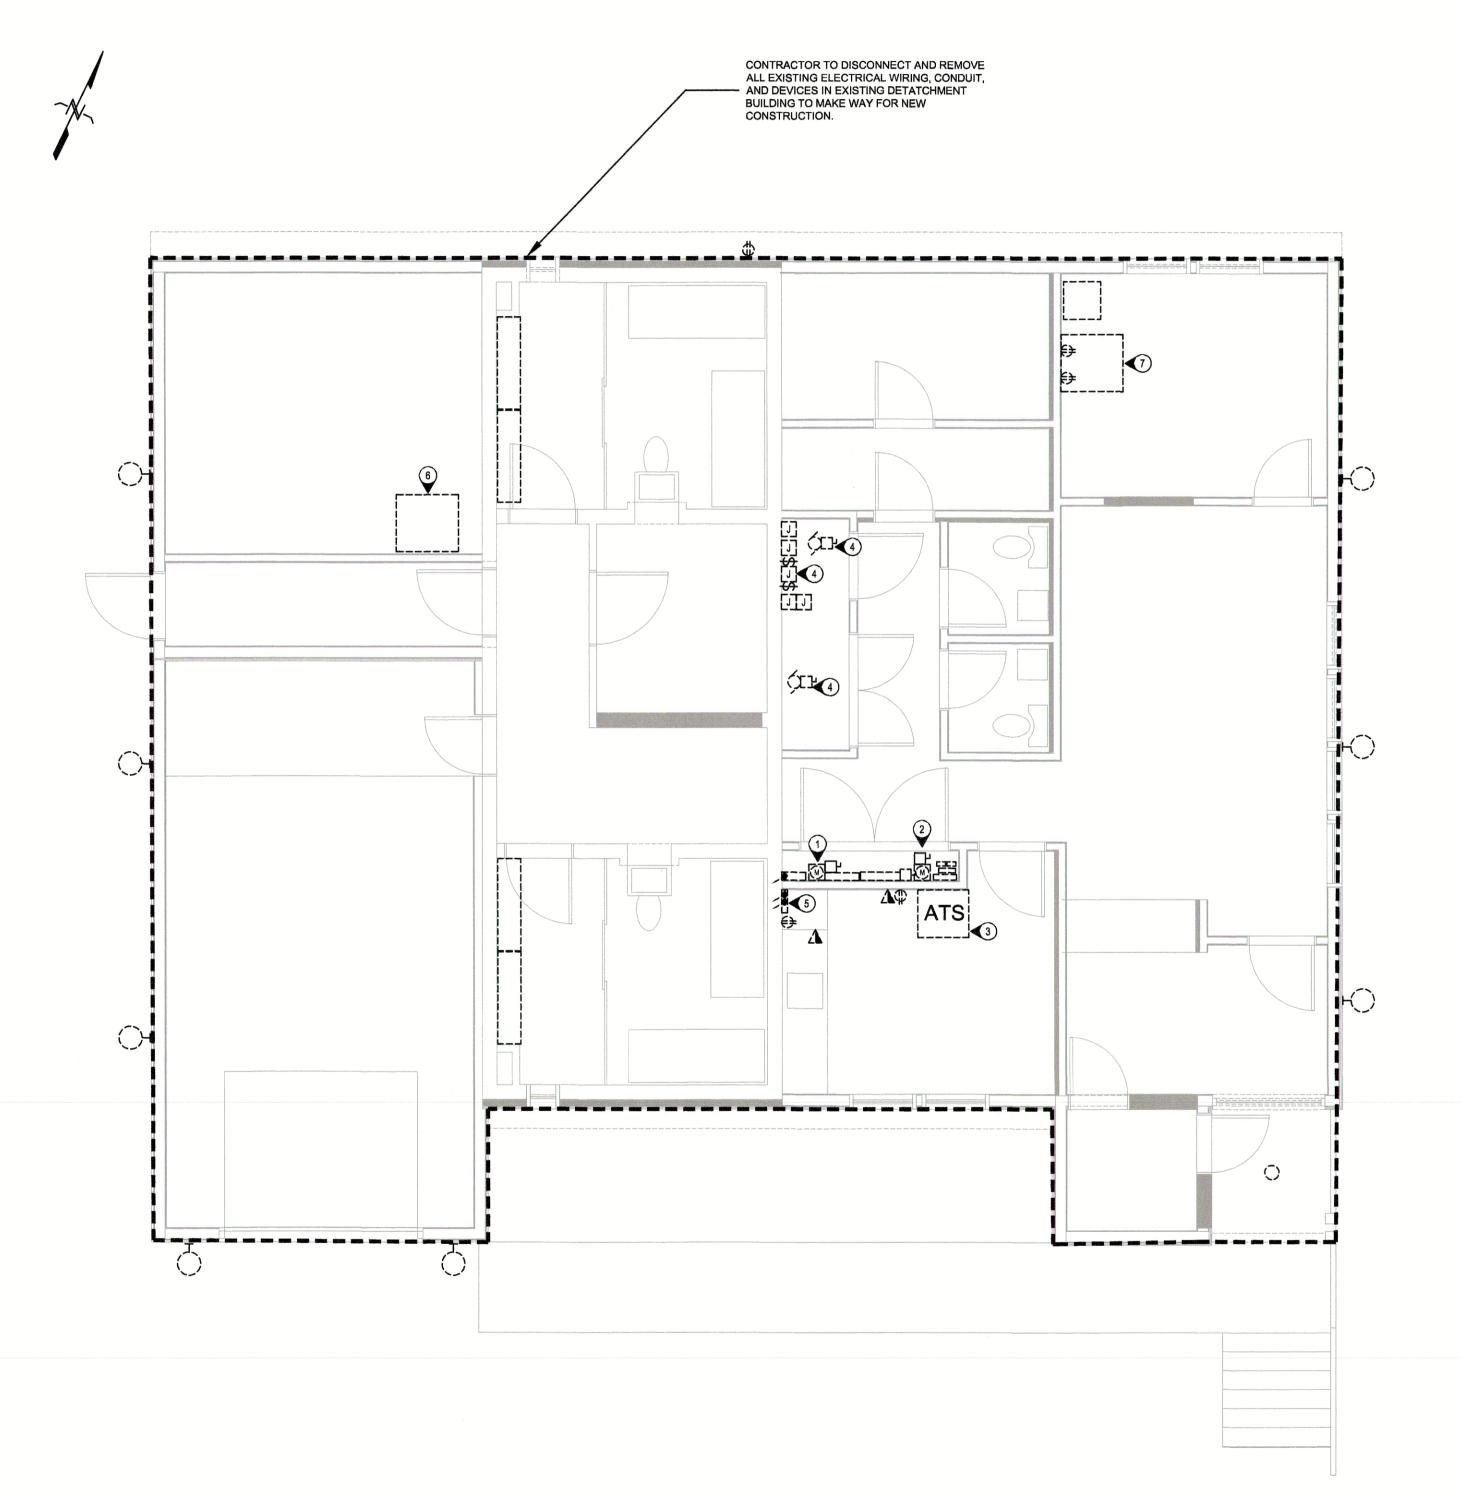



Public Works and Travaux publics et Services gouvernementaux Canada

REAL PROPERTY SERVICES
Pacific Region SERVICES IMMOBILIERS Région de Pacifique





0	ISSUED FOR TENDER	2019-12-09
В	99% REVIEW SUBMISSION	2019-10-21
А	50% REVIEW SUBMISSION	2019-09-06
Revision/ Revision	Description/Description	Date/Date

**RCMP** 14200 Green Timbers Way Surrey, B.C.

Project title/Titre du projet

RCMP ANAHIM LAKE **HOUSING RENOVATIONS** 

Consultant Signature Box Only

Designed by/Concept par

PWGSC Project Manager/Administrateur de Projets TPSGC


Drawing title/Titre du dessin

ELECTRICAL SITE PLAN

DEMOLITION AND NEW

Revision no./ La Révision

R.103948.001 | E-100

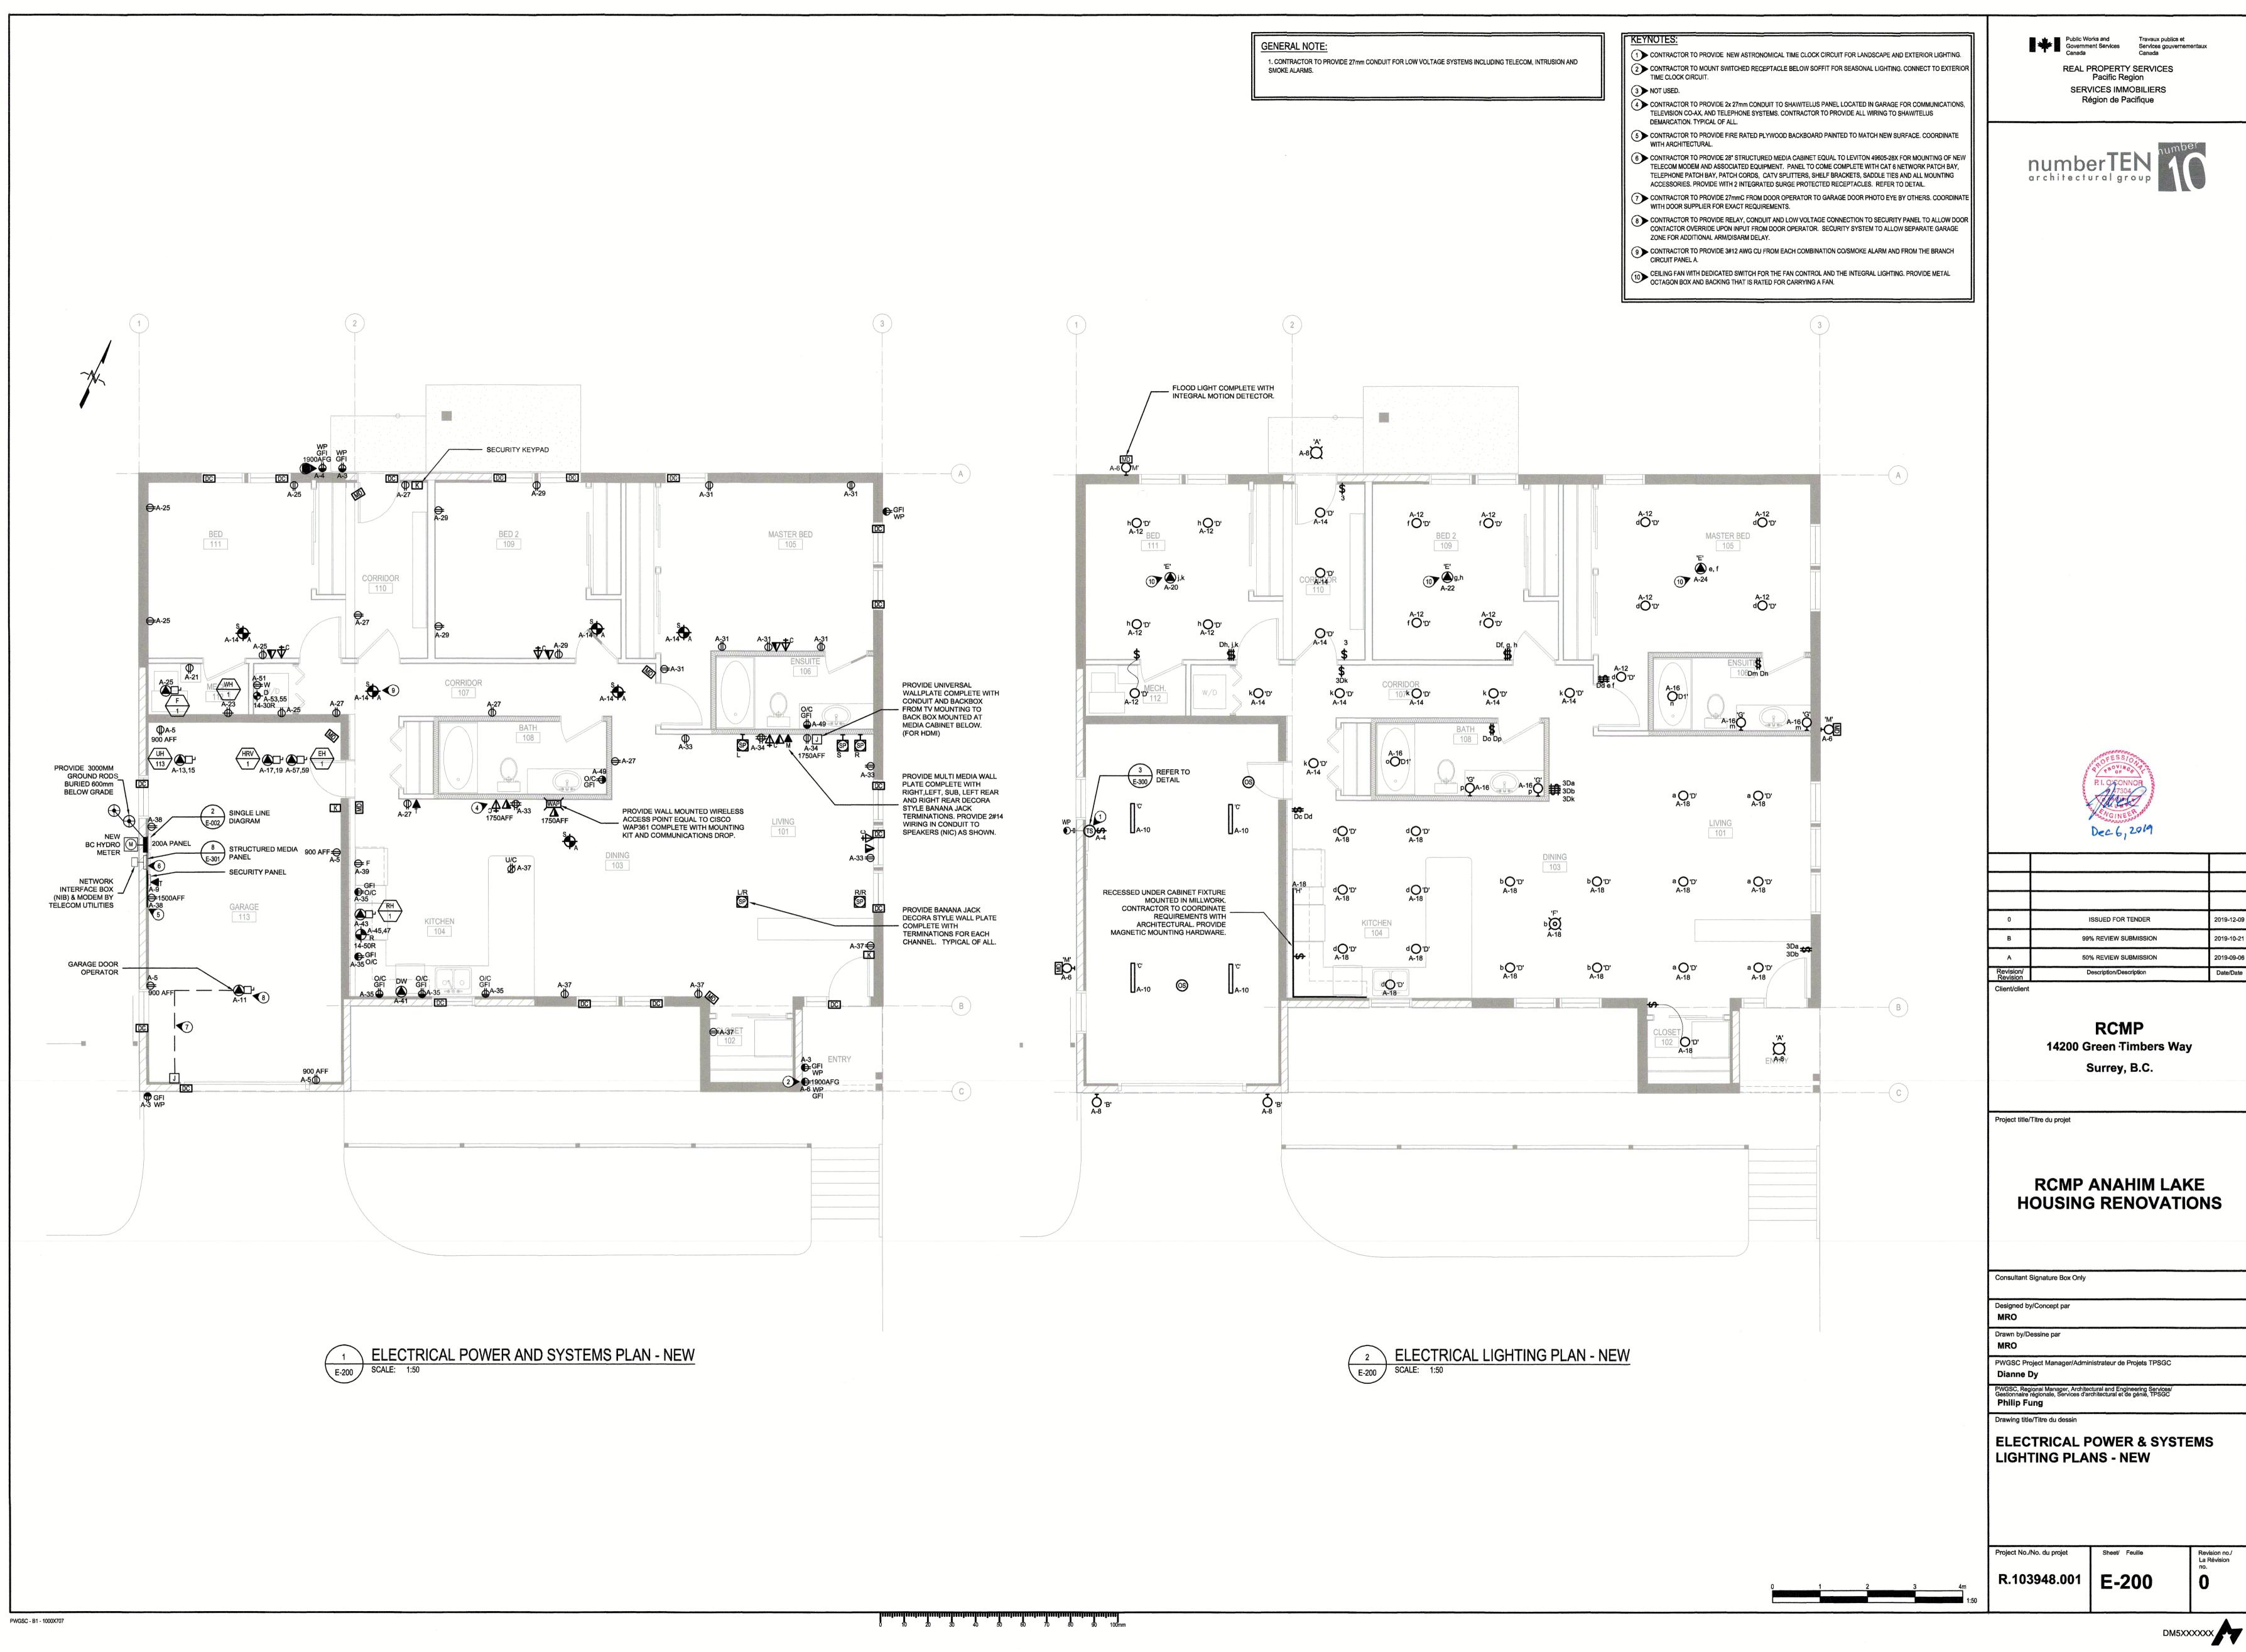

			LIGHTING FIXTURE SCHEDULE			
FIXTURE TYPE	DESCRIPTION	TYPICAL LOCATON	MIMIMAL ACCEPTABLE STANDARD	VOLTAGE	LIGHT SOURCE	NOTES
A	EXTERIOR CEILING MOUNT SEMI FLUSH	EXTERIOR ENTRNACE	BEGA - 55 942 - K3	UNV	744L, 8.7W, 3000K	IP65 WET LOCATION RATED COMPLETE WITH 120V DRIVER AND QUICK CONNECT CABL
В	EXTERIOR WALL SCONCE	GARAGE EXTERIOR	DALS - LEDWALL001D - BZ	UNV	540L, 7W, 3000K	WEATHERPROOF EXTERIOR FIXTURE COMPLETE WITH INTEGRAL DRIVER
С	SURFACE MOUNT STRIP	GARAGE INTERIOR	SIGNIFY - FSSEZ-4-40L-835-UNV-LSXR10	UNV	3653L, 32W, 3500K	COMPLETE WITH INTEGRAL MOTION SENSOR
D	RECESSED DOWNLIGHT	INTERIOR	WILLIAMS, HOUSING: 4DR-TL-L15-80-30-DIM-UNV TRIM: O-M-SG-MWT MOUNTING: N	UNV	1471L, 13.9W, 3000K	
D1	WET LOCATION RECESSED DOWNLIGHT	WASHROOM	WILLIAMS, HOUSING: 4DR-TL-L15-80-30-SCA-DIM-UNV TRIM: S-M-SG-WET/CC MOUNTING: N	UNV	1319L, 13.9W, 3000K	WET LOCATION, AIR TIGHT, NON CONDUCTIVE VERSION FOR SHOWER APPLICATION
E	CEILING FAN	BEDROOM	SPECIFIED BY OTHERS	UNV		
F	SUSPENDED FEATURE	LIVING ROOM	EUREKA - 4428-10-RAP-7-LED9-30-120-DV-C-60-WHE-WH-4902	120V		FAN LIGHT AND SWITCH TO BE SWITCHED VIA WALL SWITCH AT ROOM ENTRANCE.
G	WALL MOUNT VANITY	WASHROOM	ASTRO - TAKETA WALL 7633	120V		PROVIDE LED BULB
Н	UNDERCABINET	KITCHEN	VLT-ELL-8SL-4740-30-AL-D-LENGTH PER DRAWINGS - WE1-UL-MAG	120V		PROVIDE MAGNETIC MOUNTING SYSTEM
J	NOT USED					
К	EXTERIOR POLE MOUNT	EXTERIOR PLAY AREA	HE WILLIAMS - VA1-L110-7-30-T4-F-S-GRAY-DF-DIM	120V		
М	EXTERIOR FLOOD LIGHT	PERIMITER LIGHTING	WAC - WP-LED335-30-AGH MOTION DETECTOR: MS-120-GY	120V		

115	MECHANICAL EQUIPMENT SCHEDULE																								
RCMP An	ahim Lake Renovation			Proje	ct No:	191-1	0513-0	00												411.00					
				POWER REQUIREMENTS								START	ER		DI	SCON	IECT	T	CONT	ROL D	VICE				
TAG	DESCRIPTION	LOCATION	윺	KW	Volts	ЬН	AM FLA	PS MCA	OVERCURRE NT	SOURCE	FEEDERS	Single Pt Conn	Туре	Location	S	ı w	Туре	s	1	N T	уре	s	w	NOTES	
WH-1	Propane fired water heater	Mech Rroom			120	1			15	Α	2#12AWG CU + BOND IN 27mmC	Y	SS		M	и M		E	E	E	T	M	и м	1,16,17	
												Υ													
F-1	Gas Fired Furnace	Mech Rroom	1		120	1			15	Α	2#12AWG CU + BOND IN 27mmC		SS		M	M N		E	E	E	T	M	/ M	1,16	
HRV-1	Heat Recovery Ventilator	Garage			120	1	1.5		15	Α	2#12AWG CU + BOND IN 27mmC	Y	SS		M	и м		E	E	E	T	M	M N	1,16	
EHC-1	Duct Heaters - Electric	Garage		3	240	1			20	Α	2#12AWG CU + BOND IN 27mmC	Y	SS		M	M N		E	E	E	T	M N	ИМ	1,16	
UH-113	Electric unit heater	Garage		3	240	1			20	Α	2#12AWG CU + BOND IN 27mmC	Y	SS		M I	и м		Е	E	E	T	M I	и м	1,16	
RH-1	Range Hood	Kitchen	_		120	1	1.5		15	A	2#12AWG CU + BOND IN 27mmC	Y	SS		М	M N	<del> </del>	E	E	E	ss	M M	и м	1	

CONTROL DEVICE Ex = Existing W = Wired E = by Electrical DSC = Appliance Unfused Disconnect HOA = Magnetic Hand/Off/Auto REL = Relay AM = Airminder Timer HUM = Humidistat RAS = Rev Acting Stat. ND - Non - Fused Disconnect I = Installed w/t = wire to M = by Mechanical FASR = Fire Alarm System Relay MAG = Magnetic starter, no external control SS = Start/Stop I = Interlock T = Thermostat CO = CO detector FD - Fused Disconnect O = by Others OA = Off/Auto S = Supplied MAN = Unfused Manual Starter VFD = Var. Freq. Drive DDC = Bldg Automation (BAS) M = Manual TC = Time Clock (Max: 1/2 hp at 120V,2 HP at 208) WP = Weatherproof

GENERAL NOTES

1. Magnetic starters with pilot light and four auxiliary dry contacts for interlocks, 2 NO and 2 NC; thermal overload protection (review Mechanical shop drawings to ensure proper selection); flexible connections for power wiring to all equipment. 2. Electrical to confirm that all electrical panels in mechanical rooms can fit into the allocated space. (Electrical to review panel shop drawings for dimensions.) Shafts for ducts and/or pipes cannot used for electrical distribution. 3. Line voltage thermostats shall be supplied by Mechanical and installed by Electrical.

### 1. PROVIDE DISCONNECT FOR UNIT (WEATHERPROOF WHERE REQUIRED).

- 2. MOUNT AND CONNECT TO MECHANICALLY SUPPLIED STARTER/VFD 3. MOUNT AND CONNECT TO MECHANICALLY SUPPLIED THERMOSTAT
- 4. CONTROLS BY MECHANCIAL
- 5. UNIT TO SHUT OFF ON FIRE ALARM ACTIVATION
- 6. CONTROLLED VIA DDC, BY MECHANICAL 7. PROVIDE AND INSTALL 24V DC CONTACTOR FOR CONTROL BY MECHANICAL
- 8. PROVIDE AND INSTALL ON/OFF SWITCH COMPLETE WITH PILOT LIGHT 9. CONNECT TO 2P OCCUPANCY SENSOR
- 10. UNIT TO RUN CONTINOUSLY
- 11. PROVIDE AND INSTALL COMBINATION MAGNETIC STARTER C/W H/O/A SWITCH 12. PROVIDE AND INSTALL COMBINATION MAGNETIC STARTER C/W H/O/A SWITCH IN MCC
- 13. PROVIDE AND INSTALL RECEPTACLE ON UNIT WITH WEATHER PROOF COVER 14. CONNECT TO FLUID COOLER CONTROL PANEL; AND FROM CONTROL PANEL TO
- THE HEATER, FAN AND PUMP. REFER TO MECHANICAL AND ELECTRCIAL DRAWINGS
- 15. PROVIDE 15A RECEPTACLE CONNECTION
- 16. PROVIDE 21mmC FROM MECHANICAL CONTROLS TO UNIT
- 16. CONFIRM ON SITE DIRECT CONNECTION OR RECEPTACLE CONNECTION.

			NE	NP	ANE	L G			
	N			GAR Flus 60A 10 K	AGE h A			L 60A BREAKER	
сст	Description	Bkr	Х	Α	В	х	Bkr	Description	cc
1	EXISTING GARAGE POWER CIRCUITS	15A	NETTA STRUMENTS	X				EXTERIOR CAR BLOCK HEATER	2
3	EXISTING GARAGE POWER CIRCUITS	15A			X				4
5				X					6
7					X				8
9				X					10
11					X				12
13				X					14
15					X				16
17				X					18
19					X				20
21				X					22
23				TO SHARE	X	1	1		24

,				ienne einskuren in					
		EXI	STI	NG	PAI	NEL	PH		
		oltage: cation:					W		
		unting:				J3E			
* .		s Size:							
	Fault Current	_							
		Other:	-	COM	BINA	TION I	PANE	L 100A BREAKER	
					- AND THE STATE OF				
CCT	Description	Bkr	Х	Α	В	Χ	Bkr	Description	ССТ
11	BLANK	15A		X			604	GARAGE PANEL G	2
3	BLANK	15A			X		OOA	ONIVICE I AIVEE O	4
5	BLANK	15A		X					6
7	EXISTING HEAT TAPE	15A			X				8
9	EXISTING WELL PUMP	20A		X			15A	EXISTING FAN	10
11	Dio into Ville I oivii	20/1			X		15A	EXISTING PUMP	12
13	EXISTING ALARM SYSTEM	15A		X			154	EXISTING RECEPTAICLES	14
15	EXISTING LIGHTING	15A			X		15/	DICTIVO NECES TACEES	16
17	EXISTING RECEPTACLES	15A		X			154	EXISTING HEAT	18
19	Diolito Lou Inollo	10/4			X		10/4		20
21	BLANK			Х			1004	EXISTING SERVICE DISCONNECT	22
23	BLANK				X		1004	DIO III O DI VIOL DIOCOTALO	24

		Voltage:							
		Location:				CE G/	ARAGI	E 113	
		Mounting:							
		Bus Size:							
	Fault Curre	ent Rating:							
		Other:	-	COM	BINA	MOIT	PANE	L 200A BREAKER	
				1			T		
ССТ	Description	Bkr	Х	Α	В	Х	Bkr	Description	ССТ
1	CAR BLOCK HEATER	15A		X			20A	LIGHTING - PLAY COURT POLE	2
3	EXTERIOR - RECEPTACLE GFCI	15A			X		20A	PHOTOCEL/TIMECLOCK/RELAYS	4
5	GARAGE - RECEPTACLES	15A					20A	LIGHITING - EXTERIOR FLOOD	6
7	MEDIA CENTER PANEL POWER	15A		Х			20A	LIGHITING - EXTERIOR ENTRNACE	8
9	SECURITY PANEL POWER	15A			X		20A	LIGHITING - GARAGE	10
11	GARAGE DOOR OPERATOR	15A					20A	LIGHITING - BEDROOMS	12
13	GARAGE UH-113	20A		X			20A	LIGHITING - CORRIDORS	14
15	GARAGE OH-113	20A			X		20A	LIGHITING - WASHROOMS	16
17	CARACE URV 4	200					20A	LIGHITING - KITCHEN / LIVING	18
19	GARAGE HRV-1	20A		X			15A	BEDROOM (111) CIRCULATION FAN	20
21	FURNACE F-1	15A			X			BEDROOM (109) CIRCULATION FAN	22
23	WATER HEATER WH-1	15A						BEDROOM (105) CIRCULATION FAN	24
25	BED 111 - RECEPTACLES	15A		X					26
27	CORRIDOR RECEPTACLES	15A			X				28
29	BED 109 - RECEPTACLES	15A					1		30
31	BED 105 - RECEPTACLES	15A		X					32
33	LIVING ROOM - RECEPTACLES	15A			X		15A	LIVING ROOM MEDIA RECEPTACLE	34
35	KITCHEN - RECEPTACLES GFCI	15A					_	SMOKE ALARMS (RED BREAKER)	36
37	LIVING - RECEPTACLES	15A		X				GARAGE PANEL RECEPTACLE	38
39	FRIDGE	15A			Х		_	SPARE	40
41	DISHWASHER	15A			A Color		15A	SPARE	42
43	RANGE HOOD	15A		Х			15A	SPARE	44
45	RANGE	50A			Х		15A	SPARE	46
47	MINGE	SUA					15A	SPARE	48
49	WASHROOM - RECEPTACLES GFCI	15A		Х			15A	SPARE	50
51	WASHER	15A			Χ			SPARE	52
E2					75 05 110		AEA	ODADE	EA

15A SPARE 15A SPARE

X 15A SPARE 15A SPARE

59 GARAGE EH-1

**NEW PANEL A** 

Voltage: - 120/240V, 3P, 4W

Public Works and Travaux publics et Services gouvernementaux Canada Canada

REAL PROPERTY SERVICES Pacific Region SERVICES IMMOBILIERS Région de Pacifique





0	ISSUED FOR TENDER	2019	9-12-09
В	99% REVIEW SUBMISSION	2019	9-10-21
A	50% REVIEW SUBMISSION	2019	9-09-06
Revision/ Revision	Description/Description	Dat	te/Date

Client/client

**RCMP** 14200 Green Timbers Way Surrey, B.C.

Project title/Titre du projet

### RCMP ANAHIM LAKE **HOUSING RENOVATIONS**


Consultant Signature Box Only Designed by/Concept par PWGSC Project Manager/Administrateur de Projets TPSGC


Dianne Dy PWGSC, Regional Manager, Architectural and Engineering Services/ Gestionnaire régionale, Services d'architectural et de génie, TPSGC Philip Fung


Drawing title/Titre du dessin

ELECTRICAL SCHEDULES

R.103948.001 **E-300** 

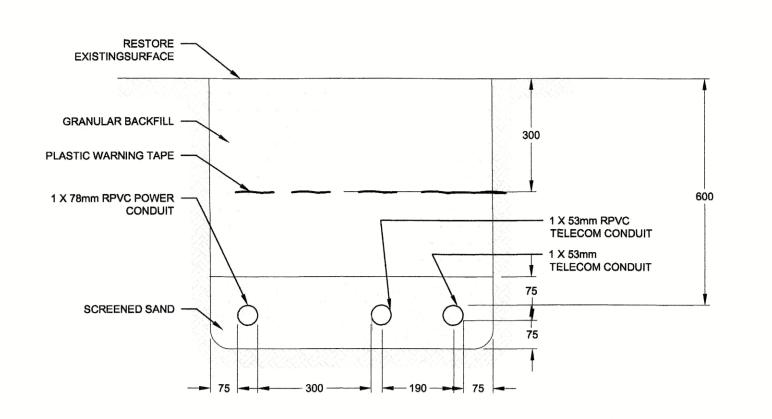


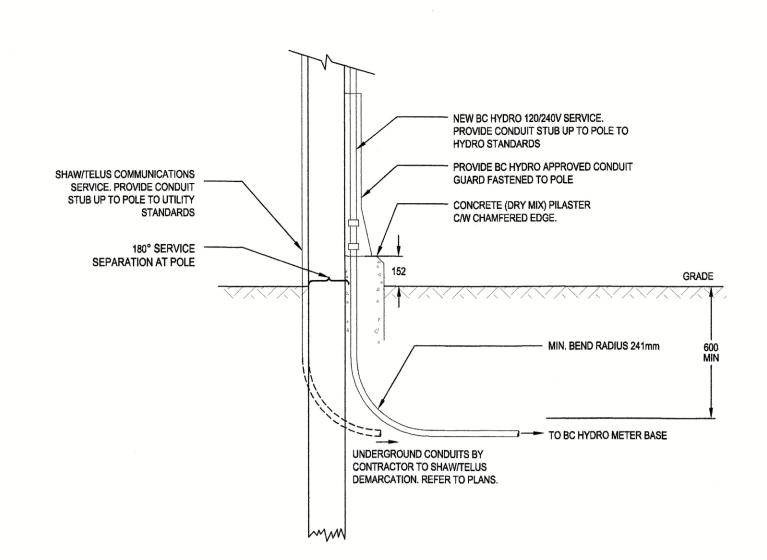


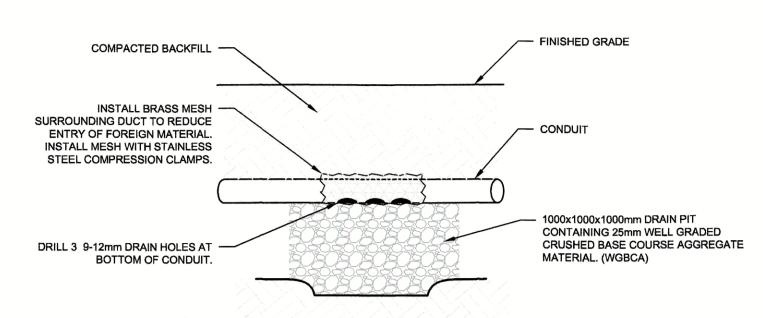


### SERVICE SEPERATION DETAIL SCALE: NTS



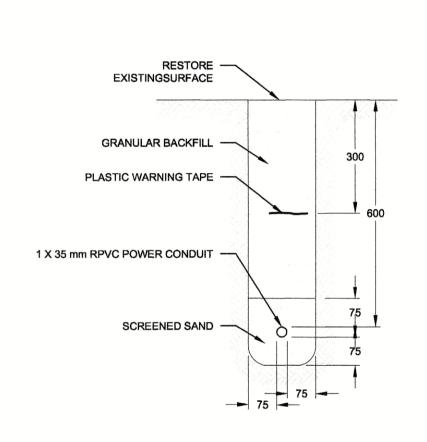

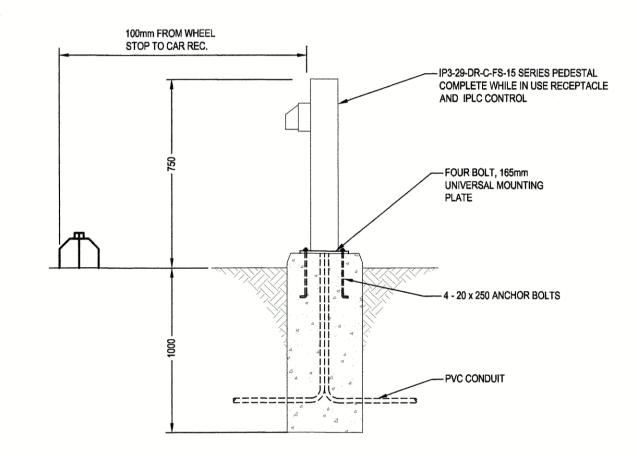

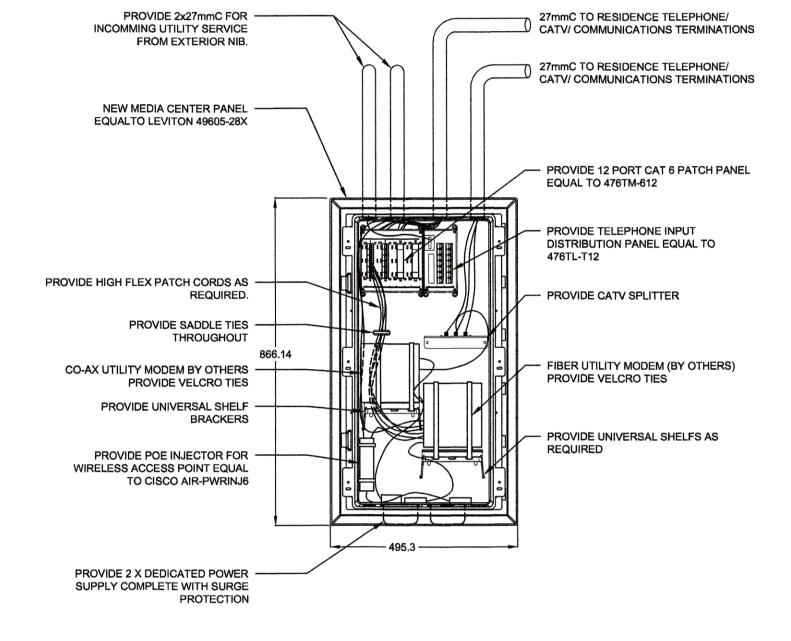








MAINTAIN REQUIRED DISTANCE FROM OTHER STRUCTURES AS FOLLOWS:



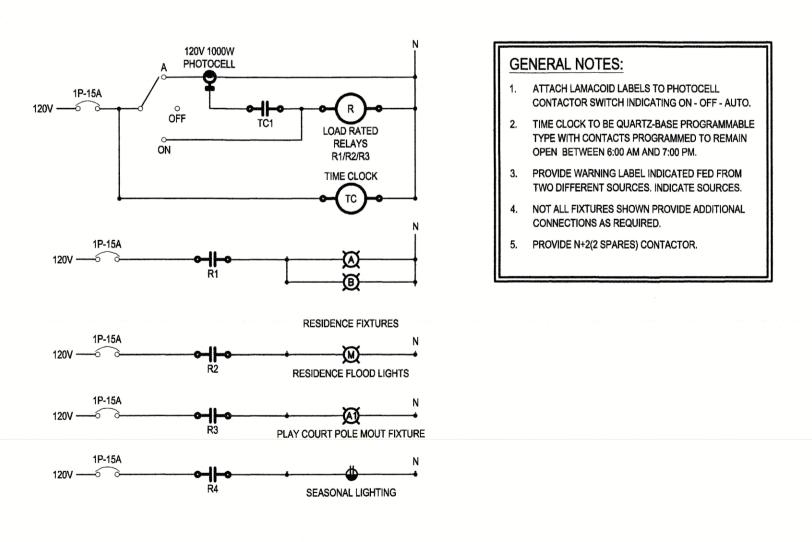

EXTERIOR LIGHTING CONTROL BLOCK DIAGRAM

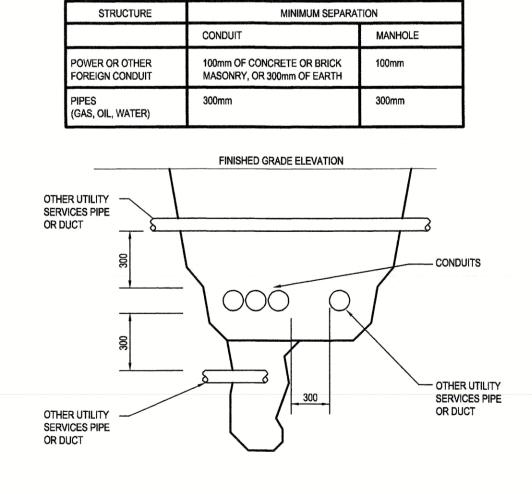

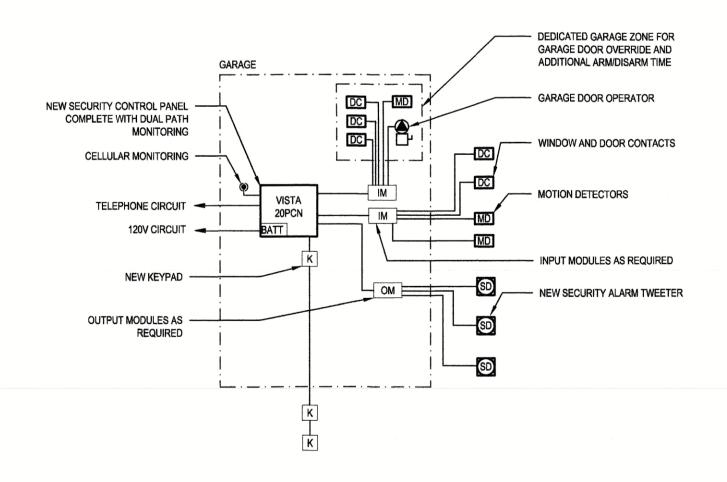

SERVICE SEPERATION DETAIL

SCALE: NTS

SCALE: NTS

SECURITY SYSTEM BLOCK DIAGRAM

REAL PROPERTY SERVICES Pacific Region SERVICES IMMOBILIERS Région de Pacifique

Public Works and Travaux publics et Services gouvernementaux Canada



0	ISSUED FOR TENDER	2019-12-09
В	99% REVIEW SUBMISSION	2019-10-21
Α	50% REVIEW SUBMISSION	2019-09-06
Revision/ Revision	Description/Description	Date/Date
Client/client		

**RCMP** 14200 Green Timbers Way Surrey, B.C.

Project title/Titre du projet


RCMP ANAHIM LAKE **HOUSING RENOVATIONS** 


Consultant Signature Box Only Designed by/Concept par MRO Drawn by/Dessine par PWGSC Project Manager/Administrateur de Projets TPSGC Dianne Dy PWGSC, Regional Manager, Architectural and Engineering Services/ Gestionnaire régionale, Services d'architectural et de génie, TPSGC Philip Fung Drawing title/Titre du dessin


**ELECTRICAL DETAILS** 

R.103948.001 **E-301** 

Revision no./ La Révision

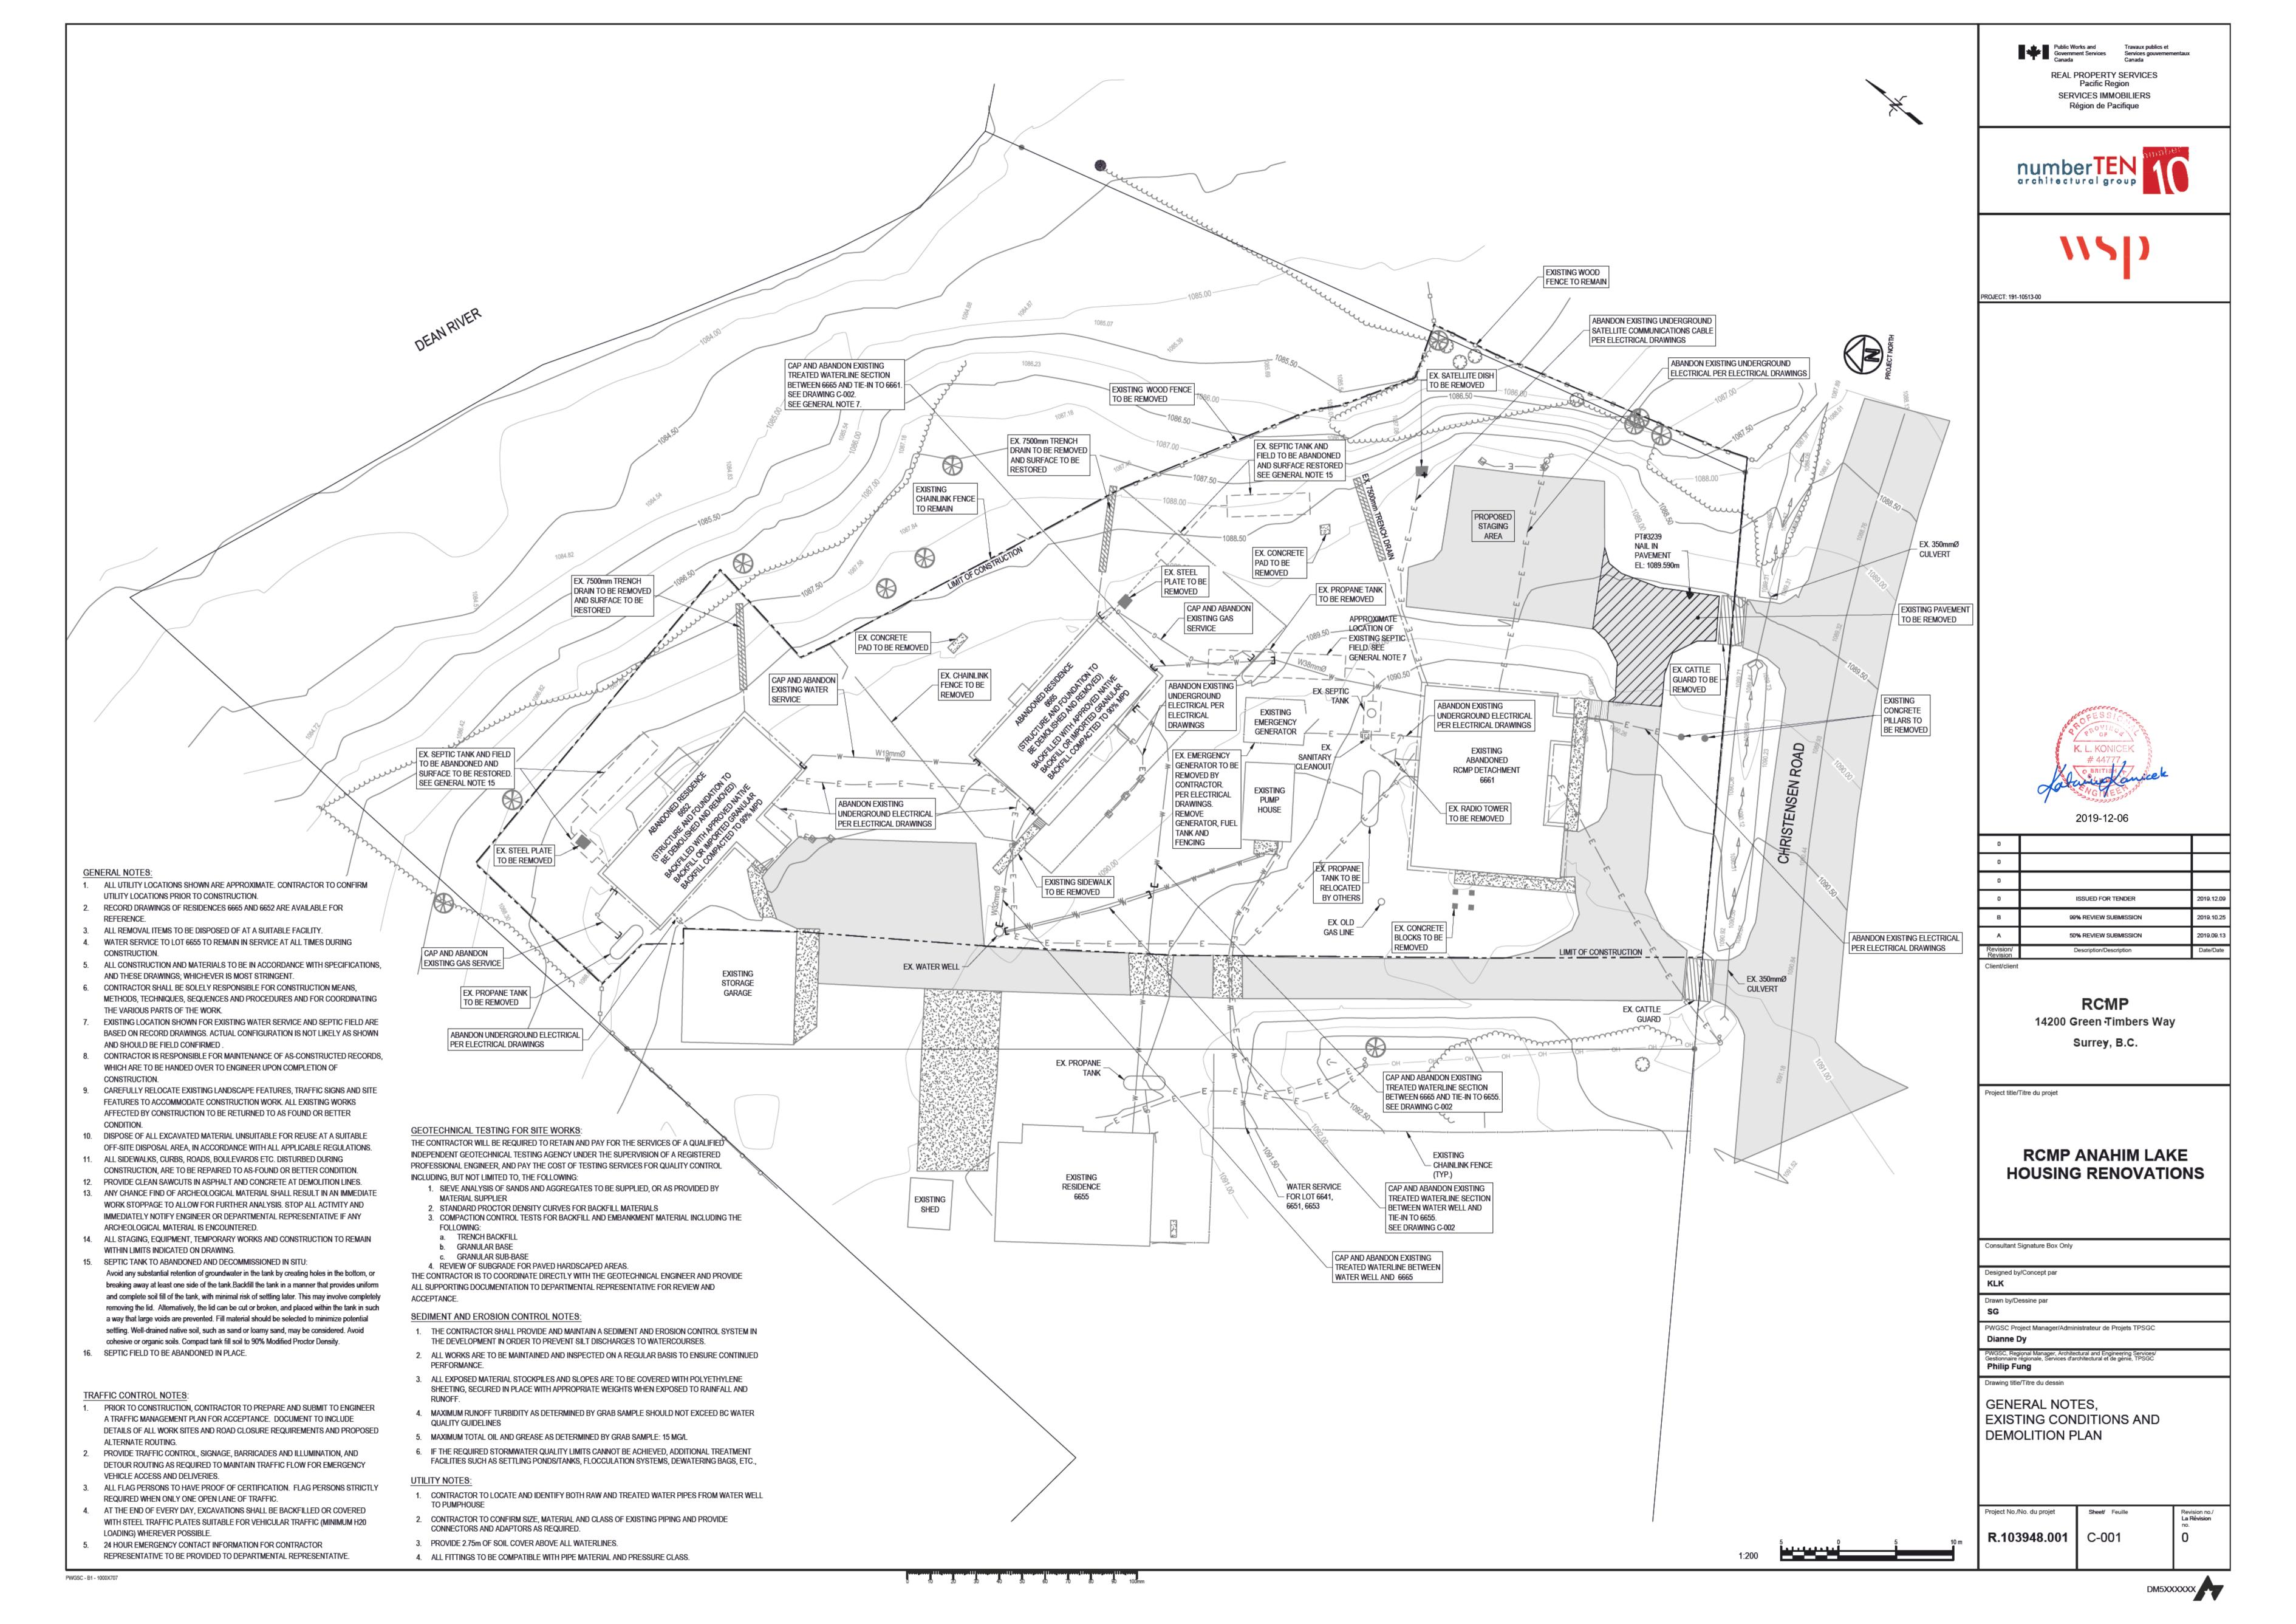

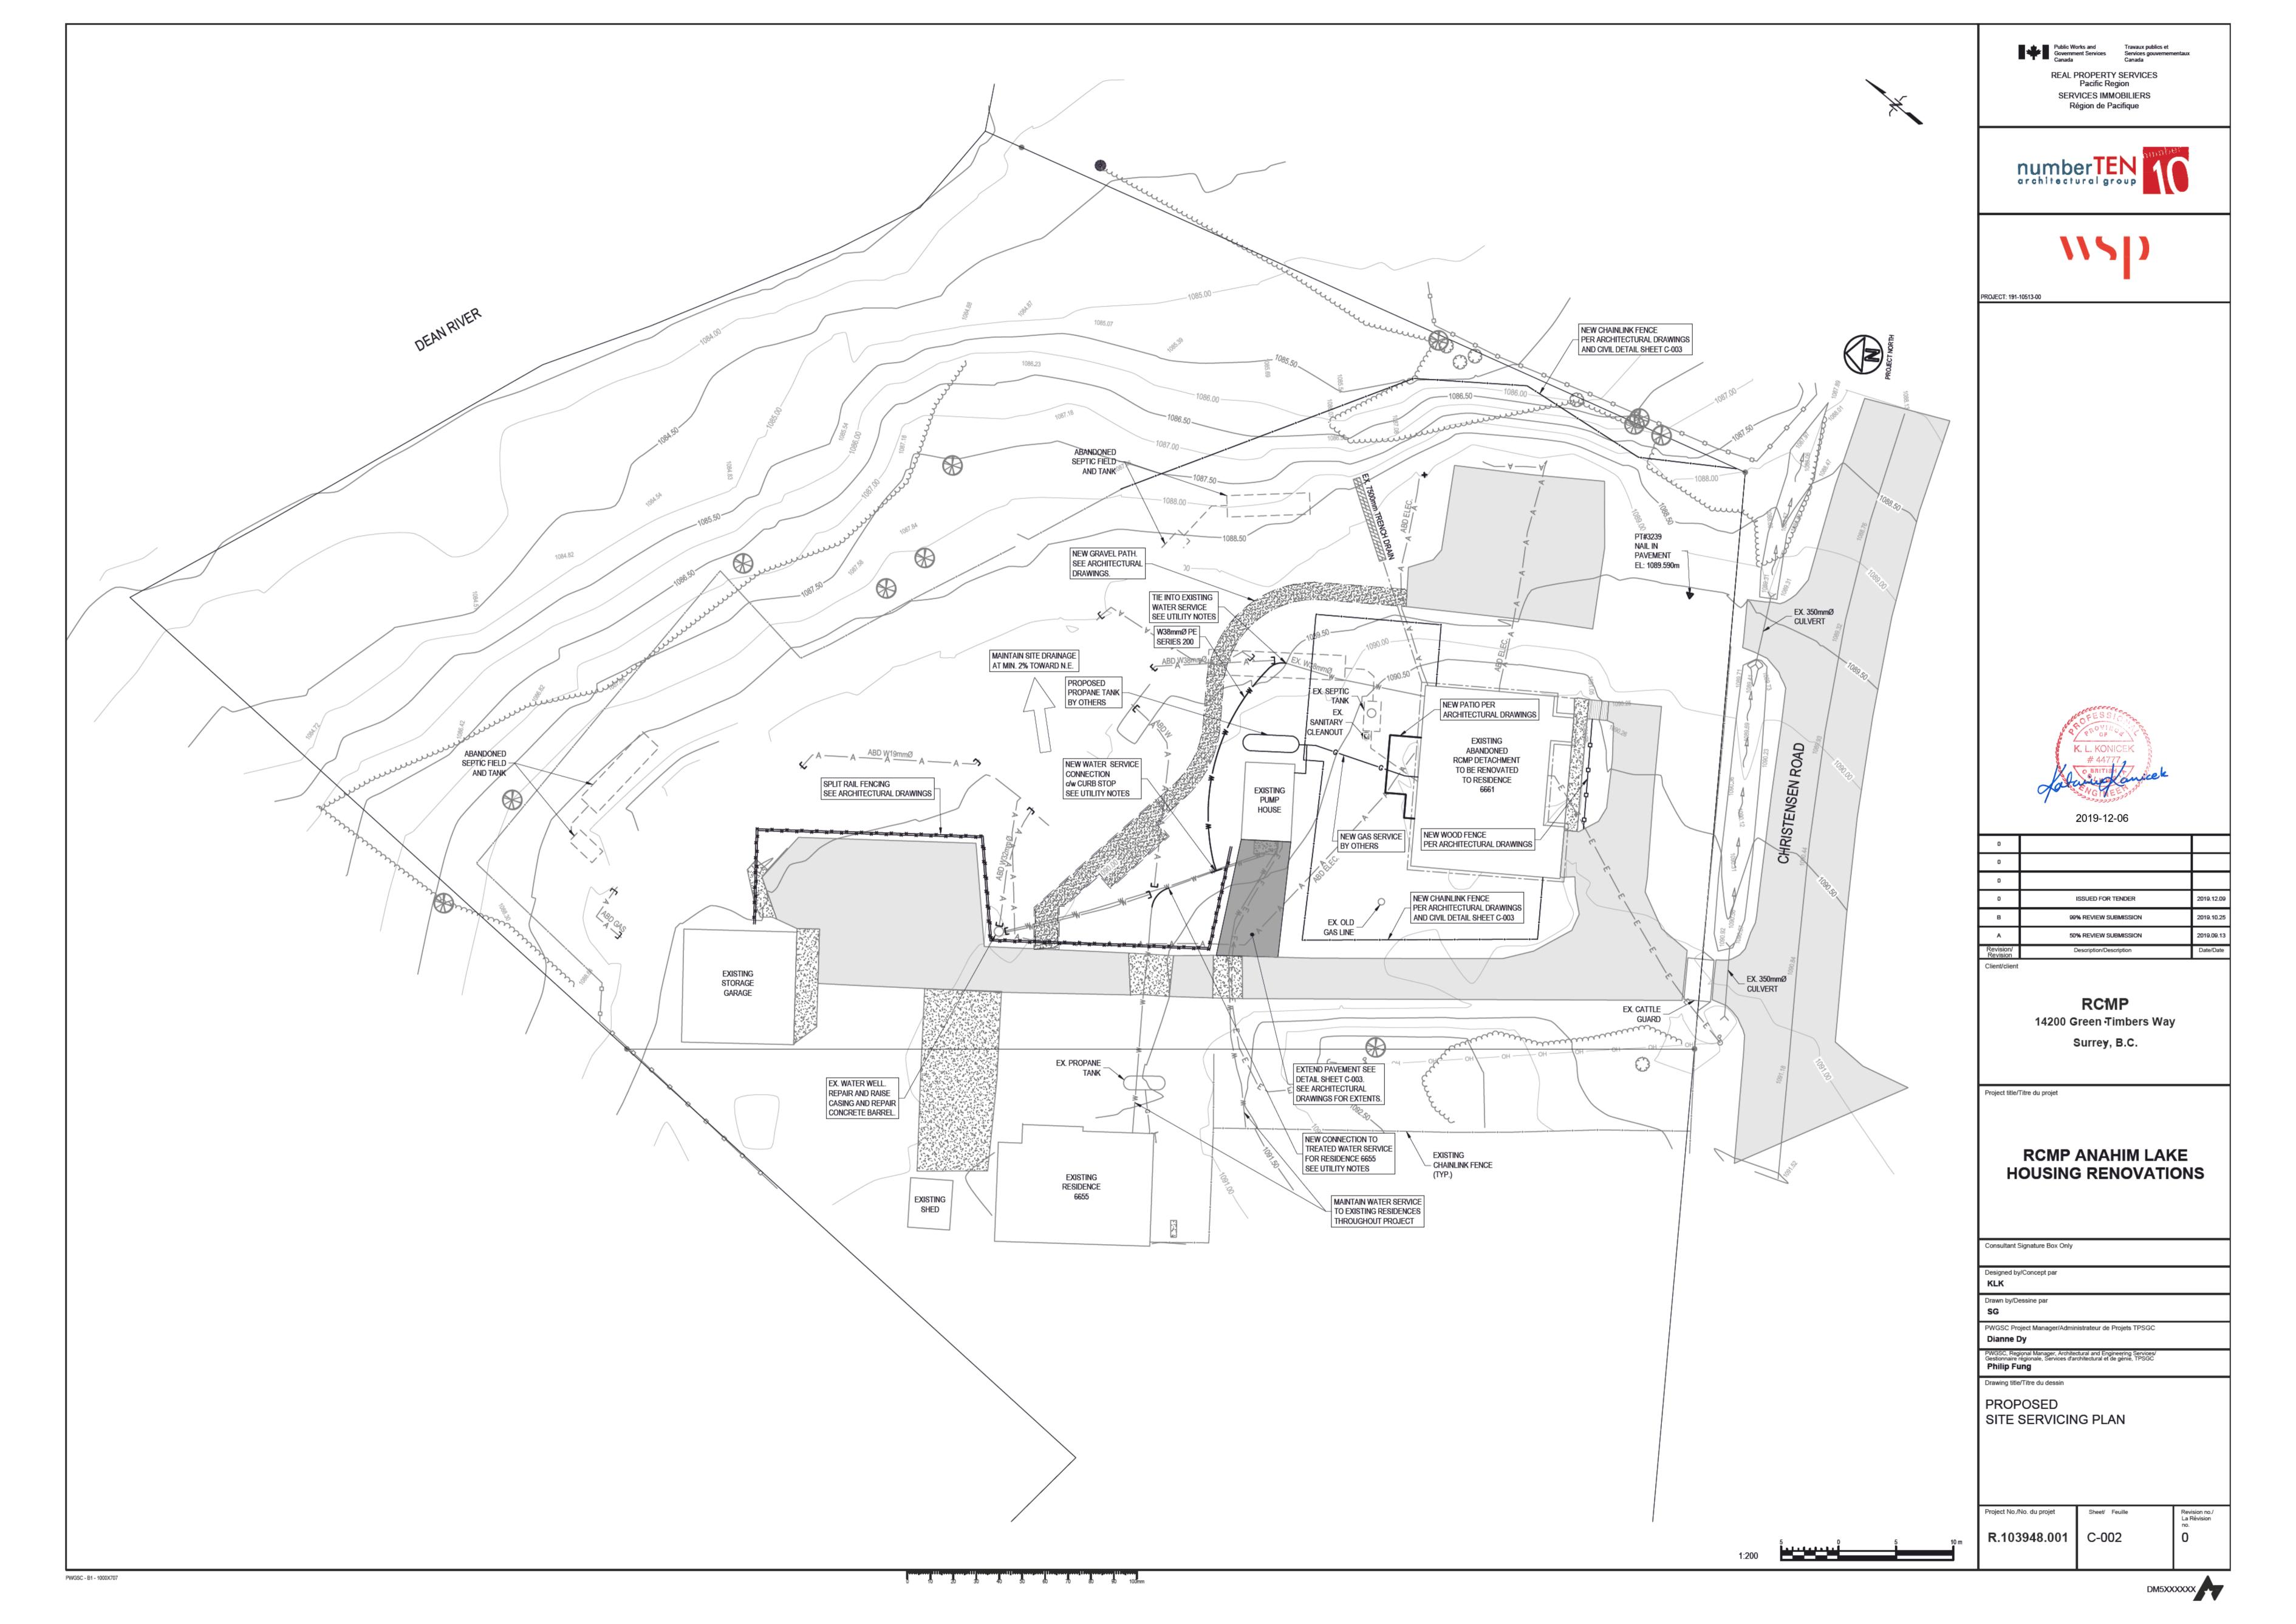

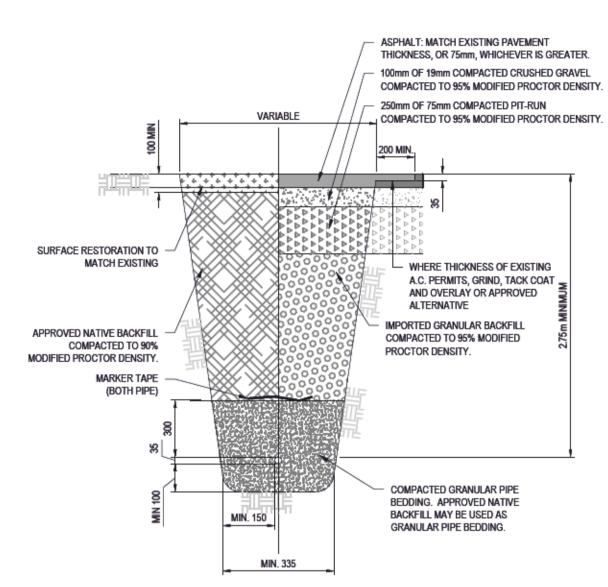

TRENCHING TO COMPLY WITH ALL REQUIREMENTS OF WORKSAFE BC.

- ALL BEDDING AND MATERIAL USED FOR BACKFILL SHALL BE COMPACTED IN MAX. 300mm LAYERS TO MIN. 90% OR 95% MPD, AS SPECIFIED ABOVE.
- 3. UNDER ROADS AND WALKWAYS, BACKFILL SHALL BE PITRUN GRAVEL. 4. ROCK TRENCHES SHALL BE EXCAVATED 150mm BELOW PIPE BOTTOM AND FILLED
- WITH GRAVEL AND COMPACTED IN DEPTH.

TYPICAL TRENCH AND CLASS 'B' BEDDING N.T.S.

**MMCD** STANDARD DETAIL DRAWINGS TIE WIRE MAXIMUM SPACING TOP RAIL 450 TENSION BANDS 375 -END POST AND CORNER POST 75 NOMINAL LINE POSTS 300 HOG RINGS 450 3.0m MAXIMUM DOME TOP-TOP RAIL 42 NOMINAL CHAIN LINK 3.55 (9 GAUGE)
WOVEN TO 50 OPENINGS TENSION WIRE 4.5 (6 GAUGE) 42 NOMINAL GENERAL ARRANGEMENT TOP OF WALL-25 MIN NON-SHRINK-CEMENT GROUT ─ 0.51mm THICK GALV. SHEET METAL SLEEVES 20 MPa CONCRETE IN EARTH O.51mm OR BETTER
WELDED TO SLEEVE USE NON-SHRINK -CEMENT GROUT TO SET TO PIPE TO GRADE ON RETAINING WALL NOTE: 1. FOR PURPOSE OF CLARITY, DETAILS OF TENSION BARS, TENSION BANDS AND MISCELLANEOUS FITTINGS NOT SHOWN ON DRAWING. 2. ALL RAILS AND POSTS SCHEDULE 40 PIPE 3. GATE POSTS AS SPECIFIED (89 NOMINAL MINIMUM). 4. REFER TO CONTRACT DRAWINGS, SECTIONS 32 31 13 FOR DETAILED SPECIFICATIONS. NOT TO SCALE DRAWING NUMBER: CHAIN LINK FENCE FOR WALKWAY

MMCD - Platinum Edition Volume II Copyright Master Municipal Construction Documents Association (c) 2009

Public Works and Travaux publics et Services gouvernementaux Canada

REAL PROPERTY SERVICES Pacific Region SERVICES IMMOBILIERS Région de Pacifique





PROJECT: 191-10513-00



0					
0					
0					
0	ISSUED FOR TENDER	2019.12.09			
В	99% REVIEW SUBMISSION	2019.10.25			
Α	50% REVIEW SUBMISSION	2019.09.13			
Revision/ Revision	Description/Description	Date/Date			
Client/client					

### **RCMP** 14200 Green Timbers Way

Surrey, B.C.

Project title/Titre du projet

### RCMP ANAHIM LAKE **HOUSING RENOVATIONS**


Consultant Signature Box Only Designed by/Concept par Drawn by/Dessine par PWGSC Project Manager/Administrateur de Projets TPSGC Dianne Dy PWGSC, Regional Manager, Architectural and Engineering Services/ Gestionnaire régionale, Services d'architectural et de génie, TPSGC **Philip Fung** 

Drawing title/Titre du dessin

DETAILS

Project No./No. du projet Revision no./ La Révision R.103948.001 C-003

0 10 20 30 40 50 60 70 80 90 100mm PWGSC - B1 - 1000X707

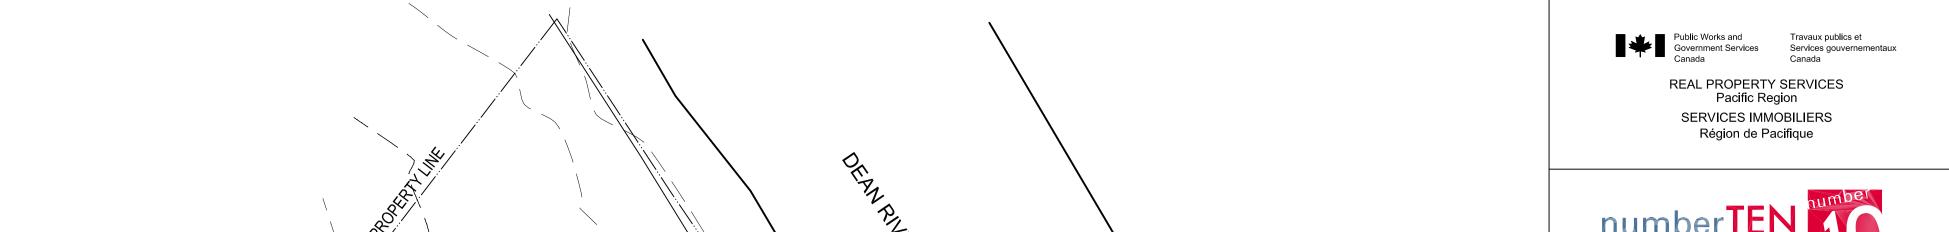











0	ISSUED FOR TENDER	2019 12 (
В	99% REVIEW SUBMISSION	2019 10 2
А	50% REVIEW SUBMISSION	2019 09
Revision/ Revision	Description/Description	Date/Dat
Client/client		

**RCMP** 14200 Green Timbers Way

Surrey, B.C.

Project title/Titre du projet

RCMP ANAHIM LAKE HOUSING RENOVATIONS

Consultant Signature Box Only

Designed by/Concept par Drawn by/Dessine par

PWGSC Project Manager/Administrateur de Projets TPSGC Philip Fung

PWGSC, Regional Manager, Architectural and Engineering Services/ Gestionnaire régionale, Services d'architectural et de génie, TPSGC Preetipal Paul

Drawing title/Titre du dessin

LANDSCAPE PLAN

Project No./No. du projet R.103948.001

TREE TO BE SET PLUMB ---- WOVEN FABRIC TREE TIE CONTRACTOR TO ALLOW FOR SETTLEMENT WHEN CONTRACTOR TO ALLOW PLACING TREE FOR SETTLEMENT WHEN - WOVEN FABRIC TREE TIE 75 MM DIA. WOOD STAKE PLACING TREE MINIMUM TREE PIT SIZE MINIMUM TREE PIT SIZE -75 MM DIA. WOOD STAKES TO BE 3.6 M. DIA. X .6 M. DEPTH TO BE 3.6 M. DIA. X .6 M. DEPTH 1000 DIA. CRUSHED ROCK -OR BARK MULCH SAUCER TREE TO BE SET PLUMB SAUCER SHALL BE SOAKED KEEP MULCH 50 MM SAUCER SHALL BE SOAKED AWAY FROM TREE IMMEDIATELY AFTER PLANTING WITH CLEAN FRESH WATER STEM FOR ALL TREES. IMMEDIATELY AFTER PLANTING COMPACT TOPSOIL TO BE ROLLED DOWN IN PLANTING PIT COMPACT TOPSOIL 1/2 OF ROOTBALL BURLAP IN PLANTING PIT TO BE ROLLED DOWN REST ROOTBALL ON 300 MM REST ROOTBALL ON 300 MM COMPACTED TOPSOIL COMPACTED TOPSOIL 300 MM TOPSOIL MIN. —— CONIFEROUS TREE PLANTING DECIDUOUS TREE PLANTING

NTS ALL DIMENSIONS IN MM

### **GENERAL NOTES**

NTS ALL DIMENSIONS IN MM

- ALL SOFT LANDSCAPE ELEMENTS TO BE INSTALLED TO BRITISH COLUMBIA LANDSCAPE STANDARD 2012 EDITION.

- REFER TO SPECIFICATIONS FOR ADDITIONAL REQUIREMENTS FOR LANDSCAPE INSTALLATION. - CONTRACTOR TO REPORT ALL ERRORS, OMISSIONS AND DISCREPANCIES TO LANDSCAPE CONSULTANT IMMEDIATLY
- AND PRIOR TO COMMENCEMENT OF WORK.

- SUBGRADES TO BE PREPARED IN ACCORDANCE WITH SPECIFICATION SECTION 32 91 21 TOPSOIL PLACEMENT AND GRADING.

- TOPSOIL TO BE INSTALLED TO STANDARDS IDENTIFIED IN SPECIFICATION SECTION 32 91 21 AND THE BRITISH COLUMBIA LANDSCAPE STANDARD - 2012 EDITION, SECTION 6.

- · LANDSCAPE CONTRACTOR TO PROVIDE A SOIL TEST OF THE IMPORTED TOPSOIL WITH RECOMMENDATIONS FROM THE TESTING LAB TO AMMEND TOPSOIL TO MEET STANDARDS IN TABLE T-6.3.5.4 LEVEL 4 - OPEN SPACE/PLAY. - SOIL TEST AND RECOMMENDATIONS CAN BE OBTAINED FROM PACIFIC SOIL ANALYSIS INC., #5-11720 VOYAGEUR WAY,
- TOPSOIL DEPTHS
- SHRUB PLANTING AREAS = 450 MM. - SEEDED GRASS AREAS = 100 MM.
- TREE PLANTING AREAS = 600 MM. DEPTH FOR 10 SQ. M. OF AREA PER TREE.

### **GRASS SEEDING**

- AREAS TO BE SEEDED TO GRASS TO BE INSTALLED IN ACCORDANCE WITH SPECIFICATION SECTION 32 92 20 SEEDING. SEE LANDSCAPE PLAN FOR EXTENTS OF AREAS TO BE SEEDED TO GRASS. - SEE ESTABLISHMENT MAINTENANCE NOTES BELOW FOR REQUIREMENTS FOR MAINTENANCE.

### TREES, SHRUBS AND GROUNDCOVER PLANTING

- SEE SPECIFICATION SECTION 32 93 10 TREES, SHRUBS AND GROUNDCOVER PLANTING FOR PLANTING REQUIREMENTS. - SEE ESTABLISHMENT MAINTENANCE NOTES BELOW FOR REQUIREMENTS FOR MAINTENANCE.

- BARK MULCH TO BE INSTALLED IN ACCORDANCE WITH SPECIFICATION SECTION 32 93 10 TREES, SHRUBS AND GROUNDCOVER PLANTING. SEE LANDSCAPE PLAN FOR EXTENTS OF PLANTING BEDS TO BE MULCHED.

### CRUSHED GRAVEL PATHWAY

- CRUSHED GRAVEL SURFACING TO CONSIST OF 100 MM DEPTH OF 19 MM MINUS CRUSHED ROCK SET ON COMPACTED SUBGRADE.

- NO EDGERS ARE REQUIRED FOR PATHWAY EDGES.

### WOOD EDGER

**BARK MULCH** 

- EDGER TO CONSIST OF 100 MM X 100 MM ROUGH CEDAR TIMBERS.

-TOP EDGE OF TIMBER SURROUNDING EDGE OF CRUSHED ROCK PATHWAY TO BE FLUSH WITH ADJACENT

CRUSHED ROCK, PLANTING BED TOPSOIL AND GRASS SURFACES.

- ANCHOR WOOD EDGER WITH REINFORCING BAR AT 2.0 M SPACING AND AT CORNERS. PLUG REINFORCING BAR OPENINGS WITH WOOD PLUGS.

- WOOD EDGERS TO BE PLACED ON 150 MM DEPTH OF COMPACTED 19 MM CRUSHED ROCK.

ESTABLISHMENT MAINTENANCE OF TREES, PLANTING BEDS AND GRASS AREAS

- SEE SPECIFICATION SECTION 32 92 20 SEEDING FOR ESTABLISHMENT MAINTENANCE REQUIREMENTS. - SEE SPECIFICATION SECTION 32 93 10 TREES, SHRUBS AND GROUNDCOVER PLANTING FOR ESTABLISHMENT MAINTENANCE REQUIREMENTS.

### LEGEND

PROPOSED SEEDED GRASS AREAS

PLANT LIST							
KEY	QUANTITY	BOTANICAL NAME	COMMON NAME	SIZE	COMMENTS		
Α	1	PICEA GLAUCA	ENGELMAN SPRUCE	3.0 M. HT.	STAKE		
В	3	PINUS CONTORTA LATIFOLIA	LODGEPOLE PINE	3.0 M. HT.	STAKE		
С	8	POPULUS TREMULOIDES	TREMBLING ASPEN	5.0 CM. CAL.	1.8 M. STANDARD, STAKE		
D	19	CORNUS STOLONIFERA "ARCTIC FIRE"	ARCTIC FIRE DOGWOOD	#3 POT			
E	22	JUNIPERUS CHINENSIS "MINT JULIP"	MINT JULIP JUNIPER	#3 POT			
F	5	PINUS MUGO MUGHUS	MUGO PINE	#3 POT			
G	10	POTENTILLA FRUTICOSA KLONDYKE	KLONDYKE POTENTILLA	#3 POT			

NOTE: \* \* \* \* \*

\*WHEN REGRADING\*SITE AFTER

CONTINUOUS SUBGRADE AND

ŤFINÍSHĚD ŤOPŠOIL GRĂDEŠ 🤘

DEMOLITION PROVIDE A SMOOTH

JĎRAIŇAGE AČROŠS ĞRAŠS AREĂ

NEW GRASS ⊁

— PUMP —

HOUSE

— NEW

ASPHALT-

PERIMETER FENCE

"NEW GRASS `

GRA∀EL

GRASS +

EXIST.

STORAGE

GARAGE

EXISTING

RESIDENCE

ASPHALT



 $W \longrightarrow E$ 

Rem. LOT 2

PLAN 17217

GNSS Control Hub (3239) Coordinates

.5815342.868

...343855.469

..1089.590

...0.999730

This plan lies within the

Cariboo Regional District

Datum: NAD83 (CSRS) 2013a

ombined scale factor....

UTM ZONE 10

UTM Northing.. UTM Easting...

Ortho Elev .

This plan was prepared for planning and discussion purposes only and is for the exclusive use of our client. It should not be relied upon as definitive proof of encroachments or the true location of structures, natural boundaries or fill in relation to any property boundary. Any questions to the above should be followed up with an additional in-depth legal field

Underground utilities were located by a 3rd party consultant. The Signatory accepts no responsibility or liability for any damages that may be suffered by a third party as a result of reproduction, transmission or alteration to this document without consent of the signatory .


© Public Services and Procurement Canada, 2019. All rights reserved.

No person may copy, reproduce, republish, transmit or alter this document, in whole or in part, without the express written consent of Public Services and Procurement Canada.

CERTIFIED CORRECT ON THE 8TH DAY OF **JULY 2019** 

Ian R. Robertson, BCLS # 749

SURVEY BY PWGSC SU SCALE: 1:300

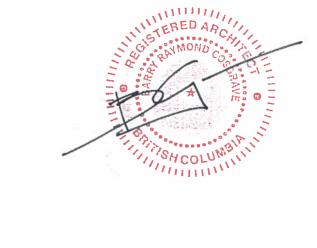

0	ISSUED FOR TENDER	2019 12 09
В	99% REVIEW SUBMISSION	2019 10 25
А	50% REVIEW SUBMISSION	2019 09 13
Revision/ Revision	Description/Description	Date/Date
Client/client		

**RCMP** 14200 Green Timbers Way Surrey, B.C.

Project title/Titre du projet

### RCMP ANAHIM LAKE HOUSING RENOVATIONS

Consultant Signature Box Only Designed by/Concept par Drawn by/Dessine par PWGSC Project Manager/Administrateur de Projets TPSGC Philip Fung PWGSC, Regional Manager, Architectural and Engineering Services/ Gestionnaire régionale, Services d'architectural et de génie, TPSGC

SURVEY

Preetipal Paul

Drawing title/Titre du dessin

Project No./No. du projet R.103948.001 Revision no./ La Révision no.

0 10 20 30 40 50 60 70 80 90 100mm PWGSC - B1 - 1000X707

 $\times_{1084.36}$ 

Alder 0.25mØ

Poplar 0.20mØ

Poplar 0.22mØ Poplar 0.22mØ

1089.65 Road

Pine 0.25mØ

🕺 4m Canopy

TOPOGRAPHIC PLAN OF LOT 1 DISTRICT LOT 405 RANGE 3

 $\times_{1084.27}$ 

Pine 0.25mØ 3m Canopy

Roof Overhang ~

1090.34 Deck Entrance

Quarters

Quarters

#6655

Rem. LOT 3

PLAN 14144

LOT 1

PLAN 17217

Pine 0.25mØ

Concrete Pad

Concrete Blocks

Old Gas Line

Poplar 0.15mØ

2m Canopy

Stairs Deck

3m Canopy

Spruce 0.25mØ 3m Canopy

PLAN 7125

COAST DISTRICT, PLAN 17217.

The intended plot size of this plan is 864mm in width by 560mm in height (D size) when plotted at a scale of 1:300.

Grid bearings are derived from differential dual frequency GNSS observations and are referred to the central meridian of

The UTM coordinates and estimated horizontal positional accuracy achieved are derived from dual frequency

GNSS static observations and processed by NRCAN Precise

This plan shows horizontal ground-level distances, unless otherwise specified. To compute grid distances, multiply

ground-level distances by the average combined factor of 0.999730. The average combined factor has been determined

Elevations are Geodetic and derived from dual frequency carrier phase

Note: Utility Locator was unable to directly connect to water lines. As

Note: Only trees having a diameter of 0.250m or larger are shown

such, all water lines are approximate based on previous surveys/locates

based on an ellipsoidal elevation of 1077.884m.

GPS observations processed using PPP

Control Point Vertical Datum: CGVD 2013a Control Point Projection: UTM Zone 10

Distances are in metres and decimals thereof.

UTM zone 10 (123° west longitude).

Point Positioning system.

Control Point: 3239 N: 5815342.868

E: 343855.469 Elev: 1089.590

Control Point Datum: NAD83

CONTOUR INTERVAL = 0.5m

All Distances Shown are Ground

Legend: → DENOTES CULVERT

> DENOTES GUY WIRE DENOTES POWER POLE DENOTES CONCRETE NAIL

DENOTES WELL

DENOTES TREE LINE

— PNB — DENOTES VEGETATION LINE

---- DENOTES ROOF OVERHANG

DENOTES MAJOR CONTOUR

——— DENOTES EDGE OF CHIP SEAL

——— DENOTES TOP/TOE OF BANK

DENOTES POWER LINE

DENOTES MINOR CONTOUR

DENOTES CENTERLINE OF ROAD

\_\_\_\_ DENOTES UNDERGROUND ELECTRICAL LINE\_ DENOTES UNDERGROUND GAS LINE

\_\_\_\_ DENOTES UNDERGOUND COMMUNICATION LINE

DENOTES APPROXIMATE LOCATION OF

UNDERGROUND WATER LINE

DENOTES CHAINLINK FENCE

DENOTES CONCRETE SLAB / SIDEWALK

DENOTES WOOD FENCE

DENOTES PROPANE TANK

DENOTES PAVEMENT

DENOTES STEEL PLATE

DENOTES CATTLE GUARD

DENOTES TREE SPRUCE

DENOTES TREE POPLAR

219-800 Burrard Street GCDOCS#205640732

Services publics et

Approvisionnement

Geomatiques Services

Project # R.103948.001

SF# 3588.00

DENOTES TREE ALDER

Vancouver, BC, V6Z 0B8 SK#5702.00

DENOTES TREE PINE

LOT A

PLAN 25014

DENOTES STAIRS

DENOTES DITCH

Public Services and Procurement

Geomatics Services

604-775-7079

FB#70 Pg 2-16

 DENOTES ELECTRICAL BOX DENOTES FLAGPOLE

DENOTES IRON PIN FOUND


DENOTES CONCRETE BLOCK


DENOTES OLD GAS LINE O DENOTES CONCRETE CHAMBER


PID 011-547-375


BCGS 93C.030 Anahim Lake

Scale 1:300

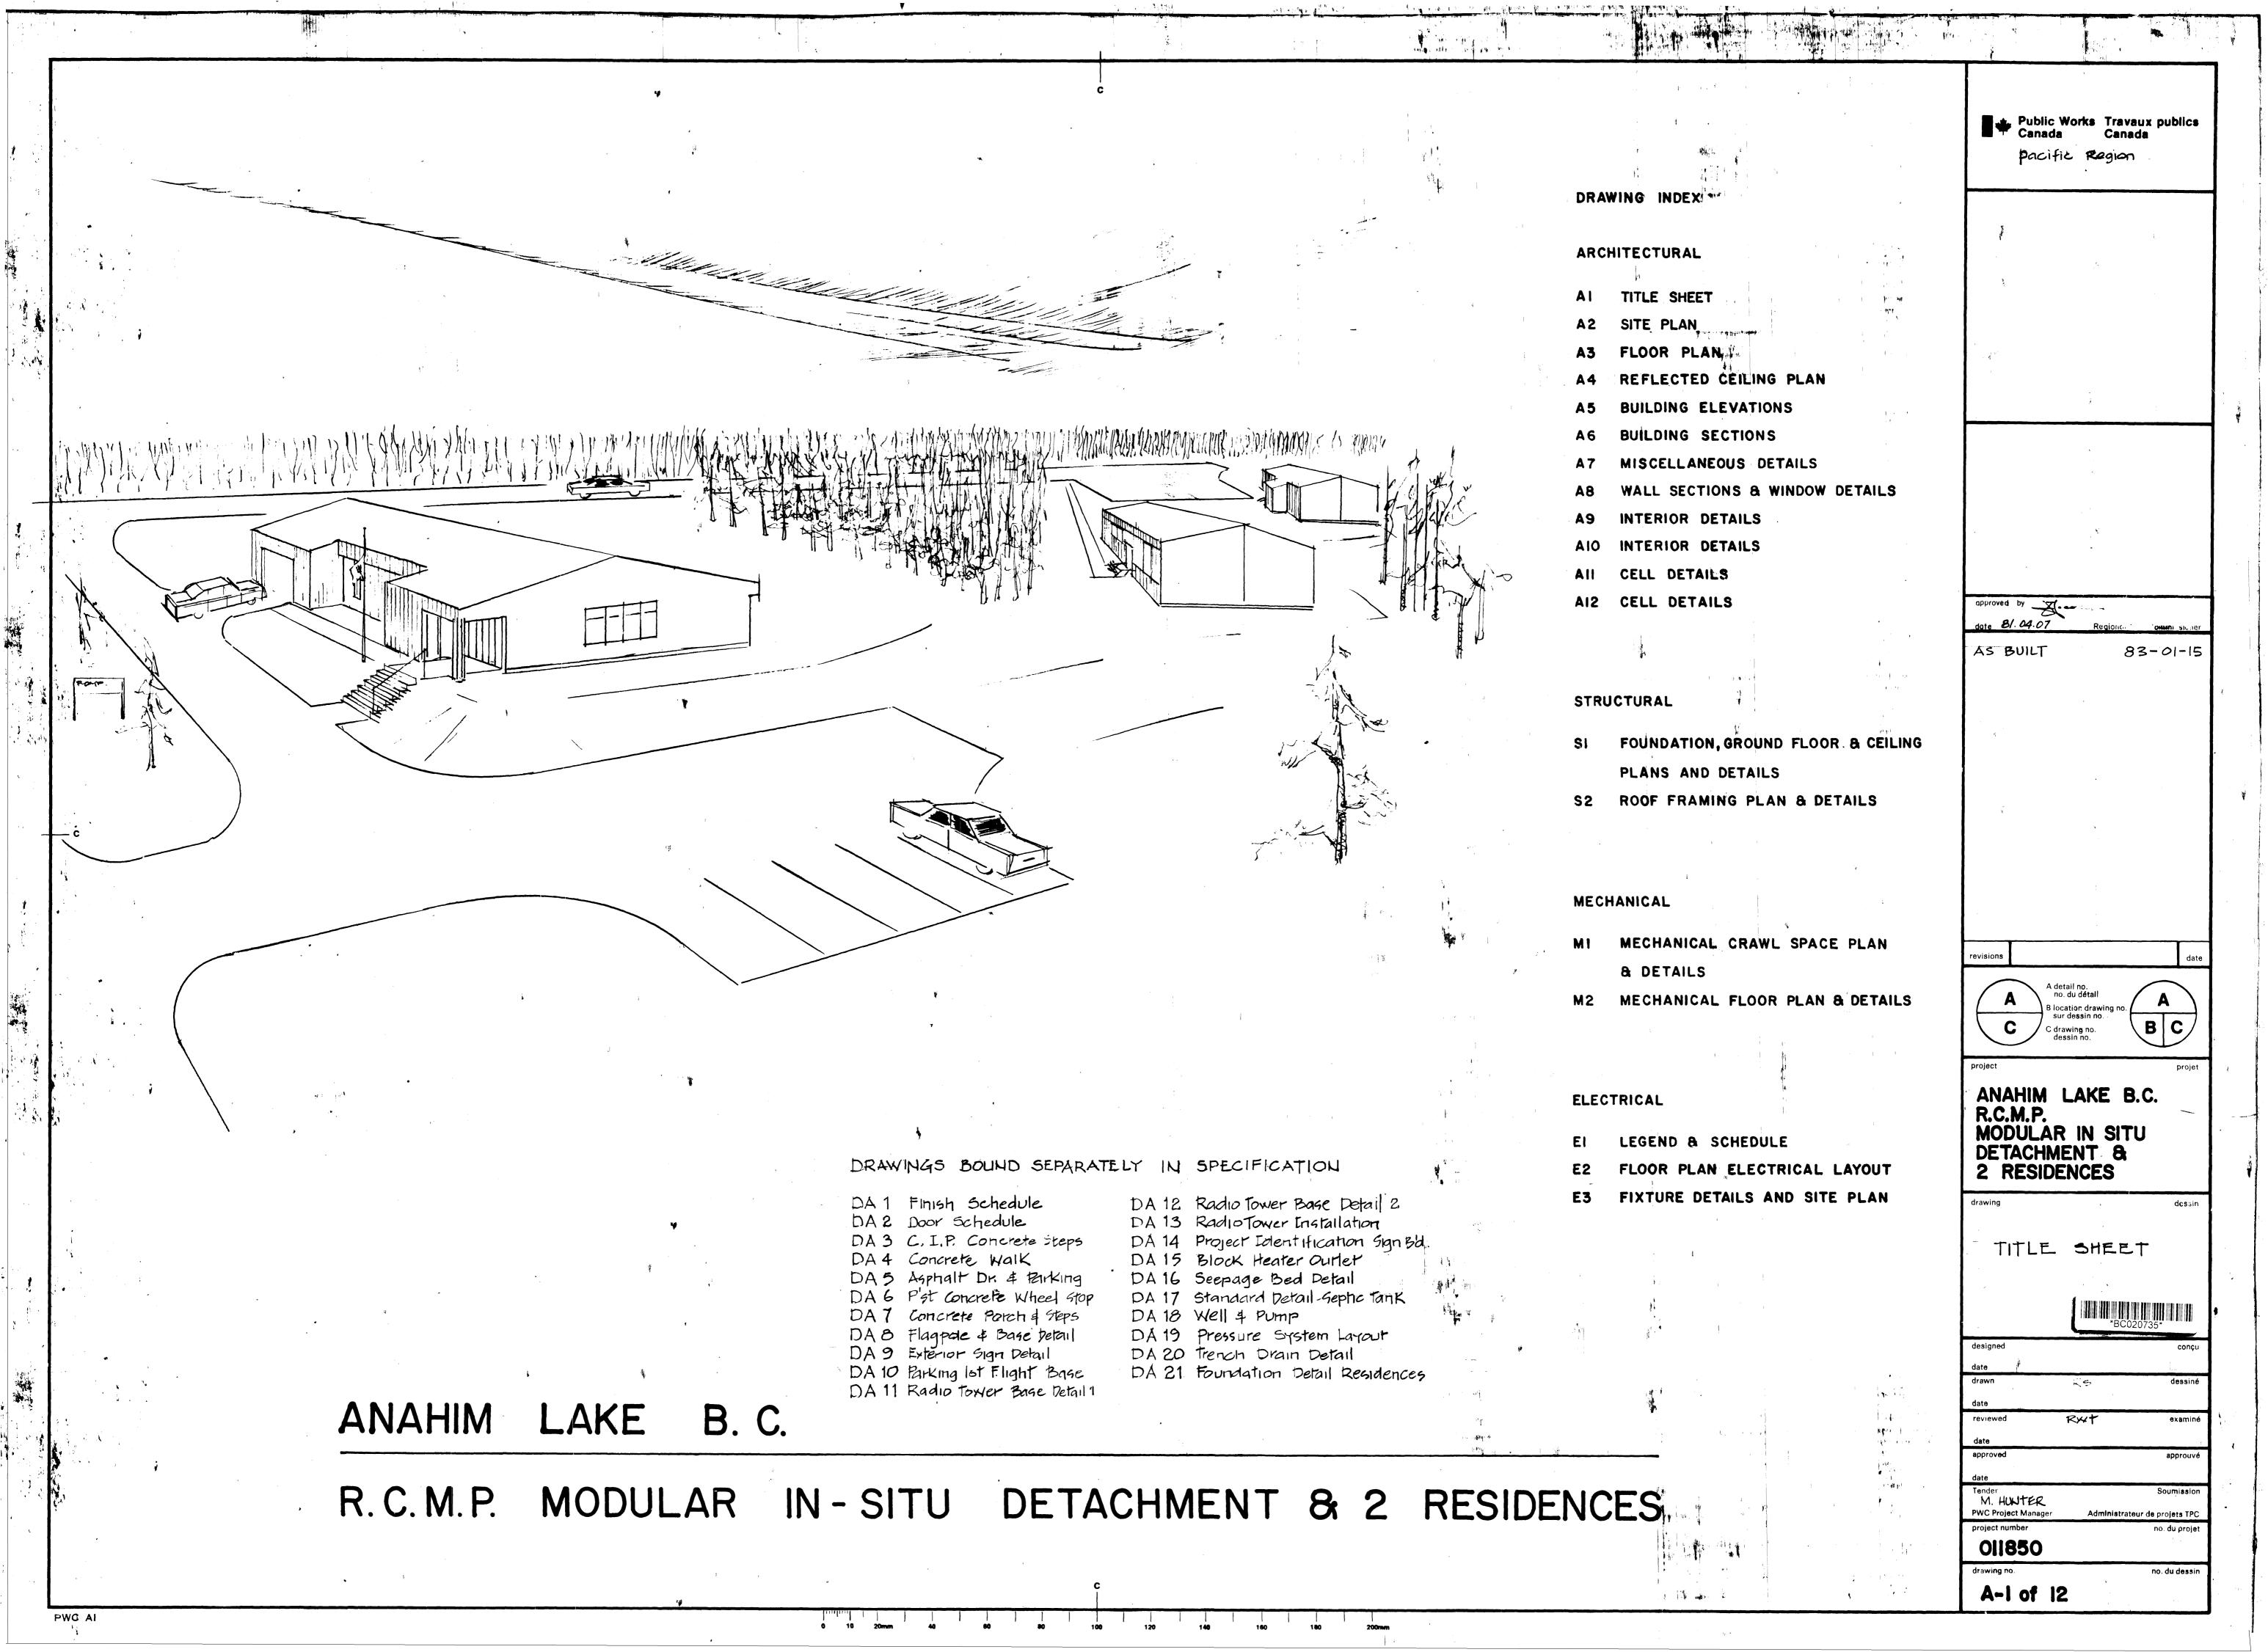

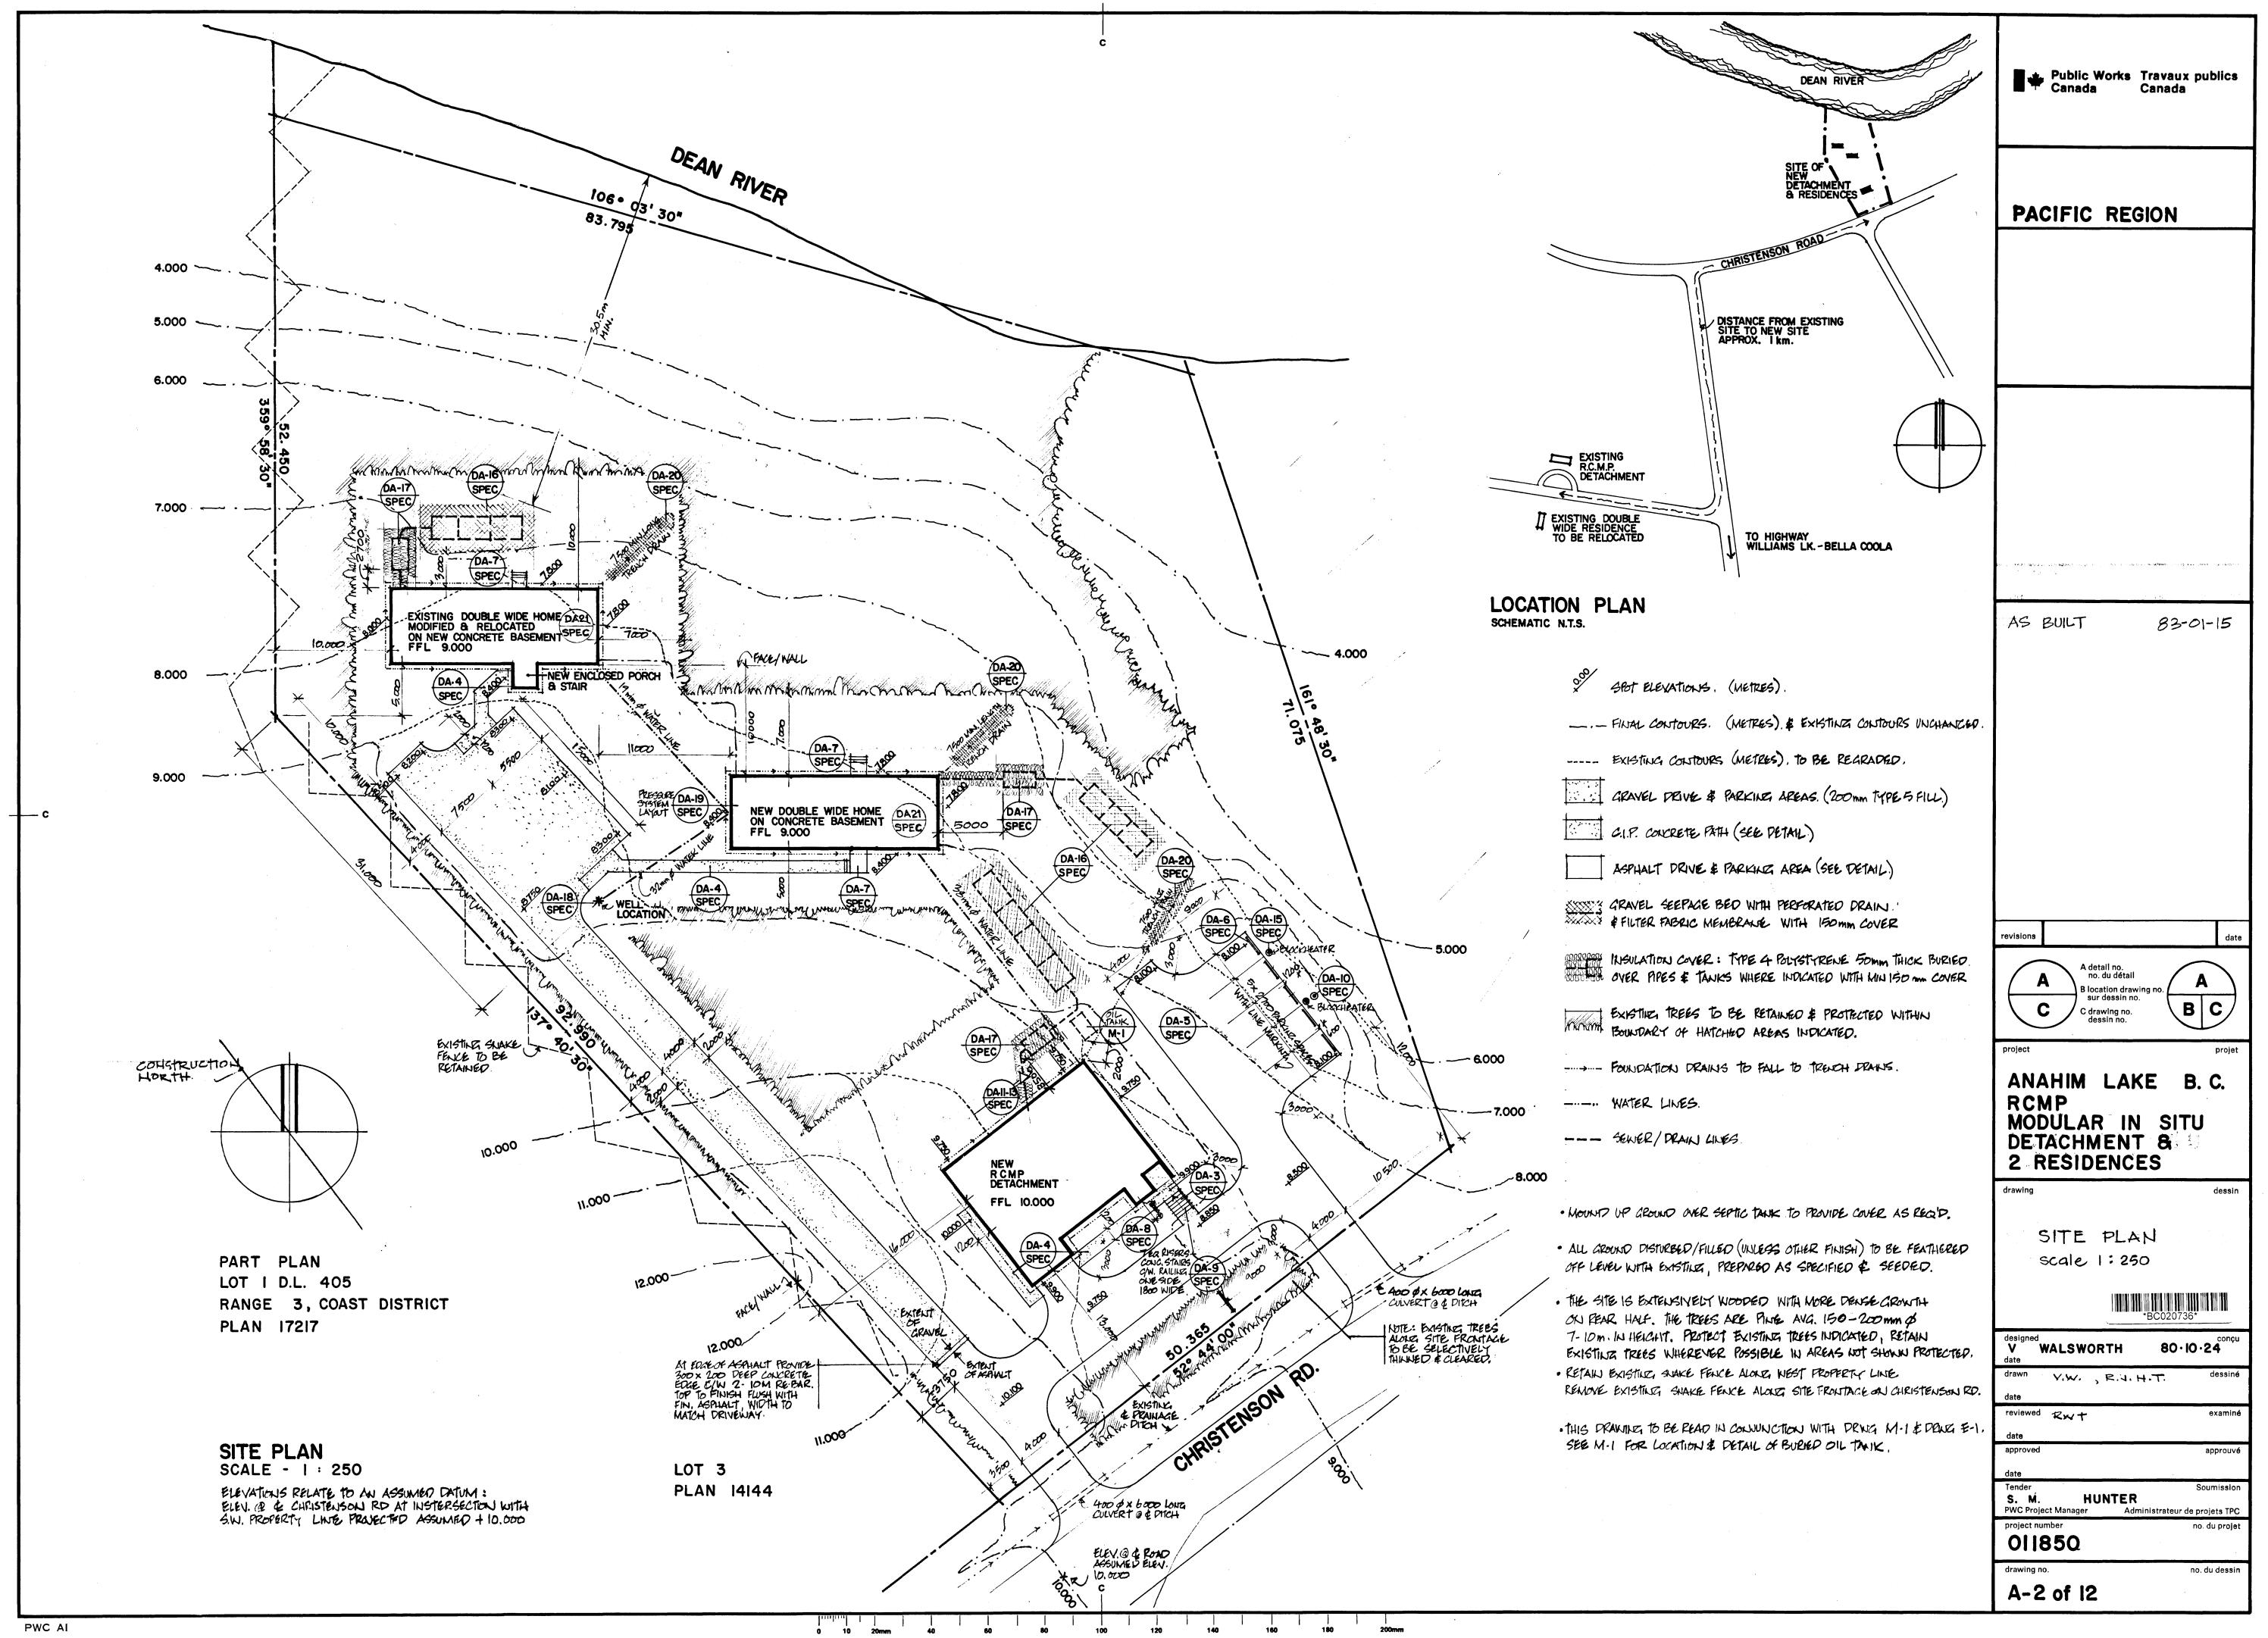

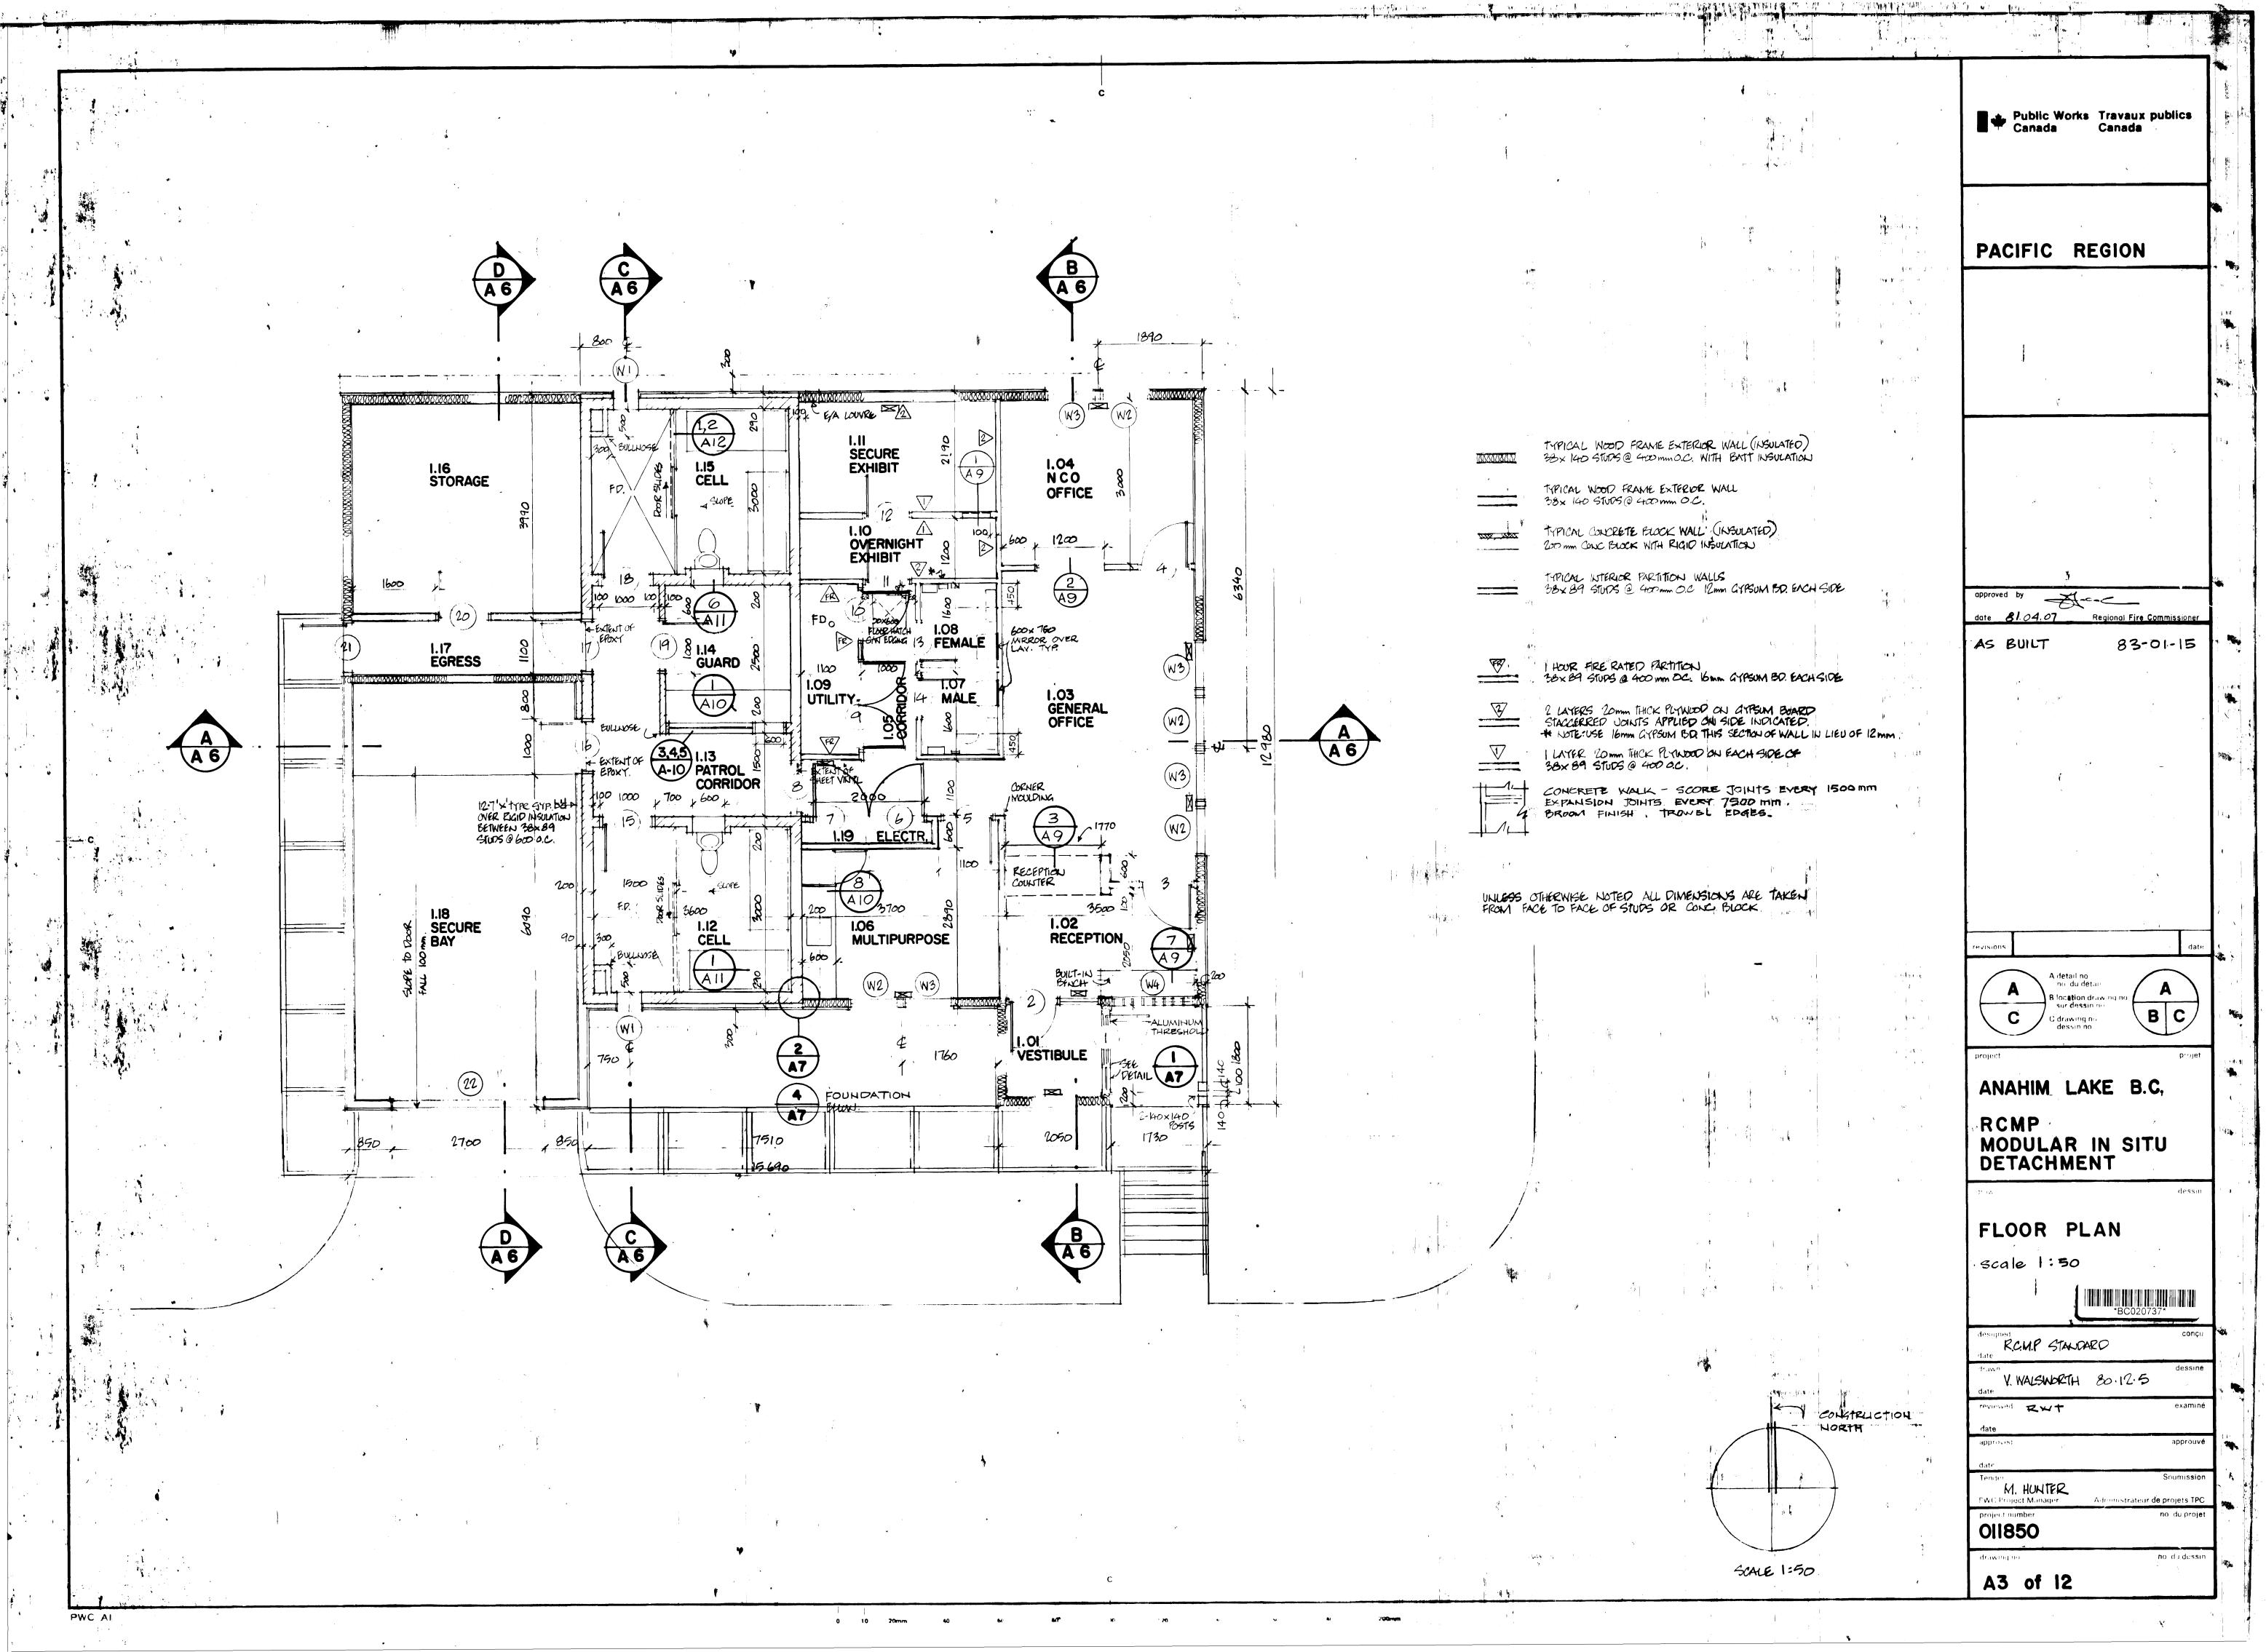

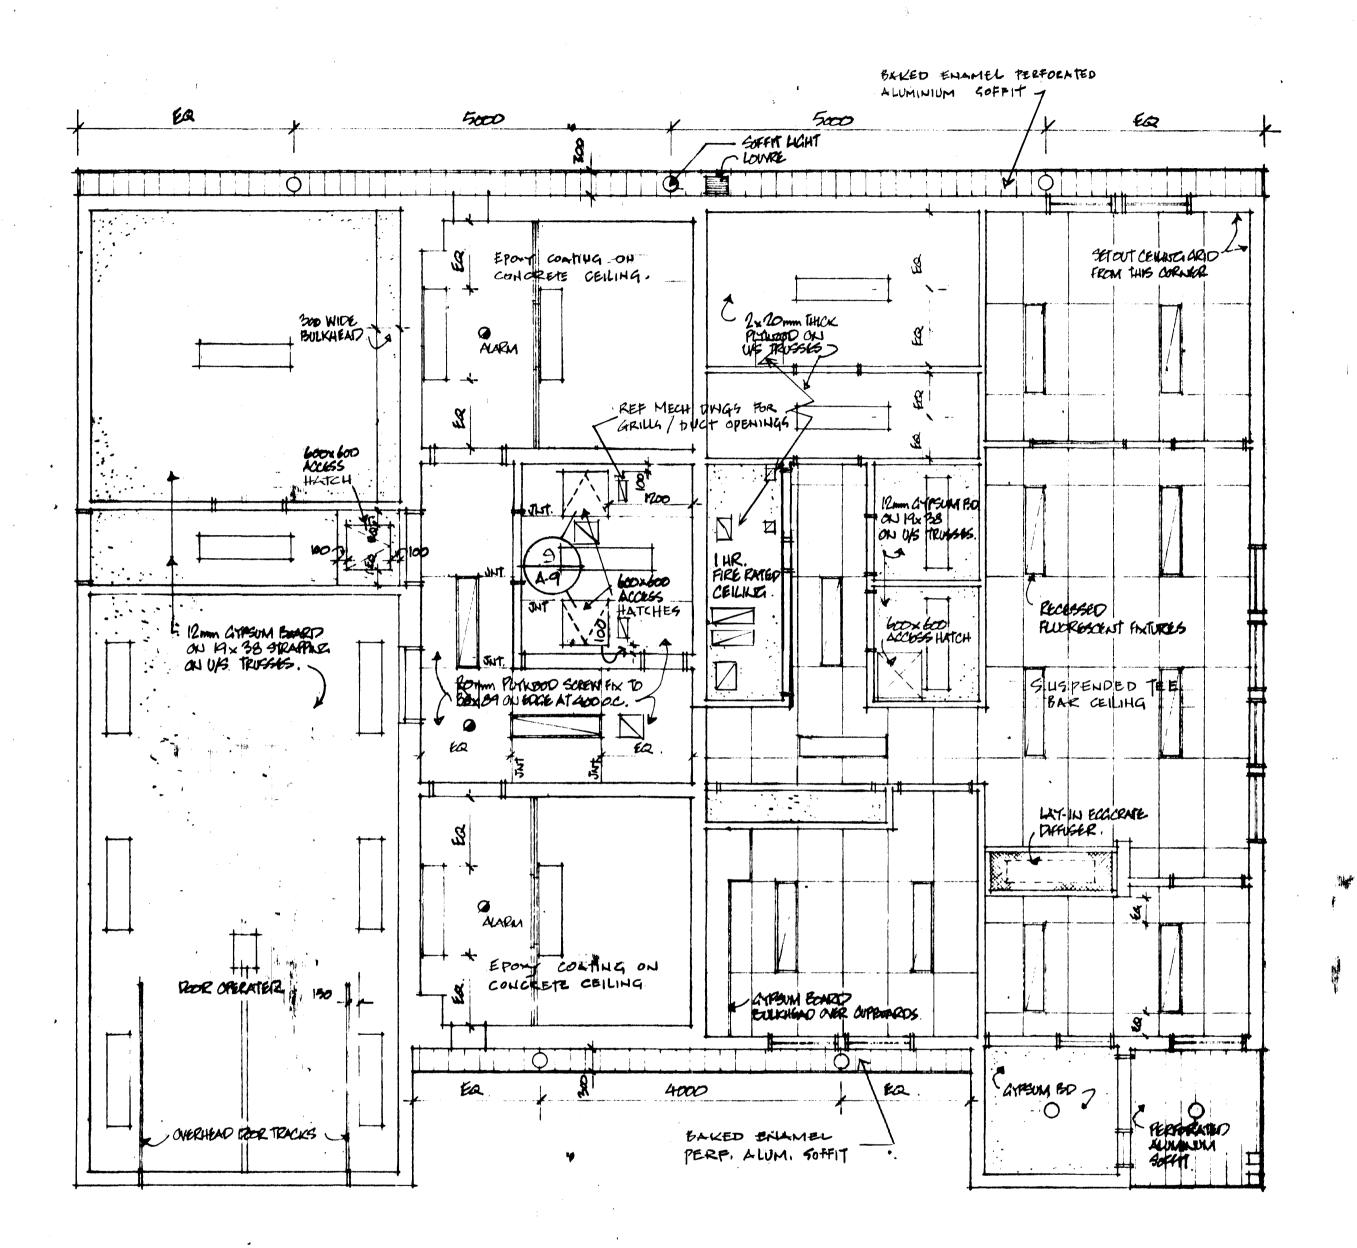



Public Works Travaux public Canada Canada PACIFIC REGION date 81.04.07 Regional Fire Commissioner B location drawing no. sur dessin no. C drawing no. dessin no. ANAHIM LAKE B.C. RCMP MODULAR IN SITU DETACHMENT REFLECTED CEILING PLAN RCMP. STANDARD. V. WALSKORTH BOILES Tender


M. HULTER.


PWC Project Manager


011850

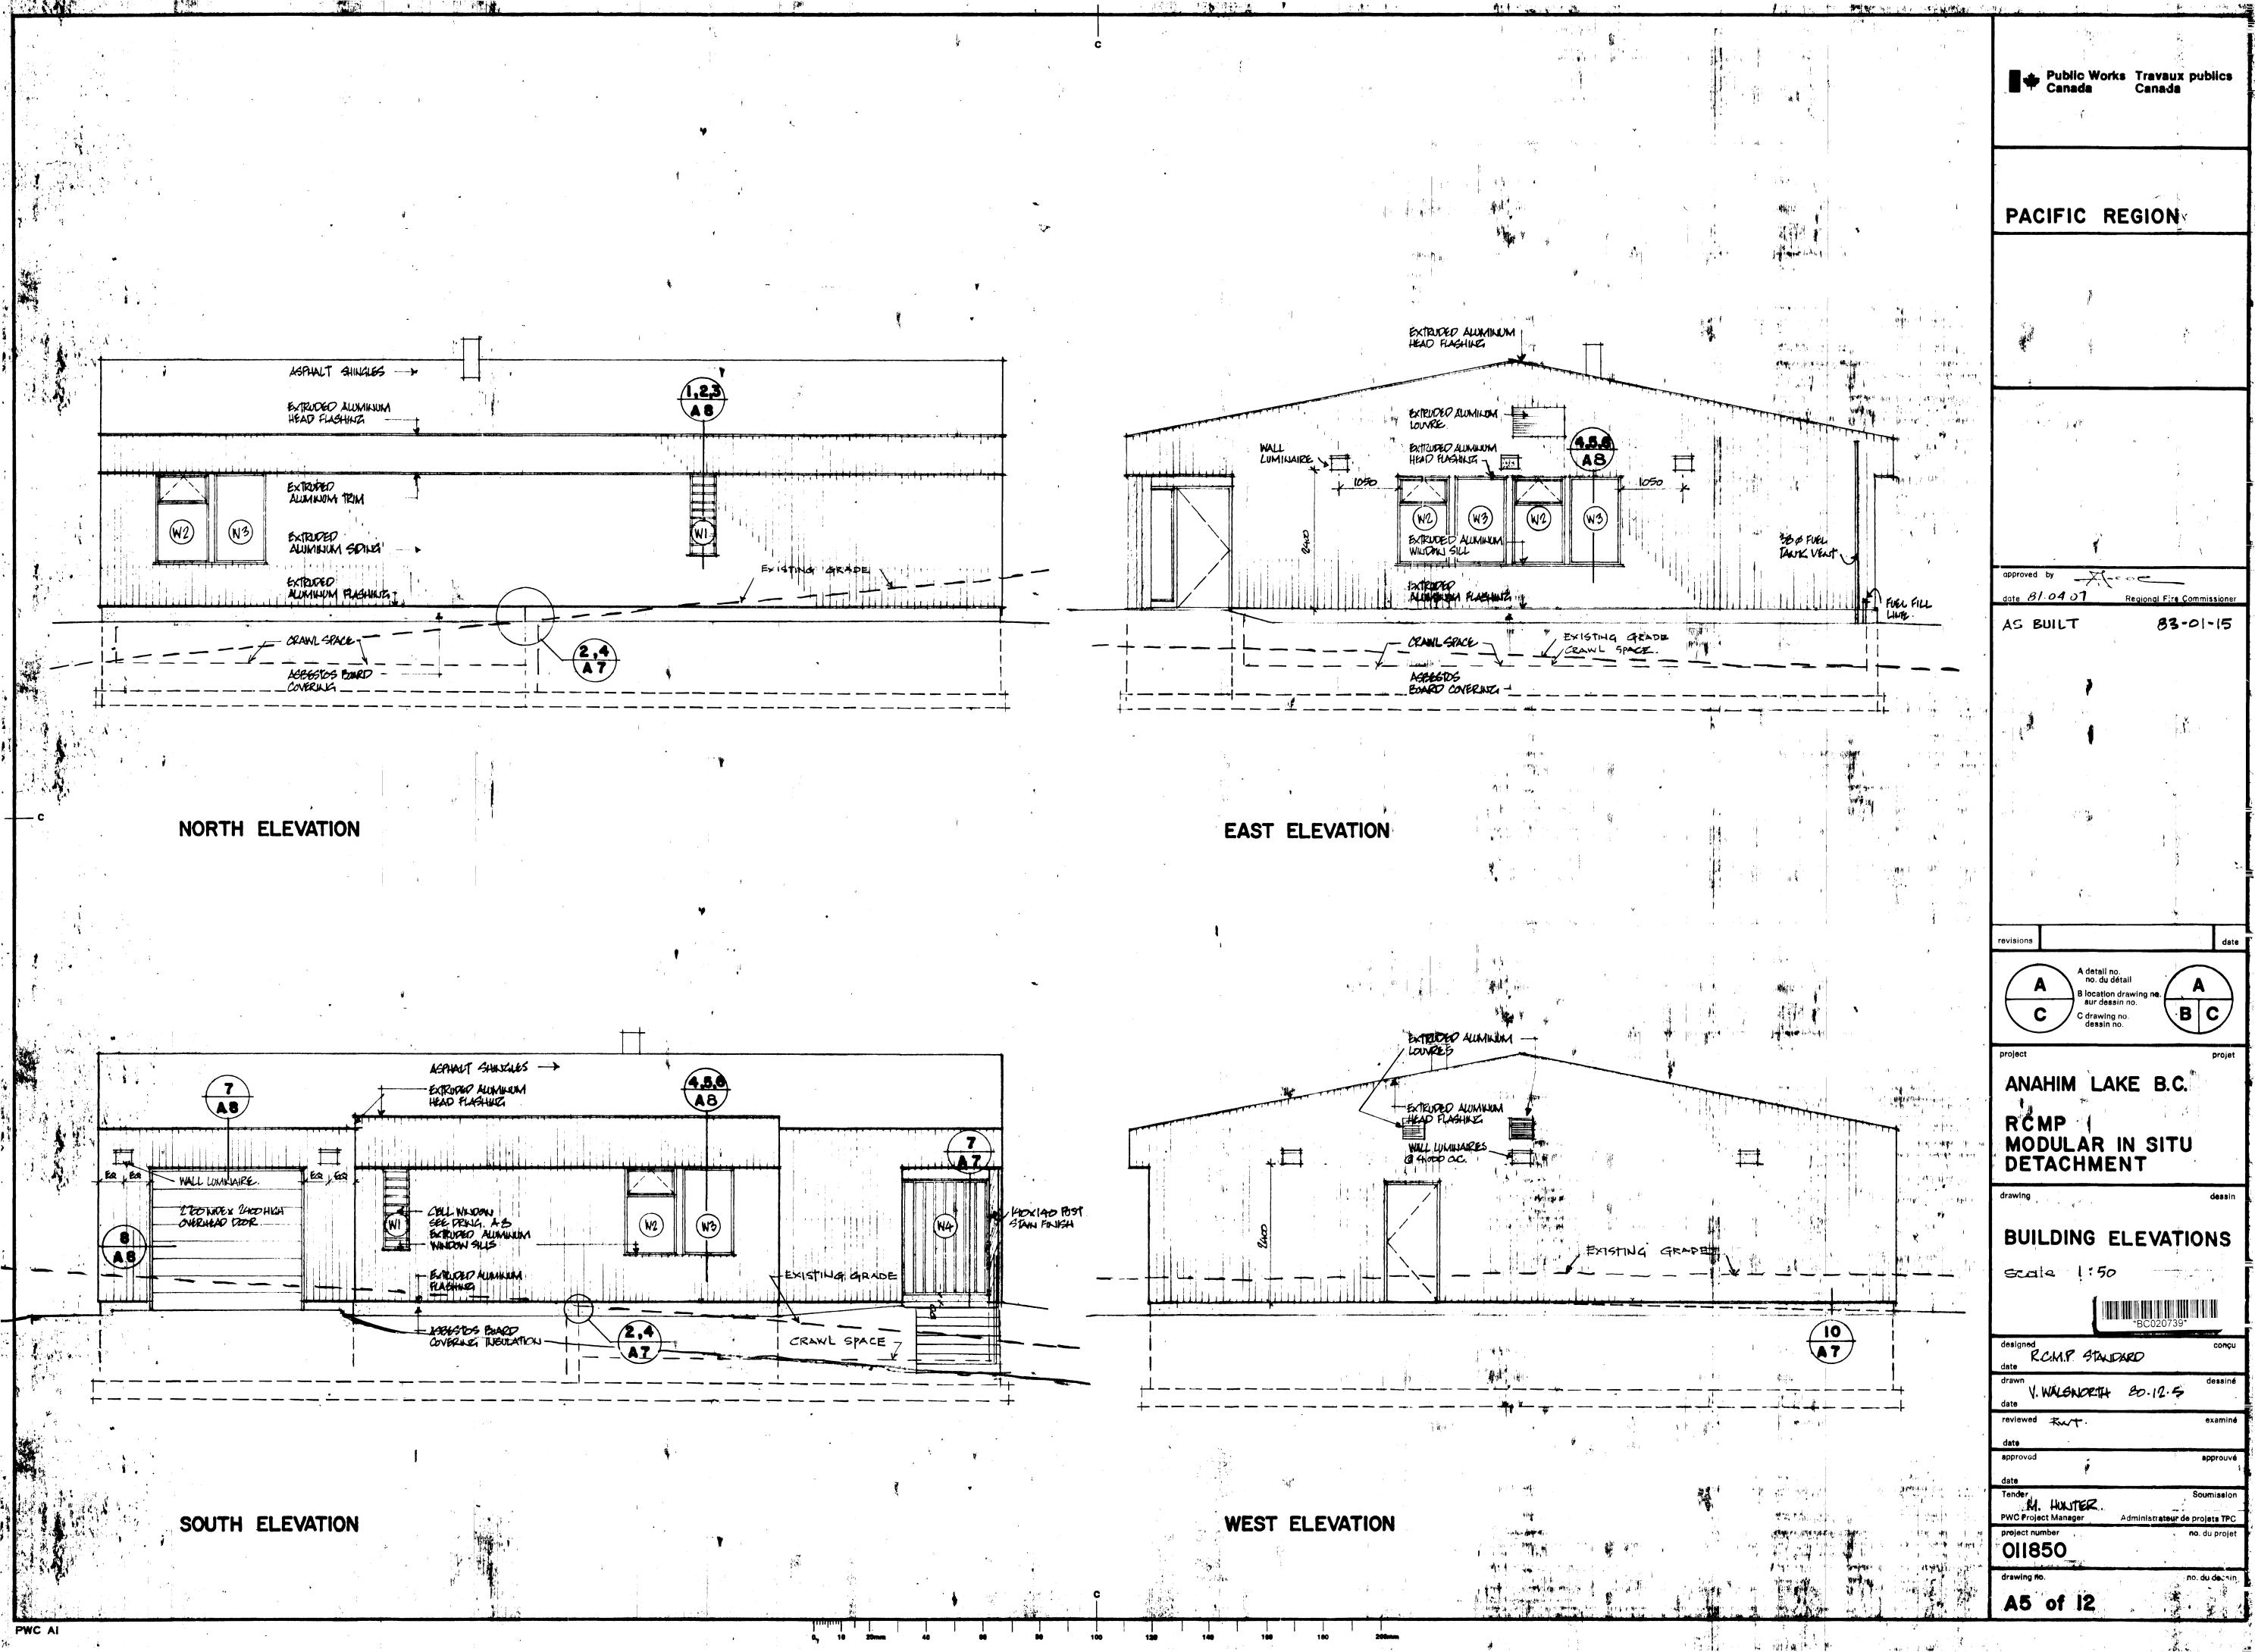


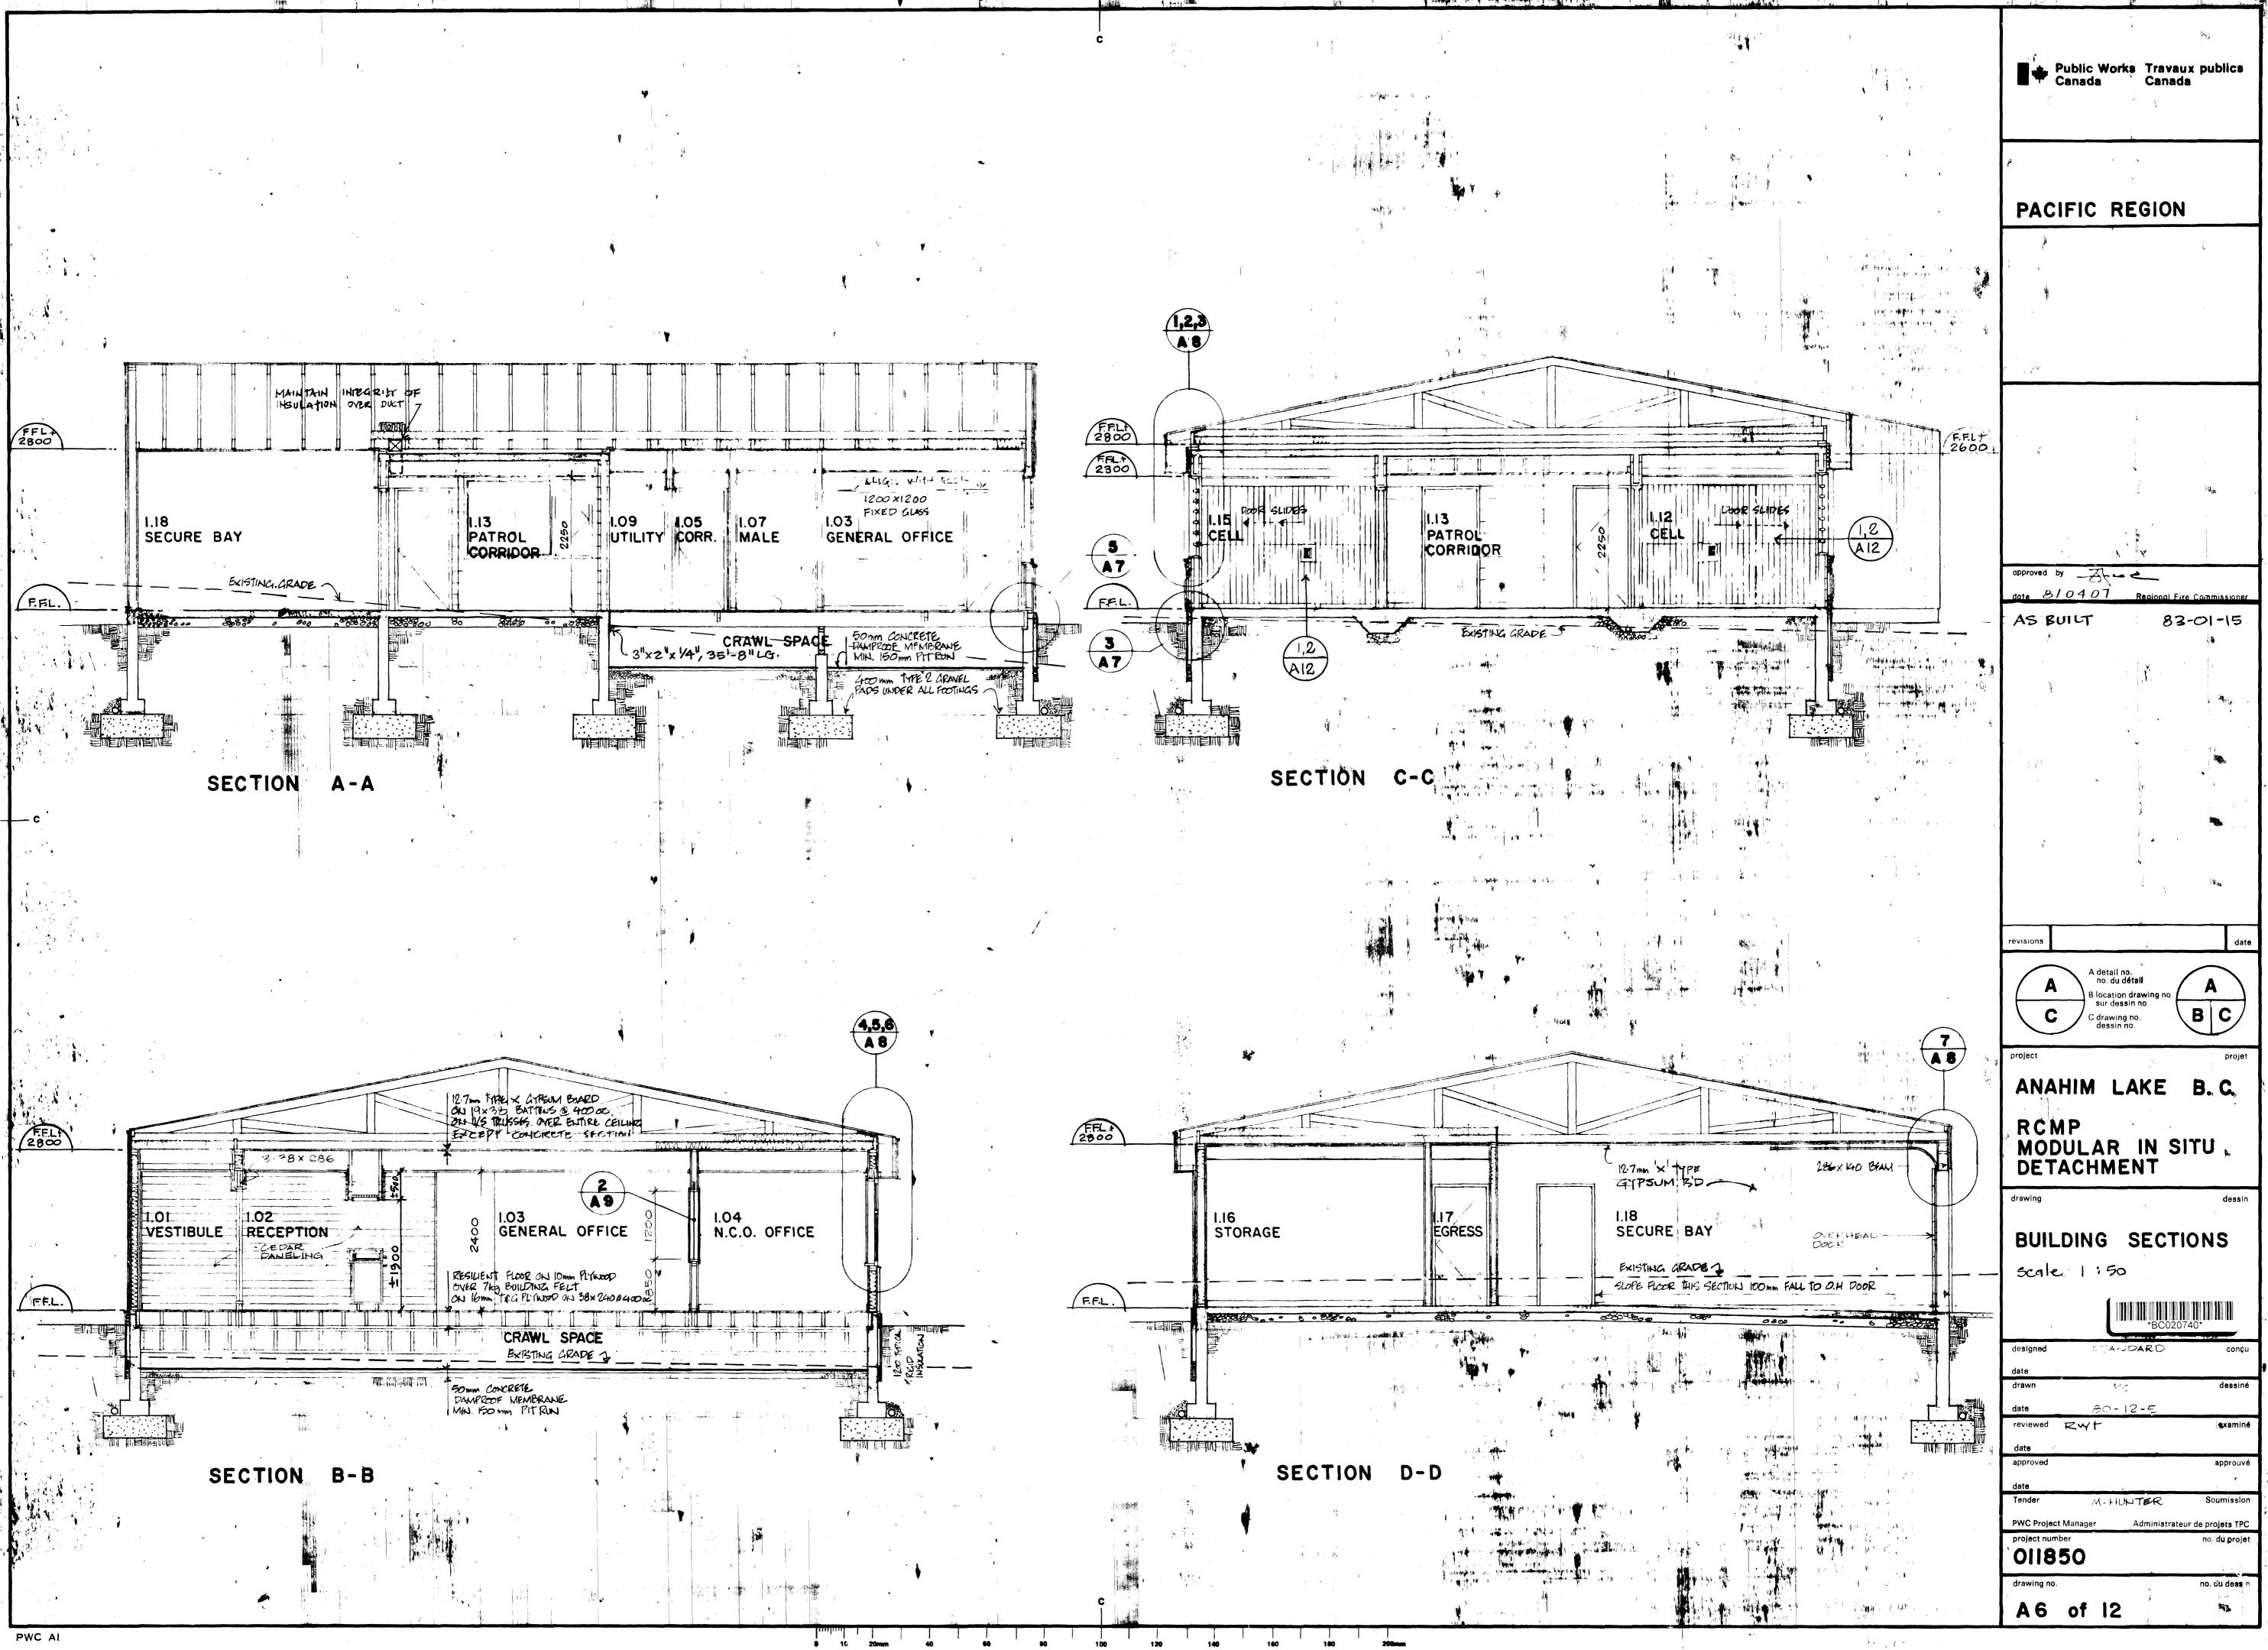


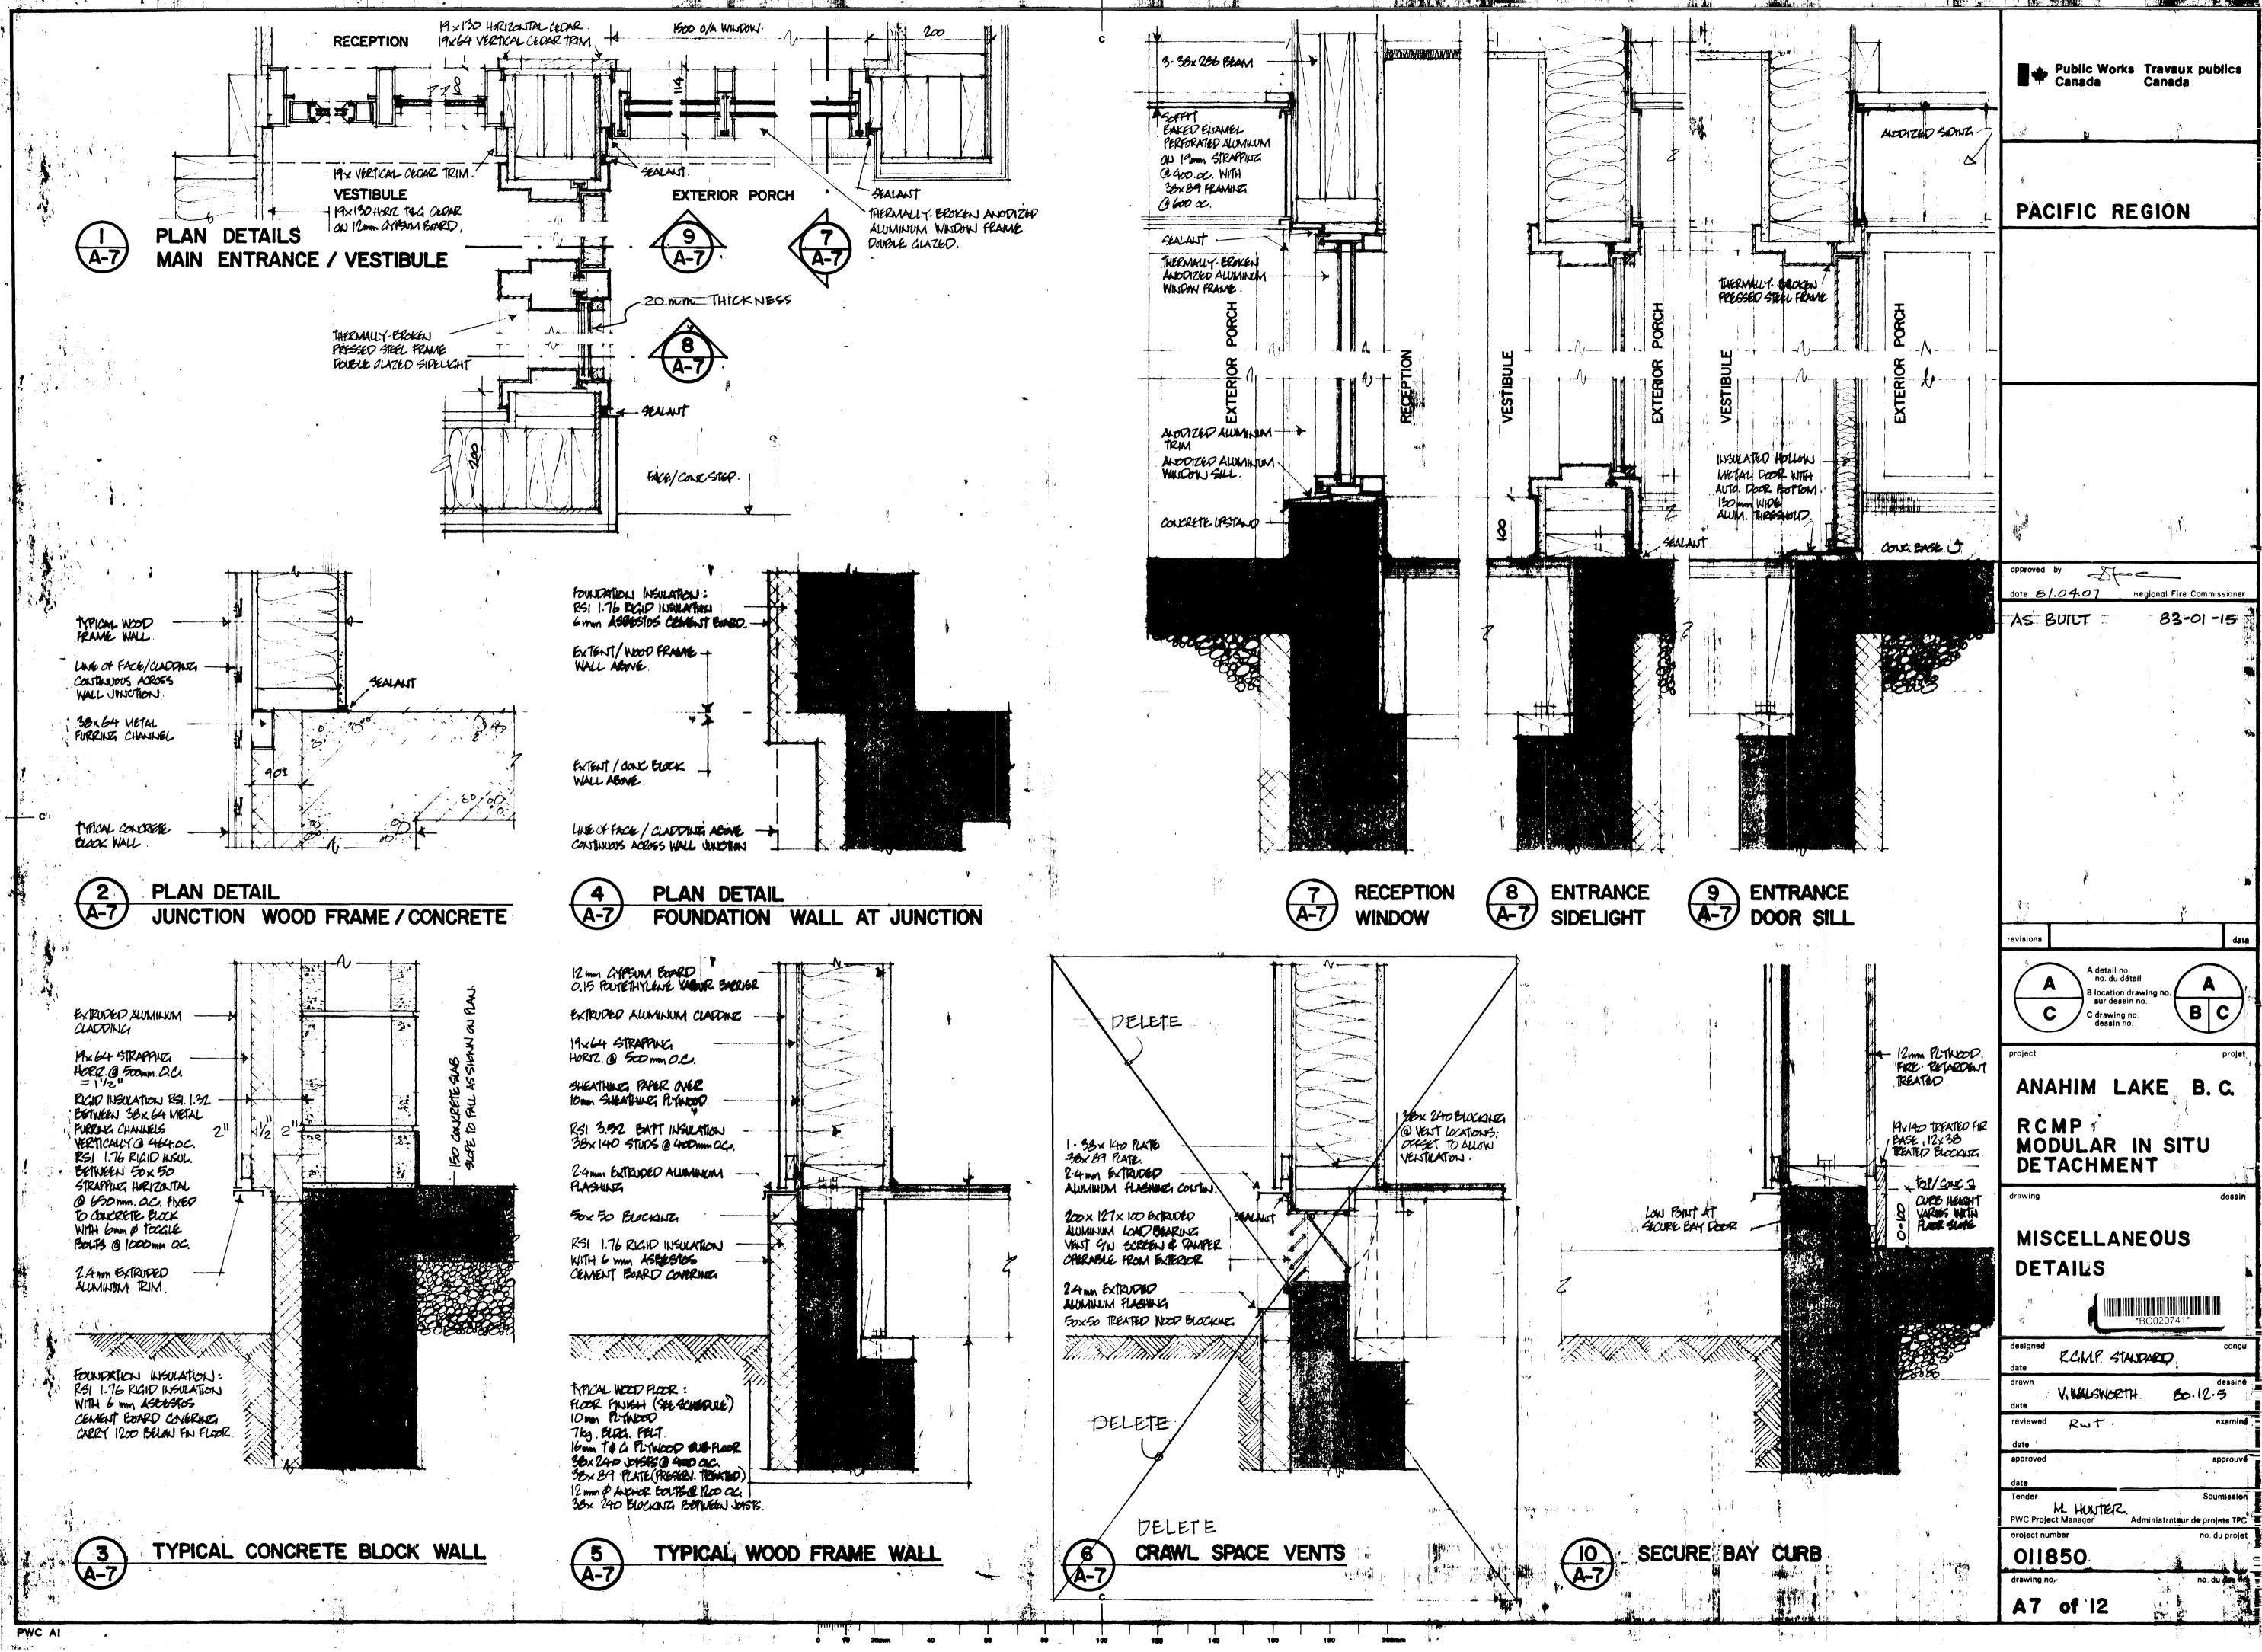


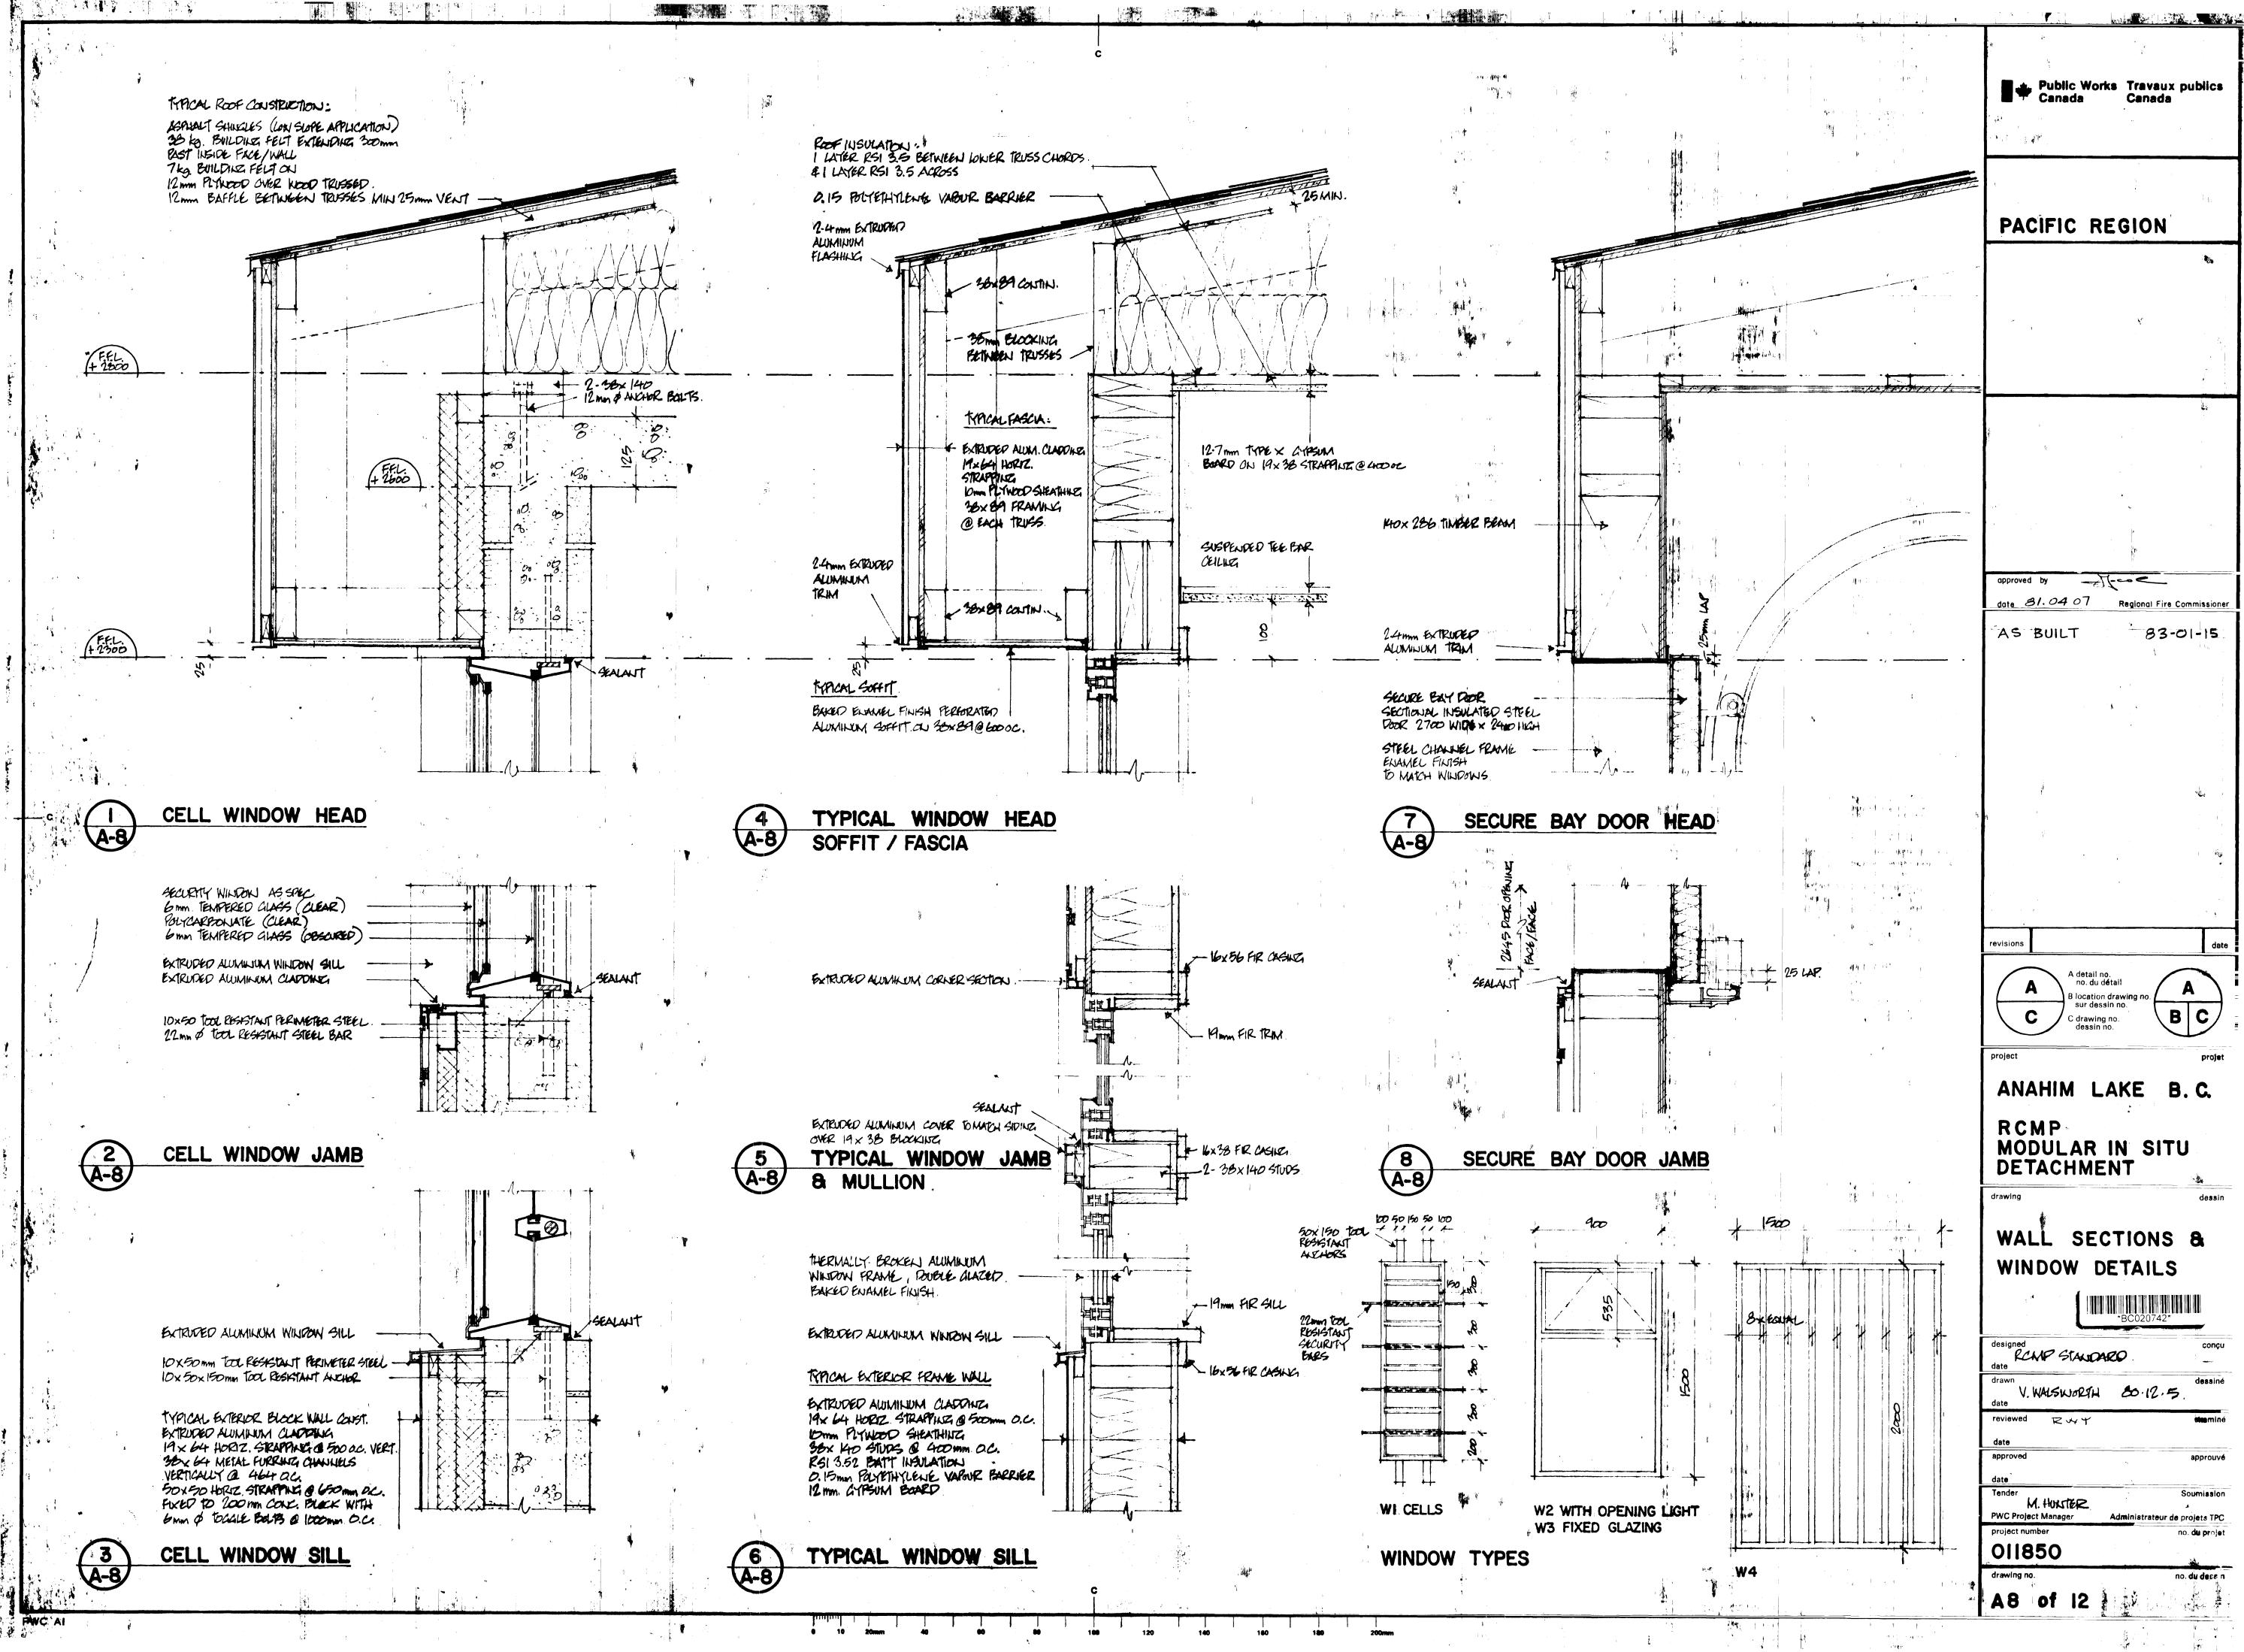


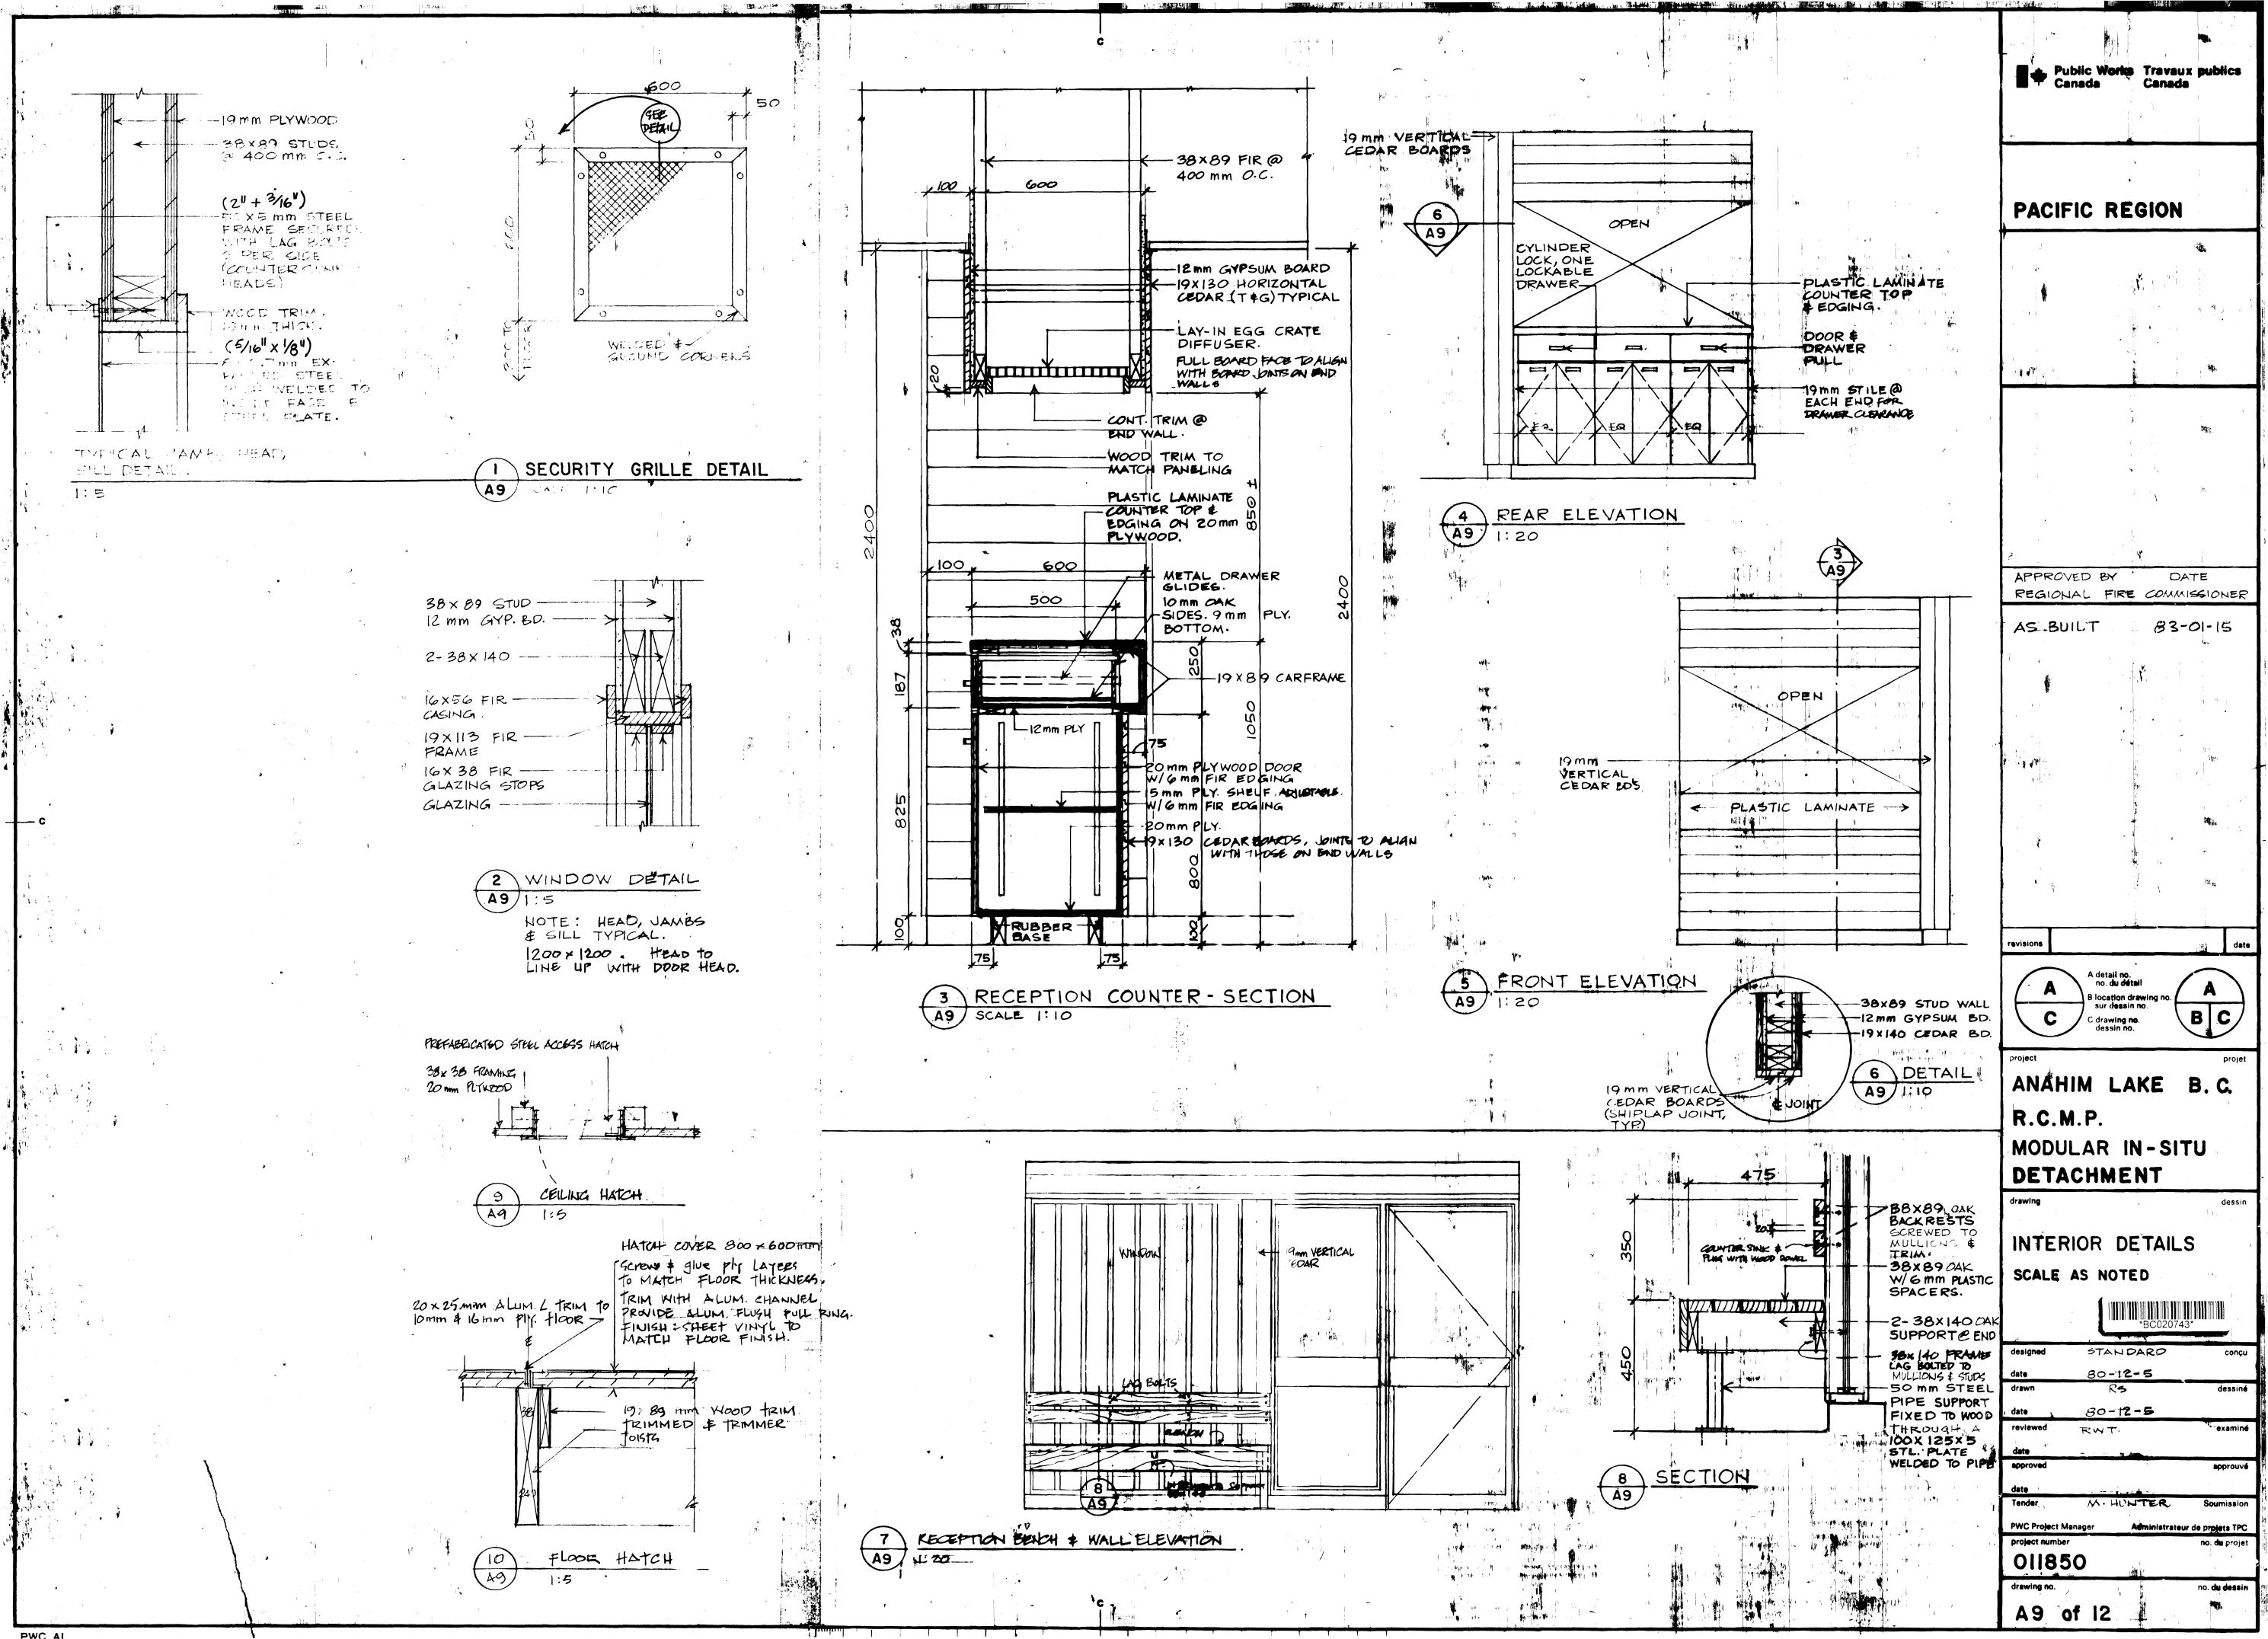


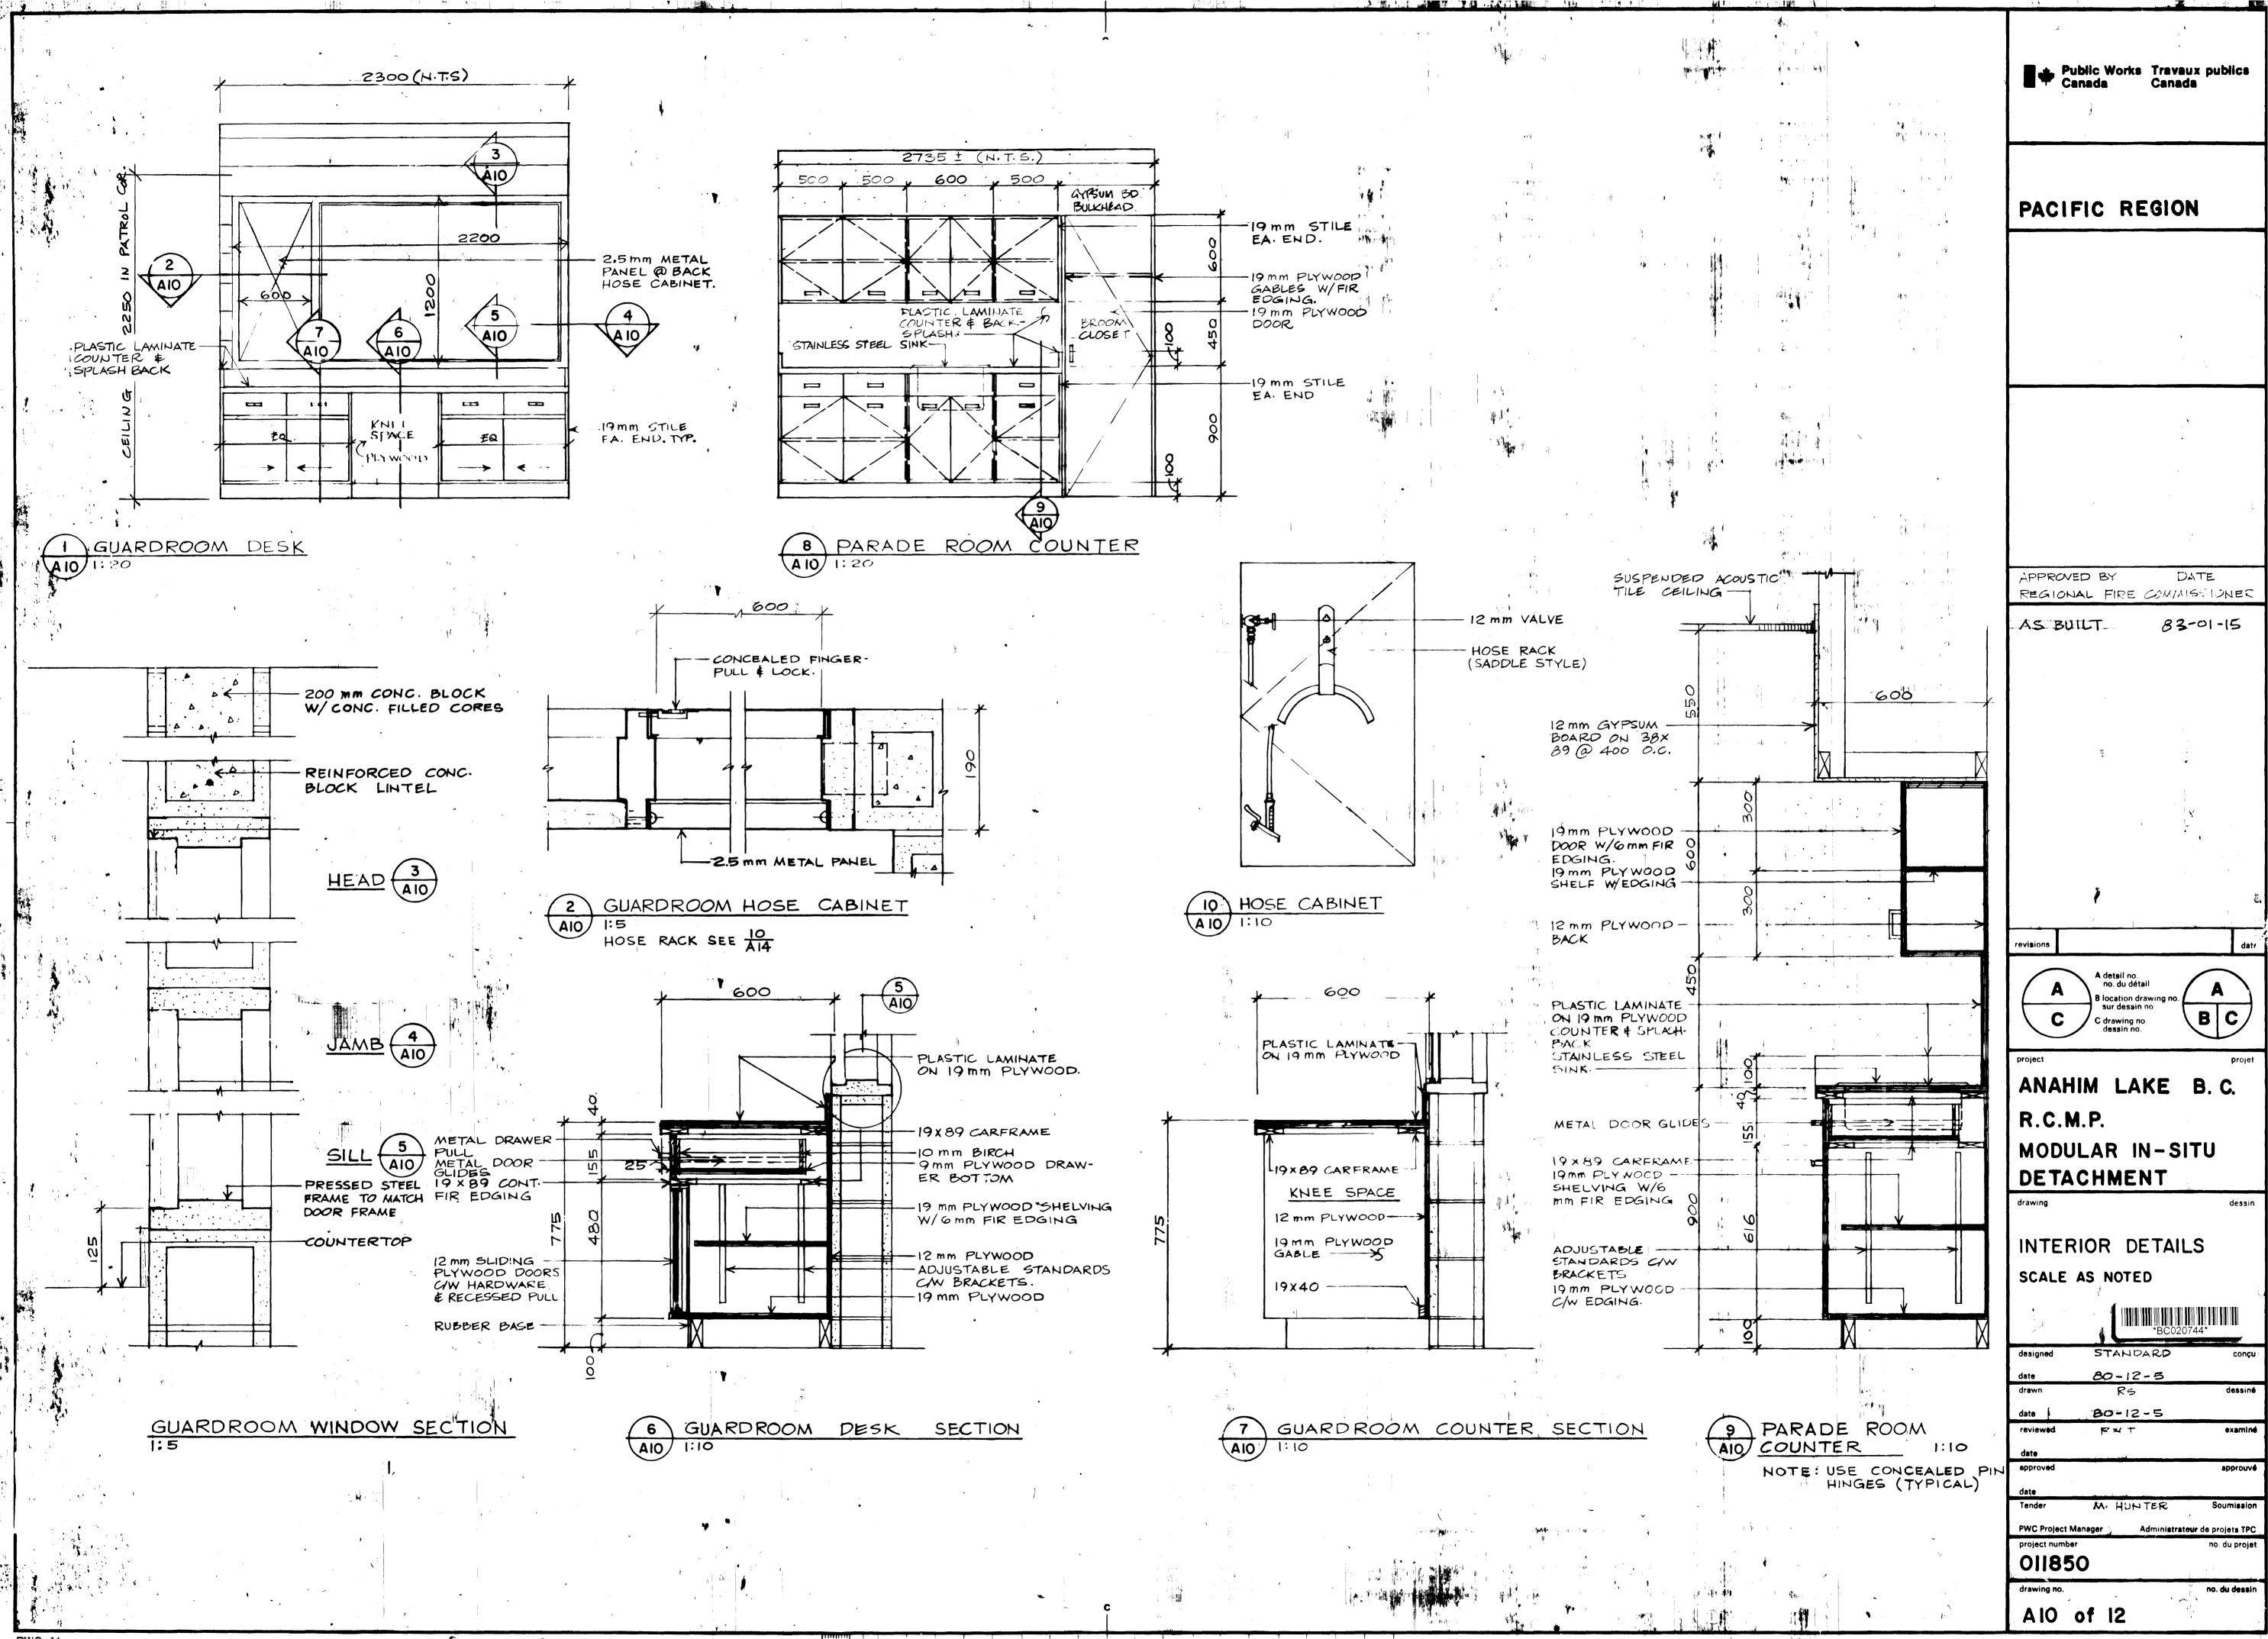

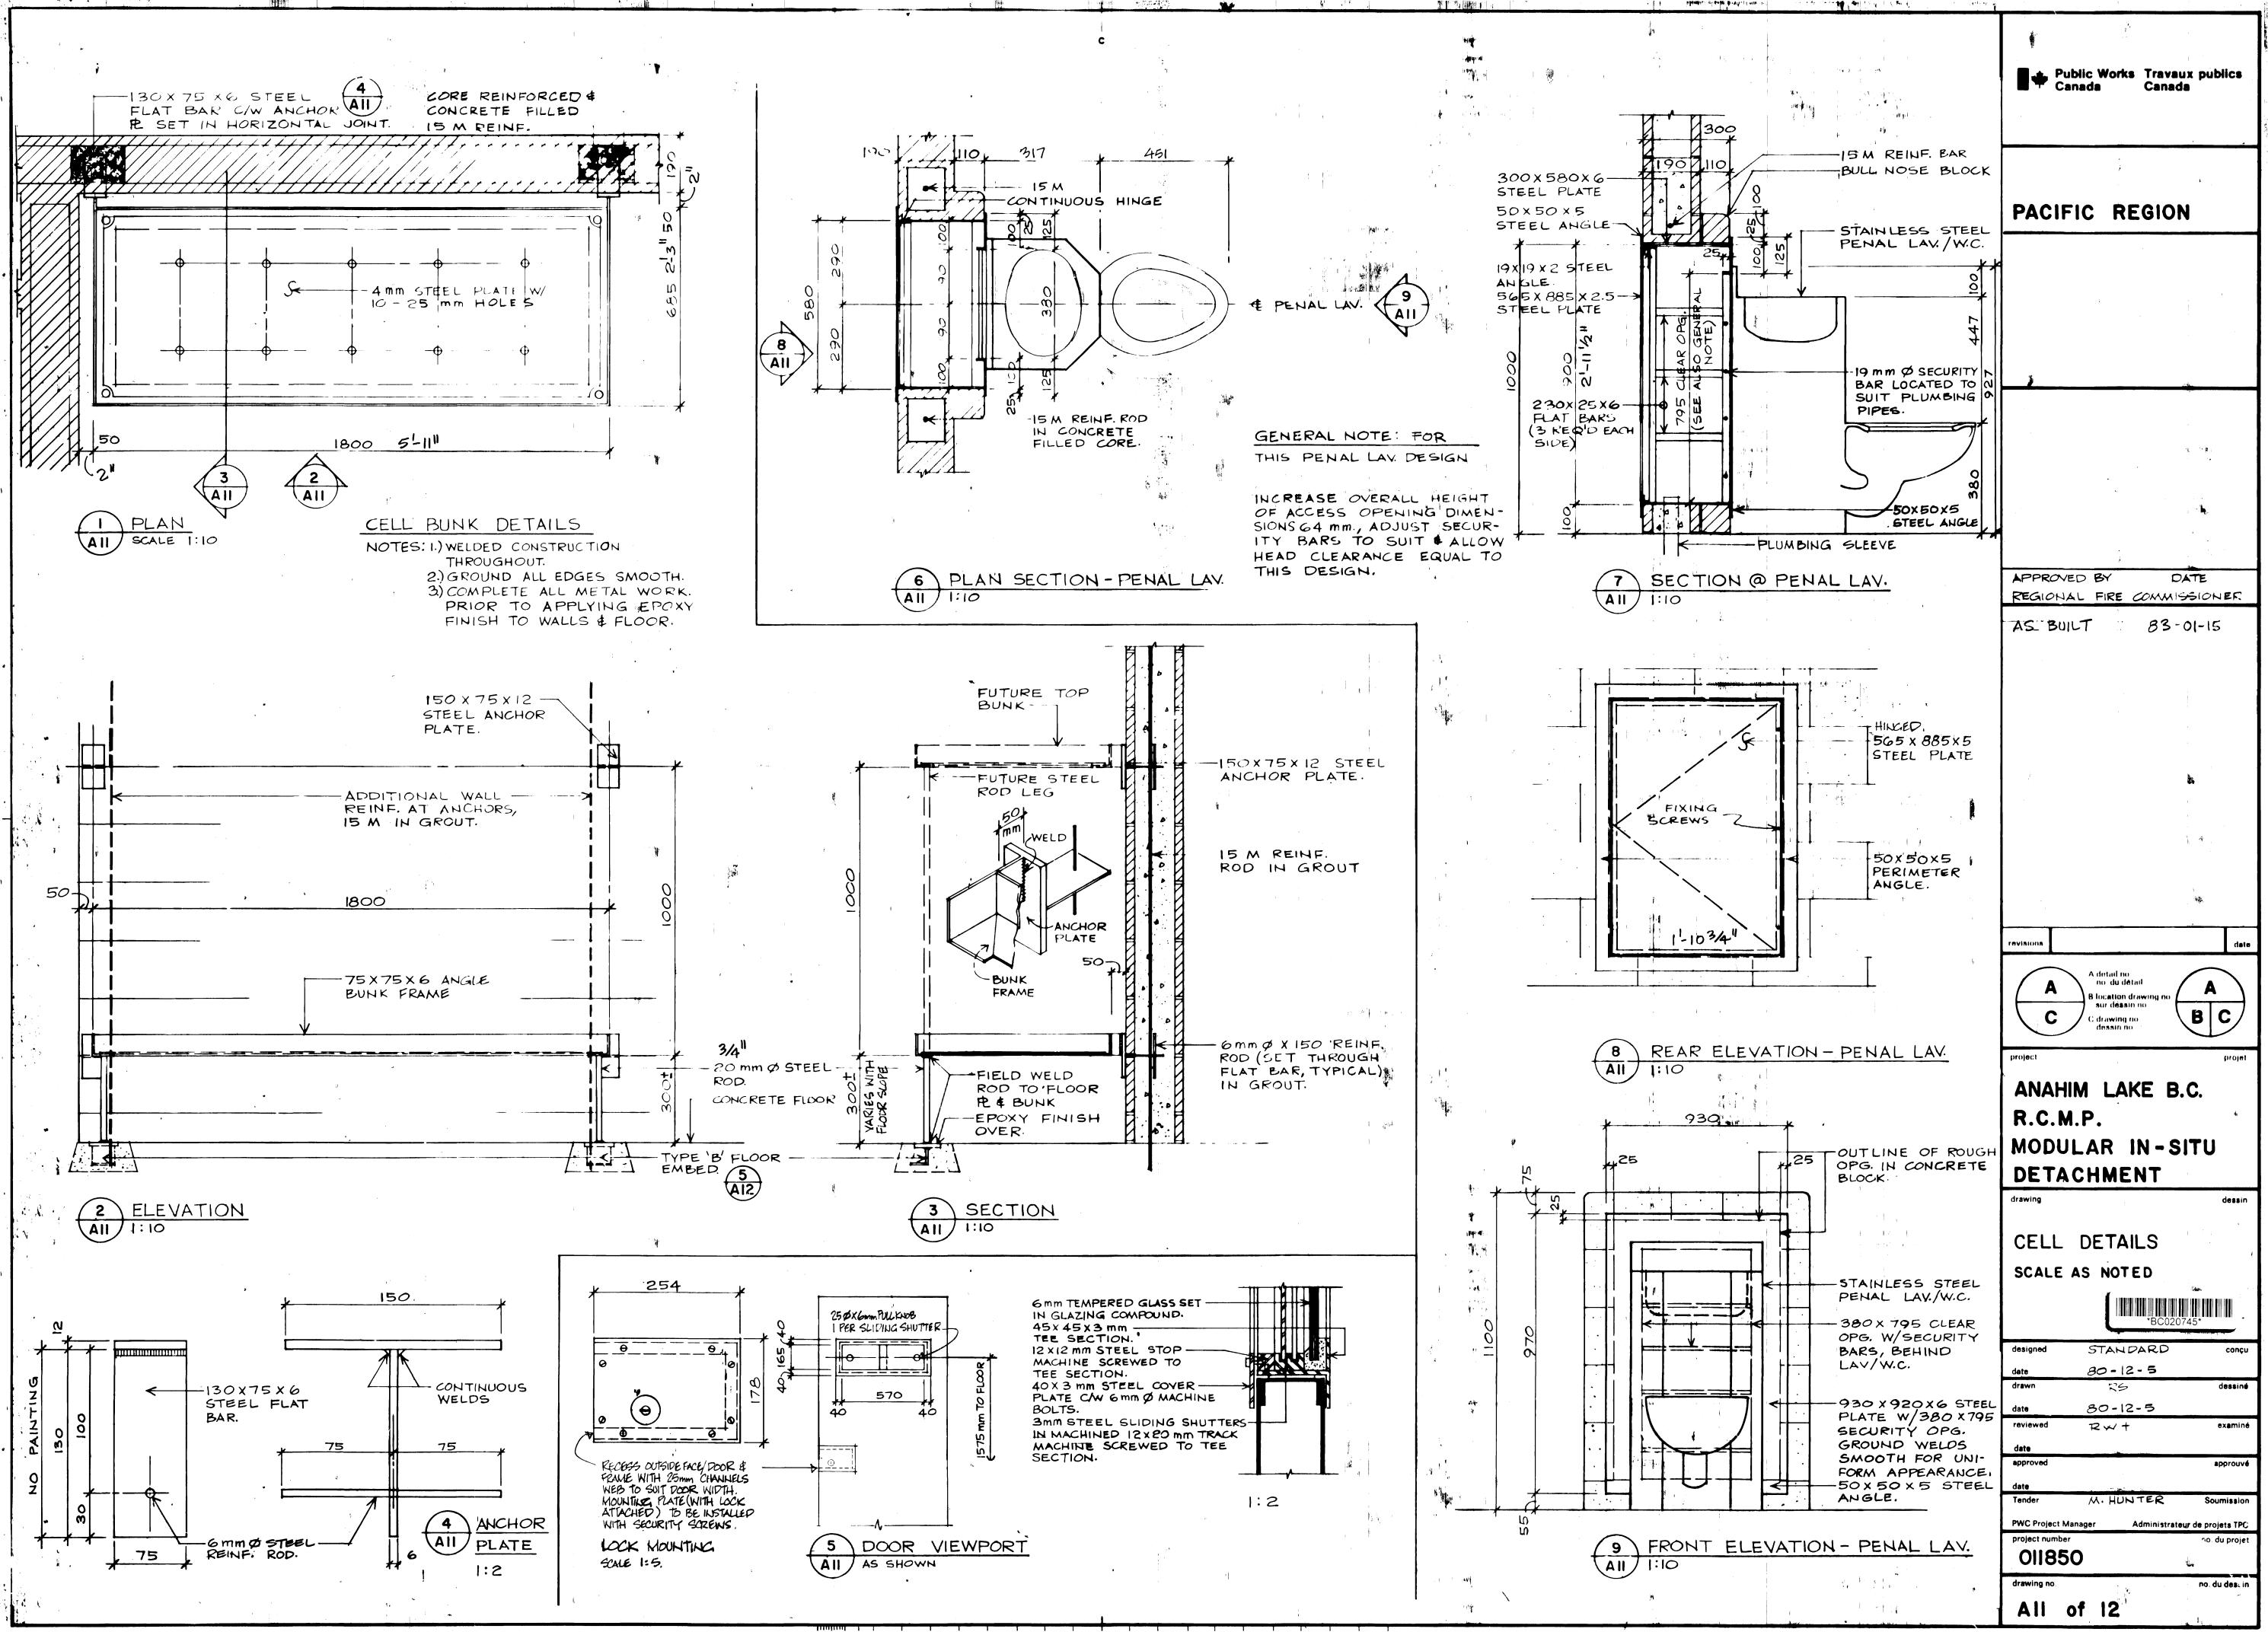

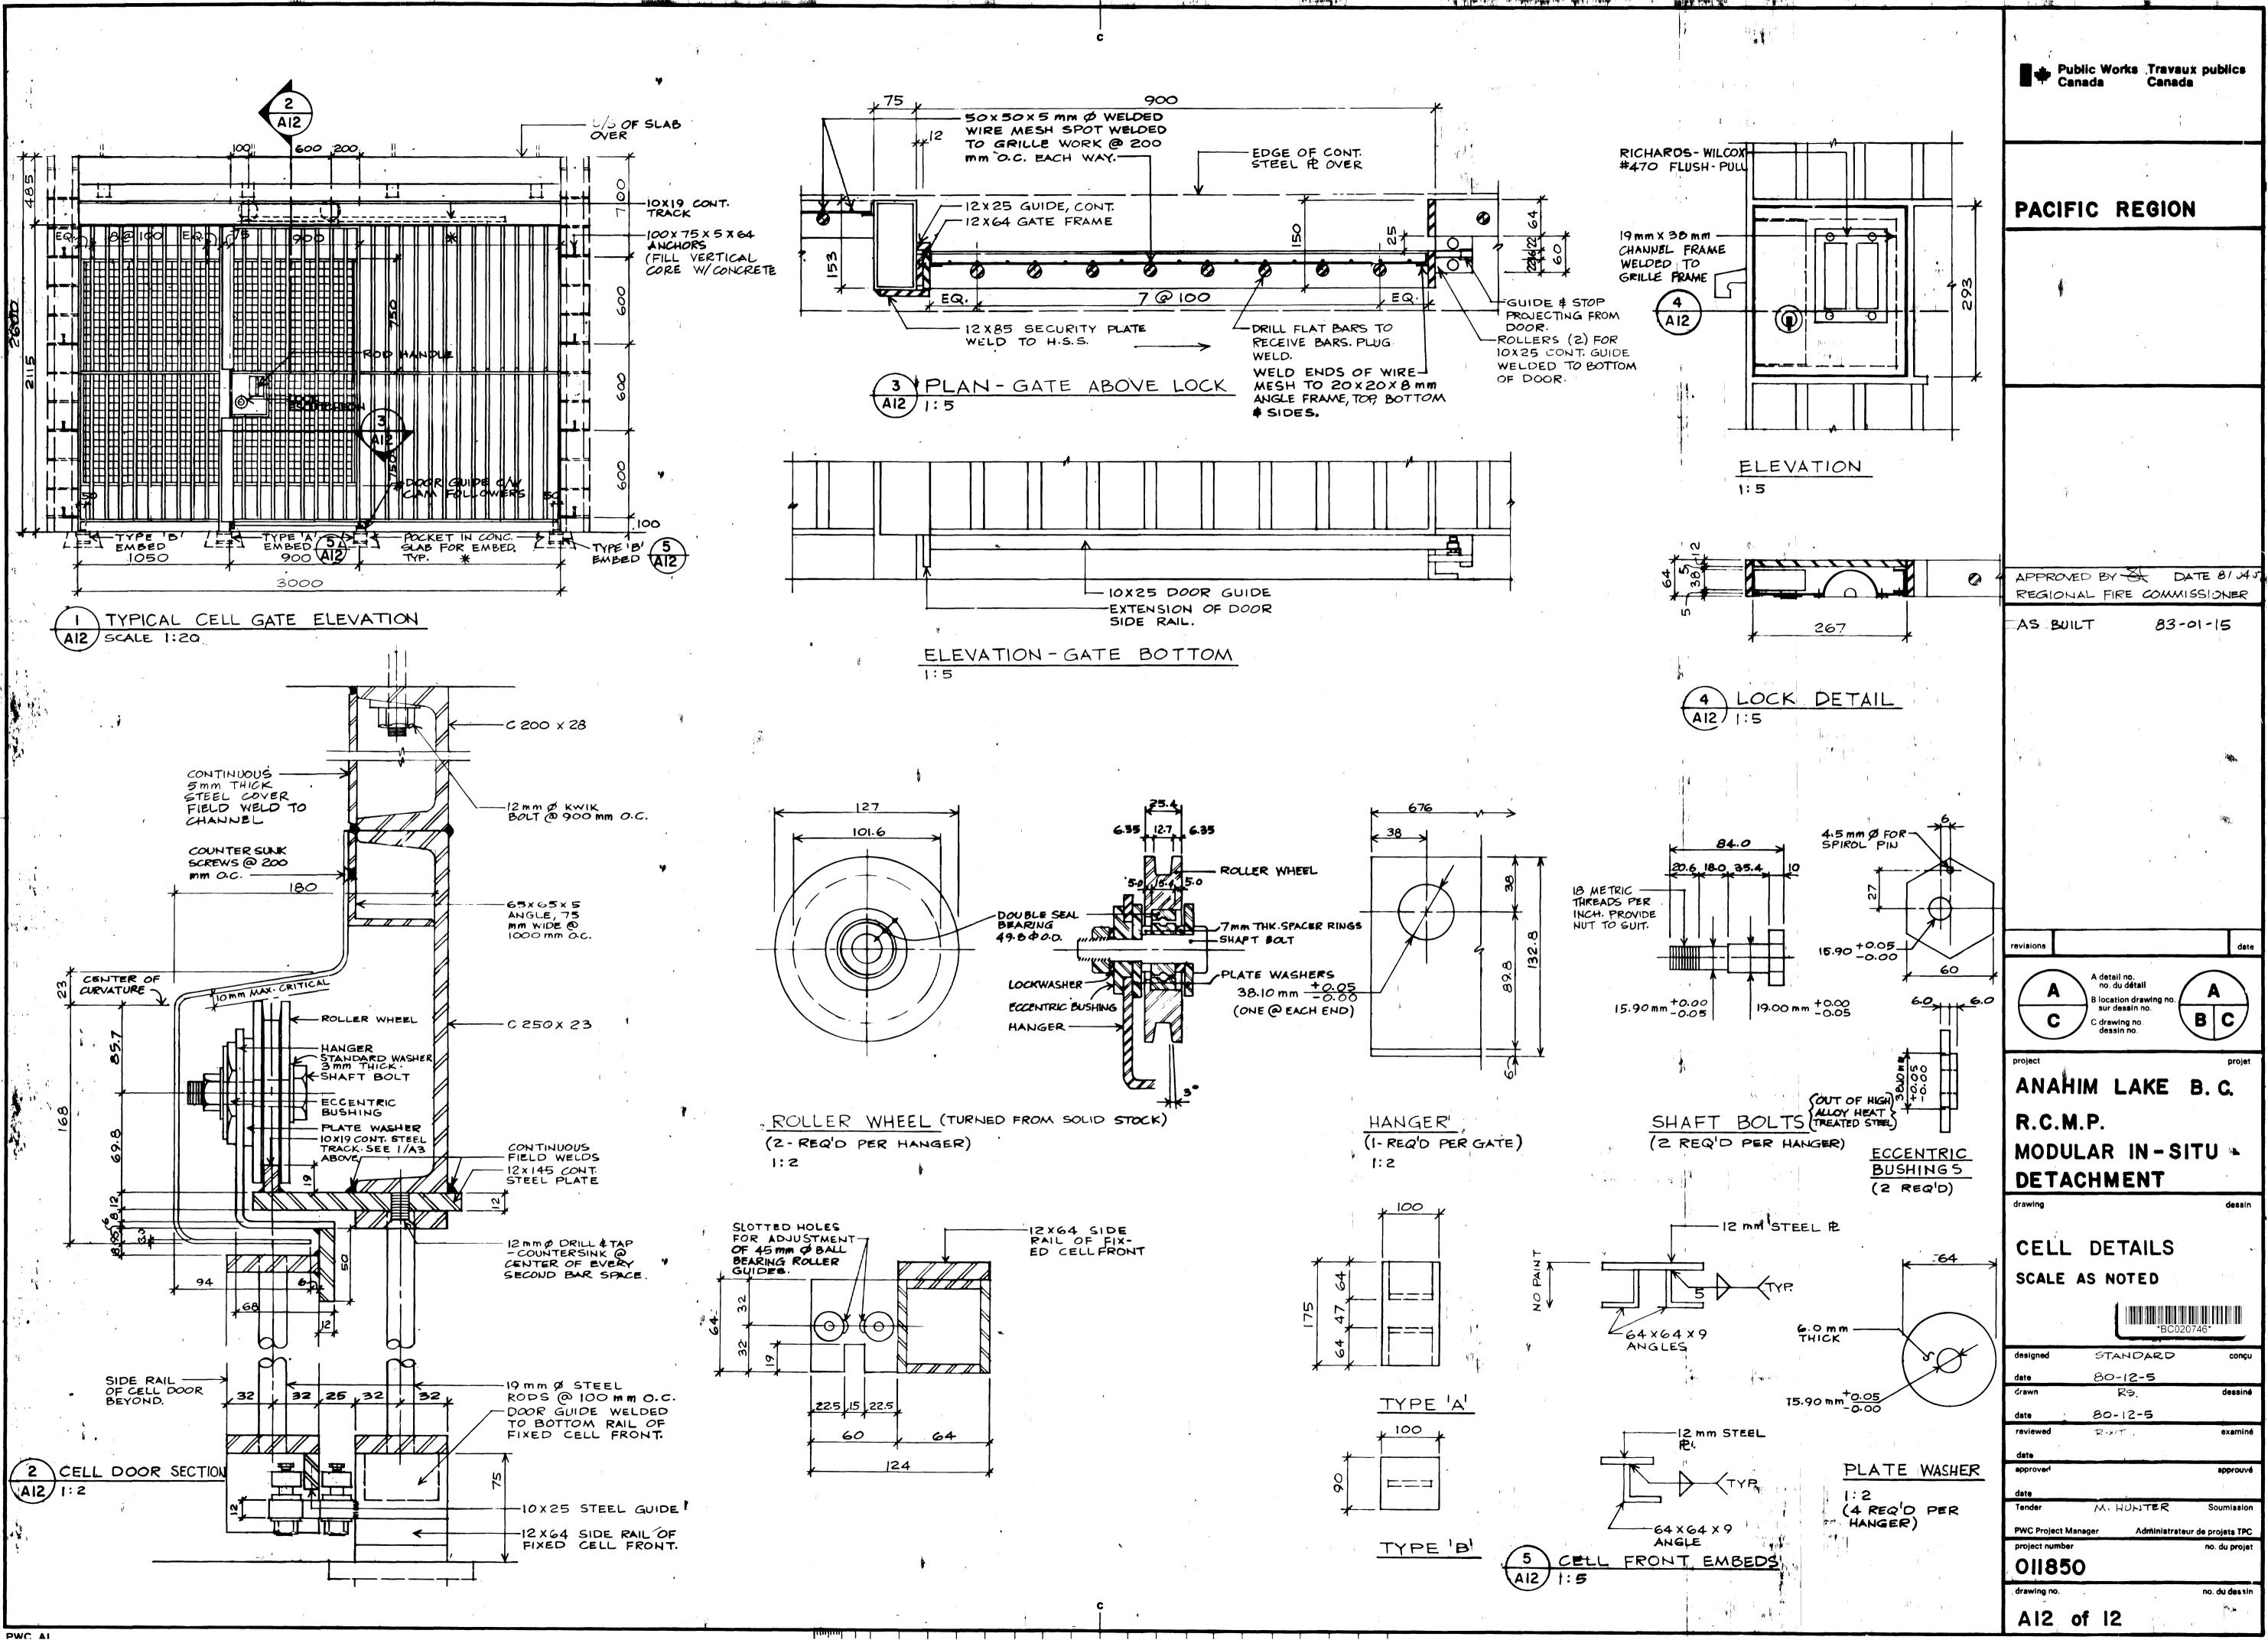


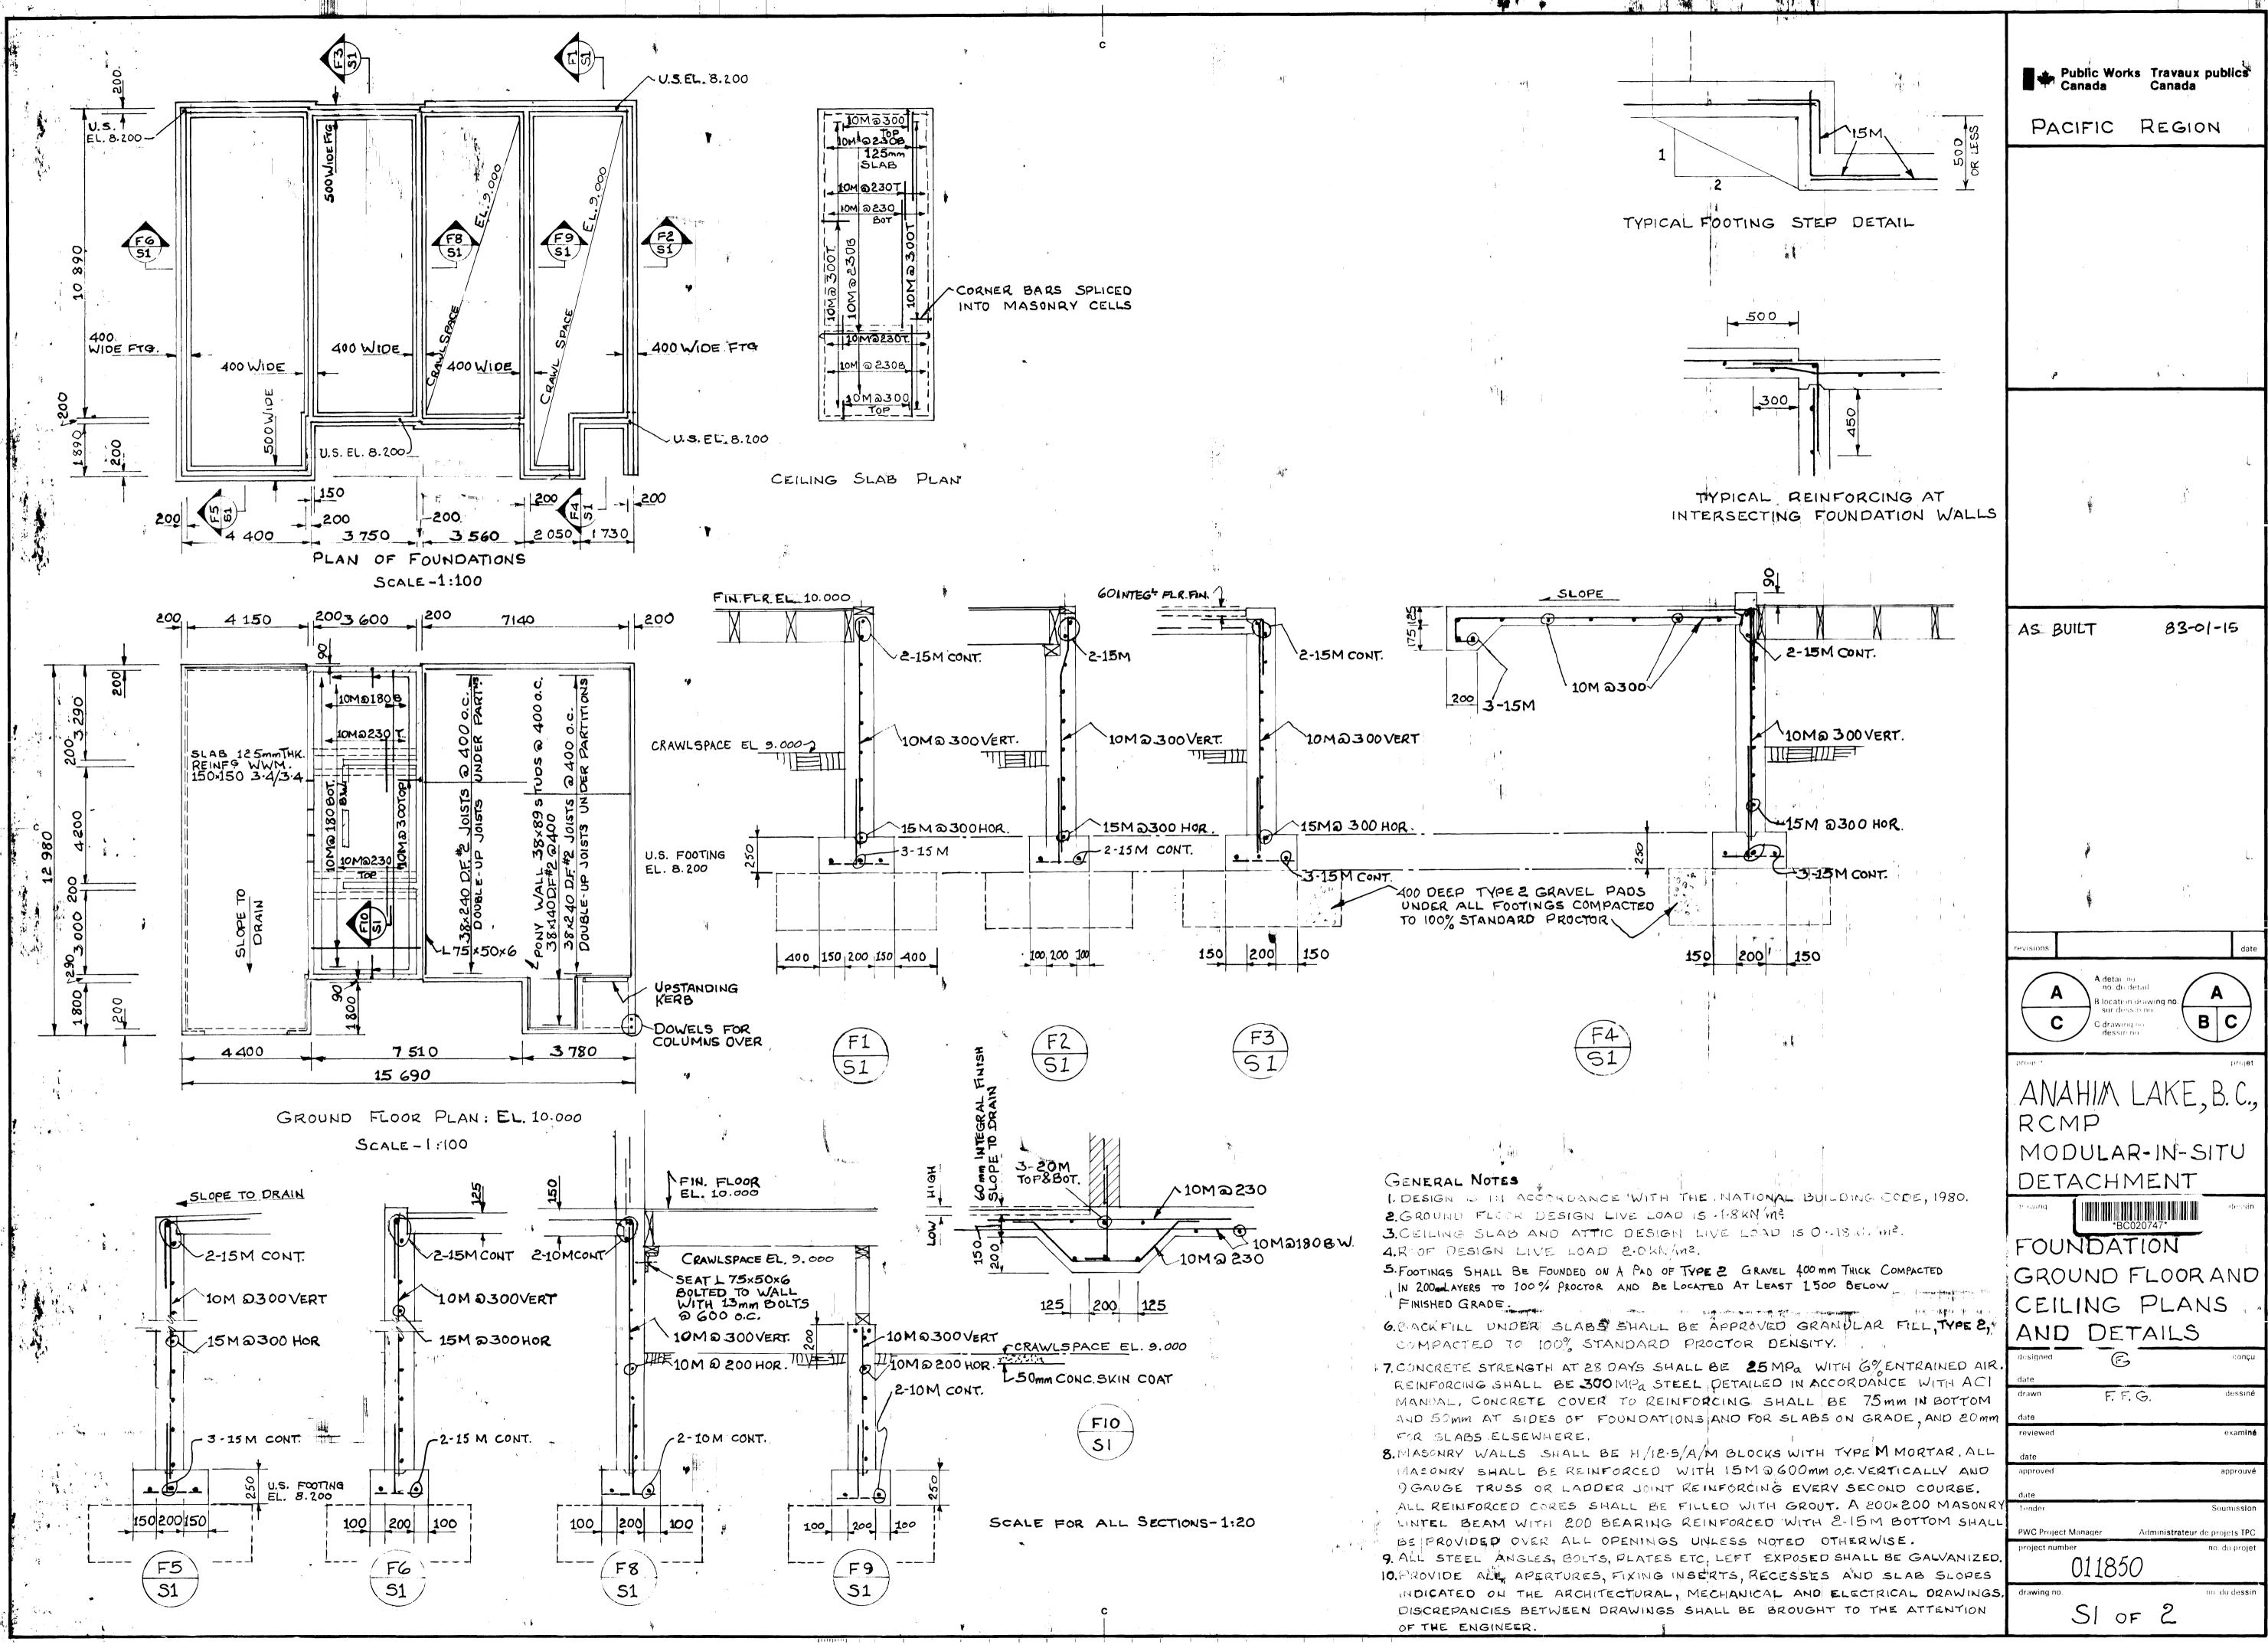


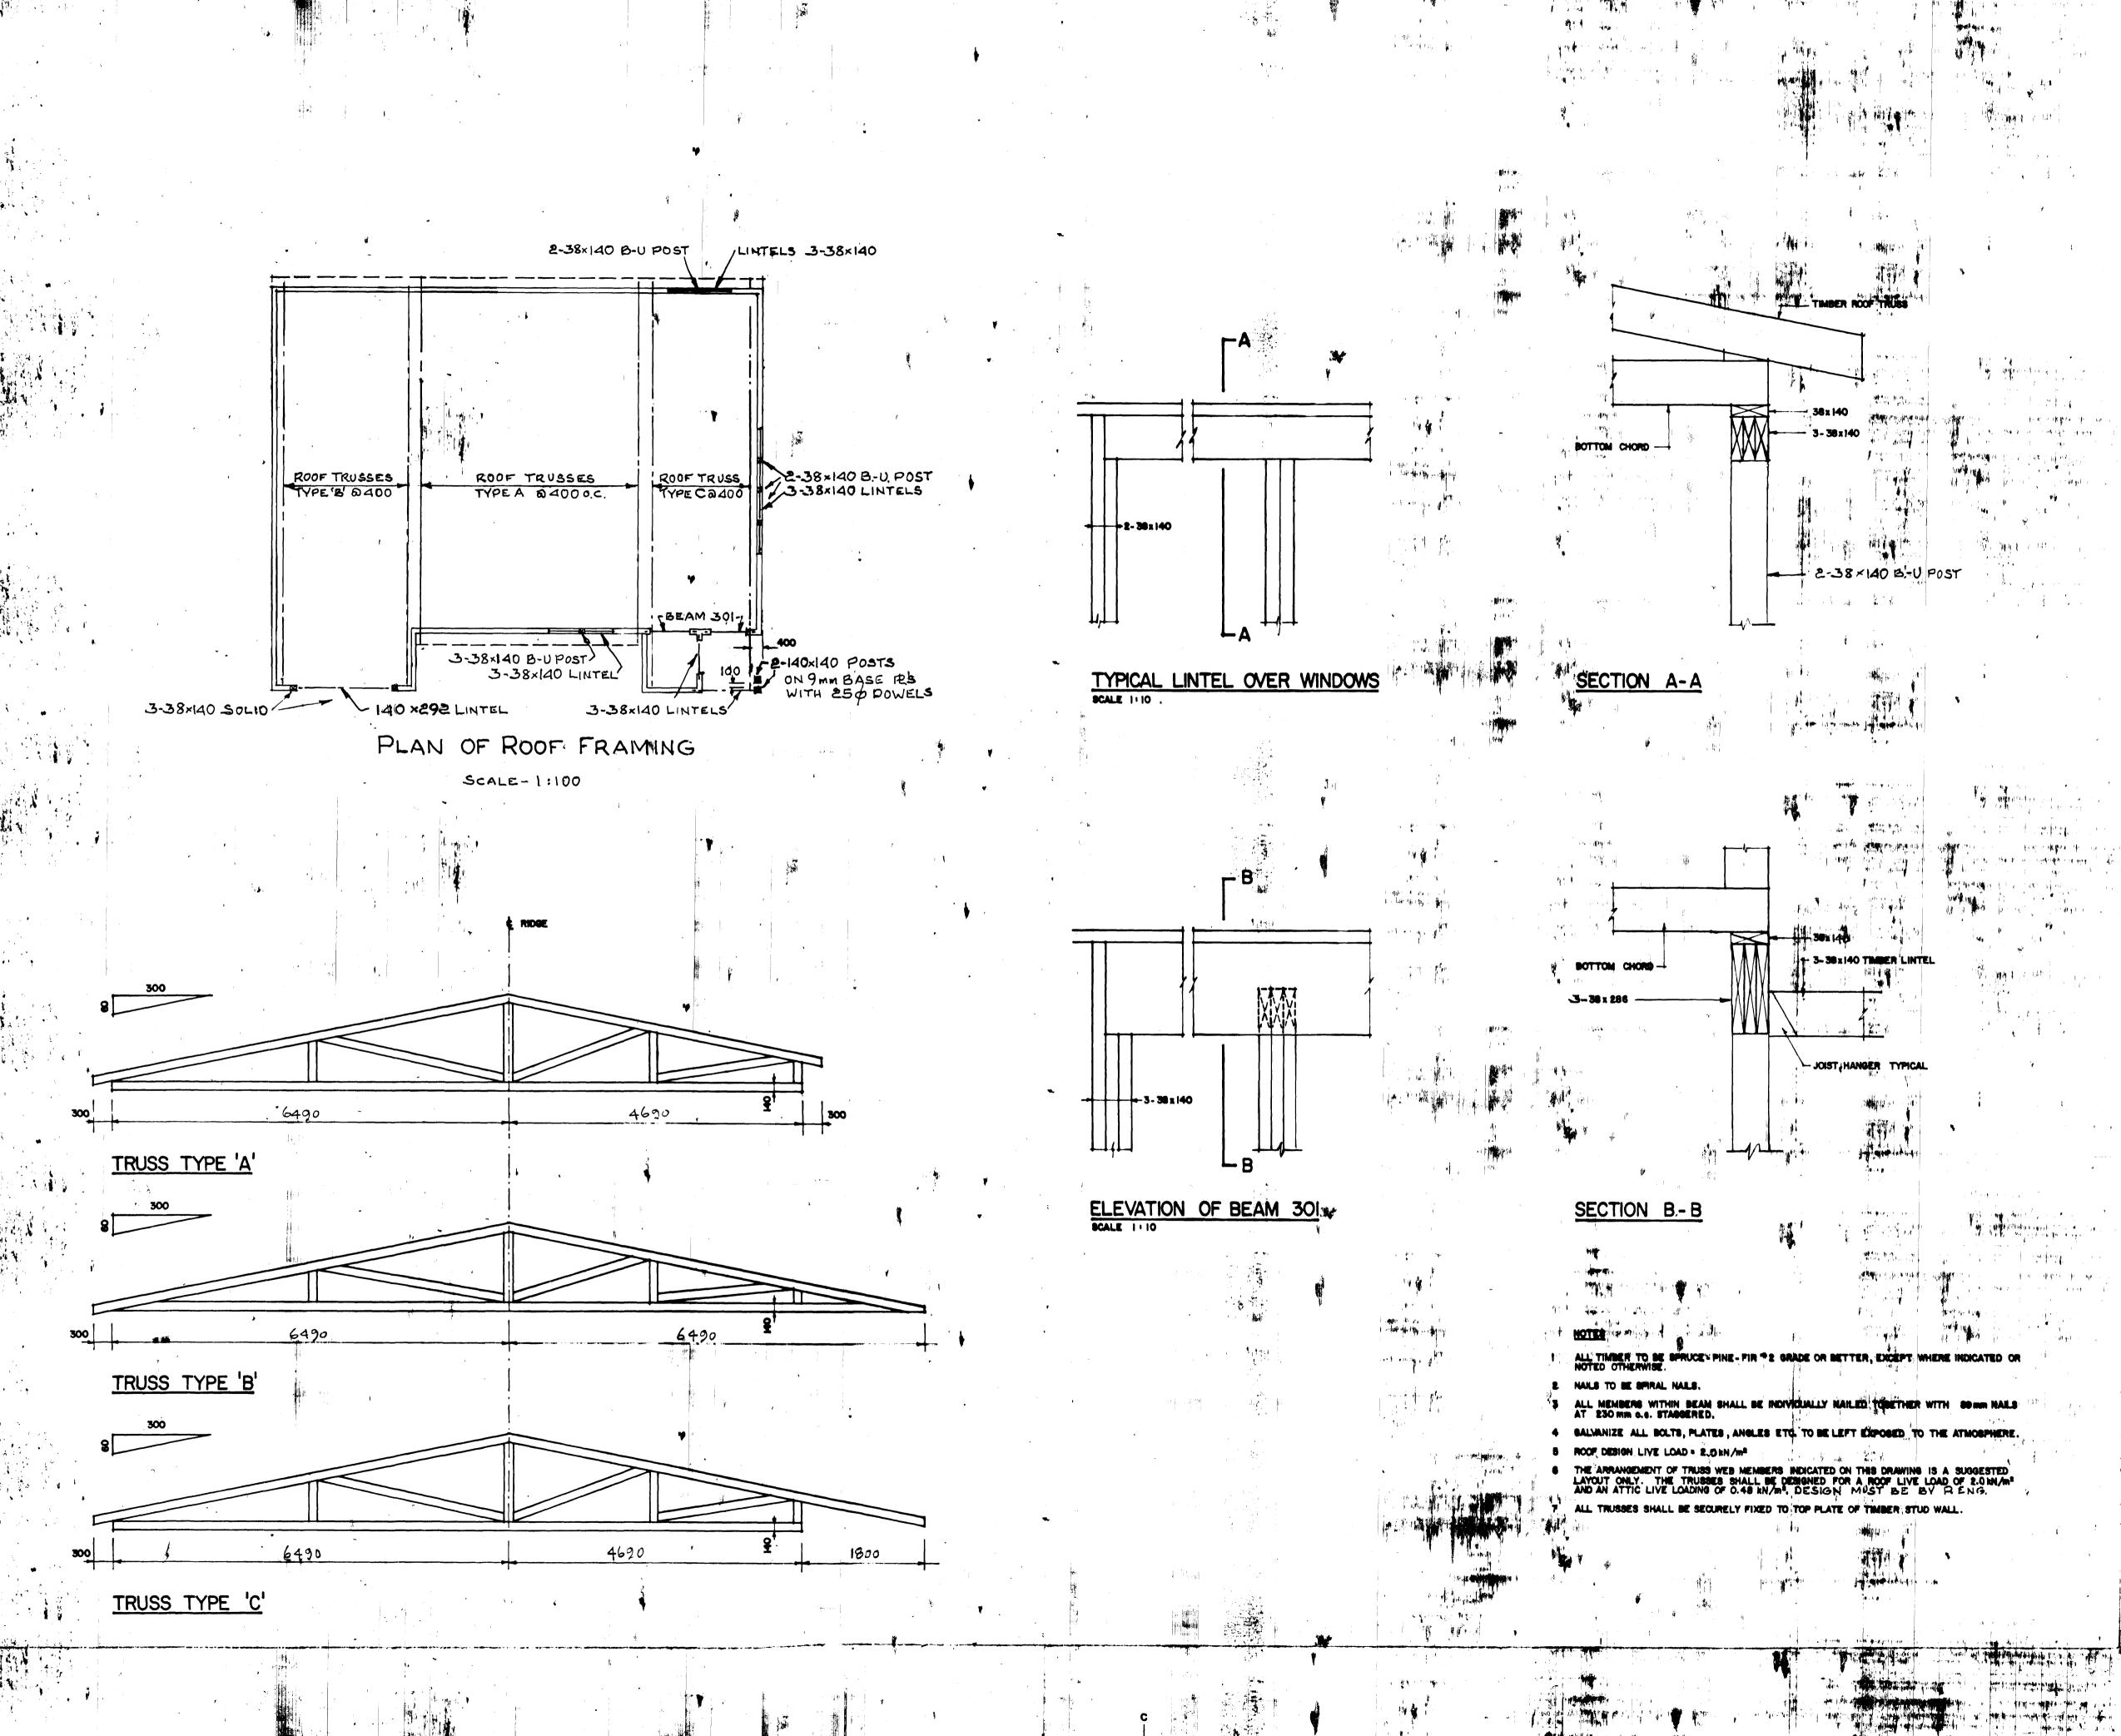



PACIFIC REGION AS BUILT 83-01-15 B location drawing n sur dessin no. C drawing no. dessin no. ANAHIM LAKE, B.C., MODULAR-IN-SITU DETACHMENT \*BC020748\* ROOF FRAMING DETAILS E 80-11-12 F.F.G. 80-11-14 011850

52 of 2

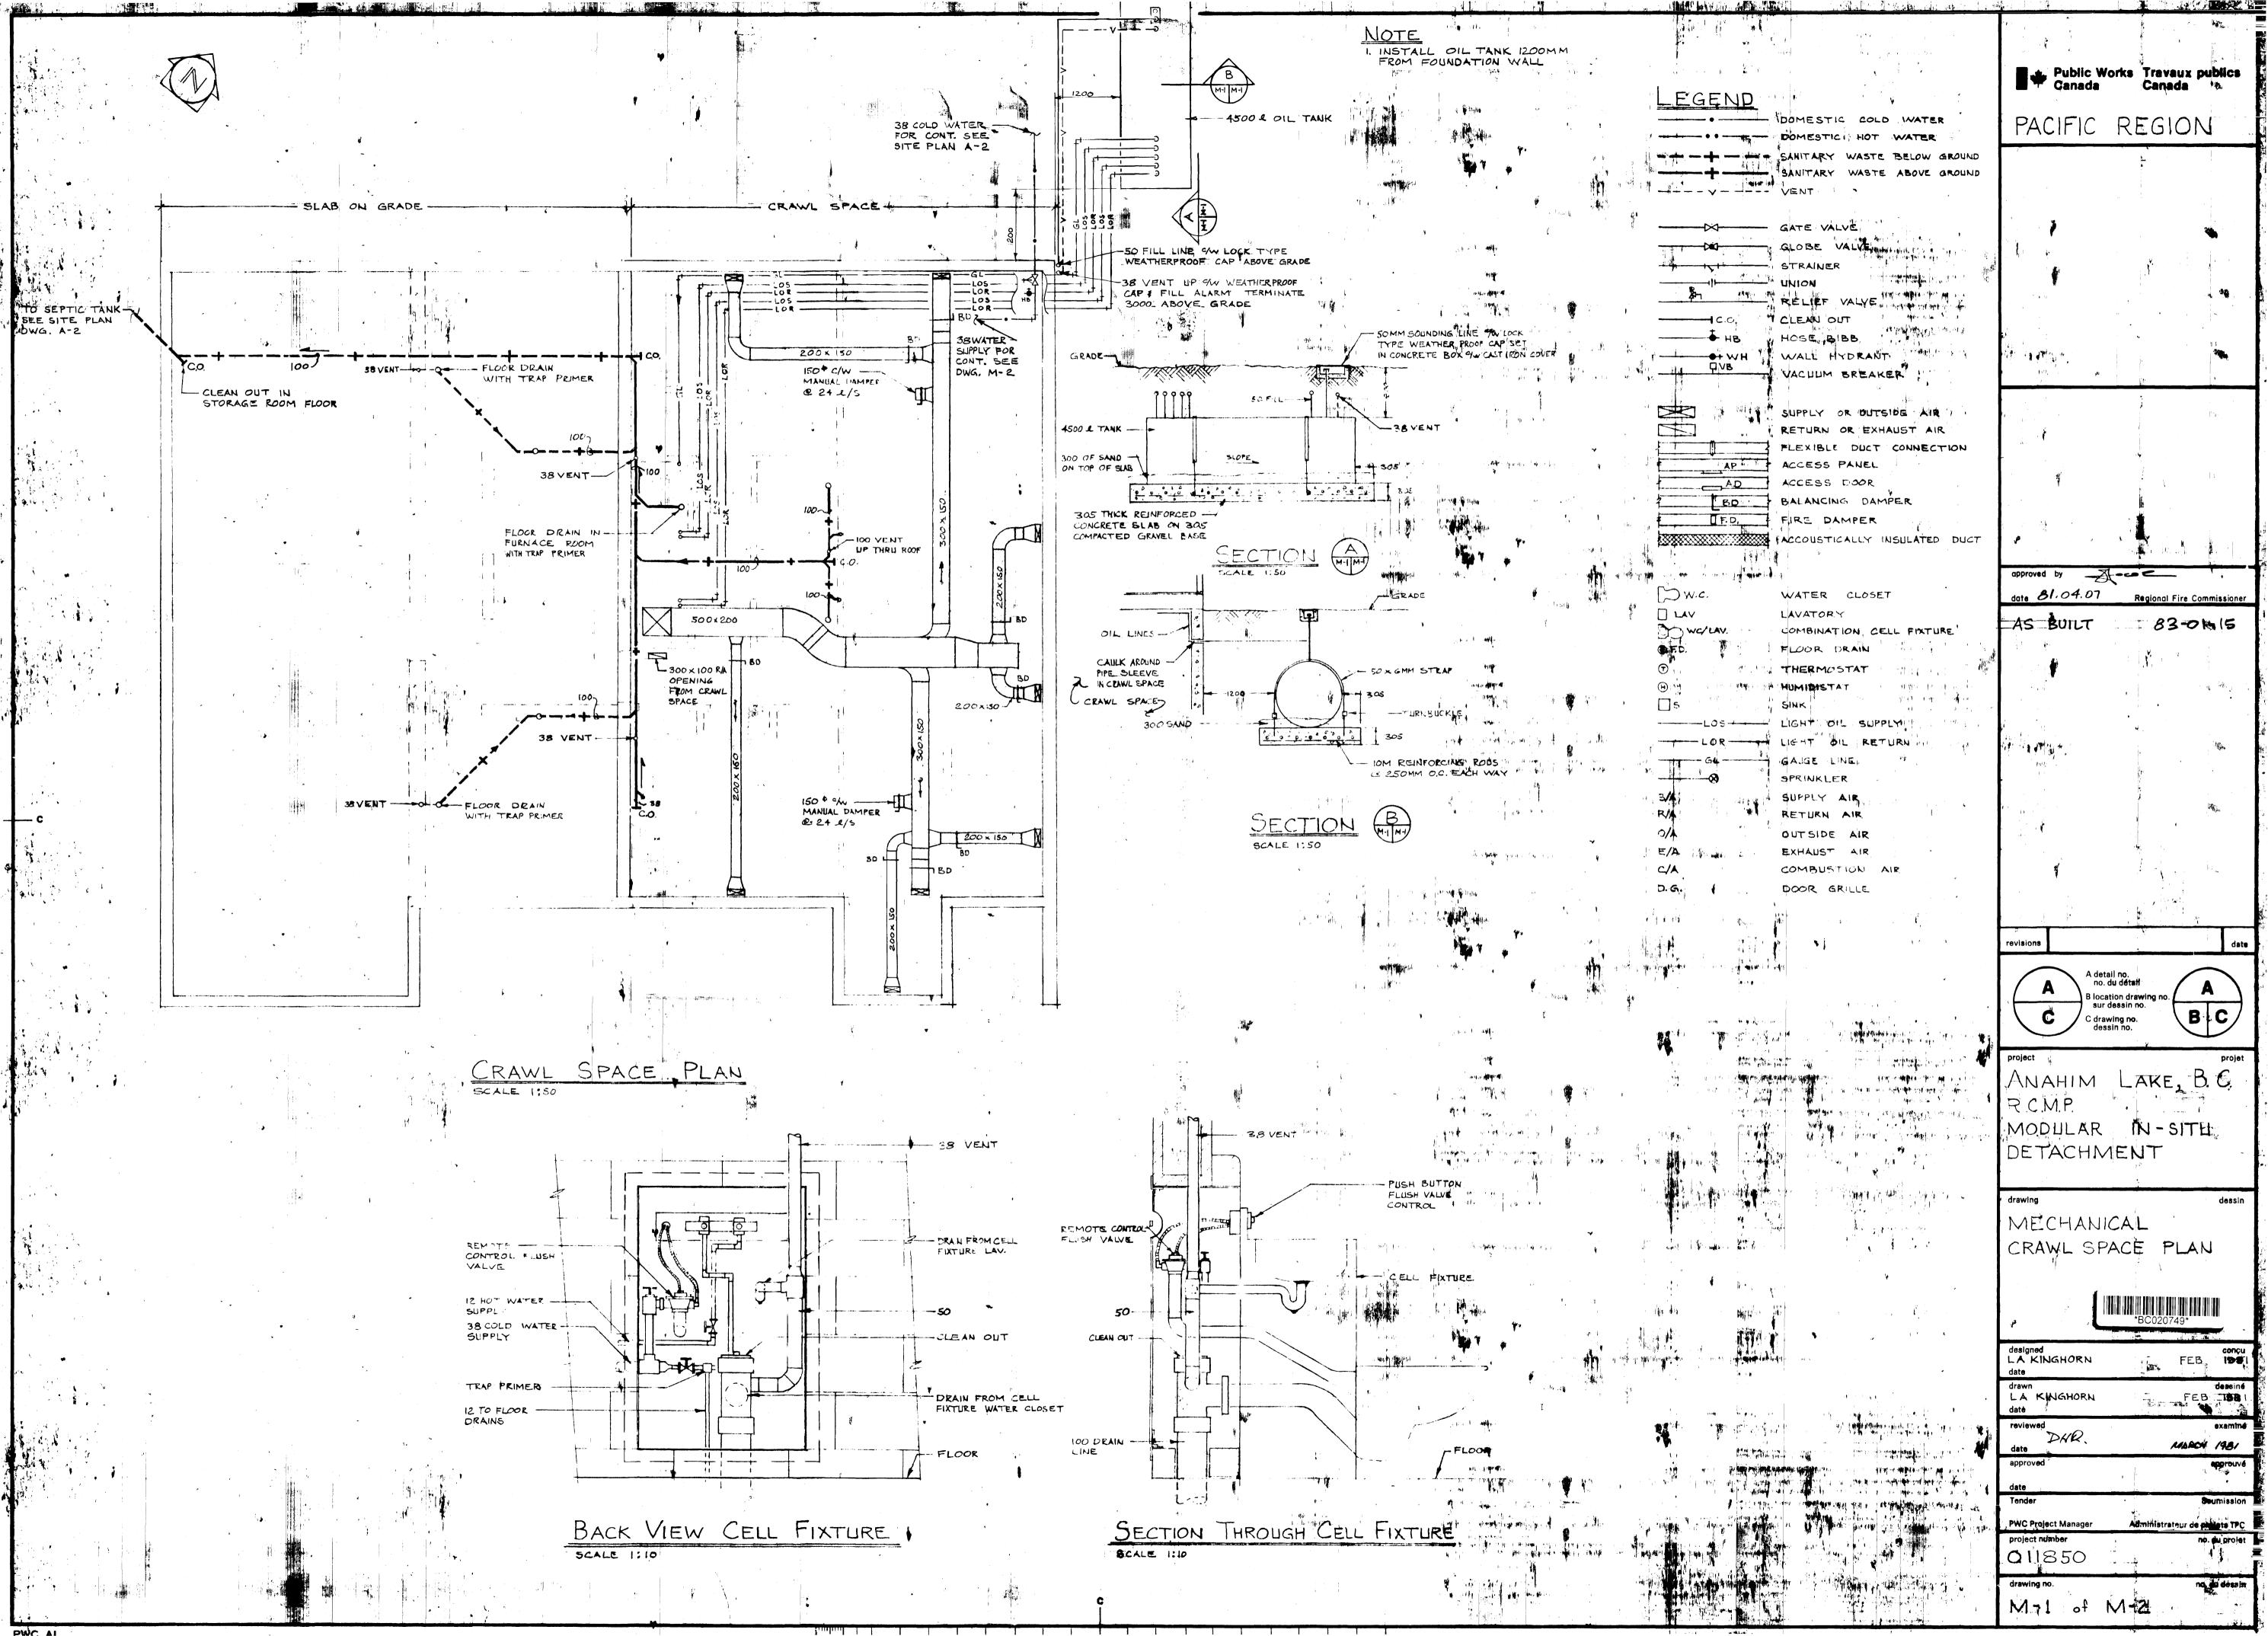

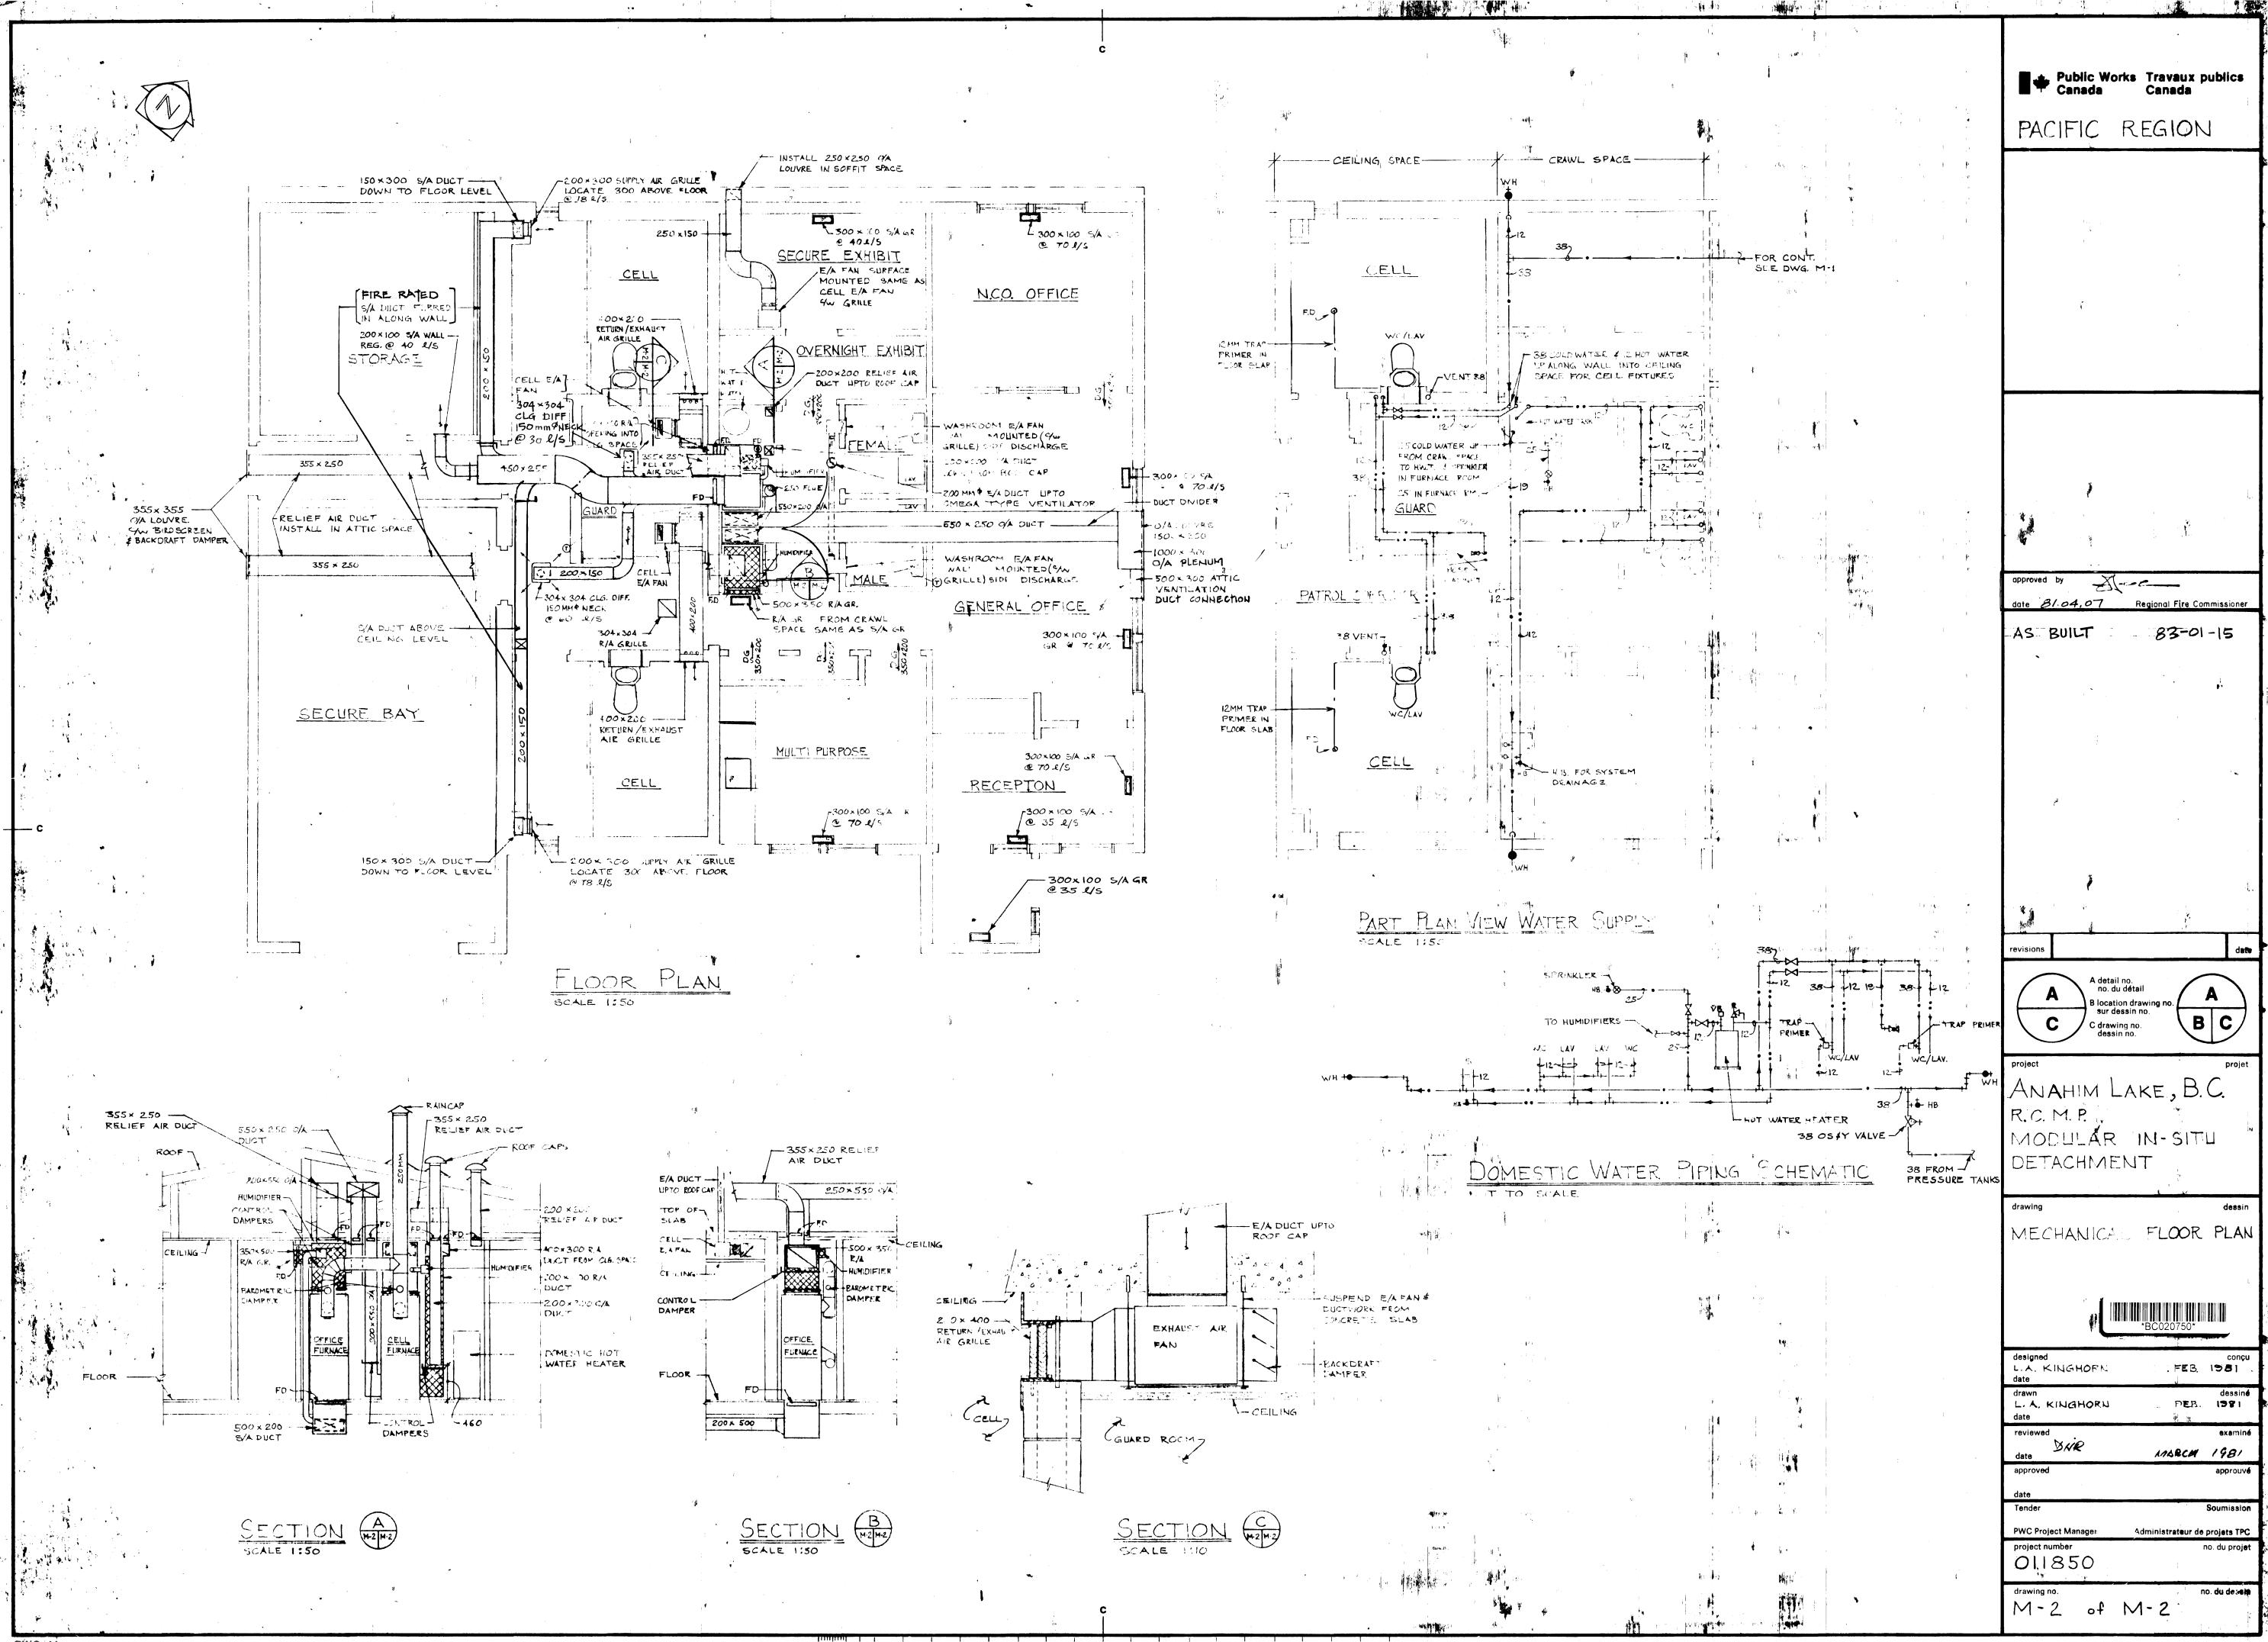

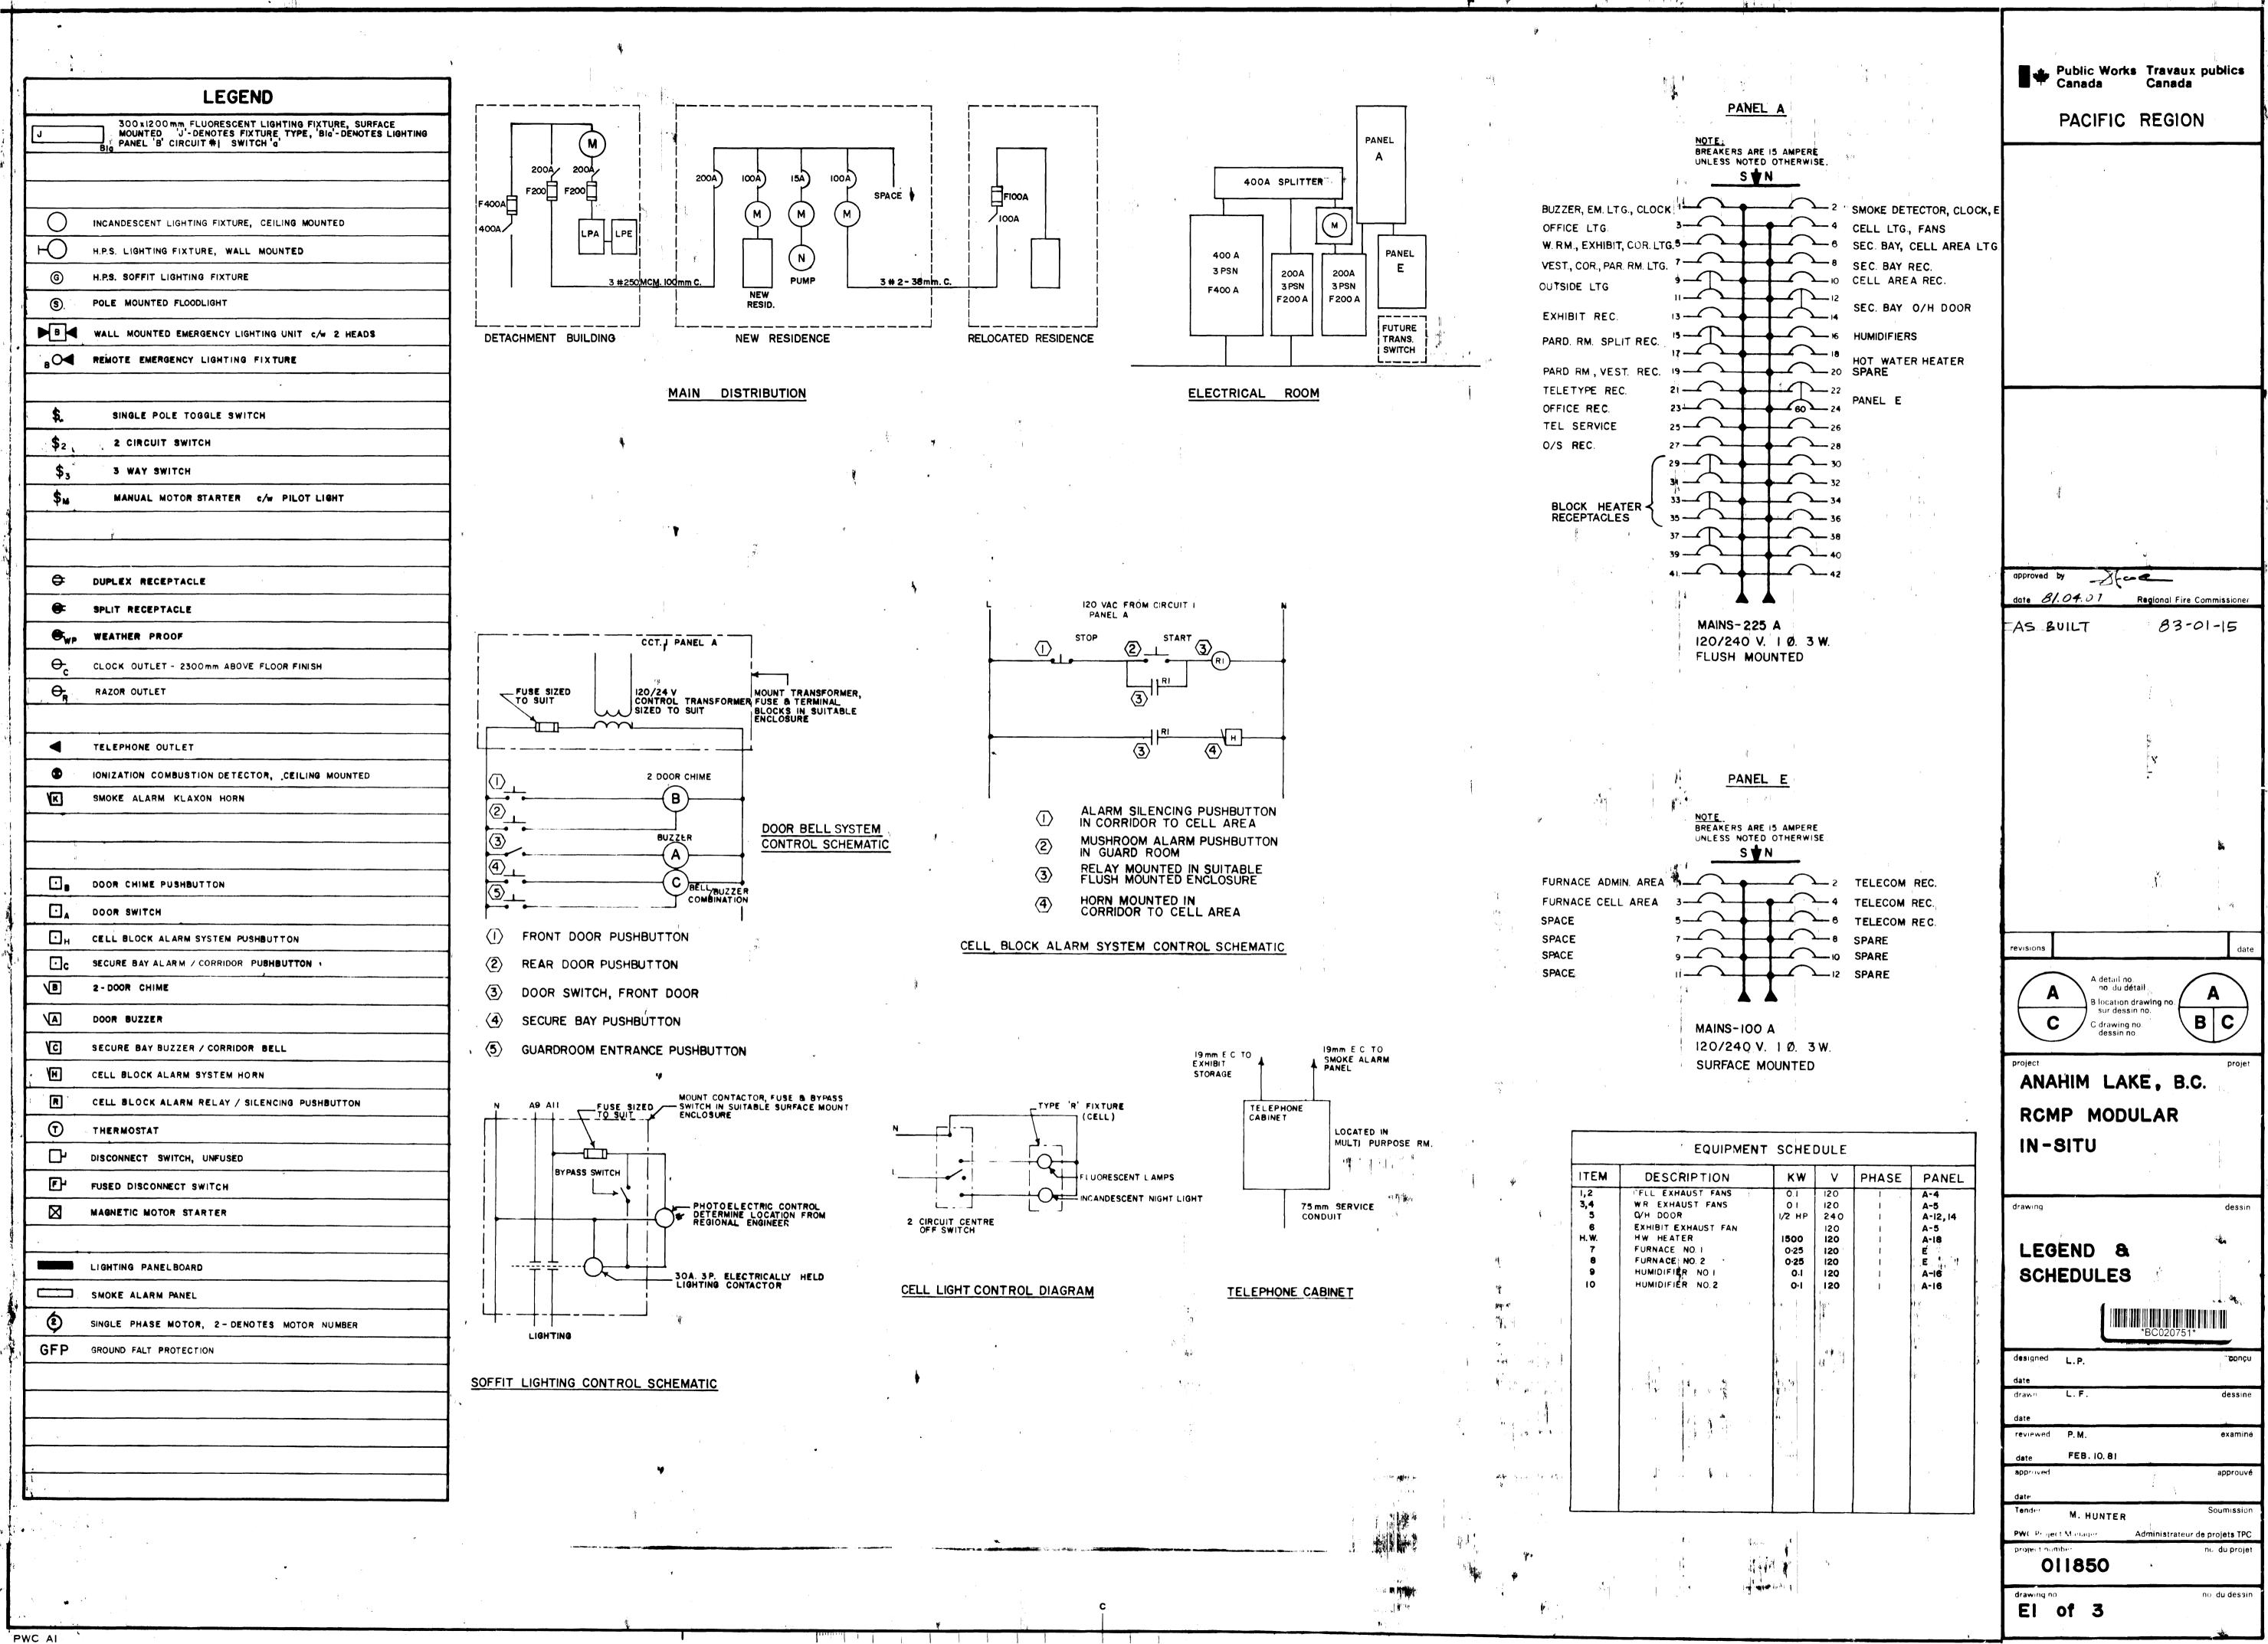

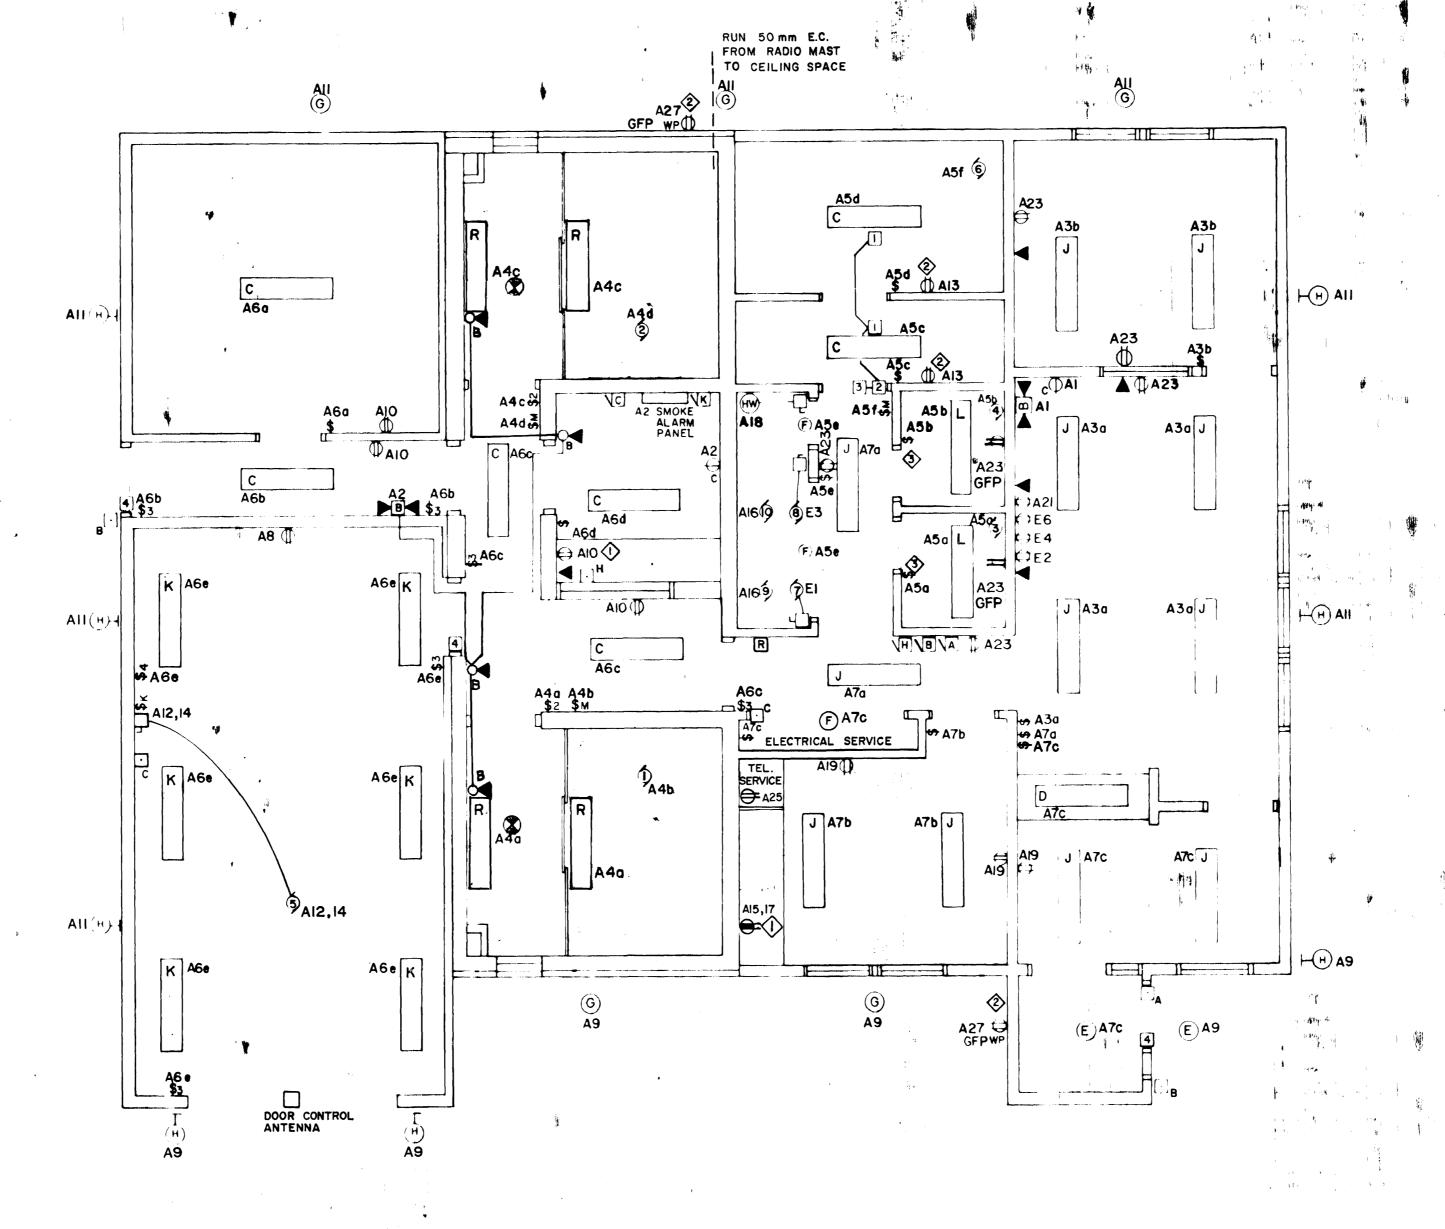

LEGEND

100mm x 100mm x 50mm PULLBOX NEAR CENTRE OF CEILING

- 100mm x 100mm x 50mm PULLBOX 50mm MAX ABOVE LEADING FDGE OF DOOR
- IOOMM x IOOMM x 50mm PULLBOX I500mm ABOVE FLOOR 50mm MAX BACK FROM FLEADING EDGE OF DOOR, RUN 125mm EC TO TELEPHONE ROOM
- PULLBOX SIMILAR TO 2 ABOVE WITH 12 5mm EC STUBBLD OUT TO CEILING SPACE OR THROUGH TO SECOND FLOOR AND CAPPED

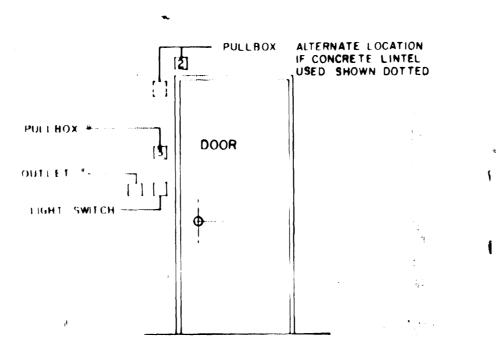


DIAGRAM OF EXHIBIT ROOM DOOR

MOUNT ABOVE COUNTER OR SPLASHBACK

- MOUNT 1800mm ABOVE FLOOR FINISH
- PROVIDE WR FANS WITH TIME-DELAY ON DE FNERGIZATION RELAY-ADJUSTABLE O-2 MIN

Public Works Travaux publics Canada Canada

PACIFIC REGION

no du détail B location drawing no sur dessin no C drawing no dessin no.

ANAHIM LAKE, B.C. RCMP MODULAR IN-SITU

FLOOR PLAN ELECTRICAL LAYOUT

Administrateur de projets TPC

no du dessin

designed L.P. drawn reviewed P.M.

FEB. 10.81 approved Tender M. HUNTER

project number 011850

PWC Project Manager

414

drawing no

E2 of 3