


EXISTING POWER, COMMUNICATION AND SYSTEMS PLAN

SCALE : 1:100

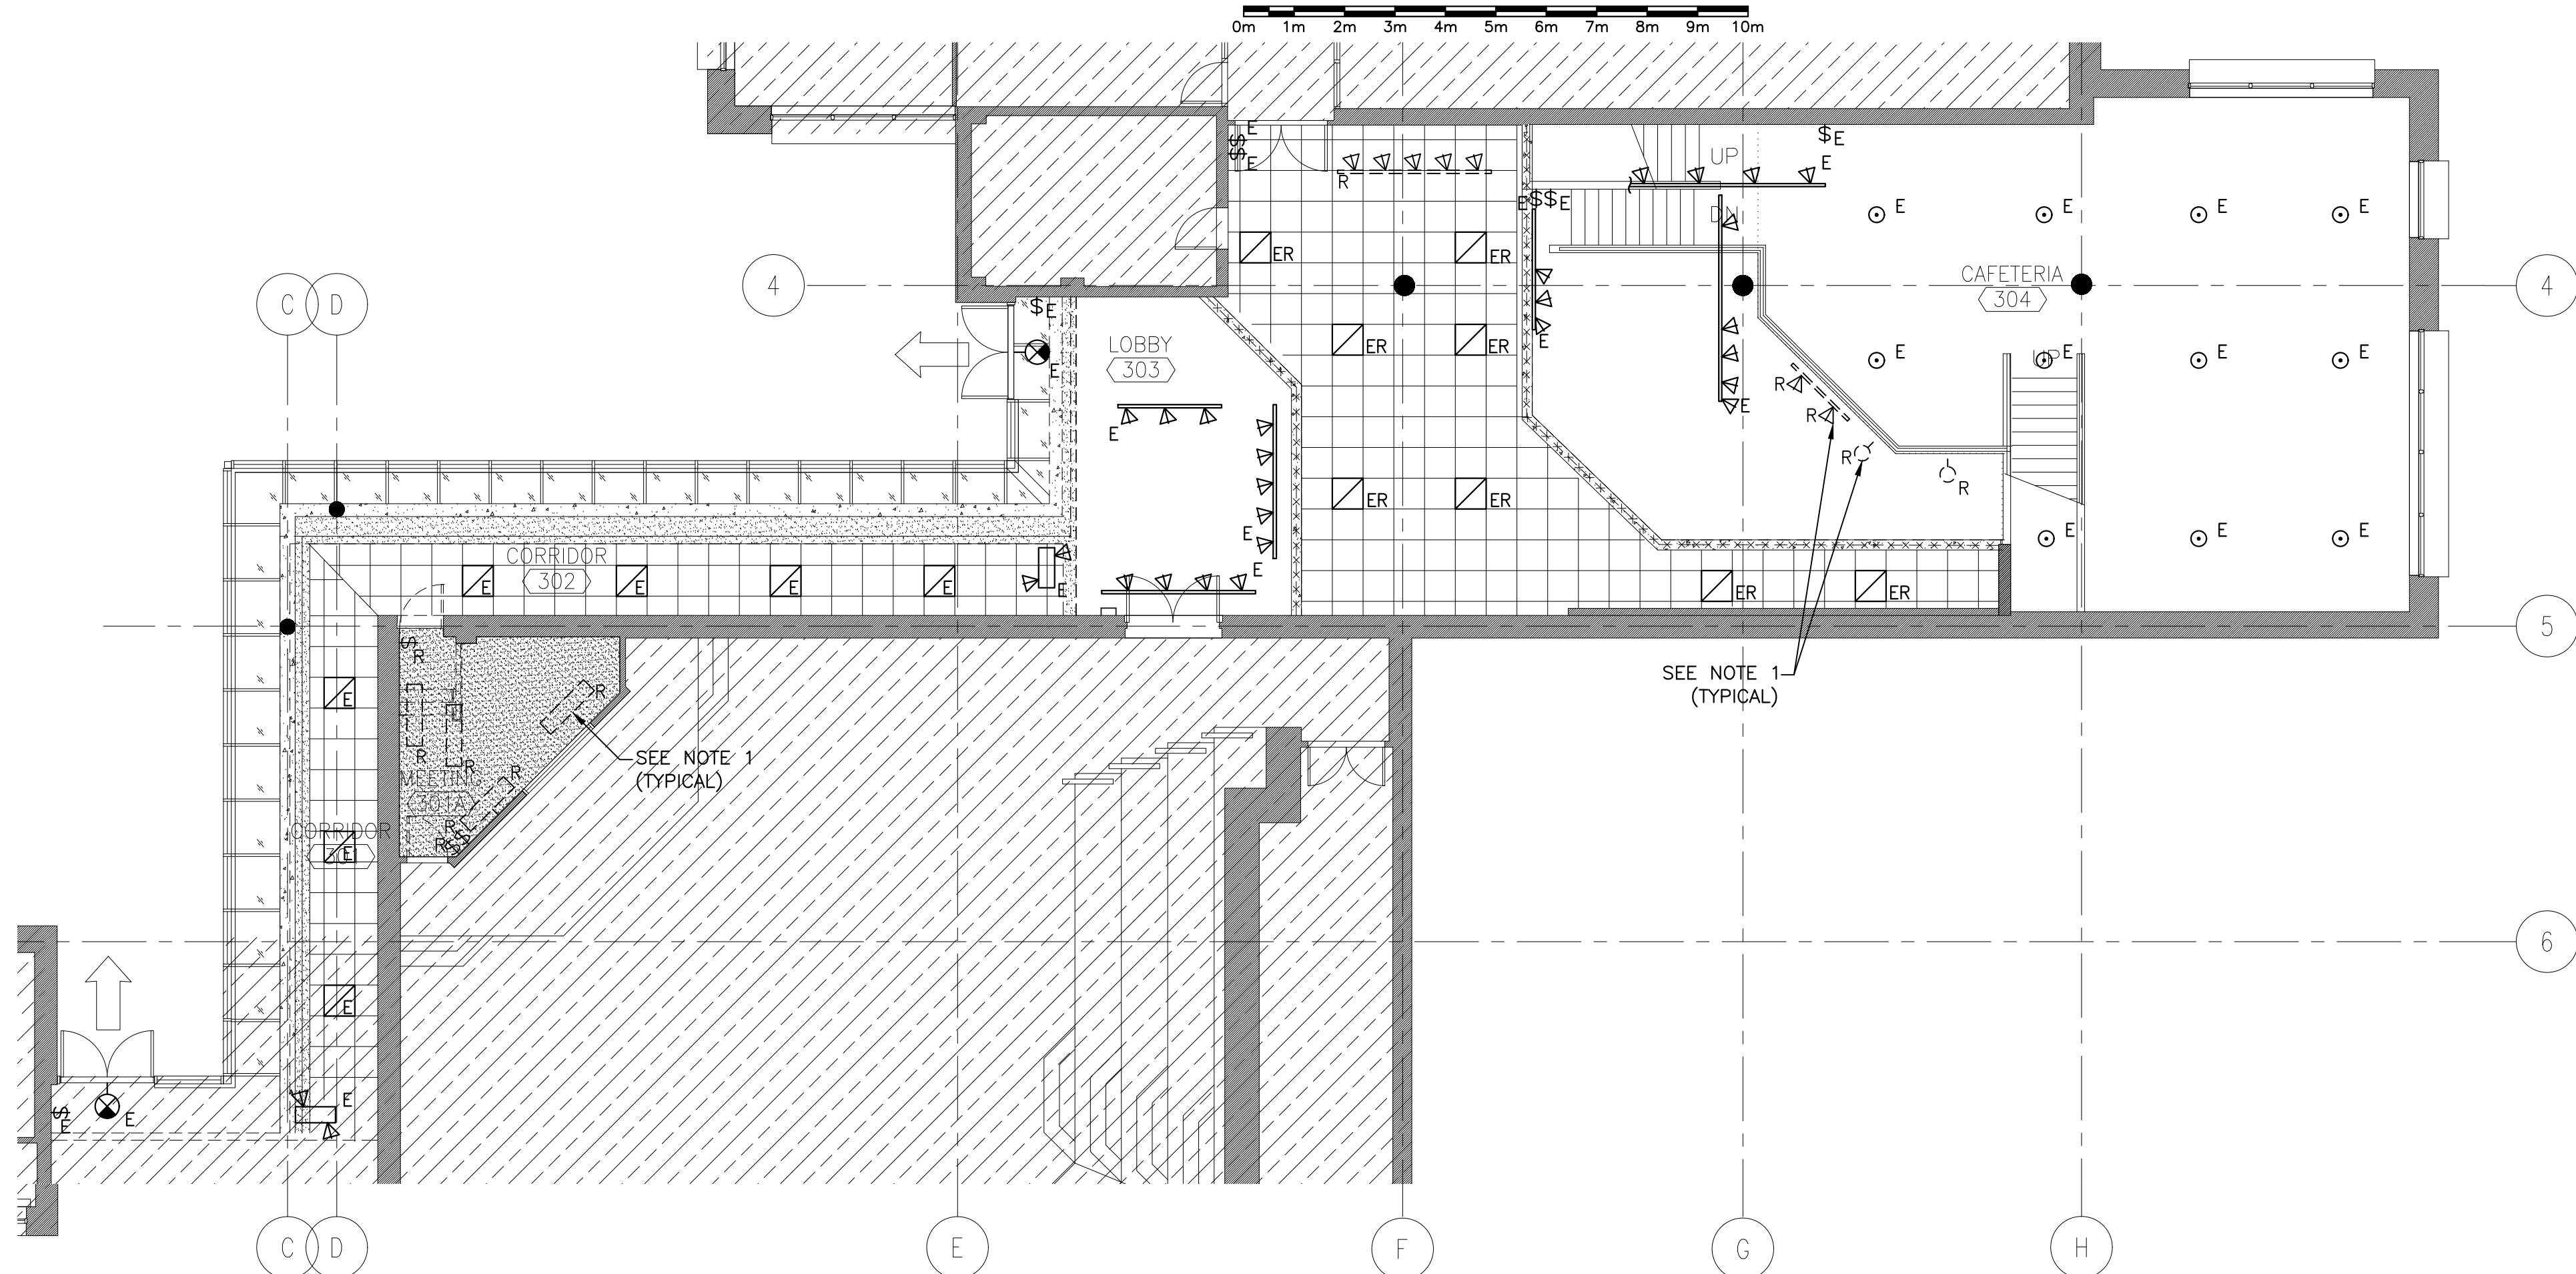

EXISTING LIGHTING PLAN

SCALE : 1:100

NOTES:

1. FOR EQUIPMENT BEING REMOVED, REMOVE ASSOCIATED CONDUCTORS, CABLES AND CONDUIT BACK TO THE SOURCE. UNLESS OTHERWISE NOTED.
2. ALL EXISTING ELECTRICAL, COMMUNICATION AND AUDIO VISUAL OUTLETS, ASSOCIATED WIRING AND CONDUIT LOCATED IN THIS ROOM IS TO BE REMOVED. ALL EXISTING JUNCTION BOXES, PULL BOXES, ETC. FEEDING EQUIPMENT IN OTHER ROOMS ARE TO BE RELOCATED AND/OR RE-ROUTED AS REQUIRED TO SUIT RENOVATION. EXTEND AND/OR TRIM WIRING AS REQUIRED. CO-ORDINATE NEW LOCATIONS ON SITE WITH DEPARTMENT REPRESENTATIVE.
3. RE-USE EXISTING CIRCUITRY TO FEED NEW RECEPTACLE.

GENERAL DEMOLITION NOTES:

- A. FOR AREA SHOWN TO BE DEMOLISHED CONTRACTOR IS TO VERIFY ANY/ALL EXISTING ELECTRICAL INFRASTRUCTURE TO BE REMOVED OR RELOCATED TO FACILITATE CONSTRUCTION. EXTEND/TRIM CONDUIT AND WIRE OF ANY CONDUIT RUNS PASSING THROUGH WALL TO BE DEMOLISHED AS REQUIRED TO FACILITATE DEMOLITION AND CONSTRUCTION.
- B. REFER TO ARCHITECTURAL, MECHANICAL AND ELECTRICAL DRAWINGS AND SPECIFICATIONS FOR EXTENT OF WORK AND COORDINATE WITH OTHER TRADES PRIOR TO COMMENCEMENT OF ANY WORK.
- C. DURING CONSTRUCTION, REMOVE AND CAREFULLY STORE ALL EXISTING FIXTURES, EQUIPMENT, ETC. TO REMAIN OR BE RELOCATED, AND RE-INSTALL AFTER CONSTRUCTION HAS BEEN COMPLETED.
- D. ANY BREAKERS NO LONGER REQUIRED AS A RESULT OF THIS WORK ARE TO BE RE-LABELED AS 'SPARE'.
- E. RE-SUPPORT EXISTING CONDUITS AS REQUIRED.
- F. CONTRACTOR SHALL PROVIDE TEMPORARY SUPPORT FOR ALL EXISTING DEVICES AS REQUIRED DURING CONSTRUCTION. IF DISCONNECTION OF EXISTING DEVICES IS NECESSARY, CONTRACTOR SHALL RE-INSTATE SAME TO THE REQUIREMENTS OF THE SPECIFICATION.
- G. EXTEND/TRIM CONDUCTORS AS REQUIRED TO SUIT NEW EQUIPMENT RELOCATION AND REMOVAL.
- H. CONTRACTOR MUST VERIFY EXTENT OF WORK AS WELL AS ALL DIMENSIONS AND CONDITIONS ON SITE BEFORE PROCEEDING WITH ANY PORTION OF THIS WORK. DO NOT SCALE FROM DRAWINGS.
- I. CONTRACTOR TO PROVIDE BLANK COVER PLATES FOR EXISTING JUNCTION BOXES AS REQUIRED.

 AREA NOT IN CONTRACT

2	ISSUED FOR TENDER	12/12/2019
1	ISSUED FOR 99% REVIEW	11/15/2019
0	ISSUED FOR 50% REVIEW	09/06/2019
revisions		date

project
**GC CO-WORKING SITE,
PILOT PROGRAM AT
BIO FACILITY
1 CHALLENGER DRIVE,
DARTMOUTH, NS**

drawing
**ELETRICAL
EXISTING POWER,
COMMUNICATIONS,
SYSTEMS AND LIGHTING
PLANS**

designed	TC	conçu
date	SEPT. 2019	
drawn	SDC	dessiné
date	SEPT. 2019	
approved	JAS	approuvé
date	DEC.2019	
Tender		Soumission
PWGSC Project Manager	Administrateur de projets TPSCG	
project number		no. du projet
	R.101402.002	
drawing no.		no. du dessin
	E-101	

