REAL PROPERTY SERVICES Pacific Region


Date/Date

2019-09-13

Drawn by/Dessine par

MAX CHENG

SERVICES IMMOBILIERS Région de Pacifique

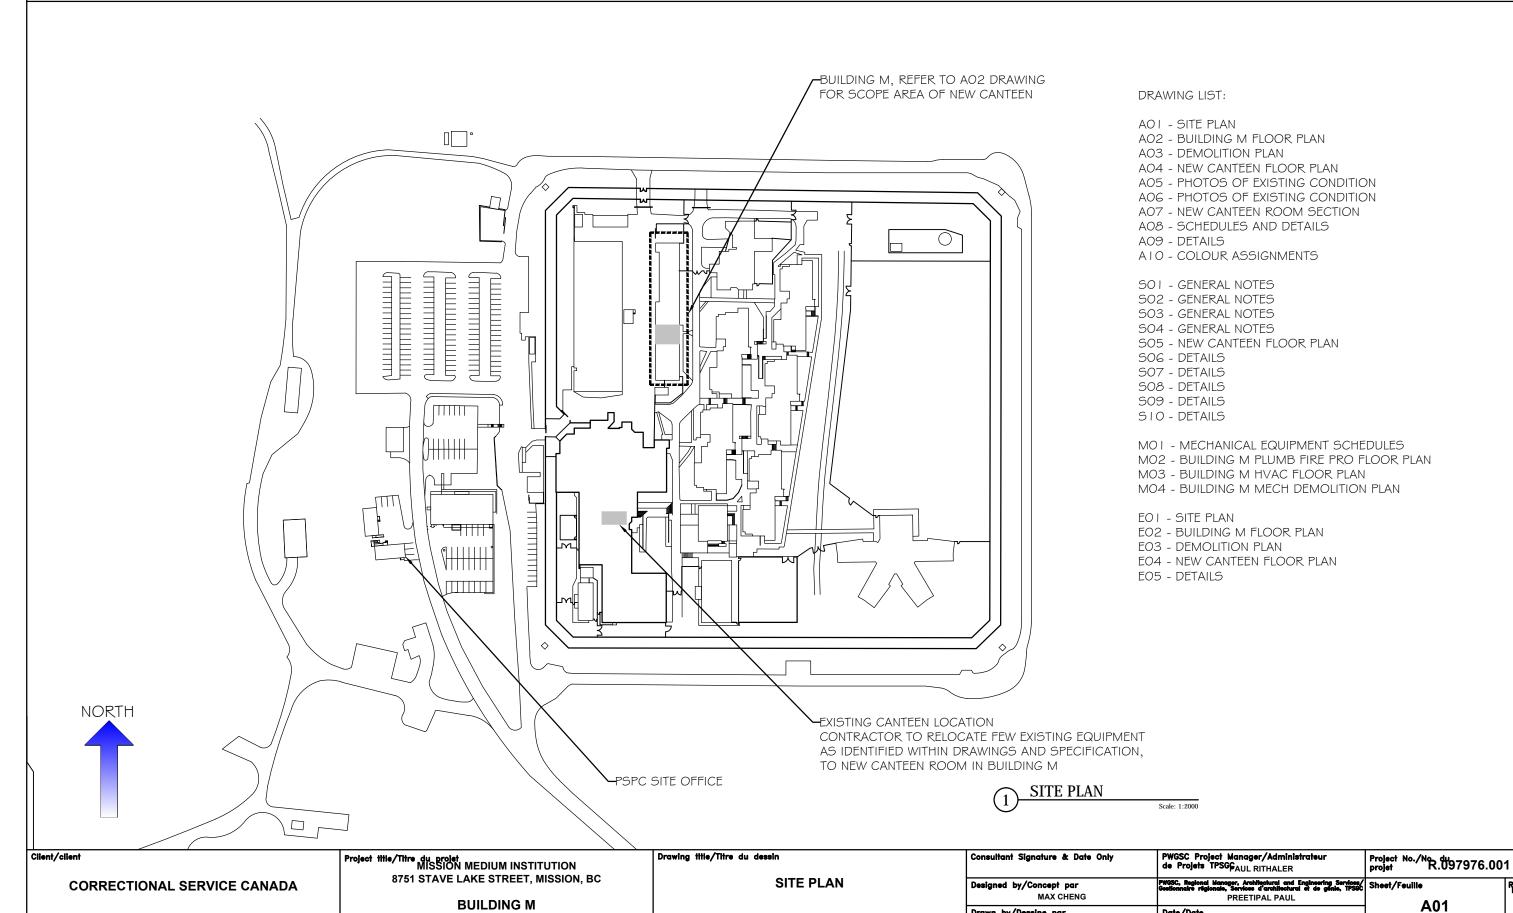

CANTEEN RELOCATION

OF

Revision/

0

Public Works and

Canada

Government Services

Canada

REAL PROPERTY SERVICES
Pacific Region

SERVICES IMMOBILIERS Région de Pacifique

GENERAL NOTES

- I. DEMOLISH AND DISPOSE EXISTING STORAGE ROOM PARTITIONS AND ASSOCIATED BUILDING COMPONENTS AS IDENTIFIED WITH DASHED LINES IN A03 DRAWING. PATCH AND MAKE GOOD FOR NEW CONSTRUCTION.
- 2. SALVAGE / DISPOSE THE DEMOLITION DEBRIS ACCORDING TO SPECIFICATION.
- 3. MOVE EQUIPMENT, MILLWORK AND FURNITURE WITHIN THE SCOPE AREA TO A DESIGNATED AREA.
- 4. EXISTING CONCRETE SLAB TO REMAIN EXCEPT NOTED OTHERWISE.
- 5. CONSTRUCT NEW CANTEEN ROOM ACCORDING TO A04 DRAWING.
- 6. SEE STRUCTURAL, ELECTRICAL, AND MECHANICAL DRAWINGS & SPECIFICATION FOR ADDITIONAL REQUIREMENTS.
- 7. REFER TO HAZMAT REPORT FOR HAZARDOUS MATERIALS DISPOSAL

PWGSC Project Manager/Administrateur de Projets TPSGF_{AUL RITHALER}

PWGSC, Regional Manager, Architectural and Engineering Services/ Gestionnaire régionale, Services d'architectural et de génie, TPSGC

PREETIPAL PAUL


2019-09-13

Consultant Signature & Date Only

MAX CHENG

Designed by/Concept par

Drawn by/Dessine par

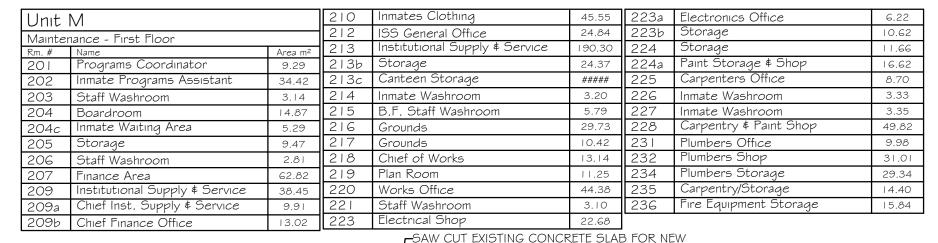


Project title/Titre du projet MISSION MEDIUM INSTITUTION

8751 STAVE LAKE STREET, MISSION, BC

BUILDING M

CANTEEN RELOCATION

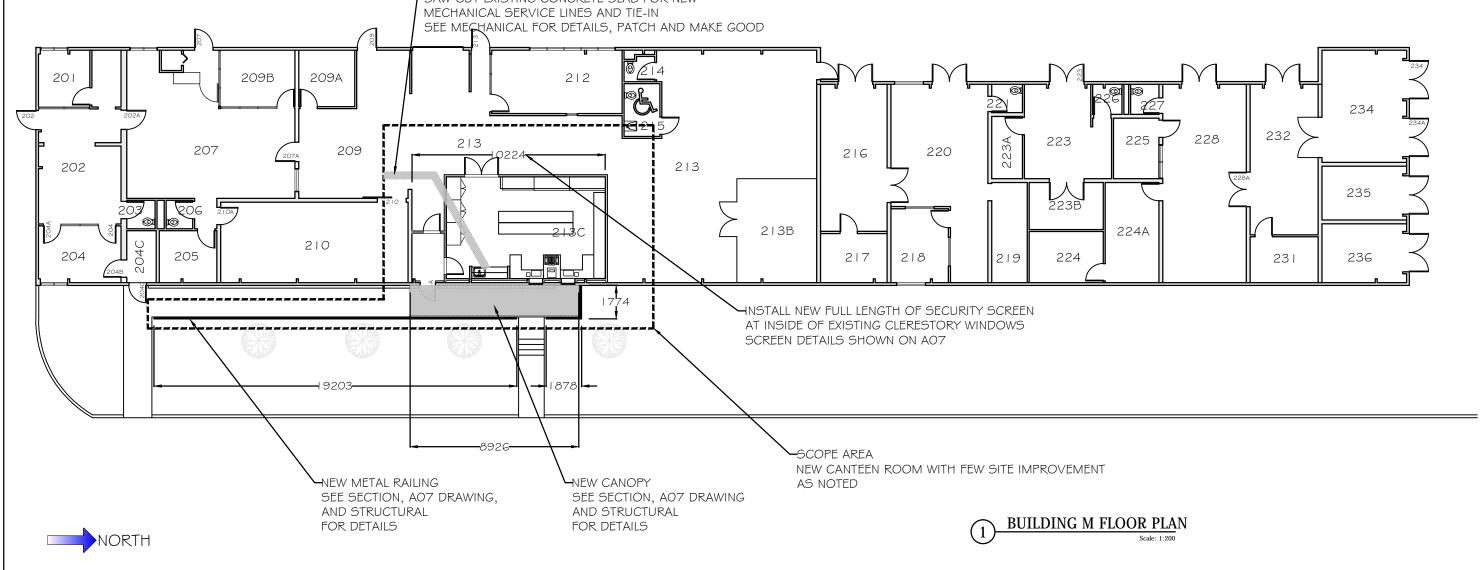

Drawing title/Titre du dessin

BUILDING M FLOOR PLAN

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Revision /

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Project No./No. du 97976.001


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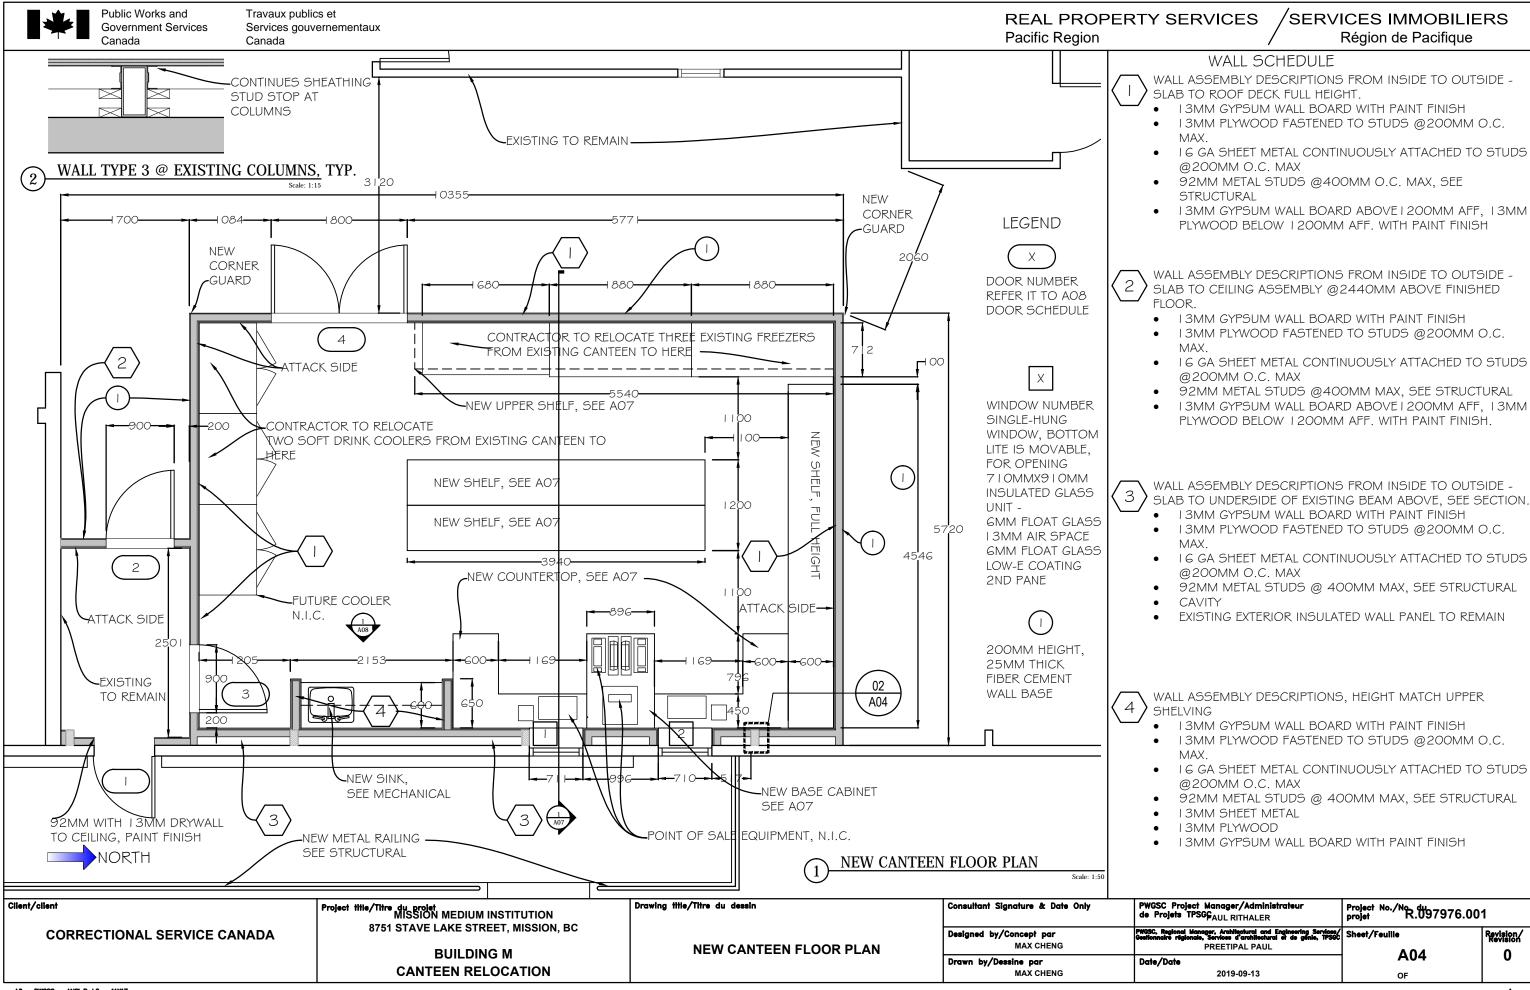
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CORRECTIONAL SERVICE CANADA

Client/client





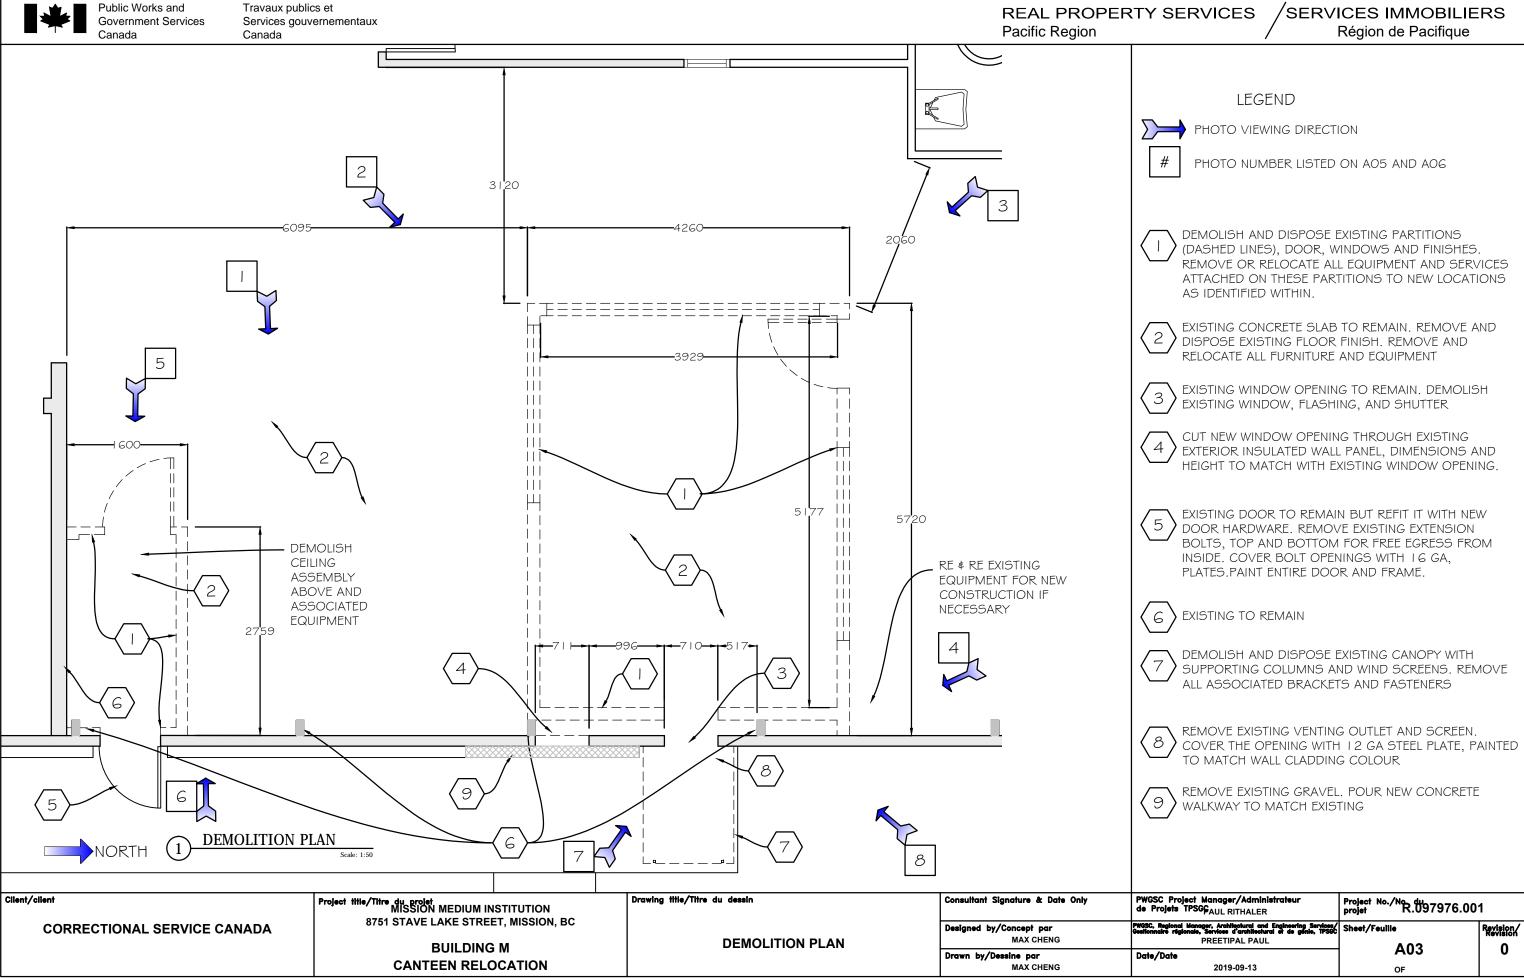

REAL PROPERTY SERVICES Pacific Region

SERVICES IMMOBILIERS Région de Pacifique

LEGEND

DEMOLISH AND DISPOSE DEBRIS ACCORDING TO SPECIFICATION

EXISTING TO REMAIN

REMOVE AND RE-INSTALL EXISTING SERVICES TO NEW LOCATION PER ELECTRICAL OR MECHANICAL DRAWINGS

ADD SECURITY SCREEN, WELDED WIRE OF 6 GA. TYPICALLY 25MM X 25MM OPENINGS FOR ENTIRE EXISTING CLERESTORY WITHIN THE NEW CANTEEN.

MOVE EXISTING FURNITURE AND EQUIPMENT TO A DESIGNATED AREA TO FACILITATE CONSTRUCTION

EXISTING CONCRETE SLAB TO REMAIN. PATCH AND MAKE GOOD

REFER TO ELECTRICAL, MECHANICAL AND STRUCTURAL DRAWINGS FOR DETAILS



Scale: N.T.S.

PHOTO OF EXISTING CONDITION

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Project title/Titre du projet MISSION MEDIUM INSTITUTION 8751 STAVE LAKE STREET, MISSION, BC

> **BUILDING M CANTEEN RELOCATION**

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PHOTO OF EXISTING CONDITION

Drawing title/Titre du dessin

PHOTOS OF EXISTING CONDITION

PWGSC Project Manager/Administrateur de Projets TPSGF_{AUL RITHALER} Consultant Signature & Date Only Project No./No. du 97976.001 WGSC, Regional Manager, Architectural and Engineering Services/ estionnaire régionale, Services d'architectural et de génie, TPSGC Sheet/Feuille Designed by/Concept par Revision/ MAX CHENG PREETIPAL PAUL A05 Drawn by/Dessine par MAX CHENG 2019-09-13 OF

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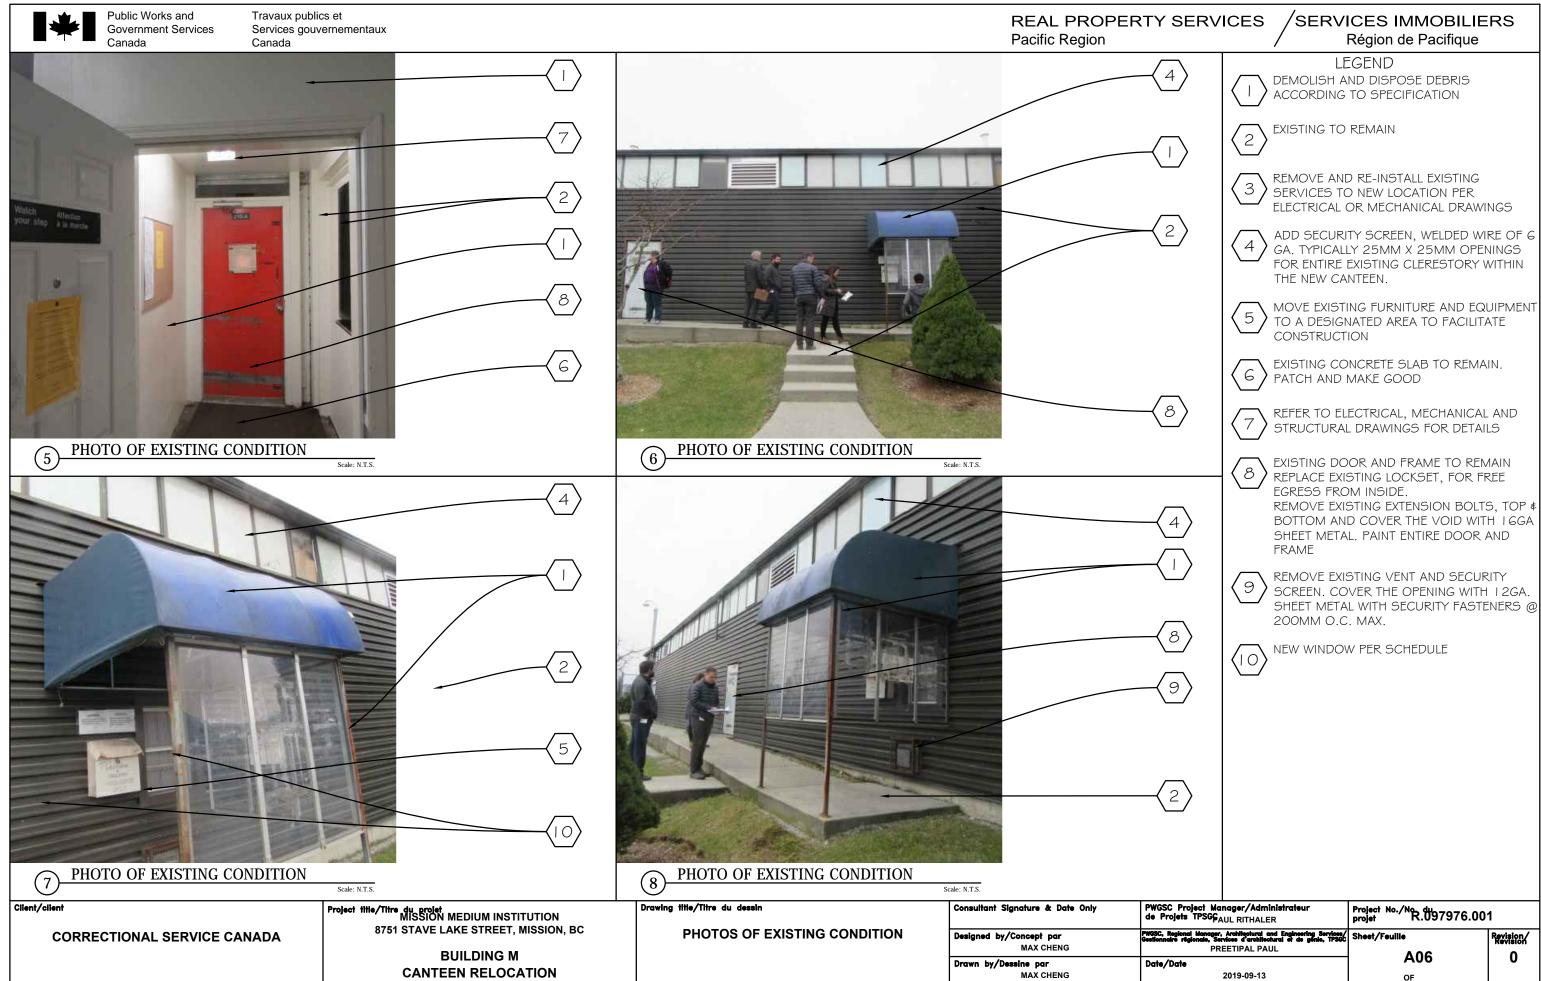
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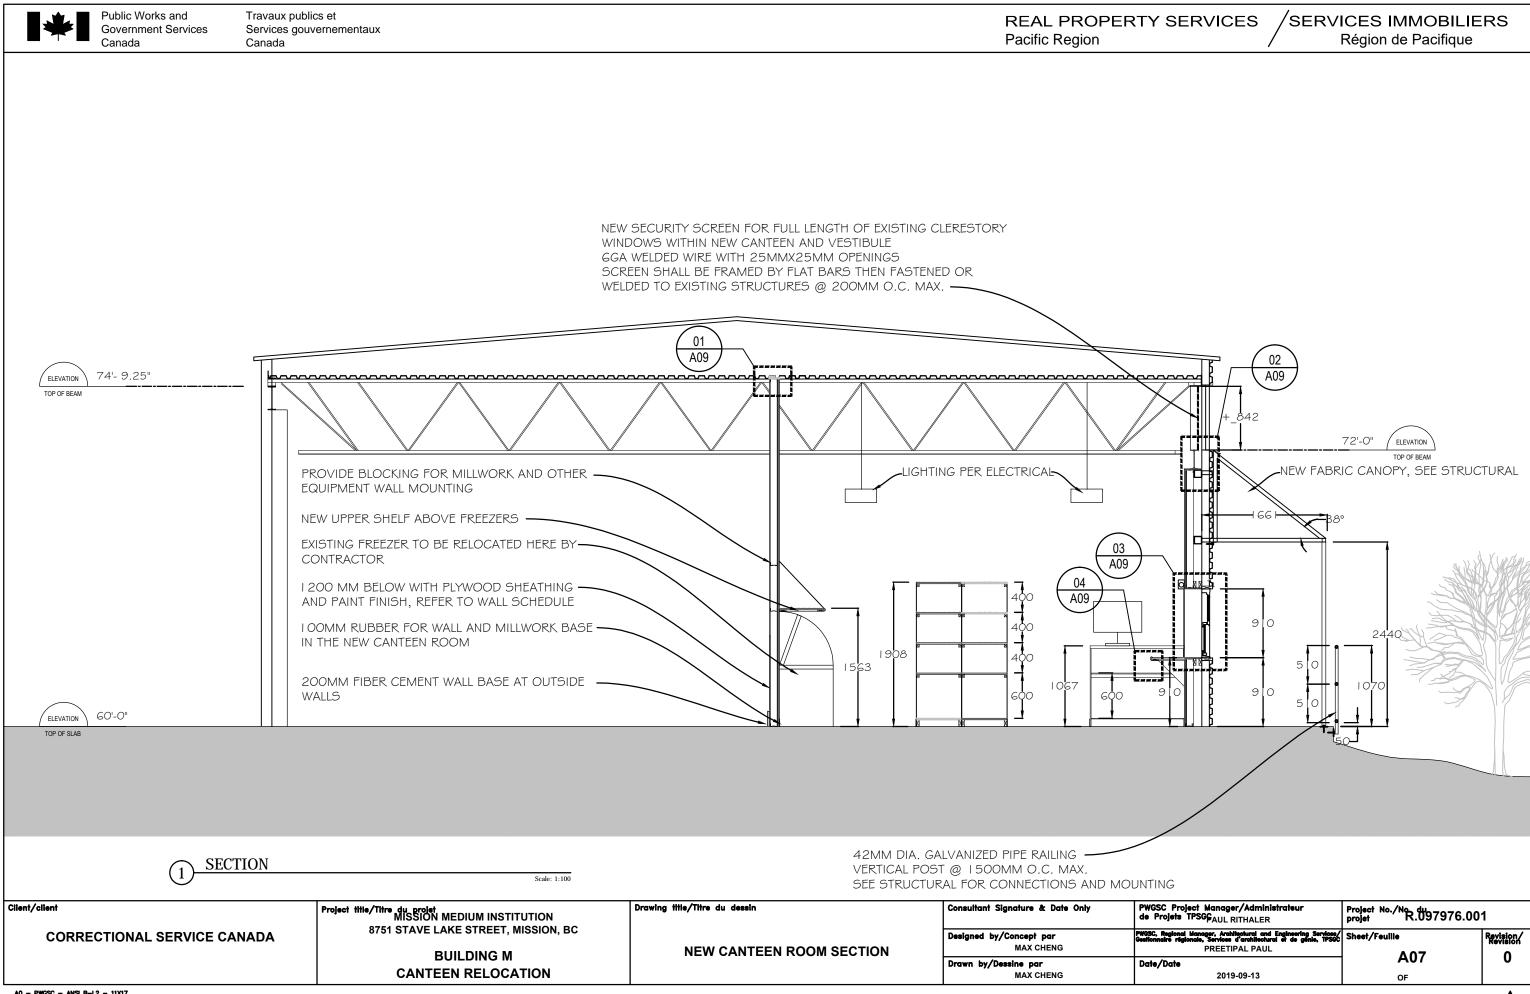
Client/client

CORRECTIONAL SERVICE CANADA

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REAL PROPERTY SERVICES
Pacific Region

SERVICES IMMOBILIERS Région de Pacifique


	DOOR AND FRAME SCHEDULE																	
No.	LEAF	LEAF DOOR SIZE				DOOR			FIRE RATING	FIRE RATING HDW SET No.		FRAME				REMARKS		
NO.	QUANTITY	WIDTH	HEIGHT	THICK.	TYPE	MATERIAL	FINISH	GLAZING	TYPE	J.	OLI III	OLI NO.	THROAT	MATERIAL	FINISH	ELEVATION	FRAME DEPTH	CLIVII (ICIO
1	SINGLE	EXIST.	EXIST.	EXIST.		EXIST.	RE-PAINTED	NONE		NONE	1	EXIST.	EXIST.	RE-PAINTED	EXIST.	EXIST.		
2	SINGLE	900	2100	45		H.M.	PAINTED	TYPE I	TYPE C	NONE	2	131	Н.М.	PAINTED		50		
3	SINGLE	900	2100	45		Н.М.	PAINTED	TYPE I	TYPE C	NONE	2	131	Н.М.	PAINTED		50		
4	PAIR	900	2100	45		H.M.	PAINTED	TYPE I	TYPE B	NONE	3	131	Н.М.	PAINTED		50		


GLAZING TYPE 1: TWO LAYERS OF GMM FLOAT GLASS HELD BY MINIMALLY A 0.78MM (30 MIL) INTERLAYER OF POLYVINYL BUTYRAL (PVB)

HARDWARE GROUP 1: MORTISE LOCKSET, CLASSROOM FUNCTION (FREE EGRESS FROM INSIDE ALWAYS)

HARDWARE GROUP 2: MORTISE LOCKSET CLASSROOM FUNCTION (FREE EGRESS FROM INSIDE ALWAYS), CLOSER, THRESHOLD, GASKETS AND DOOR STOPS

HARDWARE GROUP 3: MORTISE DEADLOCK MODEL# E068 I WITH DUMMY LEVER HANDLES ON OUTSIDE (NOT AN EGRESS DOOR), EXTENSION BOLTS BOTH LEAVES TOP AND BOTTOM, 900MM HEIGHT X FULL DOOR WIDTH KICK PLATES 18 GA. (4) TWO FOR EACH LEAF, DOOR STOPS

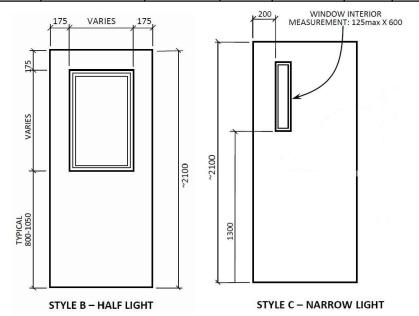

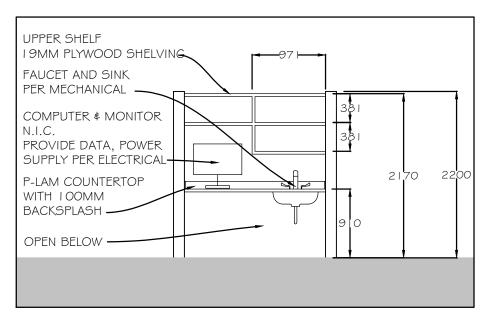


COUNTERTOP AND UPPER SHELF ELEVATION Scale: 1:50


ROOM FINISH SCHEDULE										
ROOM FLOOR			BASE	WALL		CEILING				REMARKS
No.	NAME	TLOOK	DAJL	MATERIAL	FINISH	TYPE	HEIGHT	MATERIAL	FINISH	KLIVIANN
	VESTIBULE	NEW SEALER OVER EXIST. SLAB	RUBBER	DRYWALL # EXISTING	PAINT PAINT	GYPSUM BD.		GEE NOTEG BELOW	PAINT PRE-FIN	
	NEW CANTEEN	NEW SEALER OVER EXIST. SLAB	RUBBER	DRYWALL	PAINT	EXISTING EXPOSED	EXISTING			

CEILING ASSEMBLY FROM TOP TO BOTTOM - 19MM PLYWOOD WITH NO FINISH, CEILING JOISTS (SEE STRUCTURAL), ONE LAYER OF 16 GA. SHEET METAL, ONE LAYER OF 13MM PLYWOOD AND ONE LAYER OF 16MM GYPSUM CEILING BOARD WITH PAINT FINISH. (SHEET METAL AND PLYWOOD SHALL BE MOUNTED DIRECTLY TO CEILING JOISTS AT 200 O.C. MAX.

Client/client	Project title/Titre du projet MISSION MEDIUM INSTITUTION	Drawing title/Titre du dessin	Consultant Signature & Date Only	PWGSC Project Manager/Administrateur de Projets TPSGFAUL RITHALER	Project No./No. R. du 97976.001	
CORRECTIONAL SERVICE CANADA	8751 STAVE LAKE STREET, MISSION, BC BUILDING M	SCHEDULES AND DETAILS	Designed by/Concept par MAX CHENG	PWGSC, Regional Manager, Architectural and Engineering Services/ Gestionnaire régionale, Services d'architectural et de génie, TPSGC PREETIPAL PAUL	Sheet/Feuille A08	Revision / Revision
	CANTEEN RELOCATION		Drawn by/Dessine par MAX CHENG	Date/Date 2019-09-13	OF	"



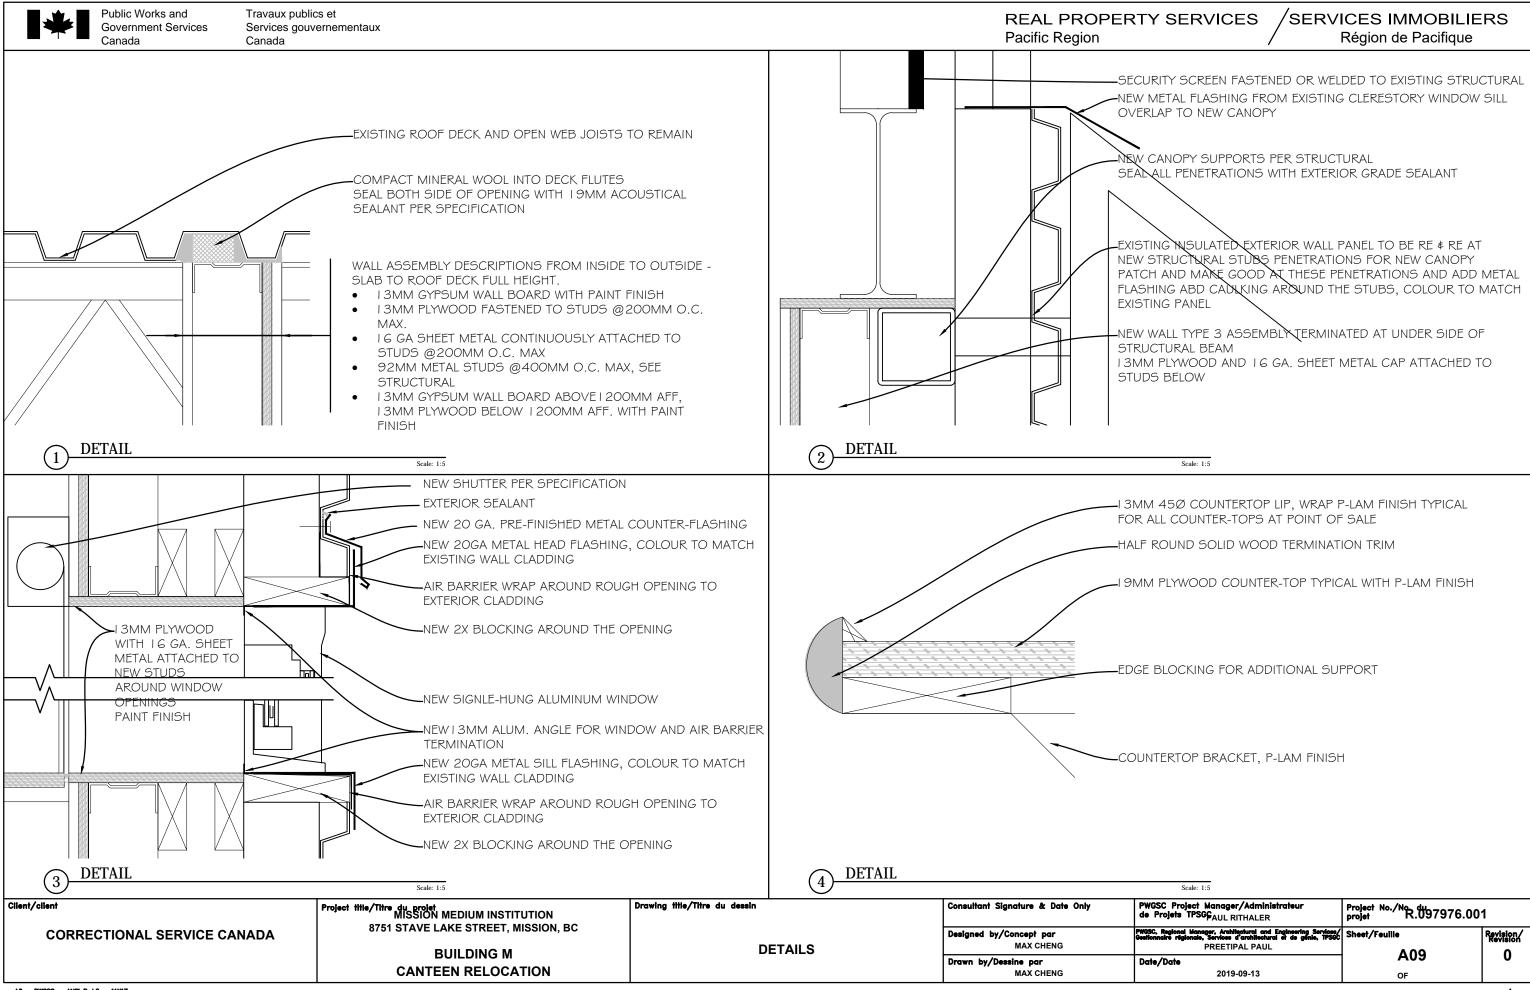

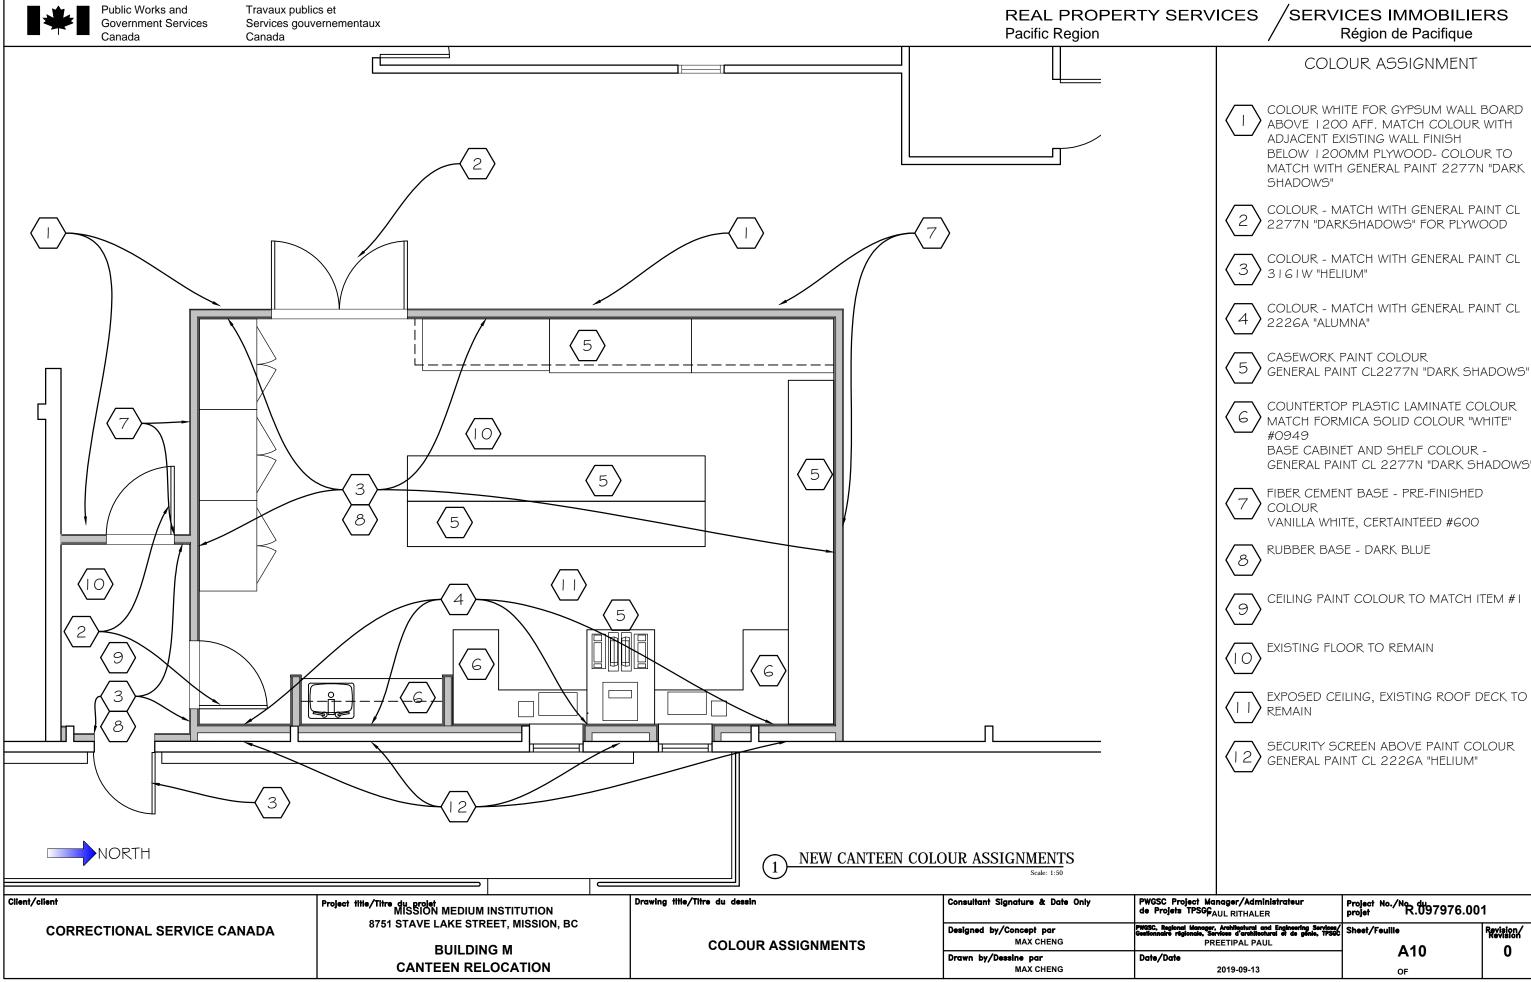

REAL PROPERTY SERVICES Pacific Region

SERVICES IMMOBILIERS Région de Pacifique

GENERAL

- THIS IS A METRIC PROJECT, UNLESS OTHERWISE NOTED, ALL DIMENSIONS ARE IN MILLIMETERS.
- ALL REFERENCED STANDARDS SHALL BE THE CURRENT EDITION OF THE EDITION REFERENCED BY THE APPLICABLE BUILDING CODE IN FORCE AT THE TIME OF BUILDING PERMIT APPLICATION.
- PRIOR TO CONSTRUCTION, REVIEW STRUCTURAL DRAWINGS IN CONJUNCTION WITH DRAWINGS PROVIDED BY ALL OTHER CONSULTANTS. AND WITH EXISTING CONDITIONS.
- REPORT DISCREPANCIES TO THE DEPARTMENTAL REPRESENTATIVE BEFORE PROCEEDING WITH THE WORK.
- DO NOT USE INFORMATION ON THESE DRAWINGS FOR ANY OTHER PROJECT OR WORKS.
- DO NOT SCALE THESE DRAWINGS.
- ALL SECTIONS, DETAILS, AND STATEMENTS NOTED AS "TYPICAL" APPLY TO LIKE/SIMILAR CONDITIONS IN THE STRUCTURE.
- SEE ARCHITECTURAL DRAWINGS FOR FIRE RATING AND FIREPROOFING REQUIREMENTS.
- STRUCTURAL DESIGN ASSUMES NON-LOAD RESTRICTED ULC FIRE RATED ASSEMBLIES, AND APPROPRIATE MATERIALS MUST BE USED.
- 10. DRAWINGS SHOW COMPLETED STRUCTURE ONLY. THEY DO NOT SHOW TEMPORARY WORKS FOR WHICH THE CONTRACTOR IS RESPONSIBLE AND WHICH MAY BE REQUIRED FOR EXECUTION OF THE PROJECT. THE CONTRACTOR TO ESTABLISH CONSTRUCTION PROCEDURE AND SEQUENCE TO ENSURE SAFETY OF THE WHOLE STRUCTURE AND ALL ITS COMPONENTS DURING ERECTION.
- DESIGN OF NON STRUCTURAL AND SECONDARY STRUCTURAL ELEMENTS (SUCH AS MISCELLANEOUS STEEL STAIRS, CLADDING, BULKHEADS, ETC.) IS THE RESPONSIBILTY OF SPECIALTY PROFESIONAL ENGINEERS ENGAGED BY THE CONTRACTOR OR THE SUPLIERS; IT IS NOT WITHIN THE SCOPE OF SERVICES PROVIDED BY THE DEPARTMENTAL REPRESENTATIVE AND WILL NOT BE REVIEWED BY THE DEPARTMENTAL REPRESENTATIVE.

DESIGN CRITERIA

STRUCTURAL DESIGN IS IN ACCORDANCE WITH THE 2015 NATIONAL BUILDING CODE (NBC), SUPPLEMENTED BY THE 2015 NATIONAL BUILDING CODE OF CANADA STRUCTURAL COMMENTARY.

- ALL REFERENCED STANDARDS SHALL BE THE CURRENT EDITION OF THE EDITION REFERENCED BY THE APPLICABLE BUILDING CODE IN FORCE AT THE TIME OF BUILDING PERMIT APPLICATION.
- 3. THE VALUES FOR CLIMATIC DATA USED IN THE DETERMINATION OF DESIGN LOADS HAVE BEEN OBTAINED FROM THE 2015 NBC FOR THE SPECIFIC LOCATION OF MISSION, BC.
- BASED ON THE USE AND OCCUPANCY. THE BUILDING IS DESIGNED TO THE REQUIREMENTS OF A NORMAL IMPORTANCE CATEGORY.
- SELF WEIGHT (SWT) IS DUE TO THE WEIGHT OF THE STRUCTURE ITSELF. IT VARIES WITH THE STRUCTURAL SYSTEM.
- 6 SUPERIMPOSED DEAD LOADS (SDL) ARE NON-STRUCTURAL DEAD LOADS DUE TO NON-STRUCTURAL TOPPINGS, FINISHES, PARTITIONS, ROOFING MATERIALS, SUSPENDED EQUIPMENT, PAVERS, SOIL, ETC.
- 7. DEAD LOAD (DL) IS THE SELF WEIGHT OF THE STRUCTURE PLUS THE SUPERIMPOSED DEAD LOAD.
- UNLESS OTHERWISE NOTED, DESIGN LOADS SHOWN ON DRAWINGS ARE SPECIFIED (UNFACTORED) LOADS, TO BE USED FOR ULS DESIGN. FOR SLS DESIGN, THESE LOADS CAN BE REDUCED BY MULTIPLYING WITH THE RATIO OF APPROPRIATE IMPORTANCE FACTORS IX(SLS) / IX(ULS) GIVEN BELOW.
- FOR CONNECTION LOADS. "+" SIGN INDICATES TENSION AND "-" SIGN INDICATES COMPRESSION, EXCEPT FOR COLUMN LOADS WHERE "+" SIGN INDICATES COMPRESSION AND "-" SIGN INDICATES TENSION.
- 10. SNOW: Ss = 2.4 kPa; Sr = 0.3 kPa; Is (ULS) = 1.0; Is (SLS) = 0.9SEE DRAWINGS FOR SNOW LOAD ACTING ON NEW CANOPY.
- 11. LATERAL LOADS IN THE EXISTING BASE STRUCTURE ARE NOT TO BE IMPACTED BY THESE WORKS.
- 12. WIND: q50 = 0.43 kPa; Iw (ULS) = 1.0; Iw (SLS) = 0.75 TERRAIN TYPE: ROUGH INTERNAL PRESSURE CATEGORY: 2
- 13. SEISMIC

Sa(0.2) = 0.644le = 1.0

leFaSa(0.2) = 0.654Sa(0.5) = 0.55

Sa(1.0) = 0.327SITE CLASSIFICATION = D (ASSUMED)

Sa(2.0) = 0.204

PGA = 0.283

OFC CATEGORIES (REFERENCE NBC2015 TABLE 4.1.8.18):

STEEL STUD PARTITION WALLS - CATEGORY 1 FREE-STANDING SHELVING UNITS - CATEGORY 21 SUSPENDED LIGHTING - CATEGORY 7

FIELD REVIEW

NOTIFY THE DEPARTMENTAL REPRESENTATIVE 48 HOURS PRIOR TO CONCRETE POURS, AND COVERING UP THE STRUCTURE WITH FINISHES.

EXISTING STRUCTURE

- EXISTING STRUCTURAL INFORMATION IS BASED UPON DRAWINGS PREPARED BY BOGUE BABICKI, DATED SEPTEMBER 16 1974, IN CONJUNCTION WITH SITE OBSERVATIONS COLLECTED BY THE DEPARTMENTAL REPRESENTATIVE JANUARY 8, 2019.
- DESIGN OF STRUCTURAL WORKS RELATED TO THE EXISTING BUILDING HAS BEEN CARRIED OUT AS FAR AS PRACTICAL, GIVEN LIMITED AVAILABILITY OF EXISTING DRAWINGS AND LIMITED RECORDS OF THE STRUCTURAL MODIFICATIONS POTENTIALLY MADE THROUGH THE LIFE OF THE BUILDING. MODIFICATIONS TO THE PROPOSED STRUCTURAL FRAMING AND / OR DETAILS MAY BE REQUIRED IF EXISTING CONDITIONS ARE FOUND TO BE DIFFERENT FROM THOSE ASSUMED AND SHOWN ON DRAWINGS.
- 3. TAKE ALL PRECAUTIONS NECESSARY TO PROTECT THE EXISTING STRUCTURE DURING CONSTRUCTION.
- REMOVE FROM SITE ALL OTHER STRUCTURAL ELEMENTS AND PRODUCTS WHICH ARE NOT INDICATED TO BE HANDED OVER TO THE DEPARTMENTAL REPRESENTATIVE.
- ALL DEMOLITION, SHORING, AND OTHER TEMPORARY WORKS TO BE DESIGNED BY A PROFESSIONAL ENGINEER RETAINED BY THE CONTRACTOR, LICENSED IN THE PLACE WHERE THE PROJECT IS LOCATED. PREPARE DRAWINGS SIGNED AND SEALED BY THAT ENGINEER SHOWING DEMOLITION PROCEDURE AND SEQUENCE AND ALL THE NECESSARY SHORING.
- UNDERTAKE CHIPPING, CUTTING, CORING, REPAIRS, PATCHING, AND REMOVAL OF DEBRIS. MAKE CUTS WITH THE PROPER SAWS AND BITS WHEN A CLEAN LINE IS REQUIRED.
- DO NOT ALTER MATERIAL PROPERTIES OF THE STRUCTURAL STEEL WHICH IS TO REMAIN BY CUTTING AND DEMOLITION PROCEDURE.
- MAKE GOOD ALL EXISTING WORK DISTURBED BY CONSTRUCTION PROCEDURES.

Client/client

CORRECTIONAL SERVICE CANADA

Project title/Titre du projet MISSION MEDIUM INSTITUTION 8751 STAVE LAKE STREET, MISSION, BC

> **BUILDING M CANTEEN RELOCATION**

Drawing title/Titre du dessin

GENERAL NOTES

Consultant	Signature	&	Date	Only		
Designed b	y/Concept	р	ar			
ASHLEY RENAUD, WSP CANADA INC						

JOHN GUERRA, WSP CANADA INC

Drawn by/Dessine par

Date/Date

PWGSC Project Manager/Administrateur de Projets TPSGC PAUL RITHALER ral and Engineering Services/ Sheet/**Feuille** hitectural et de génie, TPSGC Sheet/**Feuille**

2019-07-31

PREETIPAL PAUL

Project No./No. du projet

R.097976.001

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1

Revision/ Revision

REAL PROPERTY SERVICES
Pacific Region

SERVICES IMMOBILIERS
Région de Pacifique

CONCRETE

- 1. CONCRETE TO BE NORMAL DENSITY (MIN. 2300 kg/m3) UNLESS NOTED OTHERWISE.
- CEMENT TO BE PORTLAND CEMENT TYPE GU, UNLESS NOTED OTHERWISE OR REQUIRED BY EXPOSURE CLASS. CEMENT TO CONFORM TO CSA A3000.
- INTERIOR APPLICATIONS:
 - EXPOSURE CLASS: N
 - MINIMUM COMPRESSIVE STRENGTH AT 28 DAYS: 25 MPa.
 - NOMINAL SIZE OF COARSE AGGREGATE: 20 (3/4")
- 4. ALL OTHER EXTERIOR APPLICATIONS:
 - EXPOSURE CLASS: C1
 - MINIMUM COMPRESSIVE STRENGTH AT 28 DAYS: 35 MPa
 - NOMINAL SIZE OF COARSE AGGREGATE: 20 (3/4")
- 5. CONVEY CONCRETE FROM TRUCK TO FINAL LOCATION BY METHODS WHICH WILL PREVENT SEPARATION OR LOSS OF MATERIAL. MAXIMUM FREE FALL NOT TO EXCEED 1.5m (5'-0"). CONSOLIDATE CONCRETE USING MECHANICAL VIBRATORS.
- 6. CURE CONCRETE SURFACES NOT IN CONTACT WITH FORMS IN ACCORDANCE WITH A23.1 / A23.2, BY APPLICATION OF A CURING-SEALING COMPOUND CONFORMING TO ASTM C309 IMMEDIATELY AFTER DISAPPEARANCE OF SURFACE WATER SHEEN. ENSURE CURING-SEALING COMPOUND IS COMPATIBLE WITH APPLIED FINISHES.

CONCRETE REINFORCEMENT

- REINFORCEMENT DEFORMED BAR REINFORCEMENT CONFORMING TO CSA G30.18 GRADE 400R. USE 400W ONLY WHERE NOTED ON DRAWINGS.
- 2. ALL REINFORCING BAR SIZES ARE METRIC; "M" IS NOT NECESSARILY MARKED AFTER A BAR SIZE. FOR EXAMPLE, 10-15B NOTED ON PLAN INDICATES 10 BARS OF 15M DIAMETER. PLACED AT BOTTOM.
- 3. UNLESS OTHERWISE NOTED, LAP ALL HORIZONTAL GRADE BEAM REINFORCING WITH CLASS B LAPS.
- 4. FOR CLASS N CONCRETE, MINIMUM CONCRETE COVER TO REINFORCING BARS CLOSEST TO THE CONCRETE SURFACE TO BE 40 (1½") FOR BEAMS AND COLUMNS AND 25 (1") FOR SLABS AND WALLS.
- 5. FOR CLASS C-1 CONCRETE, MINIMUM COVER TO BE 60 (2 1/2") EXCEPT FOR SLABS PROTECTED BY MEMBRANE WHERE THE COVER SHALL BE 40 (1 1/2") TO THE TOP BARS AND 30 (1 1/4") TO THE BOTTOM BARS.
- 6. ENSURE COVER TO REINFORCEMENT IS MAINTAINED DURING CONCRETE POUR.

POST-INSTALLED ANCHORS AND DOWELS

- WHERE ADHESIVE CONCRETE ANCHORS (ACA) ARE NOTED ON DRAWINGS, PROVIDE HILTI HIT-HY200 ADHESIVE ANCHORING SYSTEM WITH HILTI HIT-Z ANCHOR RODS OR EQUIVALENT DUCTILE ANCHOR / EPOXY SYSTEM. EFFECTIVE EMBEDMENT LENGTHS AS FOLLOWS:

 12 (1/2") DIAMETER 114 (4-1/2") EMBEDMENT
 16 (5/8") DIAMETER 143 (5-5/8") EMBEDMENT
 19 (3/4") DIAMETER 171 (6-3/4") EMBEDMENT
- 2. WHERE REBAR DOWELS ARE NOTED ON DRAWINGS, PROVIDE HILTI HIT-HY 200-R ADHESIVE ANCHORING SYSTEM, OR EQUIVALENT DUCTILE EPOXY SYSTEM. SEE DRAWINGS FOR EMBEDMENT LENGTHS.
- 3. ANCHORS LOCATED OUTSIDE THE BUILDING ENVELOPE'S VAPOUR BARRIER TO BE HOT DIP GALVANIZED OR STAINLESS STEEL.
- 4. CONCRETE TO BE MINIMUM 28 DAYS OLD AT THE TIME OF ANCHOR INSTALLATION.
- 5. USE DRILLING AND INSTALLATION TOOLS AND PROCEDURES PER MANUFACTURERS' RECOMMENDATIONS.
- DO NOT CUT REINFORCEMENT TO ACCOMMODATE DRILLED ANCHORS AND DOWELS.
- 7. FOR STEEL STUD TO HOLLOW CONCRETE MASONRY CONNECTIONS, PROVIDE HILTI KWIK-CON II FASTENERS, OR EQUIVALENT DUCTILE SCREW FASTENER.

CUTTING AND CORING

- CARRY A PRICE TO RETAIN AN INDEPENDENT TESTING COMPANY TO LOCATE AND MARK EXISTING REINFORCEMENT AND CONDUIT IN THE AREAS OF PROPOSED OPENINGS USING A NON-DESTRUCTIVE METHOD. IF LOCATIONS ARE NOT ACCEPTABLE TO THE DEPARTMENTAL REPRESENTATIVE, RELOCATE PROPOSED OPENINGS AND REPEAT PROCESS AT NO EXTRA COST TO THE CONTRACT.
- 2. CORING: DO NOT CUT EXISTING REINFORCEMENT OR CONDUIT WHEN CORING EXISTING CONCRETE UNLESS APPROVED IN ADVANCE BY THE DEPARTMENTAL REPRESENTATIVE. SAVE COMPLETE LENGTH OF ALL CORES AND LABEL WITH LOCATION TAKEN. MAKE ALL CORES AVAILABLE FOR REVIEW, DO NOT DISPOSE OF CORES WITHOUT DEPARTMENTAL REPRESENTATIVE APPROVAL.

3. CUTTING: DO NOT CUT EXISTING REINFORCEMENT AND CONDUIT UNLESS APPROVED IN ADVANCE BY THE DEPARTMENTAL REPRESENTATIVE. DO NOT OVERCUT OPENINGS. CORE FOUR CORNERS AND ENDS OF INTERMEDIATE SAWCUTS OF ALL OPENINGS PRIOR TO CUTTING SIDES AND INTERMEDIATE LINES. CHIP CORNERS SQUARE AFTER SAWCUTTING IF NECESSARY. IF NEW REINFORCEMENT IS REQUIRED AT AN OPENING, INSTALL IT BEFORE CUTTING OR SHORE THE STRUCTURE UNTIL THE NEW REINFORCEMENT IS INSTALLED.

Client/client

CORRECTIONAL SERVICE CANADA

Project title/Titre du projet

MISSION MEDIUM INSTITUTION

8751 STAVE LAKE STREET, MISSION, BC

BUILDING M
CANTEEN RELOCATION

Drawing title/Titre du dessin

GENERAL NOTES

Consultant Signature & Date Only	PWGSC Project Manager/Administrateur de Projets TPSGC PAUL RITHALER
Designed by/Concept par ASHLEY RENAUD, WSP CANADA INC	PWGSC, Regional Manager, Architectural and Engineering Service Gestionnaire régionale, Services d'architectural et de génie, TPSC PREETIPAL PAUL
Drawn by/Dessine par	Date/Date

2019-07-31

JOHN GUERRA, WSP CANADA INC

Project No./No. du projet R.097976.001
Sheet/Feuille R.097976.001

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REAL PROPERTY SERVICES Pacific Region

SERVICES IMMOBILIERS Région de Pacifique


STRUCTURAL STEEL

- MATERIALS (TO CSA G40.21 UNLESS NOTED OTHERWISE):
 - ANGLES: GRADE 350W
 - HOLLOW STRUCTURAL SECTIONS (HSS): 350W CLASS "C"; OR ASTM A1085 GRADE 50 (345 MPa)
 - GALVANIZED HSS: 350W CLASS H; OTHER GRADES TO BE STRESS RELIEVED PRIOR TO GALVANIZING
 - BOLTS, NUTS AND WASHERS: ASTM F3125, GRADE A325
 - ANCHOR RODS: GRADE 300W: OR ASTM F1554 GRADE 36
 - SHOP PAINT: CISC/CPMA 1-73A
 - SHOP PRIMER PAINT: CISC/CPMA 2-75
 - ZINC-RICH PAINT (ZRP) COATING: SSPC PAINT SPECIFICATION NO. 20
 - HOT DIP GALVANIZING: ASTM A123/A123M
 - WELDING MATERIALS: CSA W48 AND CSA W59
- DO NOT SPLICE SECTIONS WITHOUT PRIOR ACCEPTANCE BY THE DEPARTMENTAL REPRESENTATIVE AND SUBMISSION OF PERTINENT SHOP DRAWINGS, ACCEPTED SPLICES TO DEVELOP THE FULL MOMENT CAPACITY OF THE SECTION. EACH SPLICE TO BE GIVEN A NON-DESTRUCTIVE TEST BY AN INDEPENDENT INSPECTION COMPANY ACCEPTABLE TO THE DEPARTMENTAL REPRESENTATIVE. TESTING TO BE AT THE CONTRACTOR'S EXPENSE. EVALUATE RESULTS IN ACCORDANCE WITH CSA W59 AND REPORT TO THE DEPARTMENTAL REPRESENTATIVE.
- DO NOT CUT HOLES OR OTHERWISE MODIFY STRUCTURAL MEMBERS ON SITE.
- 3. PROTECT COMBUSTIBLE MATERIALS AND FINISHES DURING WELDING OPERATIONS.
- DISTRIBUTE HANGER LOADS FROM MECHANICAL AND HEAVY ELECTRICAL SERVICES UNIFORMLY ALONG STEEL MEMBERS. ALTERNATE HANGER POSITION ON EITHER SIDE OF MEMBERS, DO NOT INSTALL IN A MANNER THAT WILL CAUSE TWISTING OF STEEL MEMBERS OR EXCESSIVE BENDING OF FLANGES OR CHORDS.
- PREMIXED GROUT: NON-SHRINK. MINIMUM STRENGTH 40 MPa AT 28 DAYS.
- INSTALL GROUT UNDER BASE PLATES AS SOON AS STEEL WORK IS COMPLETE. IN ACCORDANCE WITH MANUFACTURER'S DIRECTIONS. PROVIDE 100% CONTACT OVER GROUTED AREA. DO NOT APPLY ANY LOADS TO THE STEELWORK BEFORE GROUT ACHIEVES SUFFICIENT STRENGTH.

LIGHTWEIGHT STEEL FRAMING (LSF)

- CONFORM TO CSA S136, CSSBI S18, CSSBI S5 AND CSSBI S6,
- LSF CONTRACTOR MUST RETAIN A PROFESSIONAL ENGINEER REGISTERED IN THE PROVINCE OF BRITISH COLUMBIA RESPONSIBLE FOR THE SPECIALTY DESIGN OF THE LSF. THIS SUPPORTING REGISTERED PROFESSION SHALL PROVIDE THE FOLLOWING:
 - SIGNED AND SEALED SHOP DRAWINGS
 - SIGNED AND SEALED SCHEDULE S-B: ASSURANCE OF PROFESSIONAL DESIGN AND COMMITMENT FOR FIELD REVIEW BY SUPPORTING REGISTERED PROFESSIONAL
 - PERFORM PERIODIC FIELD REVIEW AND PROVIDE WRITTEN REPORTS OF FIELD REVIEW
 - SIGNED AND SEALED SCHEDULE S-C: ASSURANCE OF PROFESSIONAL FIELD REVIEW AND COMPLIANCE BY SUPPORTING REGISTERED **PROFESSIONAL**
- STEEL JOIST AND LINTEL DESIGN: 3.
 - DESIGN FOR LOADS AS INDICATED ON DRAWINGS.
 - LIMIT LIVE LOAD DEFLECTION TO 1/360 OF SPAN, LIMIT TOTAL ROOF LOAD DEFLECTION TO 1/240.
- COORDINATE WITH OTHER WORK INCLUDING AIR AND VAPOUR BARRIERS, 4. EXTERIOR SHEATHINGS AND INSULATION, STUD SPACE INSULATION, MASONRY, DRYWALL, MECHANICAL, ELECTRICAL, PLUMBING, DOORS AND WINDOWS, INTERIOR DRYWALL PARTITIONS, CONCRETE AND CONCRETE FORMWORK, AND STAIRS.
- 5. LSF SYSTEM MUST BE INSTALLED TO MEET FIRE RATED ASSEMBLIES AS SPECIFIED BY THE ARCHTIECT.
- 6. BRIDGING FOR RESTRAINING MEMBER ROTATION AND TRANSLATION OF LOADBEARING WALL STUDS IS NOT PROVIDED BY COLLATERAL SHEATHING.
- 7. ALL LSF COMPONENTS SHALL HAVE METALLIC COATINGS CONFORM TO ASTM A653/A653M (WITH ZF75 OR Z275 COATING), OR ASTM A792/A792A (WITH AZ150 COATING). TOUCH-UP WITH ZINC-RICH PAINT PER SSPC PAINT SPECIFICATION NO.20 WHEREVER PROTECTIVE COATING HAS BEEN DAMAGED DURING ERECTION.
- ALL LIGHTWEIGHT STEEL MATERIAL 0.0451" (1.146 mm) OR THINNER SHALL CONFORM TO ASTM A653/653M GRADE A, 33 KSI (227 MPa) MINIMUM YIELD; 0.0566" (1.438 mm) OR THICKER SHALL CONFORM TO ASTM A653/653M GRADE D, 50 KSI (345 MPa) MINIMUM YIELD.
- 9. ALL STUDS AND JOISTS SHALL HAVE LIPPED FLANGE.
- SPECIFICATIONS AND THICKNESS OF TRACKS SHALL BE THE SAME OR HEAVIER THAN STUDS BEING INSTALLED.

- ALL CONNECTORS SHALL BE OF CORROSIVE RESISTANCE MATERIAL COMPATIBLE WITH METALLIC COATINGS OF LSF COMPONENTS.
- STEEL JOISTS SHALL BE SPACED AT CENTERS INDICATED AND LINE UP **EXACTLY WITH SUPPORTING STUDS.**
- 13. PROVIDE COMPLETE, UNIFORM AND LEVEL BEARING SUPPORT FOR BOTTOM TRACK AT EACH BEARING STUD LOCATION. IF NOT PROVIDED, INSTALL FULL SIZE SHIMS BELOW BOTTOM TRACK AT STUD LOCATIONS AS NEEDED. OR SET BOTTOM TRACK IN HIGH-STRENGH GROUT.
- ALL INSTALLATION SHALL BE IN ACCORDANCE WITH THE MANUFACTURER'S RECOMMENDATIONS.

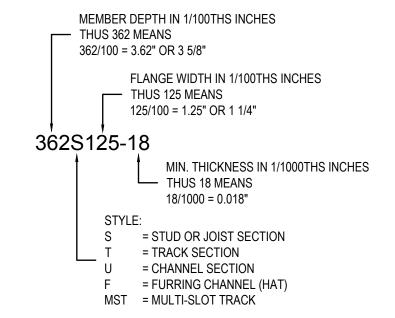

REJECTED WORK

DO NOT DELIVER MATERIALS WHICH ARE KNOWN NOT TO MEET THE REQUIREMENTS OF THE SPECIFICATIONS. IF REJECTED AFTER DELIVERY, REMOVE IMMEDIATELY FROM SITE.

Client/client

CORRECTIONAL SERVICE CANADA

Project title/Titre du projet MISSION MEDIUM INSTITUTION 8751 STAVE LAKE STREET, MISSION, BC

> **BUILDING M CANTEEN RELOCATION**

Drawing title/Titre du dessin

GENERAL NOTES

Consultant	Signature	&	Date	Only
-	y/Concept			
ASHLE	Y RENAUD.	. w	SP CA	NADA INC

JOHN GUERRA. WSP CANADA INC

Drawn by/Dessine par

PWGSC Project Manager/Administrateur de Projets TPSGC PAUL RITHALER PREETIPAL PAUL

2019-07-31

Date/Date

Architectural and Engineering Services/ Sheet/**Feuille** vices d'architectural et de aénie. TPSGC

Project No./No. du projet

R.097976.001


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Revision/ Revision



REAL PROPERTY SERVICES
Pacific Region

SERVICES IMMOBILIERS
Région de Pacifique

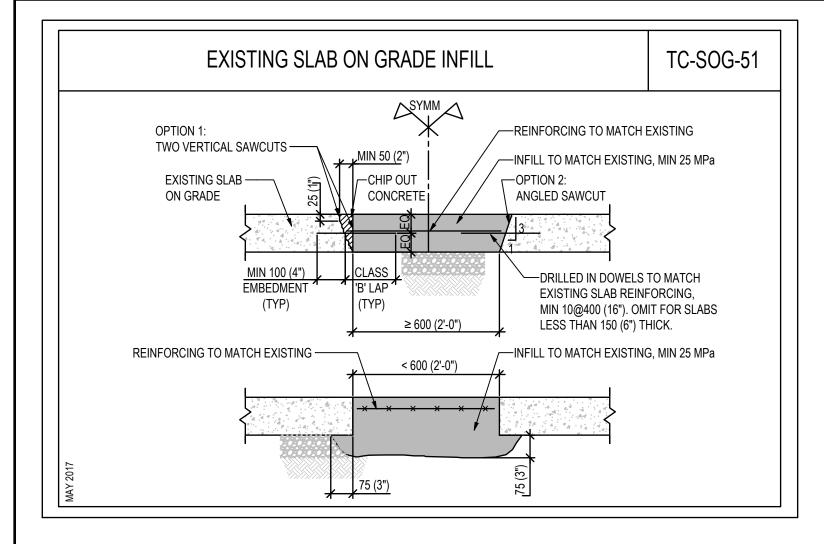

Client/client

CORRECTIONAL SERVICE CANADA

Project title/Titre du projet
MISSION MEDIUM INSTITUTION
8751 STAVE LAKE STREET, MISSION, BC

BUILDING M
CANTEEN RELOCATION

Drawing title/Titre du dessin

GENERAL NOTES

	PWGSC Project Manager/Adminis de Projets TPSGC PAUL RITHAL
signed by/Concept par	PWGSC, Regional Manager, Architectural and l Gestionnaire régionale, Services d'architectural
ASHLEY RENAUD, WSP CANADA INC	PREETIPAL PA

Drawn by/Dessine par

JOHN GUERRA, WSP CANADA INC

PWGSC Project Manager/Administrateur de Projets TPSGC PAUL RITHALER 1

PWGSC, Regional Manager, Architectural and Engineering Services/
Sestionnaire régionale, Services d'architectural et de génie, TPSGC PREETIPAL PAUL

Date/Date

2019-07-31

Project No./No. du R.097976.001

ALER projet K.097970.001

I Engineering Services/
roll et de génie, TPSGC
PAUL

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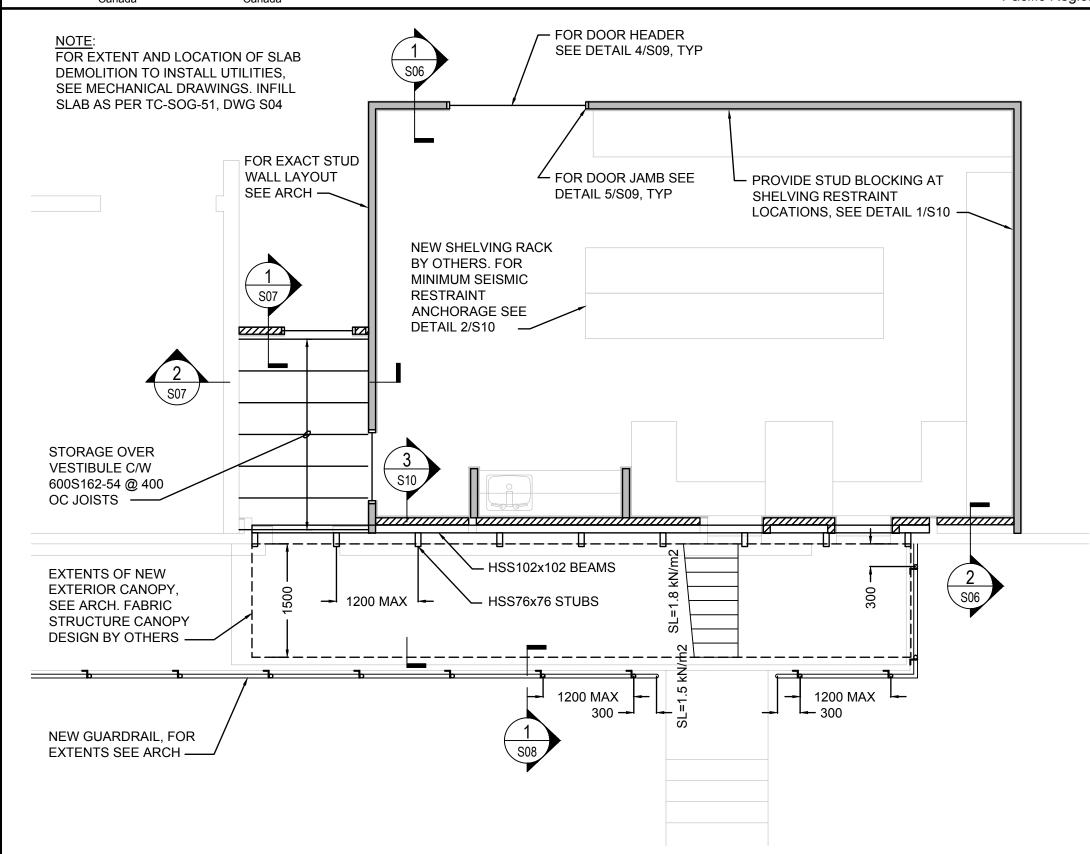


Project title/Titre du projet

MISSION MEDIUM INSTITUTION 8751 STAVE LAKE STREET, MISSION, BC

BUILDING M

CANTEEN RELOCATION



Drawing title/Titre du dessin

NEW CANTEEN FLOOR PLAN

PLAN NOTES

- SEE GENERAL NOTES AND TYPICAL DETAILS ON DRAWINGS S01 THROUGH S05.
- 2. MAIN FLOOR IS LEVEL WITH EXISTING. ASSUMED DATUM ELEVATION IS 60'-0".
- 3. UNLESS NOTED OTHERWISE ON PLAN, DESIGN LOADS ARE:

LIVE LOAD (LL) - CANTEEN = 4.8 kN/m²
LIVE LOAD (LL) - VESTIBULE STORAGE = 4.8 kN/m²
WIND LOAD (WL) - NEW STUD WALLS = 0.5 kN/m²
SUPERIMPOSED DEAD LOAD (SDL) = 1.0 kN/m²
SELF WEIGHT (SWT) - NEW STUD WALLS = 0.5 kN/m²
PARTITION LOAD IS INCLUDED IN THE SDL

4. NEW FABRIC STRUCTURE IS A DELEGATED DESIGN BY OTHERS, GEOMETRY AS SHOWN ON ARCHITECTURAL DRAWINGS AND FASTENED TO EXISTING BUILDING IN ACCORDANCE WITH STRUCTURAL SUPPORTS AS SHOWN. AT A MINIMUM, DESIGN OF NEW FABRIC CANOPY STRUCTURE, DESIGN CRITERIA AS FOLLOWS:

LIVE LOAD (SNOW) = SNOW PILING AS NOTED ON PLAN

WIND LOAD IN ACCORDANCE WITH NBC2015 DEFLECTION OF ELEMENTS TO BE LIMITED TO L/240

PWGSC Project Manager/Administrateur de Projets TPSGC PAUL RITHALER

Date/Date

PREETIPAL PAUL

2019-07-31

Consultant Signature & Date Only

ASHLEY RENAUD, WSP CANADA INC

JOHN GUERRA, WSP CANADA INC

Designed by/Concept par

Drawn by/Dessine par


R.097976.001

Project No./No. du projet


and Engineering Services/ Sheet/**Feuille**

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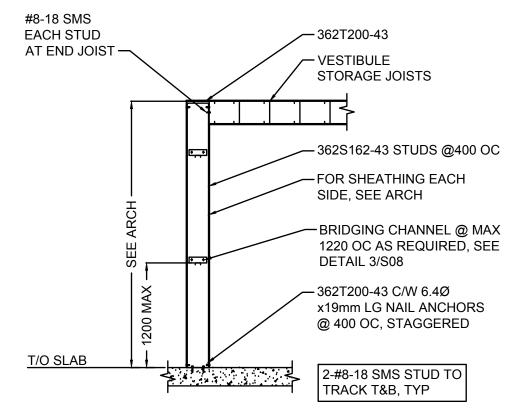


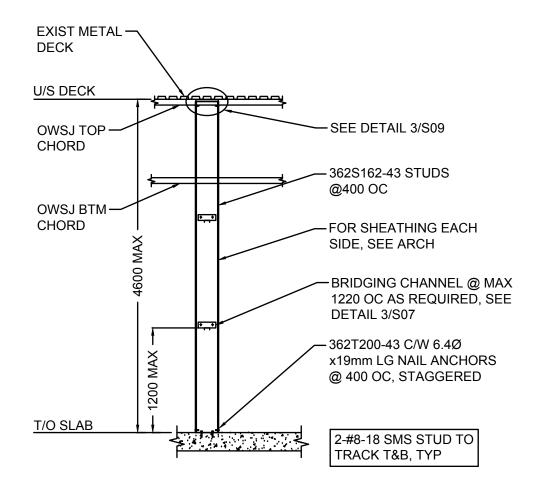


TYP STUD WALL TO U/S EXIST BEAM
N.T.S.

NOTE:
NAIL ANCHORS MUST HAVE MINIMUM CAPACITY UNO:
Tr =0.8kN
Vr =1.5kN

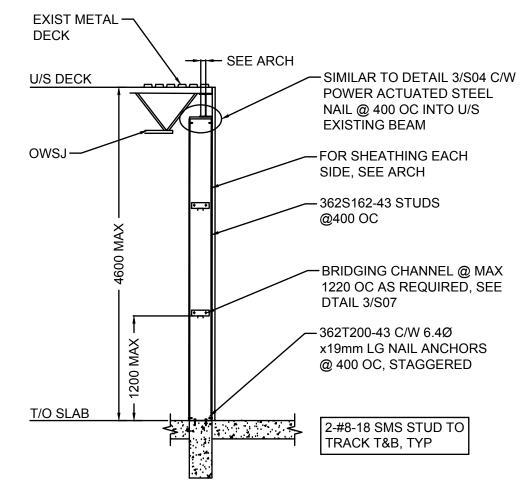Client/client	MISSION MEDIUM INSTITUTION	Drawing title/Titre du dessin	de Projets TPSGC PAUL RITHALER P		Project No./No. du projet R.097976.001	
CORRECTIONAL SERVICE CANADA	8751 STAVE LAKE STREET, MISSION, BC BUILDING M	DETAILS	Designed by/Concept par ASHLEY RENAUD, WSP CANADA INC	PWGSC, Regional Manager, Architectural and Engineering Services/ Gestionnaire régionale, Services d'architectural et de génie, TPSGC PREETIPAL PAUL	Sheet/ Feuille \$06	Revision/ Revision
	CANTEEN RELOCATION		Drawn by/Dessine par JOHN GUERRA, WSP CANADA INC	Date/Date 2019-07-31	506 OF	1





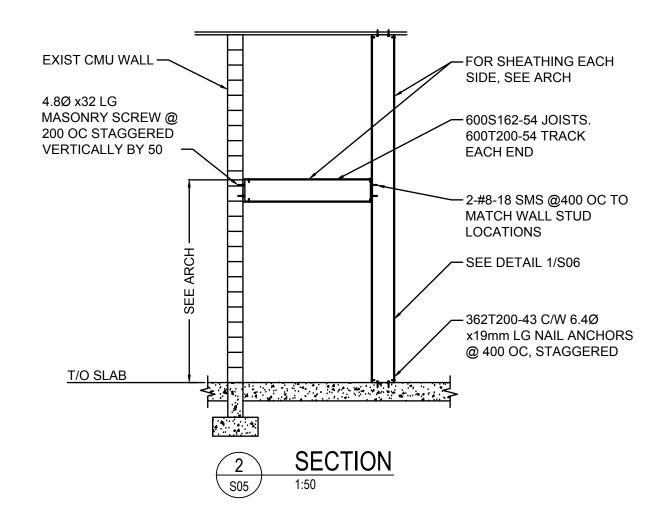


NOTE:
NAIL ANCHORS MUST HAVE MINIMUM CAPACITY UNO:
Tr =0.8kN
Vr =1.5kN


Client/client	Project title/Titre du projet MISSION MEDIUM INSTITUTION	Drawing title/Titre du dessin	Consultant Signature & Date Only	PWGSC Project Manager/Administrateur de Projets TPSGC PAUL RITHALER	Project No./No. du projet R.09797	76.001
CORRECTIONAL SERVICE CANADA	8751 STAVE LAKE STREET, MISSION, BC BUILDING M	DETAILS	Designed by/Concept par ASHLEY RENAUD, WSP CANADA INC	PWGSC, Regional Manager, Architectural and Engineering Services/ Gestionnaire régionale, Services d'architectural et de génie, TPSGC PREETIPAL PAUL	Sheet/Feuille S07	Revision/ Revision
	CANTEEN RELOCATION		Drawn by/Dessine par	Date/Date 2019-07-31	30 <i>1</i>	1

REAL PROPERTY SERVICES
Pacific Region

SERVICES IMMOBILIERS
Région de Pacifique

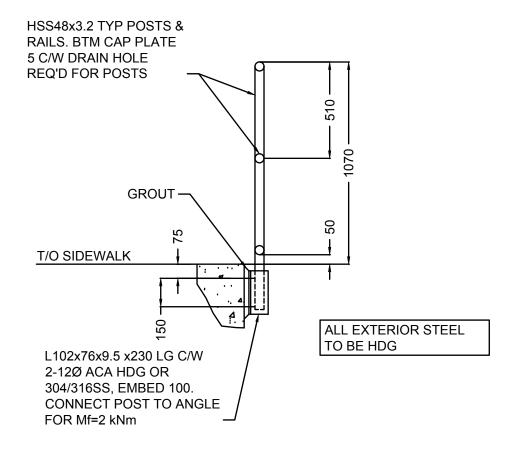




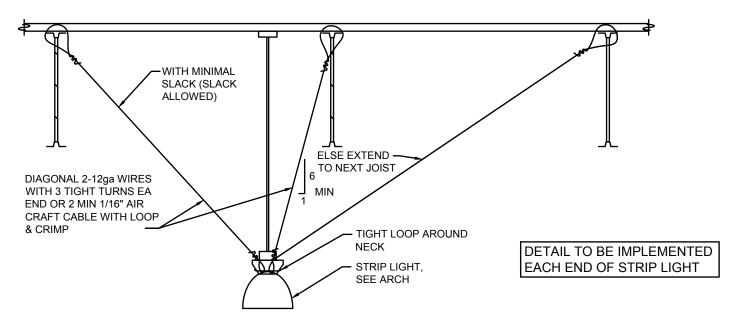

TYP SEISMIC RESTRAINT FOR STRIP LIGHTS

N.T.S.

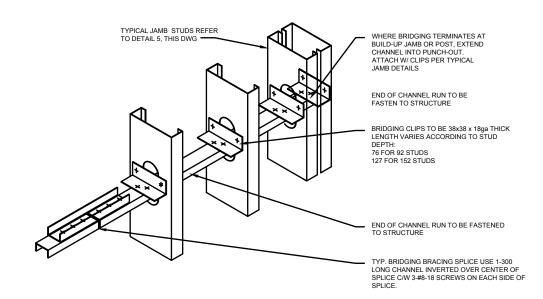

3 TYP BRIDGING DETAIL
N.T.S.

Client/client

CORRECTIONAL SERVICE CANADA

Project title/Titre du projet
MISSION MEDIUM INSTITUTION
8751 STAVE LAKE STREET, MISSION, BC

BUILDING M
CANTEEN RELOCATION

Drawing title/Titre du dessin

DETAILS

Consultant Signature & Date Only

Designed by/Concept par

ASHLEY RENAUD, WSP CANADA INC

JOHN GUERRA, WSP CANADA INC

Drawn by/Dessine par

Date Only

PWGSC Project Manager/Administrateur de Projets TPSGC PAUL RITHALER

PWGSC, Regional Manager. Architectural and Engineering St Gestionnaire régionale, Services d'architectural et de génie, PREETIPAL PAUL

Date/Date

2019-07-31

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and Engineering Services/
betural et de génie, TPSSC

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Project No./No. du
projet

Sheet/Feuille

S08


Revision Revision

S08 of 1




REAL PROPERTY SERVICES Pacific Region


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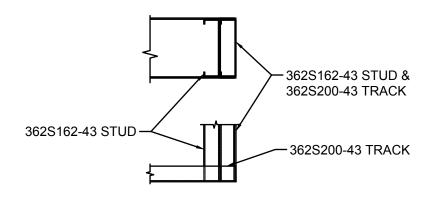
TYP STUD CORNER

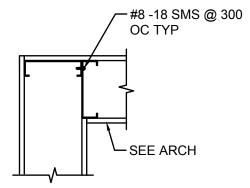


TYP DOOR HEADER

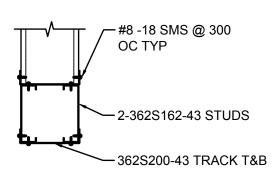


TYP STUD 'T' JUNCTION

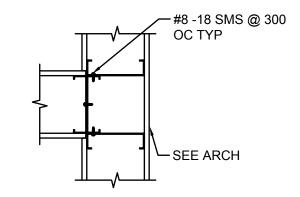


TYP DOOR JAMB

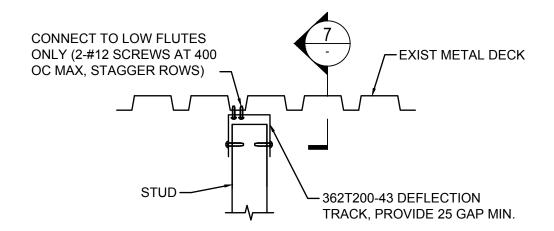

FULL HEIGHT STUD RESTRAINT

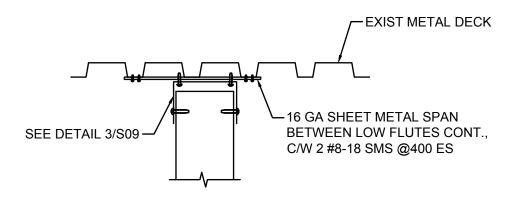

TYP TOP TRACK AT HIGH FLUTE S05

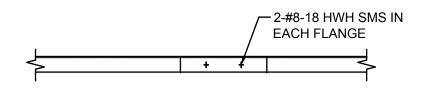

TYP TOP OR BOT TRACK SPLICE S05

Client/client

CORRECTIONAL SERVICE CANADA


Project title/Titre du projet MISSION MEDIUM INSTITUTION 8751 STAVE LAKE STREET, MISSION, BC


BUILDING M CANTEEN RELOCATION Drawing title/Titre du dessin **DETAILS**

Consultant Signature & Date Only	PWGSC Project Manager/Administrateur de Projets TPSGC PAUL RITHALER	Project No./No. du projet R.0979	76.001
Designed by/Concept par ASHLEY RENAUD, WSP CANADA INC	PWGSC, Regional Manager, Architectural and Engineering Services/ Gestionnaire régionale, Services d'architectural et de génie, TPSGC PREETIPAL PAUL	Sheet/Feuille \$09	Revision/ Revision
Drawn by/Dessine par	Date/Date	309	1
JOHN GUERRA, WSP CANADA INC	2019-07-31	OF	

REAL PROPERTY SERVICES
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TRIM EXIST CLADDING PANEL RECEIVE NEW STUBS. RE-RE EXIST BEAM-**BUILDING ENVELOPE TO** ACCOMMODATE 10mm MOVEMENT ALL AROUND 362S162-43 STUDS @ 400 OC -EXTERIOR CANOPY BY OTHERS, SEE ARCH FOR HSS102x102x6.4 BEAM AT **GEOMETRY TOP & BTM CANOPY** SUPPORT LOCATIONS. SPAN BETWEEN EXISTING HSS201x102 COLUMNS 38°.MIN HSS76x76x6.4 STUBS C/W END PLATE 6 PENETRATING THROUGH EXIST CLADDING TO RECEIVE NEW CANOPY SUPPORT FASTENERS. COORDINATE TO COINCIDE WITH HIGH FLUTE SURFACE. QUANTITY TO BE COORDINATED WITH CANOPY STRUCTURE SUPPLIER. ALL STEEL TO BE HOT DIP GALVANIZED.

TYP CANOPY SUPPORT DETAIL

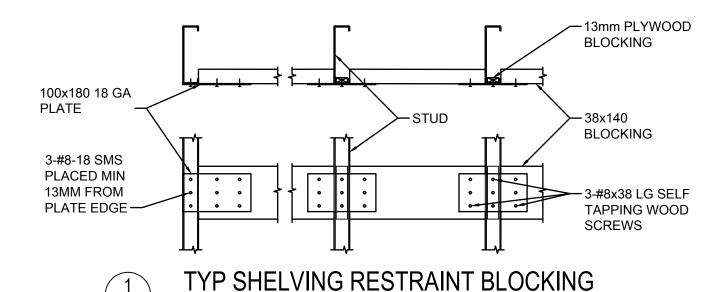1:20

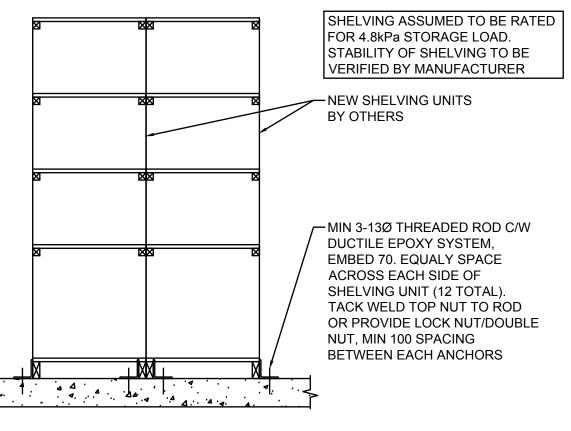

TYP SHELVING RACK SEISMIC ANCHORAGE

N.T.S.

N.T.S.

S05

CORRECTIONAL SERVICE CANADA

Project title/Titre du projet
MISSION MEDIUM INSTITUTION
8751 STAVE LAKE STREET, MISSION, BC
BUILDING M

CANTEEN RELOCATION

Drawing title/Titre du dessin

DETAILS

Consultant Signature & Date Only

Designed by/Concept par

ASHLEY RENAUD, WSP CANADA INC

Drawn by/Dessine par

JOHN GUERRA. WSP CANADA INC

PWGSC Project Manager/Administrateur
de Projets TPSGC PAUL RITHALER

PWGSC, Regional Manager, Architectural and Engineering Servi
Sestionnaire régionale, Services d'architectural et de génie, Ti
PREETIPAL PAUL

Date/Date

2019-07-31

Project No./No. du projet R.097976.001

Sheet/Feuille Revision/Revision/

S10

1

Client/client

EQUIPMENT SCHEDULE

HPI-MITSUBISHI CEILING HEAT PUMP CASSETTE PLA-A24EA7 7 kW COOLING 4.4 KW HEATING 208/230 V I PHASE MANUFACTURER RECOMMENDED

BREAKER 25 AMP 10 AWG R410A REFRIGERANT

SEER: 24.2 EER: 14.3

DIMENSIONS: 950mm X 950mm X 40 mm H

OR EQUIVALENT: DAIKIN. FUJITSU. CARRIER. SANYO

UNIT OPERATING TEMPERATURE: (HEATING) DB -8°C / WB -9°C (COOLING) DB 35°C / WB 24°C

ACCESSORIES: - WINDSCREEN ON CONDENSER FOR OPERATION IN TEMPERATURES BELOW -5°C

> - WALL MOUNTED WIRED PROGRAMMABLE CONTROLLER FOR COMBINED AC SYSTEM AND HRV SYSTEM

- LOW AMBIENT CONTROL

- AIR FLOW (CFM): 490 - 600 - 670 - 770 - SOUND dB : 28 - 30 - 33 - 36

CUI - MITSUBISHI OUTDOOR CONDENSING UNIT PUZ-A24NHA7 208/230 V I PHASE MANUFACTURER RECOMMENDED BREAKER 30 AMP 10 AWG DIMENSIONS: 943mm HIGH X 950mm LONG X 4 I 7mm DEEP OR EQUIVALENT: DAIKIN, FUJITSU, CARRIER, SANYO

WEIGHT lbs (kg): 153 (69) AIRFLOW (CFM): 1940 SOUND db (A) : 47/48

HRV I - MITSUBISHI LOSSNAY HEAT RECOVERY VENTILATOR IGH-F300RX5-F1 OR FQUIVALENT: VENMAR

ELECTRICAL: 208 V / 60 Hz

AIRFLOW : 91 CFM (43 l/s) @ 0.06" WC (15 Pa)

NOISE (db) : 18 WEIGHT (ka): 33

ACCESSORIES - ACTUATED BY-PASS MODE DAMPER

- WALL MOUNTED WIRED PROGRAMMABLE CONTROLLER

FOR COMBINED AC SYSTEM AND HRV

- HIGH EFFICIENCY FILTER

- MOTORIZED AIR DAMPER ON OUTDOOR INLET DUCT

- BACKDRAFT DAMPER ON EXHAUST DUCT

EG I - EH PRICE RPG PERFORATED ROUND GRILLE I 50mm DIAMETER COMPLETE WITH TAMPER PROOF FASTENERS

LI - EH PRICE LOUVRE 300 mm x 300 mm

ACCESSORIES: - 12 mm SIZED x 14 GAUGE SECURITY SCREEN PERMANENTLY

SECURED TO FORMED ALUMINUM FRAME AND MOUNTED ON

INTERIOR LOUVRE FACE - CONTINUOUS BLADES ONLY

- ANODIZED COATING (TO BE SELECTED BY ARCHITECT)

EQUALS: AIROLITE

SNK I - KINDRED STEEL QUEEN SINGLE BOWL STAINLESS STEEL SINK QSL1719/8 COMPLETE WITH DELTA 2179LF CHROME FINISH **FAUCET**

OR EQUIVALENTS: AMERICAN STANDARD, ELKAY, KROWNE METAL

SPH I - VIKING QUICK RESPONSE PENDANT SPRINKLER HEAD CHROME FINISH FLUSH MOUNT WITH ESCUTCHEON

Client/client

CORRECTIONAL SERVICE CANADA

Project title/Titre du projet

MISSION MEDIUM INSTITUTION 8751 STAVE LAKE STREET, MISSION, BC

BUILDING M CANTEEN RELOCATION Drawing title/Titre du dessin

MECHANICAL EQUIPMENT SCHEDULES

Designed b	v/Concept	n	7r		
Consultant	Signature	δC	рате	Only	

W CASOL

PWGSC Project Manager/Administrateur de Projets TPSGC PAUL RITHALER

2019-04-08


Project No./No. du projet **R.097976.001**


PWGSC, Regional Manager, Architectural and Engineering Services/ Gestionnaire régionale. Services d'architectural et de génie. TPSGC Sheet/Feuille PREETIPAL PAUL Drawn by/Dessine par Date/Date


M01 OF 4

Revision/ Revision

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CANTEEN RELOCATION

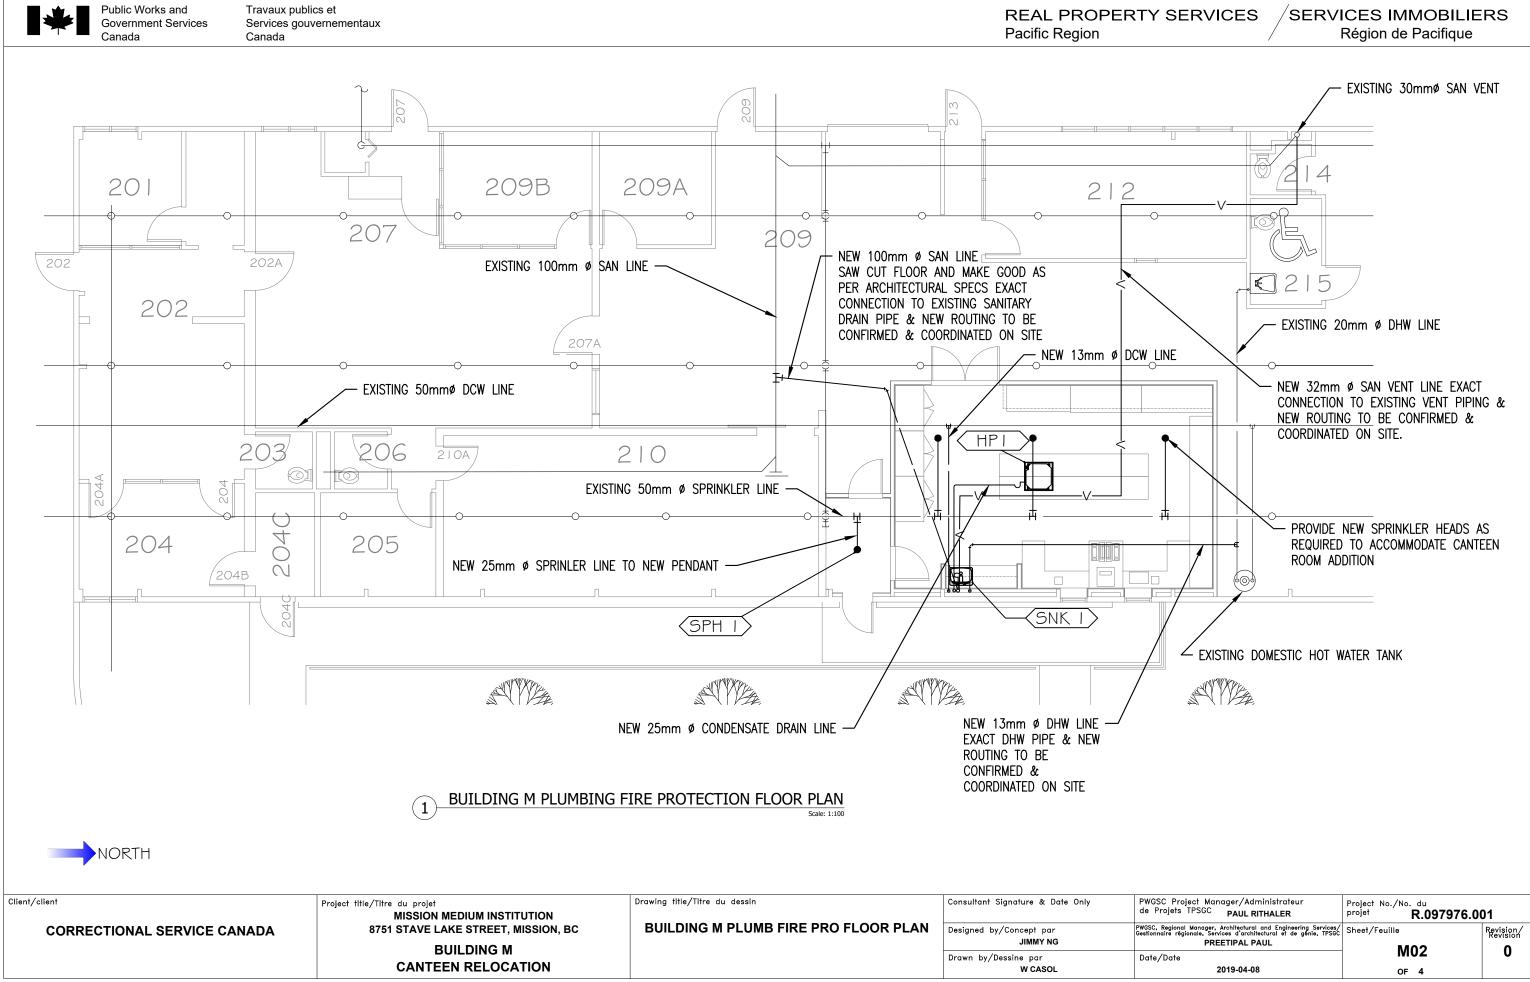Drawn by/Dessine par

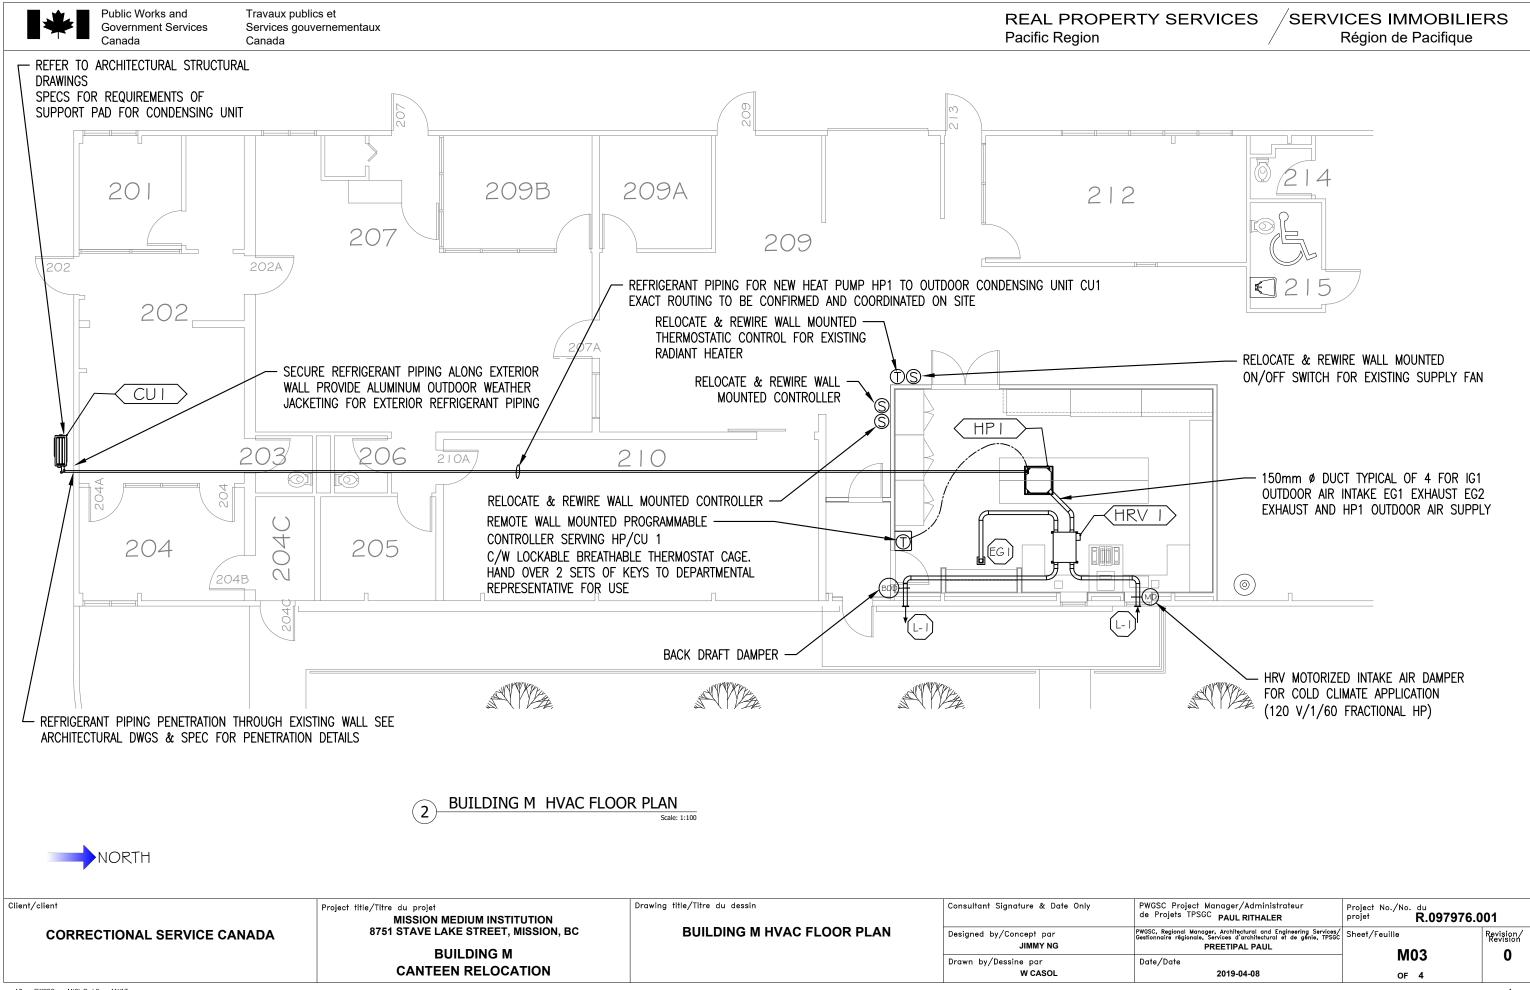STEVE BANFIELD

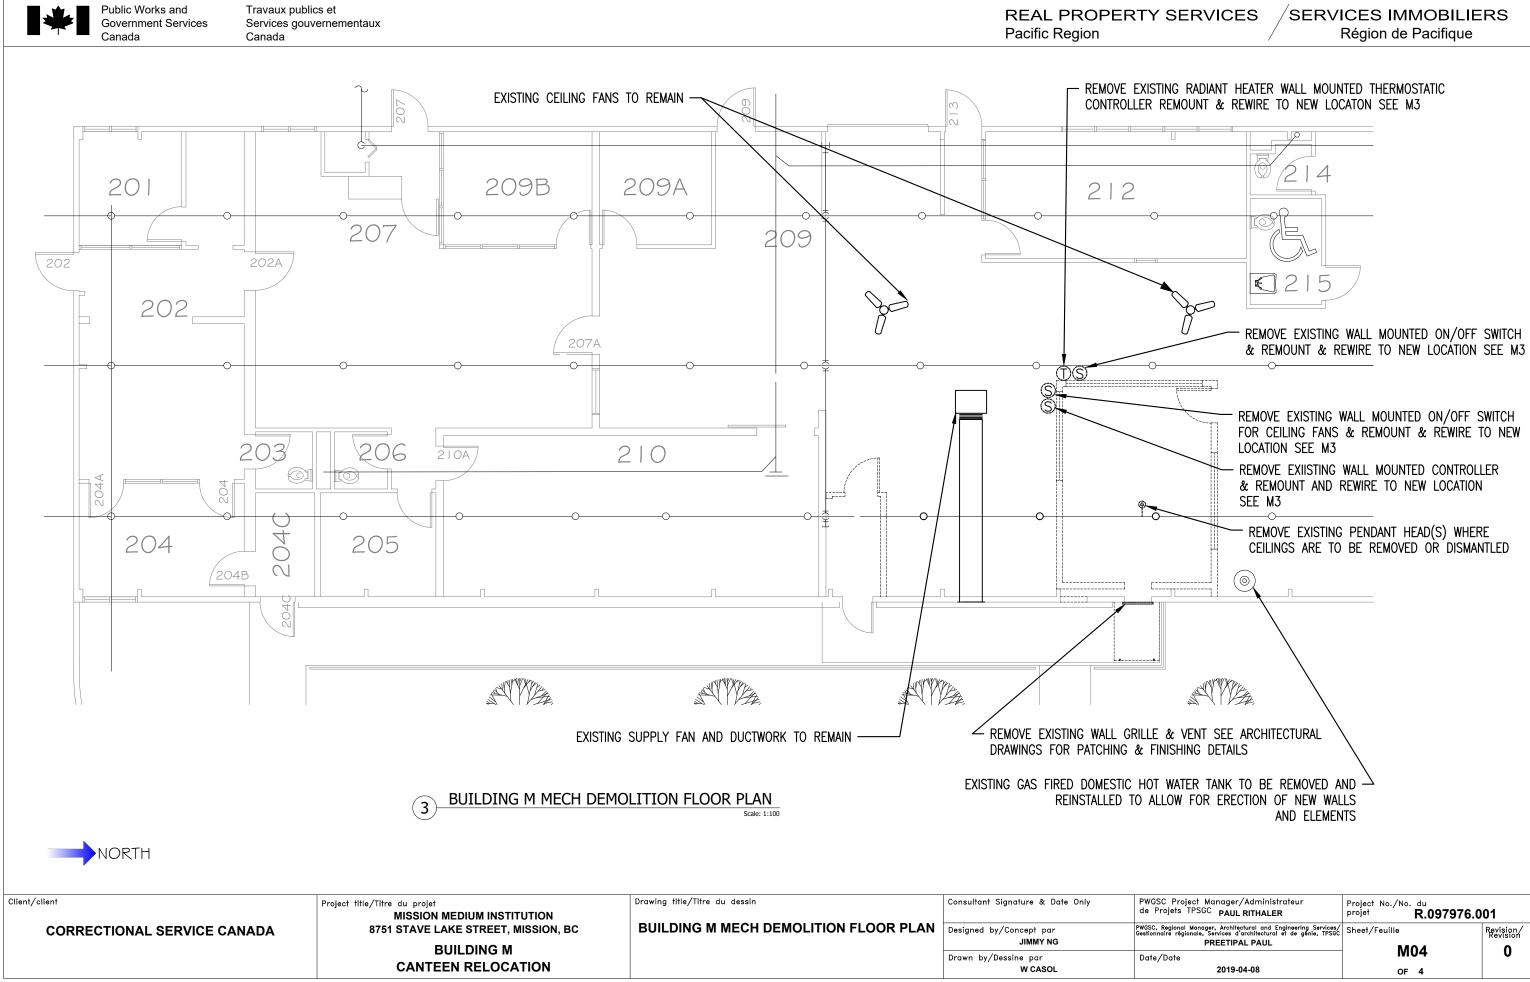Date/Date

ISSUED FOR TENDER 2019-11-30



Maintenance - First Floor

Programs Coordinator

Inmate Waiting Area

Chief Finance Office

Staff Washroom

Staff Washroom

Finance Area

Boardroom

Storage

Inmate Programs Assistant

Institutional Supply & Service

Chief Inst. Supply \$ Service

Unit M

202

203

204

204c

205

206

207

209

209a

209b

Rm. # Name

Travaux publics et Services gouvernementaux Canada

210

212

2136

213c

214

216

218

219

220

221

223

Inmates Clothing

Storage

Grounds

Grounds

Plan Room

ISS General Office

Canteen Storage

Inmate Washroom

Chief of Works

Works Office

Staff Washroom

Electrical Shop

B.F. Staff Washroom

Institutional Supply & Service


REAL PROPERTY SERVICES Pacific Region

SERVICES IMMOBILIERS Région de Pacifique

SYMBOL DENOTES THE NUMBER AND ANGLE OF PICTURE TAKEN FROM THE AREA SHOWN.

I - PROVIDE 2 NEW CCTV CAMERAS (ONE INDOOR, ONE OUTDOOR) AS SHOWN: ONE IN THE VESTIBULE AND ONE AT THE TOP OF THE BUILDING (LU-2) ACROSS THE ROAD. CONFIRM EXACT LOCATIONS ON SITE.

- 2- THIS WORK WILL INCLUDE BUT NOT LIMITED TO;
- a) PROVIDE MOUNTING BRACKETS FOR EACH CAMERA AND RUN CONDUITS WITH CAT.6 UTP CABLE TO LOCAL CCTV NETWORK SWITCH (DATA/CCTV CABINET) SHOWN ON THIS DRAWING AND TO THE ELECTRICAL ROOM IN BUILDING LU-2
- TERMINATE CAT. 6 CABLES ON THE NETWORK PATCH PANEL AND REPROGRAM THE SYSTEM IN COORDINATION WITH DEPARTMENTAL REPRESENTATIVE.
- c) PAY AND OBTAIN LICENSES FOR CAMERAS TO USE IN CSC CCTV SYSTEM. 3- HIRE CERTIFIED SECURITY CONTRACTOR TO PERFORM THE CCTV WORKS AS
- 4- REFER TO SITE PLAN EO I FOR INFORMATION ABOUT APPROXIMATE LOCATIONS OF

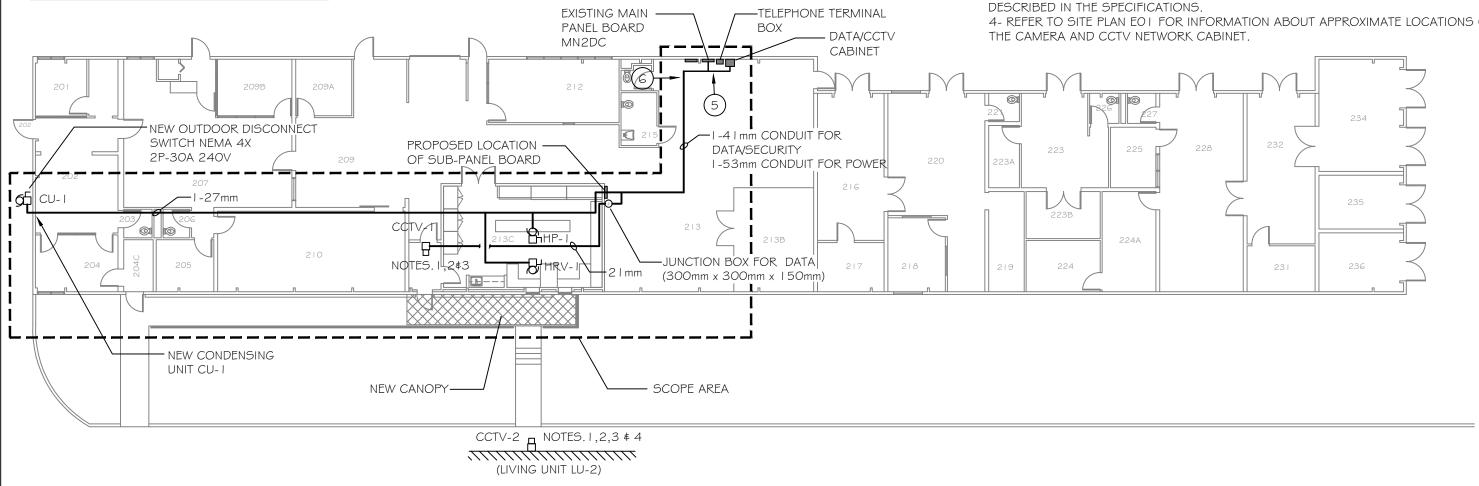

223a

223b

224

225

226

227

228

231

232

234

235

236

224a

Electronics Office

Carpenters Office

Inmate Washroom

Inmate Washroom

Plumbers Office

Plumbers Shop

Plumbers Storage

Carpentry/Storage

Paint Storage \$ Shop

Carpentry & Paint Shop

Fire Equipment Storage

Storage

Storage

BUILDING M FLOOR PLAN

SCALE 1:200

Client/client	Project title/Titre du projet MISSION MEDIUM INSTITUTION	Drawing title/Titre du dessin	Consultant Signature & Date Only	PWGSC Project Manager/Administrateur de Projets TPSGFAUL RITHALER	Project No./No. R.097976.00	01
CORRECTIONAL SERVICE CANADA	8751 STAVE LAKE STREET, MISSION, BC	BUILDING M FLOOR PLAN	Designed by/Concept par	PWGSC, Regional Manager, Architectural and Engineering Service Gestionnaire régionale, Services d'architectural et de génie, TPS	Sheet/Feuille	Revision/ Revision
	BUILDING M		VEYSEL AYDIN	PREETIPAL PAUL	E02	1
			Drawn by/Dessine par	Date/Date	E02	'
	CANTEEN RELOCATION		STEVE BANFIELD	ISSUED FOR TENDER 2019-11-30	0.5	

NORTH

UNUSED WIRING AND CONDUITS.

VESTIBULE.-

REMOVE ALL EXISTING WIRING AND CONDUITS IN THE CEILING SPACE OF CONSTRUCTION AREA AND

RE-ROUTE AS REQUIRED. DISPOSE OF THE EXISTING

REMOVE EXISTING JUNCTION BOX.

CONDUITS AND LIGHTING SWITCH FOR

NOTE:

Travaux publics et Services gouvernementaux Canada

> SPEAKER WITH **VOLUME CONTROL**

REAL PROPERTY SERVICES Pacific Region

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TELEPHONE OUTLET

SPEAKER

POWER CONNECTION (HARDWIRED)

DATA OUTLET

JUNCTION BOX LED LUMINAIRE (SUSPENDED OR CEILING MOUNT)

EMERGENCY LIGHTING HEAD & BATTERY

QUAD RECEPTACLE

LUMINAIRE WALL MOUNTED

INTERCOM - RECEIVER STATION

INTERCOM BUZZER STATION

LED EXIT LIGHT - WITH BUILT-IN BATTERY

CCTV CAMERA

DESCRIBES TYPE OF LIGHT FIXTURE

ISSUED FOR TENDER 2019-11-30



EXISTING HOT WATER TANK -HARD WIRED CONNECTION TO BE EXISTING TO REMAIN REMOVED AND RE-INSTALLED IN A JUNCTION BOX (COORDINATE WITH MECHANICAL)

STEVE BANFIELD

Client/client

CORRECTIONAL SERVICE CANADA

DEMOLITION PLAN

Project title/Titre du projet MISSION MEDIUM INSTITUTION 8751 STAVE LAKE STREET, MISSION, BC

BUILDING M

CANTEEN RELOCATION

DEMOLITION PLAN

Drawing title/Titre du dessin

EXISTING JUNCTION BOXES AND CONDUITS IN CEILING TO BE

-OVERHEAD **FAN SWITCH**

RELOCATED TO CLEAR THE NEW WALL

R R

ETR

ETR


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PWGSC Project Manager/Administrateur de Projets TPSGFAUL RITHALER Consultant Signature & Date Only Designed by/Concept par PWGSC, Regional Manager, Architectural and Engineering Services/
Gestionnaire regionale, Services d'architectural et de génie, TPSGC Sheet/Feuille **VEYSEL AYDIN** PREETIPAL PAUL Date/Date Drawn by/Dessine par

Project No./No. du 97976.001

Revision/



NEW CANTEEN FLOOR PLAN SCALE 1:50

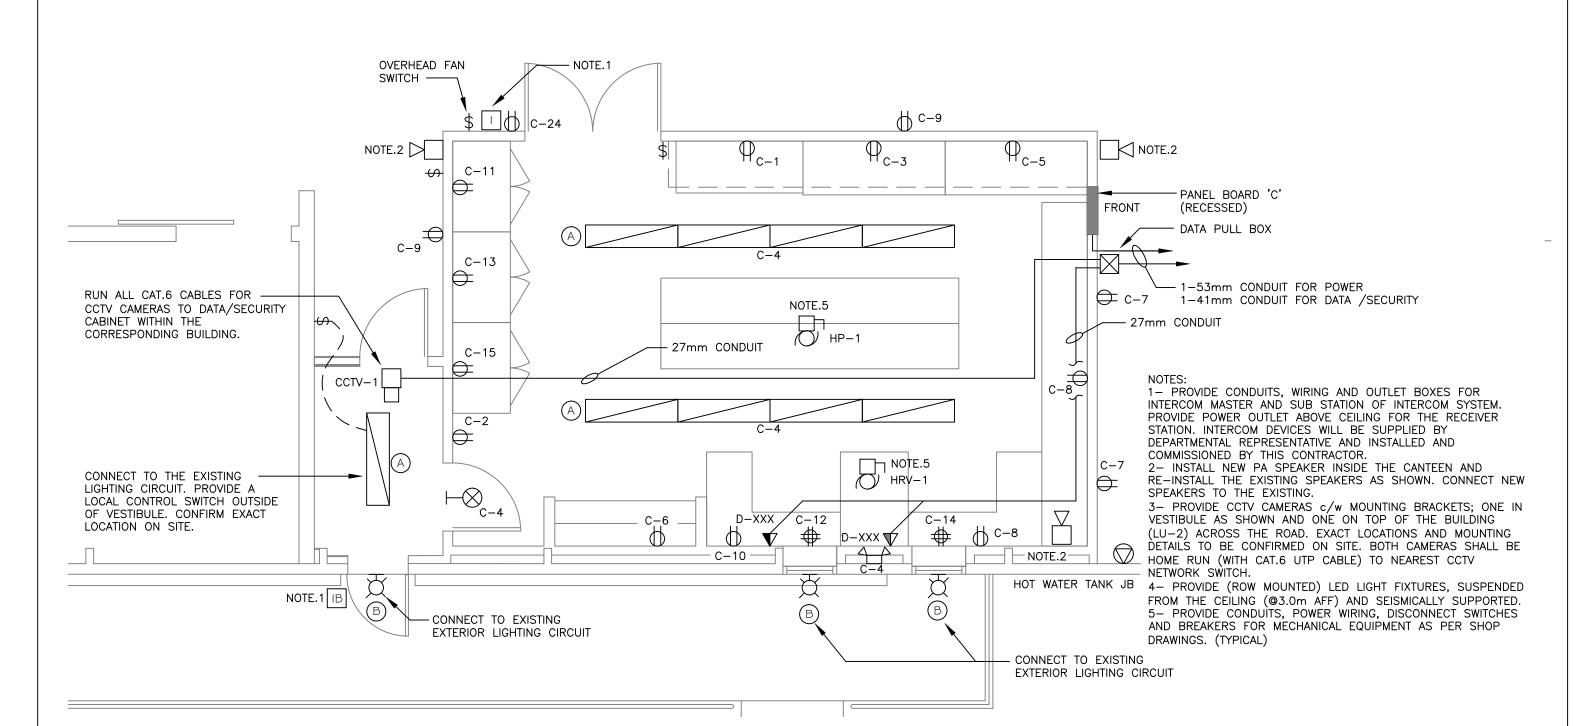BUILDING M

CANTEEN RELOCATION

Drawing title/Titre du dessin

NORTH

Client/client

Project title/Titre du projet MISSION MEDIUM INSTITUTION 8751 STAVE LAKE STREET, MISSION, BC

NEW CANTEEN FLOOR PLAN

Consultant Signature & Date Only

PWGSC Project Manager/Administrateur de Project No./Project No./Proj

E04


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PICTURE 1

SCALE NTS





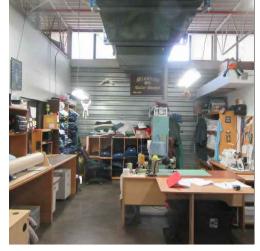


PICTURE 2

SCALE NTS

PICTURE 3
SCALE NTS

PICTURE 4
SCALE NTS



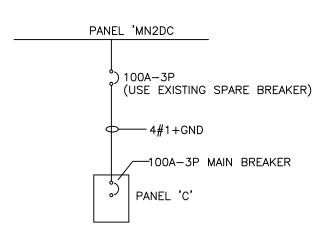









PICTURE 5
SCALE NTS

PICTURE 6
SCALE NTS

PICTURE 7
SCALE NTS

PICTURE 8
SCALE NTS

SINGLE LINE DIAGRAM

SCALE NTS

Client/client	Project title/Titre du projet MISSION MEDIUM INSTITUTION 8751 STAVE LAKE STREET, MISSION, BC	Drawing title/Titre du dessin	Consultant Signature & Date Only	PWGSC Project Manager/Administrateur de Projets TPSGF _{AUL} RITHALER	Project No./No.R.097976.001	
CORRECTIONAL SERVICE CANADA	BUILDING M CANTEEN RELOCATION	DETAILS	Designed by/Concept par VEYSEL AYDIN	PWGSC, Regional Manager, Architectural and Engineering Services/ Gestionnaire régionale, Services d'architectural et de génie, TPSGC PREETIPAL PAUL		Revision/ Revision
			Drawn by/Dessine par STEVE BANFIELD	Date/Date ISSUED FOR TENDER 2019-11-30	E05	