



Revision	Description	Date
4	ISSUED FOR CONSTRUCTION	2020/03/06
3	ISSUED FOR 90% REVIEW	2019/08/09
2	ISSUED FOR 60% REVIEW	2019/05/09
1	ISSUED FOR 30% REVIEW	2019/03/14

Revision	Description	Date
Client		client

PSPC

10025 JASPER AVE  
EDMONTON, ALBERTA, T5J 1S6  
PH. 780-919-9445

Project title / Projet  
JASPER STAFF HOUSING CONSTRUCTION

DUPLEX

720 PATRICIA STREET,  
JASPER, AB, T0E 1E0

Designed by / Conçu par  
H.Sun

Drawn by / Dessiné par  
D.Kuang


Approved by / Approuvé par  
A.Elshafey

PNCSO Project Manager / Administrateur de Projets TPSCC  
ROB HAFER

Drawing Title / Titre du dessin


2ND FLOOR & ROOF FRAMING PLAN

Project no./No. du projet	Drawing no./No. du dessin	Revision no.
R. 100429.001	S3.2	4

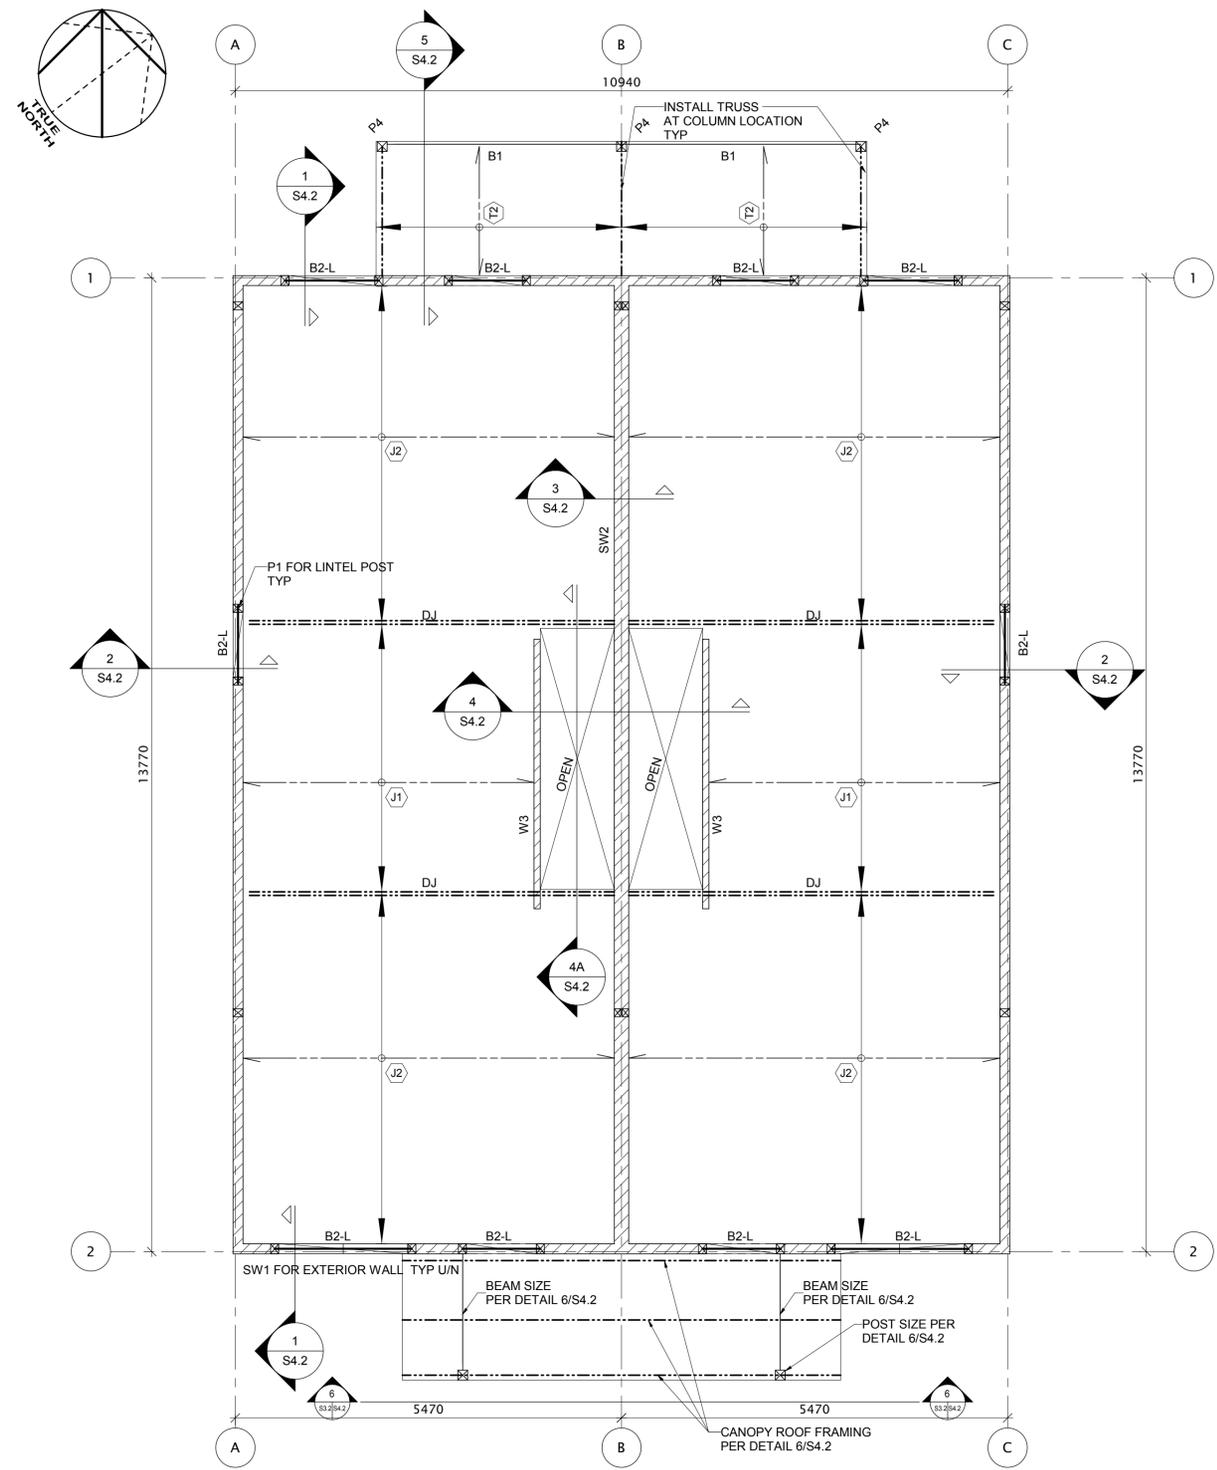

1 LEVEL 02 FRAMING PLAN  
S3.2 SCALE: 1:50

**FLOOR DESIGN LOADS:**  
DEAD LOAD = 0.72 kPa (SELF-WEIGHT)  
= 0.72 kPa (DECK & BALCONY)  
SUPERIMPOSED PARTITION LOAD = 0.5 kPa  
SUPERIMPOSED COUNTERTOP LOAD = 1.0 kPa  
(SEE ARCH FOR LOCATION)  
SUPERIMPOSED BATHTUB LOAD = 0.5 kPa  
(SEE ARCH FOR LOCATION)  
LIVE LOAD = 1.9 kPa (INSIDE UNITS)  
= 4.8 kPa (COMMON AREAS)  
= 2.4 kPa (DECK & BALCONY)  
  
**CANOPY DESIGN LOADS:**  
DEAD LOAD = 0.72 kPa  
SNOW LOAD = 2.5 kPa  
  
**NOTE:**  
JOIST SUPPLIER TO REVIEW MECHANICAL DWGS  
AND COORDINATE ALL PENETRATION AS NECESSARY

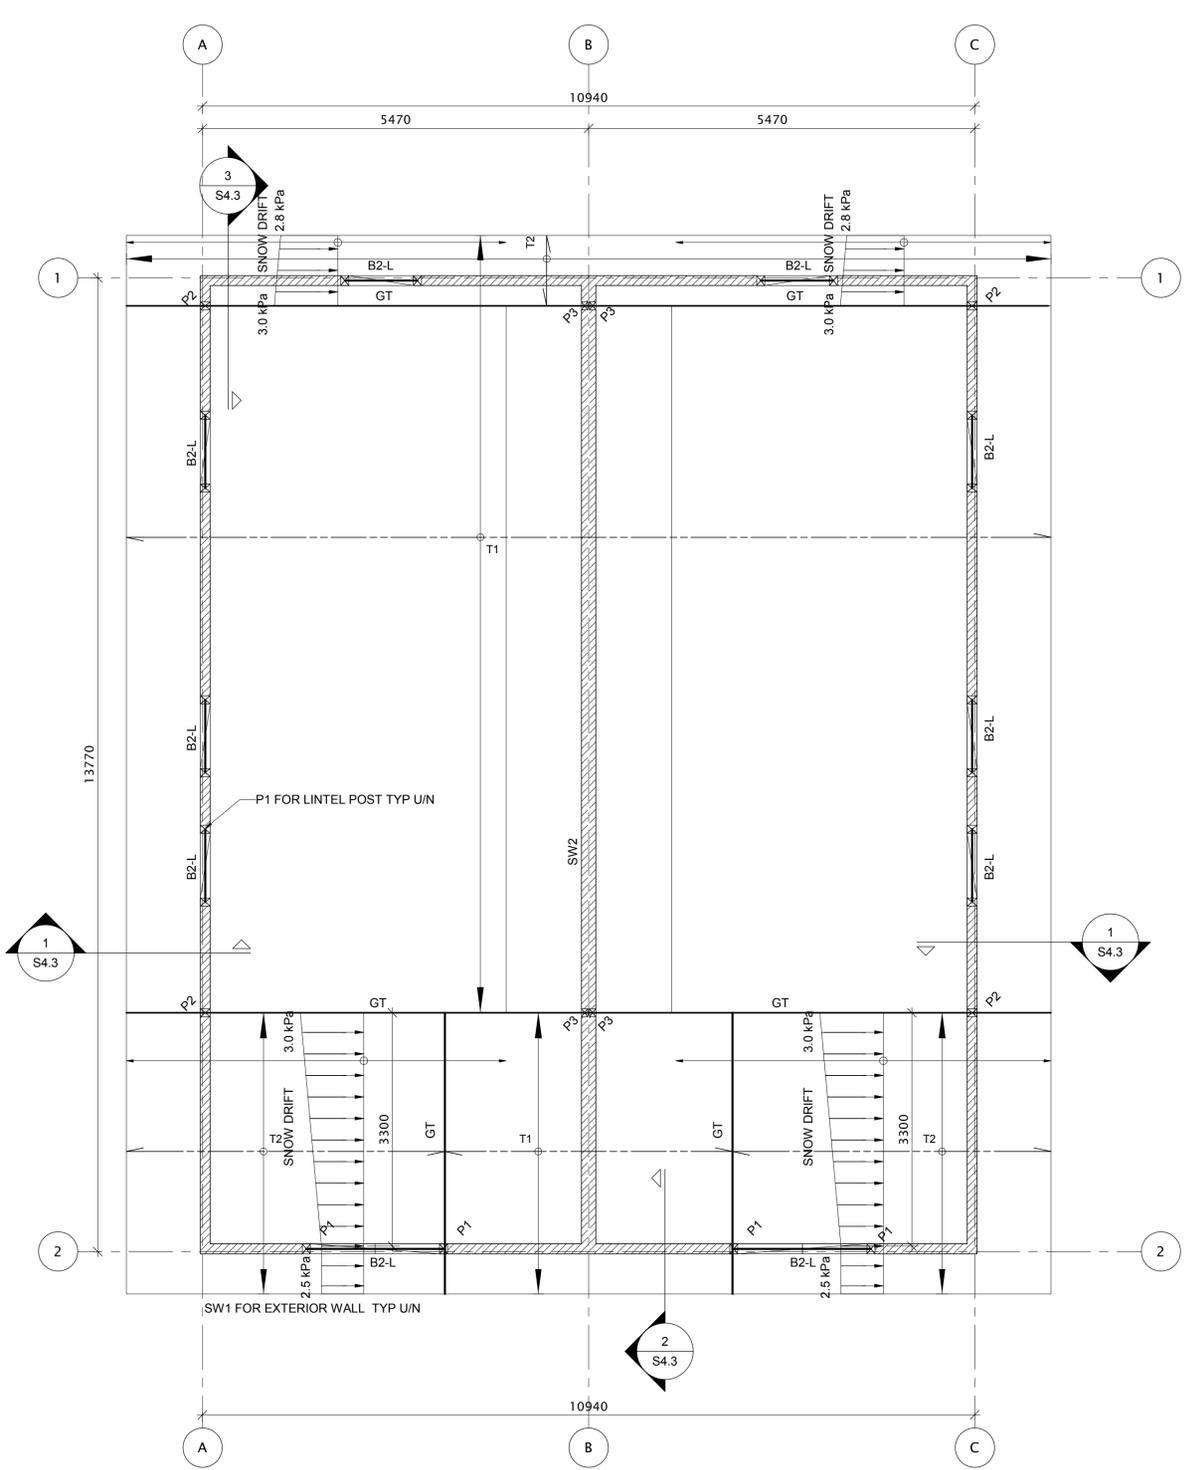

2 ROOF FRAMING PLAN  
S3.2 SCALE: 1:50

**ROOF DESIGN LOADS:**  
DEAD LOAD = 0.72 kPa  
SNOW LOAD = 2.5 kPa  
ROOF WIND UPLIFT LOAD  
SEE DETAIL

