


1
S3.2
2ND FLOOR FRAMING PLAN
SCALE: 1:50

FLOOR DESIGN LOADS:
DEAD LOAD = 0.72 kPa (SELF-WEIGHT)
= 0.72 kPa (DECK & BALCONY)
SUPERIMPOSED PARTITION LOAD = 0.5 kPa
SUPERIMPOSED COUNTERTOP LOAD = 1.0 kPa
(SEE ARCH FOR LOCATION)
SUPERIMPOSED BATHTUB LOAD = 0.5 kPa
(SEE ARCH FOR LOCATION)
LIVE LOAD = 1.9 kPa (INSIDE UNITS)
= 4.8 kPa (COMMON AREAS)
= 2.4 kPa (DECK & BALCONY)
CANOPY DESIGN LOADS:
DEAD LOAD = 0.72 kPa
SNOW LOAD = 2.5 kPa
NOTE:
JOIST SUPPLIER TO REVIEW MECHANICAL DWGS
AND COORDINATE ALL PENETRATION AS NECESSARY

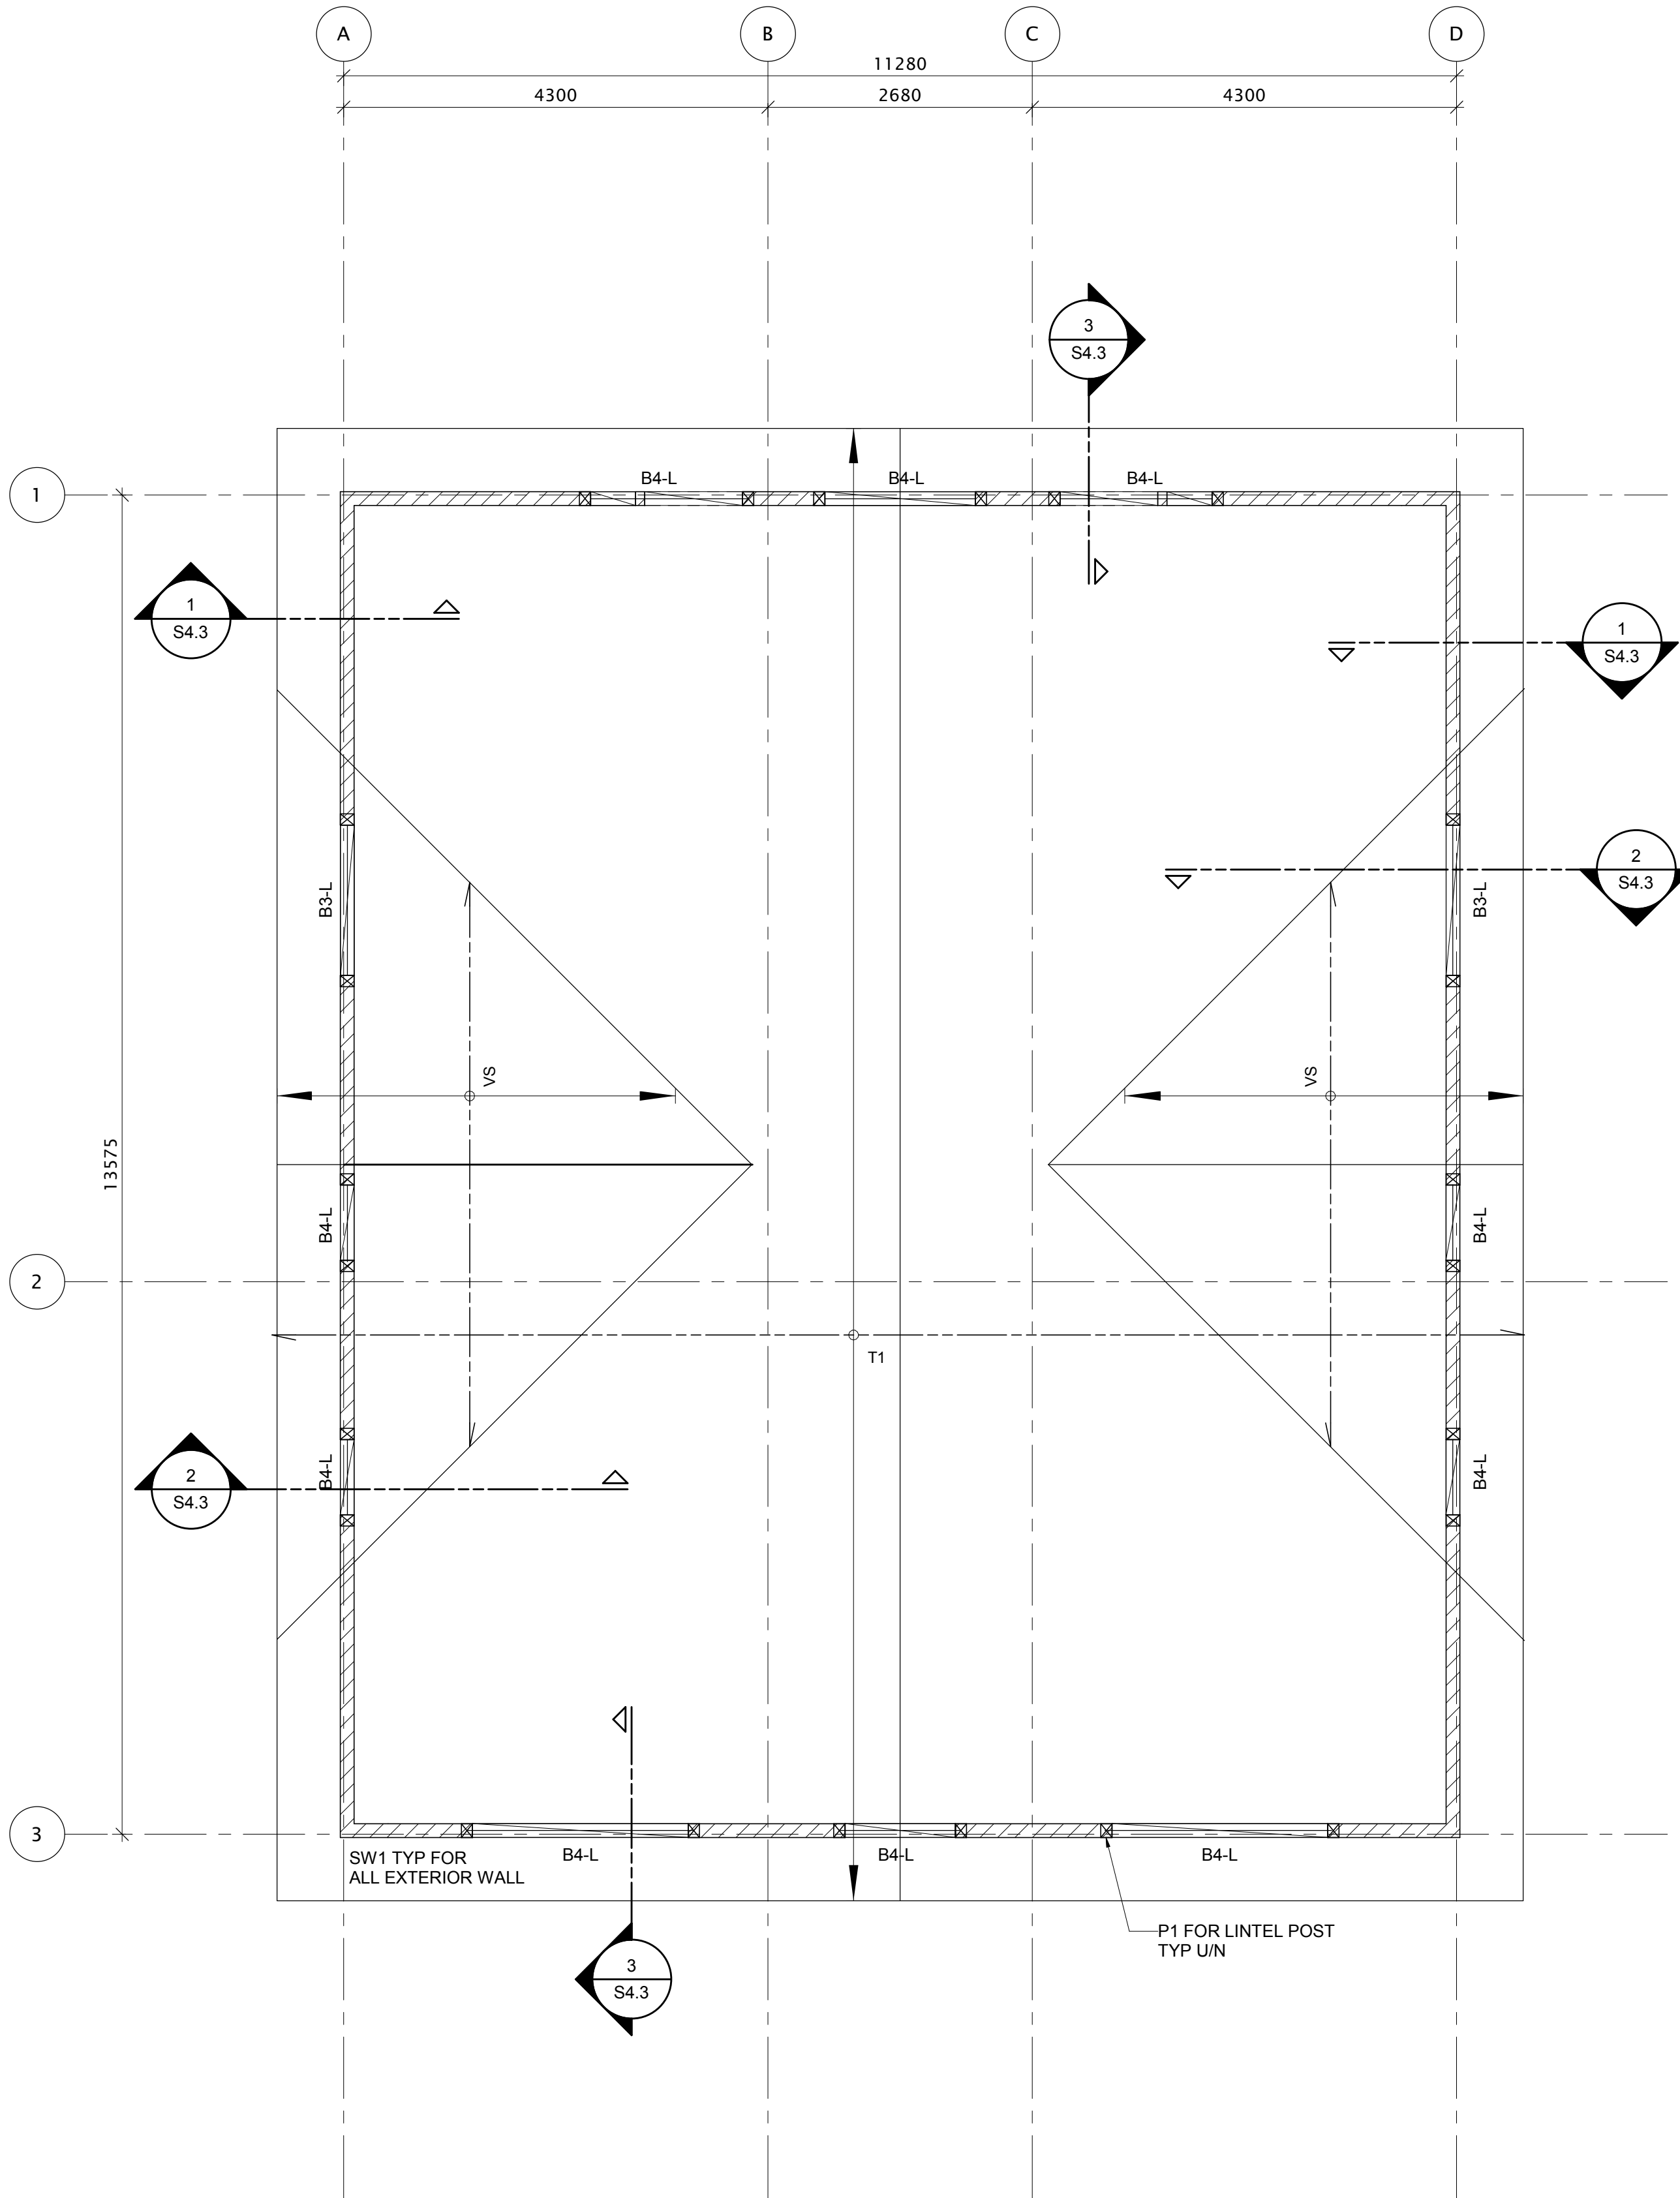


2
S3.2
ROOF FRAMING PLAN
SCALE: 1:50

ROOF DESIGN LOADS:

DEAD LOAD = 0.72 kPa
SNOW LOAD = 2.5 kPa


- ROOF UPLIFT LOAD SEE DETAIL
- TYP SNOW DRIFT LOAD ALONG ROOF VELLEY:

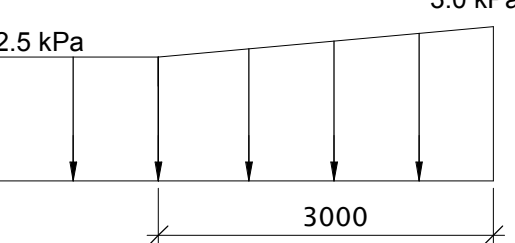

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Revision	Description	Date
5	ISSUED FOR CONSTRUCTION 2	2020/03/06
4	ISSUED FOR CONSTRUCTION	2019/10/29
3	ISSUED FOR 90% REVIEW	2019/08/29
2	ISSUED FOR 60% REVIEW	2019/05/09
1	ISSUED FOR 30% REVIEW	2019/03/14

Client: PSPC

PSPC
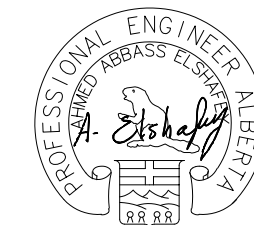
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EDMONTON, ALBERTA, T5J 1S6
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Project Title: JASPER STAFF HOUSING CONSTRUCTION

5 PLEX

902 PATRICIA STREET,
JASPER, AB, T0E 1E0

Designed by: H.Sun

Drawn by: D.Kuang

Approved by: A.Elshafey

Project Manager: ROB HAFER

Drawing Title: 2ND FLOOR & ROOF FRAMING PLAN

Project no./No. du projet: R.100429.001

Drawing no./No. du dessin: S3.2

Revision no.: 5

OF