


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Revision	Description	Date
5	ISSUED FOR CONSTRUCTION 2	2020/03/06
4	ISSUED FOR CONSTRUCTION	2019/10/29
3	ISSUED FOR 90% REVIEW	2019/08/29
2	ISSUED FOR 60% REVIEW	2019/05/09
1	ISSUED FOR 30% REVIEW	2018/03/14

Client		client
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PSPC

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Project Title: JASPER STAFF HOUSING CONSTRUCTION


5 PLEX

902 PATRICIA STREET
JASPER, AB, T0E 1E0
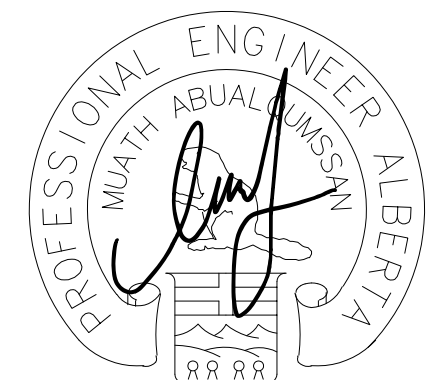
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Drawn by	Dessiné par
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Drawing Title	Titre du dessin

SECOND FLOOR HEATING PLAN

Project no./No. du projet	Drawing no./No. du dessin	Revision no.
R.100429.001	M4.2 OF	5

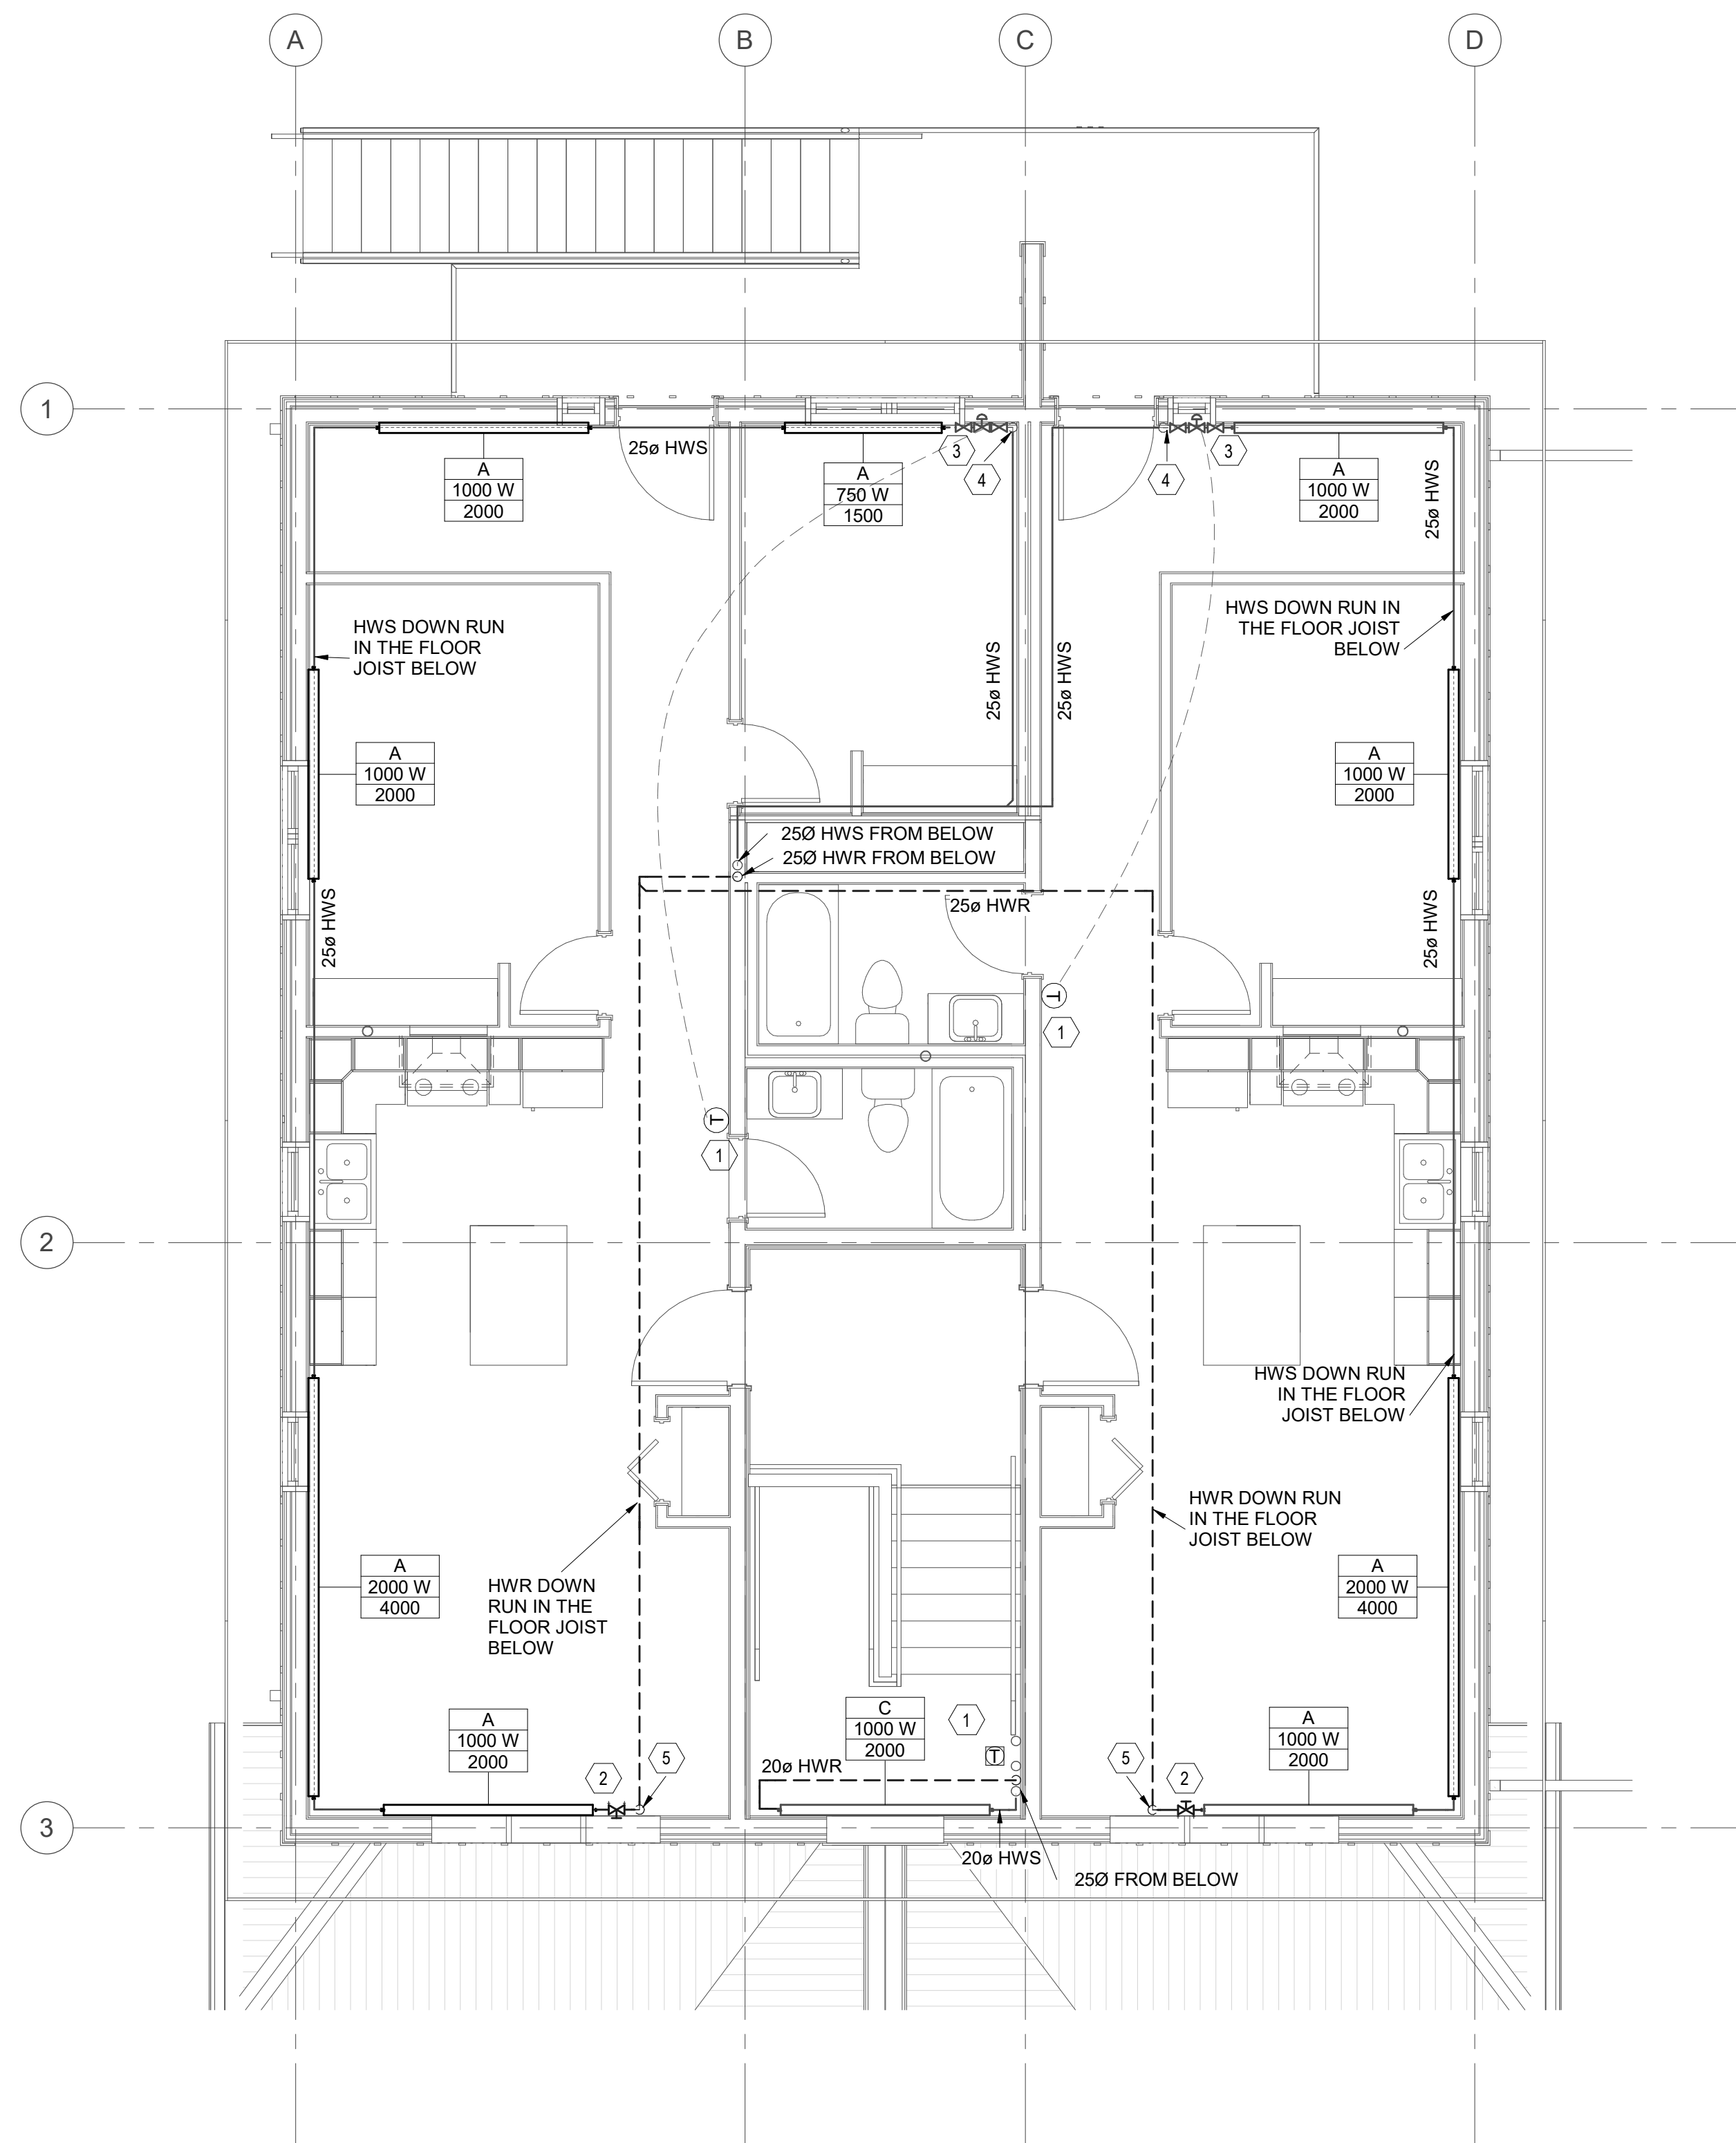

1
M4.2

SECOND LEVEL HEATING PLAN
SCALE: 1 : 50

GENERAL NOTES:

- ALL HWS AND HWR SHALL BE 20Ø OR OTHERWISE NOTED.
- PROVIDE RADIATION CABINET FOR HEATING PIPING AS INDICATED.
- AIR TRAP TO BE PROVIDED AS REQUIRED.
- CONTRACTOR TO COORDINATE WITH JOIST MANUFACTURER REGARDING THE LOCATION OF PIPE PENETRATION THROUGH THE JOIST PRIOR TO CONSTRUCTION.

KEYNOTES:

- MOUNT THERMOSTAT @ 1500 MM A.F.F. TYP. PROVIDE LOCKABLE COVER FOR THERMOSTATS IN PUBLIC AREA.
- CIRCUIT BALANCING VALVE AT 0.20L/S TO BE INSTALLED INSIDE THE BASEBOARD CABINET.
- CENTRAL VALVE AND ISOLATION VALVE TO BE INSTALLED INSIDE THE BASEBOARD CABINET.
- HWS UP FROM JOIST TO BASEBOARD CABINET.
- HWR DOWN RUN IN THE FLOOR JOIST BELOW.