

ALBERTA PERMIT TO PRACTICE
NUMBER-11944
03/06/2020

NORR

2300, 411 1st Street SE,
Calgary, Alberta, Canada T2G 4Y5
norr.com

NORR ARCHITECTS ENGINEERS PLANNERS
A Partnership of Limited Companies

Yvonne Smith, Architect, A.A.A., B.Arch., M.A.S.C.
Bruce McKenzie, Architect, A.A.A., B.Arch., M.A.S.C.
A. Shih Siddiqui, Architect, A.A.A., B.Arch., M.A.S.C.
Amin Toohidi, P.Eng., A.P.E.G.A.
Chris Pat, P.Eng., A.P.E.G.A.

6	ISSUED FOR CONSTRUCTION 2	2020-03-06
4	ISSUED FOR CONSTRUCTION	2019-10-29
3	95% CLIENT REVIEW	2019-08-29
2	66% CLIENT REVIEW	2019-05-09
1	33% CLIENT REVIEW	2019-03-14

Client: **PSPC**
10025 JASPER AVE
EDMONTON, AB, T5J 1S6
PH. 780-919-9445


Project Name: **JASPER STAFF HOUSING CONSTRUCTION**

5 PLEX
902 PATRICIA STREET
JASPER, AB, T0E 1E0

Designed by	Compu par
R.ALLEN	
Drawn by	Desiné par
F.HAK	
Approved by	Approuvé par
D.HIDER	
Project Manager / Administrateur de Projets	
ROB HAFER	
Drawing Title	Titre du dessin
ELECTRICAL SITE PLAN	

- GENERAL NOTES:**
- ALL UNDERGROUND UTILITY DUCTING TO BE RIGID PVC.
 - SECONDARY DUCTING AND CABLING FROM POLE MOUNTED TRANSFORMER TO PROPERTY LINE BY ATCO. SECONDARY DUCTING AND CABLING FROM PROPERTY LINE TO TO BUILDING METERING LOCATION BY ELECTRICAL CONTRACTOR.
 - REFER TO SINGLE LINE DIAGRAM ON DRAWING E3.0 FOR FEEDER QUANTITIES AND SIZES.

- REFFERAL NOTES:**
- EXISTING UTILITY POWER POLE.
 - APPROXIMATE LOCATION OF ELECTRICAL ROOM. REFER TO DRAWING E2.0 FOR CONTINUATION AND LAYOUT.
 - ELECTRICAL CONTRACTOR TO LOCATE SECONDARY STUB OUT AND CONTINUE CABLING AND CONDUIT TO BUILDING ELECTRICAL ROOM.
 - ELECTRICAL CONTRACTOR TO LOCATE TELUS AND SHAW STUB OUTS AND CONTINUE CONDUIT TO BUILDING ELECTRICAL ROOM. CONDUIT TO BE INSTALLED COMPLETE WITH PULL STRING. REFER TO DRAWING E3.0 FOR ADDITIONAL INFORMATION.
 - SECONDARY CONDUIT AND CABLING FROM POWER POLE TO PROPERTY LINE BY UTILITY.
 - COORDINATE LOCATION OF ALL STUB OUTS WITH UTILITY PRIOR TO INSTALLATION.
 - REFER TO DRAWING E2.1 FOR METERING LOCATION AND LAYOUT.

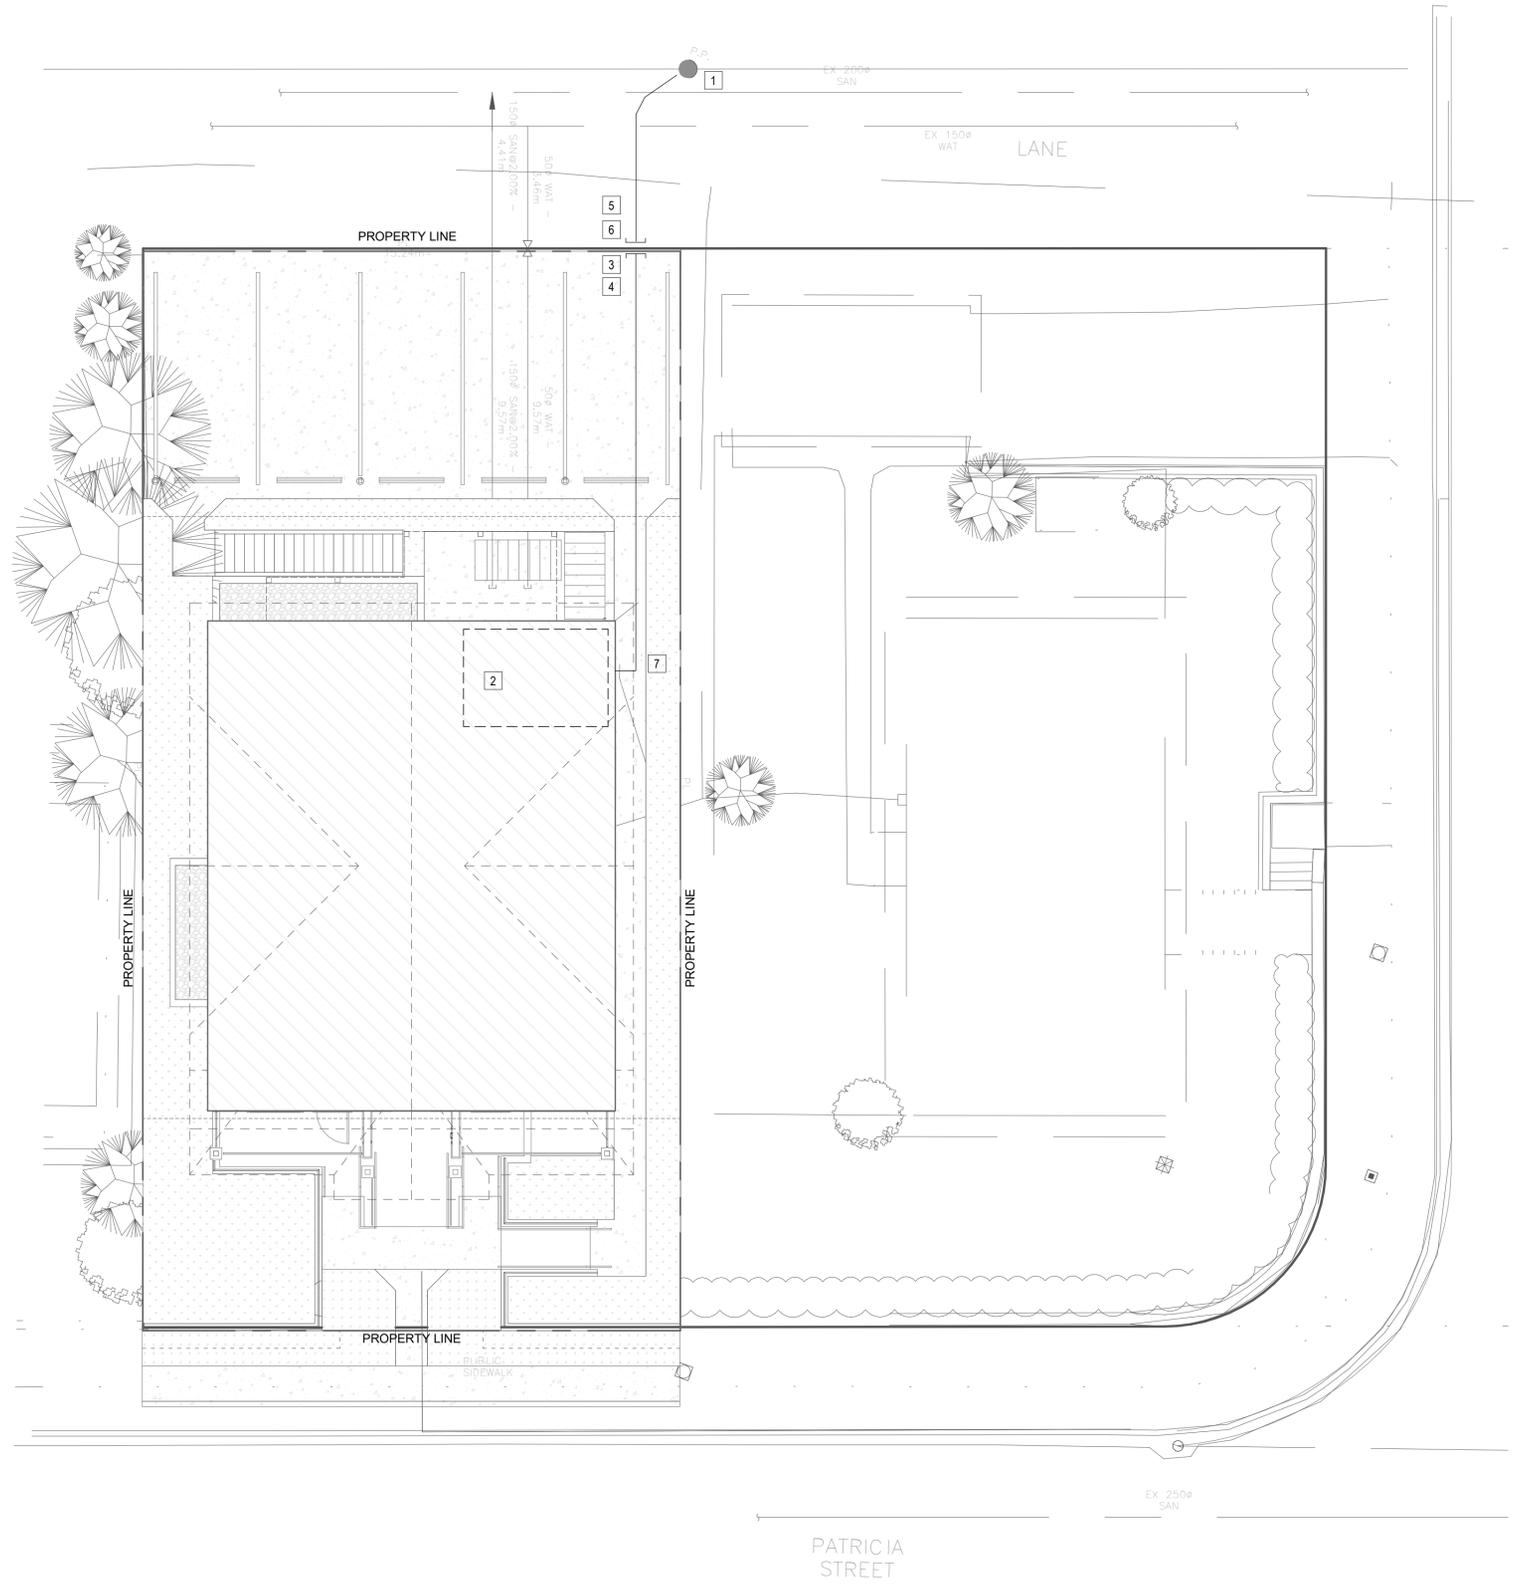

1 ELECTRICAL SITE PLAN
E1.1 SCALE: 1 : 100

