


1
S4.2
LEVEL 02 FRAMING PLAN
SCALE: 1:50

FLOOR DESIGN LOADS:

DEAD LOAD = 0.72 kPa (SELF-WEIGHT)
= 0.72 kPa (DECK & BALCONY)
SUPERIMPOSED PARTITION LOAD = 0.5 kPa
SUPERIMPOSED COUNTERTOP LOAD = 1.0 kPa
(SEE ARCH FOR LOCATION)
SUPERIMPOSED BATHTUB LOAD = 0.5 kPa
(SEE ARCH FOR LOCATION)
LIVE LOAD = 1.9 kPa (INSIDE UNITS)
= 4.8 kPa (COMMON AREAS)
= 2.4 kPa (DECK & BALCONY)

CANOPY DESIGN LOADS:
DEAD LOAD = 0.72 kPa
SNOW LOAD = 2.5 kPa


NOTE:
JOIST SUPPLIER TO REVIEW MECHANICAL DWGS
AND COORDINATE ALL PENETRATION AS NECESSARY

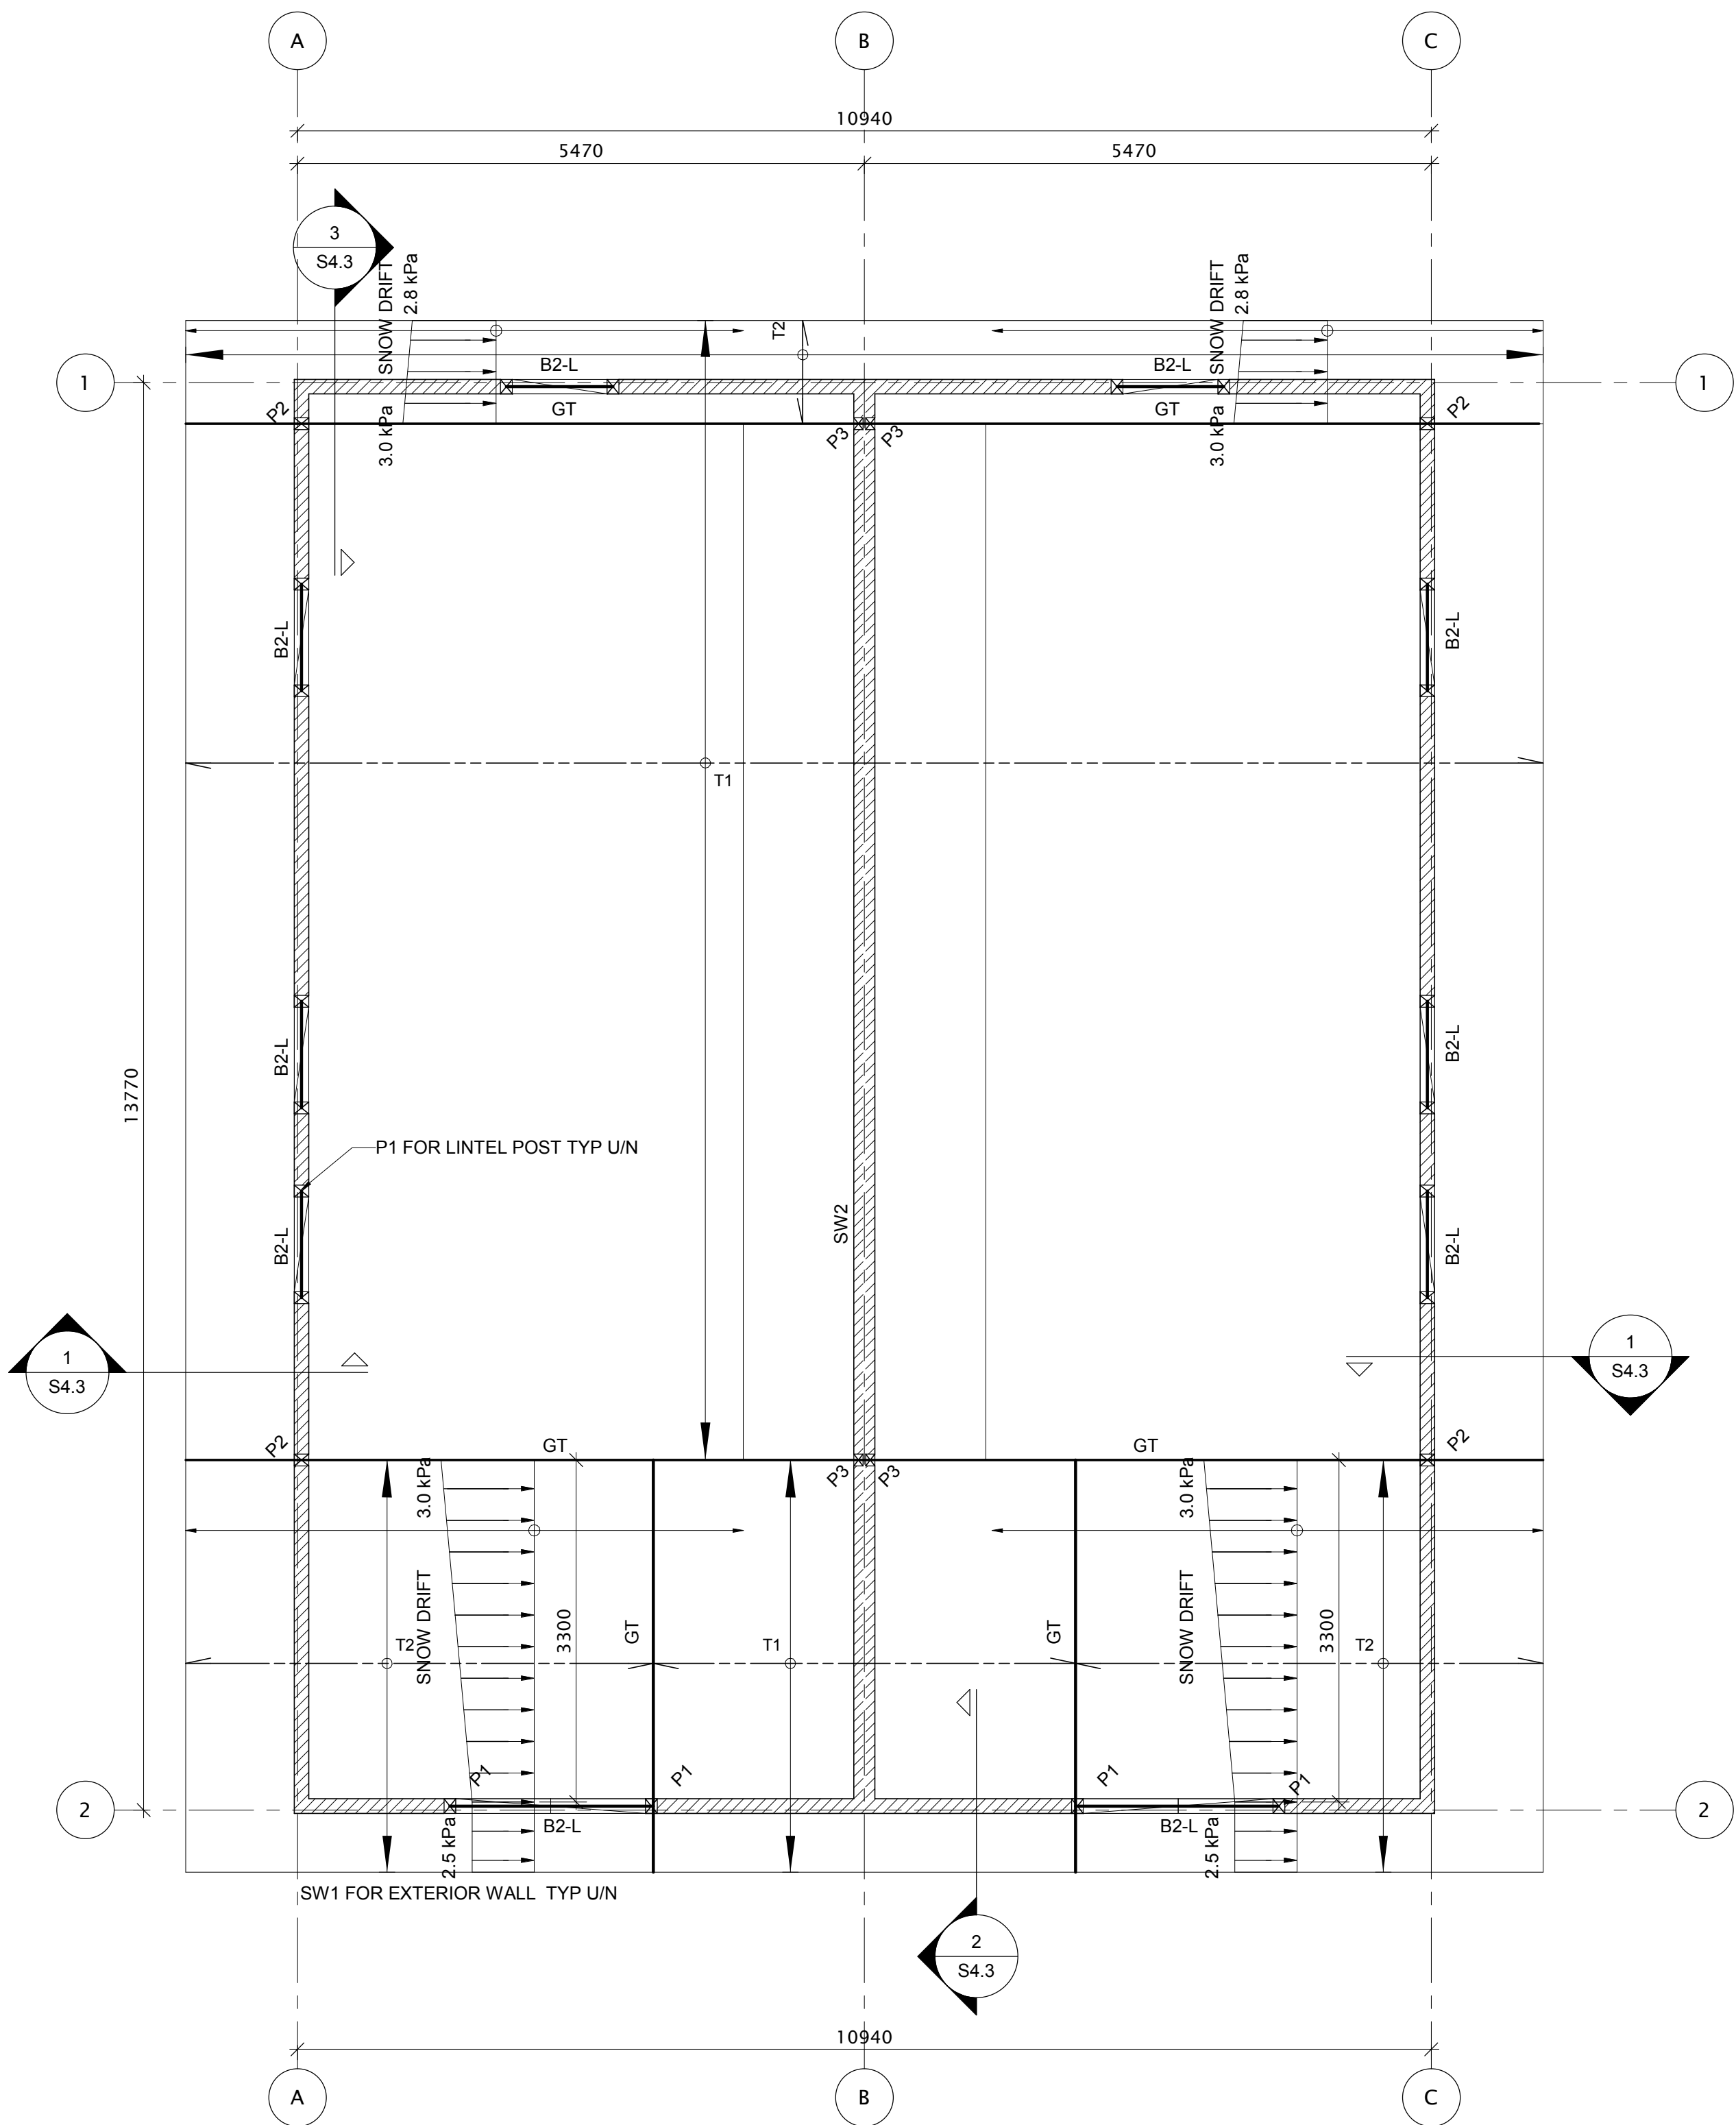

2
S4.3
ROOF FRAMING PLAN
SCALE: 1:50

ROOF DESIGN LOADS:

DEAD LOAD = 0.72 kPa
SNOW LOAD = 2.5 kPa
ROOF WIND UPLIFT LOAD
SEE DETAIL

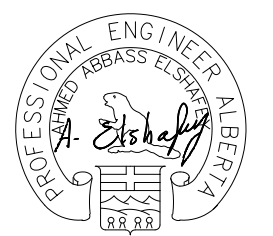

Revision	Description	Date
4	ISSUED FOR CONSTRUCTION	2020/03/06
3	ISSUED FOR 90% REVIEW	2019/08/29
2	ISSUED FOR 60% REVIEW	2019/05/09
1	ISSUED FOR 30% REVIEW	2019/03/14

Client

PSPC

10025 JASPER AVE
EDMONTON, ALBERTA, T5J 1S6
PH. 780-919-9445

Project title
JASPER STAFF HOUSING CONSTRUCTION

DUPLEX

720 PATRICIA STREET,
JASPER, AB, T0E 1E0

Designed by
H.Sun

Drawn by
D.Kuang

Approved by
A.Elshafey

Project Manager
ROB HAFER

Drawing Title
2ND FLOOR & ROOF FRAMING PLAN

Project no./No. du projet	Drawing no./No. du dessin	Revision no.
R. 100429.001	S3.2 OF	4