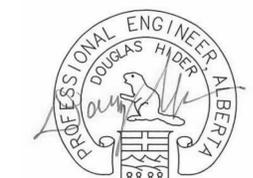


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Revised	Description	Date
5	ISSUED FOR CONSTRUCTION	2020-03-06
3	99% CLIENT REVIEW	2019-08-29
2	66% CLIENT REVIEW	2019-05-09
1	33% CLIENT REVIEW	2019-03-14

Client: PSPC

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Designed by: Designer

Drawn by: Author

Approved by: Approver

Project Manager / Administrateur de Projets: ROB HAFER

Drawing Title: ELECTRICAL SITE PLAN

**GENERAL NOTES:**

A. ALL UNDERGROUND UTILITY DUCTING TO BE RIGID PVC.

B. SECONDARY DUCTING AND CABLING FROM POLE MOUNTED TRANSFORMER TO PROPERTY LINE BY ATCO. SECONDARY DUCTING AND CABLING FROM PROPERTY LINE TO TO BUILDING METERING LOCATION BY ELECTRICAL CONTRACTOR.

C. REFER TO SINGLE LINE DIAGRAM ON DRAWING E3.0 FOR FEEDER QUANTITIES AND SIZES.

**REFFERAL NOTES:**

1 EXISTING UTILITY POWER POLE.

2 APPROXIMATE LOCATION OF ELECTRICAL ROOM. REFER TO DRAWING E2.0 FOR CONTINUATION AND LAYOUT.


3 ELECTRICAL CONTRACTOR TO LOCATE SECONDARY STUB OUT AND CONTINUE CABLING AND CONDUIT TO BUILDING ELECTRICAL ROOM.

4 ELECTRICAL CONTRACTOR TO LOCATE TELUS AND SHAW STUB OUTS AND CONTINUE CONDUIT TO BUILDING ELECTRICAL ROOM. CONDUIT TO BE INSTALLED COMPLETE WITH PULL STRING. REFER TO DRAWING E3.1 FOR ADDITIONAL INFORMATION.

5 SECONDARY CONDUIT AND CABLING FROM POWER POLE TO PROPERTY LINE BY UTILITY.

6 COORDINATE LOCATION OF ALL STUB OUTS WITH UTILITY PRIOR TO INSTALLATION.

7 REFER TO DRAWING E2.1 FOR METERING LOCATION AND LAYOUT.

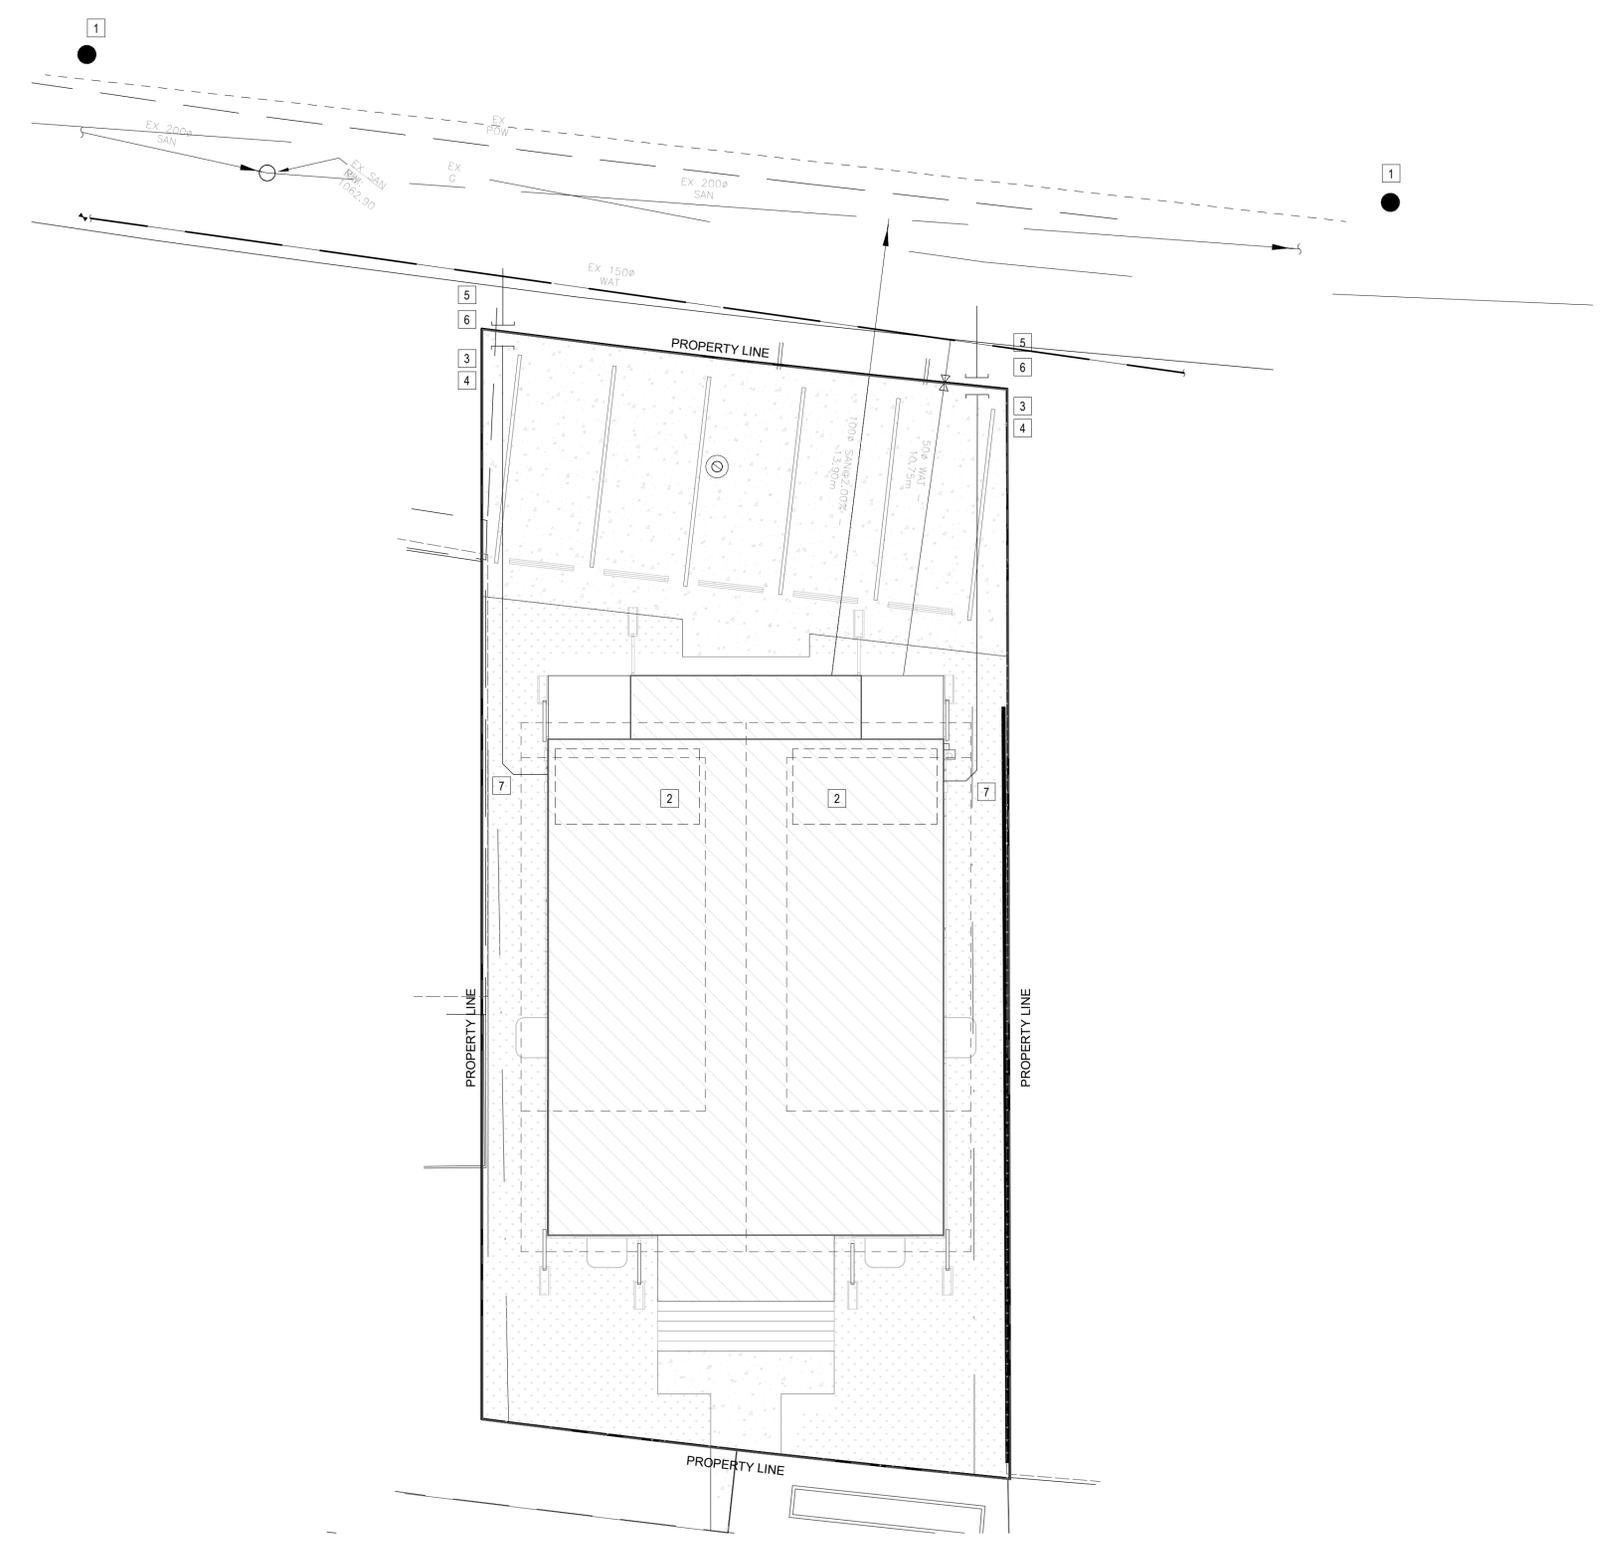

1 SITE PLAN  
SCALE: 1 : 100

