


1 FOUNDATION PLAN
SCALE: 1:50

FOOTING SCHEDULE

MARK	SIZE	REINF	MARK
SF1	600x200 DP	3-15 CONT BOTT	STRIP FOOTING
PF1	600x600x250 DP	3-15 EW BOTT	PAD FOOTING
GB1	200 x 1050 DP	2-15 T&B, 10@200 ES 10M TIES @ 300	GRADE BEAM
GB2	200 x 550 DP	2-15 T&B, 10@200 ES 10M TIES @ 300	GRADE BEAM

- NOTES:**
- FILL ANY SOIL VOIDS DUE TO BOLDERS REMOVAL BY LEAN CONCRETE UNLESS OTHERWISE RECOMMENDED BY GEOTECHNICAL ENGINEER.
 - REFER TO ARCHITECTURAL, MECHANICAL AND ELECTRICAL DRAWINGS FOR LOCATION AND SIZE OF DEPRESSIONS, HOUSEKEEPING PADS, TRENCHES, ETC.
 - REFER TO CIVIL, LANDSCAPING AND ARCHITECTURAL DRAWINGS FOR TOP OF RETAINING WALL AND LANDSCAPING WALL ELEVATION.
 - FOR GENERAL NOTES, REFER TO S1 DRAWING SERIES.
 - FOR TYPICAL DETAILS, REFER TO S2 DRAWING SERIES.

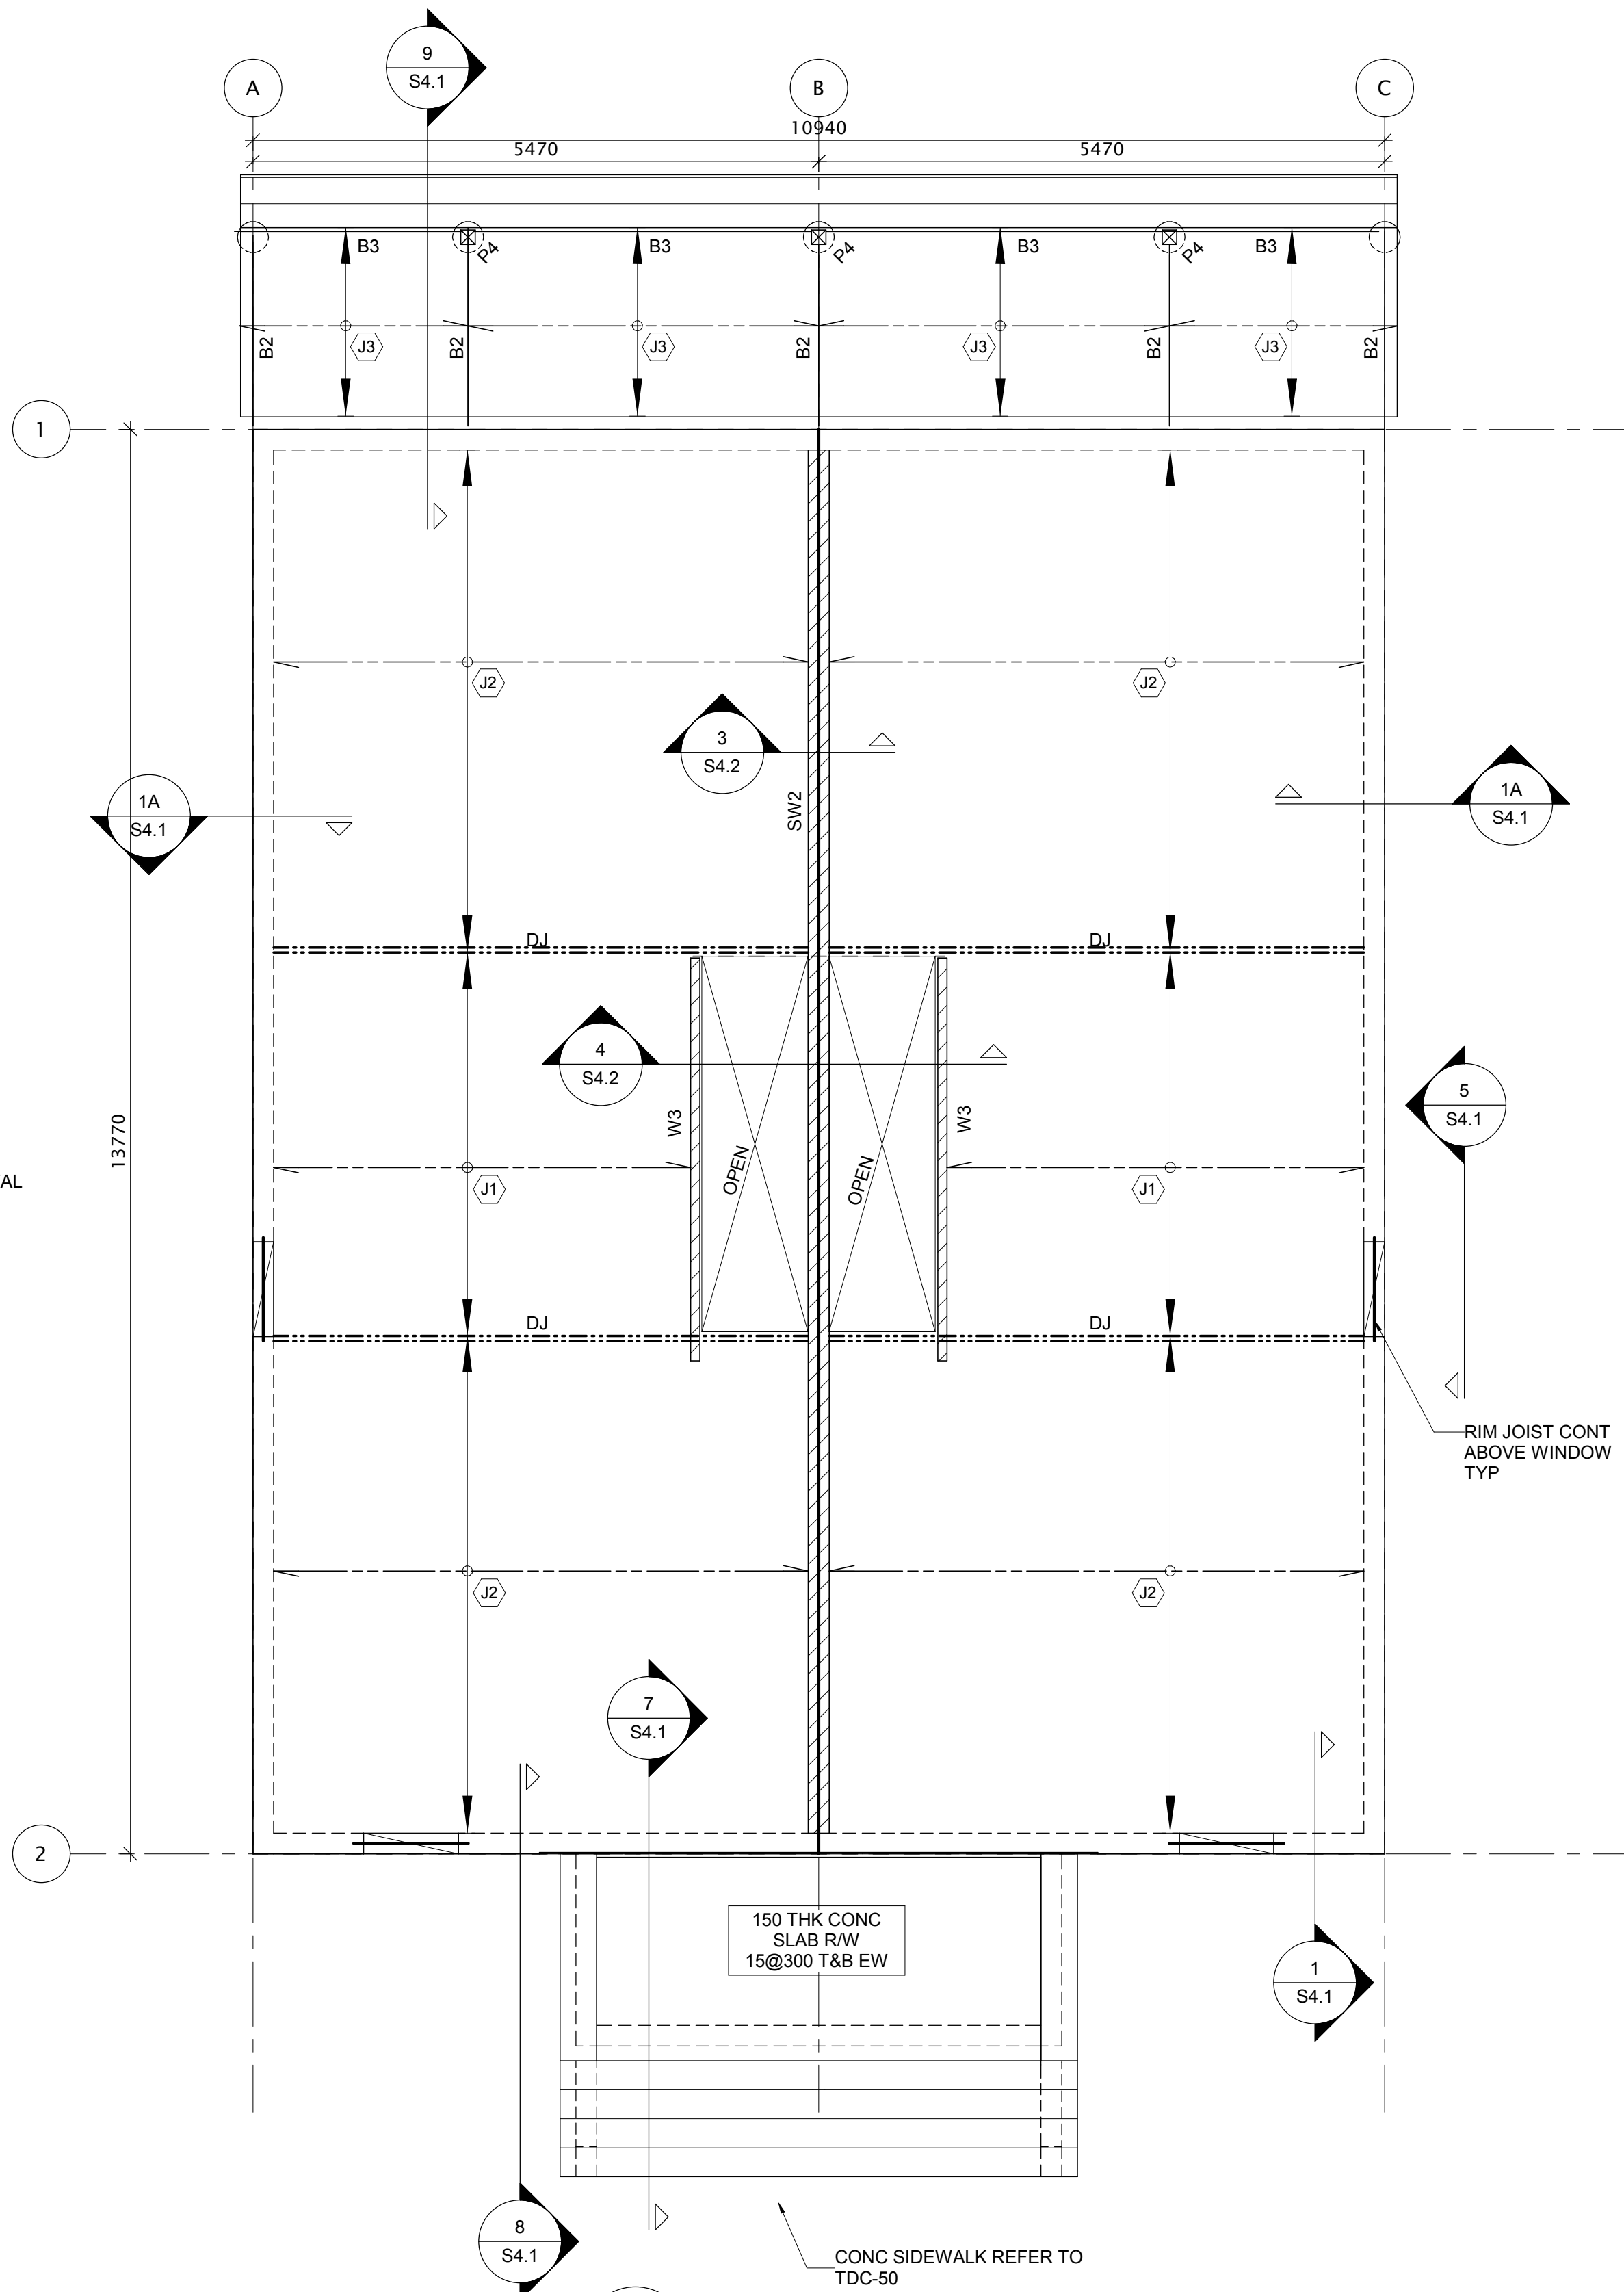

2 MAIN FLOOR FRAMING PLAN
SCALE: 1:50


FLOOR DESIGN LOADS:

DEAD LOAD = 0.72 kPa (SELF-WEIGHT)
= 0.72 kPa (DECK & BALCONY)
SUPERIMPOSED PARTITION LOAD = 0.5 kPa
SUPERIMPOSED COUNTERTOP LOAD = 1.0 kPa
(SEE ARCH FOR LOCATION)
SUPERIMPOSED BATHTUB LOAD = 0.5 kPa
(SEE ARCH FOR LOCATION)
LIVE LOAD = 1.9 kPa (INSIDE UNITS)
= 4.8 kPa (COMMON AREAS)
= 2.4 kPa (DECK & BALCONY)

CANOPY DESIGN LOADS:

DEAD LOAD = 0.72 kPa
SNOW LOAD = 2.5 kPa

NOTE:
JOIST SUPPLIER TO REVIEW MECHANICAL DWGS
AND COORDINATE ALL PENETRATION AS NECESSARY

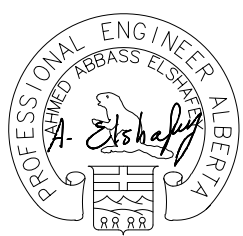

APEGA PERMIT TO PRACTICE NO.
11944
MAR. 06/2020

Revision	Description	Date
4	ISSUED FOR CONSTRUCTION	2020/03/06
3	ISSUED FOR 90% REVIEW	2019/08/29
2	ISSUED FOR 60% REVIEW	2019/05/09
1	ISSUED FOR 30% REVIEW	2019/03/14

Client

PSPC

10025 JASPER AVE
EDMONTON, ALBERTA, T5J 1S6
PH. 780-919-9445

Project title
JASPER STAFF HOUSING CONSTRUCTION

DUPLEX

720 PATRICIA STREET,
JASPER, AB, T0E 1E0

Designed by
H.Sun

Drawn by
D.Kuang

Approved by
A.Elshafey

Project Manager
ROB HAFER

Drawing Title
FOUNDATION & MAIN FLOOR FRAMING PLANS

Project no./no. du projet
R. 100429.001

Drawing no./no. du dessin
S3.1
OF

Revision no.
4