

NOTES:

1. ALL DIMENSIONS ARE IN MILLIMETRES UNLESS NOTED OTHERWISE.
2. ALL ELEVATIONS, COORDINATES AND STATIONING ARE IN METRES UNLESS NOTED OTHERWISE.
3. COORDINATES SHOWN IN DRAWINGS ARE BASED ON THE NAD83 UTM ZONE 14 COORDINATE SYSTEM.
4. ALL DIMENSIONS ARE TO BE VERIFIED IN THE FIELD BY THE CONTRACTOR.


wood.

Consultant's Name
Nom de l'expert-conseil

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Calgary, Alberta CANADA T2E 7T8
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Eng. Stamp
Sceau de l'ingénieur



DO NOT SCALE DRAWINGS

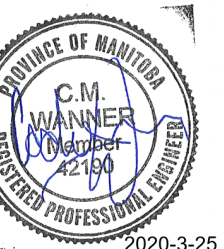5		
4		
3		
2		
1		
0	ISSUED FOR TENDER	2010/06
revisions	description	date

Client

**PUBLIC WORKS &
GOVERNMENT SERVICES
CANADA**

310 - 269 MAIN ST.
WINNIPEG, MANITOBA R3C 1B3

project title

**ST ANDREWS LOCK & DAM
625 RIVER ROAD
LOCKPORT, MANITOBA R1A 2R4
ST ANDREWS LOCK & DAM
STOPLOG FABRICATION
AND LOCK REPAIRS**

approved by

G. NORLANDER

designed by

C. WANNER

drawn by

S. BROWN

PWSSC Project Manager

B. JAIKARAN

PWSSC, Architectural and Engineering Resources Manager

R. MAY

Client

PUBLIC WORKS AND GOVERNMENT SERVICES CANADA

drawing title

**LOCK
PLAN AND PROFILE**

project no.

R.097505.001

sheet


C05

revision no.

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CONCRETE REPAIR QUANTITY ESTIMATES


REPAIR DESCRIPTION	UNIT	QUANTITY
FLOOR REPAIR	m ²	50
FLOOR CRACK FILLING	m	140
WALL REPAIR	m ²	30
WALL CRACK FILLING	m	60

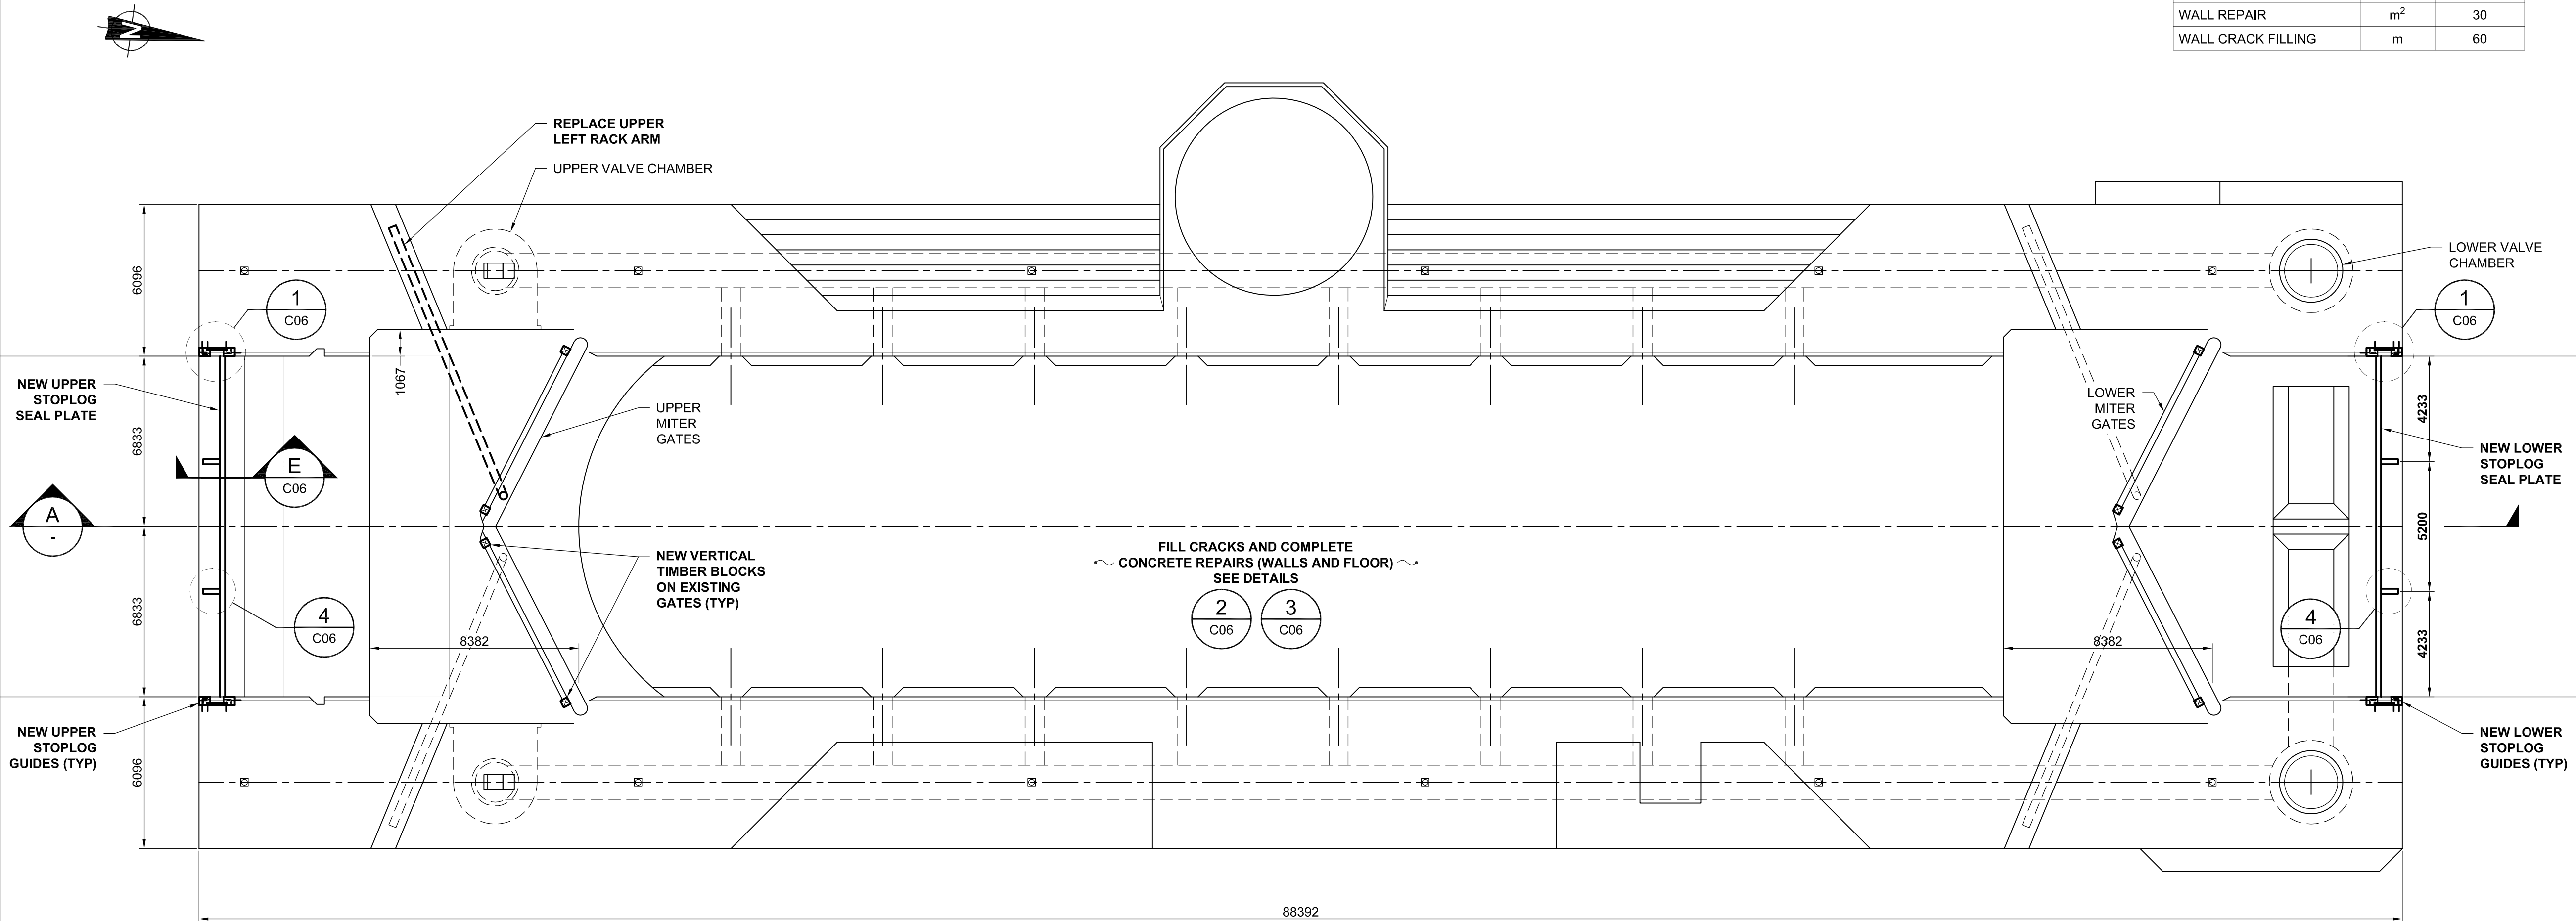

PLAN

LOCK CHAMBER

Scale 1:150

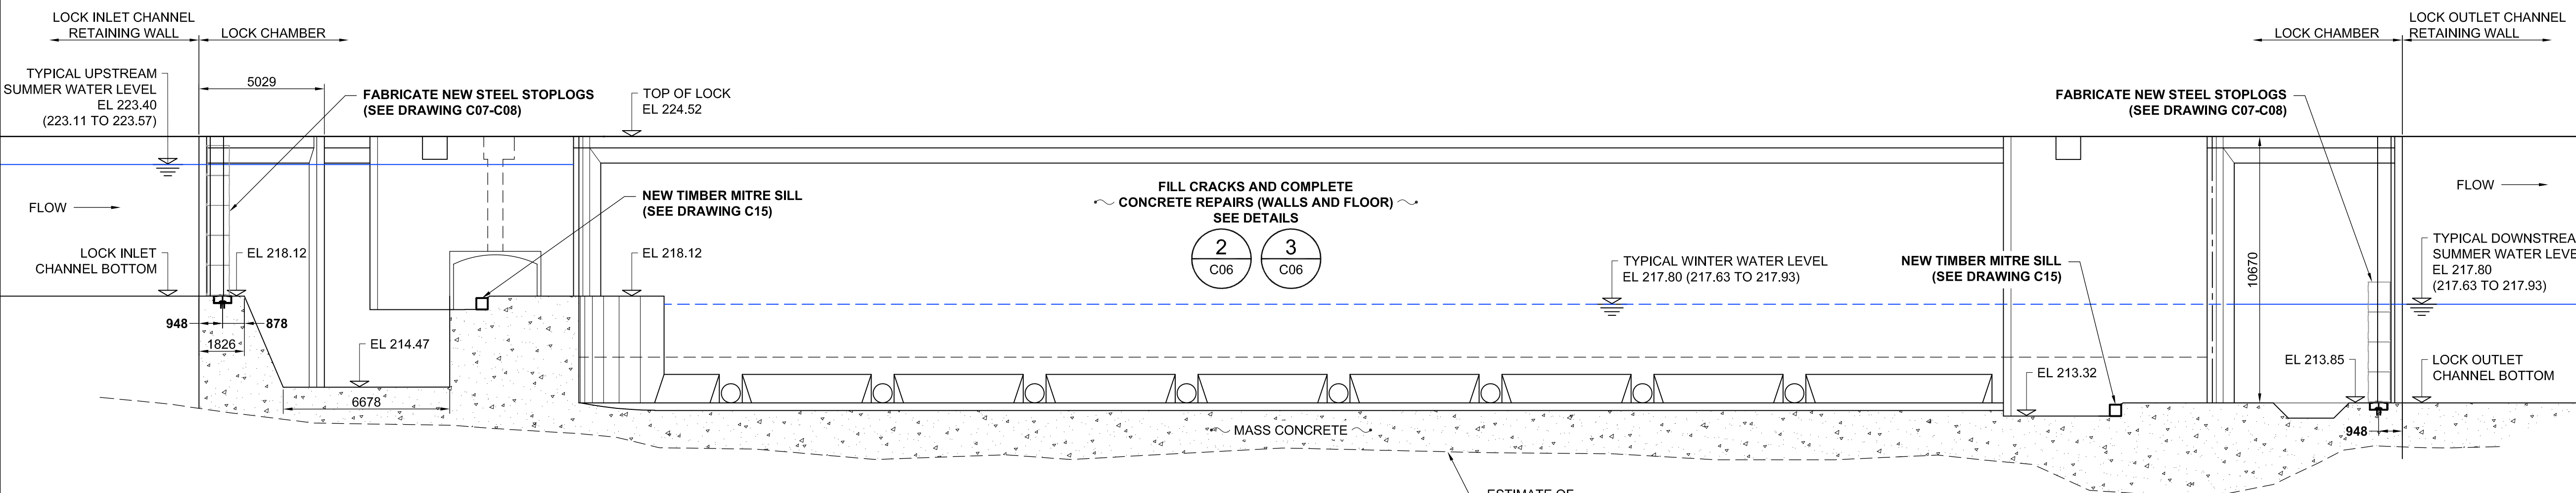

A
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SECTION

LOCK CHAMBER

Scale 1:150

