
DAVID FLORIDA LABORATORY

BUILDING 65, SHIRLEY'S BAY WATER MAIN SYSTEM UPGRADE

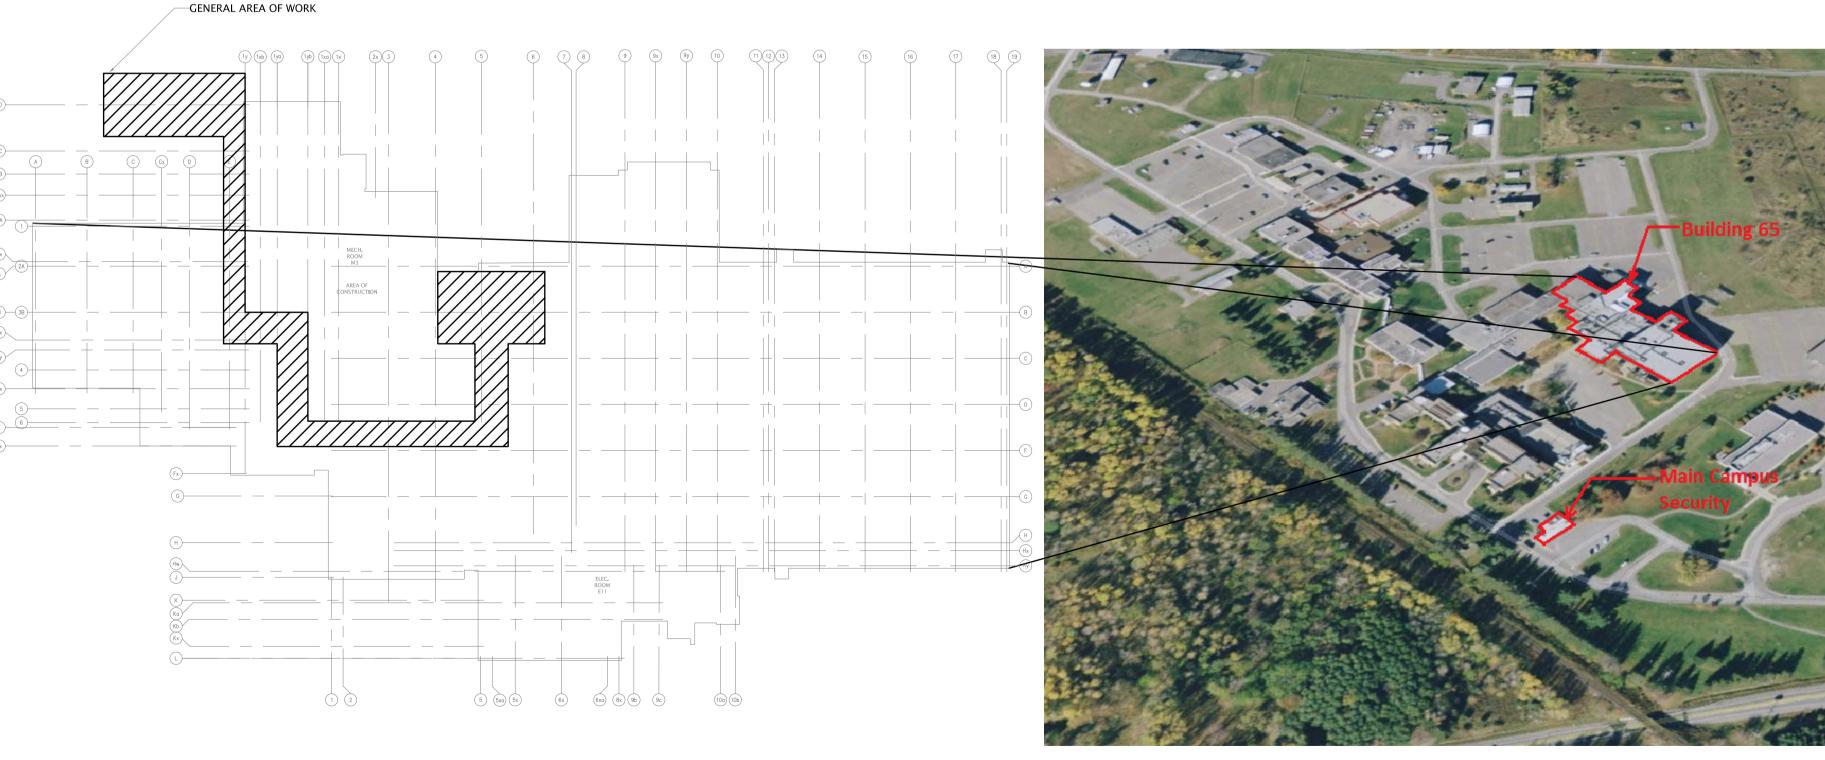




DRAWING LIST			
DRAWING	DESCRIPTION		
G1	DRAWING LIST, & SITE KEYPLAN		
MECHANICAL			
M1	MECHANICAL LEGENDS, GENERAL NOTES & PROCEDURES		
M2	MECHANICAL FIRE PROTECTION SCHEMATIC DEMOLITION		
М3	MECHANICAL FIRE PROTECTION SCHEMATIC NEW WORK		
M4	FIRE PROTECTION DEMOLITION & NEW WORK BASEMENT LEVEL PARTIAL PLAN		
ELECTRICAL			
El	ELECTRICAL LEGENDS, GENERAL NOTES & PROCEDURES, & SCHEDULES		
E2	POWER & SYSTEMS DEMOLITION & NEW WORK PARTIAL BASEMENT LEVEL PLAN		
E3	POWER & SYSTEMS NEW WORK GROUND LEVEL PARTIAL PLAN		
E4	ELECTRICAL DISTRIBUTION SINGLE LINE DIAGRAM NEW WORK		
E5	POWER & SYSTEMS BUILDING 89 REFERENCE PICTURES		

Canad Space

Agence spatial canadienne

ÉRIC VACHON
Director, Security & Facilities

M. FARID, P. Eng.

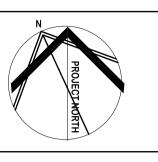

2019.12.02




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Contractor to verify all dimensions & conditions on site and immediately notify the engineer of all discrepancies.

08	Issued for Tender	2019.12.02
07	Re-Issued for Tender	2019.09.20
06	Re-Issued for Tender	2019.09.06
05	Re-Issued for Tender	2018.10.12
04	Issued for Tender	2018.08.17
03	Issued for Review	2017.12.08
02	Issued for ESA Review	2017.10.18
01	Issued for 90% Review	2017.07.28
revisions	description	date



no. du detail

B location drawing no. sur dessin no.

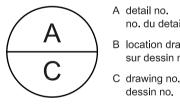C drawing no. dessin no.

oject

WATER MAIN SYSTEM UPGRADE

BUILDING 65, SHIRLEY'S BAY CAMPUS 3701 CARLING AVENUE, OTTAWA, ON ADDRESS

DRAWING LIST, & SITE KEYPLAN

Designed By	Conçu par
Date	(yyyy/mm/dd)
Drawn By	Dessiné par
Date	(yyyy/mm/dd)
Reviewed By	Examiné par
Date	(yyyy/mm/dd)
Approved By	Approuvé par
Date	(yyyy/mm/dd)
Tender	Soumission
Project Manager	Administrateur de projets

roject Manager Administrateur de projet Project no.

No. du projet CSA17-M1

Drawing no.

G 1 No. du dessin

1 SITE KEY PLAN
G1 Scale: 1:500

DFL PROJECTS GENERAL NOTES, & PROCEDURES:

INTENDED

- 1. THE MECHANICAL CONTRACTOR SHALL ACT AS THE PRIME CONTRACTOR. PRIME CONTRACTOR SHALL RETAIN ALL REQUIRED SUB-TRADES & COORDINATE & SCHEDULE ALL EFFORTS FOR PROJECT SCOPE OF WORK. HEREAFTER THE MECHANICAL CONTRACTOR SHALL BE REFERRED TO AS "CONTRACTOR".
- THE CONTRACTOR SHALL ARRANGE AND PAY FOR ALL NECESSARY PERMITS, INSPECTIONS & RE-INSPECTIONS REQUIRED TO BE PERFORMED BY LOCAL AUTHORITIES HAVING IURISDICTION INCLUDING INSPECTION AND TESTING EXCEPT FOR BUILDING PERMIT TO THE CITY OF OTTAWA WHICH WILL BE APPLIED FOR BY OWNER. TURN OVER TO THE OWNER ALL ORIGINAL APPROVAL DOCUMENTATION & CERTIFICATES.
- CONTRACTOR TO BE RESPONSIBLE FOR THE PROVISION (SUPPLY AND INSTALLATION) OF ALL MATERIALS, EQUIPMENT & SERVICES SHOWN ON THE PROJECT DRAWINGS & SPECIFICATIONS AS REQUIRED FOR A FULLY OPERABLE SYSTEM. UNLESS CHANGED OR REPLACED BY REVISED DRAWINGS, SPECIFICATIONS OR ADDENDA.
- THE CONTRACTOR SHALL BE RESPONSIBLE FOR ALL ARCHITECTURAL, STRUCTURAL, MECHANICAL. ELECTRICAL. PLUMBING & FIRE PROTECTION WORK. BE RESPONSIBLE FOR ALL FLOOR CUTTING. CORE DRILLING. ALL CHASES. OPENINGS AND PATCHING AS MAY BE REQUIRED BY ALL SUB TRADES WHO MAY OR MAY NOT BE UNDER HIS CONTRACT
- DRAWINGS ARE NOT INTENDED TO SHOW THE DETAILS & ROUTE OF EACH COMPONENT TO BE INSTALLED OR REMOVED. THEY ARE ONLY PROVIDING A GENERAL OVERVIEW OF THE PROJECT SCOPE. THE CONTRACTOR SHALL BE RESPONSIBLE TO REVIEW THE SITE CONDITIONS DURING THE TENDER PERIOD AND EXAMINE THE EXTENT OF THE DEMOLITION, REMOVALS & NEW INSTALLATIONS TO INCLUDE IN THE TENDER PRICE ALL NECESSARY LABOR AND MATERIAL REQUIRED FOR A FULLY OPERABLE SYSTEM AS
- ALL MATERIALS AND WORKMANSHIP SHALL BE IN ACCORDANCE WITH THE CURRENT CODES, BY-LAWS AND ORDINANCES OF THE RELEVANT BUILDING AUTHORITIES WHERE VARIED BY THE PROJECT SPEC.
- 7. ALL DIMENSIONS TO BE VERIFIED ON SITE. EXACT LOCATION & ELEVATION OF EQUIPMENT IS SUBJECT TO SITE MEASUREMENTS.
- 8. CONTRACTOR TO SUBMIT SHOP DRAWINGS FOR ALL MATERIAL, EQUIPMENT & FIXTURES TO DEPARTMENTAL REPRESENTATIVE FOR APPROVAL BEFORE COMMENCING INSTALLATION OR ORDERING. ALL SAMPLES TO BE PROVIDED UPON CSA REQUEST AT NO ADDITIONAL
- ALL SUPPLIED MATERIALS, FIXTURES & EQUIPMENT TO BE NEW, FREE FROM DEFECTS, CERTIFIED & APPROVED BY CODE. REUSE OF ANY EXISTING PARTS IN SOT PERMITTED UNLESS APPROVED BY OWNER
- 10. CSA SHALL BE GIVEN THE OPTION OF RETAINING ANY REMOVED COMPONENTS OR EQUIPMENT. COORDINATE AND HAND OVER TO CSA PROJECT MANAGER AS REQUIRED. DISPOSE OF ANY REMAINING OR UNWANTED EQUIPMENT OR SERVICES AND REMOVE OFF SITE IN A LEGAL MANNER AND COMPLY WITH THE ENVIRONMENTAL PROTECTION ACT ONTARIO REGULATIONS FOR WASTE MANAGEMENT PROGRAM. CERTIFICATE OF DISPOSAL TO BE HANDED OVER TO OWNER AFTER REMOVALS ARE DONE.
- 11. INSTALL ALL EQUIPMENT IN FULL ACCORDANCE WITH THE MANUFACTURER SPECIFICATIONS & RECOMMENDATIONS
- 12. ALL TRADES SHOULD BE LICENSED TO PERFORM ALL WORK SHOWN ON THE DRAWINGS INCLUDING REMOVALS & DEMOLITION.
- 13. DO NOT DAMAGE EXISTING FIRE SEPARATIONS AND FIRE PROTECTIONS IN THE PROJECT AREAS, ANY DAMAGES INCURRED TO EXISTING FIRE SEPARATIONS AND PROTECTIONS SHALL BE RESTORED TO APPROVED CONDITIONS TO MEET REQUIRED RATING AND CODES AT NO ADDITIONAL COSTS TO THE PROJECT.
- 14. UNDER ANY CIRCUMSTANCES, DO NOT BLOCK REQUIRED ACCESS TO EXITS AND FIRE ESCAPE ROUTES DURING THE PROJECT DURATION. ALL EXISTING LIFE SAFETY SYSTEMS AND INDICATORS SHALL BE OPERATIONAL AT ALL TIMES.
- 15. SMOKE EATERS & POWERED EXHAUST FANS VENTED TO OUTSIDE OF BUILDING MUST BE USED DURING ALL BRAZING / WELDING / SOLDERING / CUTTING / GRINDING ACTIVITIES TO MINIMIZE CONTAMINATION & ODOR TO ADIACENT AREAS PARTICULARLY IN CLEAN ROOMS. PROVIDE 72 HOUR NOTICE TO CSA TO ARRANGE FOR HOT WORK PERMITS.
- 16. CONTRACTOR TO PROTECT ALL ARCHITECTURAL FINISHES & FLOORING DURING CONSTRUCTION. BE RESPONSIBLE FOR ANY DAMAGES TO EXISTING SURFACES RESULTING FROM ALL PROJECT'S WORK. THE CONTRACTOR SHALL MAKE GOOD ALL DAMAGED SURFACES INCLUDING ANY PAINT TOUCH-UPS REQUIRED. REPAIR ALL WALLS, FLOORS & CEILINGS IN CORE AREA WHERE MECHANICAL & ELECTRICAL SERVICES PASS THROUGH.
- 17. EXACT TARPING LIMITS AND ACCESS ROUTES TO BE DETERMINED ON SITE IN COORDINATION WITH CSA PROJECT MANAGER
- 17.1. ALL TARPS TO BE NEW HEAVY DUTY POLYETHYLENE. WATER / MILDEW / TEAR RESISTANT, WHITE, TIGHT SEALED FROM DECK TO FLOOR, CONTRACTOR TO PROVIDE ACCESS ZIPPERS OR DOORS AS REQUIRED BY CSA, USE METAL STUDS AS FRAMING SUPPORTS, NO WOOD MATERIALS TO BE USED IN TARPS CONSTRUCTION UNLESS APPROVED BY CSA
- 17.2. APPROVED METHODS TO ATTACH STUDS / TARPS TO BUILDING AS FOLLOW: 17.2.1. ON FLOORS: HEAVY DUTY COMMERCIAL DOUBLE SIDED TAPE TO SECURE METAL STUDS TO FLOORS, USE OF SCREWS OR TAPCONS ARE NOT
- 17.2.2. ON DRYWALLS / MASONRY / METAL SIDING WALLS: DUCT OR TUCK TAPE IS NOT ALLOWED DIRECTLY ON BUILDING FINISHES AS IT WILL DAMAGE THEM WHEN REMOVED; APPLY MASKING PAINT GREEN TAPE FIRST AND THEN DUCT / TUCK TAPE ON TOP OF IT. STUDS CAN BE SCREWED TO DRYWALL / MASONRY WALLS GIVING THAT ALL HOLES WILL BE PATCHED & PAINTED (WHOLE WALL / AREA TO BE PAINTED, SMALL / LOCAL PAINT PATCHES ARE
- NOT PERMITTED). 17.3. TARPS COULD BE HANGED OFF BUILDING STEEL STRUCTURAL USING HIGH STRENGTH CABLE TIES, PROVIDE HEAVY GAUGE UNISTRUTS AS NEEDED FOR CROSS RUNS OR TO DISTRIBUTE TARPS LOAD.
- 17.4. HANGING TARPS FROM BUILDING SERVICES (DUCTWORK, CONDUITS, PIPES, SUPPORTS, HANGERS ... ETC.) IS NOT PERMITTED.
- 17.5. CONTRACTOR IS RESPONSIBLE FOR CLEANING, PATCHING, REPAIRING & PAINTING ALL DAMAGED SURFACES & TAPE MARKS AFTER REMOVING TARPS.
- 18. PROVIDE FLOOR PROTECTION TO ENTIRE PROJECT AREAS AS FOLLOW: 18.1. FLOOR TO BE WIPED CLEAN FROM ANY DEBRIS OR DUST PARTICLES. 18.2. PROVIDE MIN. 1/8" FOAM LAYER DIRECTLY ON ALL FLOORING.
- 18.3. PROVIDE HARD SHEETS ON TOP OF FOAM LAYER. ALL SHEETS SEAMS TO BE DUCT-TAPED TO PREVENT DEBRIS / DUST FROM GETTING TRAPPED UNDER THE PROTECTION SHEETS. USE OF OSB SHEETS IS NOT PERMITTED.
- 19. PROVIDE FURNITURE AND EQUIPMENT PROTECTION AS FOLLOW: 19.1. OFFICE / LAB FURNITURE AND EQUIPMENT: TO BE COMPLETELY COVERED AND WRAPPED WITH NEW HEAVY DUTY CLEAR PLASTIC ROLL SHEETS. 19.2. SENSITIVE LAB TESTING EQUIPMENT: TO BE COMPLETELY COVERED AND WRAPPED

WITH NEW HEAVY DUTY CLEAR PLASTIC ROLL SHEETS, CLEAN SCAFFOLDING TO BE ERECTED ON TOP OF ALL LAB EQUIPMENT TO PROTECT FROM POSSIBLE FALLING

- 20. CONTRACTOR TO PROVIDE BILINGUAL CONSTRUCTION, ACCESS & SAFETY SIGNAGE, SIGNS TO BE POSTED ON ALL PROJECT FENCES & ENTRANCES AT THE START OF PROJECT AND
- BEFORE COMMENCING ANY WORK. 21. ACCESS TO THE SITE FOR MATERIAL, WORK FORCES AND FOR WASTE REMOVAL IS TO BE COORDINATED WITH CSA PROJECT MANAGER, USE ONLY ELEVATORS DESIGNATED BY CSA

AND PROTECT THEM FROM DAMAGE.

NOT BE USED. KEEP FACILITIES CLEAN

EQUIPMENT AND LIFTS.

PWGSC A1 (841x594)

- 22. WHEN TESTING ACTIVITIES ARE NOT UNDERWAY, LARGE OR SMALL LOADING DOCKS CAN BE USED TO MOVE MATERIALS IN AND OUT OF THE BUILDING FROM 7:00 AM TO 8:00 AM WITHOUT CSA NEEDING TO PROVIDE NOTICE TO BUILDING STAFF. IF ACCESS IS REQUIRED AFTER THIS TIME OR FOR LONGER PERIODS, 72 HOUR NOTICE MUST BE PROVIDED TO CSA
- 23. SANITARY FACILITIES WILL BE ASSIGNED FOR CONTRACTOR'S PERSONNEL. OTHERS SHALL
- 24. ONLY DESIGNATED AREAS ARE TO BE USED FOR LUNCH AND BREAK TIME. ALL OTHER AREAS ARE OFF LIMITS INCLUDING CAMPUS CAFETERIA.

TO CONFIRM AVAILABILITY AND ARRANGE FOR PROPER NOTICES

- 25. CONTRACTOR TO RESPECT ALL BUILDING FLOOR LOADING LIMITATIONS, COORDINATE AND CONFIRM WITH CSA PROJECT MANAGER PRIOR TO BRING IN ANY HEAVY TOOLS,
- 26. CONTRACTOR SHALL BE RESPONSIBLE TO KEEP THE OWNER'S ACCESS AREAS AND CORRIDORS CLEAN AT ALL TIMES 26.1. CLEAN AND REMOVE ALL DEMOLITION AND CONSTRUCTION WASTE FROM PROJECT
- SITE ON DAILY BASIS AND UPON COMPLETION OF PROJECT. 26.2. DO NOT USE CSA WASTE CONTAINERS. AN AREA WILL BE DESIGNATED FOR
- LOCATING CONTRACTOR WASTERINS 26.3. CONTRACTOR TO PROVIDE ALL CLEANING EQUIPMENT & SUPPLIES, USE OF BUILDING CLEANING EQUIPMENT OR SUPPLIES ARE NOT PERMITTED.
- 27. DO NOT SUBJECT ANY PART OF THE BUILDING TO ANY NOISE, DUST OR ANY OTHER UNACCEPTABLE ENVIRONMENTAL CONDITIONS DURING THE COURSE OF THE PROJECT. ANY NOISY / DUSTY / SMELLY ACTIVITIES SHALL BE DONE AFTER REGULAR WORKING HOURS OR WEEKENDS, COORDINATE WITH CSA PROJECT MANAGER WITH A MINIMUM NOTICE OF 72 HOURS.
- 28. ALL PENETRATIONS THROUGH WALLS AND FLOORS SHALL BE SAW-CUT OR CORE DRILLED.

- JACK HAMMERING IS NOT PERMITTED. ALL WALLS, FLOORS & CEILINGS PENETRATIONS TO BE SEALED BY CONTRACTOR IN ACCORDANCE WITH APPLICABLE CODES & THE DEPARTMENTAL REPRESENTATIVE'S REQUIREMENTS.
- 29. PARTS NOTED TO BE SUPPLIED BY DEPARTMENTAL REPRESENTATIVE SHALL BE FULLY INSTALLED & SUPPORTED BY CONTRACTOR AT NO ADDITIONAL COST.
- 30. PROJECTS MAY TAKE PLACE IN A CLEANROOM ENVIRONMENT, MANDATING SPECIAL MEASURES BE TAKEN TO REDUCE LABORATORY DISRUPTION. CLASS 8 CLEANROOM STANDARDS ARE TO BE MET FOR THE AREA SURROUNDING CONSTRUCTION AT ALL TIMES

AND ARE SUBJECT TO VERIFICATION.

- 31. ALL PERSONNEL MUST ATTEND MANDATORY DFL BRIEFING ON THE FIRST DAY OF PROJECT AND BEFORE STARTING ANY WORK, ADHERE TO THE INFORMATION PRESENTED AT ALL TIMES. ANY PERSON WHO DID NOT ATTEND THIS BRIEFING WILL NOT BE ALLOWED TO WORK ON SITE - NO EXCEPTIONS
- 32. IMPROPER / UNCLEAN / RIPPED CLOTHING, FOUL LANGUAGE, IMPROPER BEHAVIOR, SMOKING IN UNDESIGNATED AREAS INCLUDING E-CIGARETTES WILL NOT BE TOLERATED AND WORKER WILL BE ESCORTED OFF CAMPUS IMMEDIATELY - NO EXCEPTIONS
- 33. CSA, AT THEIR DISCRETION, MAY REQUEST A WORKER TO LEAVE THE SITE IF THERE IS DEMONSTRATED IMPAIRED MENTAL OR PHYSICAL CAPABILITY AFFECTING HIS/HER WORK PERFORMANCE AND POSSIBLY PUTTING OTHERS AT RISK DUE TO CONSUMPTION OF ALCOHOL OR ILLEGAL SUBSTANCES.
- 34. DFL IS A HIGH PROFILE OCCUPIED BUILDING, USE OF MUSIC OR RADIO ON SITE IS NOT PERMITTED AT ALL TIMES.
- 35. ALL PRIME CONTRACTOR & SUB-TRADES WORKERS HAVE TO BE ESCORTED AT ALL TIMES
- WHILE IN BUILDING AND ON CAMPUS 35.1. CSA WILL PROVIDE SECURITY COMMISSIONAIRES TO ESCORT. 35.2. PRIOR TO PROJECT START, GC TO PROVIDE A FULL LIST OF ALL PERSONNEL
- WORKING ON THE PROJECT AS WELL AS DEPARTMENTAL REPRESENTATIVES, SUPPLIERS & INSPECTORS IF POSSIBLE TO ISSUE NECESSARY FORMS FOR SITE AND BUILDING ACCESS
- 35.3. PROVIDE AT LEAST 72 HOUR NOTICE FOR ANY ADDITIONAL NAMES OR FOR AFTER HOURS OR WEEKEND WORK. 35.4. NOTIFY CSA IMMEDIATELY OF ANY CHANGE IN SCHEDULE THAT AFFECTS THE NEED
- FOR SECURITY ESCORTS. 35.5. INDIVIDUALS WHO ARE NOT ON THAT LIST WILL BE DENIED ACCESS WITH NO **EXCEPTIONS**
- 36. CONTRACTOR REPRESENTATIVE HAS TO BE PRESENT ON SITE AT ALL TIMES AND ACCOMPANY ALL SUB-TRADE WORKERS: SUB-TRADES ARE NOT ALLOWED TO BE ON SITE OR TO WORK WITHOUT THE PRESENCE OF PRIME CONTRACTOR - NO EXCEPTIONS.
- 37. WEEKEND AND/OR AFTER-HOURS SHUTDOWNS TO BE SCHEDULED IN AGREEMENT WITH CSA PROJECT MANAGER. PROVIDE AT LEAST 72 HOURS NOTICE IN ADVANCE.
- 38 CSA IS COMMITTED TO ENSURING A HEALTHY AND SAFE ENVIRONMENT FOR ITS EMPLOYEES, CONTRACTORS AND VISITORS AND WILL ALIGN ITSELF WITH CONTRACTORS WHO SHARE IN THIS VISION.
- 38.1. THE REQUIREMENTS OUTLINED BELOW ARE PROVIDED AS REFERENCE AND ARE THERE TO ASSIST THE CONTRACTING COMPANY WHO PERFORMS THE WORK AND ACCEPTS THIS COMMITMENT COMPLETELY 38.1.1. ONTARIO OCCUPATIONAL HEALTH AND SAFETY ACT:
- HTTP://WWW.E-LAWS.GOV.ON.CA 38.1.2. INFRASTRUCTURE HEALTH AND SAFETY ASSOCIATION "GUIDE TO DEVELOPING HEALTH AND SAFETY POLICIES AND PROGRAMS IN CONSTRUCTION" A COMPREHENSIVE GUIDE GEARED TO MID- TO LARGE-SIZED GENERAL CONTRACTORS FOR DEVELOPING AND IMPLEMENTING AN
- EFFECTIVE HEALTH AND SAFETY PROGRAM: HTTP://WWW.IHSA.CA 38.1.3. INFRASTRUCTURE HEALTH AND SAFETY ASSOCIATION "CONSTRUCTION HEALTH AND SAFFTY MANUAL". GUIDANCE ON HAZARD CONTROLS FOR
- ONTARIO CONTRACTORS: HTTP://WWW.IHSA.CA 38.2. THE CONTRACTOR WILL BE REQUIRED TO PREPARE AND SUBMIT TO THE CSA PROJECT MANAGER A FULL PROJECT HEALTH AND SAFETY PLAN, HEREIN CALLED
- PHSP, PRIOR TO THE COMMENCEMENT OF ANY WORKS AND WITHIN 2 WEEKS OF CONTRACT AWARD 38.3. THE CONTRACTOR SHALL PROVIDE CSA PROJECT MANAGER A COPY OF ALL NOTICES OR OTHER WRITTEN CORRESPONDENCE PROVIDED TO OR RECEIVED BY THE
- ONTARIO MINISTRY OF LABOR, FOR THE DURATION OF THE CONTRACT. 38.4. THE CONTRACTOR SHALL FULLY IMPLEMENT THE PHSP FOR THE FULL DURATION OF
- THE CONTRACT 38.5. A COPY OF ALL APPLICABLE TRAINING CERTIFICATES MUST BE PROVIDED PRIOR TO COMMENCING ANY WORK. CERTIFICATES MUST SHOW EXACT COMPANY NAME AND ADDRESS THAT PROVIDED THE TRAINING. CSA RESERVES THE RIGHT TO REQUEST THE COURSE OUTLINE FROM THE COMPANY THAT PROVIDED THE TRAINING. IF THE PROOF OF TRAINING DOFS NOT DEMONSTRATE THE WORKER AS BEING COMPETENT OPERATORS, FURTHER TRAINING MAY BE REQUESTED BY THE CSA PRIOR TO COMMENCING ANY WORK AT NO ADDITIONAL COST.
- 39. CONTRACTOR TO PROVIDE A MINIMUM OF 48 HOUR NOTICE TO CSA PRIOR FOR ANY DELIVERIES, GENERAL CONTRACTOR MUST BE ON SITE TO RECEIVE THE SHIPMENT, IF THE DELIVERY PERTAINS TO LIFTING FOLIPMENT. THE QUALIFIED CONTRACTOR SCHEDULED TO USE THE EQUIPMENT MUST INSPECT AND RECEIVE THE LIFT FROM THE COMPANY.
- 40. CONTRACTOR AND ALL HIS SUB-TRADES ARE RESPONSIBLE TO PROVIDE ALL LADDERS, SCAFFOLDING. LIFTS. CRANES AND ALL OTHER EQUIPMENT & TOOLS REQUIRED FOR PROIECT SCOPE INCLUDING INSTALLING & REMOVING TARPS & PROTECTION MATERIALS. USE OF BUILDING TOOLS, EQUIPMENT, TROLLIES, FORKLIFTS, SKIDS, LADDERS, LIFTS, CRANES ... ETC. ARE NOT PERMITTED.

ZONE 1: • ELECTRIC EMT CONDUITS (POWER, CONTROLS, FIREETC.) • DRAINS & WELDED MECHANICAL PIPING W/ MINIMUM POSSIBLE LEAKAGE	ZONE 1	1	T.	L	-	CEILING STRUCTURI OWSJ
ZONE 2: SUPPLY / RETURN DUCTWORK EXHAUST DUCTWORK	ZONE 2	7			2	
ZONE 3: • MECHANICAL PIPING (CHWS/R, HWS/R, DCW, DHW, CAETC.)	ZONE 3					
ZONE 4:	ZONE 4					
 COMMUNICATION TRAYS (NETWORK, FIBER OPTICSETC.) 	ZONE 5				-	SUSPENDEI CEILING
ZONE 5:						
 CLEAR MAINTENANCE & HEAD ROOM 						

ZONE - MINIMUM OF 8"

BUILDING STANDARDS - SERVICES ELEVA	mone		
ZONE 1:			
 ELECTRIC EMT CONDUITS (POWER, CONTROLS, FIREETC.) 			CEILIN
 DRAINS & WELDED MECHANICAL PIPING w/ MINIMUM POSSIBLE LEAKAGE 	ZONE 1		ROP
ZONE 2:	ZONE 2		
SUPPLY / RETURN DUCTWORKEXHAUST DUCTWORK	ZONE Z	2	
ZONE 3:	ZONE 3		
 MECHANICAL PIPING (CHWS/R, HWS/R, DCW, DHW, CAETC.) 	ZONE 3		
ZONE 4:	ZONE 4		
 COMMUNICATION TRAYS (NETWORK, FIBER OPTICSETC.) 	ZONE 5		SUSP
ZONE 5:			
 CLEAR MAINTENANCE & HEAD ROOM 			

BUILDING STANDARDS - SERVICES ELEVATIONS

42. CONTRACTOR AND ALL TRADES TO FOLLOW ALL CAMPUS & CSA/DFL PROCEDURES AT ALL TIMES, CONTRACTOR IS RESPONSIBLE TO DISTRIBUTE ALL PROCEDURES TO ALL HIS

WORKERS & SUB-TRADES. MECHANICAL GENERAL NOTES:

ZONE - MINIMUM OF 8"

- 1. ALL MATERIALS AND WORKMANSHIP SHALL AS A MINIMUM BE IN ACCORDANCE WITH
- THE LATEST EDITION OF THE FOLLOWING:
- NATIONAL BUILDING CODE ONTARIO BUILDING CODE (OBC)
- CAN / CGA B149.1 & .2,
- ONTARIO PLUMBING & FIRE CODES ALL OTHER APPLICABLE PROVINCIAL, MUNICIPAL AND SAFETY CODES AND REGULATIONS.
- 2. CONFIRM ALL PIPING / DUCTWORK DIMENSIONS AND ELEVATIONS ON SITE PRIOR TO INSTALLATION OR ORDERING EQUIPMENT.
- 3. CONTRACTOR TO ARRANGE FOR ALL NECESSARY HOT WORK PERMITS, ALLOW FOR 72 HOURS NOTICE AT LEAST FOR CSA TO ISSUE.
- 4. BE RESPONSIBLE FOR REMOVAL AND REINSTATING CEILINGS AS NECESSARY. USE GLOVES
- TO PROTECT FROM FINGER PRINTS.
- 5. ALL BUILDING HVAC RETURN / EXHAUST GRILLS WITHIN CONSTRUCTION AREA MUST BE

- PROTECTED & FILTERED AT ALL TIMES DURING CONSTRUCTION. PROVIDE DUST SEALS OR TEMPORARY FILTERS ON ALL SUPPLY DIFFUSERS. DO NOT OPERATE HVAC UNTIL FINAL
- 6. USE OF TIE WRAPS, TIE WIRE, PERFORATED BAND, WIRE CHAIN OR SOLID RING TYPE HANGERS IS NOT PERMITTED
- 7. USE OF C-CLAMPS ON STEEL BEAMS IS NOT PERMITTED, USE BEAM CLAMP TO SUPPORT ALL
- . SEVERAL SYSTEMS OR PART OF SYSTEMS WILL BE SUBJECT TO A SHUT-DOWN PERIOD. BE RESPONSIBLE FOR HAVING ALL NECESSARY TOOLS, MANPOWER AND EQUIPMENT REQUIRED TO MAXIMIZE THE PRODUCTION DURING A SHUT-DOWN. ALL SHUT DOWNS SHALL BE COORDINATED WITH THE OWNER REPRESENTATIVES AND THE DEPARTMENTAL REPRESENTATIVE WITH A 72 HOURS WRITTEN NOTICE
- 9. VERIFY THE EXACT LOCATION OF EXISTING SERVICES AND MAINS TO BE TYING-IN, REMOVED OR CAPPED PRIOR TO COMMENCING WORK
- 10. USE FLAT BOTTOM DUCT TRANSITION PIECES FOR EFFECTIVE DRAINAGE.

THREADED RODS FROM ALL BEAMS AND OWSI.

- 11. ALL DUCT WORK AND SHEET METAL SHALL BE IN ACCORDANCE WITH S.M.A.C.N.A. LOW
- 12. SEAL ALL LONGITUDINAL AND CIRCUMFERENCE DUCT JOINTS WITH HIGH VELOCITY DUCT SEALER. "DURO DYNE" OR APPROVED EQUAL.
- 13. AS A MINIMUM PROVIDE 25mm THICK, HEAVY DENSITY, FIBERGLASS INSULATION WITH VAPOR BARRIER AND JACKETING ON ALL PLUMBING PIPING. INSULATE THE LAST 10 FEET FROM OUTSIDE OF ALL EXHAUST & FRESH AIR INTAKE DUCTWORK WITH 40mm FIBERGLASS WRAP. ALL INSULATION JOINTS TO BE STAGGERED. PROVIDE REMOVABLE INSULATION JOINTS AT ALL VALVES & UNIONS.
- 14. ALL EXPOSED JACKETING TO BE 0.016" ALUMINUM, PEBBLED (STUCCO) FINISH.
- 15. PROVIDE 300mm INSULATION PROTECTION GALVANIZED SHIELD / SADDLE PLATES WITH LOCK TABS AT EACH PIPE HANGER LOCATION.
- 16. ALL PIPING TO BE PRESSURE TESTED FOR A MINIMUM OF 24 HOURS AND IN ACCORDANCE WITH THE CODE REQUIREMENTS, DO NOT CONCEAL OR INSULATE ANY PIPING UNTIL
- 17. PROVIDE FIRE DAMPERS ON ALL DUCTS OR AIR TRANSFER OPENINGS PENETRATING A **BUILDING FIRE SEPARATION**

TESTED & REVIEWED BY DEPARTMENTAL REPRESENTATIVE

- 18. FLEXIBLE DUCTS SHALL BE LIMITED TO A MAXIMUM LENGTH OF 6 FEET AND MINIMUM DIAMETER OF 150mm
- 19. ALL HVAC CONTROLS AND WIRING SHALL BE SIZED, SELECTED BY A SPECIALIZED CONTROLS SUB-TRADE IN FULL ACCORDANCE WITH EQUIPMENT MANUFACTURER
- 20. ISOLATE COPPER PIPE FROM HANGER OR OTHER PIPING WHERE ELECTROLYTIC ACTION
- 21. VENT AND PRIME ALL P-TRAP FIXTURES IN ACCORDANCE WITH THE ONTARIO LATEST EDITION PLUMBING CODE. USE AUTOMATIC PRIMERS "ANCON" OR "ZURN" AT ALL NEW & EXISTING FLOOR DRAINS. ALL FIXTURES VENTS TO BE CONNECTED TO BUILDING COMMON
- 22. APPROVED PLUMBING ACCESSORIES & VALVES: ANCON, ZURN, WATTS & CRANE.
- 23. ALL DRAINAGE AND VENT PIPING TO BE CAST IRON WITH MI JOINTS OR DWV COPPER AS RATED BY MANUFACTURERS FOR RETURN AIR PLENUM USE AND APPROVED BY CODE.
- 24. ALL PLUMBING PIPING SHALL BE TYPE "L" NEW COPPER WITH LEAD FREE SOLDERED JOINTS.
- USE ONLY STRAIGHT COPPER RUNS, COPPER COILS OF ANY SIZE ARE NOT PERMITTED.
- 25. ALL TEMPERATURE & PRESSURE GAUGES TO BE 125mm DIAL SIZE, STAINLESS STEEL & GLYCERIN FILL. USE THERMO WELLS ON ALL TEMPERATURE GAUGES.
- 26. USE VMC KORFUND MAXI-FLEX NEOPRENE MOUNTING FLOOR PADS ON ALL HEAVY EQUIPMENT TO ISOLATE VIBRATION & PROTECT FLOORING. GRADE / COLOR TO MACH
- 27. USE ARMSTRONG CBV FOR ALL CIRCUIT BALANCING VALVES.

ELECTROPLATED.

- 28. CONTRACTOR TO PROVIDE FULL DRAWINGS. SKETCHES & SPECIFICATIONS FOR ALL PROPOSED SERVICES SUPPORTS. ANCHORS & HANGERS UNDER THIS PROJECT SCOPE FOR PROJECT MANAGER APPROVAL BEFORE COMMENCING ANY WORK.
- 29. CONTRACTOR TO SUPPORT ALL SERVICES SHOWN ON PROJECT SCOPE FROM BUILDING STRUCTURAL MEMBERS, SUPPORT ALL MECHANICAL PIPING USING CLEVIS HANGERS AT ADEQUATE SPACING TO INSURE NO SAG OR FAILURE OF IQINTS, ADEQUATELY BRACE PIPING AND ALLOW FOR EXPANSION OR CONTRACTION PROVIDE EXPANSION LOOPS OR JOINTS SIZED TO COMPENSATE FOR CHANGES IN PIPE LENGTH CAUSED BY A TEMPERATURE DIFFERENTIAL OF 65°C FOR TYPICAL BUILDING SYSTEMS AND 200°C FOR LAB SPECIAL SYSTEMS. ALL SUPPORTS & HANGERS TO BE HOT DIPPED GALVANIZED OR ZINC
- 30. CONTRACTOR TO PROVIDE FULL SYSTEM OF SUPPORTS AND HANGERS COMPLETE WITH ALL NECESSARY BRACKETS, BASE PLATES, INSERTS, FASTENERS, RODS AND ALL OTHER ACCESSORIES IN ACCORDANCE WITH MSS SP-58 AND TO MATCH EXISTING BUILDING SUPPORTS. ALL SUPPORTS & HANGERS TO BE E. MYATT, ITT GRINNELL OR APPROVED
- 31. CONTRACTOR TO TEMPORARILY SUPPORT ALL REMAINING PIPING LEFT AFTER DEMOLITION OR MODIFICATION UNTIL NEW PIPING & BRANCHES ARE TIED IN & INSTALLED AND FINAL PERMANENT SUPPORTS ARE IN PLACE
- 32. LABEL ALL PIPING, EQUIPMENT & DUCTWORK WITH REFERENCE TO THEIR SERVICE AND LOCATION. USE W.H.BRADY LABELS STYLE, B-946 VINYL FILM, 50mm WIDE. MATCH BUILDING IDENTIFICATION / LABELING SYSTEM AS FOLLOW:
- 32.1. WHITE LETTERS & ARROWS ON GREEN TAPE 32 1 1 CHILLED WATER SUPPLY & RETURN 32.1.2. DRAINAGE, SANITARY, STORM & VENTS

32.1.3. HVAC SUPPLY & RETURN, EXHAUST AIR & FRESH AIR INTAKE DUCTWORK

32.2. BLACK LETTERS & ARROWS ON YELLOW TAPE: 32.2.1. HEATING WATER SUPPLY & RETURN 32.2.2. STEAM PIPING

MECHANICAL LEGEND

SYMBOL	DESCRIPTION
	EXISTING PIPING/DUCTWORK/EQUIPMENT
	EXISTING PIPING/DUCTWORK/EQUIPMENT
	TO BE REMOVED NEW/RELOCATED PIPING/DUCTWORK/EQUIPMENT
(E)	DENOTES EXISTING EQUIPMENT
(X)	DENOTES EXISTING EQUIPMENT TO BE REMOVED
(N)	DENOTES NEW EQUIPMENT
NG	NATURAL GAS PIPING
 ⇒	PIPING DOWN
 >	PIPING OFFSET
- 3	BRANCH PIPING DOWN
]	CAP
5	PIPE BREAK
ιδι	BALL VALVE
$\bowtie 3$	ISOLATION VALVE
	DOUBLE CHECK VALVE
DHÎ HÎ HD Ÿ BFP	BACK FLOW PREVENTER
	PUMP
	CONDENSATE PUMP
FS	FLOW SWITCH
SV	SUPERVISORY VALVE
FD ⊜	FLOOR DRAIN
RV ≨	RELIEF VALVE
Ç PG	PRESSURE GAUGE
, ×	EXPANSION TANK

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PROJECTMORTH	J. D. ALEXANDER S. 100081054 2019.09.20 TOWNOE OF ONT PRIO
)	ProEng CONSULTING INC. Building and Energy Engineers Unit 101-399 Bayrose Dr, Ottawa, ON, Canada, K2J 5R5 T: 613-843-0065

Agence spatiale

ÉRIC VACHON

Director, Security & Facilities

M. FA

Project Man

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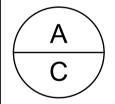
07	Re-Issued for Tender	2019.09.20
06	Re-Issued for Tender	2019.09.06
05	Re-Issued for Tender	2018.10.12
04	Issued for Tender	2018.08.17
03	Issued for Review	2017.12.08
02	Issued for ESA Review	2017.10.18
01	Issued for 90% Review	2017.07.28
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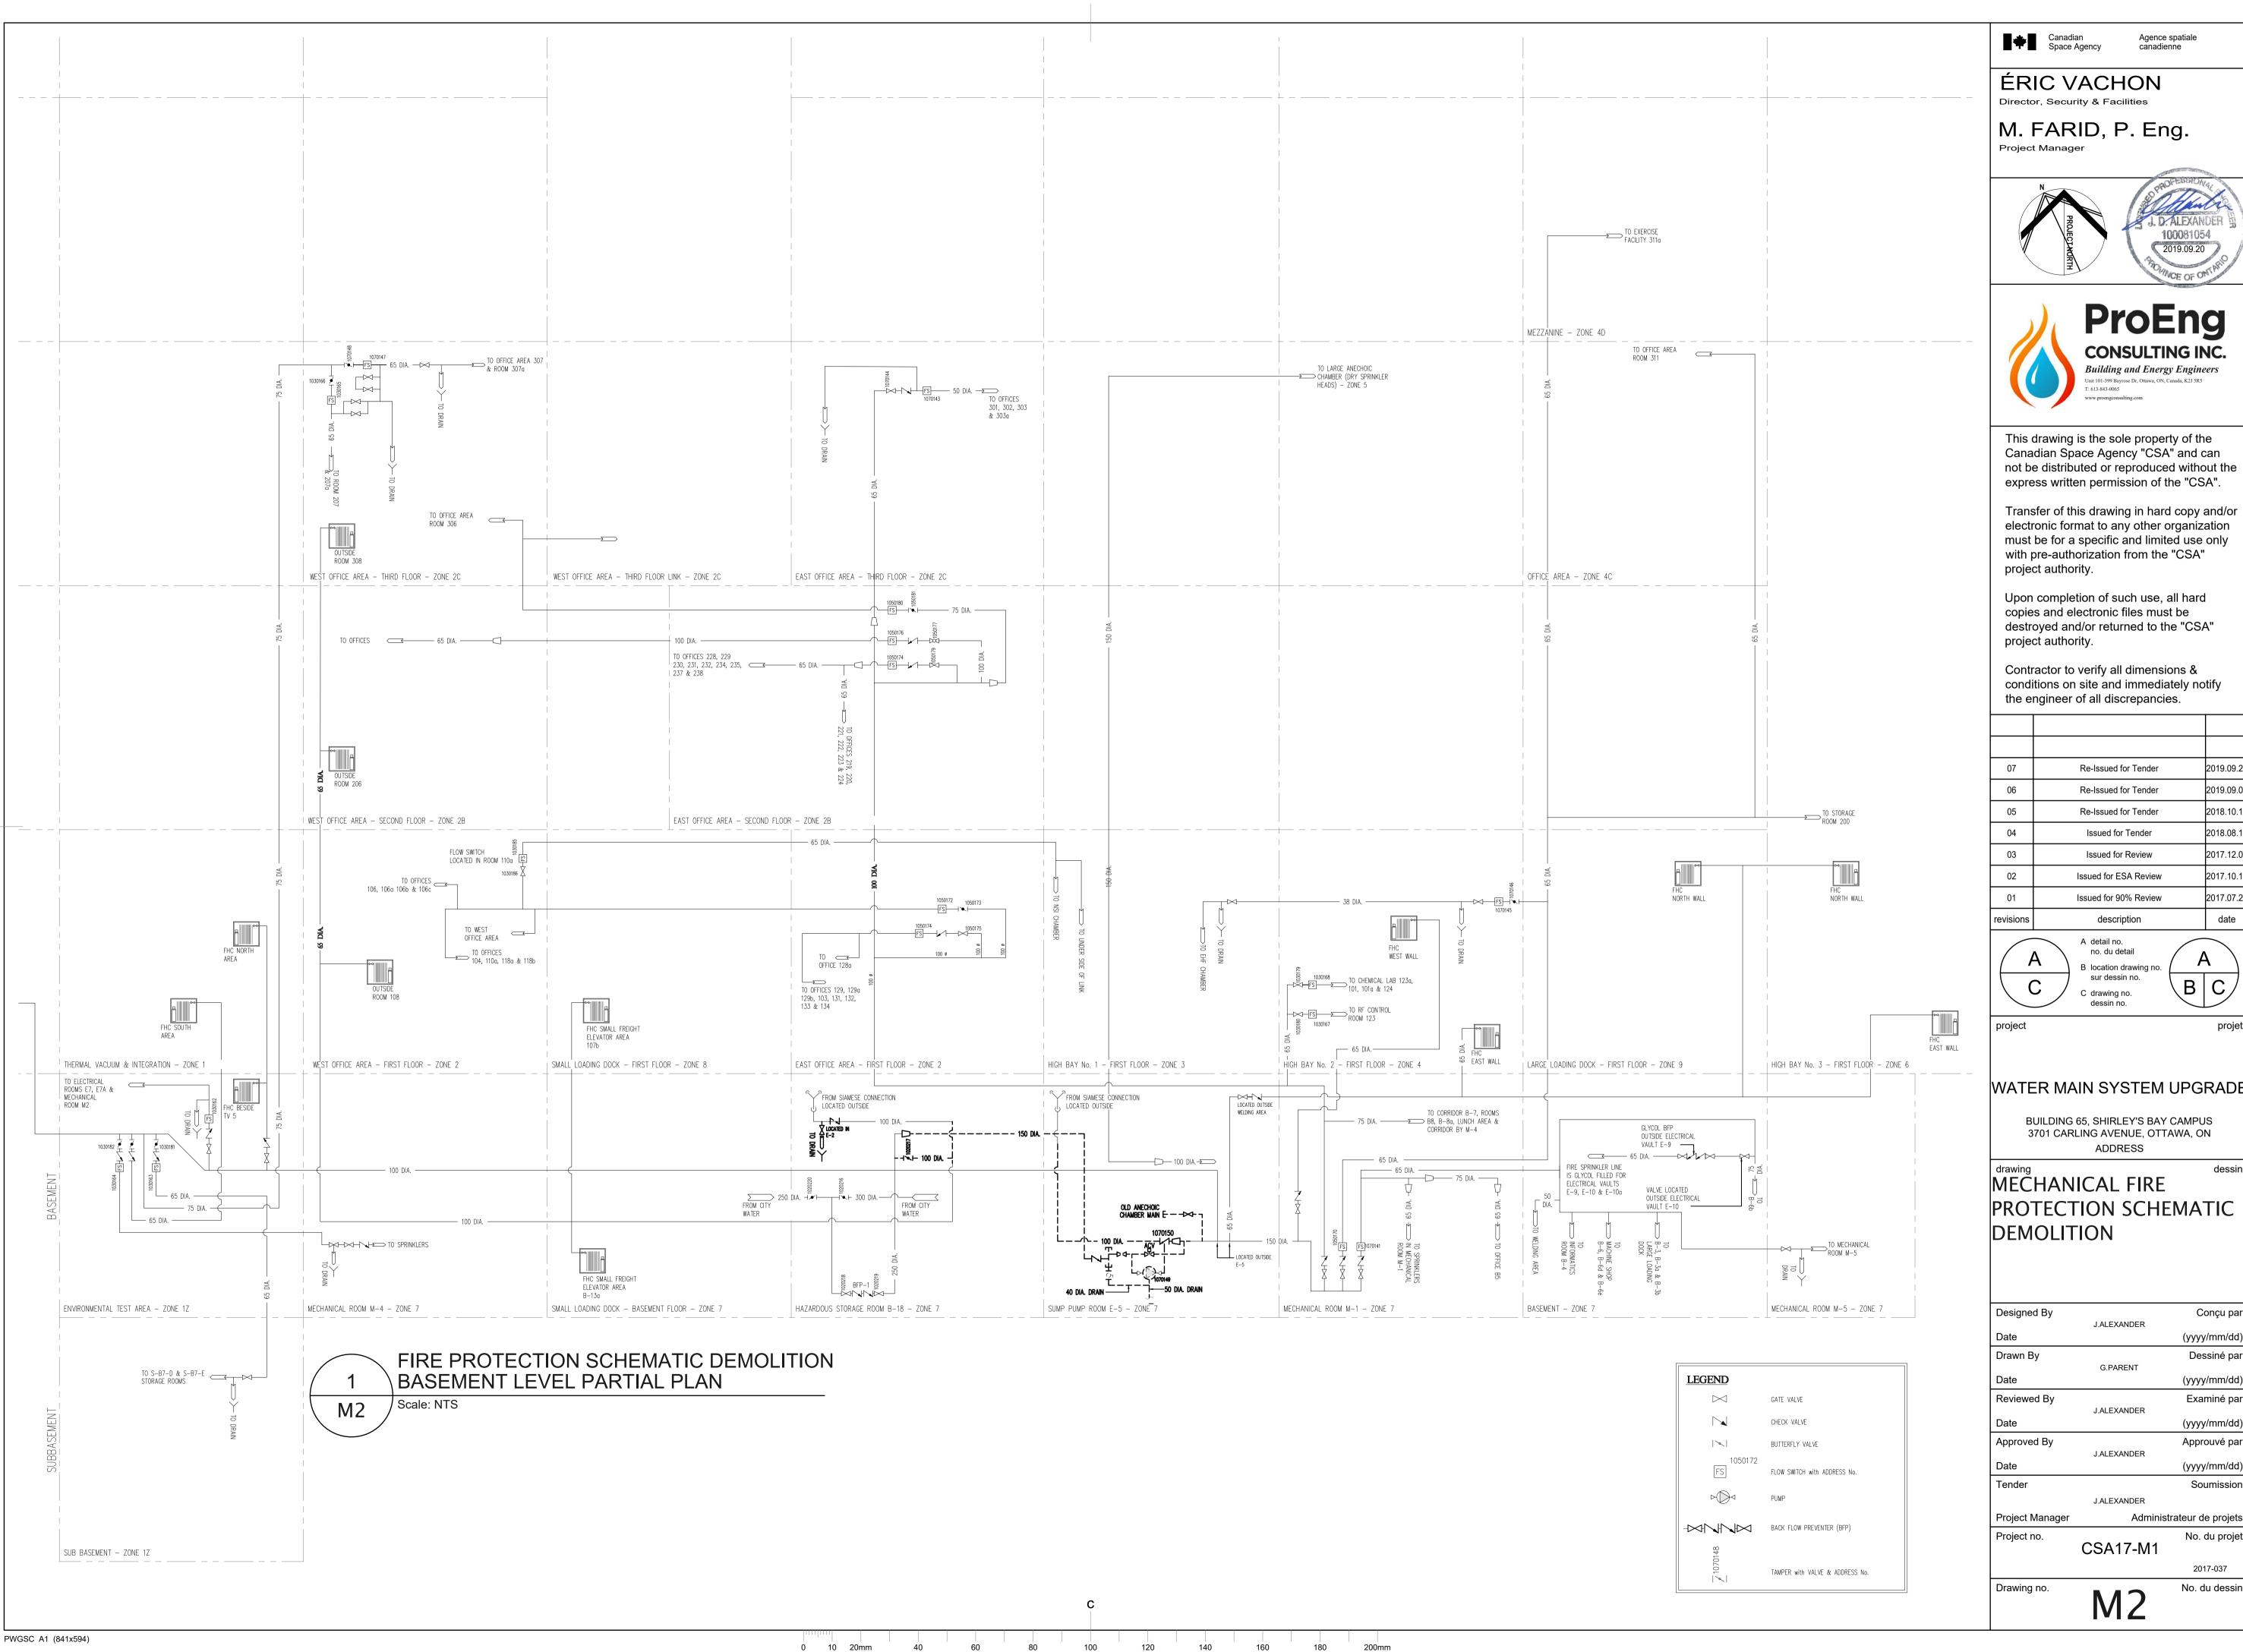
WATER MAIN SYSTEM UPGRADE


BUILDING 65, SHIRLEY'S BAY CAMPUS 3701 CARLING AVENUE, OTTAWA, ON ADDRESS

MECHANICAL LEGENDS, GENERAL NOTES AND **PROCEDURES**

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	J.ALEXANDER	
Date		(yyyy/mm/dd)
Drawn By	O DADENT	Dessiné par
Date	G.PARENT	(yyyy/mm/dd)
Reviewed By		Examiné par
5 .	J.ALEXANDER	, , , , , , , , , , , , , , , ,
Date		(yyyy/mm/dd)
Approved By		Approuvé par
	J.ALEXANDER	
Date		(yyyy/mm/dd)
Tender		Soumission
	J.ALEXANDER	
Project Manager	Administr	ateur de projets
Project no.	0011711	No. du projet
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WATER MAIN SYSTEM UPGRADE


BUILDING 65, SHIRLEY'S BAY CAMPUS 3701 CARLING AVENUE, OTTAWA, ON


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Date	G.PARENT	(yyyy/mm/dd)	
Reviewed By		Examiné par	
Date	J.ALEXANDER	(yyyy/mm/dd)	
Approved By		Approuvé par	
Date	J.ALEXANDER	(yyyy/mm/dd)	
Tender		Soumission	
	J.ALEXANDER		
Project Manager	Administrateur de projets		

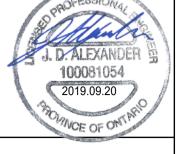No. du projet

2017-037



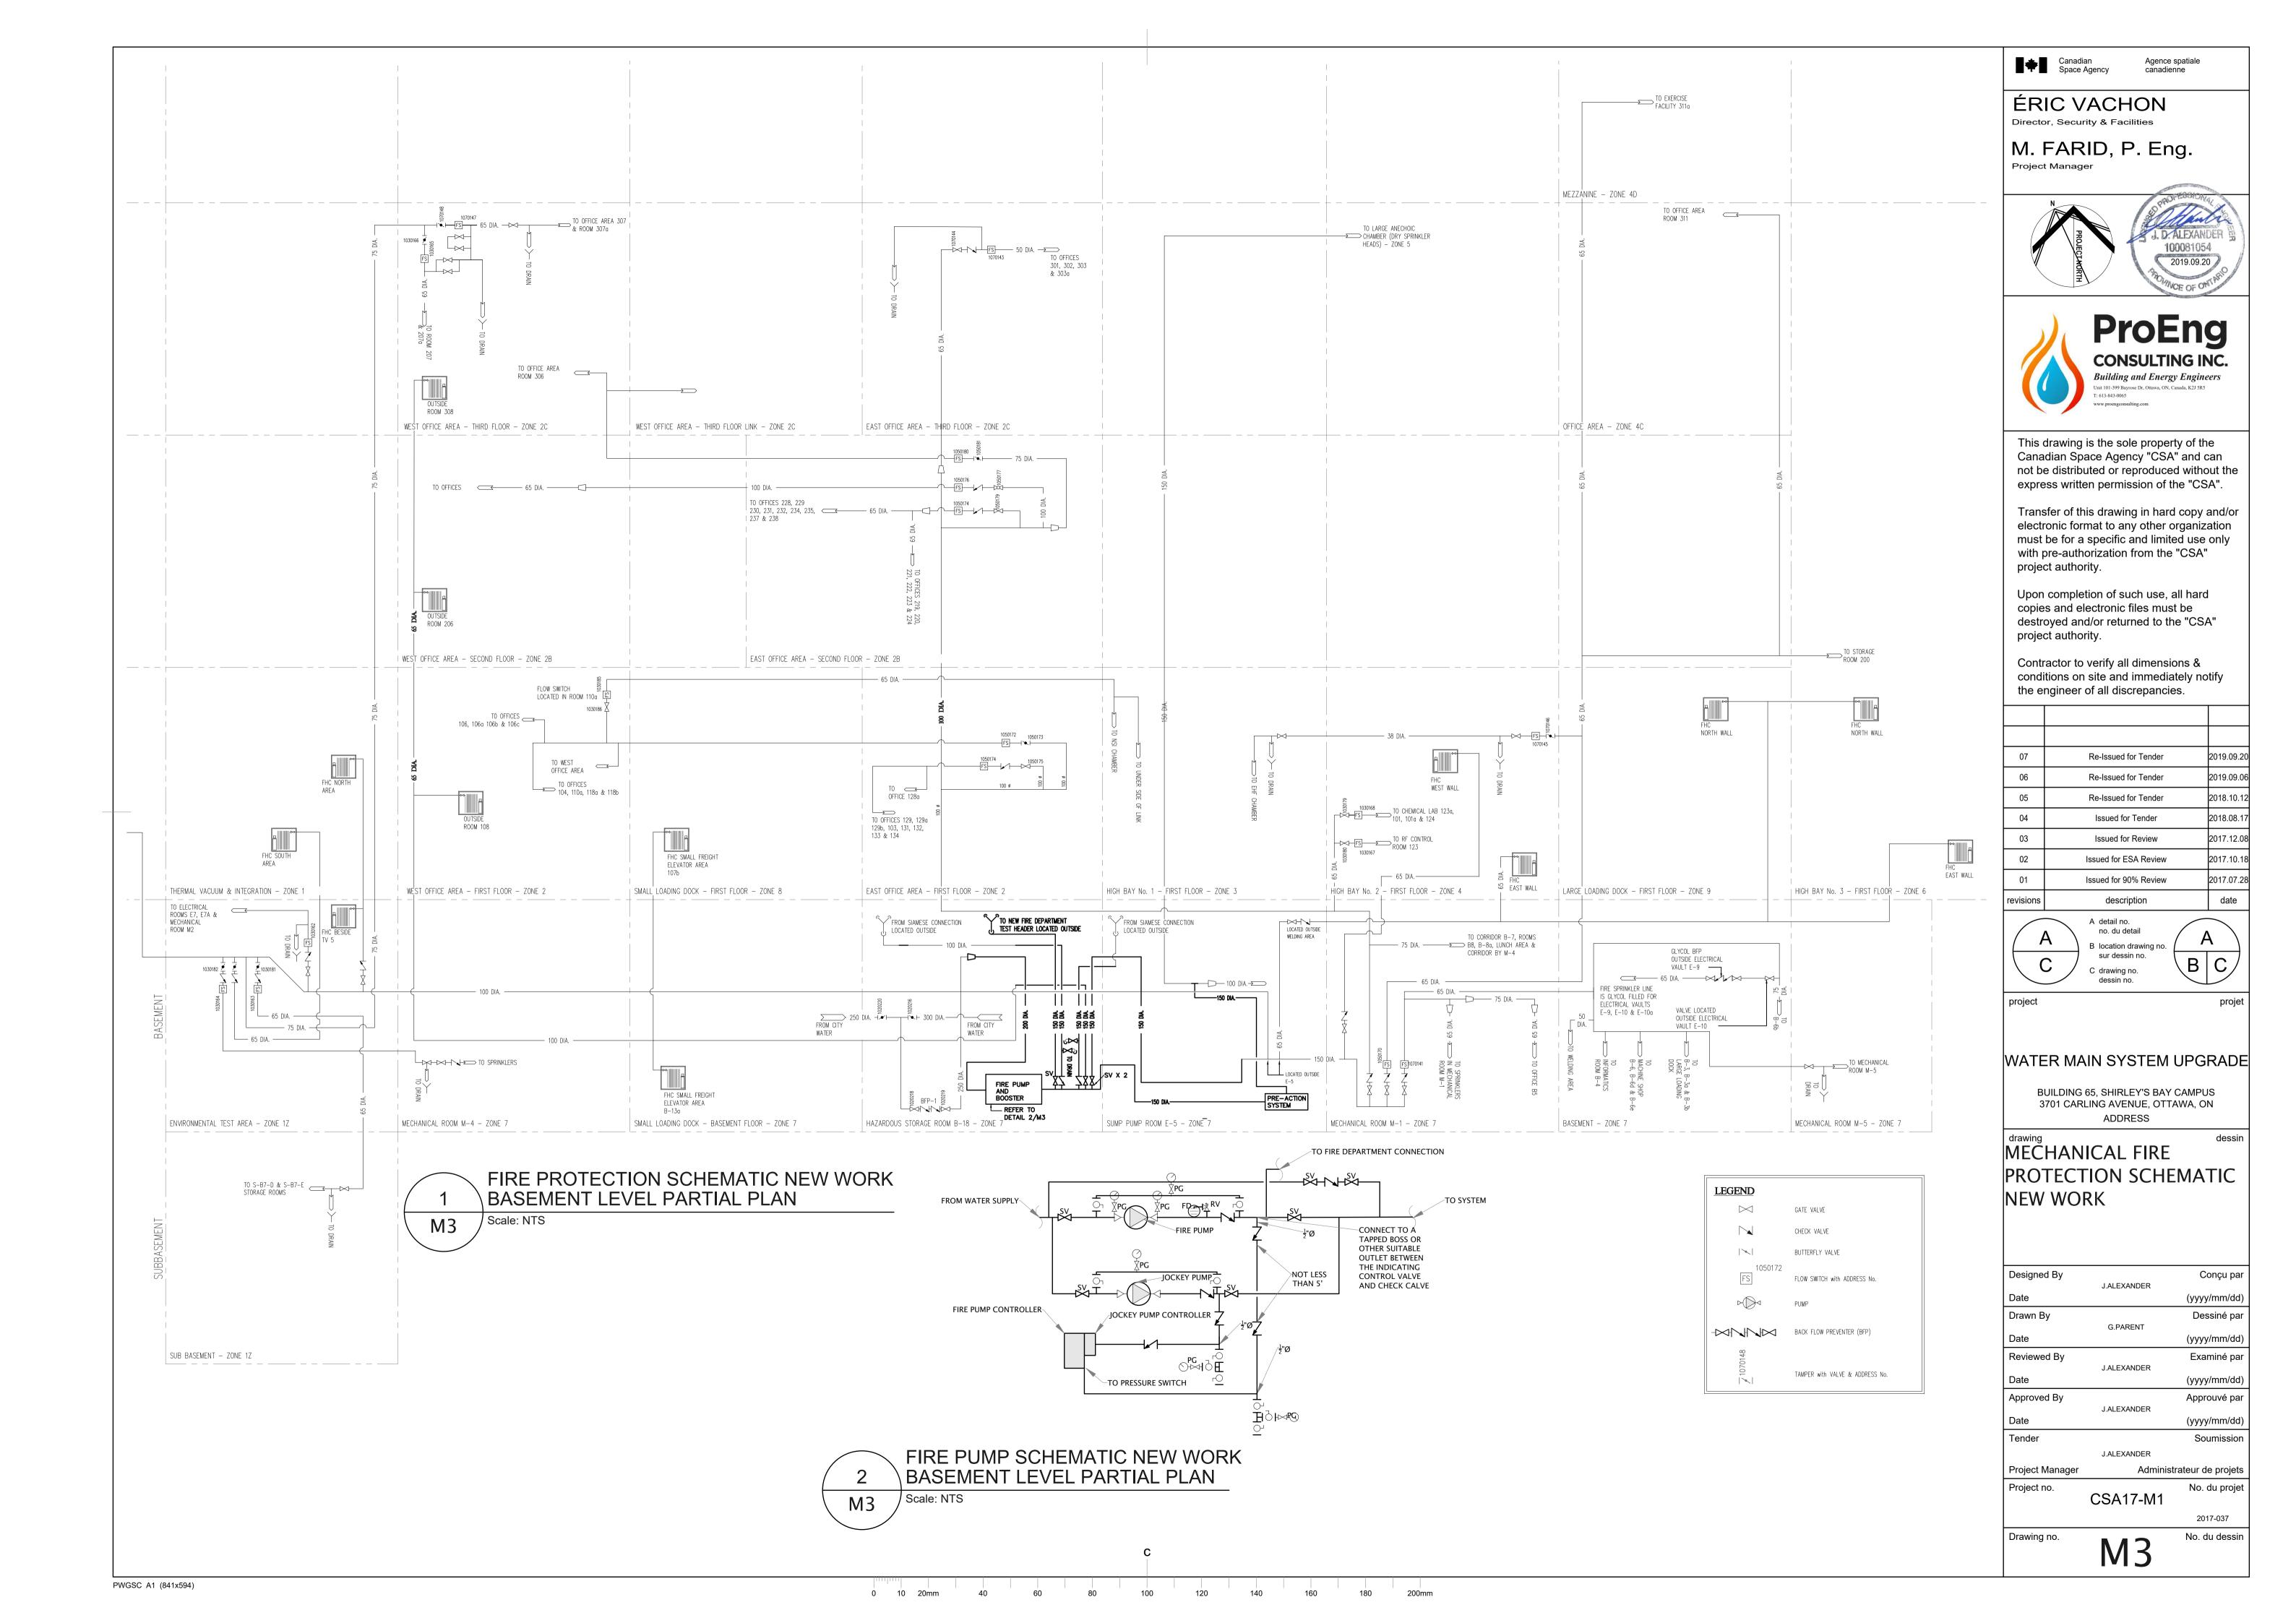

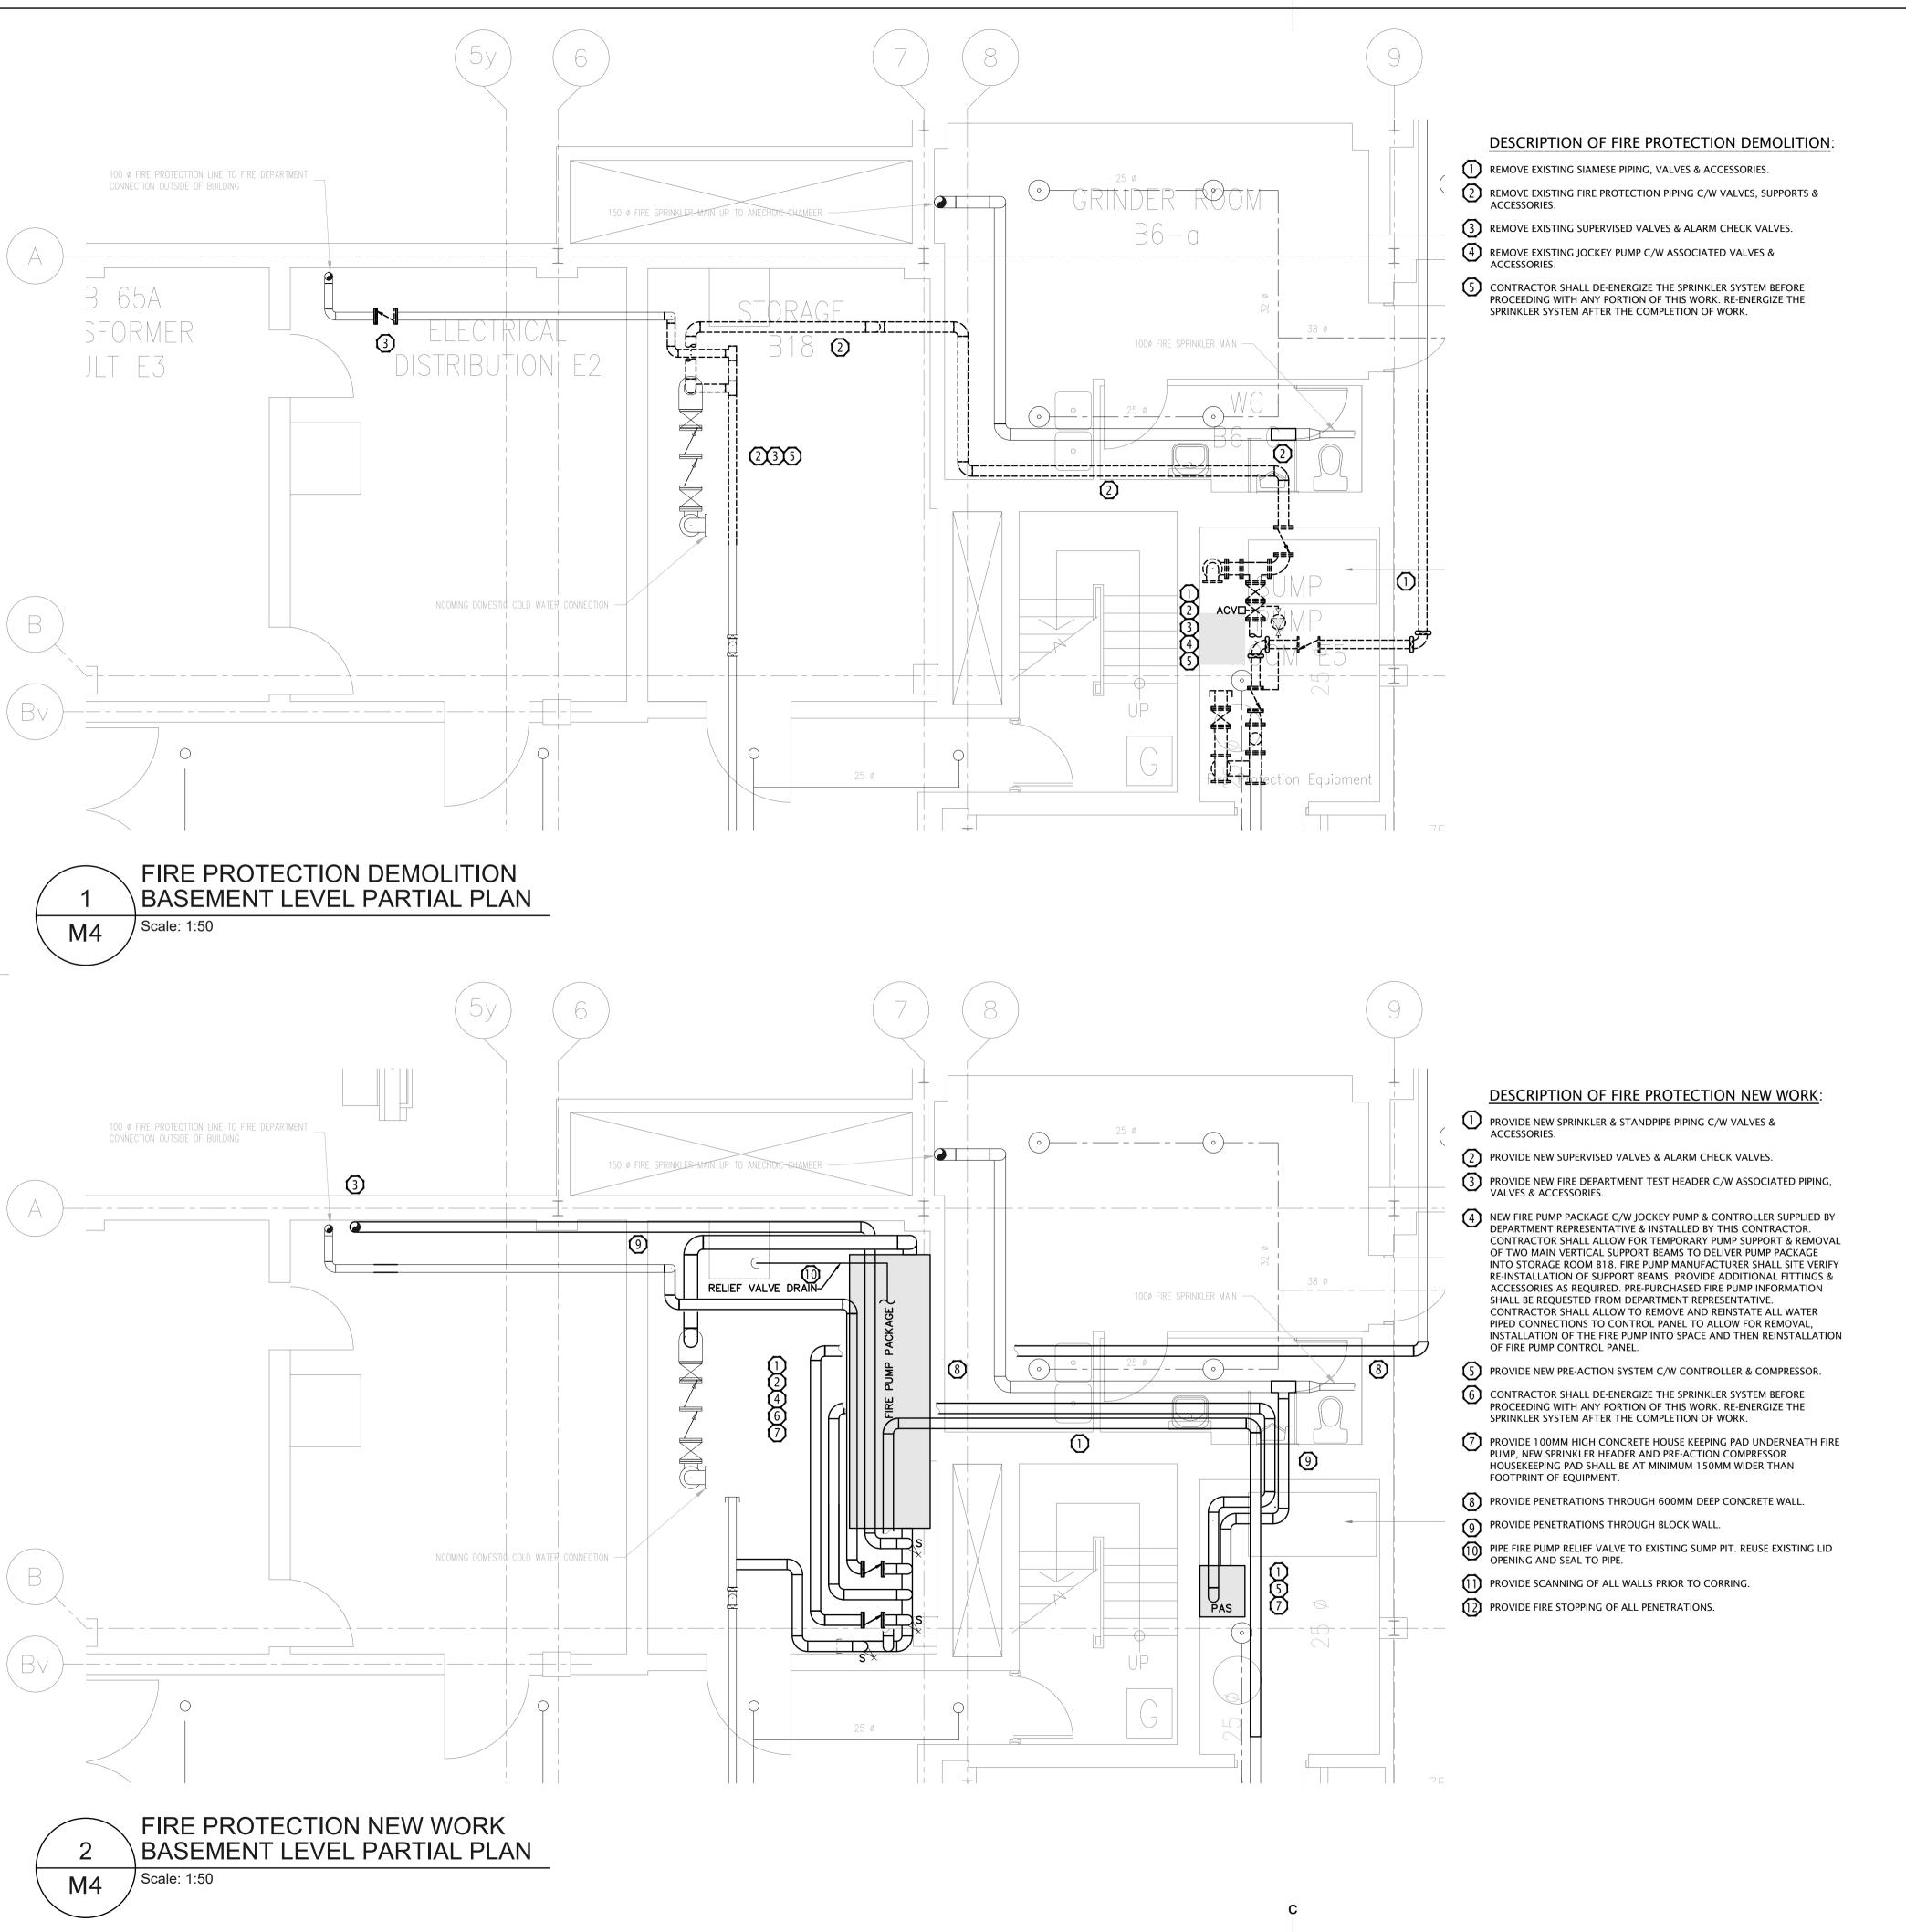Canadian
Space Agency


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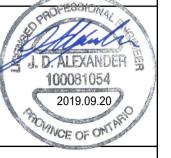
Agence spatiale canadienne

ÉRIC VACHON

Director, Security & Facilities

M. FARID, P. Eng.



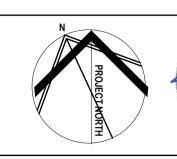




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PLAN

WATER MAIN SYSTEM UPGRADE

BUILDING 65, SHIRLEY'S BAY CAMPUS 3701 CARLING AVENUE, OTTAWA, ON ADDRESS

FIRE PROTECTION

DEMOLITION & NEW

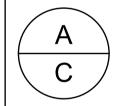WORK

BASEMENT LEVEL PARTIAL

Designed By	J.ALEXANDER	Conçu par
Date	J.ALEXANDER	(yyyy/mm/dd)
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DFL PROJECTS GENERAL NOTES, & PROCEDURES:

- 1. THE GENERAL CONTRACTOR SHALL ARRANGE AND PAY FOR ALL NECESSARY PERMITS, INSPECTIONS & RE-INSPECTIONS REQUIRED TO BE PERFORMED BY LOCAL AUTHORITIES HAVING IURISDICTION INCLUDING INSPECTION AND TESTING EXCEPT FOR BUILDING PERMIT TO THE CITY OF OTTAWA WHICH WILL BE APPLIED FOR BY OWNER. TURN OVER TO THE OWNER ALL ORIGINAL APPROVAL **DOCUMENTATION & CERTIFICATES**
- CONTRACTOR TO BE RESPONSIBLE FOR THE PROVISION (SUPPLY AND INSTALLATION) OF ALL MATERIALS. EQUIPMENT & SERVICES SHOWN ON THE PROJECT DRAWINGS & SPECIFICATIONS AS REQUIRED FOR A FULLY OPERABLE SYSTEM, UNLESS CHANGED OR REPLACED BY REVISED DRAWINGS, SPECIFICATIONS OR ADDENDA.
- 3. THE GENERAL CONTRACTOR SHALL BE RESPONSIBLE FOR ALL ARCHITECTURAL. STRUCTURAL. MECHANICAL, ELECTRICAL, PLUMBING & FIRE PROTECTION WORK. BE RESPONSIBLE FOR ALL FLOOR CUTTING, CORE DRILLING, ALL CHASES, OPENINGS AND PATCHING AS MAY BE REQUIRED BY ALL SUB TRADES WHO MAY OR MAY NOT BE UNDER HIS CONTRACT AGREEMENTS.
- 4. DRAWINGS ARE NOT INTENDED TO SHOW THE DETAILS & ROUTE OF EACH COMPONENT TO BE INSTALLED OR REMOVED. THEY ARE ONLY PROVIDING A GENERAL OVERVIEW OF THE PROJECT SCOPE THE CONTRACTOR SHALL BE RESPONSIBLE TO REVIEW THE SITE CONDITIONS DURING THE TENDER PERIOD AND EXAMINE THE EXTENT OF THE DEMOLITION, REMOVALS & NEW INSTALLATIONS TO INCLUDE IN THE TENDER PRICE ALL NECESSARY LABOR AND MATERIAL REQUIRED FOR A FULLY OPERABLE SYSTEM AS INTENDED.
- 5. ALL MATERIALS AND WORKMANSHIP SHALL BE IN ACCORDANCE WITH THE CURRENT CODES, BY-LAWS AND ORDINANCES OF THE RELEVANT BUILDING AUTHORITIES WHERE VARIED BY THE PROJECT SPEC.
- 6. ALL DIMENSIONS TO BE VERIFIED ON SITE. EXACT LOCATION & ELEVATION OF EQUIPMENT IS SUBJECT TO SITE MEASUREMENTS.
- 7. CONTRACTOR TO SUBMIT SHOP DRAWINGS FOR ALL MATERIAL, EQUIPMENT & FIXTURES TO DEPARTMENTAL REPRESENTATIVE FOR APPROVAL BEFORE COMMENCING INSTALLATION OR ORDERING.
- 8. ALL SUPPLIED MATERIALS, FIXTURES & EQUIPMENT TO BE NEW, FREE FROM DEFECTS, CERTIFIED & APPROVED BY CODE. REUSE OF ANY EXISTING PARTS IN SOT PERMITTED UNLESS APPROVED BY OWNER.

ALL SAMPLES TO BE PROVIDED UPON CSA REQUEST AT NO ADDITIONAL COST.

- 9. CSA SHALL BE GIVEN THE OPTION OF RETAINING ANY REMOVED COMPONENTS OR EQUIPMENT COORDINATE AND HAND OVER TO CSA PROIECT MANAGER AS REQUIRED. DISPOSE OF ANY REMAINING OR UNWANTED EQUIPMENT OR SERVICES AND REMOVE OFF SITE IN A LEGAL MANNER AND COMPLY WITH THE ENVIRONMENTAL PROTECTION ACT. ONTARIO REGULATIONS FOR WASTE MANAGEMENT PROGRAM. CERTIFICATE OF DISPOSAL TO BE HANDED OVER TO OWNER AFTER REMOVALS ARE DONE.
- 10. INSTALL ALL EQUIPMENT IN FULL ACCORDANCE WITH THE MANUFACTURER SPECIFICATIONS & RECOMMENDATIONS.
- 11. ALL TRADES SHOULD BE LICENSED TO PERFORM ALL WORK SHOWN ON THE DRAWINGS INCLUDING
- 12. DO NOT DAMAGE EXISTING FIRE SEPARATIONS AND FIRE PROTECTIONS IN THE PROJECT AREAS. ANY DAMAGES INCURRED TO EXISTING FIRE SEPARATIONS AND PROTECTIONS SHALL BE RESTORED TO APPROVED CONDITIONS TO MEET REQUIRED RATING AND CODES AT NO ADDITIONAL COSTS TO THE
- 13. UNDER ANY CIRCUMSTANCES, DO NOT BLOCK REQUIRED ACCESS TO EXITS AND FIRE ESCAPE ROUTES DURING THE PROJECT DURATION. ALL EXISTING LIFE SAFETY SYSTEMS AND INDICATORS SHALL BE OPERATIONAL AT ALL TIMES.
- 14. SMOKE EATERS & POWERED EXHAUST FANS VENTED TO OUTSIDE OF BUILDING MUST BE USED DURING ALL BRAZING / WELDING / SOLDERING / CUTTING / GRINDING ACTIVITIES TO MINIMIZE CONTAMINATION & ODOR TO ADJACENT AREAS PARTICULARLY IN CLEAN ROOMS. PROVIDE 72 HOUR NOTICE TO CSA TO ARRANGE FOR HOT WORK PERMITS
- 15. CONTRACTOR TO PROTECT ALL ARCHITECTURAL FINISHES & FLOORING DURING CONSTRUCTION, BE RESPONSIBLE FOR ANY DAMAGES TO EXISTING SURFACES RESULTING FROM ALL PROJECT'S WORK. THE CONTRACTOR SHALL MAKE GOOD ALL DAMAGED SURFACES INCLUDING ANY PAINT TOUCH-UPS REQUIRED. REPAIR ALL WALLS, FLOORS & CEILINGS IN CORE AREA WHERE MECHANICAL & ELECTRICAL SERVICES PASS THROUGH.
- 16. EXACT TARPING LIMITS AND ACCESS ROUTES TO BE DETERMINED ON SITE IN COORDINATION WITH CSA PROJECT MANAGER.
- 16.1. ALL TARPS TO BE NEW HEAVY DUTY POLYETHYLENE, WATER / MILDEW / TEAR RESISTANT, WHITE, TIGHT SEALED FROM DECK TO FLOOR, CONTRACTOR TO PROVIDE ACCESS ZIPPERS OR DOORS AS REQUIRED BY CSA, USE METAL STUDS AS FRAMING SUPPORTS, NO WOOD MATERIALS TO BE USED IN TARPS CONSTRUCTION UNLESS APPROVED BY CSA.
- 16.2. APPROVED METHODS TO ATTACH STUDS / TARPS TO BUILDING AS FOLLOW: 16.2.1. ON FLOORS: HEAVY DUTY COMMERCIAL DOUBLE SIDED TAPE TO SECURE METAL STUDS
 - TO FLOORS, USE OF SCREWS OR TAPCONS ARE NOT PERMITTED. 16.2.2. ON DRYWALLS / MASONRY / METAL SIDING WALLS: DUCT OR TUCK TAPE IS NOT ALLOWED DIRECTLY ON BUILDING FINISHES AS IT WILL DAMAGE THEM WHEN REMOVED: APPLY MASKING PAINT GREEN TAPE FIRST AND THEN DUCT / TUCK TAPE ON TOP OF IT STUDS CAN BE SCREWED TO DRYWALL / MASONRY WALLS GIVING THAT ALL HOLES WILL BE PATCHED & PAINTED (WHOLE WALL / AREA TO BE PAINTED, SMALL / LOCAL PAINT PATCHES ARE NOT PERMITTED).
- 16.3. TARPS COULD BE HANGED OFF BUILDING STEEL STRUCTURAL USING HIGH STRENGTH CABLE TIES, PROVIDE HEAVY GAUGE UNISTRUTS AS NEEDED FOR CROSS RUNS OR TO DISTRIBUTE TARPS
- 16.4. HANGING TARPS FROM BUILDING SERVICES (DUCTWORK, CONDUITS, PIPES, SUPPORTS, HANGERS
- .. ETC.) IS NOT PERMITTED. 16.5. CONTRACTOR IS RESPONSIBLE FOR CLEANING, PATCHING, REPAIRING & PAINTING ALL DAMAGED SURFACES & TAPE MARKS AFTER REMOVING TARPS.
- 17. PROVIDE FLOOR PROTECTION TO ENTIRE PROJECT AREAS AS FOLLOW:
- 17.1. FLOOR TO BE WIPED CLEAN FROM ANY DEBRIS OR DUST PARTICLES. 17.2. PROVIDE MIN. 1/8" FOAM LAYER DIRECTLY ON ALL FLOORING.
- 17.3. PROVIDE HARD SHEETS ON TOP OF FOAM LAYER, ALL SHEETS SEAMS TO BE DUCT-TAPED TO PREVENT DEBRIS / DUST FROM GETTING TRAPPED UNDER THE PROTECTION SHEETS. USE OF OSB
- 18. PROVIDE FURNITURE AND EQUIPMENT PROTECTION AS FOLLOW:
- 18.1. OFFICE / LAB FURNITURE AND EQUIPMENT: TO BE COMPLETELY COVERED AND WRAPPED WITH
- NEW HEAVY DUTY CLEAR PLASTIC ROLL SHEETS. 18.2. SENSITIVE LAB TESTING EQUIPMENT: TO BE COMPLETELY COVERED AND WRAPPED WITH NEW HEAVY DUTY CLEAR PLASTIC ROLL SHEETS, CLEAN SCAFFOLDING TO BE ERECTED ON TOP OF ALL LAB EQUIPMENT TO PROTECT FROM POSSIBLE FALLING OBJECTS.
- 19. CONTRACTOR TO PROVIDE BILINGUAL CONSTRUCTION, ACCESS & SAFETY SIGNAGE, SIGNS TO BE POSTED ON ALL PROJECT FENCES & ENTRANCES AT THE START OF PROJECT AND BEFORE COMMENCING
- 20. ACCESS TO THE SITE FOR MATERIAL, WORK FORCES AND FOR WASTE REMOVAL IS TO BE COORDINATED WITH CSA PROJECT MANAGER, USE ONLY ELEVATORS DESIGNATED BY CSA AND PROTECT THEM FROM DAMAGE
- 21. WHEN TESTING ACTIVITIES ARE NOT UNDERWAY, LARGE OR SMALL LOADING DOCKS CAN BE USED TO MOVE MATERIALS IN AND OUT OF THE BUILDING FROM 7:00 AM TO 8:00 AM WITHOUT CSA NEEDING TO PROVIDE NOTICE TO BUILDING STAFF. IF ACCESS IS REQUIRED AFTER THIS TIME OR FOR LONGER PERIODS, 72 HOUR NOTICE MUST BE PROVIDED TO CSA TO CONFIRM AVAILABILITY AND ARRANGE FOR
- 22. SANITARY FACILITIES WILL BE ASSIGNED FOR CONTRACTOR'S PERSONNEL. OTHERS SHALL NOT BE USED. KEEP FACILITIES CLEAN.
- 23. ONLY DESIGNATED AREAS ARE TO BE USED FOR LUNCH AND BREAK TIME. ALL OTHER AREAS ARE OFF LIMITS INCLUDING CAMPUS CAFETERIA.
- 24. CONTRACTOR TO RESPECT ALL BUILDING FLOOR LOADING LIMITATIONS, COORDINATE AND CONFIRM WITH CSA PROJECT MANAGER PRIOR TO BRING IN ANY HEAVY TOOLS, EQUIPMENT AND LIFTS.
- 25. GENERAL CONTRACTOR SHALL BE RESPONSIBLE TO KEEP THE OWNER'S ACCESS AREAS AND CORRIDORS 25.1. CLEAN AND REMOVE ALL DEMOLITION AND CONSTRUCTION WASTE FROM PROJECT SITE ON


NOTES: ALL FEEDERS SHALL HAVE SEPARATE GROUND CONDUCTOR.

DAILY BASIS AND UPON COMPLETION OF PROJECT. 25.2. DO NOT USE CSA WASTE CONTAINERS. AN AREA WILL BE DESIGNATED FOR LOCATING

- CONTRACTOR WASTE BINS. 25.3. CONTRACTOR TO PROVIDE ALL CLEANING EQUIPMENT & SUPPLIES, USE OF BUILDING CLEANING EOUIPMENT OR SUPPLIES ARE NOT PERMITTED.
- 26. DO NOT SUBJECT ANY PART OF THE BUILDING TO ANY NOISE, DUST OR ANY OTHER UNACCEPTABLE ENVIRONMENTAL CONDITIONS DURING THE COURSE OF THE PROJECT. ANY NOISY / DUSTY / SMELLY ACTIVITIES SHALL BE DONE AFTER REGULAR WORKING HOURS OR WEEKENDS, COORDINATE WITH CSA PROJECT MANAGER WITH A MINIMUM NOTICE OF 72 HOURS
- 27. ALL PENETRATIONS THROUGH WALLS AND FLOORS SHALL BE SAW-CUT OR CORE DRILLED. JACK HAMMERING IS NOT PERMITTED. ALL WALLS, FLOORS & CEILINGS PENETRATIONS TO BE SEALED BY CONTRACTOR IN ACCORDANCE WITH APPLICABLE CODES & THE DEPARTMENTAL REPRESENTATIVE'S
- 28. PARTS NOTED TO BE SUPPLIED BY OWNER SHALL BE FULLY INSTALLED & SUPPORTED BY CONTRACTOR AT NO ADDITIONAL COST.
- 29. PROJECTS MAY TAKE PLACE IN A CLEANROOM ENVIRONMENT, MANDATING SPECIAL MEASURES BE TAKEN TO REDUCE LABORATORY DISRUPTION. CLASS 8 CLEANROOM STANDARDS ARE TO BE MET FOR THE AREA SURROUNDING CONSTRUCTION AT ALL TIMES AND ARE SUBJECT TO VERIFICATION.
- 30. ALL PERSONNEL MUST ATTEND MANDATORY DFL BRIEFING ON THE FIRST DAY OF PROJECT AND BEFORE STARTING ANY WORK, ADHERE TO THE INFORMATION PRESENTED AT ALL TIMES. ANY PERSON WHO DID NOT ATTEND THIS BRIEFING WILL NOT BE ALLOWED TO WORK ON SITE - NO EXCEPTIONS
- 31. IMPROPER / UNCLEAN / RIPPED CLOTHING, FOUL LANGUAGE, IMPROPER BEHAVIOR, SMOKING IN UNDESIGNATED AREAS INCLUDING E-CIGARETTES WILL NOT BE TOLERATED AND WORKER WILL BE
- 32. CSA, AT THEIR DISCRETION, MAY REQUEST A WORKER TO LEAVE THE SITE IF THERE IS DEMONSTRATED IMPAIRED MENTAL OR PHYSICAL CAPABILITY AFFECTING HIS/HER WORK PERFORMANCE AND POSSIBLY PUTTING OTHERS AT RISK DUE TO CONSUMPTION OF ALCOHOL OR ILLEGAL SUBSTANCES.


ESCORTED OFF CAMPUS IMMEDIATELY - NO EXCEPTIONS.

- 33. DFL IS A HIGH PROFILE OCCUPIED BUILDING, USE OF MUSIC OR RADIO ON SITE IS NOT PERMITTED AT
- 34. ALL GC & SUB-TRADES WORKERS HAVE TO BE ESCORTED AT ALL TIMES WHILE IN BUILDING AND ON
- 34.1. CSA WILL PROVIDE SECURITY COMMISSIONAIRES TO ESCORT. 34.2. PRIOR TO PROJECT START, GC TO PROVIDE A FULL LIST OF ALL PERSONNEL WORKING ON THE PROJECT AS WELL AS DEPARTMENTAL REPRESENTATIVES, SUPPLIERS & INSPECTORS IF POSSIBLE
- TO ISSUE NECESSARY FORMS FOR SITE AND BUILDING ACCESS. 34.3. PROVIDE AT LEAST 72 HOUR NOTICE FOR ANY ADDITIONAL NAMES OR FOR AFTER HOURS OR
- WEEKEND WORK 34.4. NOTIFY CSA IMMEDIATELY OF ANY CHANGE IN SCHEDULE THAT AFFECTS THE NEED FOR SECURITY ESCORTS
- 34.5. INDIVIDUALS WHO ARE NOT ON THAT LIST WILL BE DENIED ACCESS WITH NO EXCEPTIONS.
- 35. GENERAL CONTRACTOR REPRESENTATIVE HAS TO BE PRESENT ON SITE AT ALL TIMES AND ACCOMPANY ALL SUB-TRADE WORKERS; SUB-TRADES ARE NOT ALLOWED TO BE ON SITE OR TO WORK WITHOUT THE PRESENCE OF GC - NO EXCEPTIONS.
- 36. WEEKEND AND/OR AFTER-HOURS SHUTDOWNS TO BE SCHEDULED IN AGREEMENT WITH CSA PROJECT MANAGER, PROVIDE AT LEAST 72 HOUR NOTICE IN ADVANCE.
- 37. CSA IS COMMITTED TO ENSURING A HEALTHY AND SAFE ENVIRONMENT FOR ITS EMPLOYEES. CONTRACTORS AND VISITORS AND WILL ALIGN ITSELF WITH CONTRACTORS WHO SHARE IN THIS
- 37.1. THE REQUIREMENTS OUTLINED BELOW ARE PROVIDED AS REFERENCE AND ARE THERE TO ASSIST THE CONTRACTING COMPANY WHO PERFORMS THE WORK AND ACCEPTS THIS COMMITMENT COMPLETELY:
- 37.1.1. ONTARIO OCCUPATIONAL HEALTH AND SAFETY ACT: HTTP://WWW.E-LAWS.GOV.ON.CA 37.1.2. INFRASTRUCTURE HEALTH AND SAFETY ASSOCIATION "GUIDE TO DEVELOPING HEALTH AND SAFETY POLICIES AND PROGRAMS IN CONSTRUCTION" A COMPREHENSIVE GUIDE GEARED TO MID- TO LARGE-SIZED GENERAL CONTRACTORS FOR DEVELOPING AND
- IMPLEMENTING AN EFFECTIVE HEALTH AND SAFETY PROGRAM: HTTP://WWW.IHSA.CA 37.1.3. INFRASTRUCTURE HEALTH AND SAFETY ASSOCIATION "CONSTRUCTION HEALTH AND SAFETY MANUAL". GUIDANCE ON HAZARD CONTROLS FOR ONTARIO CONTRACTORS: HTTP://WWW.IHSA.CA
- 37.2. THE GENERAL CONTRACTOR WILL BE REQUIRED TO PREPARE AND SUBMIT TO THE CSA PROIECT MANAGER A FULL PROJECT HEALTH AND SAFETY PLAN. HEREIN CALLED PHSP. PRIOR TO THE COMMENCEMENT OF ANY WORKS AND WITHIN 2 WEEKS OF CONTRACT AWARD. 37.3. THE GENERAL CONTRACTOR SHALL PROVIDE CSA PROJECT MANAGER A COPY OF ALL NOTICES
- OR OTHER WRITTEN CORRESPONDENCE PROVIDED TO OR RECEIVED BY THE ONTARIO MINISTRY OF LABOR FOR THE DURATION OF THE CONTRACT 37.4. THE GENERAL CONTRACTOR SHALL FULLY IMPLEMENT THE PHSP FOR THE FULL DURATION OF
- ANY WORK. CERTIFICATES MUST SHOW EXACT COMPANY NAME AND ADDRESS THAT PROVIDED THE TRAINING. CSA RESERVES THE RIGHT TO REQUEST THE COURSE OUTLINE FROM THE COMPANY THAT PROVIDED THE TRAINING, IF THE PROOF OF TRAINING DOES NOT DEMONSTRATE THE WORKER AS BEING COMPETENT OPERATORS. FURTHER TRAINING MAY BE REQUESTED BY THE CSA PRIOR TO COMMENCING ANY WORK AT NO ADDITIONAL COST.
- 38. GC TO PROVIDE A MINIMUM OF 48 HOUR NOTICE TO CSA PRIOR FOR ANY DELIVERIES. GENERAL CONTRACTOR MUST BE ON SITE TO RECEIVE THE SHIPMENT. IF THE DELIVERY PERTAINS TO LIFTING EQUIPMENT, THE QUALIFIED CONTRACTOR SCHEDULED TO USE THE EQUIPMENT MUST INSPECT AND
- 39. GC AND ALL HIS SUB-TRADES ARE RESPONSIBLE TO PROVIDE ALL LADDERS, SCAFFOLDING, LIFTS. CRANES AND ALL OTHER EQUIPMENT & TOOLS REQUIRED FOR PROJECT SCOPE INCLUDING INSTALLING & REMOVING TARPS & PROTECTION MATERIALS. USE OF BUILDING TOOLS, EQUIPMENT, TROLLIES, FORKLIFTS, SKIDS, LADDERS, LIFTS, CRANES ... ETC. ARE NOT PERMITTED.
- 40. ALL TRADES TO FOLLOW BUILDING SERVICE ELEVATIONS STANDARD AS FOLLOW:

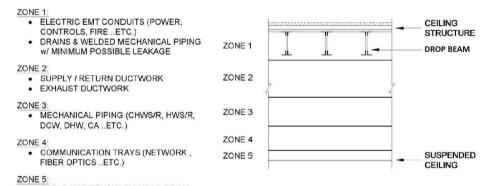

CLEAR MAINTENANCE & HEAD ROOM ZONE - MINIMUM OF 8"

BUILDING STANDARDS - SERVICES ELEVATIONS

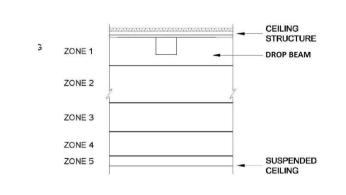

41. GENERAL CONTRACTOR AND ALL TRADES TO FOLLOW ALL CAMPUS & CSA/DFL PROCEDURES AT ALL TIMES. GC IS RESPONSIBLE TO DISTRIBUTE ALL PROCEDURES TO ALL HIS WORKERS & SUB-TRADES.

- 1. THESE DRAWINGS MUST BE READ IN CONJUNCTION WITH ALL ISSUED CONTRACT SPECIFICATIONS. ARCHITECTURAL. STRUCTURAL. MECHANICAL AND ELECTRICAL DRAWINGS. EXCEPT WHERE REPLACED OR CHANGED BY DIRECTIVE OR CORRECTIVE ADDENDA OR REVISED DRAWINGS AND
- 2. ALL WORK MUST BE IN FULL ACCORDANCE WITH THE CANADIAN ELECTRIC CODE PART 1 C22.1-02 AND THE LATEST EDITION OF THE ONTARIO SAFETY CODE.
- 3. THE CONTRACTOR SHALL BE RESPONSIBLE FOR THE PROVISION (SUPPLY, INSTALLATION & WIRING) OF ALL EQUIPMENT SHOWN ON THE CONTRACT DRAWINGS AND SPECIFICATIONS UNLESS CHANGED OR REPLACED BY REVISED DRAWINGS. SPECIFICATIONS ADDENDA.
- 4. THE SUCCESSFUL BIDDER SHALL ARRANGE AND PAY FOR ALL NECESSARY PERMITS AND WORK REQUIRED TO BE PERFORMED BY LOCAL AUTHORITIES INCLUDING INSPECTION BY ESA AND
- 5. ALL DIMENSIONS SHALL BE VERIFIED ON SITE. EXACT LOCATION OF EQUIPMENT IS SUBJECT TO SITE MEASUREMENTS.
- 6. ALL BIDDERS AND THEIR SUB TRADES ARE STRONGLY ADVISED TO ATTEND THE SITE VISIT TO FAMILIARIZE THEMSELVES WITH THE SITE CONDITIONS AND EXACT SCOPE OF WORK.
- IF ANY DISCREPANCY OCCURS ON THE DEPARTMENTAL REPRESENTATIVE'S DRAWINGS. THE CONTRACTOR SHALL, DURING TENDERING, ASSUME THE LARGER / GREATER, ANY DISCREPANCY SHALL BE REFERRED TO THE DEPARTMENTAL REPRESENTATIVE BEFORE PROCEEDING WITH THE
- 8. DRAWINGS ARE NOT INTENDED TO SHOW THE DETAILS OF CONDUIT ROUTES, OFFSETS, ETC. BE RESPONSIBLE FOR CAREFULLY EXAMINE THE WORK SITE PRIOR TO TENDER CLOSE-OUT AND INCLUDE IN THE TENDER PRICE ALL NECESSARY LABOR AND MATERIAL REQUIRED FOR A FULLY OPERABLE SYSTEM AS INTENDED.
- 9. PARTS NOTED ON DRAWINGS TO BE SUPPLIED BY OWNER SHALL BE FULLY INSTALLED &
- 10. ALL WIRING TO BE MINIMUM #12 AWG COPPER STRANDED WIRES UNLESS OTHERWISE STATED. CONDUITS & JUNCTION BOXES SHALL NOT BE LOADED MORE THAN 60% OF ITS MAXIMUM RATED
- 11. ALL ELECTRICAL RACEWAYS & EQUIPMENT TO BE SQUARE TO BUILDING LINES AND SHALL BE SEPARATELY SUPPORTED FROM BUILDING STRUCTURE. A GROUND CONDUCTOR IS REQUIRED IN
- 12. ALL CONNECTORS & COUPLINGS SHALL BE STEEL WITH INSULATED THROATS, ALL CONDUITS TO BE EMT, MINIMUM OF 3/4" UNLESS OTHERWISE STATED, ARMORED CABLE IS NOT A CONDUIT & PROJECT MANAGER MUST APPROVE THE USE OF IT
- 13. LOCATE ALL BOXES ON STRAIGHT RUNS, EACH BOX TO BE BONDED.
- 14. ALL CONDUIT RUNS SHALL BE COLOR CODED TO BUILDING COLOR CODE, ALL CONDUITS TO BE MARKED AT THE START AND END OF EACH RUN & AT BOTH SIDES OF ANY WALL, STANDARD ELECTRIC TAPE IS TO BE USED FOR MARKING
- 15. ALL OUTLETS, SWITCHES, COMMUNICATION JACKS TO BE WHITE, DECORA STYLE W/ BRUSHED STAINLESS STEEL COVER PLATE.
- 16. USE OF TIE WRAPS OR TIE WIRE IS NOT ACCEPTABLE.
- 17. ALL CONDUITS RUNS LENGTH SHOWN ON DRAWINGS ARE FOR GENERAL REFERENCE ONLY, CONTRACTOR TO EXAMINE SITE TO DETERMINE EXACT ROUTE & DIMENSIONS.
- 18. IMMEDIATELY AFTER AWARDING THE CONTRACT, THE CONTRACTOR SHALL SUBMIT TO THE DEPARTMENTAL REPRESENTATIVE A DETAILED WORK SCHEDULE, IN THE FORM OF COMPUTERIZED BAR CHART OUTLINING ALL PROJECT ACTIVITIES AND SCHEDULED SHUT DOWNS.
- 19. CORE DRILL WALLS AND FLOORS FOR NEW SERVICES & WIRING. SEALING OF ALL EXISTING OPENINGS AFTER SERVICES ARE REMOVED SHALL FORM PART OF THIS CONTRACT.
- 20. INSTALL EQUIPMENT IN FULL ACCORDANCE WITH THE MANUFACTURER RECOMMENDATIONS.
- 37.5. A COPY OF ALL APPLICABLE TRAINING CERTIFICATES MUST BE PROVIDED PRIOR TO COMMENCING 21. BE RESPONSIBLE FOR REMOVAL AND REINSTATING CEILINGS AS NECESSARY.
 - 22. WORK UNDER THIS PROJECT MAYBE CONDUCTED AT ELEVATIONS IN EXCESS OF 15M± (50 FT ±), CONTRACTOR MUST ENSURE THAT ALL STAFF & SUB CONTRACTORS ARE TRAINED IN ELEVATED WORK AND FALL PROTECTION.
 - 23. ALL SERVICES OR EQUIPMENT THAT IS SHOWN TO BE REMOVED SHALL BE REMOVED IN THEIR ENTIRETY COMPLETE WITH ALL ASSOCIATED SERVICES, SUPPORTS, HANGERS ETC. ANY ABANDONED OR UNUSED COMPONENTS FOUND WITHIN THE SCOPE OF THIS PROJECT SHALL BE TERMINATED, REMOVED AND REMAINING IF ANY SHALL BE MADE SAFE.
 - OR REMOVED. THEY ARE ONLY PROVIDING A GENERAL OVERVIEW OF THE PROJECT SCOPE. BE RESPONSIBLE TO REVIEW THE SITE CONDITIONS DURING THE TENDER PERIOD AND EXAMINE THE EXTENT OF THE DEMOLITION, REMOVALS & NEW INSTALLATIONS.
 - 25. OWNER SHALL BE GIVEN THE OPTION OF RETAINING ANY REMOVED COMPONENTS OR EQUIPMENT. COORDINATE AND HAND OVER AS NECESSARY. DISPOSE OF ANY REMAINING UNWANTED EQUIPMENT OR SERVICES AND REMOVE OFF SITE.

UNACCEPTABLE ENVIRONMENTAL CONDITIONS DURING THE COURSE OF THE PROJECT. ANY NOISY / DUSTY / SMELLY ACTIVITIES SHALL BE DONE AFTER HOURS OR AT WEEKENDS, COORDINATE WITH

26. DO NOT SUBJECT ANY PART OF THE BUILDING TO ANY NOISE, DUST OR ANY OTHER

CSA PROJECT MANAGER WITH A MINIMUM NOTICE OF 48 HOURS.

- 24. DRAWINGS ARE NOT INTENDED TO SHOW THE DETAILS OF EACH COMPONENT TO BE INSTALLED

POWER AND SYSTEMS LEGEND

SYMBOL	DESCRIPTION
BB	ELECTRICAL BOX: JB - POWER DISCONNECT EXTERNAL BREAKER FIRE ALARM ATS CONTROLS CABINET CONDUIT STUB C/W INSULATED PLASTIC BUSHINGS / CONDUIT UP / CONDUIT DOWN FIRE ALARM SUPERVISORY VALVE FIRE ALARM FLOW SWITCH FIRE ALARM MODULE DIRECT MOTOR CONNECTION TO 600V 3Ø EQUIPMENT, HORSEPOWER INDICATED ELECTRICAL CABINET, TYPE AS INDICATED (FIRE ALARM, CONTROLS, ELECTRICAL PANEL)
300A	BREAKER, RATING INDICATED

LINETYPE LEGEND SYMBOL DESCRIPTION EXISTING CONDUIT/EQUIPMENT

EXISTING CONDUIT/EQUIPMENT TO BE REMOVED/RELOCATED _ _ _ _ _ NEW/RELOCATED CONDUIT/EQUIPMENT CONDUIT BELOW GRADE/SLAB _____ MECHANICAL EQUIPMENT **ROOM OUTLINE**


Agence spatiale

ÉRIC VACHON Director, Security & Facilities

Project Manager

M. FARID, P. Eng.



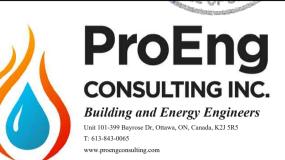


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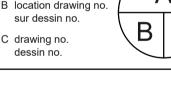
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Contractor to verify all dimensions & conditions on site and immediately notify the engineer of all discrepancies.

08	Issued for Tender	2019.12.02
07	Re-Issued for Tender	2019.09.20
06	Re-Issued for Tender	2019.09.06
05	Re-Issued for Tender	2018.10.12
04	Issued for Tender	2018.08.17
03	Issued for Review	2017.12.08
02	Issued for ESA Review	2017.10.18
01	Issued for 90% Review	2017.07.28
revisions	description	date



project

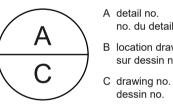

WATER MAIN SYSTEM UPGRADE

BUILDING 65. SHIRLEY'S BAY CAMPUS 3701 CARLING AVENUE, OTTAWA, ON **ADDRESS**


ELECTRICAL LEGENDS, **GENERAL NOTES &** PROCEDURES, & **SCHEDULES**

Designed By	M.LACHOWICZ	Conçu par
Date		(yyyy/mm/dd)
Drawn By		Dessiné par
	J.GIBSON	
Date		(yyyy/mm/dd)
Reviewed By		Examiné par
	M.LACHOWICZ	
Date		(yyyy/mm/dd)
Approved By		Approuvé par
	M.LACHOWICZ	
Date		(yyyy/mm/dd)
Tender		Soumission
	M.LACHOWICZ	
Project Manager	Administ	rateur de projets


CSA17-M1 2017-037 Drawing no

No. du dessin

No. du projet

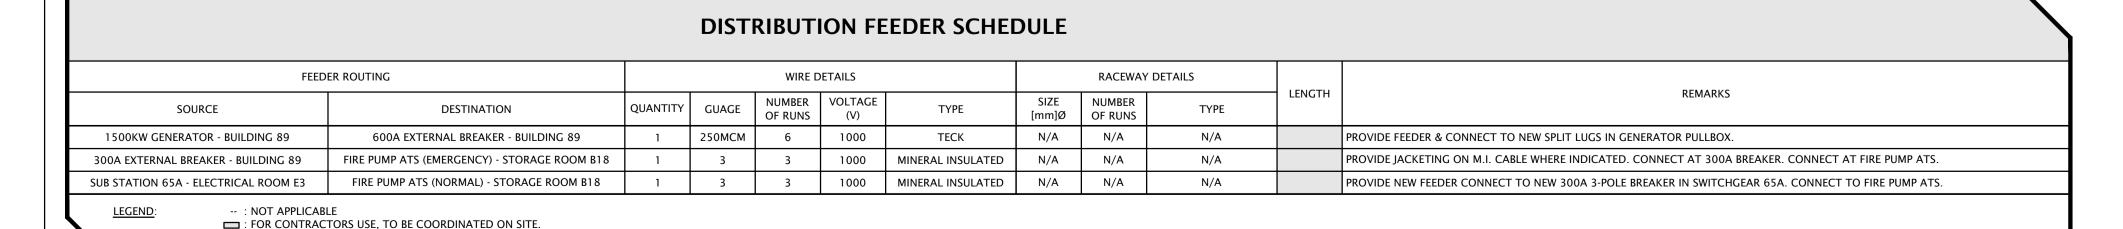

PWGSC A1 (841x594)

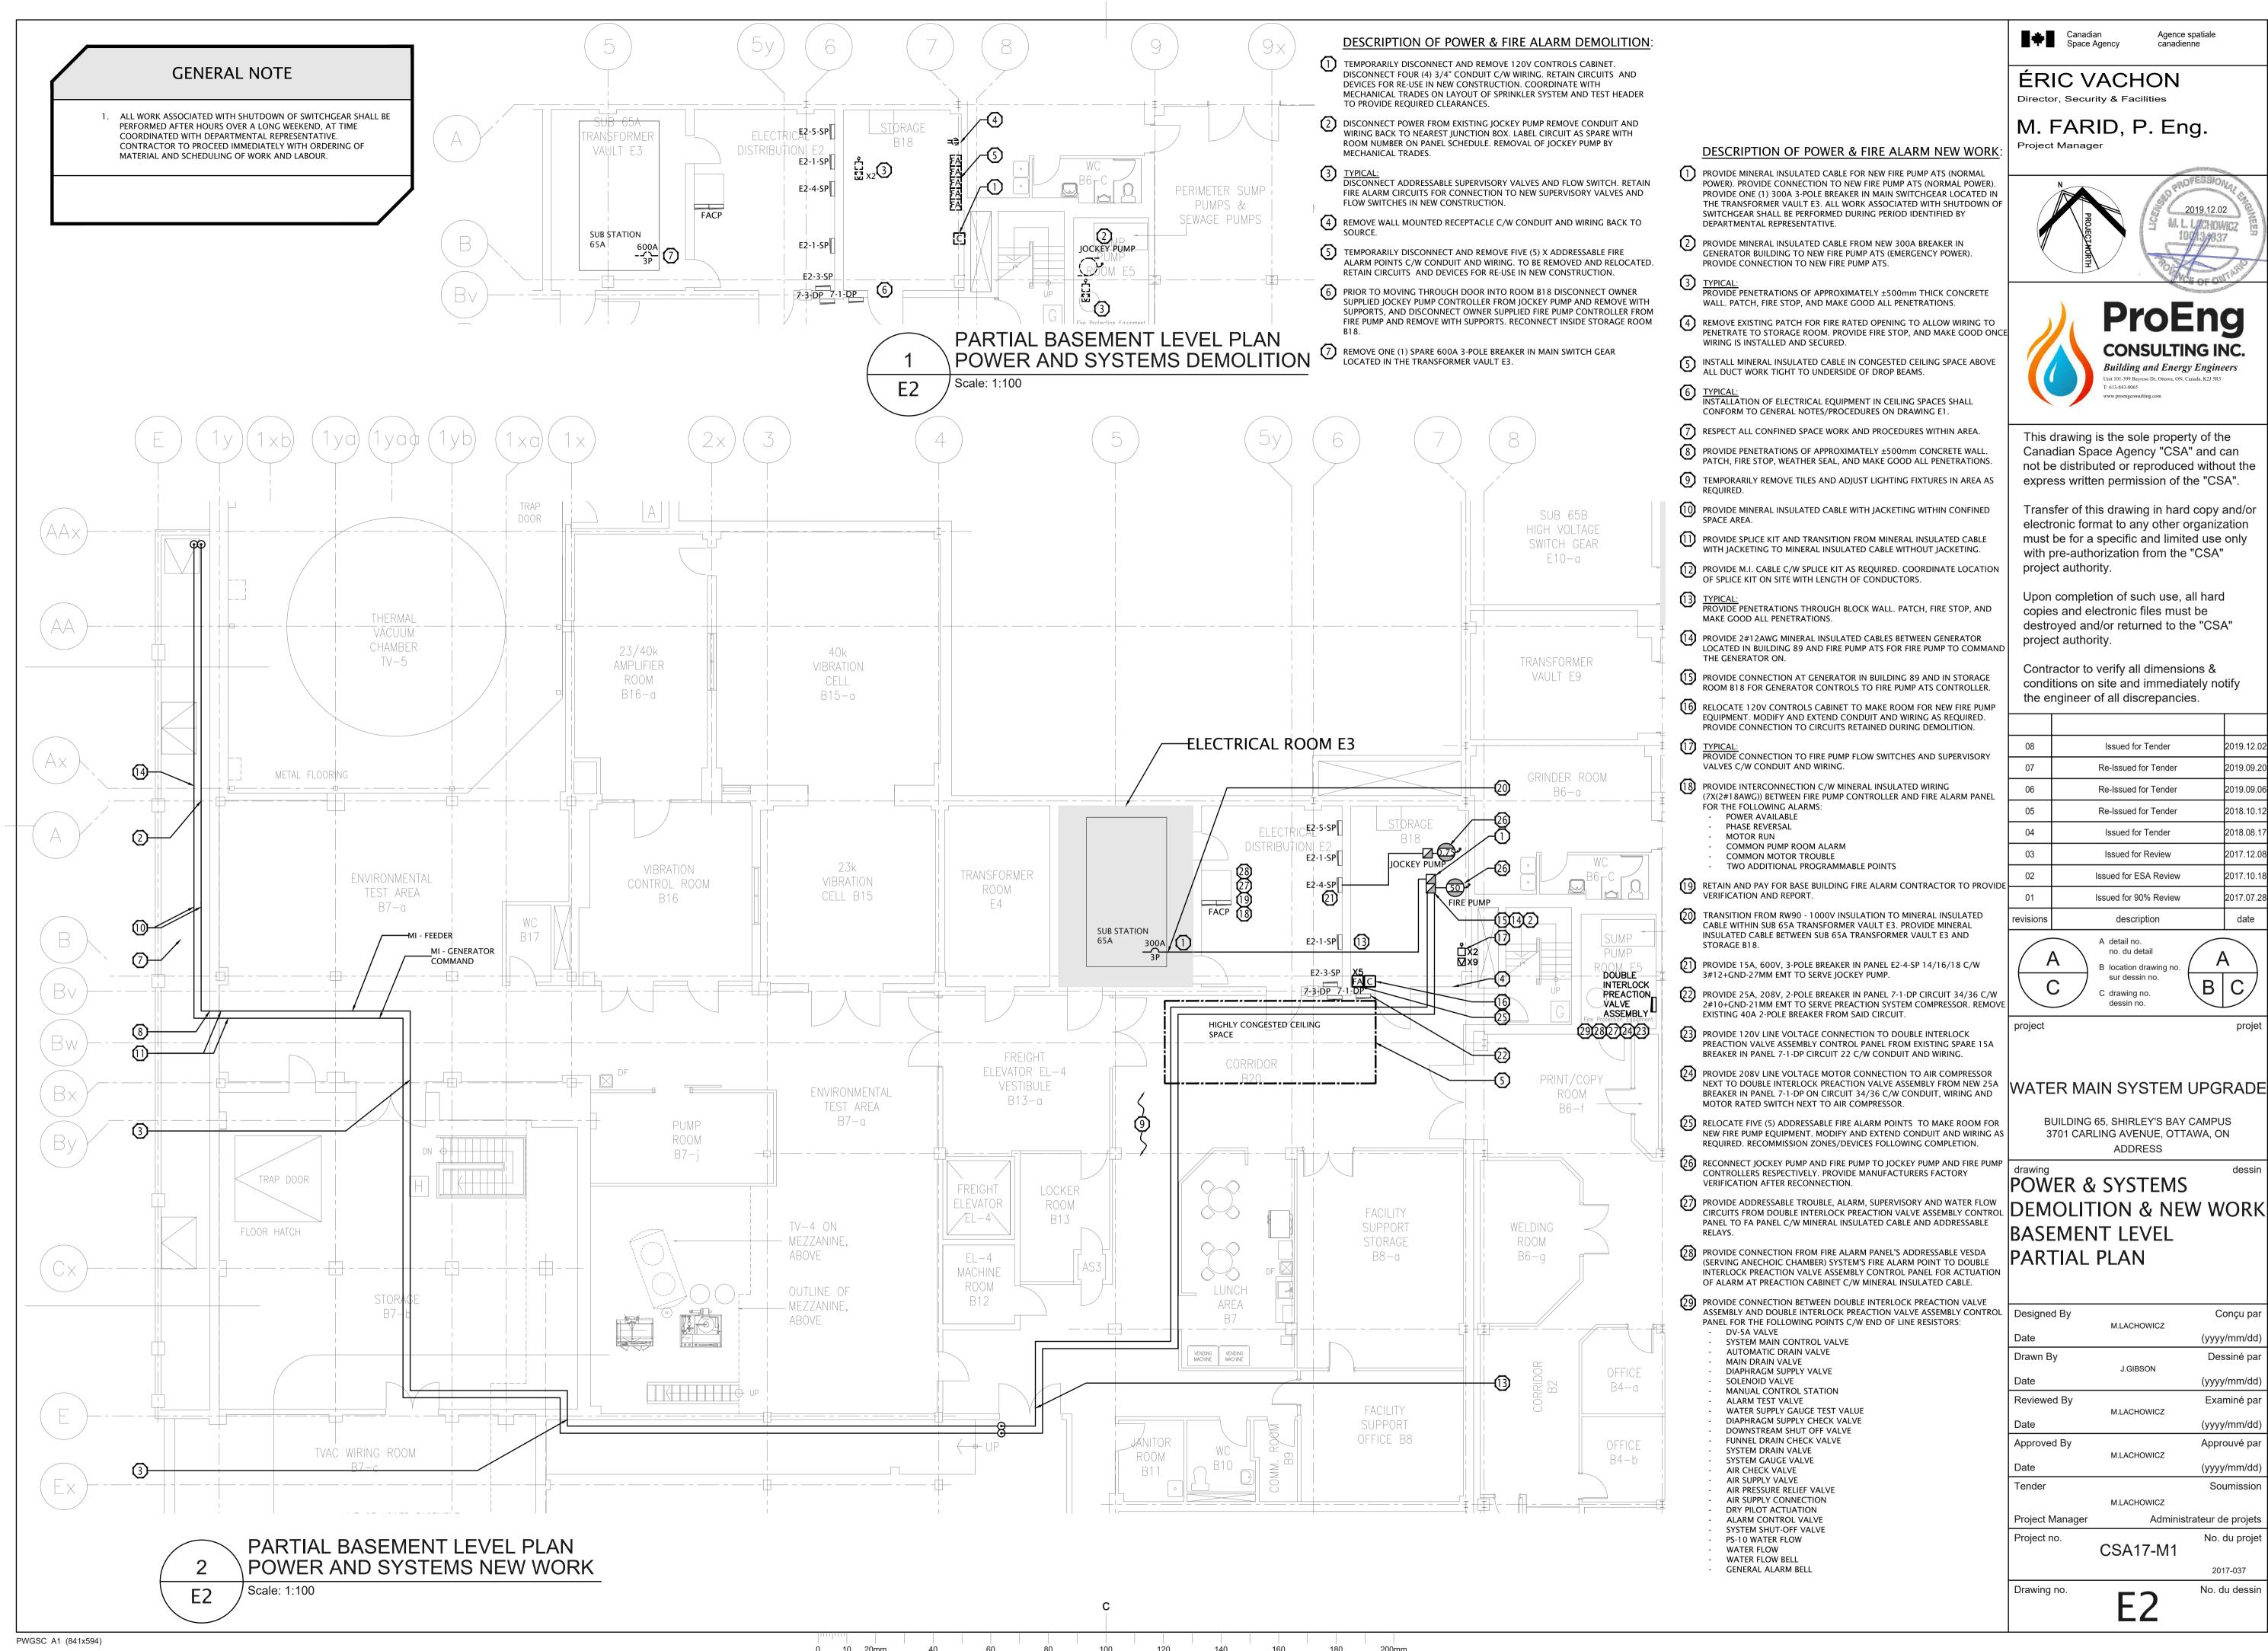






	08	Issued for Tender	2019.12.02
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	05	Re-Issued for Tender	2018.10.12
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	03	Issued for Review	2017.12.08
E	02	Issued for ESA Review	2017.10.18
	01	Issued for 90% Review	2017.07.28
	revisions	description	date

DEMOLITION & NEW WORK


Designed By		Conçu par
Date	M.LACHOWICZ	(yyyy/mm/dd)
Drawn By		Dessiné par
Date	J.GIBSON	(yyyy/mm/dd)
Reviewed By	M. A. O. J. O. W. O. Z.	Examiné par
Date	M.LACHOWICZ	(yyyy/mm/dd)
Approved By		Approuvé par
Date	M.LACHOWICZ	(yyyy/mm/dd)
Tender		Soumission
	M.LACHOWICZ	
Project Manager	Administ	rateur de projets
Project no.	CSA17-M1	No. du projet
		2017-037

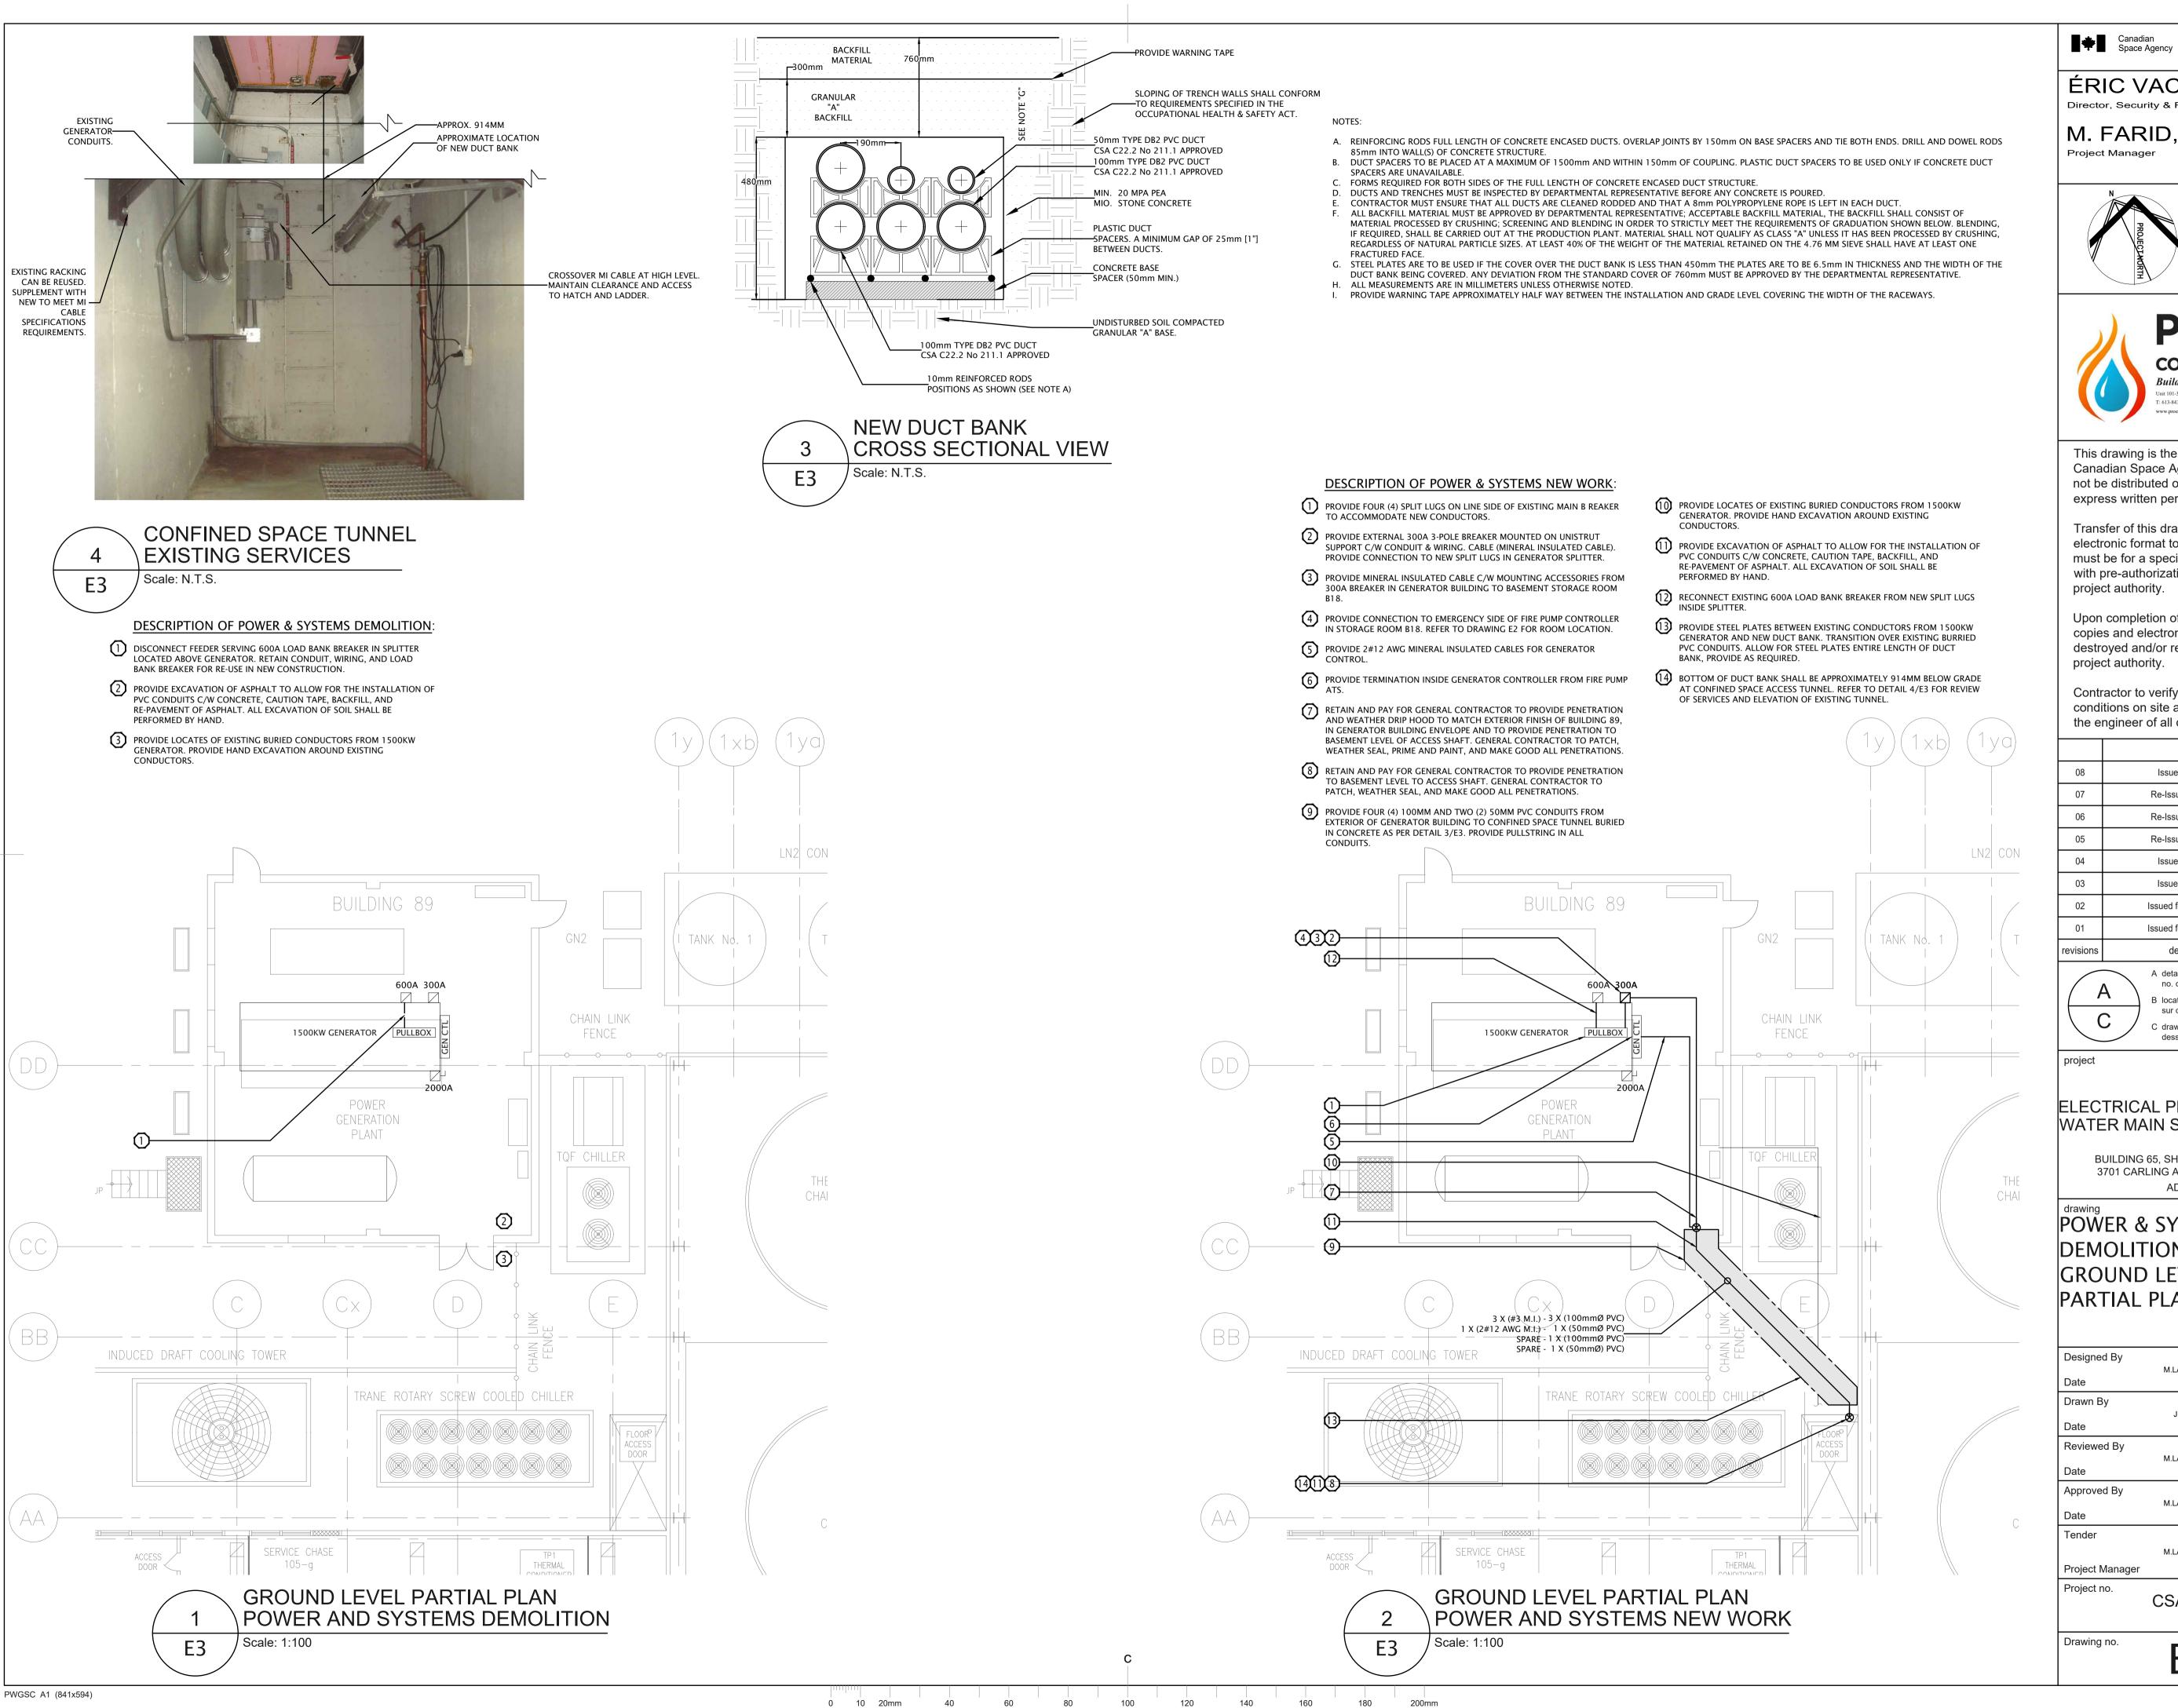

Agence spatiale

ÉRIC VACHON Director, Security & Facilities

M. FARID, P. Eng.

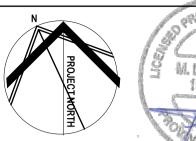





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A detail no. no. du detail B location drawing no sur dessin no.


ELECTRICAL PREPARATION FOR WATER MAIN SYSTEM UPGRADE

BUILDING 65, SHIRLEY'S BAY CAMPUS 3701 CARLING AVENUE, OTTAWA, ON **ADDRESS**

POWER & SYSTEMS DEMOLITION & NEW WORK GROUND LEVEL PARTIAL PLAN

Project no.	No. du projet	
Project Manager	Administrateur de projets	
Tender	M.LACHOWICZ	Soumission
Date		(yyyy/mm/dd)
	M.LACHOWICZ	
Approved By		Approuvé par
Date	WILACHOWICZ	(yyyy/mm/dd)
Reviewed By	M.LACHOWICZ	Examiné par
Date	5.5.2 .0 0N	(yyyy/mm/dd)
Drawn By	J.GIBSON	Dessiné par
Date		(yyyy/mm/dd)
Designed By	M.LACHOWICZ	Conçu par

2017-037 No. du dessir

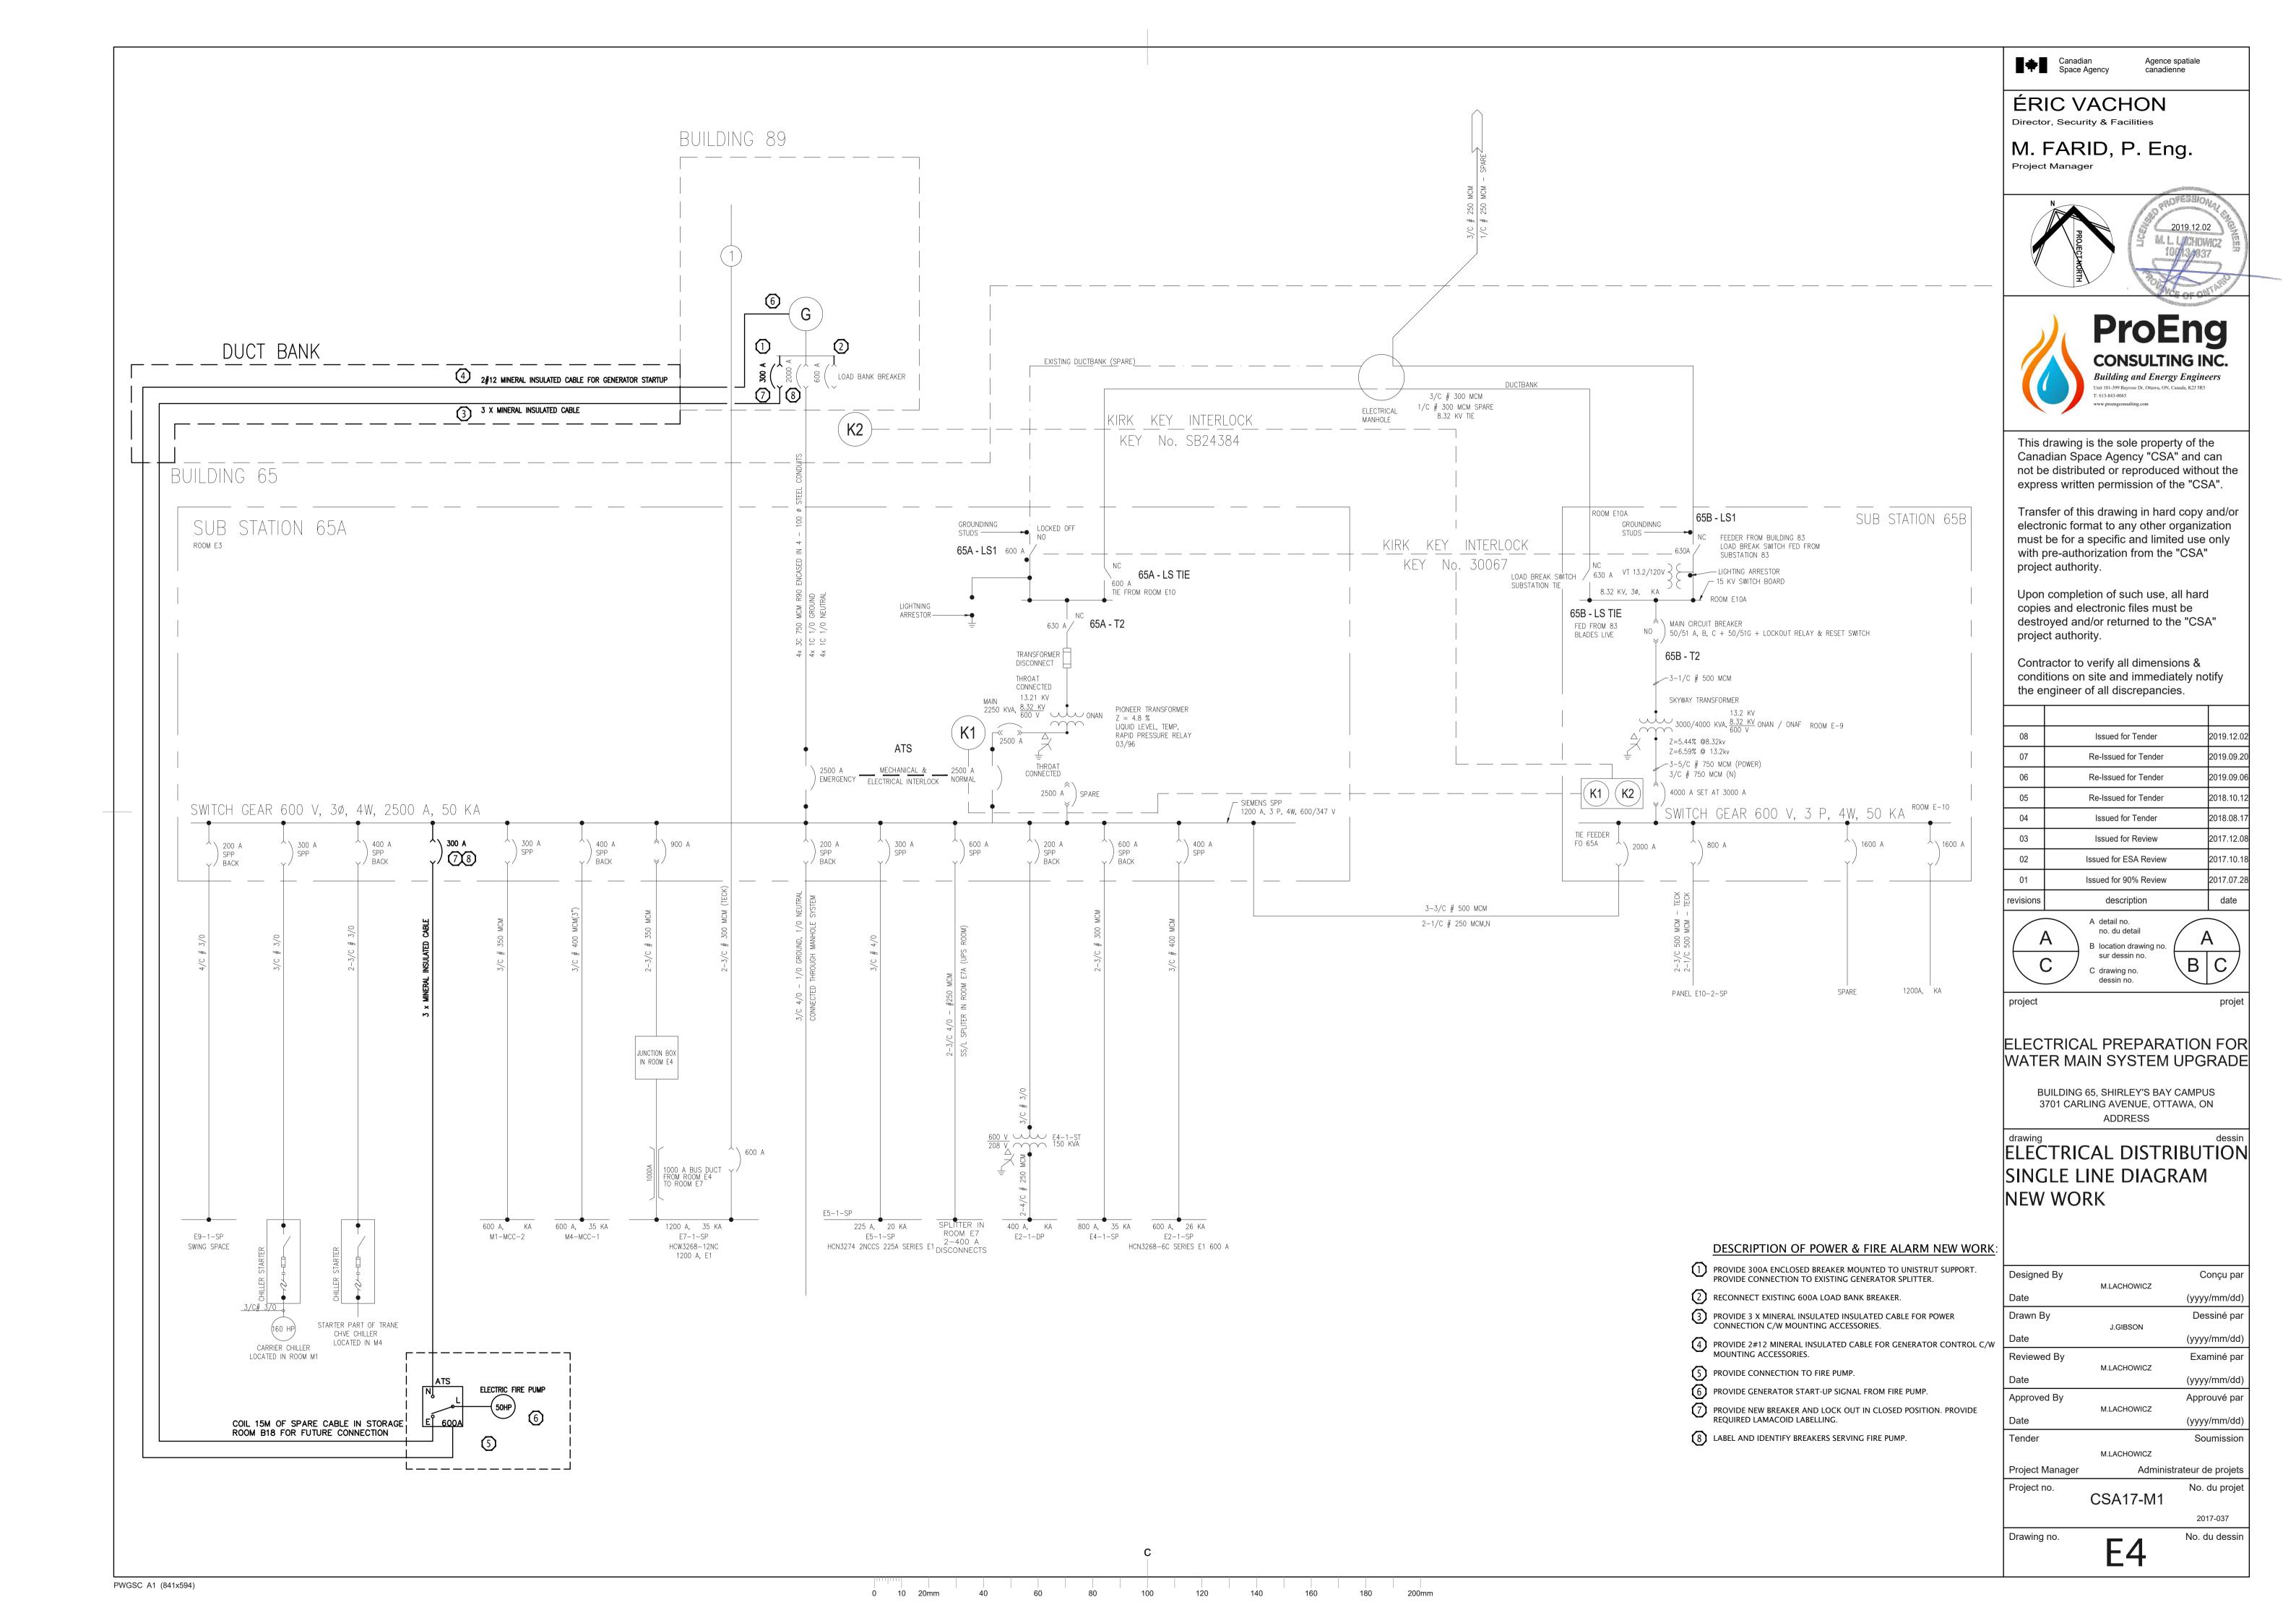










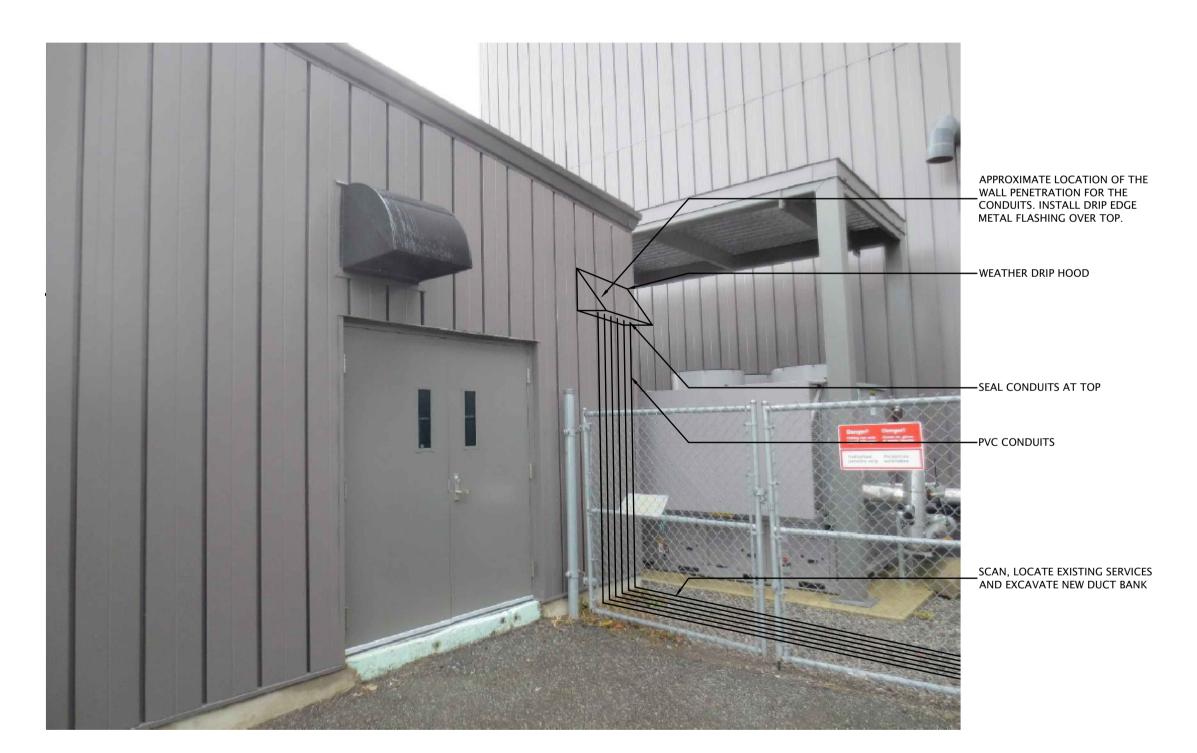

BUILDING 89
WALL PENETRATION

E5
Scale: N.T.S.

Canadian Space Agency Agence spatiale canadienne

ÉRIC VACHON
Director, Security & Facilities

M. FARID, P. Eng.






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B location drawing no. sur dessin no.

C drawing no. dessin no.

ELECTRICAL PREPARATION FOR WATER MAIN SYSTEM UPGRADE

BUILDING 65, SHIRLEY'S BAY CAMPUS 3701 CARLING AVENUE, OTTAWA, ON ADDRESS

POWER & SYSTEMS
BUILDING 89
REFERENCE PICTURES

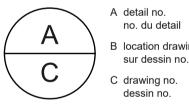Designed By		Conçu par
Date	M.LACHOWICZ	(yyyy/mm/dd)
Drawn By		Dessiné par
Date	J.GIBSON	(yyyy/mm/dd)
Reviewed By		Examiné par
Date	M.LACHOWICZ	(yyyy/mm/dd)
Approved By		Approuvé par
Date	M.LACHOWICZ	(yyyy/mm/dd)
Tender		Soumission
	M.LACHOWICZ	
Project Manager	Administ	rateur de projets
Project no.	CSA17-M1	No. du projet
		2017-037
Drawing no.		No. du dessin

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