

NOTES

1. CEILING MOUNTED EXIT LIGHTS AND EMERGENCY LIGHT TO BE REMOVED AND REINSTALLED IN NEW CEILING.
2. EMERGENCY LIGHTING UNIT TO CSA C22.2 NO.141, 120 VAC SUPPLY, 12 VDC OUTPUT, 60 MINUTE OPERATING TIME, SEALED, MAINTENANCE FREE BATTERY, MINIMUM 115 WATTS FOR 60 MINUTES. SOLID STATE REGULATED CHARGER, SOLID STATE TRANSFER CIRCUIT, SIGNAL LIGHTS FOR AC POWER ON AND HIGH CHARGE. LAMP HEADS INTEGRAL ON UNIT, 345 DEGREES HORIZONTAL AND 190 DEGREES VERTICAL ADJUSTMENT, LAMP TYPE MR16 LED, 6 WATT, MOUNTED INSIDE VANDAL RESISTANT LEXAN COVER, AUTOMATIC TEST SELF-DIAGNOSTICS, BATTERY DISCONNECT DEVICE AND TEST SWITCH.

TEK CONSULTANTS LIMITED
CONSULTING ELECTRICAL ENGINEERS

P.O. BOX 1
FREDERICTON, NB
E3B 4Y2

TEL: (506) 458-9661
tek@tekcon.ca



0	ISSUED FOR TENDER	MAR/27 2020
revisions		date

project
**MACTAQUAC
BIODIVERSITY FACILITY,
ADMINISTRATION BUILDING
RENOVATIONS
FRENCH VILLAGE, N.B.**

drawing
design


LIGHTING

designed	SDF	conçu
date	MARCH 2020	
drawn	EFS/SDF	dessiné
date	MARCH 2020	
approved	BET	approuvé
date	MARCH 2020	
Tender		Soumission

PWSC Project Manager
Administrateur de projets TPSCG

project number
R.104486.001

drawing no.
E2

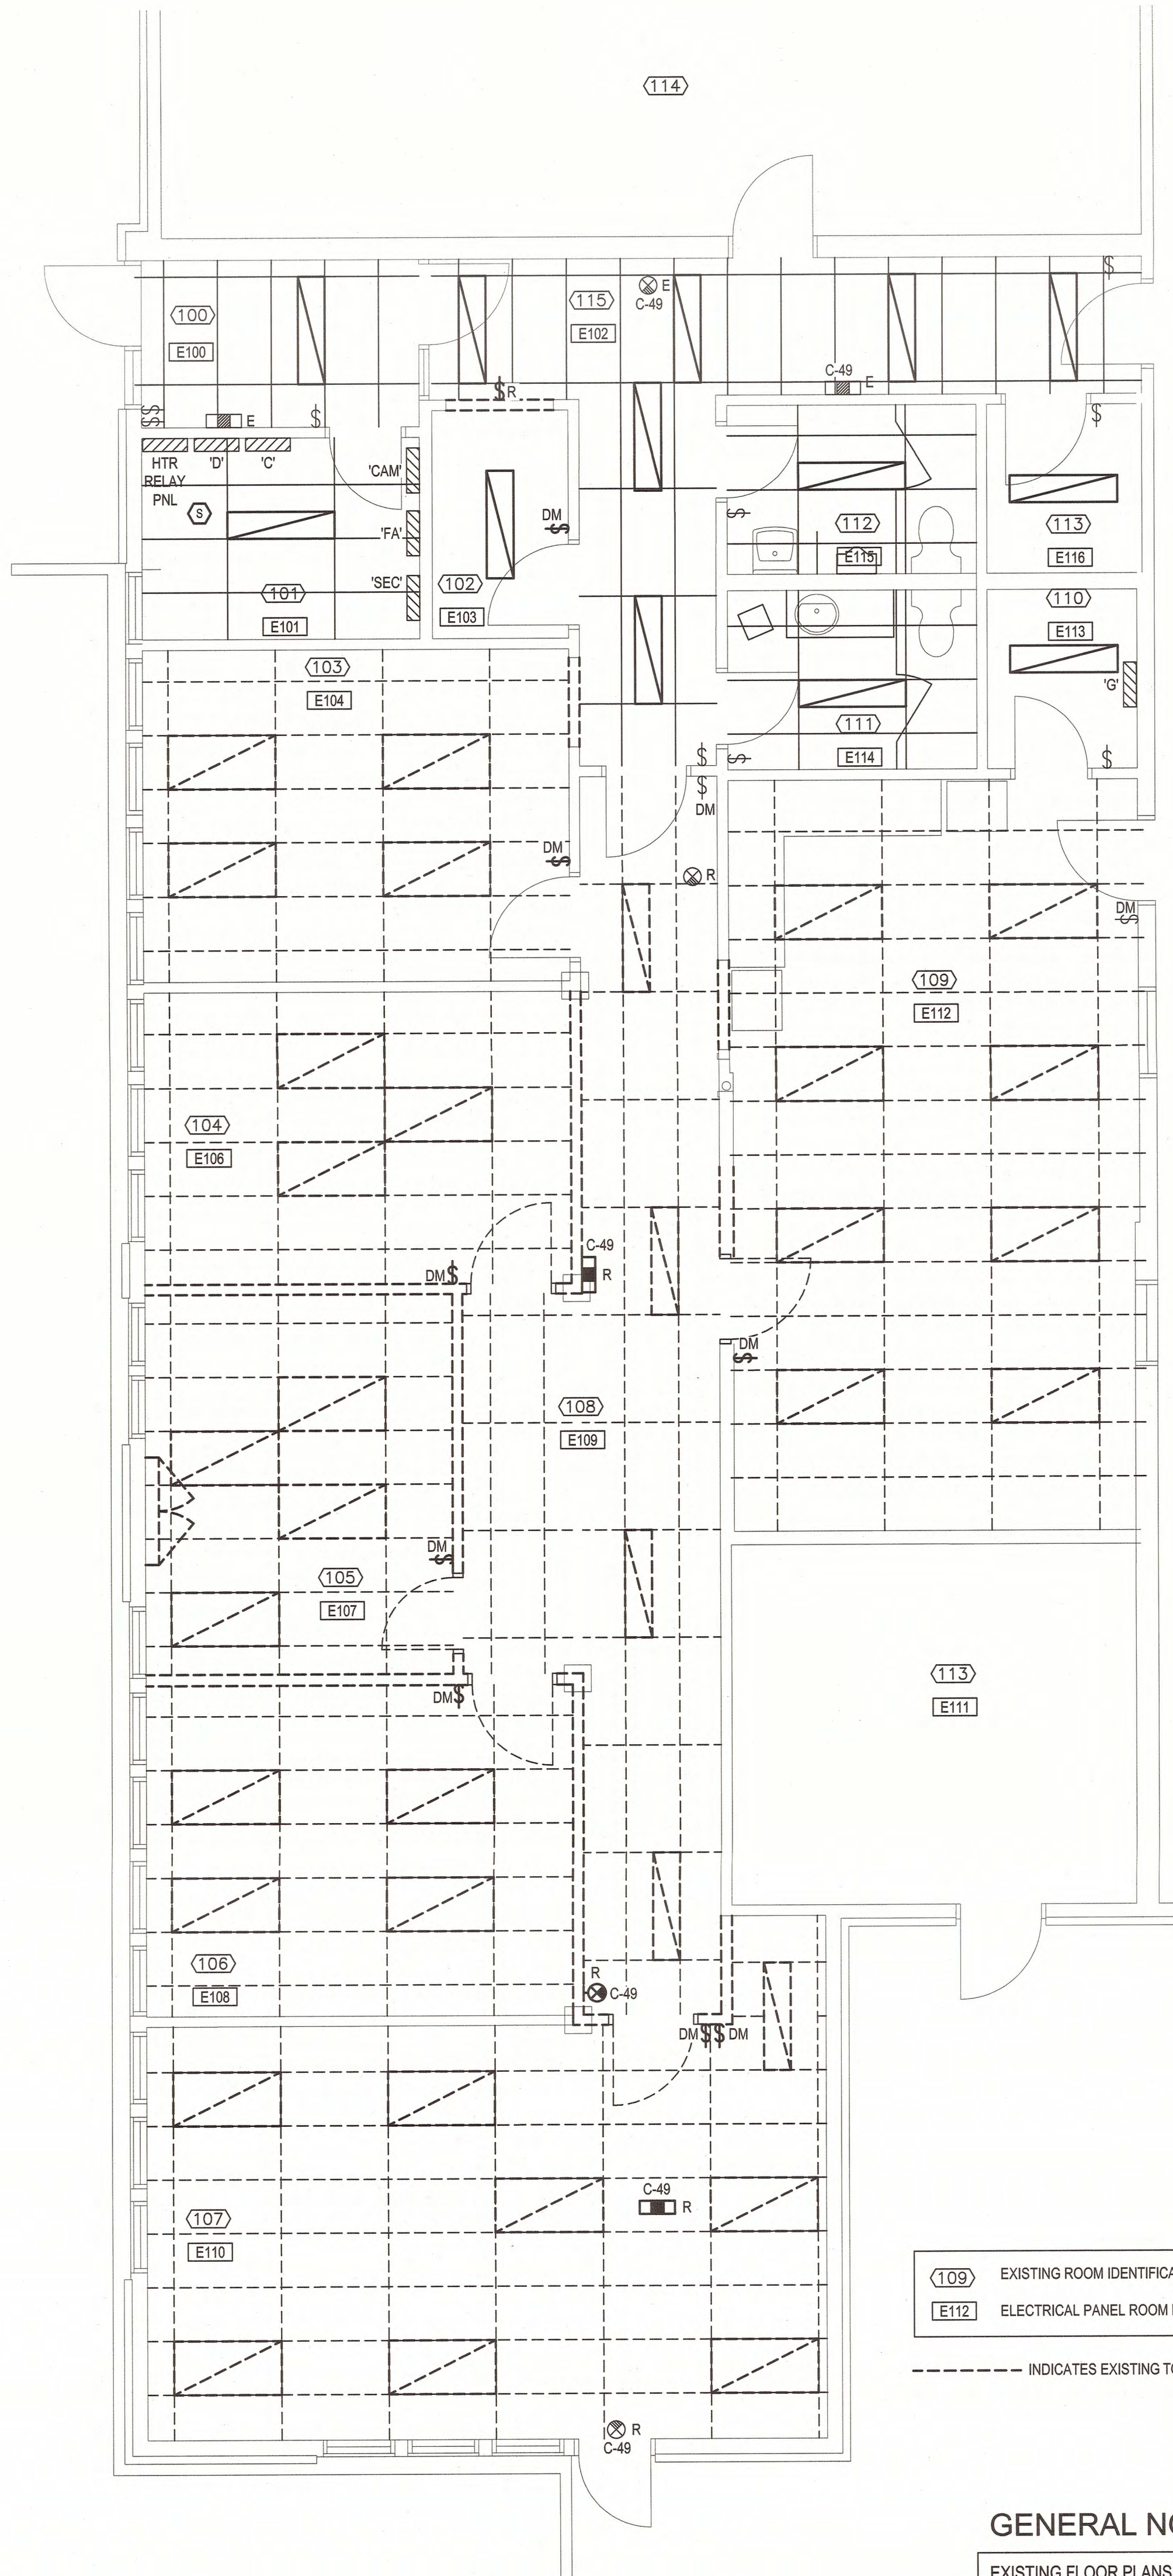

(109) EXISTING ROOM IDENTIFICATION
(E112) ELECTRICAL PANEL ROOM IDENTIFICATION
----- INDICATES EXISTING TO BE REMOVED


GENERAL NOTES

EXISTING FLOOR PLANS ARE ISSUED FOR INFORMATION ONLY AND SHOWS MAJOR ITEMS ONLY. CONTRACTOR SHALL EXAMINE ARCHITECTURAL, MECHANICAL AND ELECTRICAL DRAWINGS, VISIT THE SITE TO VERIFY EXISTING EQUIPMENT AND CONDITIONS AND SCOPE OF WORK INVOLVED IN DEMOLITION PRIOR TO SUBMITTING A TENDER.

DEVICES SHOWN ON EXISTING FLOOR PLAN BUT NOT SHOWN ON RENOVATION FLOOR PLAN ARE TO BE REMOVED C/W UNUSED WIRING, UNLESS NOTED OTHERWISE.

EXISTING LIGHTING

SCALE : 1:50
0m 1m 2m 3m 4m 5m

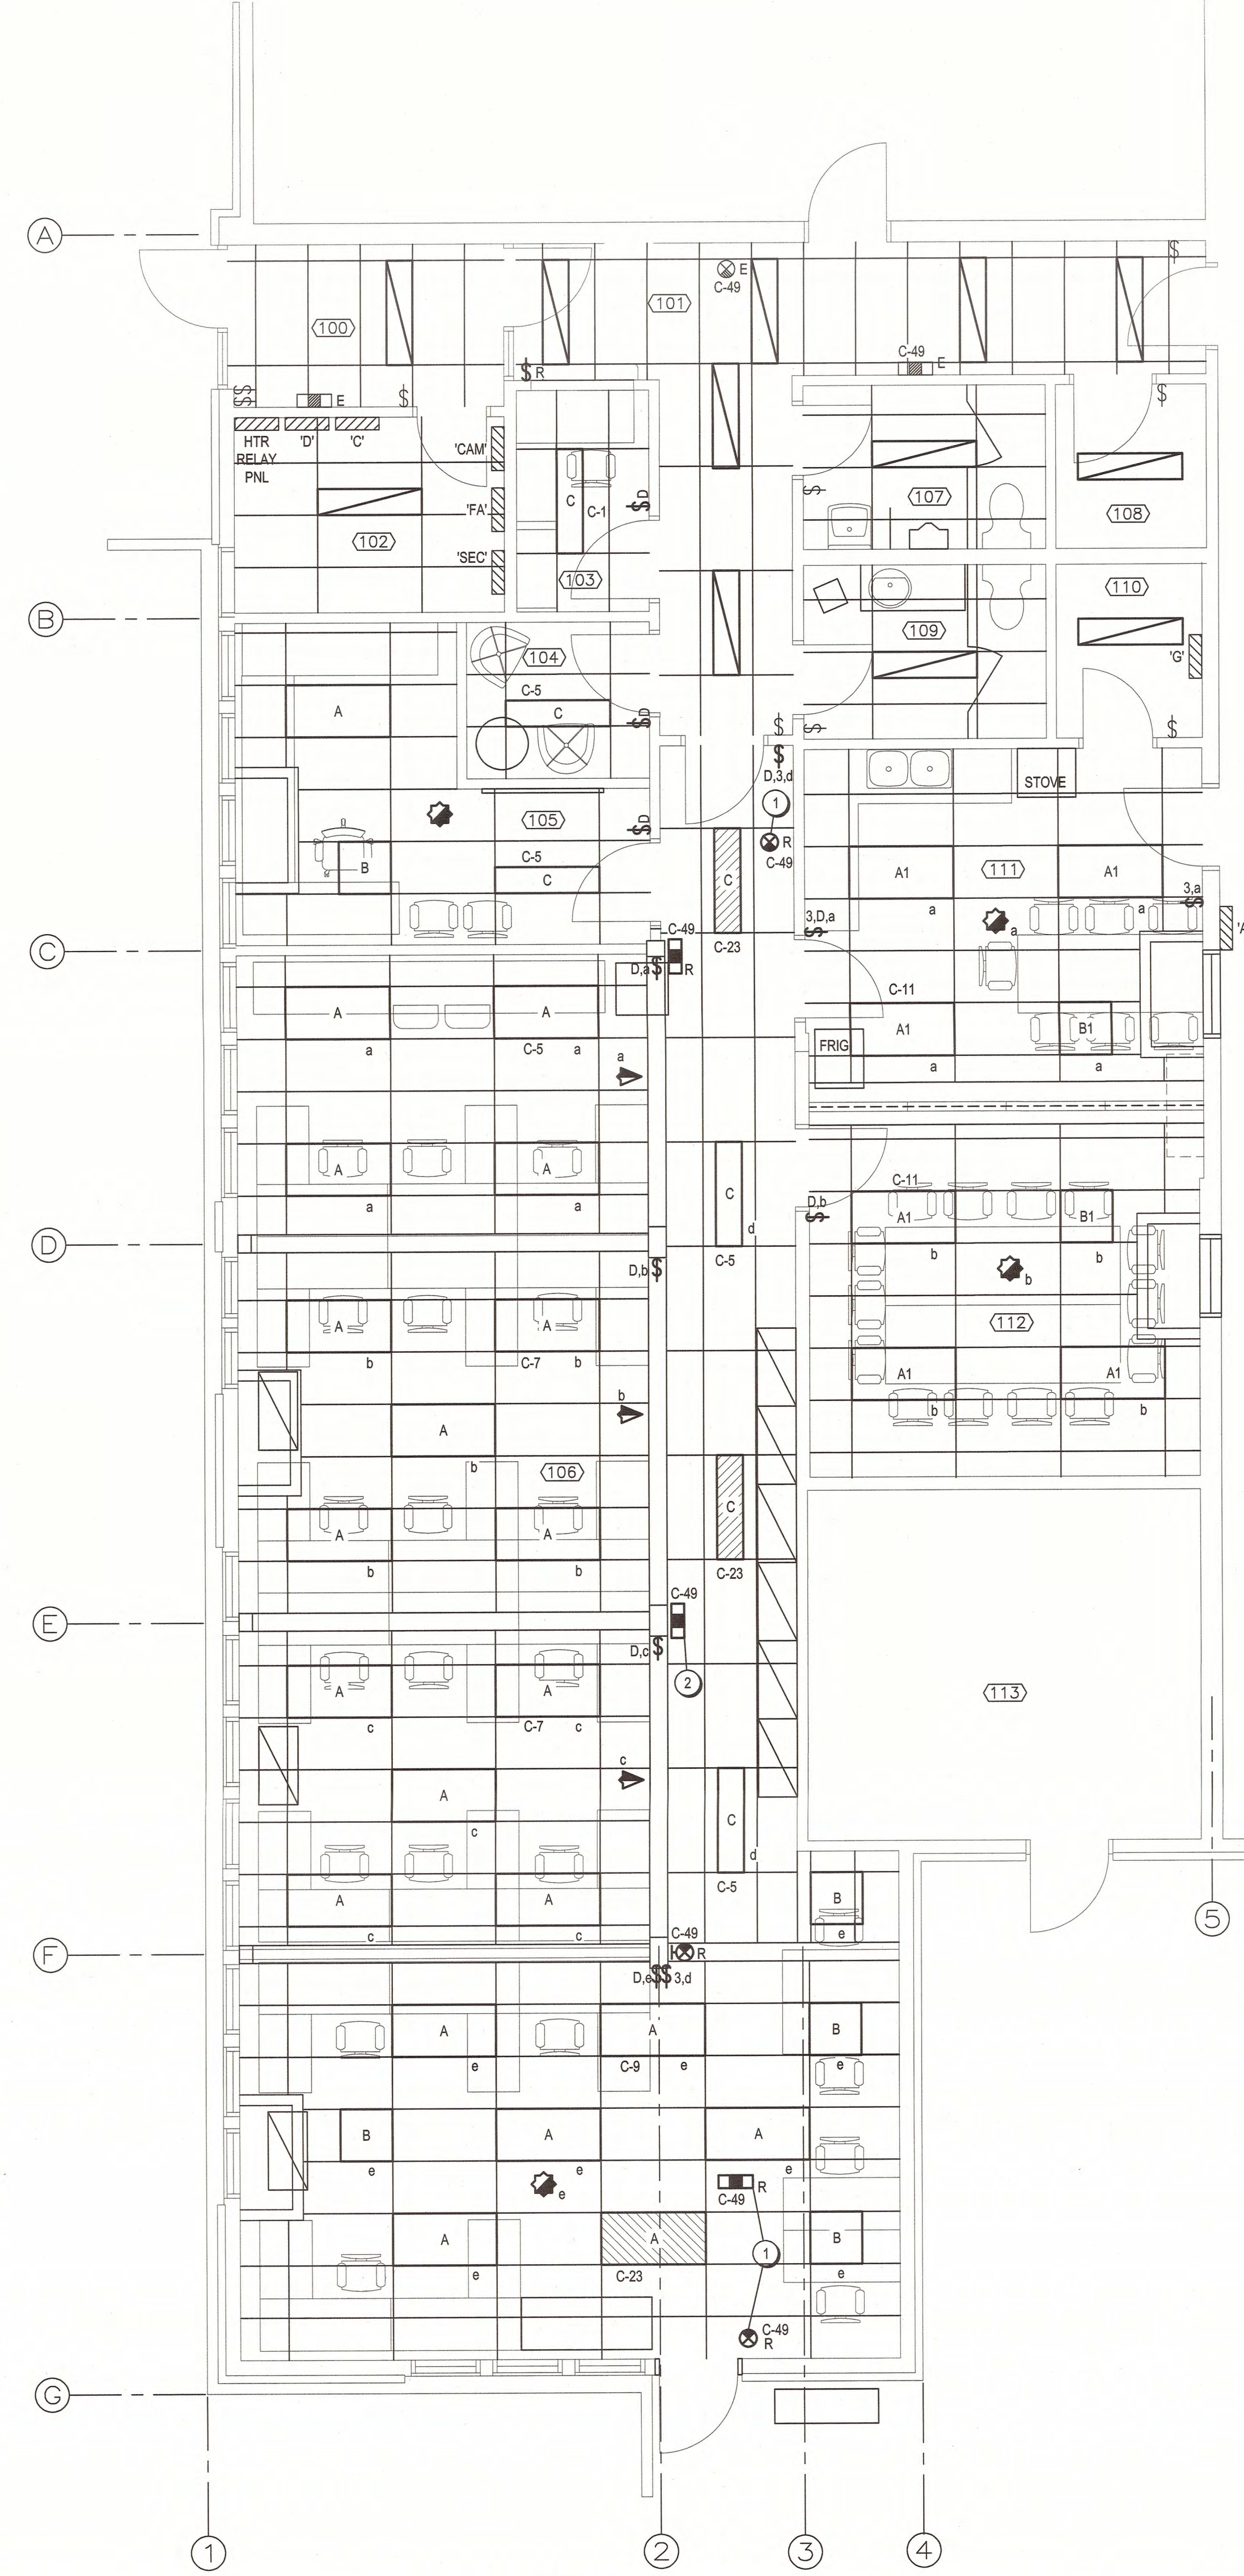

LIGHTING

SCALE : 1:50
0m 1m 2m 3m 4m 5m