






GENERAL NOTES:
1. ALL DIMENSIONS ARE IN MILLIMETERS. SITE VERIFY BEFORE PROCEEDING WITH WORK.

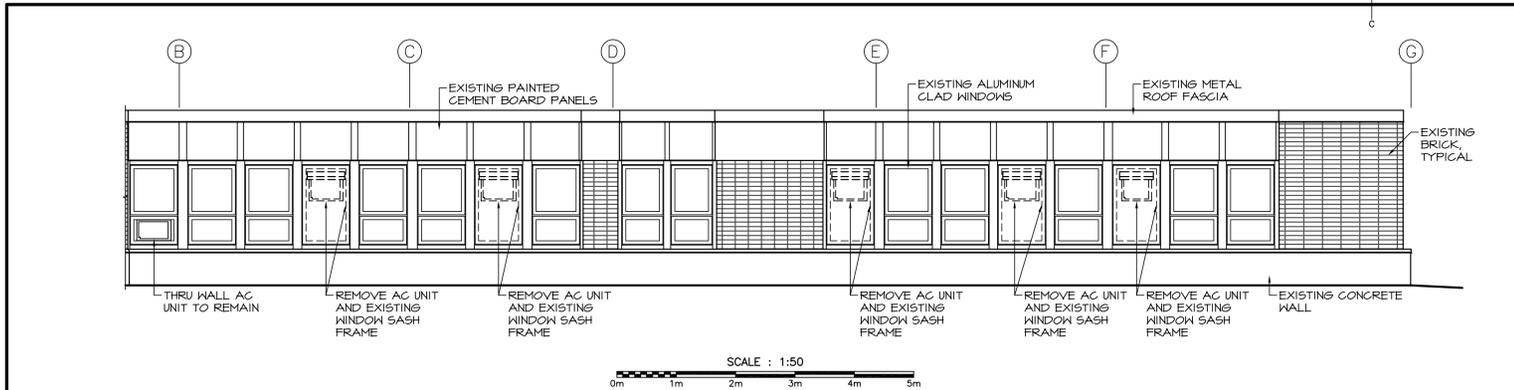


1) EXISTING FRONT WALL EXTERIOR ELEVATION
SCALE 1:50

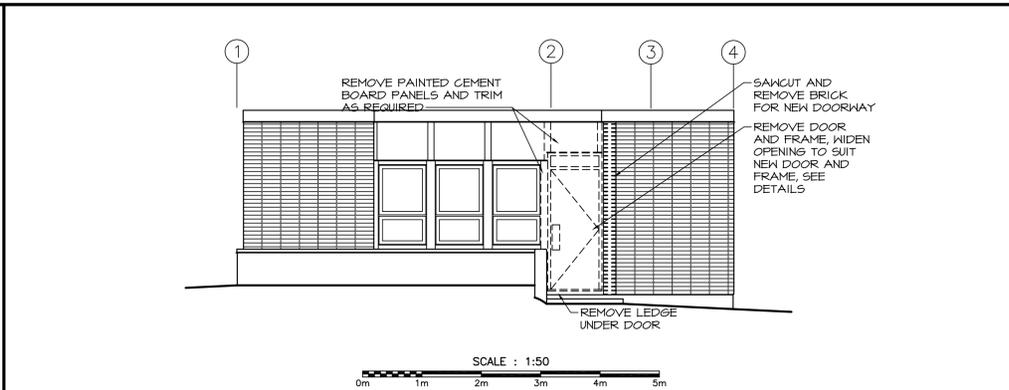


2) EXISTING END WALL EXTERIOR ELEVATION
SCALE 1:50

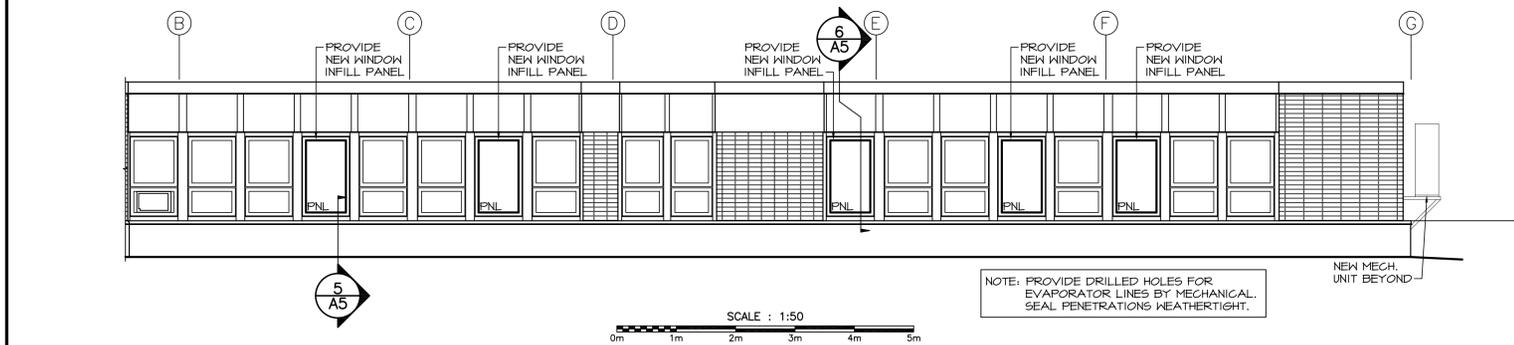


3) NEW FRONT WALL EXTERIOR ELEVATION
SCALE 1:50

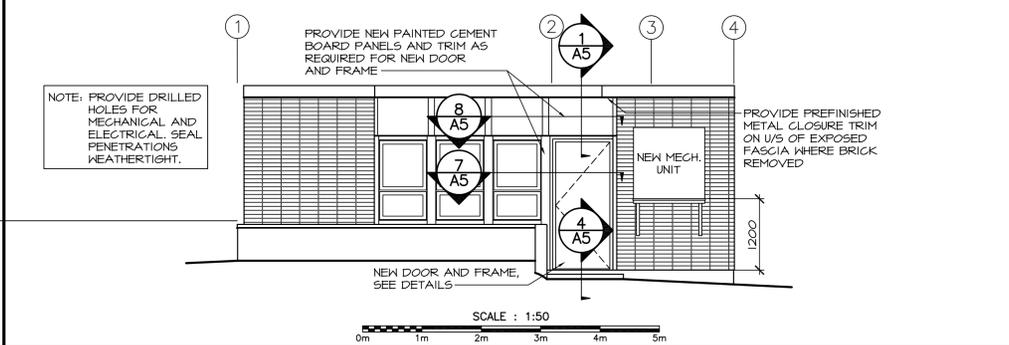


4) NEW END WALL EXTERIOR ELEVATION
SCALE 1:50

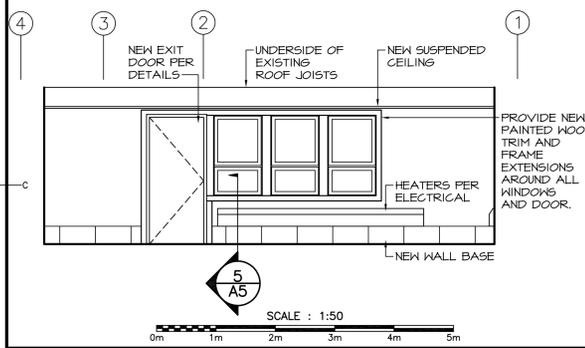

5) ROOM 106 END WALL INTERIOR ELEVATION
SCALE 1:50

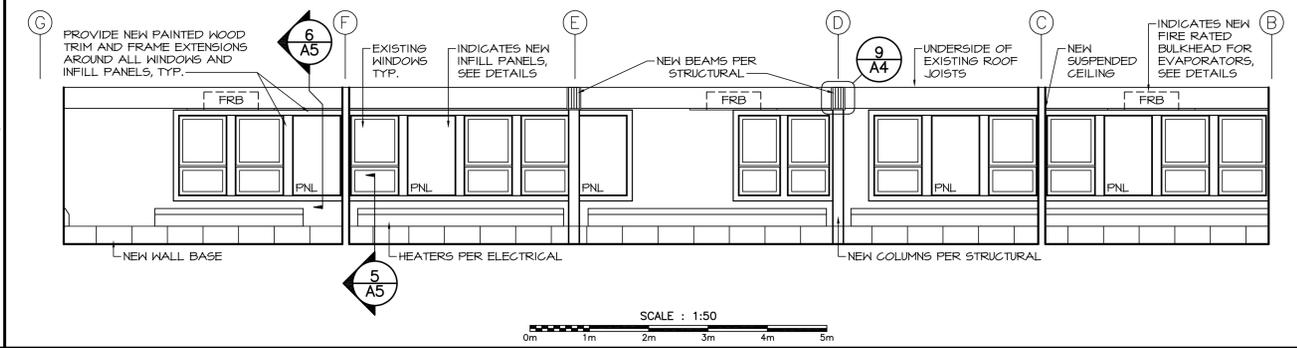

6) ROOM 106 FRONT WALL INTERIOR ELEVATION
SCALE 1:50

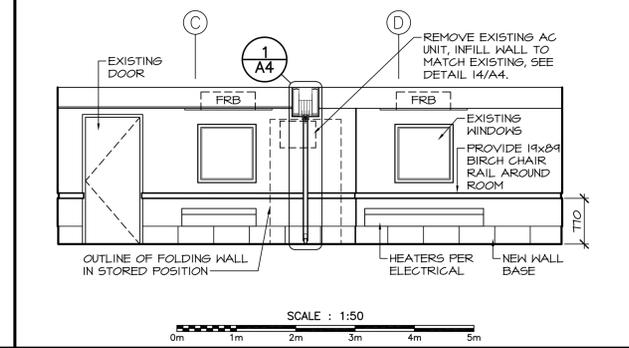

7) ROOM 111 & 112 INTERIOR ELEVATION
SCALE 1:50

DOOR SCHEDULE




LOCATION	SIZE (W x H)	ELEVATION	HARDWARE SET	FIRE RATING
103 RECEPTION	914 x 2134	A	2	-
104 PRIVACY	914 x 2134	A	2	-
105 OFFICE	914 x 2134	A	2	-
106 OPEN OFFICE	914 x 2134	B	1	-
III KITCHEN	914 x 2134	A	3	-
112 MEETING	914 x 2134	A	2	-

FINISH SCHEDULE

LOCATION	FLOOR	BASE	WALLS	CEILING
100 VESTIBULE	-	RUB	P1	-
101 HALLWAY	-	RUB	P1	ACP 2
102 ELECTRICAL	-	-	P2	ACP 2
103 RECEPTION	CT	CT	P1	ACP 1
104 PRIVACY	CT	CT	P1	ACP 1
105 OFFICE	CT	CT	P1	ACP 1
106 OPEN OFFICE	CT	CT	P1	ACP 1
107 MALE WR	-	-	-	-
108 CUSTODIAL	-	-	-	-
109 FEMALE WR	-	-	-	-
110 ELECTRICAL	-	-	-	-
III KITCHEN	CT (NOTE 6)	CT	PI, WD	ACP 1
112 MEETING	CT	CT	PI, WD	ACP 1
113 LOCKER	-	-	-	-
MECHANICAL	-	-	P2	-

PARTITION SCHEDULE

P1	- 15.9mm TYPE "X" GYPSUM BOARD - 6 MIL POLY VAPOUR RETARDER - EXISTING BATT THERMAL INSULATION - EXISTING WOOD STUD FRAMING, SHEATHING, EXTERIOR CLADDING (NOT SHOWN)
P2	- 15.9mm TYPE "X" GYPSUM BOARD - RESILIENT METAL CHANNEL @ 400 C.C. - 89mm ACOUSTIC BATT INSULATION - EXISTING WOOD STUD FRAMING - EXISTING WALL FINISH
P3	- 15.9mm TYPE "X" GYPSUM BOARD - RESILIENT METAL CHANNEL @ 400 C.C. - 89mm ACOUSTIC BATT INSULATION - EXISTING WOOD STUD FRAMING - EXISTING WALL FINISH
P4	- 15.9mm TYPE "X" GYPSUM BOARD - RESILIENT METAL CHANNEL @ 400 C.C. - 89mm ACOUSTIC BATT INSULATION - EXISTING WOOD STUD FRAMING - EXISTING WALL FINISH
P5	- 15.9mm TYPE "X" GYPSUM BOARD - RESILIENT METAL CHANNEL @ 400 C.C. - 89mm ACOUSTIC BATT INSULATION - WOOD STUD FRAMING @ 400 C.C. - 2 LAYERS 15.9 mm TYPE "X" GYPSUM BOARD

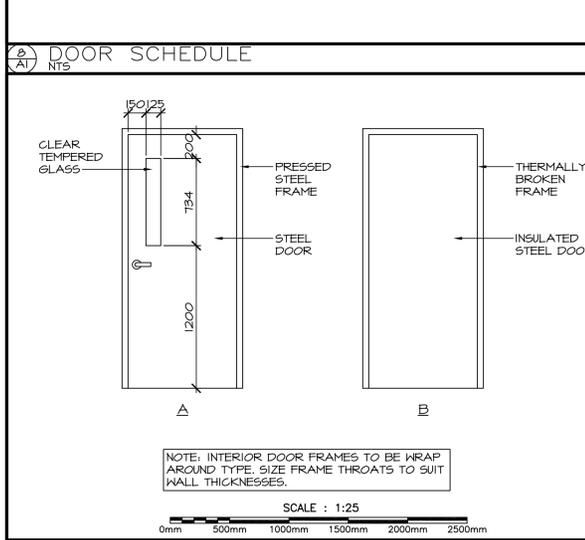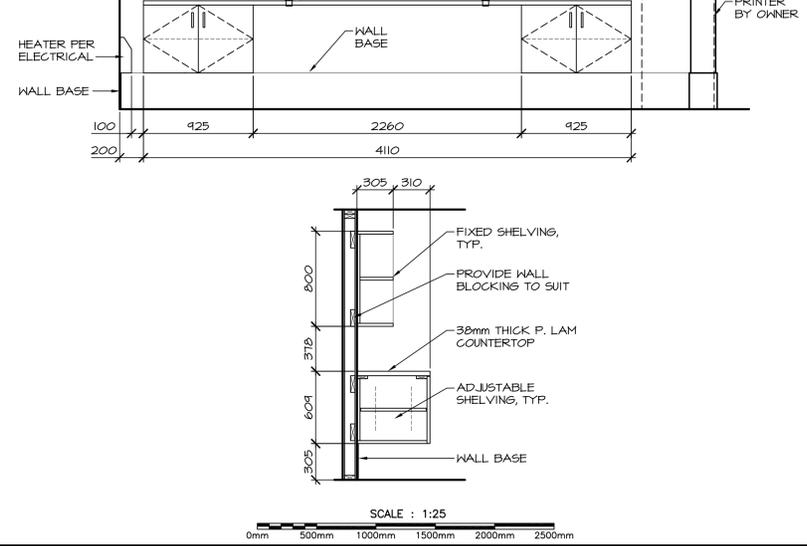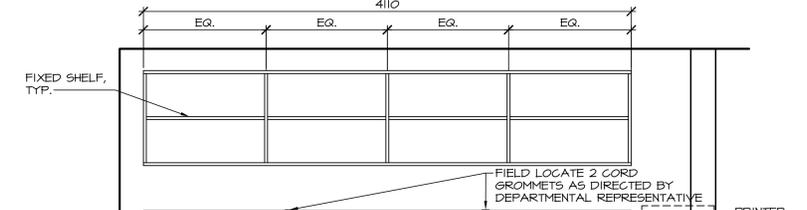

LEGEND

- P1 - PAINT ALL WALLS, COLUMNS, AND BULKHEADS.
- P2 - TOUCH UP PAINT AREAS AFFECTED BY THE WORK TO MATCH EXISTING.
- CT - CERAMIC TILE
- WD - PROVIDE CLEAR FINISHED 19x89 BIRCH CHAIR RAIL AROUND ROOM
- RUB - REMOVE EXISTING RUBBER BASE AND PROVIDE NEW RUBBER BASE
- ACP 1 - FIRE RATED SUSPENDED ACOUSTIC PANEL SYSTEM
- ACP 2 - CUT AND PATCH EXISTING ACOUSTIC PANEL SYSTEM WHERE AFFECTED BY THE WORK
- INDICATES NO FINISH REQUIRED

GENERAL FINISH SCHEDULE NOTES

- PAINT DOORS AND FRAMES IN ROOM WHERE WALLS ARE TO BE PAINTED.
- PAINT ACCESS DOORS AND EXPOSED SERVICES TO MATCH THE COLOUR OF THE PAINT ON THE SURFACE WHICH THEY OCCUR.
- PAINT WOOD WINDOW AND DOOR TRIM AND WINDOW INFILL PANELS.
- PAINT NEW EXTERIOR CEMENT BOARD PANELS TO MATCH EXISTING ADJACENT.
- PAINT NEW EXTERIOR STEEL SUPPORT FRAME FOR MECHANICAL UNIT.
- SEE FLOOR PLAN FOR EXTENT OF EXISTING FLOOR TILE TO REMAIN IN KITCHEN.

GENERAL PARTITION SCHEDULE NOTES

- INTERIOR PARTITIONS: EXTEND GYPSUM BOARD AND FRAMING TO UNDERSIDE OF ROOF DECK. CUT AND FIT AROUND EXISTING ROOF JOISTS.
- EXTERIOR WALLS: EXTEND GYPSUM BOARD TO UNDERSIDE OF ROOF FRAMING INSTEAD OF UNDERSIDE OF ROOF DECK.
- FIRESTOP INTERIOR PARTITION WALL PENETRATIONS AND AT TERMINATIONS TO ROOF DECK AND AROUND ROOF JOISTS.
- IN EXISTING WALLS, PROVIDE ADDITIONAL WOOD FRAMING AS REQUIRED TO INFILL OPENINGS, REFRAME NEW OPENINGS, PROVIDE NEW BLOCKING AND SUPPLEMENTARY FRAMING REQUIRED FOR GYPSUM BOARD SECUREMENT.



Issued for Tender Mar 27 2020

revisions project project
MACTAQUAC BIODIVERSITY FACILITY ADMINISTRATION BUILDING RENOVATIONS FRENCH VILLAGE, N.B.

designed congu
INTERIOR AND EXTERIOR ELEVATIONS AND SCHEDULES

drawn D. CLARK dessiné
approved approuvé
date
Tender Soumission
PWSC Project Manager Administrateur de projets TPSCG
project number no. du projet
R.104486.001
drawing no. no. du dessin
A1