


FISHERIES AND OCEAN CANADA IOS NEW GUARD HOUSE

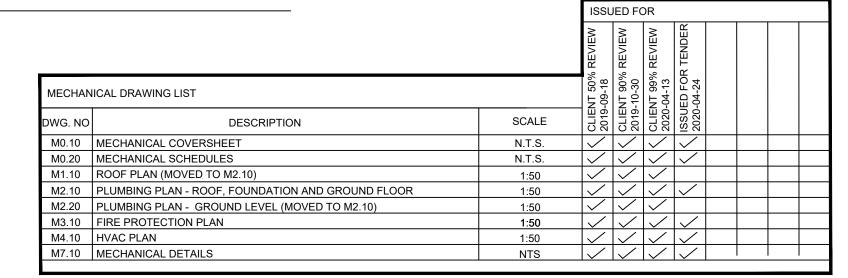


BUILDING LOADS

OMESTIC WATER

DESCRIPTION

TORM

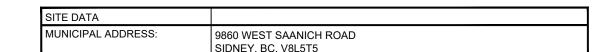

1. STORM LOAD IS BASED ON 9mm/15 MINUTE RAINFALL INTENSITY.


2. DOMESTIC WATER SIZED TO ASPE UNIFORM PRESSURE LOSS METHOD,

BASED ON MAXIMUM 5FT/S USING COPPER PIPE UNLESS OTHERWISE

LOAD UNITS PIPE SIZE NOTES

53.5 FU 50Ø

2 L/S 50Ø

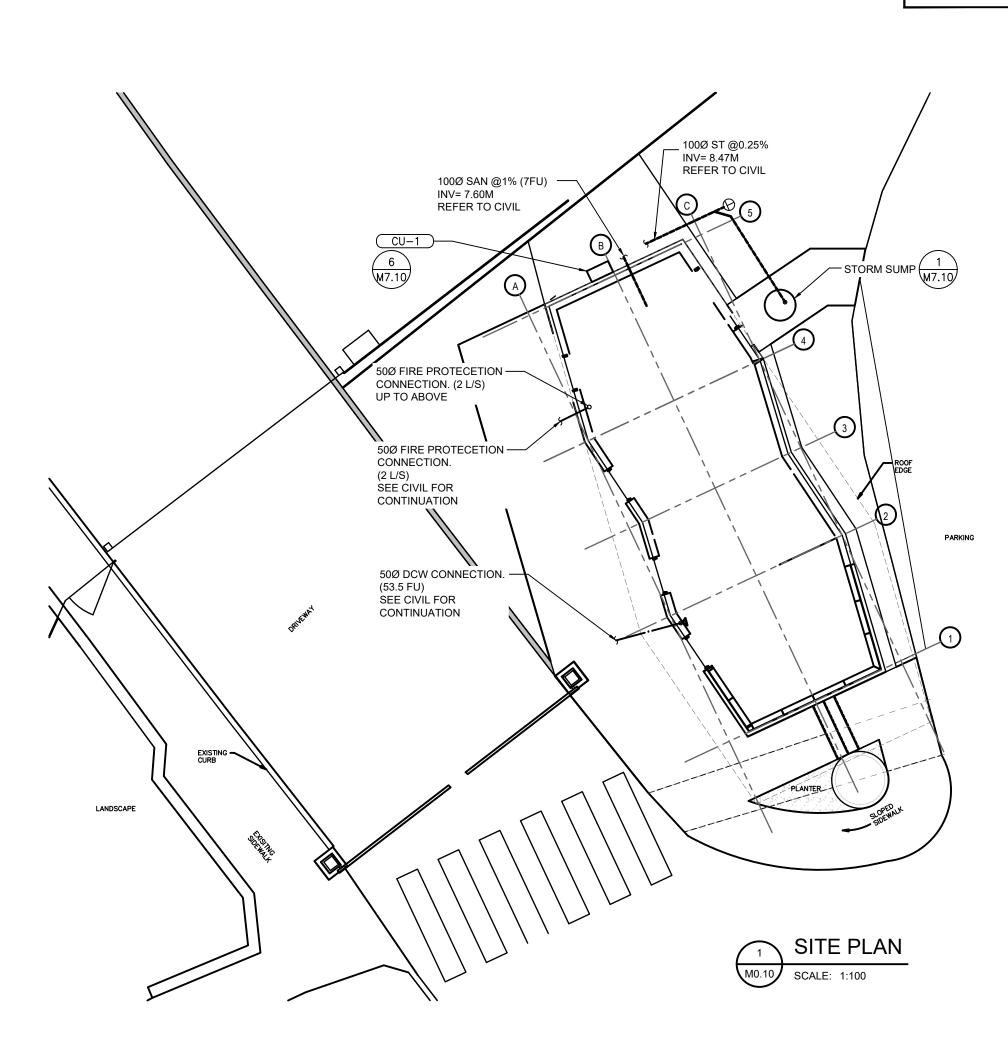

FISHERIES AND OCEANS CANADA REAL PROPERTY AND SAFETY AND SECURITY SCALE **INSTITUTE OF OCEAN**

DAJ DRAWN DAJ/SR CHECKED PPROVED Issued for 90% Review
Issued for 50% Review

REVISIONS

NO. DATE

SCIENCES NEW GUARDHOUSE 9860 WEST SAANICH ROAD SIDNEY, BC, V8L 5T5

*

APPROVED

START DATE DRAWING NUMBER

AS SHOWN

REVISION

RATIO

NOTES

PWGSC - A1 - 841X594

DWG. NO.

DRAWING REFERENCES

MECHANICAL COVERSHEET

REDU	REDUCED PRESSURE BACKFLOW PREVENTER													
EQUIPMEN [*]	LOCATION	SERVICE	BACKFLOW PREVENTOR TYPE	MANUFACTURER	MODEL NO.	SIZE	MAX WORKING	NOTES						
TAG						(MM)	PRESS. (KPA)							
BFP-1	WATER ENTRY	DOMESTIC WATER	DCVA	WATTS	LF007	65	1207	1						
BFP-2	SPRINKLER CABINET	FIRE PROTECTION	DCDA	WATTS	007DCDA	65	1207							
NOTES:														

1 LEAD FREE (NO EXCEPTIONS)

DIFFUSE	DIFFUSERS AND GRILLES												
EQUIPMENT	DESCRIPTION/TYPE	MODEL NUMBER	NOTES										
TAG													
SG-1	SQUARE PLAQUE DIFFUSER	EH-PRICE	SUPPLY	SPD	ALL								
SG-2	LOUVERED FACE SUPPLY	EH-PRICE	SUPPLY	520	1,2								
L-1	LOUVER	EH-PRICE	OUTDOOR AIR	DE635	1,2								
R-1	LOUVERD FACE RETURN	EH-PRICE	RETURN	530	1,2								
E-1	LOUVERD FACE RETURN	EH-PRICE	OUTDOOR AIR/ EXHAUST	630	ALL								

- PROVIDE DIFFUSERS AND GRILLES WITH BORDER STYLES THAT ARE COMPATIBLE WITH ADJACENT WALLS AND CEILING SYSTEMS. REFER TO ARCHITECTURAL DRAWINGS.
- STANDARD WHITE COLOR BORDER STYLE SUITABLE FOR SOFFIT INSTALLATION

UNIT NUMBER	QTY	UNIT DESCRIPTION	UNIT LOCATION		ELECTRICAL LOAD VOLT PH			EQUIPMENT			STARTER				DISCONNECT CONTROL					NOTES				
				MCA	FLA	KW	HP			s	ı	С	s	1	С	TYPE	S	I	С	S	ı	С	TYPE	<u> </u>
		DOMESTIC WATER HEATER								+				_										├─
DWH-1	1	DOMESTIC HOT WATER (TANKLESS)	ATTIC ABOVE UNIVERSAL WC 106		54	18		240	1	М	М	Е	М	М	М	INT	Е	Е	Е	М	М	М	INT	1
		FAN COIL UNIT																						
CU-1	1	VRF HEAT PUMP/CONDENSING UNIT	OUTDOORS - NORTH SIDE OF BUILDING	16.5				208	1	М	М	Е	М	М	Е	INT	Е	Е	Е	М	М	М	PCS	
FC-1	1	MEETING ROOM 103 FAN COIL	ATTIC ABOVE VESTIBULE 105	0.8				208	1	М	М	Е	М	М	М	INT	Е	Е	Е	М	М	М	WC	
FC-2	1	SECURITY ROOM 106 VESTIBULE 104 FAN COIL	ATTIC ABOVE SECURITY CONTROL ROOM 107	0.3				208	1	М	М	Е	М	М	М	INT	Е	Е	Е	М	М	М	WC	
FC-3	1	ELEX 101 FAN COIL	ELEX 101 WALL	0.8				208	1	М	М	Е	М	М	М	INT	Е	Е	Е	М	М	М	WC	
FC-4	1	DATA 102 FAN COIL	DATA 102 WALL	0.8				208	1	М	М	Е	М	М	М	INT	Е	Е	Е	М	М	М	WC	
		EXHAUST FANS																						
EF-1	1	W/C UNIVERSAL 106 EXHAUST FAN	WASHROOM 106	0.18			FRAC	120	1	М	М	Е	М	М	М	INT	Е	Е	Е	М	М	М	TC, WS	
EF-2	1	MEETING ROOM EXHAUST FAN	MEETING ROOM 104	0.13			FRAC	120	1	М	М	Е	М	М	М	INT	Е	Е	Е	М	М	М	os	
		MISCELLANEOUS																						
		HEAT TRACE	REFER TO DWGS							М	М	Е	М	М	М	INT	Е	Е	Е	М	М	М	INT	

SUPPLIER / INSTALL / WIRE CODES: MECH = MECHANICAL CONTROL DEVICE CODES: AQUA = PUMP CONTROLLED BY AQUASTAT ELECTRICAL LOAD CODES: BHP = BREAK HORSEPOWER ELEC = ELECTRICAL BMS = BLDG MANAGEMENT SYSTEM FLA = UNIT FULL LOAD AMPS S = SUPPLIED BY ES = END SWITCH PH = POWER PHASE I = INSTALLED BY ET = LINE VOLTAGE T'STAT FAP = FIRE ALARM PANEL C = CONNECTED BY FS = FLOW SWITCH STARTER CODES: H = HUMIDITY SENSOR MISCELLANEOUS CODES: MAN = MANUAL STARTER I = INTERLOCK, SEE NOTES HOA = MAGNETIC STARTER W/ HAND/OFF/AUTO LIGHT = WIRED TO LIGHT SWITCH SWITCH W/ AUX. CONTACTS INT = INTEGRAL PART OF UNIT LS = LEVEL SWITCH MAG = MAGNETIC STARTER C/W AUX STATUS CONTACTS OS = OCCUPANT SENSOR MRR = MOTOR RATED RELAY, 24 VAC COIL PS = PRESSURE SWITCH

TC = TIME CLOCK

WS = WALL SWITCH

R. STAT = REVERSE ACTING THERMOSTAT

WC=WALL MOUNTED HARD-WIRED CONTROLLER

T = LOW VOLTAGE T'STAT OR SENSOR

VS = VARIABLE SPEED SWITCH

HP = UNIT OR MOTOR HORSE POWER MCA = MINIMUM CIRCUIT AMPS VOLT = REQUIRED SUPPLY VOLTAGE FRAC = FRACTIONAL HORSEPOWER

<u>NOTES:</u>
1. POWER AND OUTPUT TO BE DE-RATED BY 25% WHEN CONNECTED TO 208/1/60

FAN COIL	FAN COIL UNIT														
EQUIPMENT QTY	DESCRIPTION	SERVICE	LOCATION	MANUFACTURER	MODEL	MODEL	WEIGHT	AIR FLOV	V (LPS)	OUTDOOR AIR FLOW	ESP	HGT CAP	TOTAL CLG	SENS. CLG	NOTES
TAG						SIZE	(KG)	HIGH	LOW	(L/S)	(PA)	(KW)	CAP (KW)	CAP (KW)	
FC-1 1	CONCEALED DUCTED	MEETING ROOM 102	ATTIC ABOVE UNIVERSAL WC 105	DAIKIN	FXSQ05TAVJU	0.5	24.9	133	109	65	50	1.9	1.7	1.4	1,3,4
FC-2 1	CASSETTE	SECURITY CONTROL ROOM 106	ATTIC ABOVE SECURITY CONTROL ROOM 106	DAIKIN	FXZQ05TAVJU	0.5	15.5	142	108	35	-	1.9	1.7	1.4	2,4
FC-3 1	CONCEALED DUCTED	ELEX 101	MEETING ROOM 104	DAIKIN	FXSQ07TAVJU	0.6	24.9	133	109	0	149	2.5	2.2	1.7	1,3,4
FC-4 1	CONCEALED DUCTED	DATA 102	MEETING ROOM 104	DAIKIN	FXSQ12TAVJU	1	24.9	158	117	0	149	4.0	3.5	2.8	1,3,4
NOTES:															

- C/W DRIP PAN UNDER COOLING COIL AND/OR UNIT.
- C/W CONDENSATE PUMP. PROVIDE MERV-13 FILTER AT AIR IN-LET.
- PROVIDE CONDENSATE LINE TO NEAREST SANITARY DRAIN.

& MOTOR PROTECTION SWITCH

PCS = PACKAGED CONTROL SYSTEM

WS = WALL SWITCH

CP = CONTROL PANEL

FANS										-		
EQUIPMENT	QTY	SERVICE	LOCATION	TYPE	MANUFACTURER	MODEL	AIR FLOW	E. S. P.	FAN	DRIVE	SOUND LEVEL	NOTES
TAG							(L/s)	(IN Pa)	(RPM)	TYPE	(SONES)	
EF-1	1	W/C UNIVERSAL (106)	W/C UNIVERSAL (106)	CEILING MOUNTED	PANASONIC	FV-0511VQ1	40	75.0	1,172	DIRECT	0.6	1,2,3
EF-2	1	MEETING ROOM (104)	MEETING ROOM (104)	CEILING MOUNTED	PANASONIC	FV-0511VQ1	55	75.0	1,093	DIRECT	0.4	1,2,4
NOTES:												
1	EANIGH	IDDI IED WITH CONTROL MODIII E TO AL	LOW EARL TO BLIN CONTINUOUSLY AT L	OW SDEED (20CEM)								ļ

- FAN SUPPLIED WITH CONTROL MODULE TO ALLOW FAN TO RUN CONTINUOUSLY AT LOW SPEED (30CFM). REFER TO MOTORLIST FOR ELECTRICAL REQUIREMENTS PROVIDE AND INSTALL WALL SWITCH (2-POSITION, LOW, HIGH).
- PROVIDE AND INSTALL OCCUPANCY SENSOR. UPON OCCUPANCY, SWITCH TO HIGH SPEED.

VRF	CONDEN	SING OUTD	OOR UNITS							
EQUIP.	DESCRIPTION	LOCATION	MANUFACTURER	MODEL	DIMENSIONS	WEIGHT	POWER	COOLING CAPACITY	HEATING CAPACITY	NOT
TAG					WxHxD (mm)	(KG)	(V/P/H)	KW	KW	
CU-1	HEAT PUMP	WALL MOUNTED	DAIKIN	RXTQ36TAVJ9	940x9916x305	78	208/1/60	10	11	AL
NOTES:										
1	INDOOR UNITS F	OWERED BY OUTDO	OOR UNIT							
2	PROVIDE FACTO	RY WALL-MOUNT KI	T, C/W RUBBER ISOL	ATORS FOR VIBR	ATION.					

DOMESTIC WATER HEATER (ELECTRIC)											
EQUIPMENT	LOCATION	MANUFACTURER	MODEL	INPUT	TYPE	TEMP RISE (F) AT	POWER	SHIPPING WEIGHT	NOTES		
TAG				(KW)		0.09/0.12L/S(1.5/2GPM)	(V/P/H)	(KG)			
DWH-1	BELOW KICHNETTE	RHEEM	RTEX-18	18.0	TANKLESS	82/62	240/1/60	3.86	ALL		
NOTES:	1. C/W COMPRESSIO	N FITTINGS									
	2. REPLACEMENT CATRIDGE INSERT										
	3. REFER TO SPECIFICATIONS FOR FURTHER INFORMATION.										
	4 POWER AND OUT	PUT TO BE DE-RATED BY	Y 25% WHEN	CONNEC	TED TO 208/1/6	n			1		

RATIO



					DESIGNED DAJ DRAWN DAJ/SR CHECKED GT	
		4	Issued for Tender	2020-04-24	RECOMMENDED	
		3 2	Issued for 99% Review Issued for 90% Review Issued for 50% Review	2020-04-13 2019-10-30 2019-09-18	APPROVED	
NO.	DATE		REVISIONS		APPROVED	

INSTITUTE OF OCEAN SCIENCES NEW GUARDHOUSE 9860 WEST SAANICH ROAD SIDNEY, BC, V8L 5T5


FISHERIES AND OCEANS CANADA REAL PROPERTY AND SAFETY AND SECURITY SCALE AS SHOWN START DATE


REVISION

DRAWING NUMBER

NOTES DWG. NO. DRAWING REFERENCES

MECHANICAL SCHEDULES

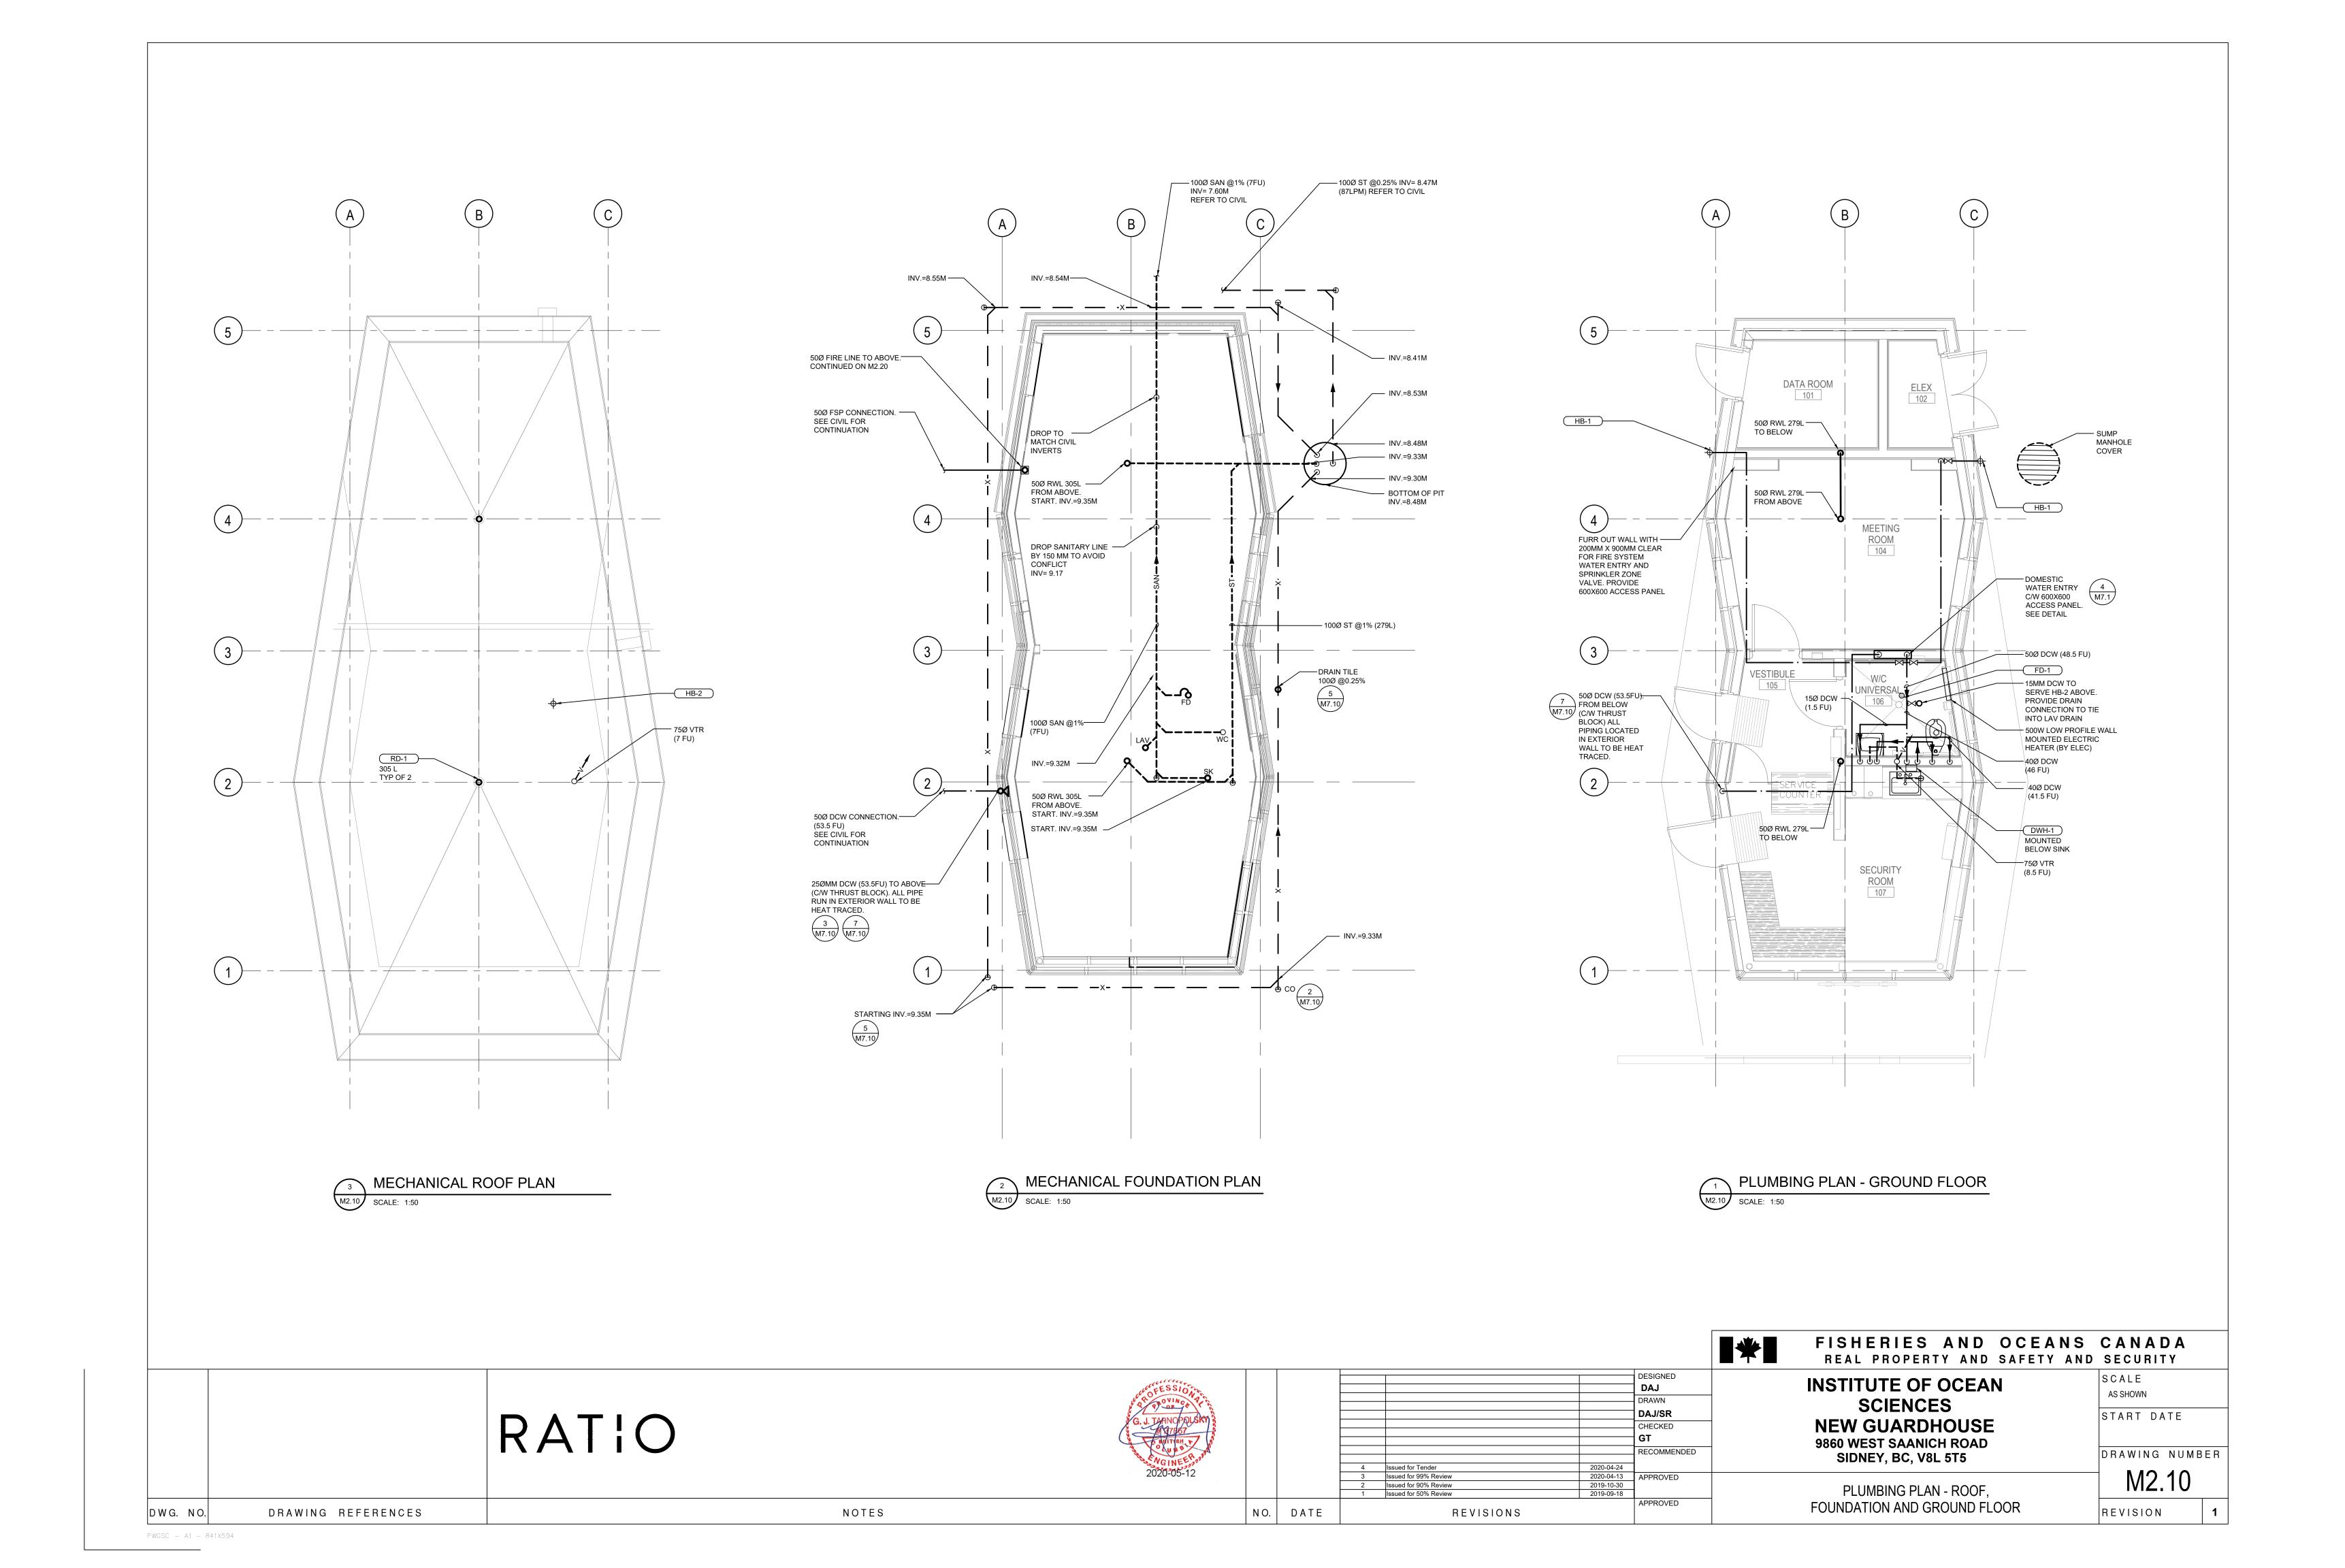

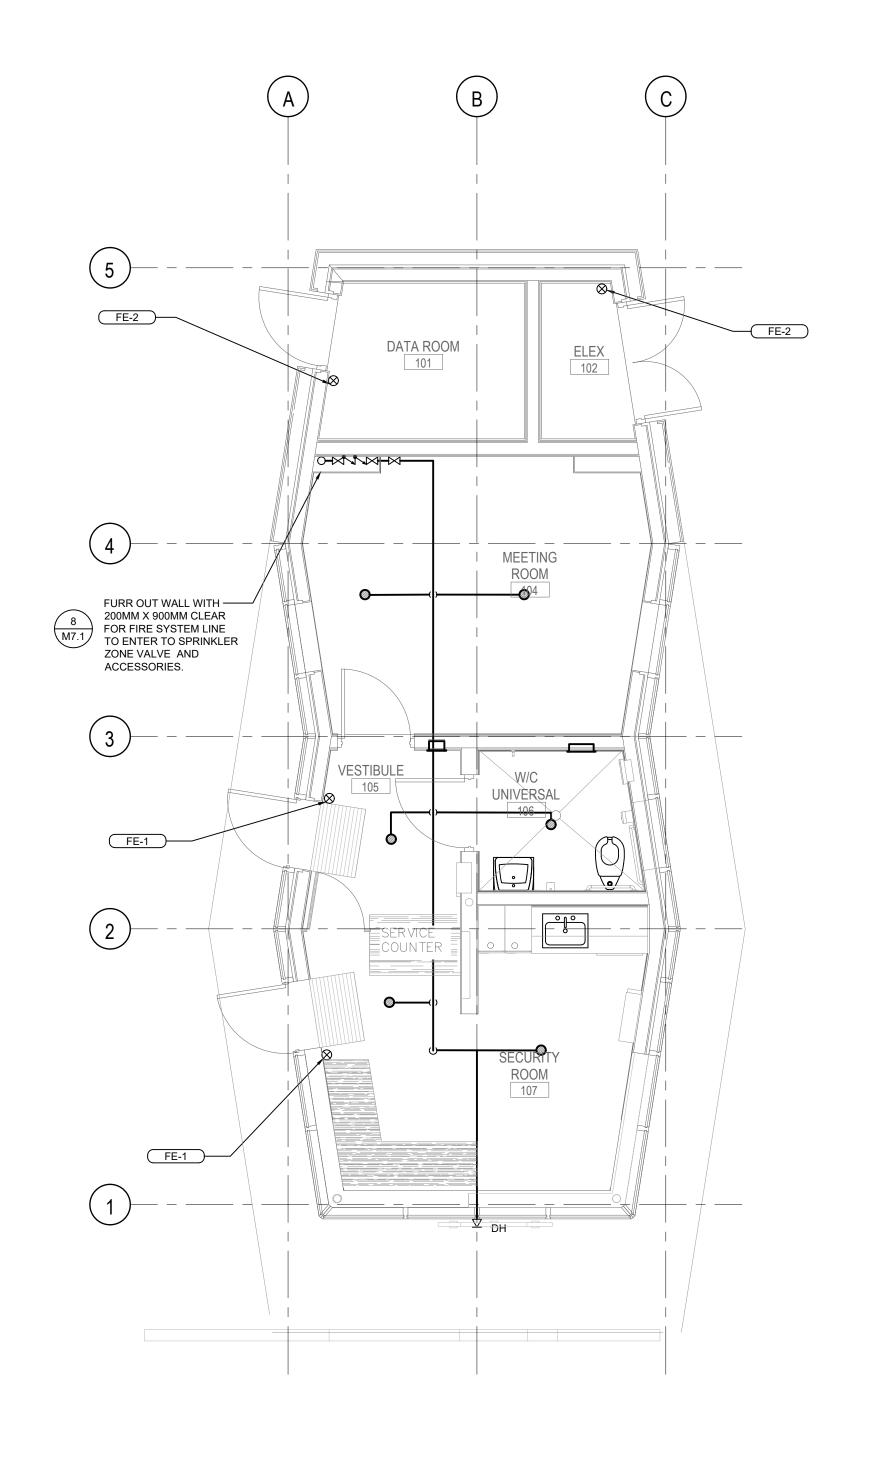

FIRE PROTECTION PLAN

M3.10 SCALE: 1:50

FISHERIES AND OCEANS CANADA REAL PROPERTY AND SAFETY AND SECURITY SCALE DESIGNED **INSTITUTE OF OCEAN DAJ**DRAWN AS SHOWN **SCIENCES** RATIO DAJ/SR START DATE **NEW GUARDHOUSE** 9860 WEST SAANICH ROAD SIDNEY, BC, V8L 5T5 DRAWING NUMBER RECOMMENDED 4 Issued for Tender
3 Issued for 99% Review
2 Issued for 90% Review
1 Issued for 50% Review M3.10 FIRE PROTECTION PLAN DRAWING REFERENCES NO. DATE NOTES REVISIONS REVISION DWG. NO.


PWGSC - A1 - 841X594

GENERAL NOTE

1. RUN ALL FAN COIL CONDENSATE TO NEAREST SINK

KEY NOTES

DUCT TO BE MOUNTED TO PROVIDE 150 MM CLEARANCE BELOW FOR ELECTRICAL CABLE TRAY

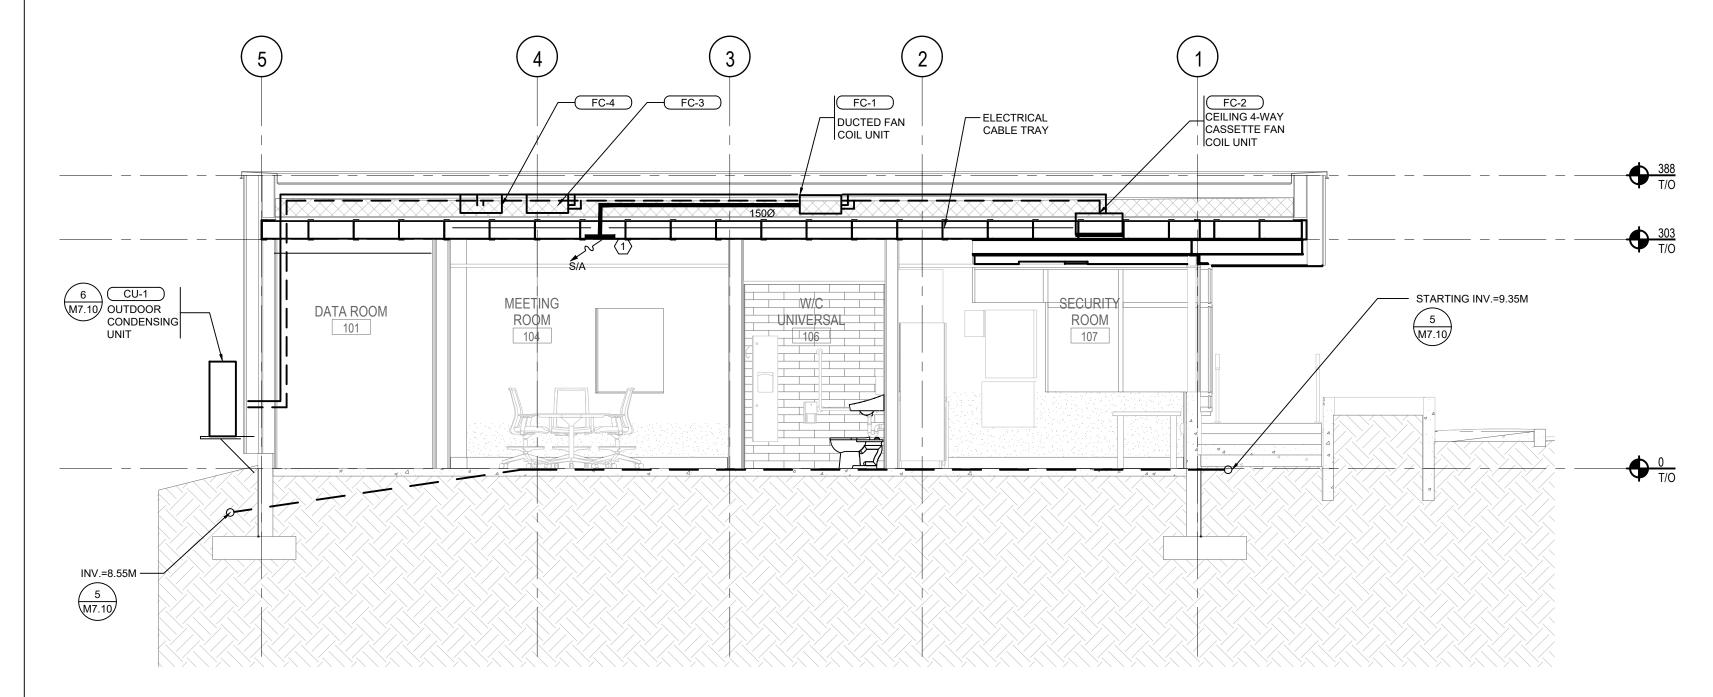

SOUTH-NORTH SECTION - MECHANICAL

SCALE: 1:50

