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GRAND-PRÉ NATIONAL HISTORIC SITE MEMORIAL CHURCH AND MONUMENTS REPOINTING

GRAND-PRÉ, NOVA SCOTIA


ISSUED FOR TENDER - 02 APRIL 2020

PROJECT NO. 1241



DRAWING LIST

NO.	DRAWING NAME
STRUCTURAL	
S100	STRUCTURAL ELEVATIONS AND SECTIONS
S101	STRUCTURAL MONUMENTS RE-CONSTRUCTION FOUNDATION DETAILS
ARCHITECTURAL	
A100	GENERAL NOTES
A101	SITE PLAN
A401	EXISTING PLANS AND ELEVATIONS
A402	SOUTH ELEVATION - PHOTOS
A403	WEST & NORTH ELEVATION - PHOTOS
A404	EAST ELEVATION, RAINWATER LEADERS & INTERIOR - PHOTOS
A405	DEMOLITION ELEVATIONS
A406	DEMOLITION ELEVATIONS
A407	NEW ELEVATIONS
A408	NEW ELEVATIONS
A701	SECTIONS AND DETAILS
A702	SECTIONS AND DETAILS
A901	EVANGELINE MONUMENT
A902	LONGFELLOW MONUMENT
A903	HERBIN CROSS MONUMENT
A904	PLANTERS MONUMENT

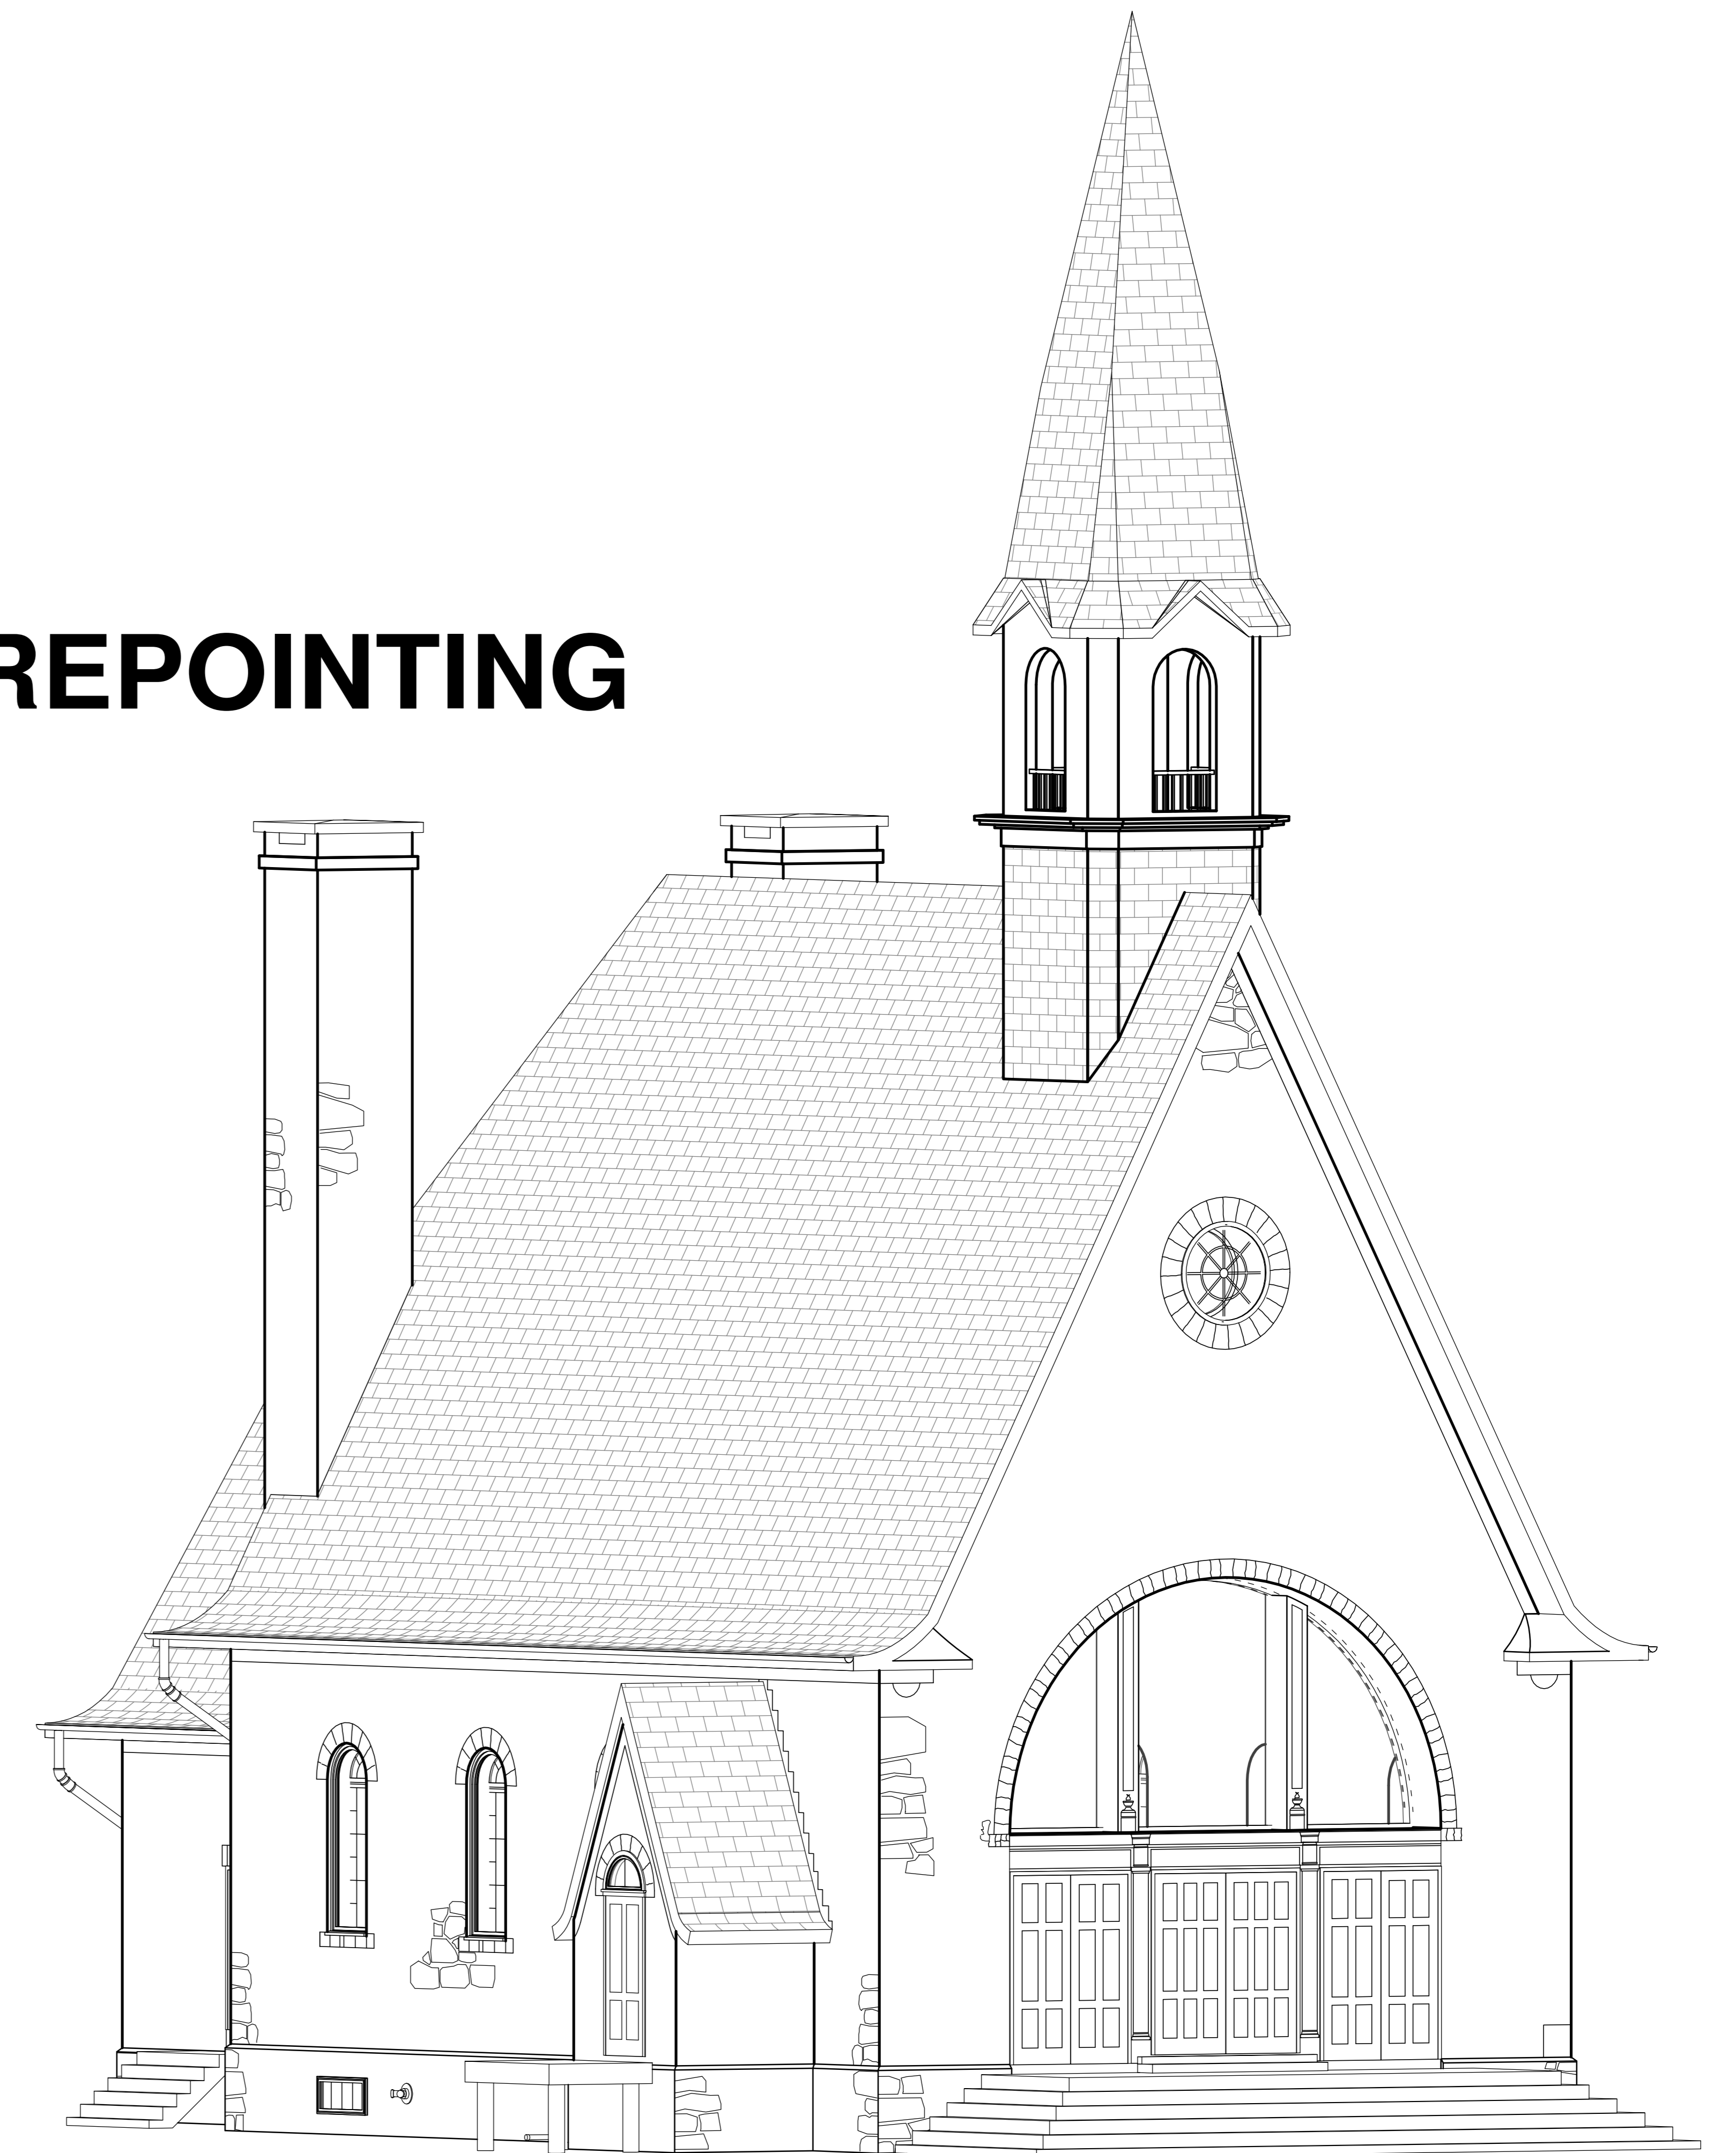

Canada



GENERAL NOTES


1. ALL DIMENSIONS ON THIS DRAWING ARE IN MILLIMETERS UNLESS NOTED OTHERWISE.
2. ALL WORK AND MATERIALS SHALL CONFORM TO THE CSA A23.1-14.
3. THE CONTRACTOR IS RESPONSIBLE FOR REPAIR OR DAMAGE TO THE EXISTING STRUCTURES, EQUIPMENT OR FACILITIES THAT IS THE RESULT OF ITS CONSTRUCTION ACTIVITIES.
4. CONTRACTOR SHALL DESIGN, INSTALL AND MAINTAIN ACCURATE TEMPORARY BRACING AND SHORING OF STRUCTURAL ELEMENTS FOR STABILITY AND SAFETY WHERE REQUIRED DURING CONSTRUCTION. CONTRACTOR SHALL PROVIDE ALL HORING AS REQUESTED TO CONDUCT REPAIRS AND CONTROL DUST DURING DURATION OF WORK.
5. CONTRACTOR IS RESPONSIBLE FOR WASTE REMOVAL FROM SITE.
6. ALL WORK IS TO BE DONE IN ACCORDANCE WITH PARKS CANADA CONTRACT DOCUMENTS.
7. CONTRACTOR TO OBTAIN ALL NECESSARY PERMITS REQUIRED TO PERFORM WORK AND TO COMPLY WITH ALL APPLICABLE LOCAL REGULATIONS.
8. WHERE EXISTING CONDITIONS ARE SHOWN THEY ARE NOT NECESSARILY ACCURATE OR COMPLETE. THE CONTRACTOR SHALL CONFIRM ALL EXISTING DIMENSIONS AND LOCATIONS AND REPORT ANY DISCREPANCIES TO THE DEPARTMENT REPRESENTATIVE.
9. THE CONTRACTOR SHALL CHECK AND VERIFY ALL PROPOSED DIMENSIONS BEFORE PROCEEDING WITH CONSTRUCTION. ANY ADJUSTMENTS WILL BE MADE BY THE DEPARTMENT REPRESENTATIVE FIRST.
10. AT COMPLETION OF WORK REINSTATE ALL DISTURBED AREAS TO THE SATISFACTION OF THE DEPARTMENT REPRESENTATIVE.
11. CONTRACTOR TO REFER TO WORKING AT HEIGHTS AND CSA Z397 SCALFOLDING.
12. TEMPORARY SHORING AND STABILITY OF WORK ITEMS TO BE THE RESPONSIBILITY OF THE CONTRACTOR

REINFORCED CONCRETE NOTES:


1. DO CONCRETE WORK TO A23.1-14 AND TESTING TO A23.2-14
2. CONCRETE COMPRESSIVE STRENGTH AT 28 DAYS SHALL BE EXPOSURE CLASS F2 WITH A MINIMUM COMPRESSIVE STRENGTH OF 24MPa.
3. AIR ENTRAIN ALL CONCRETE EXPOSED TO WEATHER 5% TO 8% AIR BY VOLUME.
4. MAXIMUM SLUMP TO BE 75MM. MAXIMUM AGGREGATE SIZE TO BE 20MM.
5. REINFORCING STEEL TO CONFORM TO G30.18 REINFORCING STEEL DETAILING TO BE IN ACCORDANCE WITH RSIC REINFORCING STEEL MANUAL OF STANDARD PRACTICE. REBAR YIELD STRENGTH TO BE 40MPa.
6. PROVIDE MINIMUM CLASS B TENSION LAP SPlice IN ACCORDANCE WITH A23.3-14. NO MORE THAN 50% OF THE REINFORCING TO BE SPliced AT ANY GIVEN LOCATION.
7. REINFORCING STEEL EMBEDDED PARTS, ANCHOR RODS AND CONEELS, ETC. TO BE SECURED IN POSITION PRIOR TO PLACING CONCRETE AND HELD RIGIDLY DURING PLACEMENT OF CONCRETE.
8. SLEEVES ARE TO BE PROVIDED AT LOCATIONS WHERE MECHANICAL AND ELECTRICAL PIPES AND CONDUITS PENETRATE THE CONCRETE SLAB. CONCRETE CORING SHALL BE AVOIDED.
9. SLOPE SLAB TOWARDS FLOOR DRAINS TYPICAL REFER TO MECHANICAL AND SLAB PLAN FOR LOCATIONS.

TIMBER NOTES:


1. ALL WORK SHALL BE COMPLETED IN STRICT ACCORDANCE WITH THE SPECIFICATIONS AND DRAWINGS.
2. THIS PART SPECIFIES SOME OF THE MATERIALS AND PROCEDURES TO BE USED IN THE REPAIR AND REINFORCEMENT WORK. IT IS EXPECTED THAT CONSTRUCTION CREWS WILL BE SUPERVISED BY PERSONNEL WHO ARE EXPERIENCED IN TIMBER AND CONCRETE CONSTRUCTION METHODS.
3. WORKMANSHIP IN FABRICATION, PREPARATION AND INSTALLATION OF MATERIALS SHALL CONFORM THROUGHOUT TO ACCEPTED GOOD PRACTICE.
4. CARE SHALL BE TAKEN TO SAFEGUARD AND PROTECT ALL EXISTING STRUCTURES DURING THE REPAIR AND REINFORCEMENT WORK. ALL FINISHES SHALL BE MADE GOOD ON COMPLETION OF THE WORK.
5. WHEN REPLACING OLD MEMBERS WITH NEW ONES, ALL BOLT HOLES AND CONNECTOR GROOVES MUST MATCH EXACTLY. USE THE OLD MEMBER AS A TEMPLATE FOR LOCATING PILOT HOLES IN THE NEW MEMBER.
6. EXISTING TIMBER MEMBER DIMENSIONS ARE BASED ON DIMENSIONS PROVIDED AND SHALL BE CONFIRMED BY CONTRACTOR.
7. UNLESS OTHERWISE INDICATED ON THE DRAWINGS, ALL SAWN TIMBER USED AS REPLACEMENT MEMBERS SHALL BE SPF No. 1/2 GRADED IN ACCORDANCE WITH CSA 086.19 ENGINEERING DESIGN IN WOOD NLGA 2017 STANDARD GRADING RULES FOR CANADIAN LUMBER. GLUED-LAMINATED OR LVL TIMBER MAY BE SUBSTITUTED FOR SPF No. 1/2 UNLESS OTHERWISE INDICATED ON THE DRAWINGS. ALL SAWN TIMBER USED AS PURLS, PURLIN SUPPORTS, BRACING, DECK SHEATHING, OR BRACING SHALL BE NO. 1 & 2 GRADE SPRUCE-PINE-FIR.
8. SAWN TIMBER SHALL BE DRIED TO A MOISTURE CONTENT OF NOT MORE THAN 15 PER CENT BEFORE INSTALLATION AND SHALL BE STORED AND HANDLED IN A MANNER THAT WILL PREVENT WARP AND DEGRADE.
9. GLUED-LAMINATED TIMBER SHALL BE EXTERIOR GRADE 180-E DOUGLAS FIR AND SHALL CONFORM WITH CSA STANDARD (122MM (R01)) STRUCTURAL GLUED-LAMINATED TIMBER.
10. LVL OR LAMINATED VENEER LUMBER SHALL BE EXTERIOR DOUGLAS FIR WITH A RATED MODULUS OF ELASTICITY OF 13.3 GPa AND AN ALLOWABLE BENDING STRESS OF 19.3 MPa.
11. PLYWOOD SHALL BE EXTERIOR SHEATHING GRADE CONFORMING TO CSA STANDARD 0121-08 (R2013).

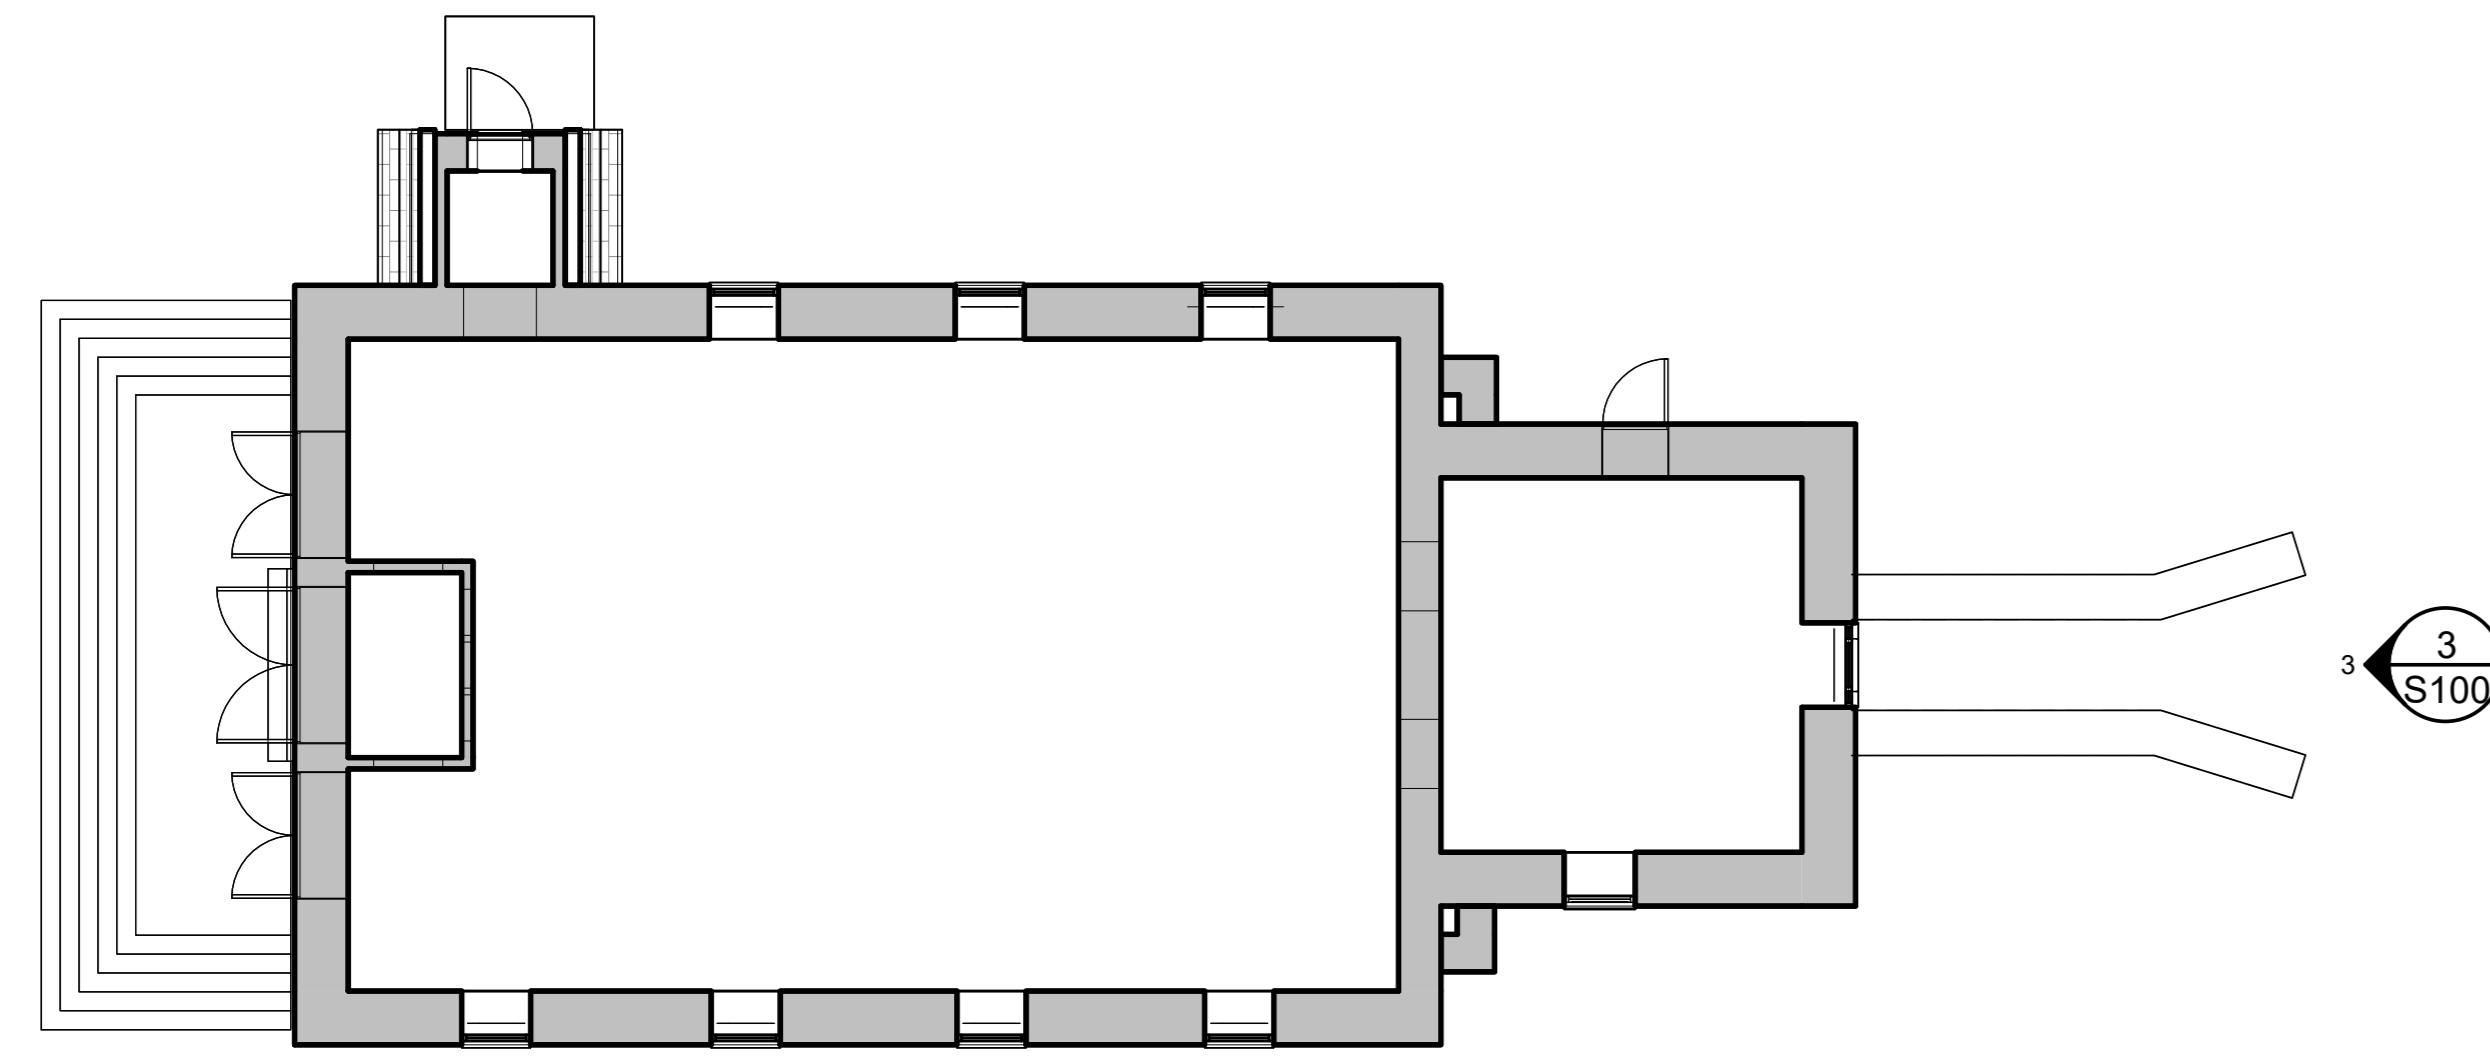

1 STRUCTURAL - KEY PLAN
S100 1:100

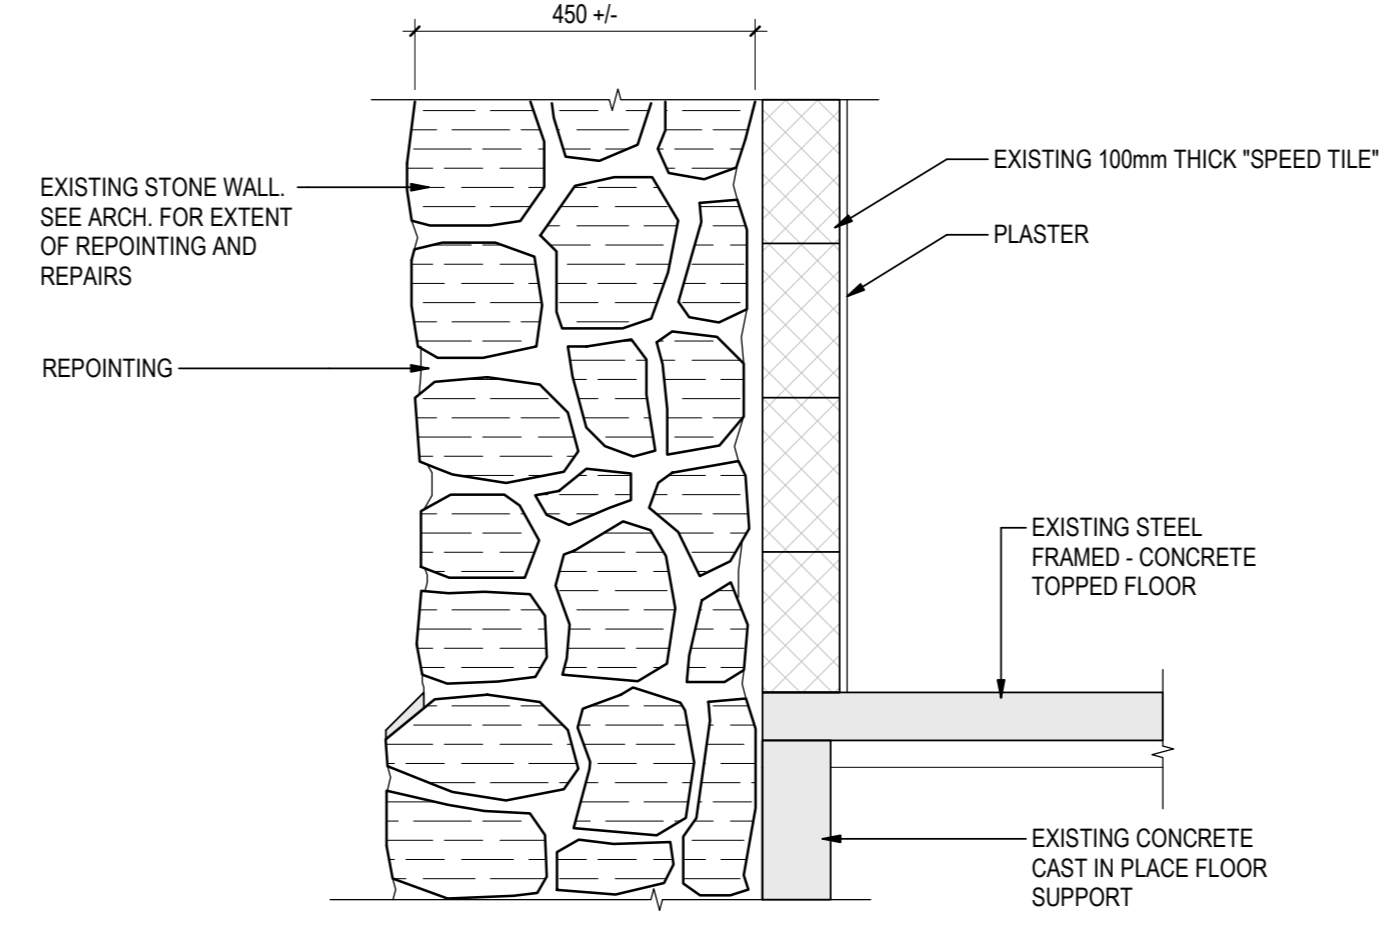


A TYPICAL EXISTING WALL SECTION
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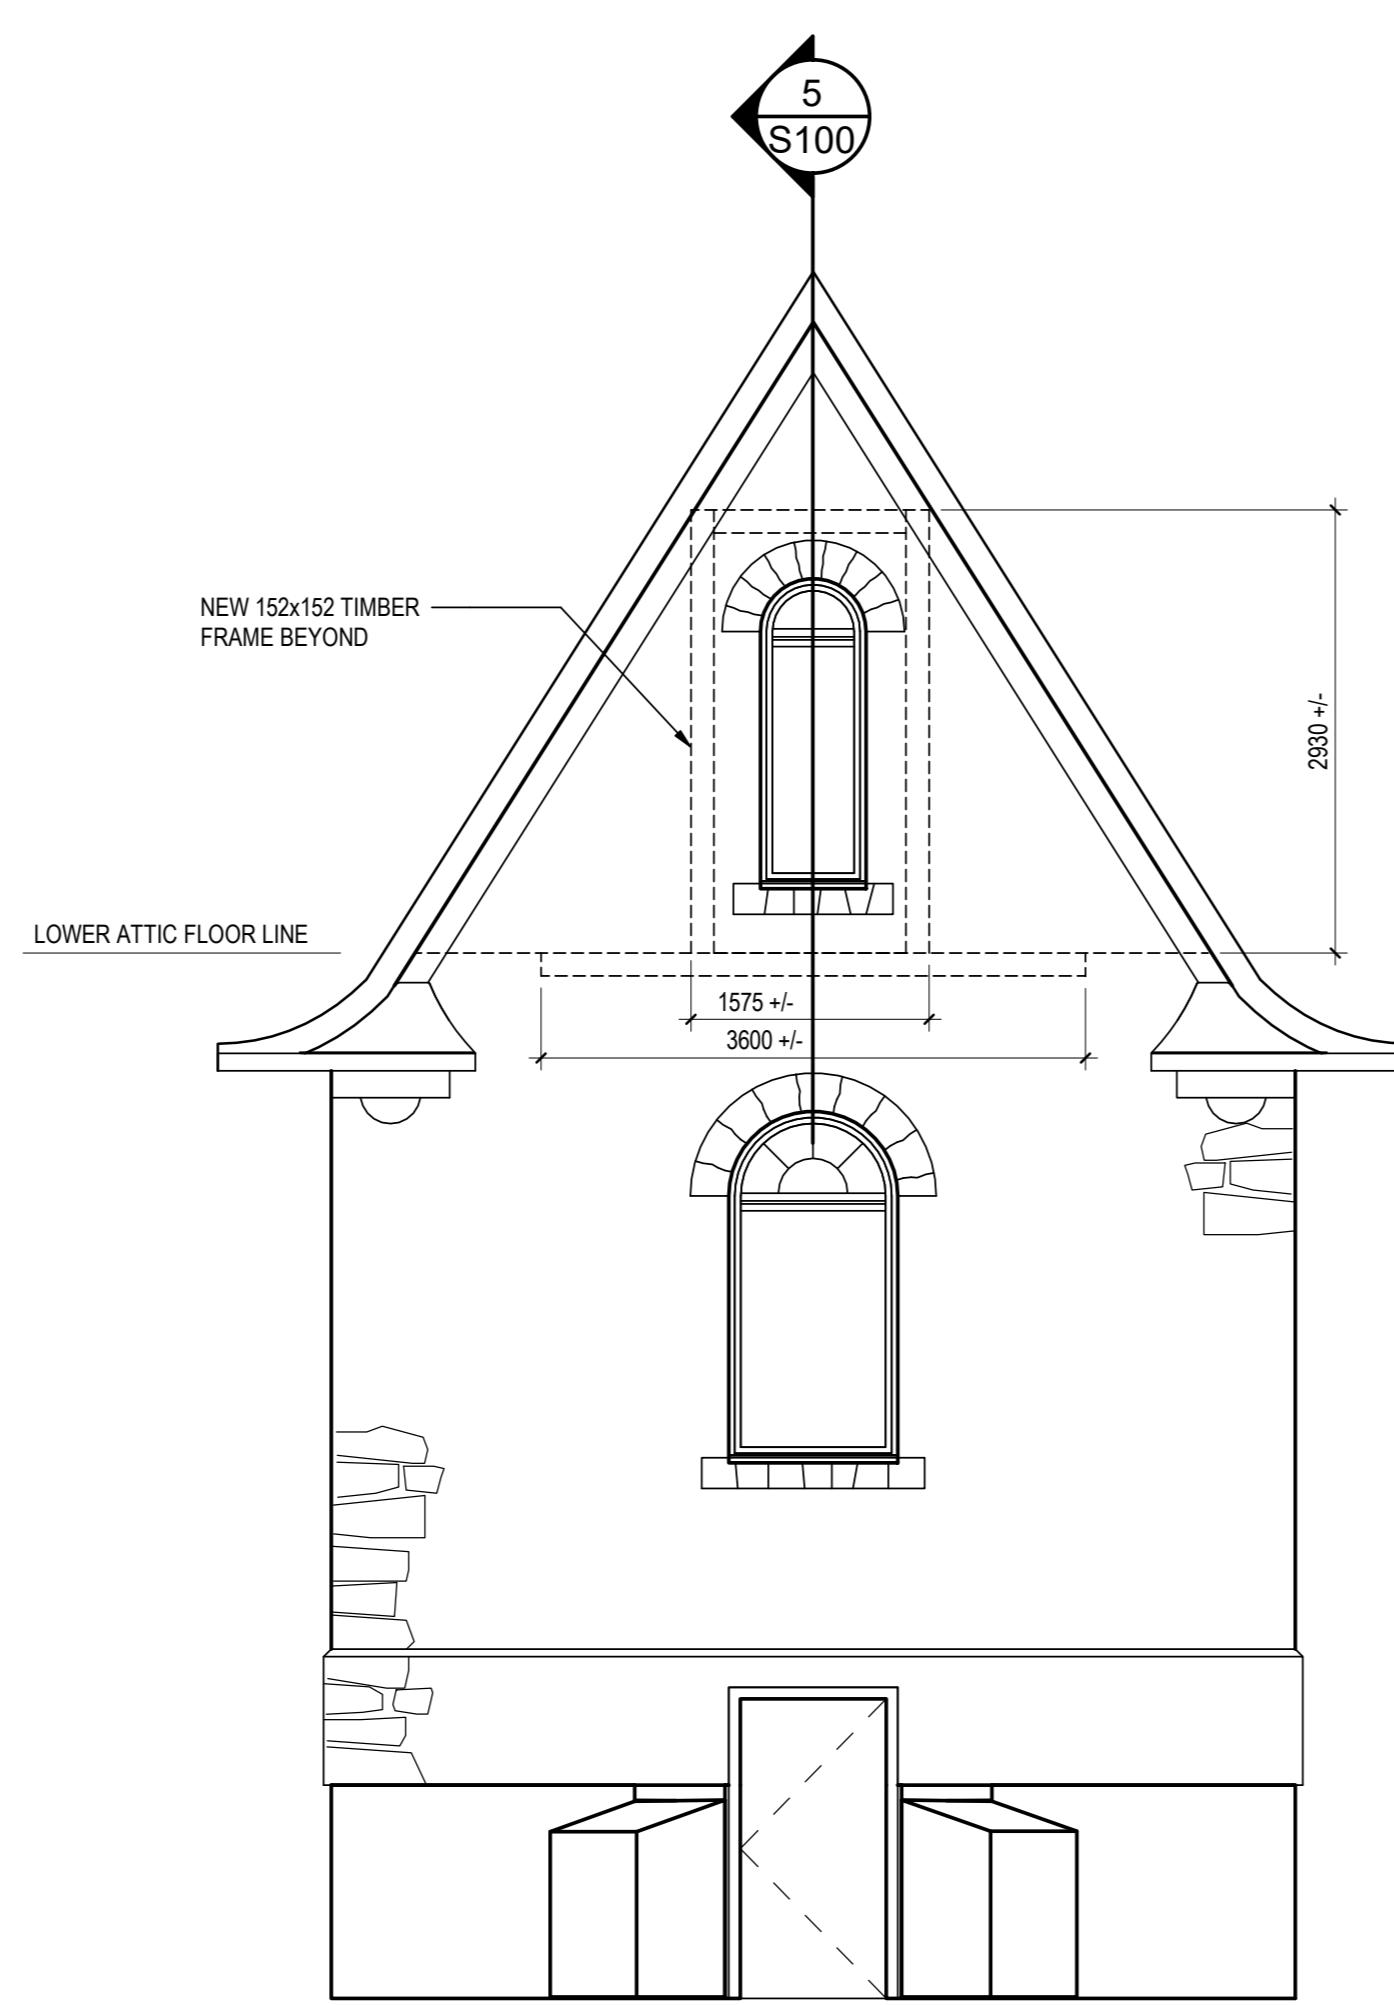


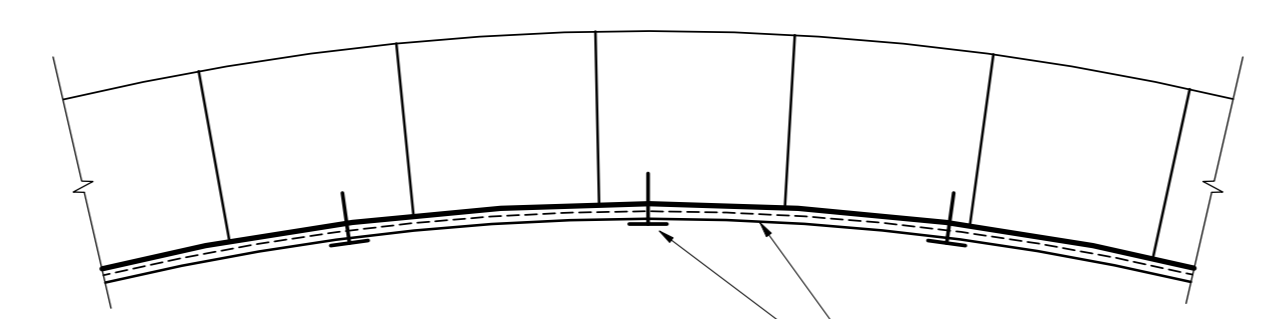1/2" #16 GALVANIZED EXPANDED METAL MESH - RAISED PROFILE 0.175" THICK X 0.375" X 0.938 OPENING C/W CEMENTITIOUS FARGING. SCREWS TO BE IN PAIRS AT 400mm C/C TYP.


B DETAIL
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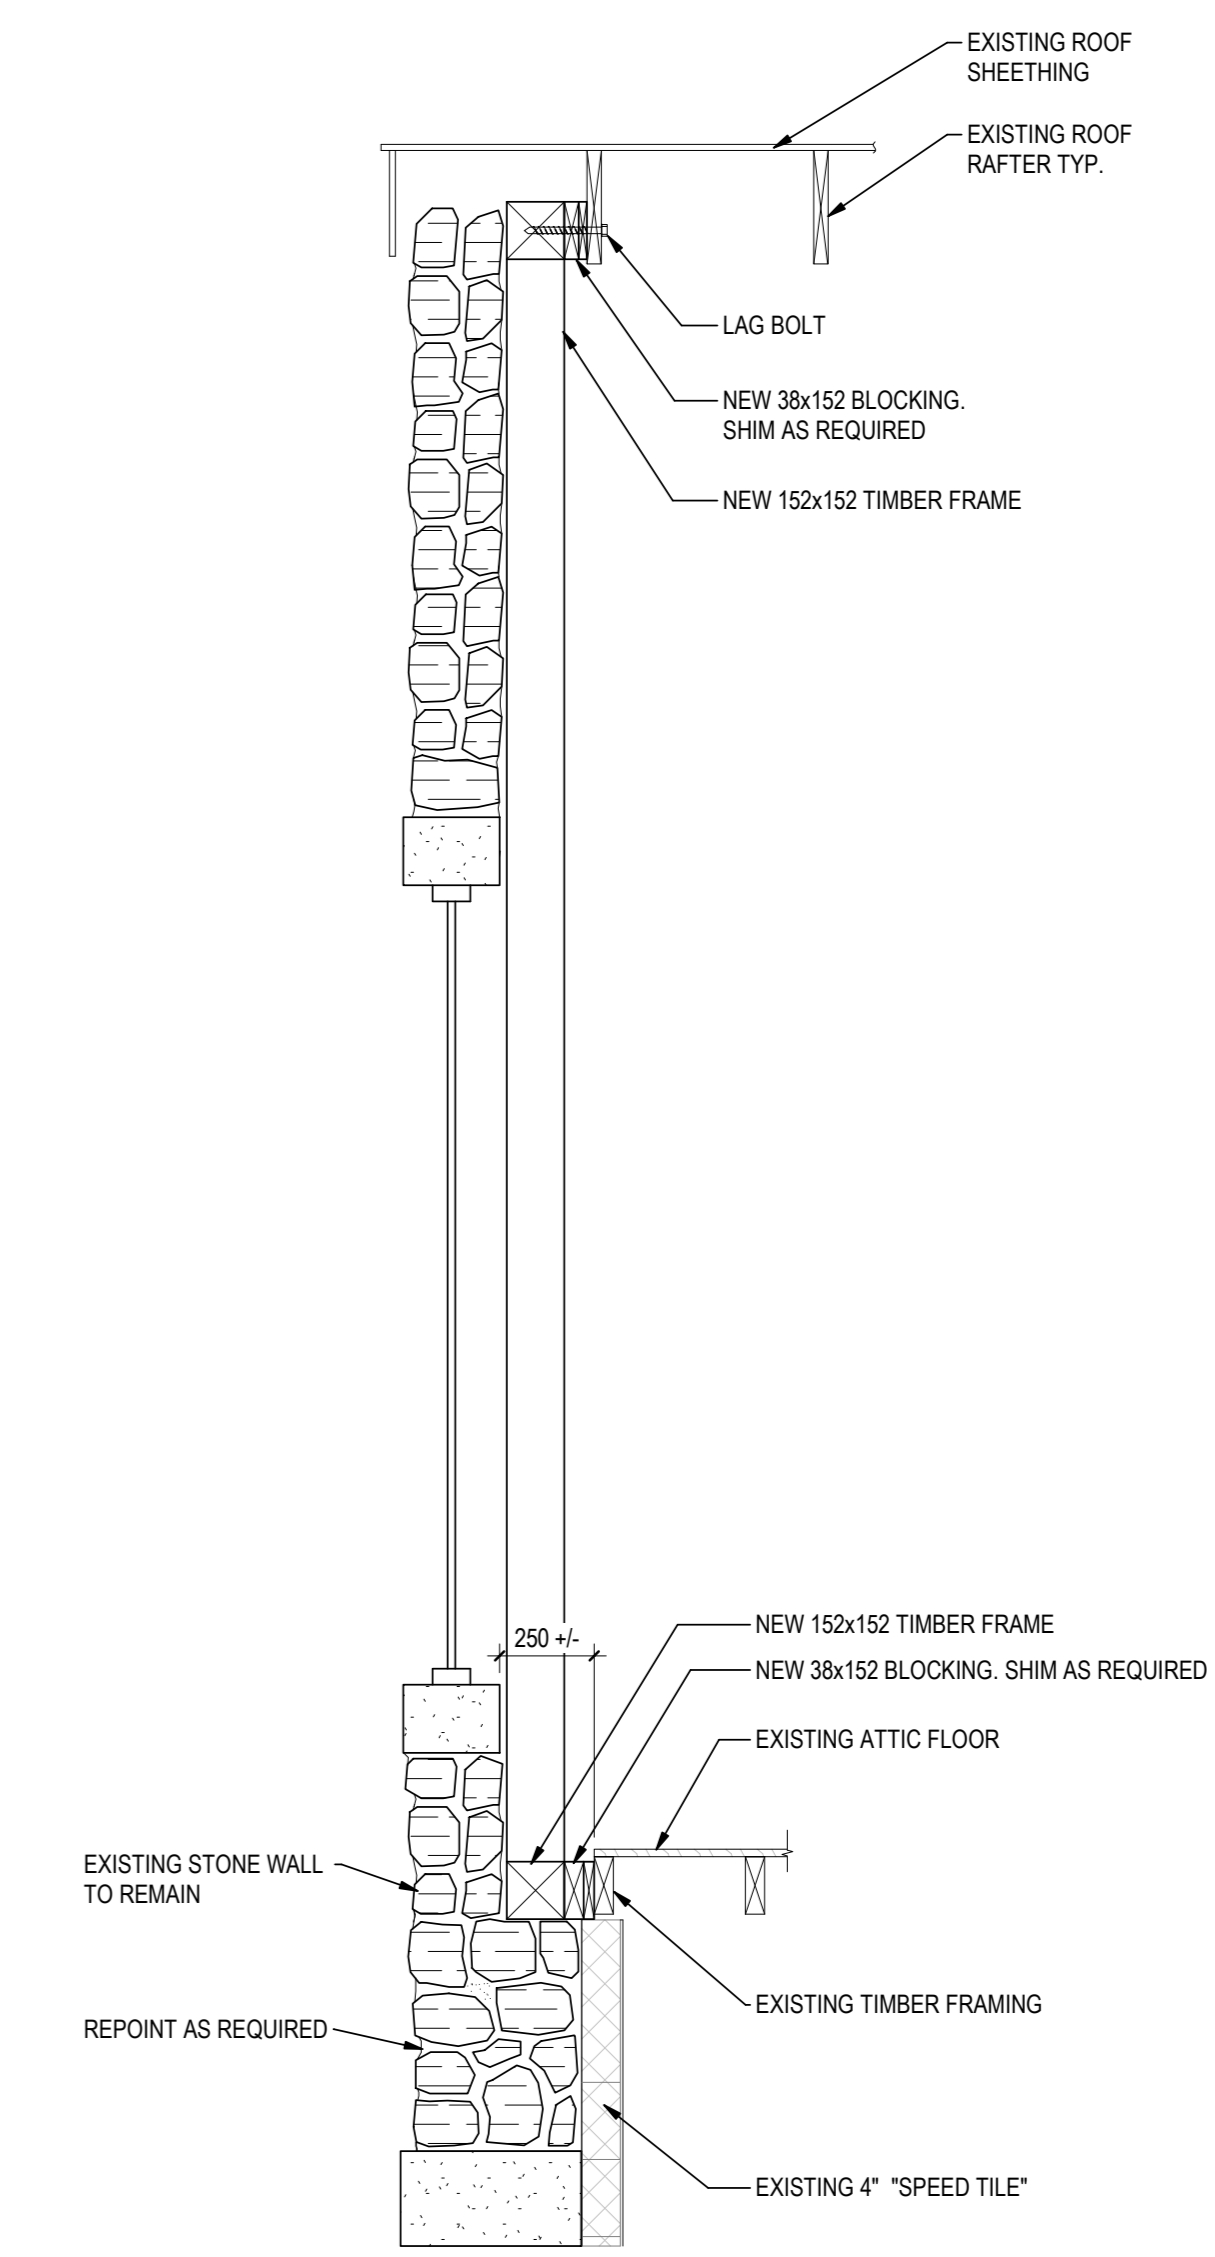
2 EXISTING SOUTH ELEVATION
S100 1:50

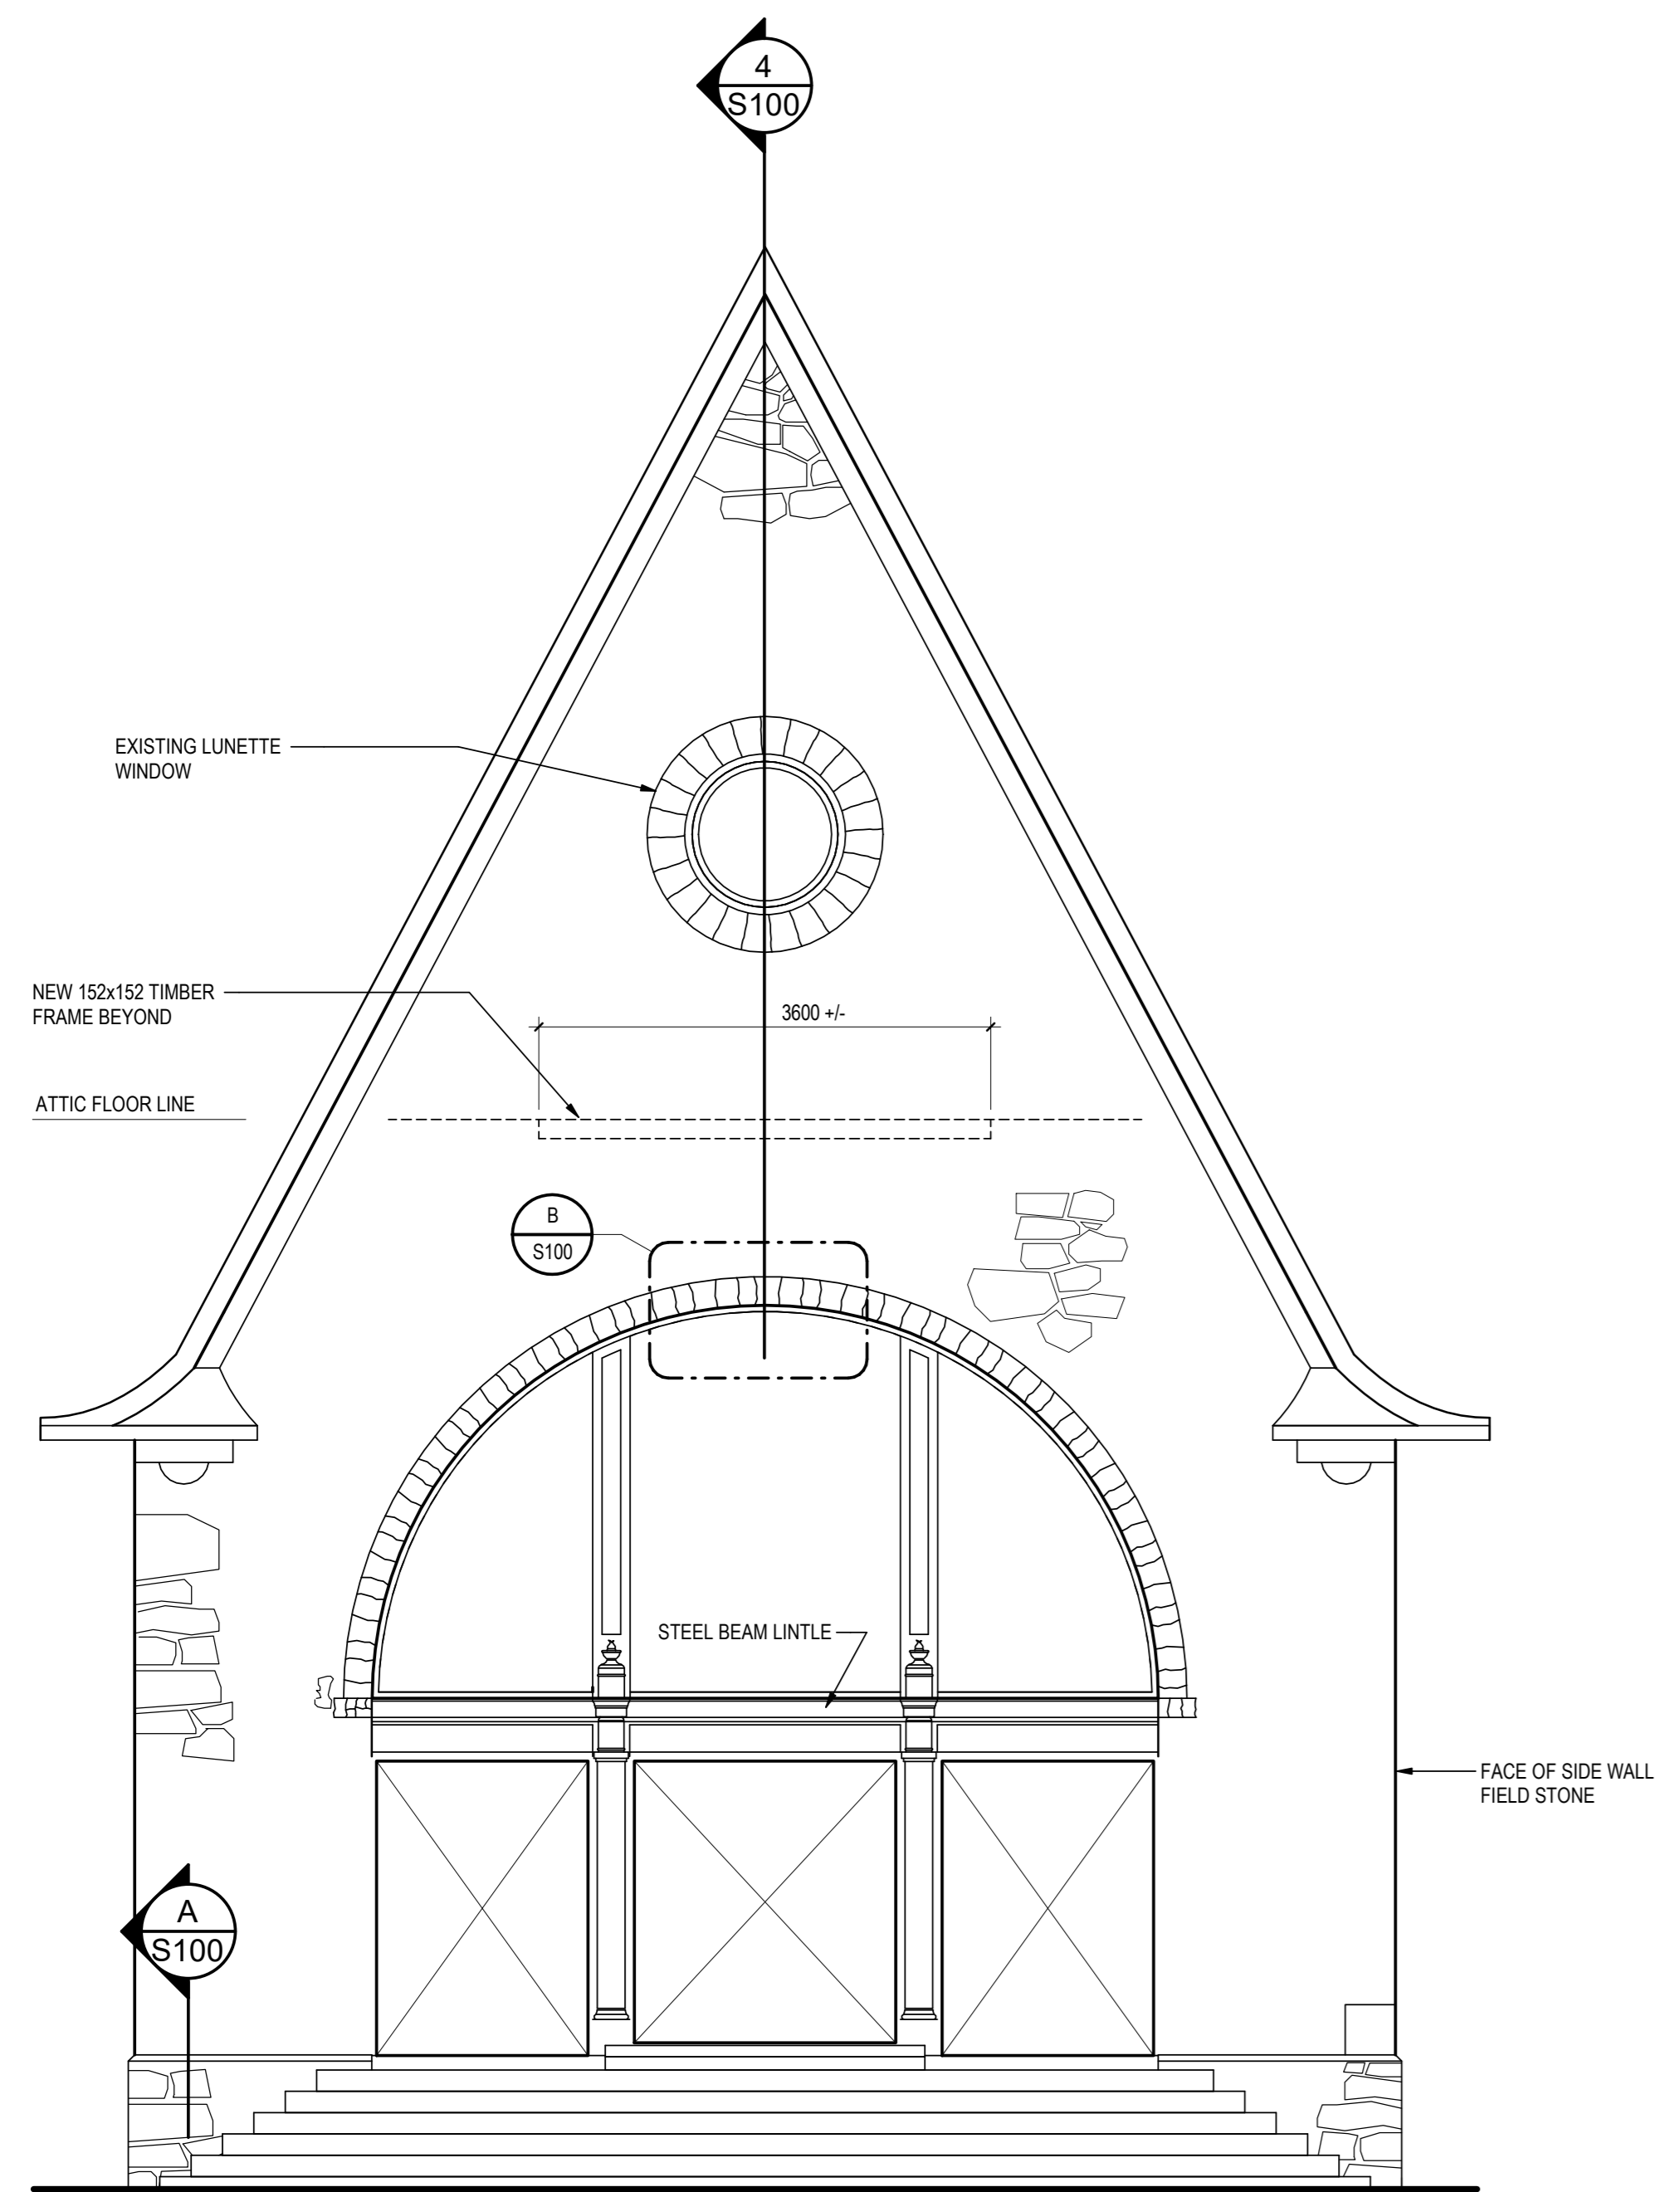


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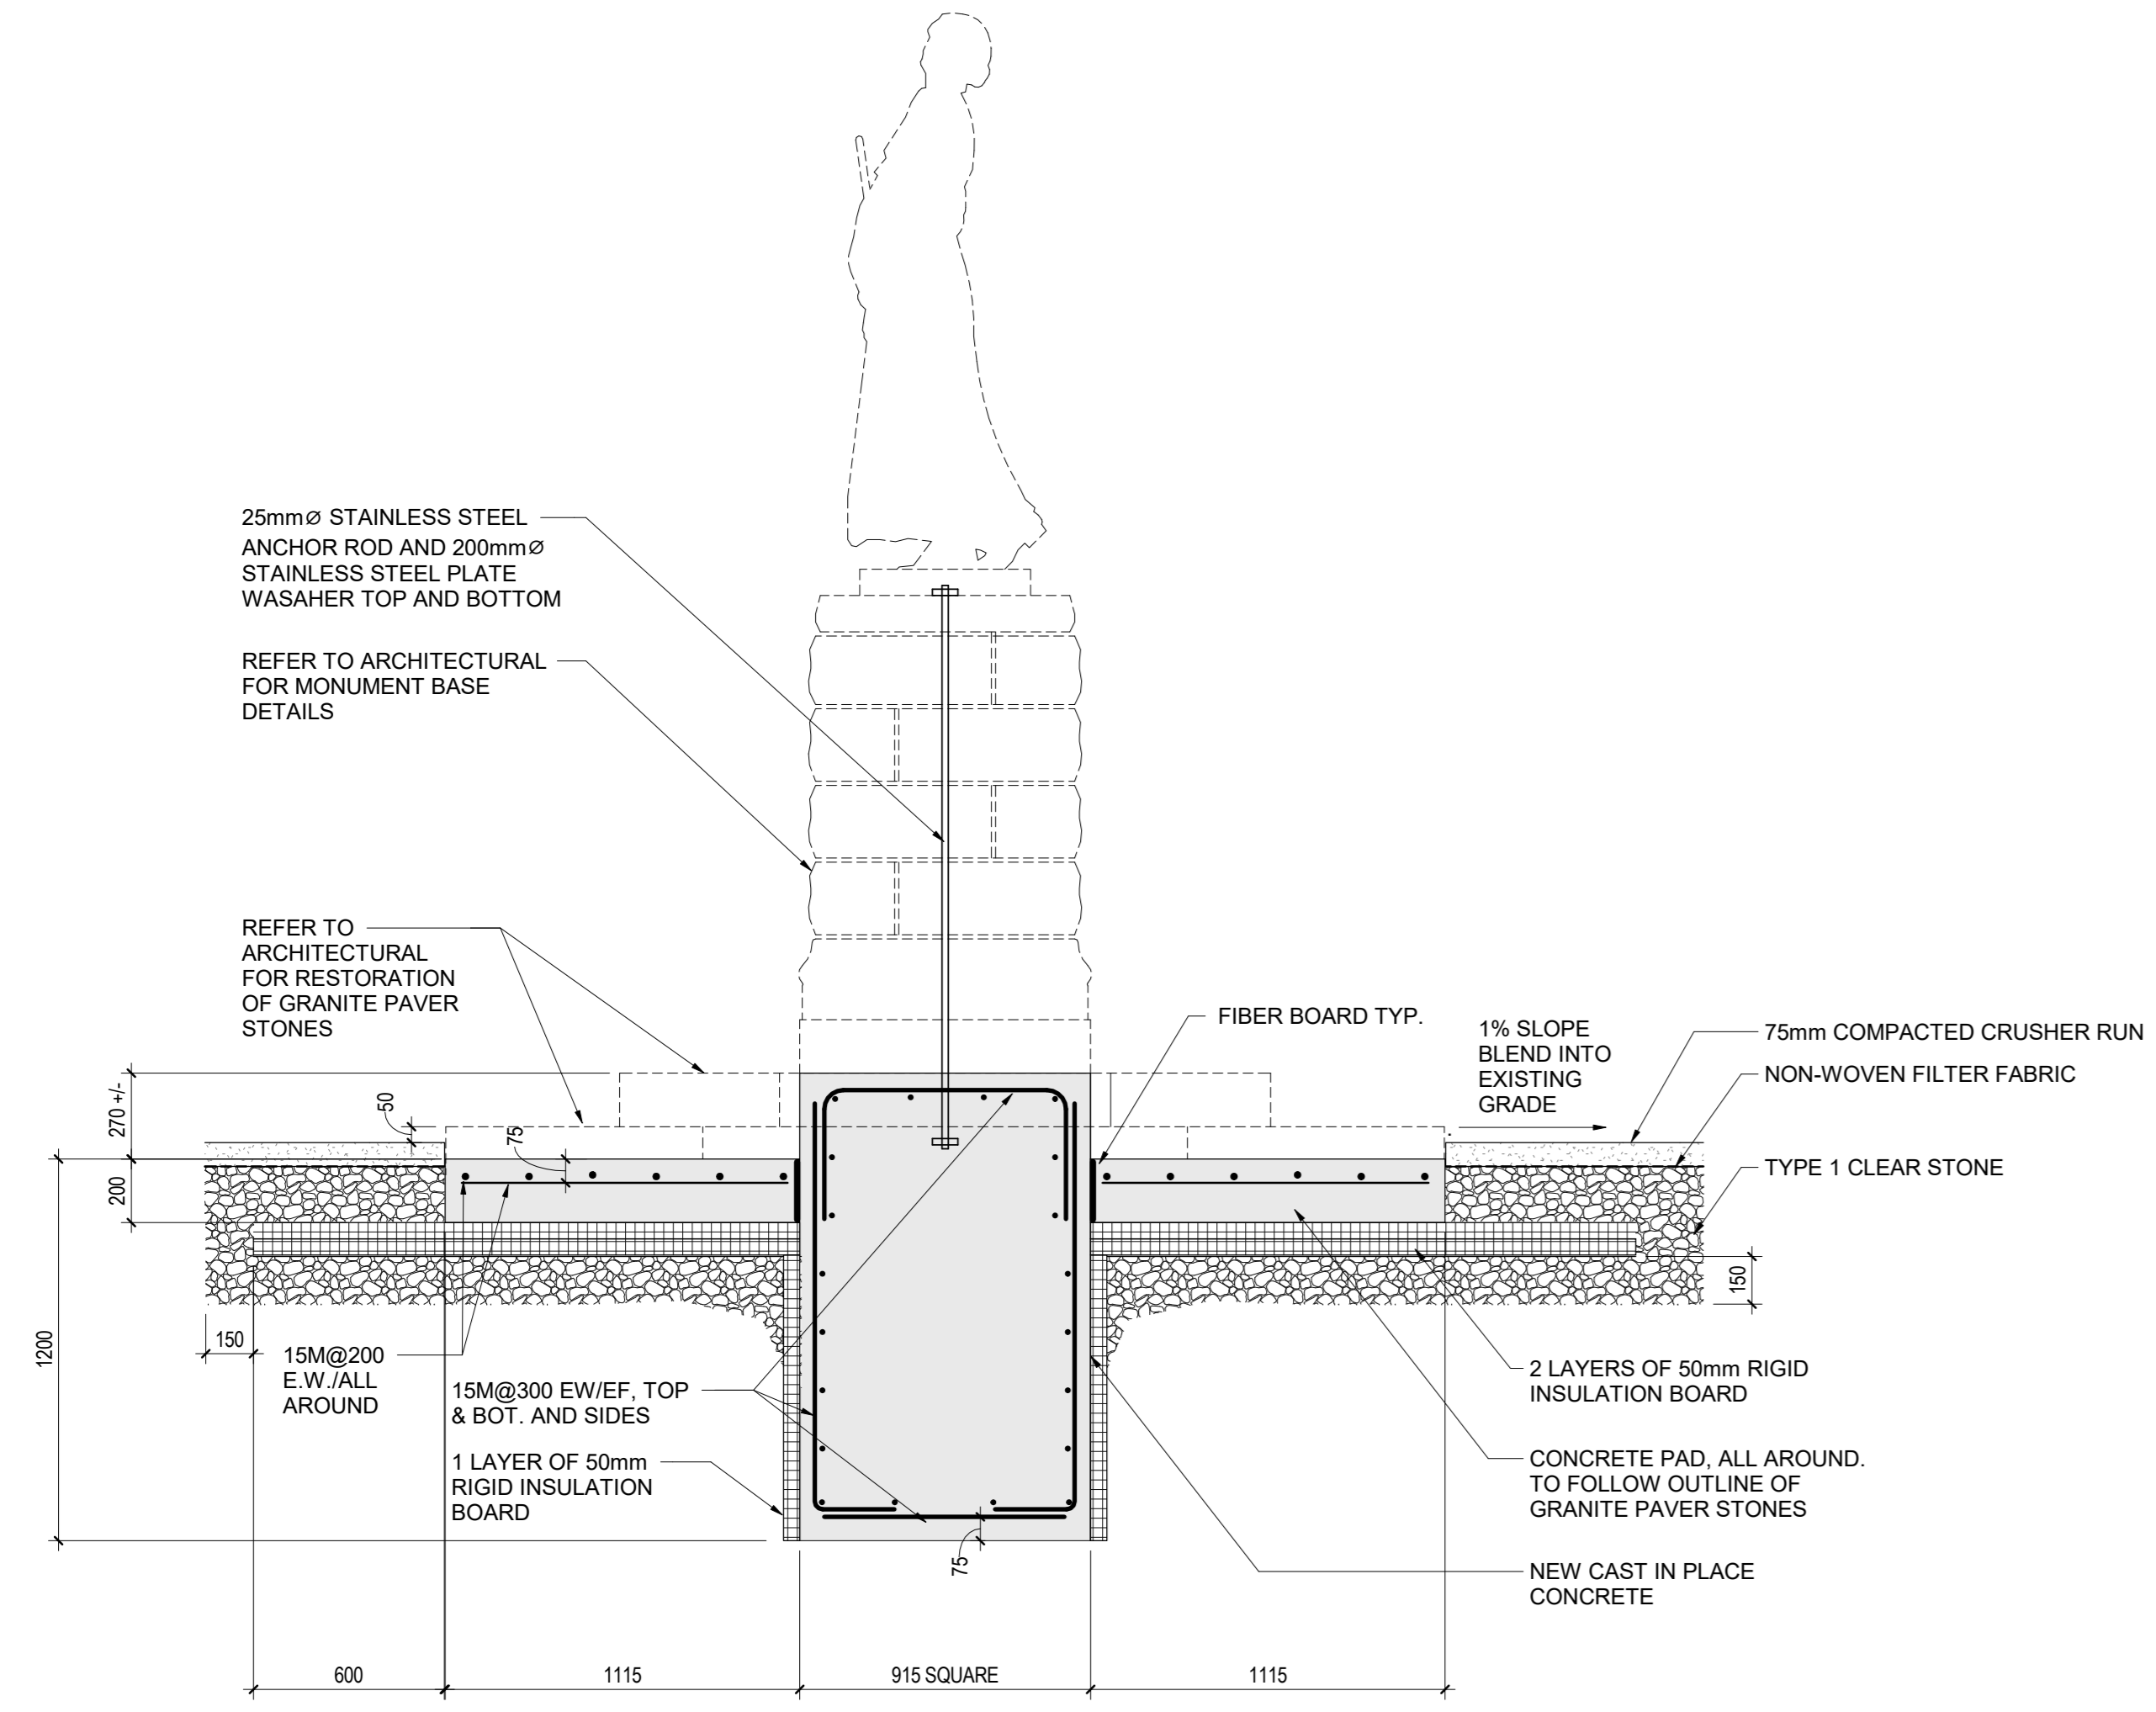
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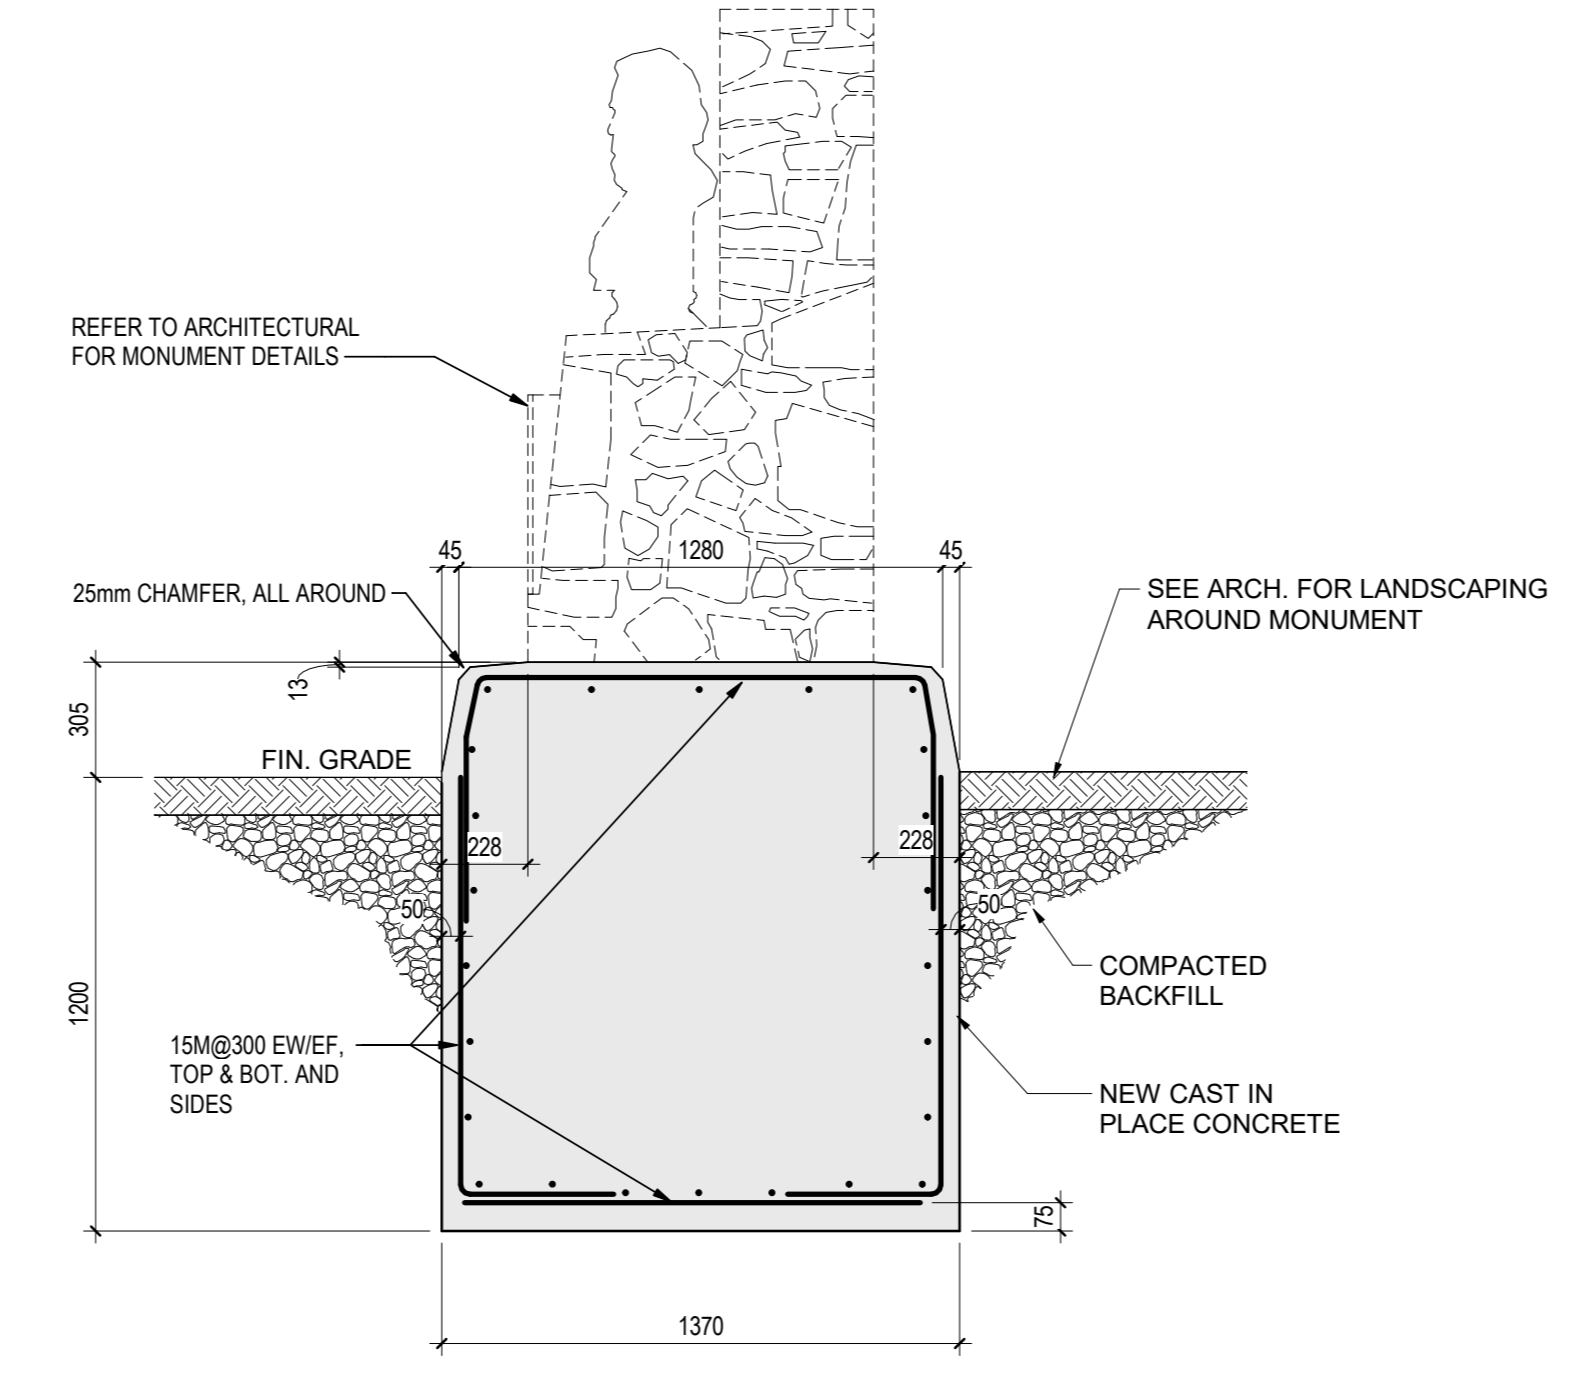
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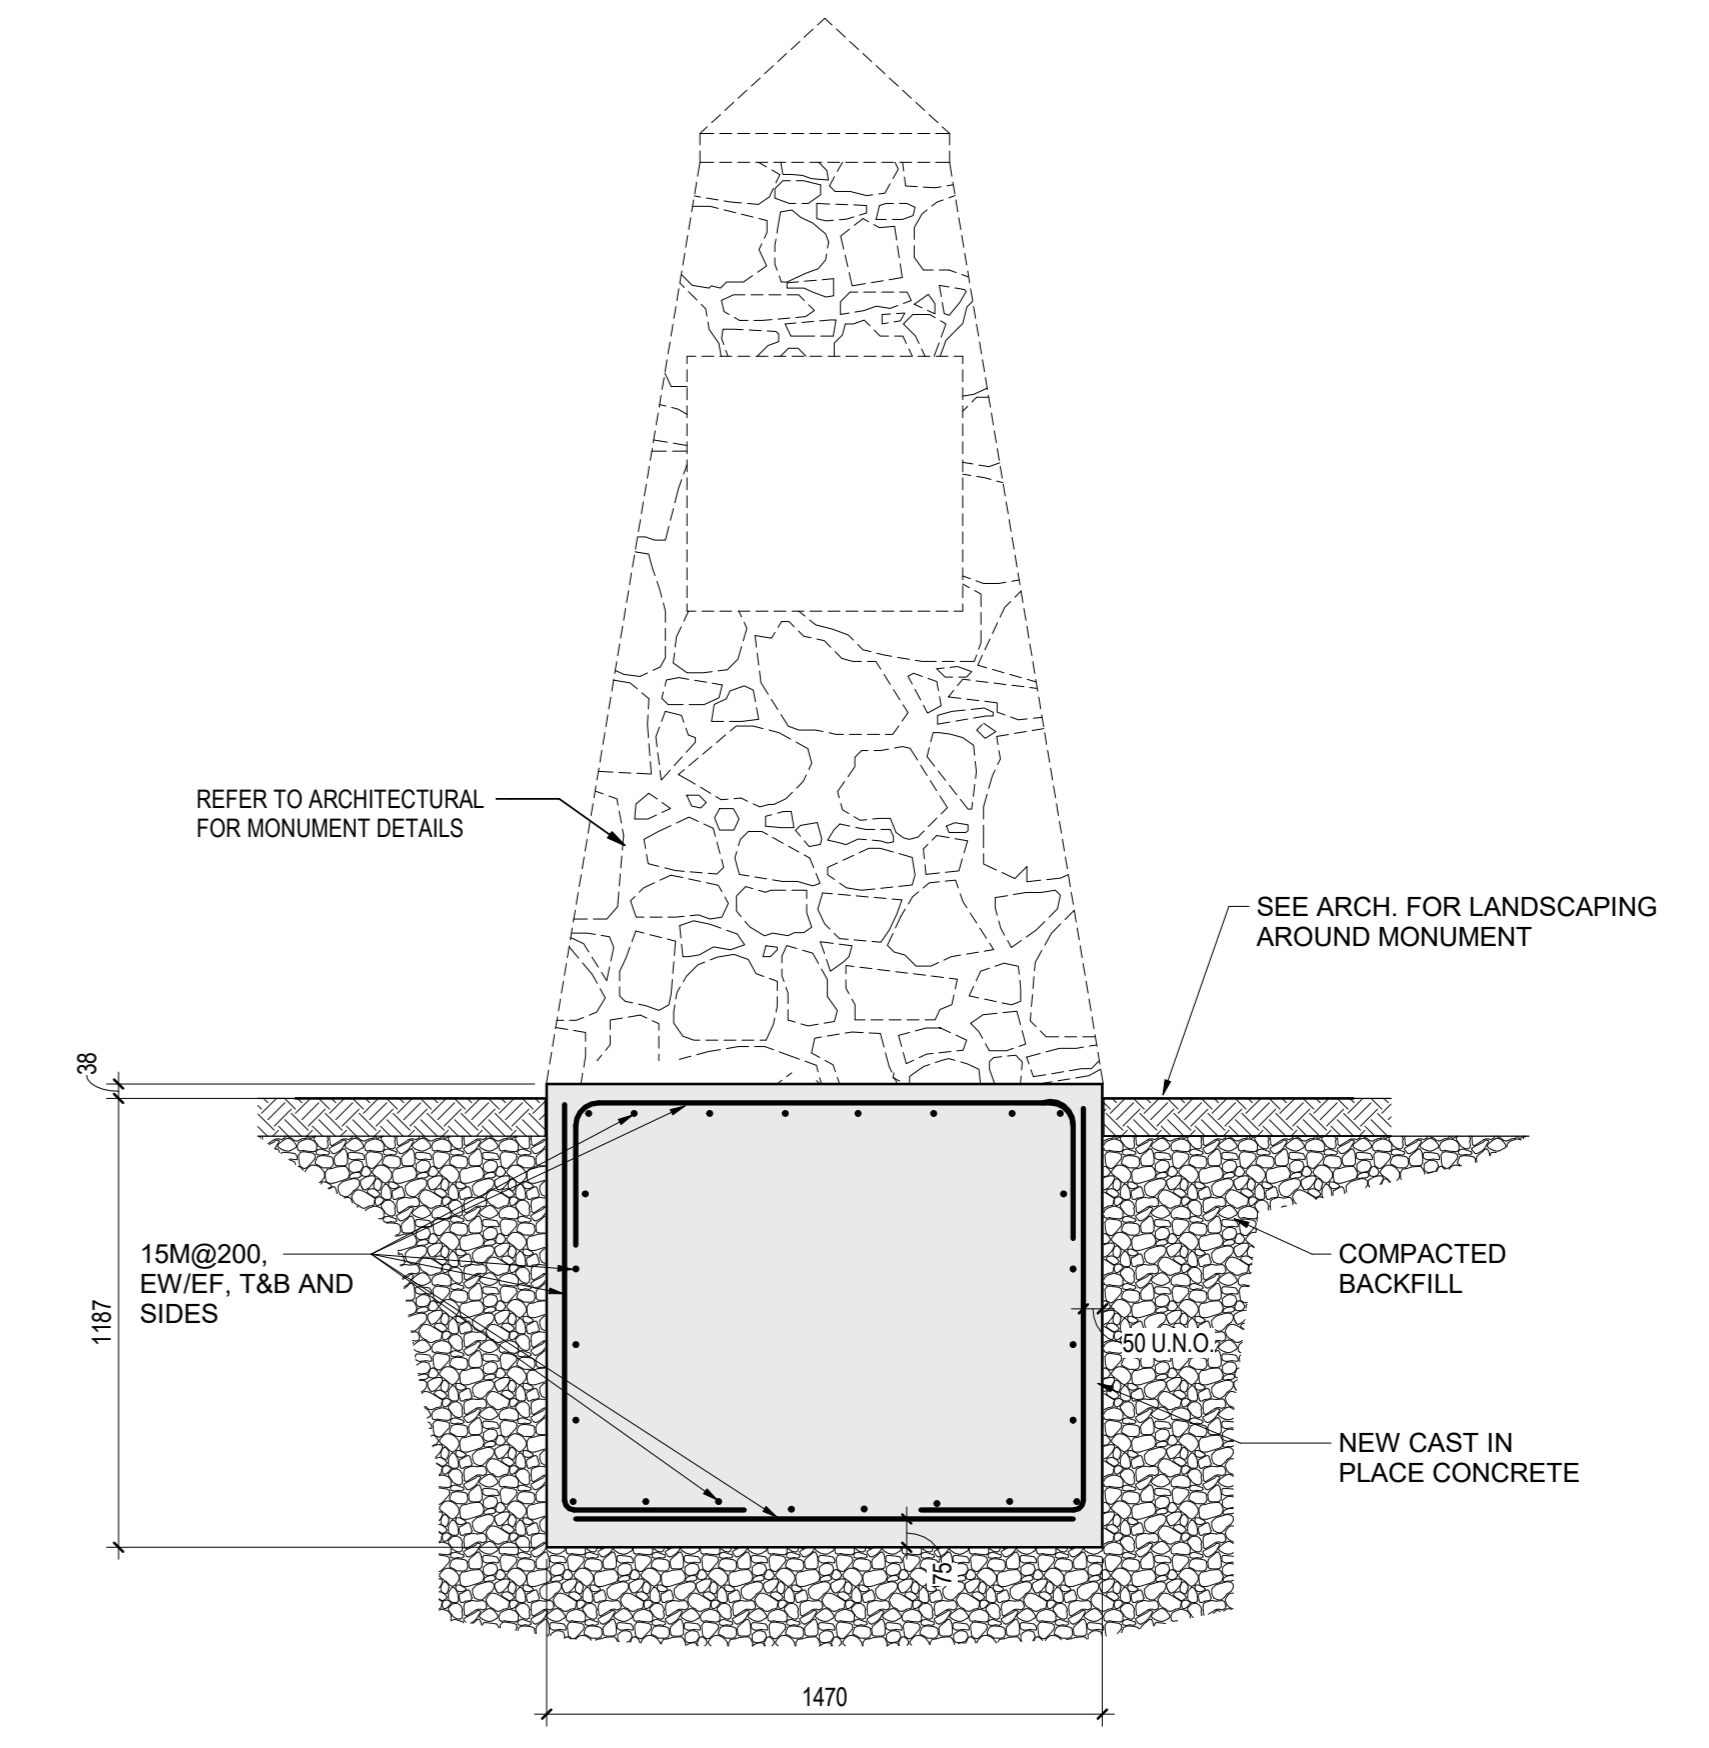
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drawn	PL	dessiné
date	08/28/19	
approved	DB	approuvé
date	08/28/19	
Tender	Soumission	
PW/GSC Project Manager	Administrateur de projets TP/GSC	
project number	no. du projet	
	1241	
drawing no.	no. du dessin	
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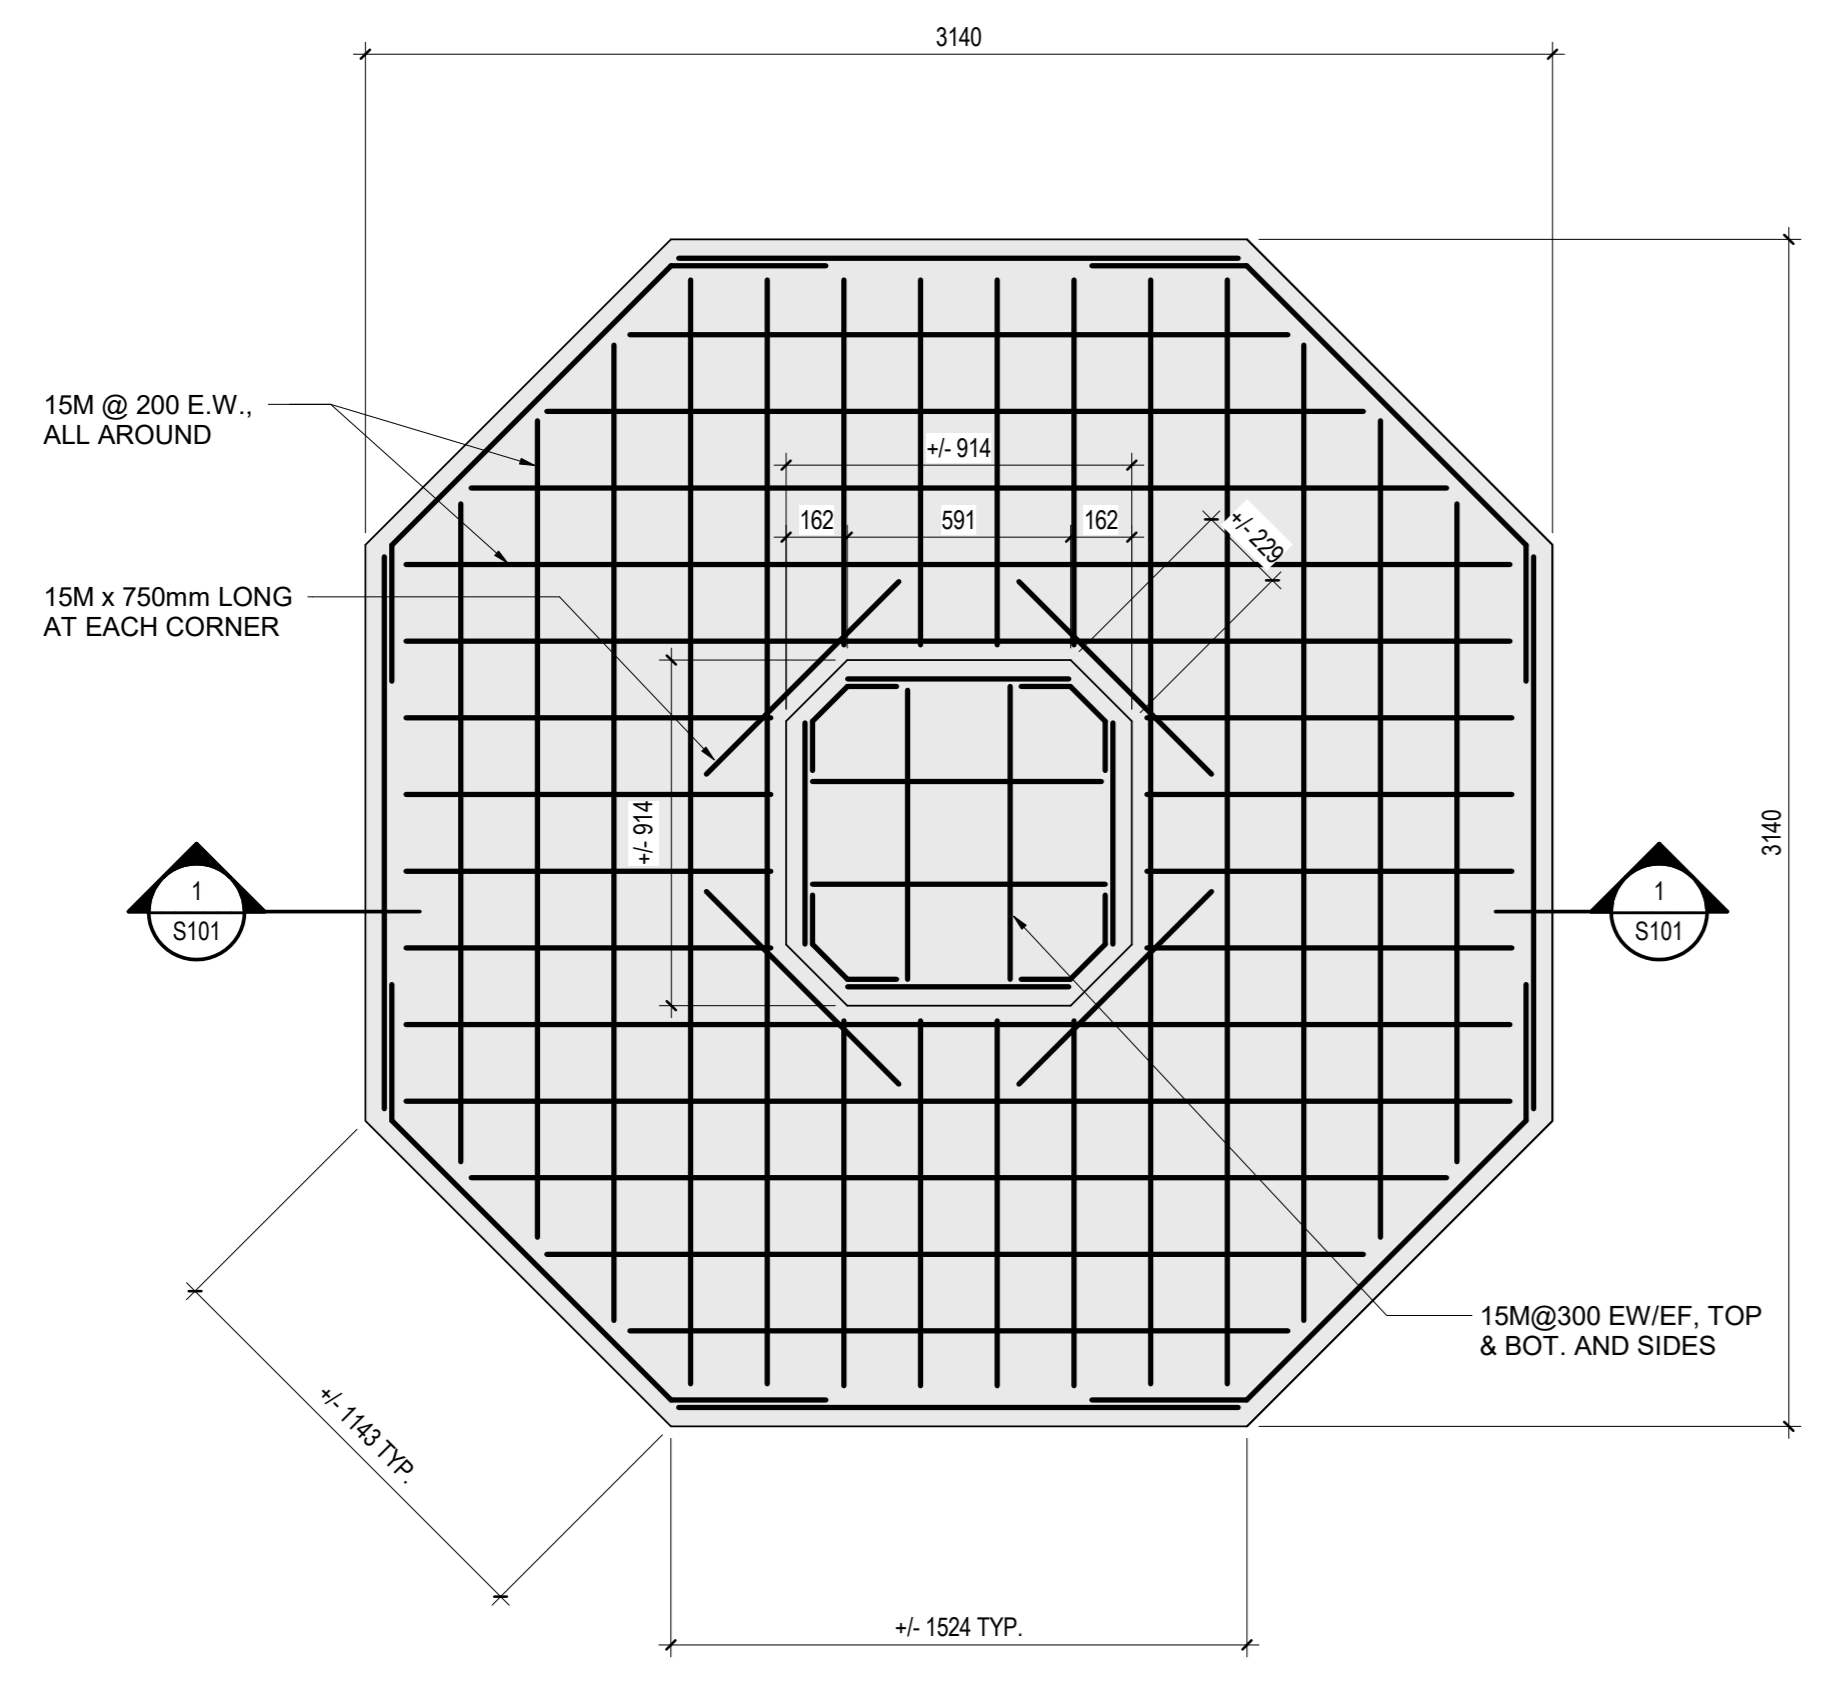
1 EVANGELINE MONUMENT
S101 1:20




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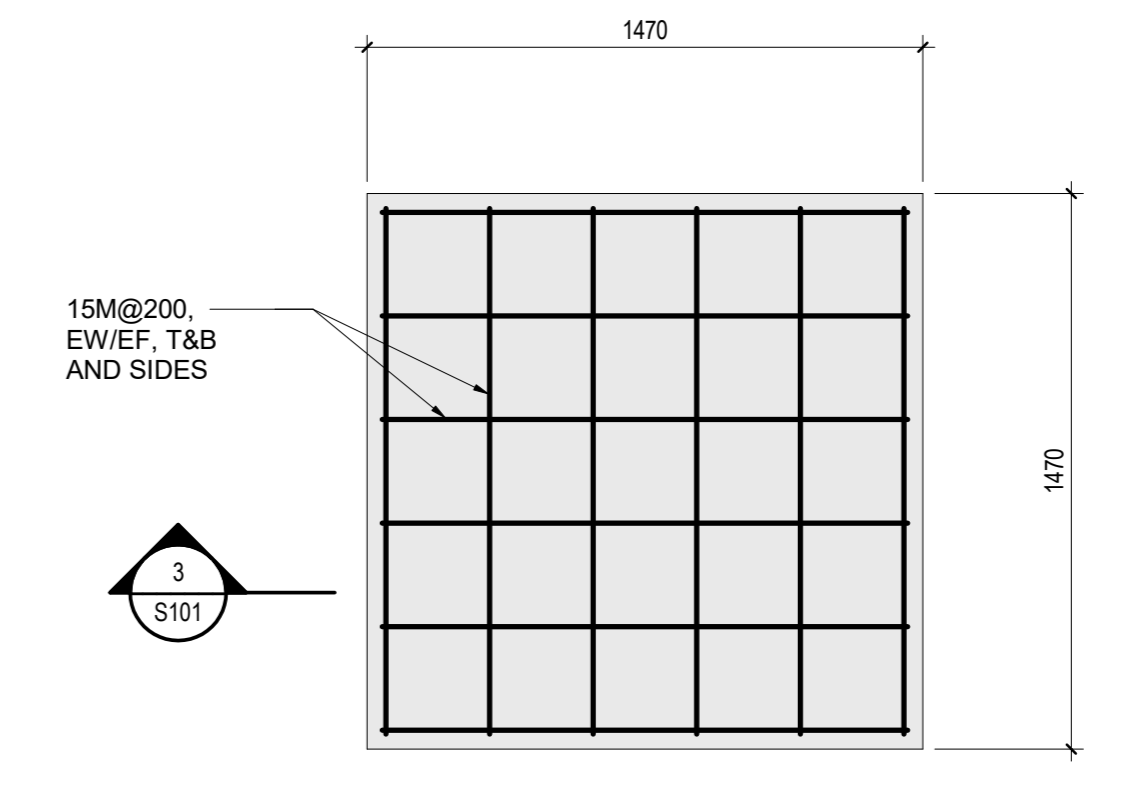
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S101 1:20

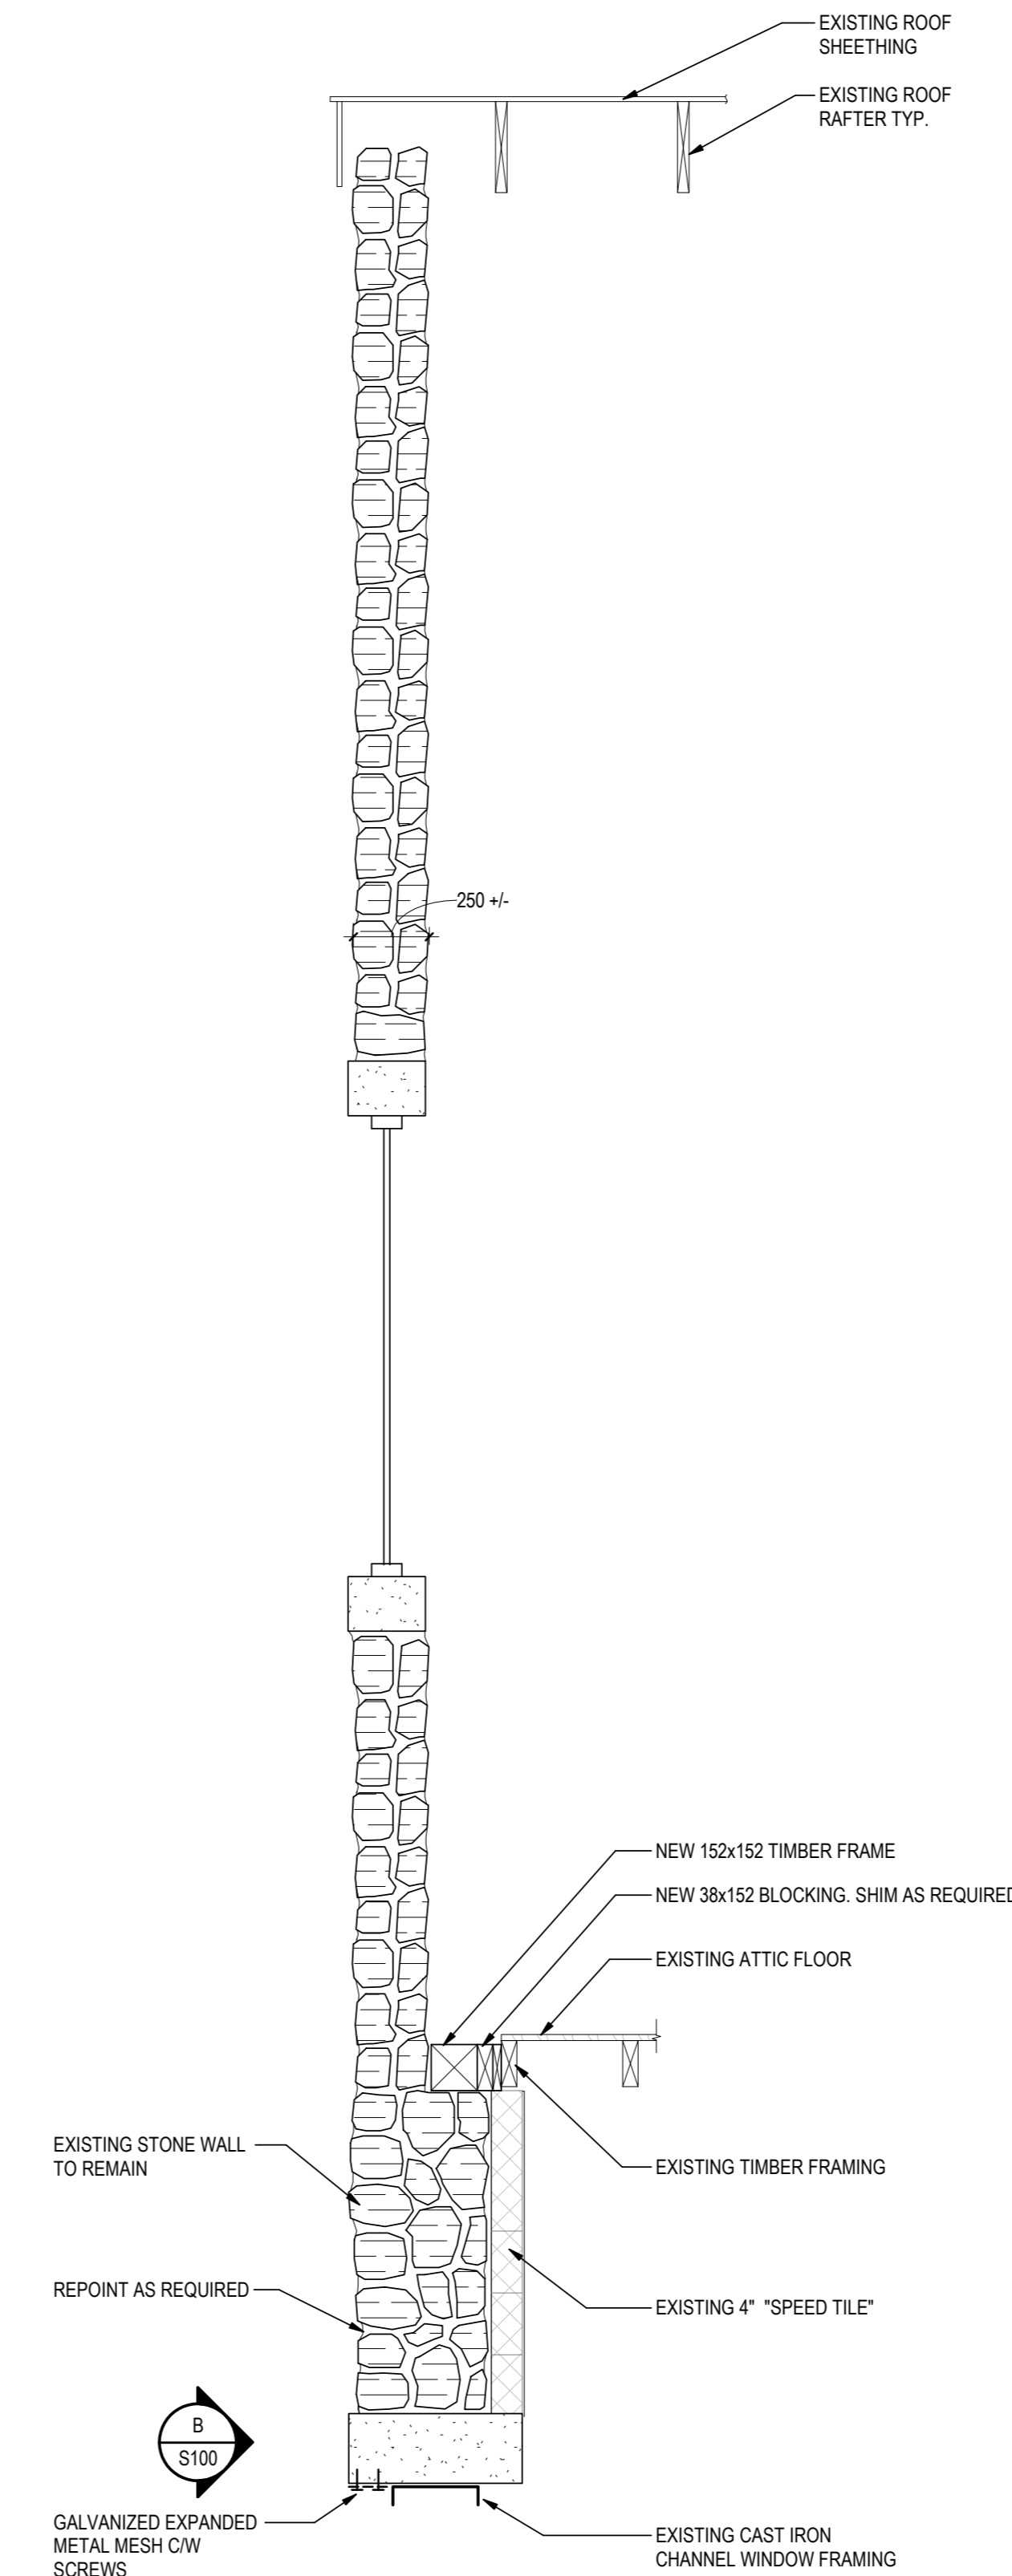


4 EVANGELINE FOUNDATION PLAN
S101 1:20

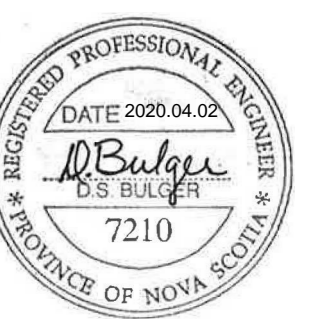

5 LONGFELLOW FOUNDATION PLAN
S101 1:20

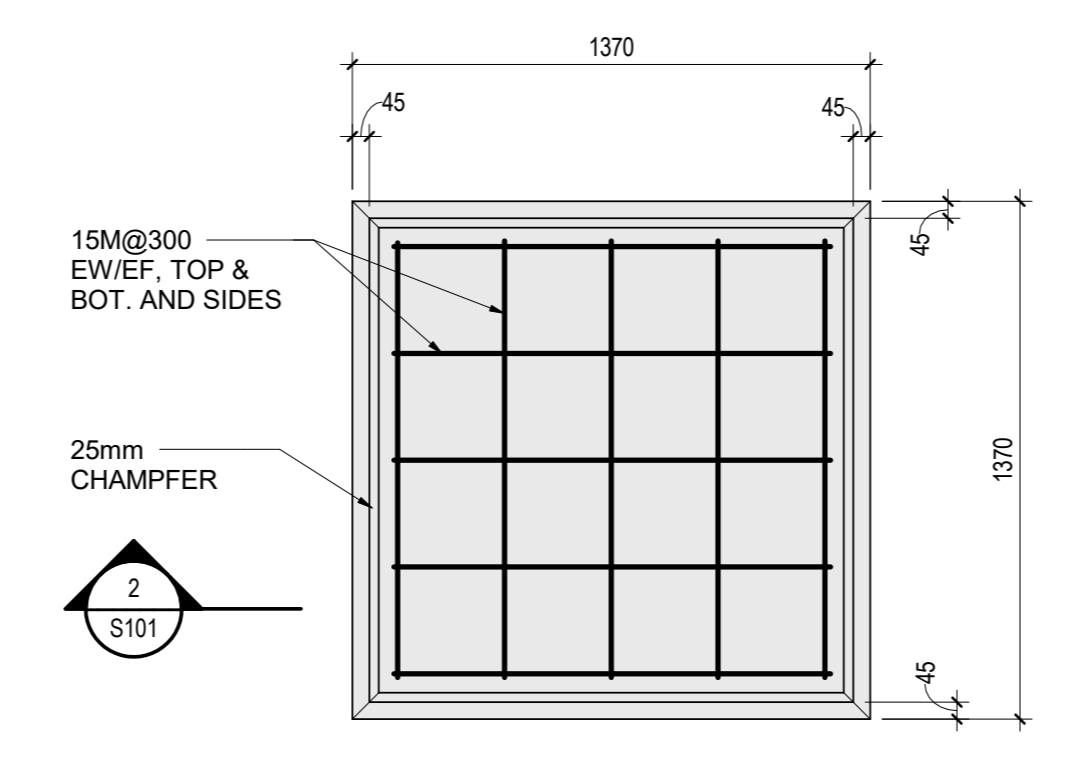

6 PLANTERS FOUNDATION PLAN
S101 1:20

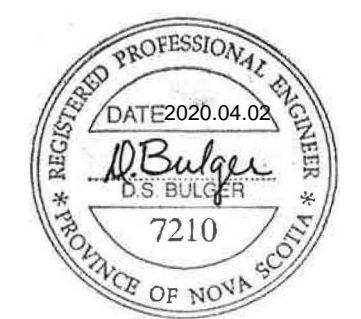

ISSUED FOR TENDER	11 APRIL 2020
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GRAND PRE NATIONAL HISTORIC SITE MEMORIAL CHURCH AND MONUMENTS REPOINTING	
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STRUCTURAL MONUMENTS RE-CONSTRUCTION FOUNDATION DETAILS	
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drawn PL	dessiné
date 11/13/19	
approved DB	approuvé
date 11/13/19	
Tender	Soumission
PWGSC Project Manager	Administrateur de projets TPSGC
project number	no. du projet
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drawing no.	no. du dessin
S101	



ABBREVIATIONS:

A.F.F.	ABOVE FINISHED FLOOR	M.O.	MASONRY OPENING
BD.	BOARD	N/A	NOT APPLICABLE
CL	CENTER TO CENTER	N.I.C.	NOT IN CONTRACT
CL	CENTER LINE	N.T.S.	NOT TO SCALE
CLW	COMPLETE WITH	O.C.	ON CENTER
DEM	DEMOLITION	PCA	PARKS CANADA AGENCY
DWG	DRAWING	SIM.	SIMILAR
ELEV.	ELEVATION	T.O.	TOP OF
EQ.	EQUAL	TYP.	TYPICAL
MAX.	MAXIMUM	US	UNDERSIDE
MIN.	MINIMUM		

GENERAL NOTES:


- THE BIDDING CONTRACTORS ARE ADVISED THAT THIS SET OF CONSTRUCTION DOCUMENTS HAVE BEEN DEVELOPED AND ARE BASED UPON EXISTING ARCHIVED DRAWINGS PROVIDED BY PCA AND RECENT SITE OBSERVATIONS. THE LOCATIONS OF ARCHITECTURAL COMPONENTS, ELECTRICAL COMPONENTS, MECHANICAL COMPONENTS, AND BUILDING SERVICES MAY SLIGHTLY VARY FROM THESE DOCUMENTS. THE CONTRACTORS ARE THEREFORE REQUIRED TO SITE VERIFY AND RECORD QUANTITY TAKE-OFFS OF ALL EXISTING CONDITIONS, PRIOR TO THE COMMENCEMENT OF ANY DEMOLITION WORK. IN ORDER TO PROVIDE THE BIDDING CONTRACTORS WITH A COMPLETE UNDERSTANDING OF THE ENTIRE SCOPE OF WORK REQUIRED, IMMEDIATELY NOTIFY THE PRIME CONSULTANT OF ANY DISCREPANCIES BETWEEN EXISTING CONDITIONS AND THE CONSTRUCTION DOCUMENTS.
- DO NOT SCALE DRAWINGS, ONLY FOLLOW GIVEN DIMENSIONS.
- THE AWARDED CONTRACTOR WILL BE RESPONSIBLE FOR RECORDING AND LABELING ALL TEMPORARILY REMOVED EXTERIOR WALL COMPONENTS AND THE LOCATIONS FROM WHERE EACH COMPONENT CAME FROM IN ORDER TO ENSURE THAT ALL RE-INSTALLED COMPONENTS ARE SECURED BACK TO THEIR ORIGINAL LOCATIONS.
- THE AWARDED CONTRACTOR WILL BE RESPONSIBLE FOR, BUT NOT LIMITED TO, THE COST AND IMPLEMENTATION OF THE FOLLOWING: PROTECTION FOR LANDSCAPING, WEATHER TIGHT BARRIER PROTECTION, PUBLIC SAFETY BARRIERS, DUST CONTROL BARRIERS, MAINTAINING ALL HEALTH AND LIFE SAFETY MEASURES, DEBRIS CONTAINERS AND TEMPORARY FACILITIES. THE CONTRACTOR IS ALSO RESPONSIBLE FOR ANY COSTS FOR SUPPLY AND INSTALLATION OF ANY REPAIRS / REPLACEMENT OF CONDITIONS AND COMPONENTS DAMAGED AS A RESULT OF MOBILIZATION OF CONSTRUCTION MATERIALS, PERSONNEL, EQUIPMENT, TEMPORARY HOARDING, DEMOLITION AND NEW CONSTRUCTION.
- COORDINATE SEQUENCING OF REMOVALS WITH PCA REPRESENTATIVE IN ORDER TO MINIMIZE IMPACTS OF THE DAILY OPERATIONS OF THE FACILITY.
- PATCH, REPAIR AND RE-INSTALL ANY REMAINING CONDITIONS DUE TO REMOVALS OF EXIST COMPONENTS. ENSURE THAT ALL TRANSITIONS BETWEEN NEW / EXISTING SURFACES ARE FLUSH, LEVEL AND SMOOTH AND THAT THE QUALITY OF WORKMANSHIP AND FINISHES MATCH EXISTING ADJACENT CONDITIONS.
- ENSURE THE EXTERIOR ENVELOPE AND MONUMENTS ARE WEATHER PROTECTED AT ALL TIMES DURING THE ENTIRE DURATION OF THE PROJECT. COORDINATE WITH PCA REPRESENTATIVE FOR LOCATIONS OF HOARDING, WASTE CONTAINERS AND ANY OTHER TEMPORARY MEASURES, FACILITIES AND SERVICES REQUIRED TO COMPLETE THE SCOPE OF WORK.
- THE CONTRACTOR IS RESPONSIBLE FOR PROTECTING ALL EXISTING STORED COMPONENTS THROUGHOUT THE DURATION OF THE PROJECT. THE CONTRACTOR IS ALSO RESPONSIBLE FOR ANY COSTS FOR SUPPLY AND INSTALLATION OF ANY REPAIRS / REPLACEMENT OF STORED COMPONENTS DUE TO LOSS OR DAMAGES.

GENERAL DEMOLITION NOTES:

- TEMPORARY AND PERMANENT REMOVALS OF EXTERIOR COMPONENTS:
 - USE CAUTION AND CARE WHEN REMOVING EXISTING COMPONENTS, INCLUDING BUT NOT LIMITED TO WOOD DOORS AT SOUTH ENTRANCES, LUNETTE WINDOW, STONE MASONRY, WOOD TRIM AND DECORATIVE COMPONENTS, WOOD SOFFIT, GUTTERS, DOWNSPOUTS, LIGHTNING ROD / COMPONENTS, CALLING AT OPENINGS; IF DAMAGES OCCUR THEN THE COST OF SUPPLY AND INSTALLATIONS OF REPAIRS / REPLACEMENT SHALL BE THE RESPONSIBILITY CONTRACTOR. REPORT AND HAND OVER DAMAGED COMPONENTS TO THE GENERAL CONTRACTOR FOR REPLICATION. STORE ALL COMPONENTS AND COORDINATE WITH PCA REPRESENTATIVE FOR LOCATIONS OF HOARDING.
 - PRIOR TO REMOVALS OF BUILDING COMPONENTS FOR EITHER REPLICATION, REPAIR AND/OR REPLACEMENT THE CONTRACTOR IS TO LABEL AND RECORD THE LOCATION AND PHYSICAL DIMENSIONS OF EACH COMPONENT REMOVED FROM THE BUILDING.
 - TEMPORARILY REMOVE EXISTING WOOD DOORS AND HARDWARE, FRAMES TO REMAIN UNLESS COMPONENTS EXHIBIT SIGNS OF DETERIORATION BEYOND THE POINT OF REPAIR. STORE DOORS AND HARDWARE FOR RE-FINISHING AND RE-INSTALLATION AS DIRECTED BY PCA REPRESENTATIVE.
 - REMOVE PORTIONS OF ANY ADJACENT REMAINING WOOD COMPONENTS, SURROUNDING WOOD DOORS, WHICH EXHIBIT SIGNS OF SERVE DETERIORATION, MOLD, SPLITTING, ROT AND ANY OTHER SIGNS OF WEAR WHICH WOULD COMPROMISE THE INTEGRITY OF ENTRANCE SYSTEM.
 - TEMPORARILY REMOVE AND STORE EXISTING COMPONENTS AFFEDED INTO EXISTING MASONRY CONDITIONS, INCLUDING BUT NOT LIMITED TO THE FOLLOWING COMPONENTS: BUILDING SIGNAGE, STONE COMPONENTS, ELECTRICAL COMPONENTS, DEVICES, EQUIPMENT, PENETRATIONS FOR BUILDING SERVICES, WALL GONGS, BELLS, BUZZERS, HOSE BIBS AND ANY OTHER COMPONENTS WHICH MAY IMPEDE THE PROGRESS OF DEMOLITION.
- EXTERIOR COMPONENTS TO REMAIN:
 - EXISTING WOOD DOORS AND FRAMES ON WEST ELEVATION, EXISTING WINDOWS, EXISTING ROOF COMPONENTS, EXISTING STAIRS AND RAMP.
 - ANY COMPONENT ATTACHED TO BUILDING THAT DOES NOT EXHIBIT SIGNS OF DETERIORATION OR IMPEDE THE PROCESS OF DEMOLITION OF CONSTRUCTION.
- TEMPORARY REMOVALS OF INTERIOR CONDITIONS AND COMPONENTS:
 - TEMPORARILY REMOVE AND STORE EXISTING INTERIOR COMPONENTS INCLUDING BUT NOT LIMITED TO ARTIFACTS, SIGNAGE, DEVICES THAT MAY BE DAMAGED DURING THE PROCESS OF DEMOLITION.
 - THE CONTRACTOR IS RESPONSIBLE FOR LABELING AND RECORDING ALL TEMPORARILY REMOVED / RELOCATED COMPONENTS AND THE LOCATIONS WHERE EACH COMPONENT CAME FROM IN ORDER TO ENSURE THAT ALL RE-INSTALLED COMPONENTS ARE SECURED BACK TO THEIR ORIGINAL LOCATIONS.
- TEMPORARY AND PERMANENT REMOVALS OF EXISTING SITE RELATED CONDITIONS AND COMPONENTS ADJACENT TO THE PERIMETER OF THE BUILDING:
 - TEMPORARILY PROTECT ANY REMAINING TREES, SHRUBS, PLANTS AND ANY OTHER ORGANIC CONDITIONS, ADJACENT TO PERIMETER OF EXTERIOR WALLS, WHICH MAY IMPEDE THE PROGRESS OF DEMOLITION.
 - THE CONTRACTOR IS RESPONSIBLE FOR LABELING AND RECORDING ALL TEMPORARILY REMOVED / RELOCATED COMPONENTS AND THE LOCATIONS WHERE EACH COMPONENT CAME FROM IN ORDER TO ENSURE THAT ALL RE-INSTALLED COMPONENTS ARE SECURED BACK TO THEIR ORIGINAL LOCATIONS.
- EXTERIOR METAL COMPONENTS:
 - TEMPORARILY REMOVE AND STORE METAL HANDRAILS AND FASTENERS TO ALLOW FOR REPAIRS TO STONE MASONRY. PERMANENTLY REMOVE ANY FASTENERS THAT ARE DETERIORATED BEYOND THE POINT OF REPAIR.

GENERAL CONSTRUCTION NOTES:

- RE-INSTALLATION OF EXISTING WALL COMPONENTS:
 - RE-INSTALLATION OF PREVIOUSLY REMOVED COMPONENTS AND CONDITIONS ALONG ENTIRE PERIMETER OF BUILDING, INCLUDE BUT ARE NOT LIMITED TO, THE FOLLOWING COMPONENTS: SOUTH ENTRY WOOD DOORS AND HARDWARE, BUILDING SIGNAGE, STONE COMPONENTS, SANDSTONE COMPONENTS, ELECTRICAL, MECHANICAL COMPONENTS, DEVICES, EQUIPMENT, PENETRATIONS FOR BUILDING SERVICES, WALL GONGS, BELLS, BUZZERS, HOSE BIBS AND ANY OTHER PREVIOUSLY REMOVED COMPONENTS AND CONDITIONS. ENSURE THAT ALL COMPONENTS, DEVICES, EQUIPMENT AND SERVICES ARE RE-INSTALLED AND SECURED BACK TO THEIR ORIGINAL LOCATIONS IN ORDER TO PROVIDE A COMPLETE AND FULLY OPERATIONAL FACILITY.
- INSTALLATION OF NEW, REPLICATED AND RESTORED COMPONENTS:
 - CLEAN AND PREPARE EXISTING REMAINING OPENINGS TO RECEIVE EXISTING OR NEW DOORS AND ANY OTHER SERVICE PENETRATIONS PREVIOUSLY REMOVED. NO FABRICATION OF COMPONENTS IS PERMITTED WITHOUT SITE MEASURED VERIFICATION OF EACH MASONRY OPENING.
 - REPLICATE WOOD COMPONENTS TO EXACTLY MATCH PERMANENTLY REMOVED COMPONENT INCLUDING BUT NOT LIMITED TO WOOD TRIM AND DECORATIVE COMPONENTS, WOOD SOFFIT, LUNETTE WINDOW COMPONENTS, GUTTERS, DOWNSPOUTS AND LIGHTNING ROD / COMPONENTS, NO FABRICATION OF ANY COMPONENTS ARE PERMITTED WITHOUT SITE MEASURED VERIFICATION OF EACH COMPONENT TO ENSURE THAT EACH REPLICATED UNIT WILL FIT BACK INTO ITS ORIGINAL LOCATION WITHOUT CONFLICT.
 - NEW WOOD COMPONENTS TO MATCH EXISTING CONDITIONS. WOOD COMPONENTS TO BE FINISHED WITH PAINTS / STAINS TO MATCH PREVIOUS REMOVED COMPONENTS.
 - CLEAN AND PREPARE EACH EXISTING OPENING TO RECEIVE RESTORED WOOD DOORS AND LUNETTE WINDOW. RE-INSTALL PREVIOUSLY REMOVED HARDWARE BACK TO THEIR ORIGINAL LOCATIONS PRIOR TO RE-INSTALLATION OF DOORS BACK TO THEIR ORIGINAL FRAMES. PATCH, REPAIR AND RE-FINISH ADJACENT WOOD COMPONENTS, WHICH WERE PREVIOUSLY REMOVED DUE TO SEVERE DETERIORATION.
 - REPLACE EXISTING SEALANTS AND WEATHER STRIPPING ALONG PERIMETER OF DOORS AND FRAMES. INSTALLATION OF ALL COMPONENTS TO BE SQUARE, LEVEL, PLUMB, TRUE AND WEATHER TIGHT.
- MODIFICATIONS AND REPAIRS TO REMAINING WOOD DOOR AND WINDOW COMPONENTS:
 - REMOVE, LABEL AND STORE ALL HARDWARE COMPONENTS PRIOR TO RE-FINISHING OF WOOD DOORS.
 - RE-FINISH AND SEAL EXISTING WOOD FRAMES AND METAL TRANSOM FRAMES AT SOUTH DOOR ENTRANCES AND LUNETTE WINDOW WITH EXTERIOR PAINT TO MATCH EXISTING.
 - CLEAN ALL DOOR HARDWARE PRIOR TO RE-INSTALLATION OF DOORS. ENSURE ALL HARDWARE COMPONENTS ARE INSTALLED BACK TO THEIR ORIGINAL LOCATIONS.
- RE-INSTALLMENT OF PREVIOUSLY REMOVED / RELOCATED INTERIOR COMPONENTS AND CONDITIONS:
 - RE-INSTALLATION OF PREVIOUSLY REMOVED / RELOCATED COMPONENTS AND CONDITIONS. INCLUDE BUT ARE NOT LIMITED TO, THE FOLLOWING: ARTIFACTS, SIGNAGE AND DEVICES WHICH IMPEDED THE PROGRESS OF DEMOLITION AND CONSTRUCTION.
 - ENSURE THAT ALL PREVIOUSLY REMOVED COMPONENTS ARE RELOCATED BACK TO THEIR ORIGINAL LOCATIONS.
- RE-INSTALLMENT OF EXISTING SITE RELATED CONDITIONS AND COMPONENTS ALONG THE PERIMETER OF THE BUILDING:
 - REMOVE TEMPORARY PROTECTION FROM EXISTING PLANTS, LANDSCAPING, SHRUBS AND ANY OTHER ORGANIC CONDITIONS. THE CONTRACTOR IS RESPONSIBLE FOR ANY COSTS ASSOCIATED FOR SUPPLY AND INSTALLATION ANY SITE CONDITIONS DAMAGED AS A RESULT OF MOBILIZATION OF CONSTRUCTION MATERIALS, SITE PERSONNEL, EQUIPMENT, TEMPORARY HOARDING, DEMOLITION AND NEW CONSTRUCTION.
- EXTERIOR METAL COMPONENTS:
 - ENSURE THAT ANY PERMANENTLY REMOVED METAL COMPONENTS ARE REPLACED WITH NEW COMPONENTS MATCHING THE PHYSICAL CHARACTERISTICS OF THE PREVIOUSLY REMOVED COMPONENT.
 - REMOVE ALL SURFACE RUST, PRIOR TO RE-FINISHING, FROM PREVIOUSLY REMOVED METAL HANDRAILS. RE-INSTALL PREVIOUSLY REMOVED COMPONENTS AFTER REPAIRS TO ORIGINAL LOCATION.

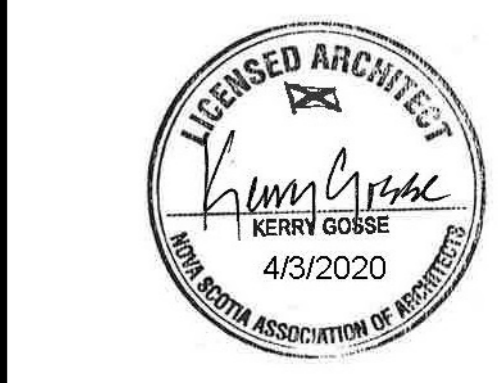


1	ISSUED FOR TENDER	02 APRIL 2020
revisions		date


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GRAND-PRÉ NATIONAL HISTORIC SITE MEMORIAL CHURCH AND MONUMENTS REPOINTING
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GENERAL NOTES

designed Designer	conpu
date	01/08/20
drawn	MG
date	01/08/20
approved Approver	approuv
date	01/08/20
Tender	Soumission
PWGSC Project Manager	Administrateur de projets TPSCG
project number	no. du projet
	1241
drawing no.	no. du dessin
	A100

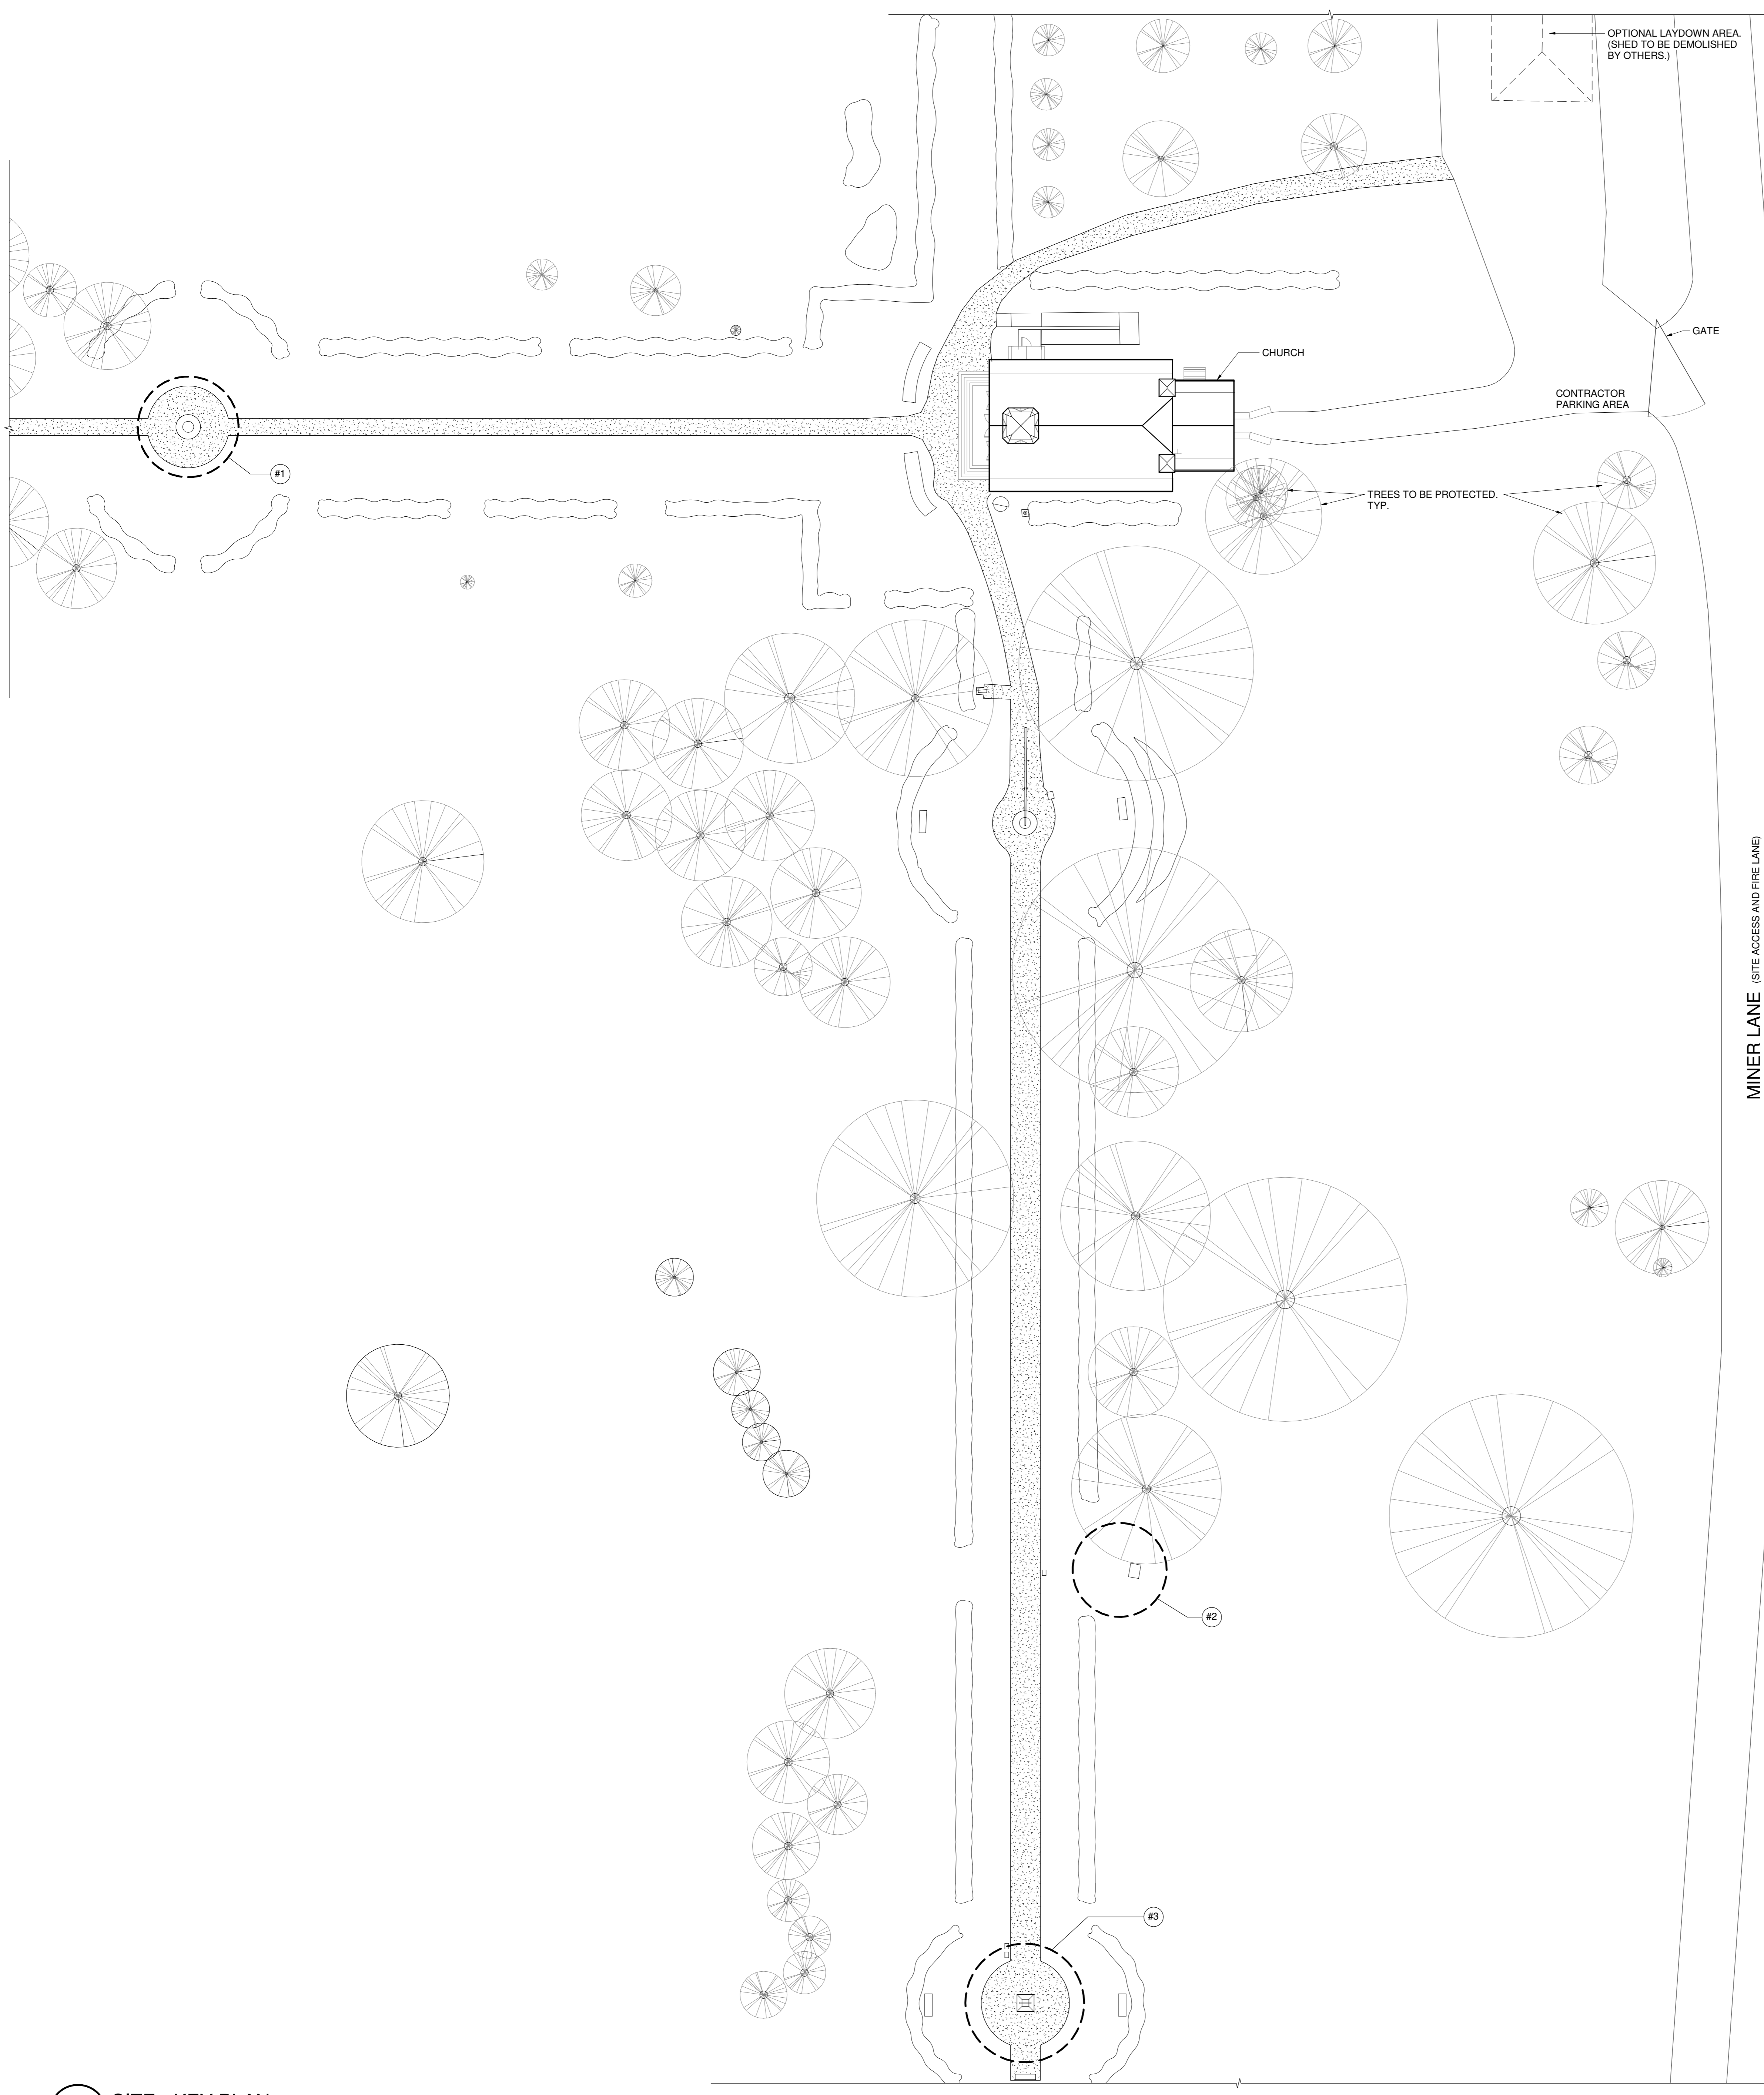

1 SITE - KEY PLAN
A101 1:250

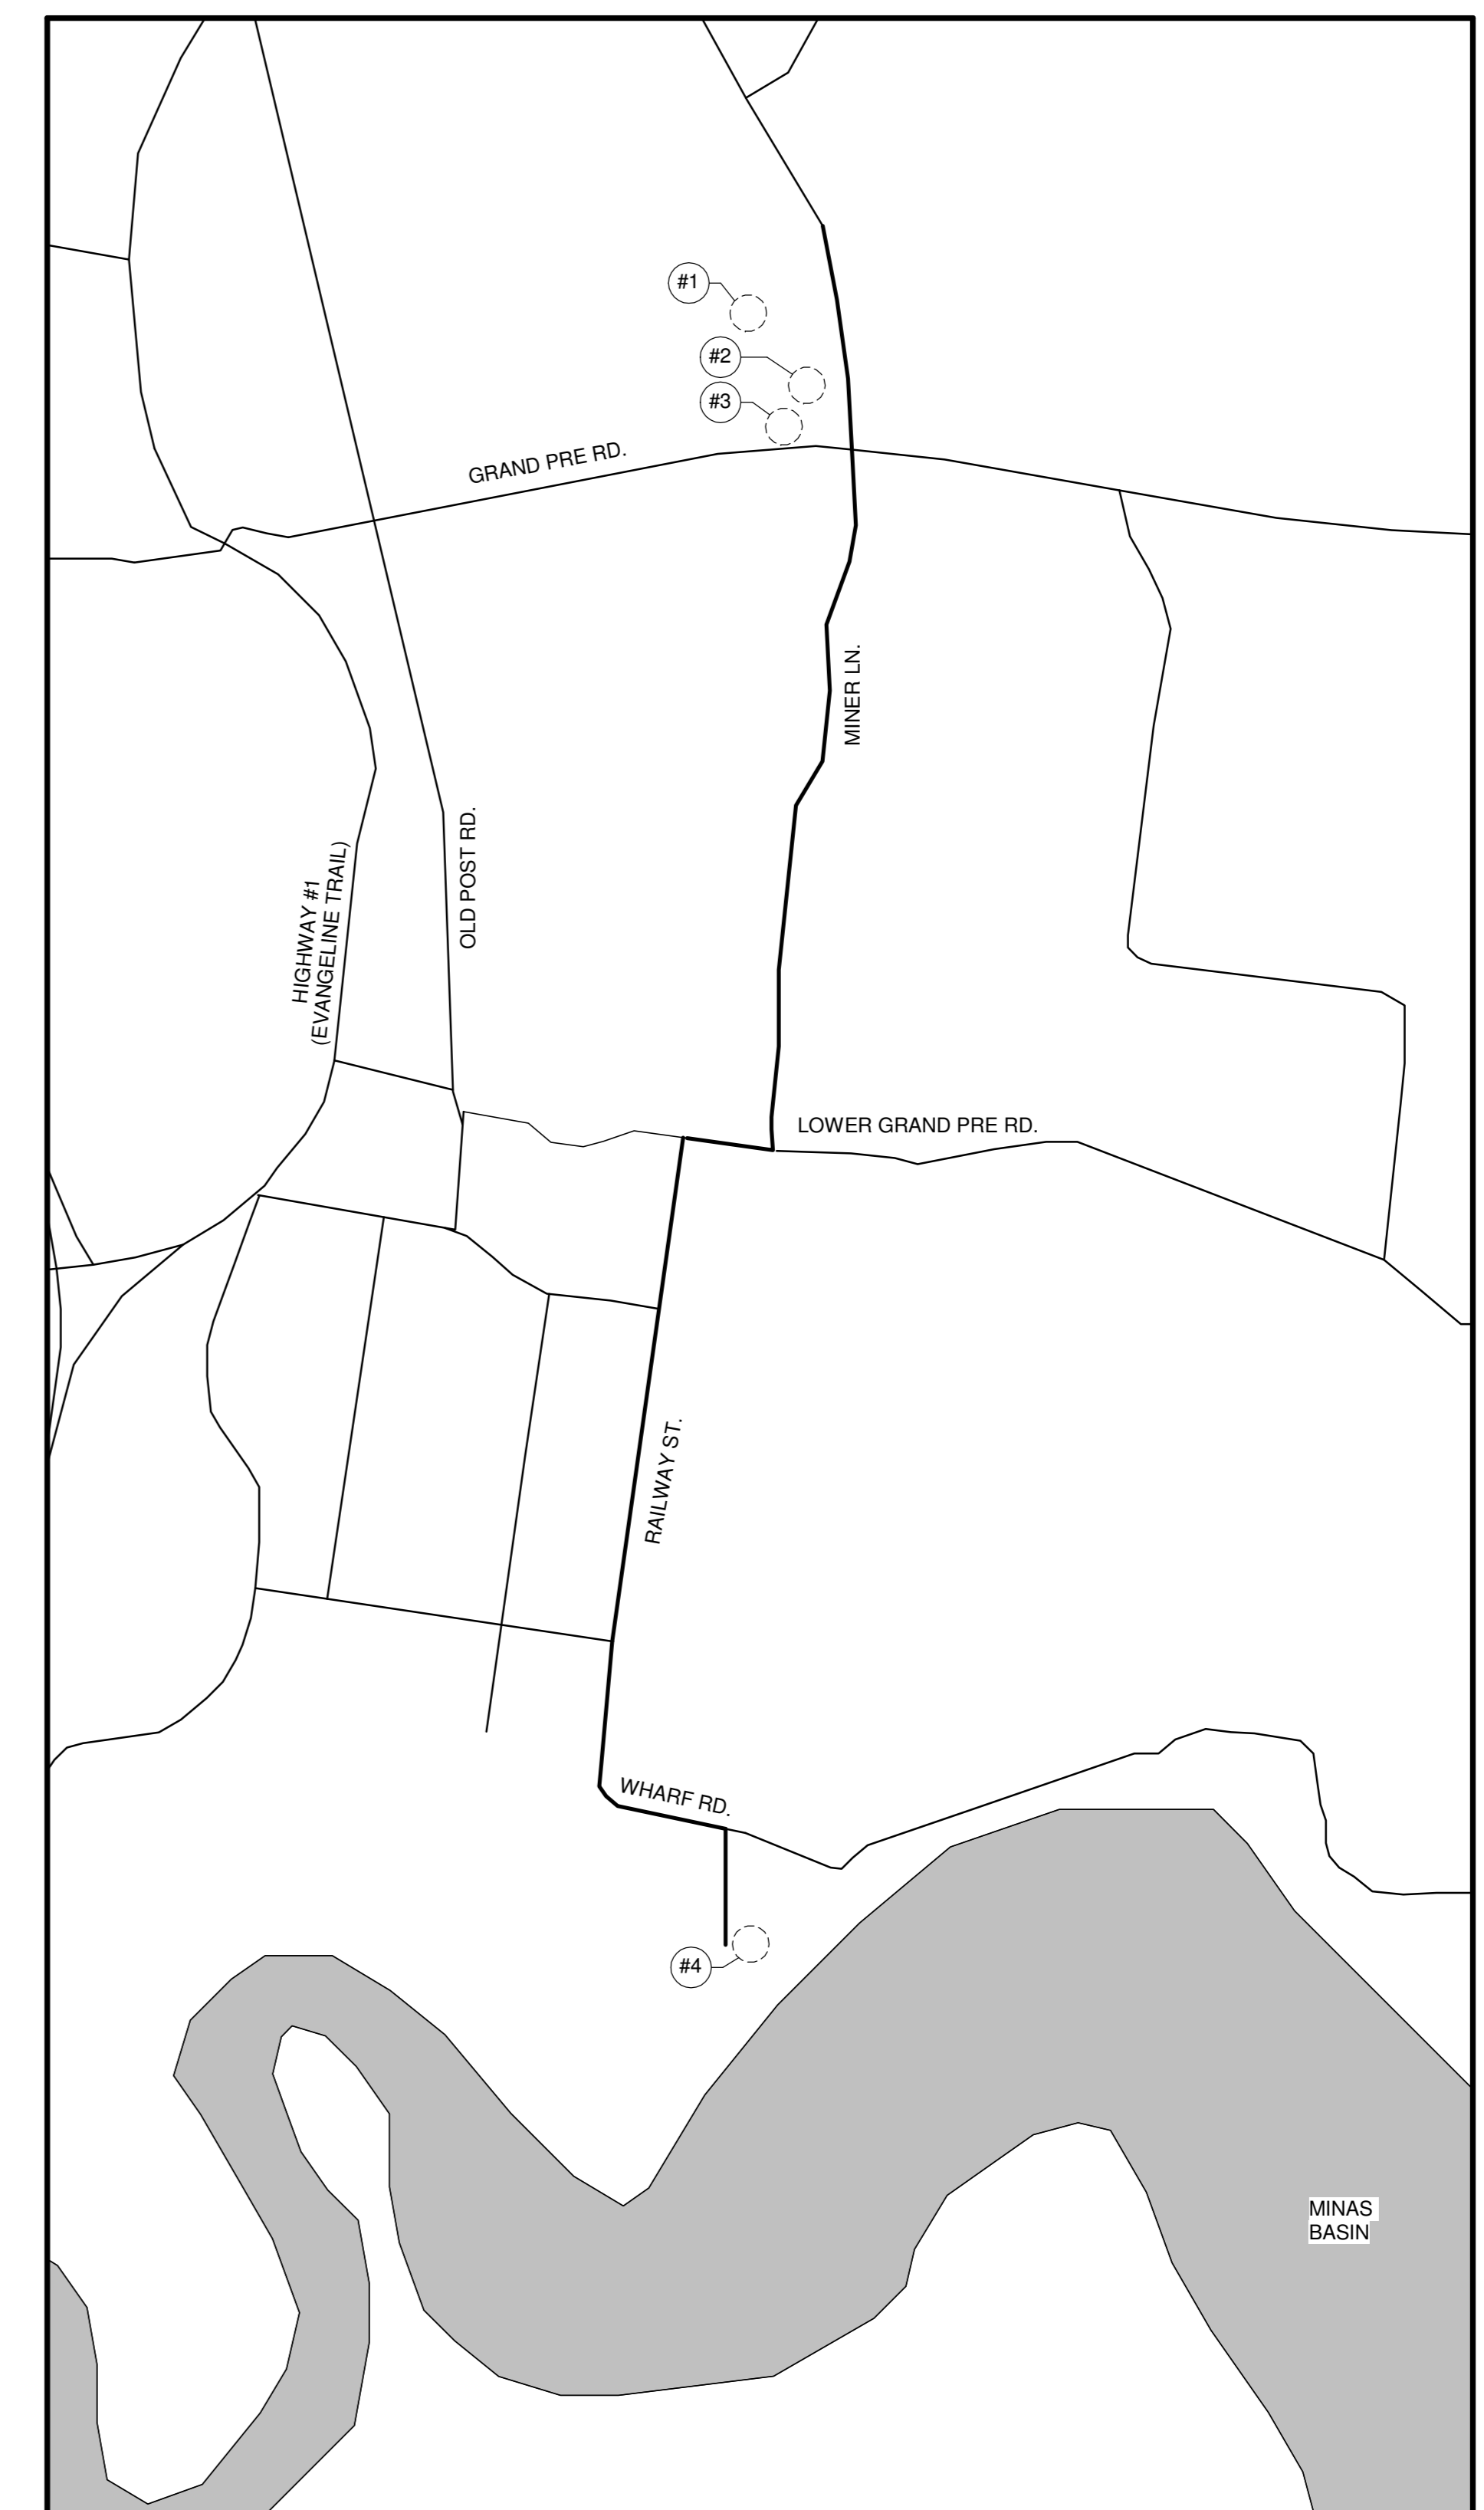


MONUMENT KEYPLAN

MONUMENT IDENTIFIER LEGEND:



- #1 EVANGELINE MONUMENT
- #2 LONGFELLOW MONUMENT
- #3 HERBIN CROSS MONUMENT
- #4 PLANTER'S MONUMENT AT HORTON LANDING

SITE LEGEND:

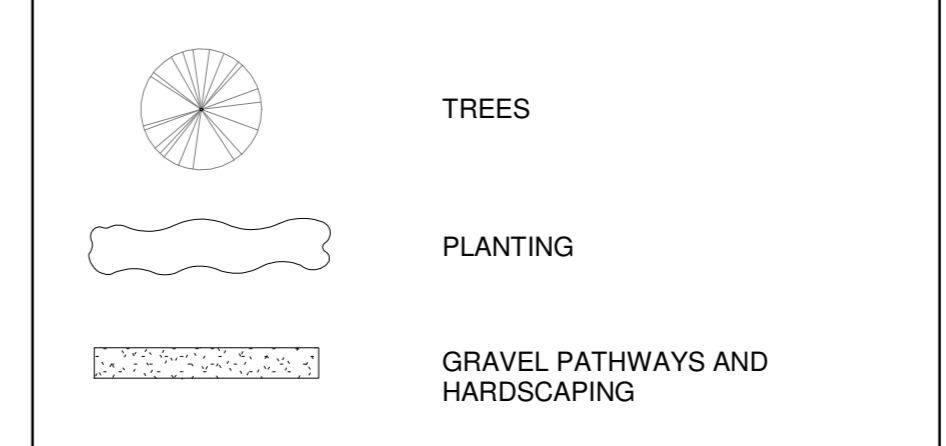

GENERAL NOTES:

1. THIS IS A NATIONAL HISTORIC SITE AND UNESCO WORLD HERITAGE SITE. ALL NECESSARY CARE AND PRECAUTIONS MUST BE TAKEN TO PREVENT DISTURBING OR DAMAGING EXISTING SITE CONDITIONS. THE CONTRACTOR IS RESPONSIBLE FOR PROVIDING MEANS (SUPPORTED BY ENGINEER'S STAMP IF REQUESTED) FOR SUB-SURFACE PROTECTION FOR ALL LOCATIONS WHERE MATERIALS MAY BE LAID DOWN OR STORED, WHERE VEHICLES OR EQUIPMENT MAY RUN, WHERE STONES ARE WASHED, OR WHERE ANY OTHER POSSIBLE ACTIVITIES OCCUR THAT MAY CAUSE DETRIMENTAL IMPACT.

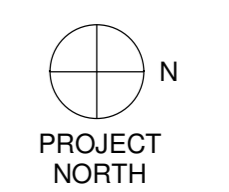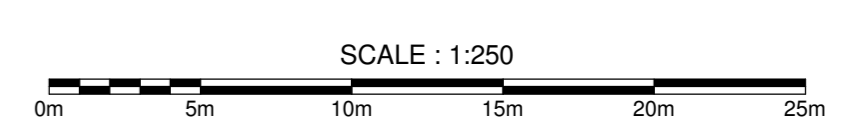


1	ISSUED FOR TENDER	02 APRIL 2020
revisions		date
project	GRAND-PRÉ NATIONAL HISTORIC SITE MEMORIAL CHURCH AND MONUMENTS REPOINTING	
drawing	SITE PLAN	

designed	Designer	conpu
date	07/12/19	
drawn	Author	desiné
date	07/12/19	
approved	Approver	approuvé
date	07/12/19	
Tender	Submission	
PWGSC Project Manager	Administrateur de projets TPSCG	
project number	1241	no. du projet
drawing no.	A101	no. du dessin




6
A401

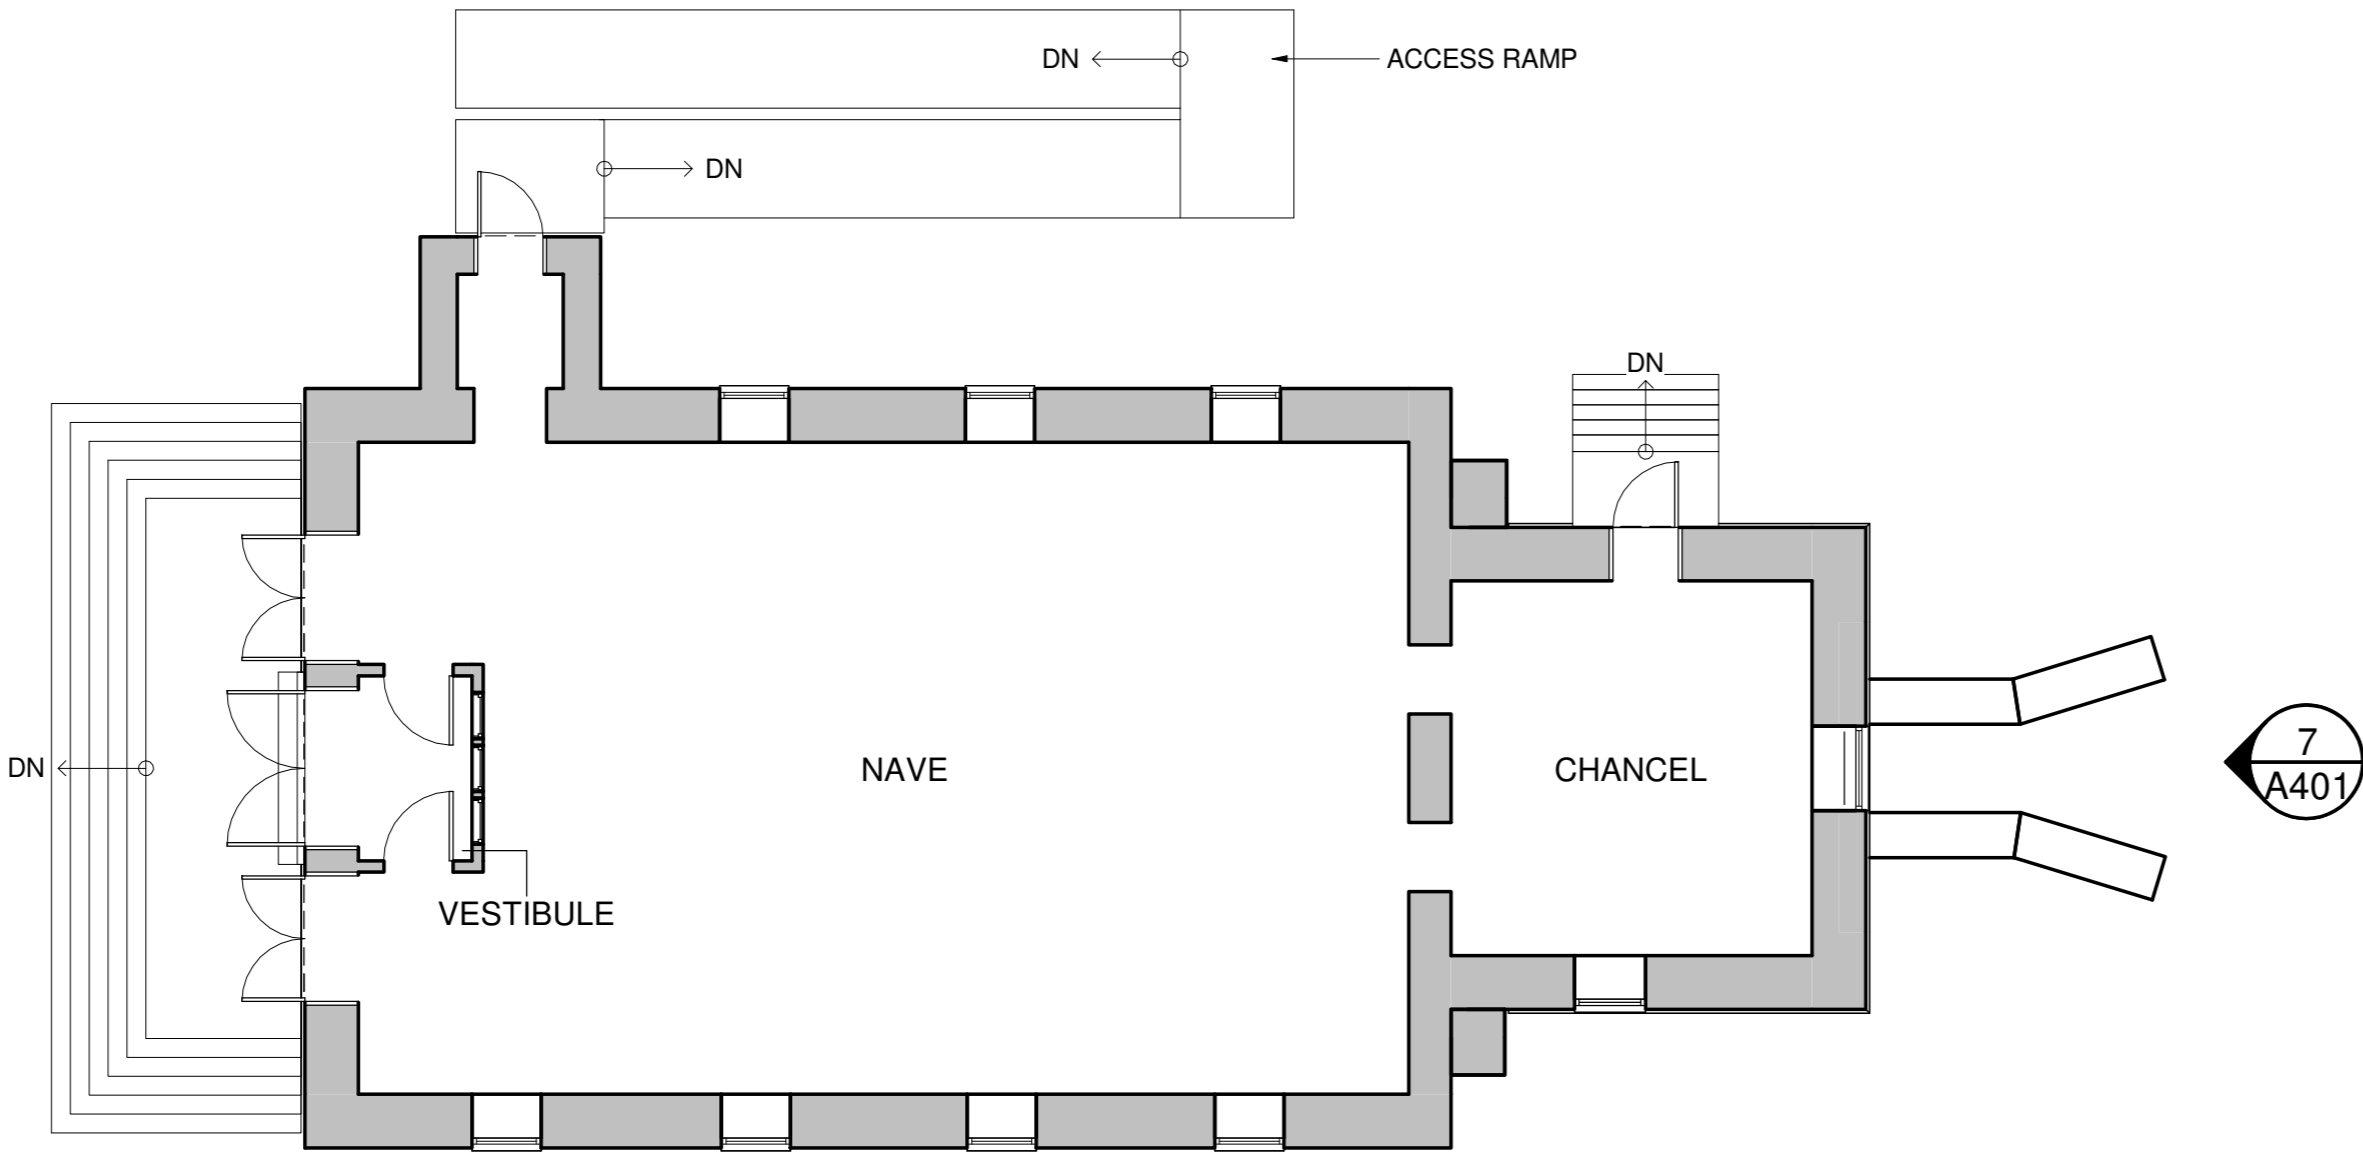



EXISTING CONDITIONS LEGEND

X# PHOTOGRAPH LOCATION. SEE DRAWINGS A901-A903
X = ELEVATION
= PHOTO NUMBER

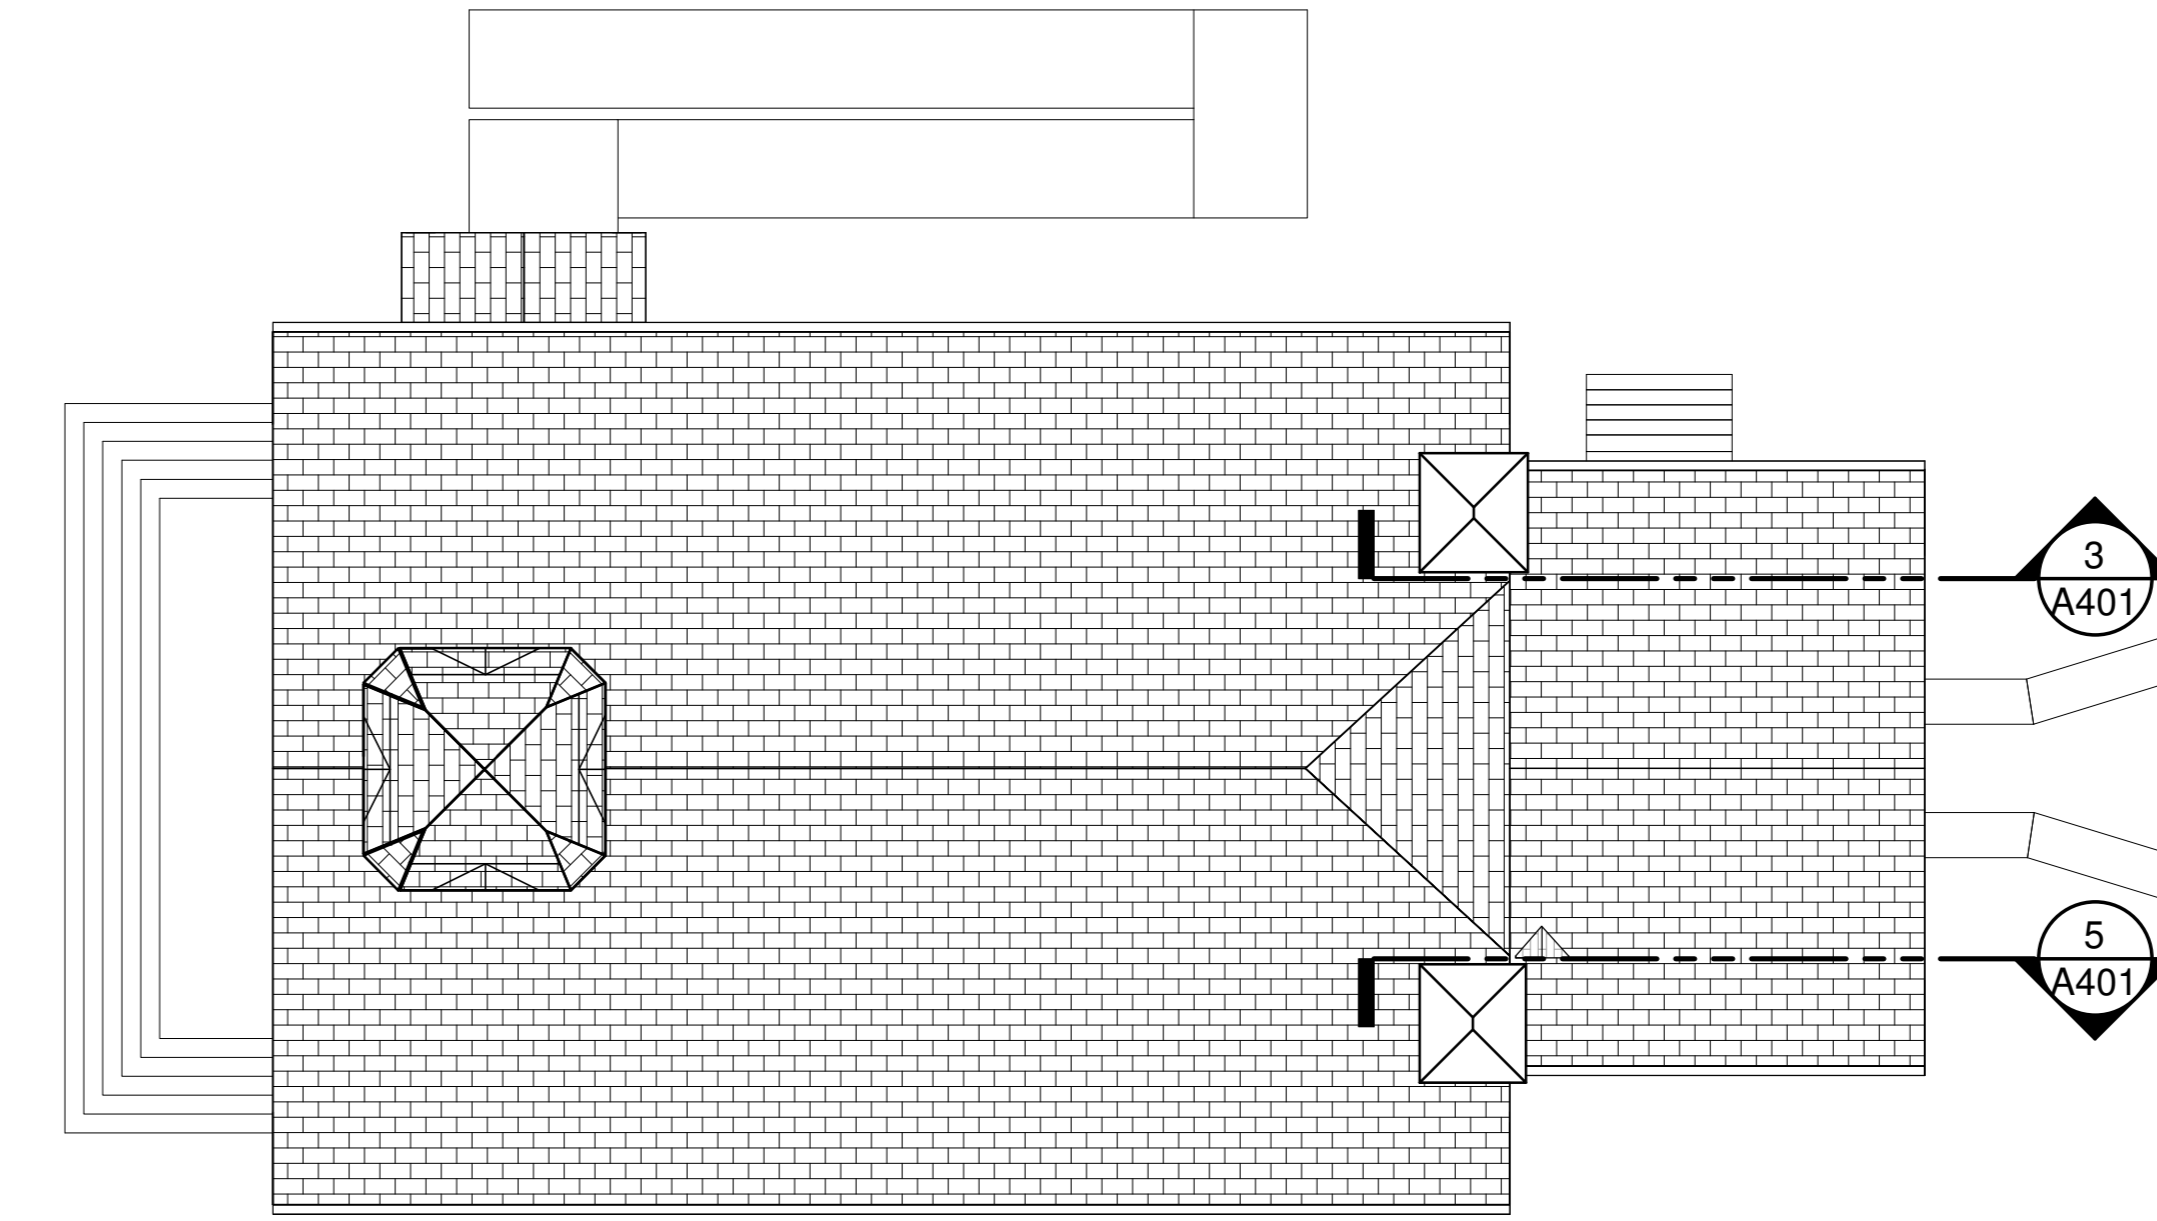

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A401
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EXISTING MAIN FLOOR



2
A401
1:100
EXISTING ROOF PLAN

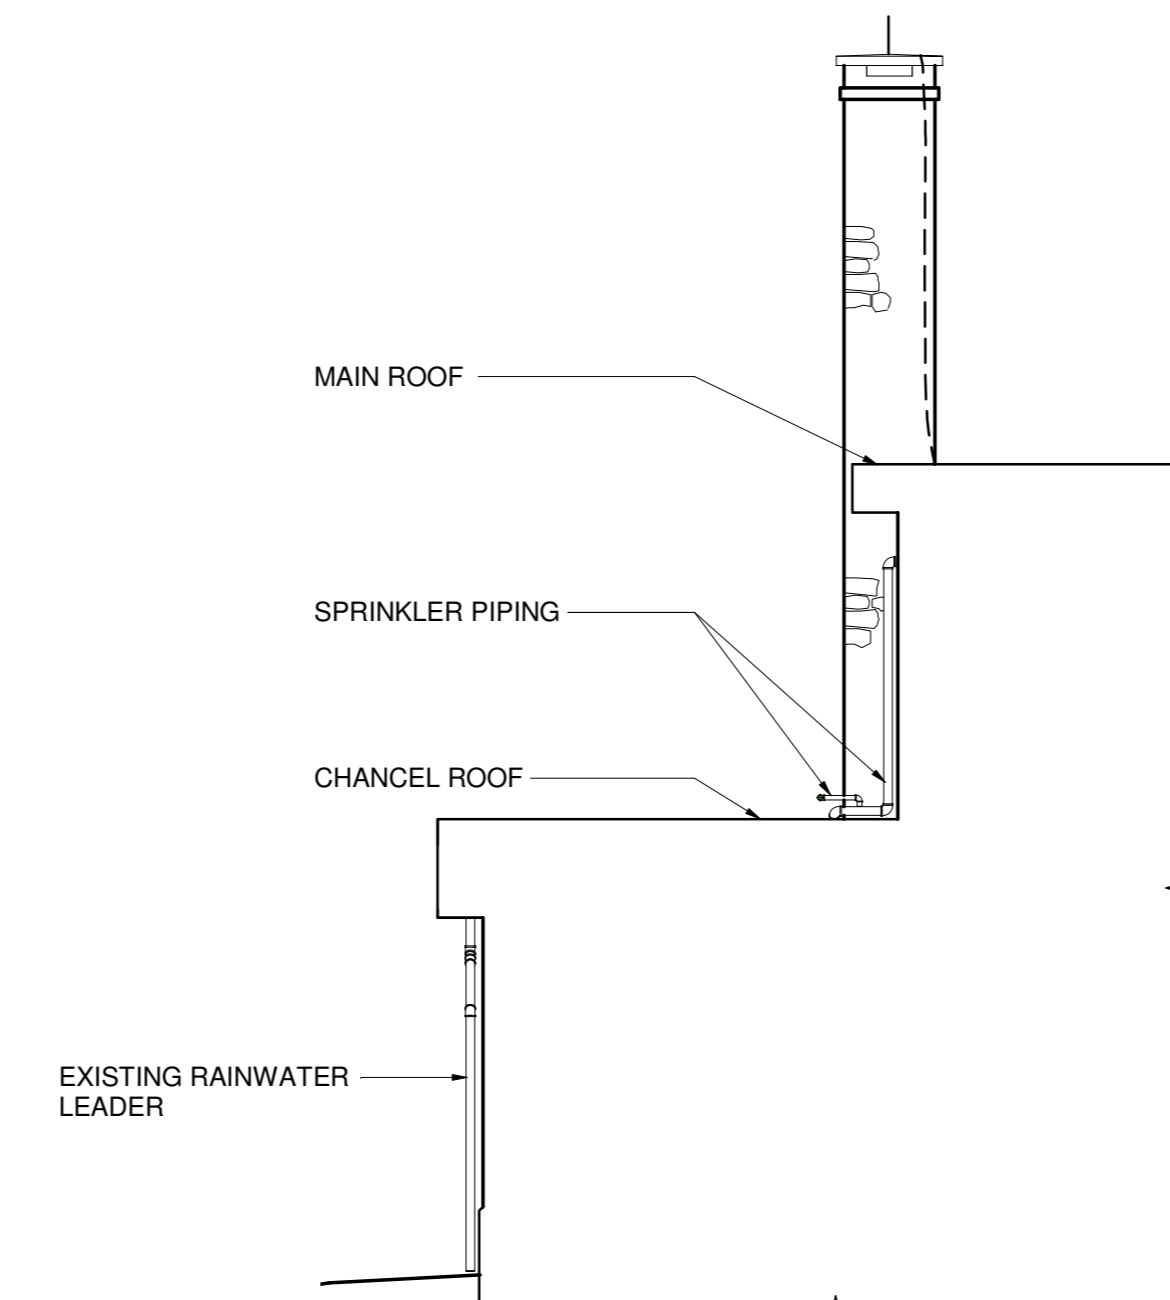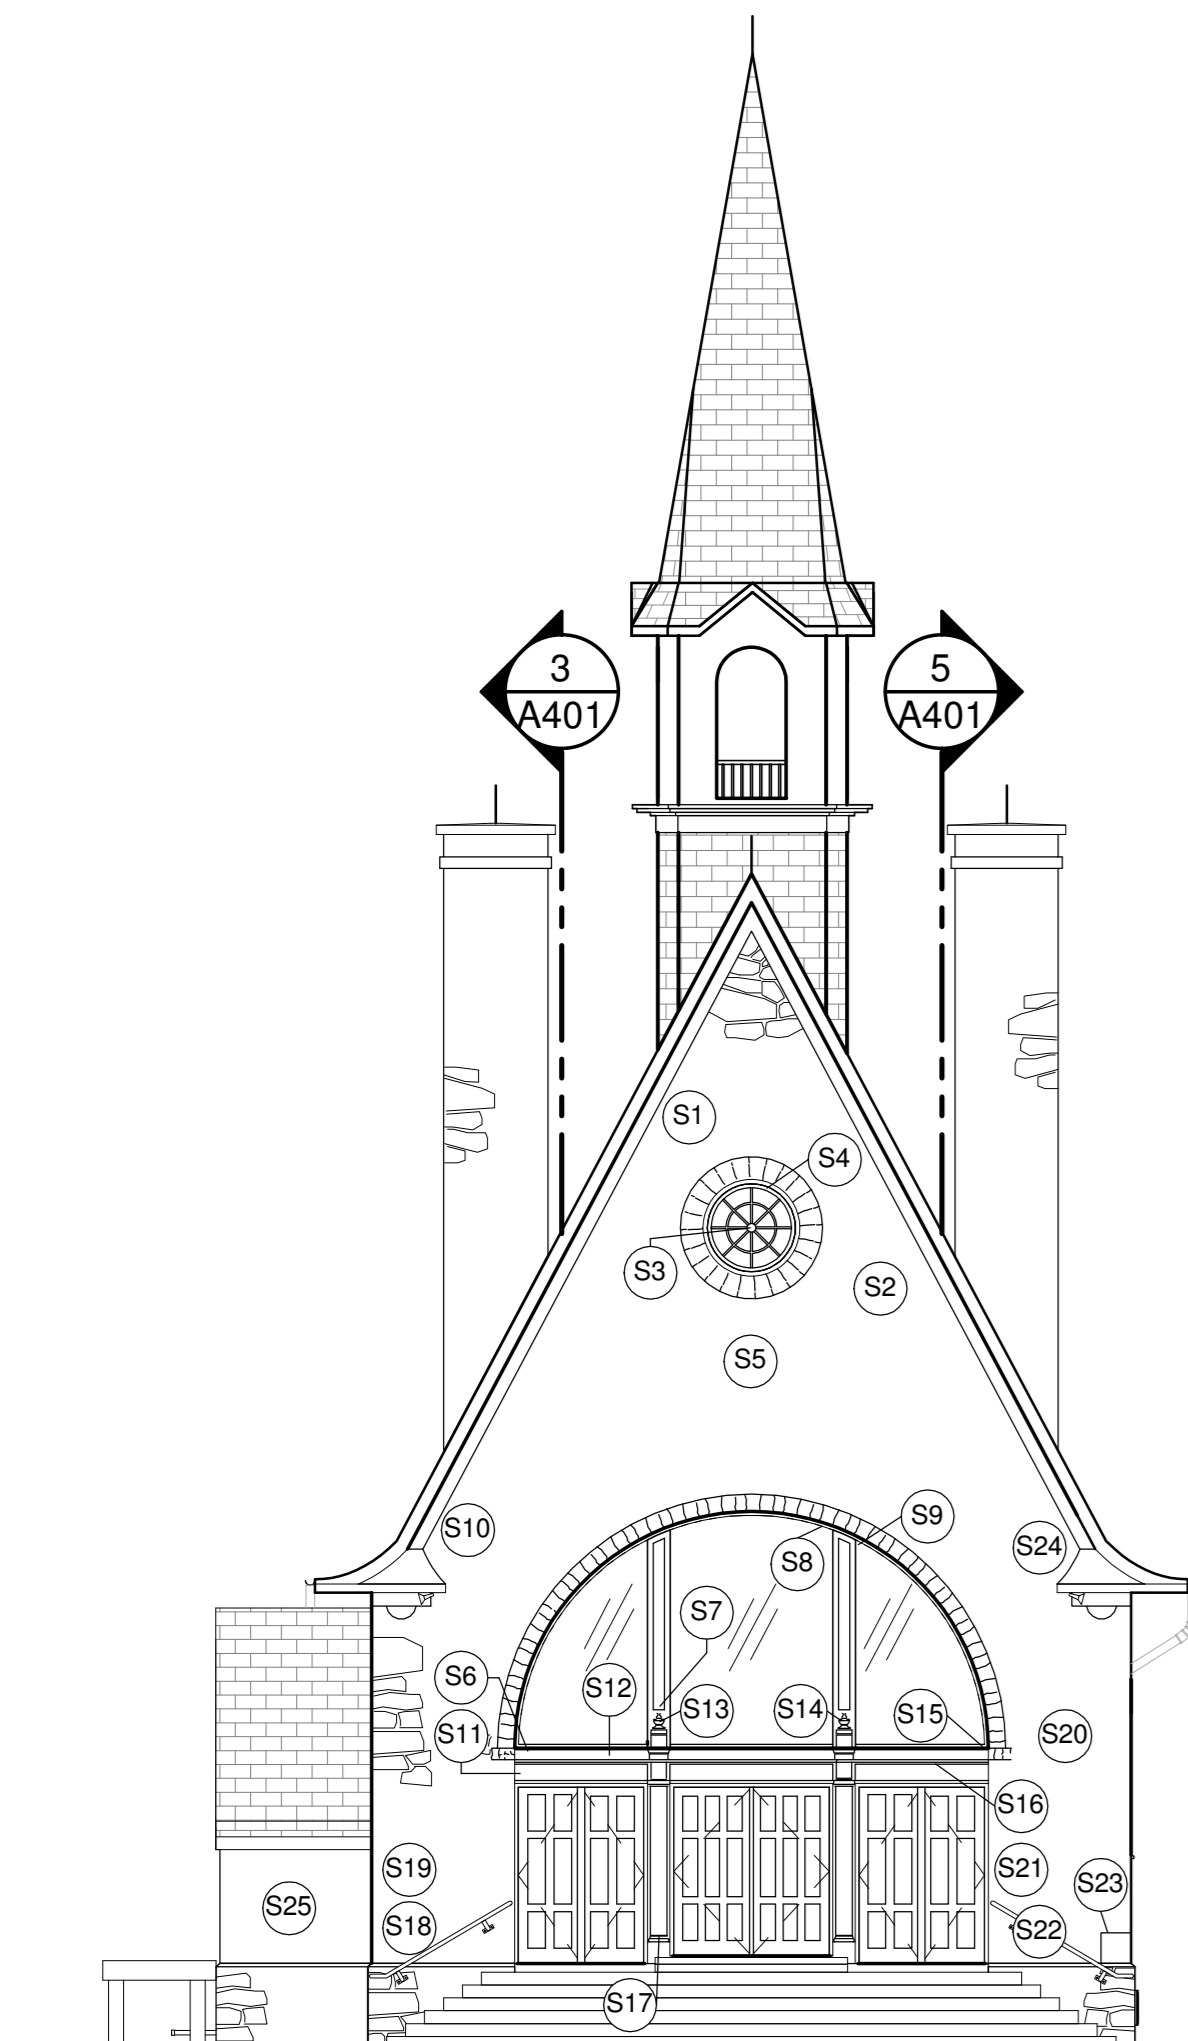

4
A401
1:100
EXISTING SOUTH (FRONT) ELEVATION

5
A401
1:100
WEST ELEVATION OF EAST CHIMNEY

6
A401
1:100
EXISTING WEST ELEVATION

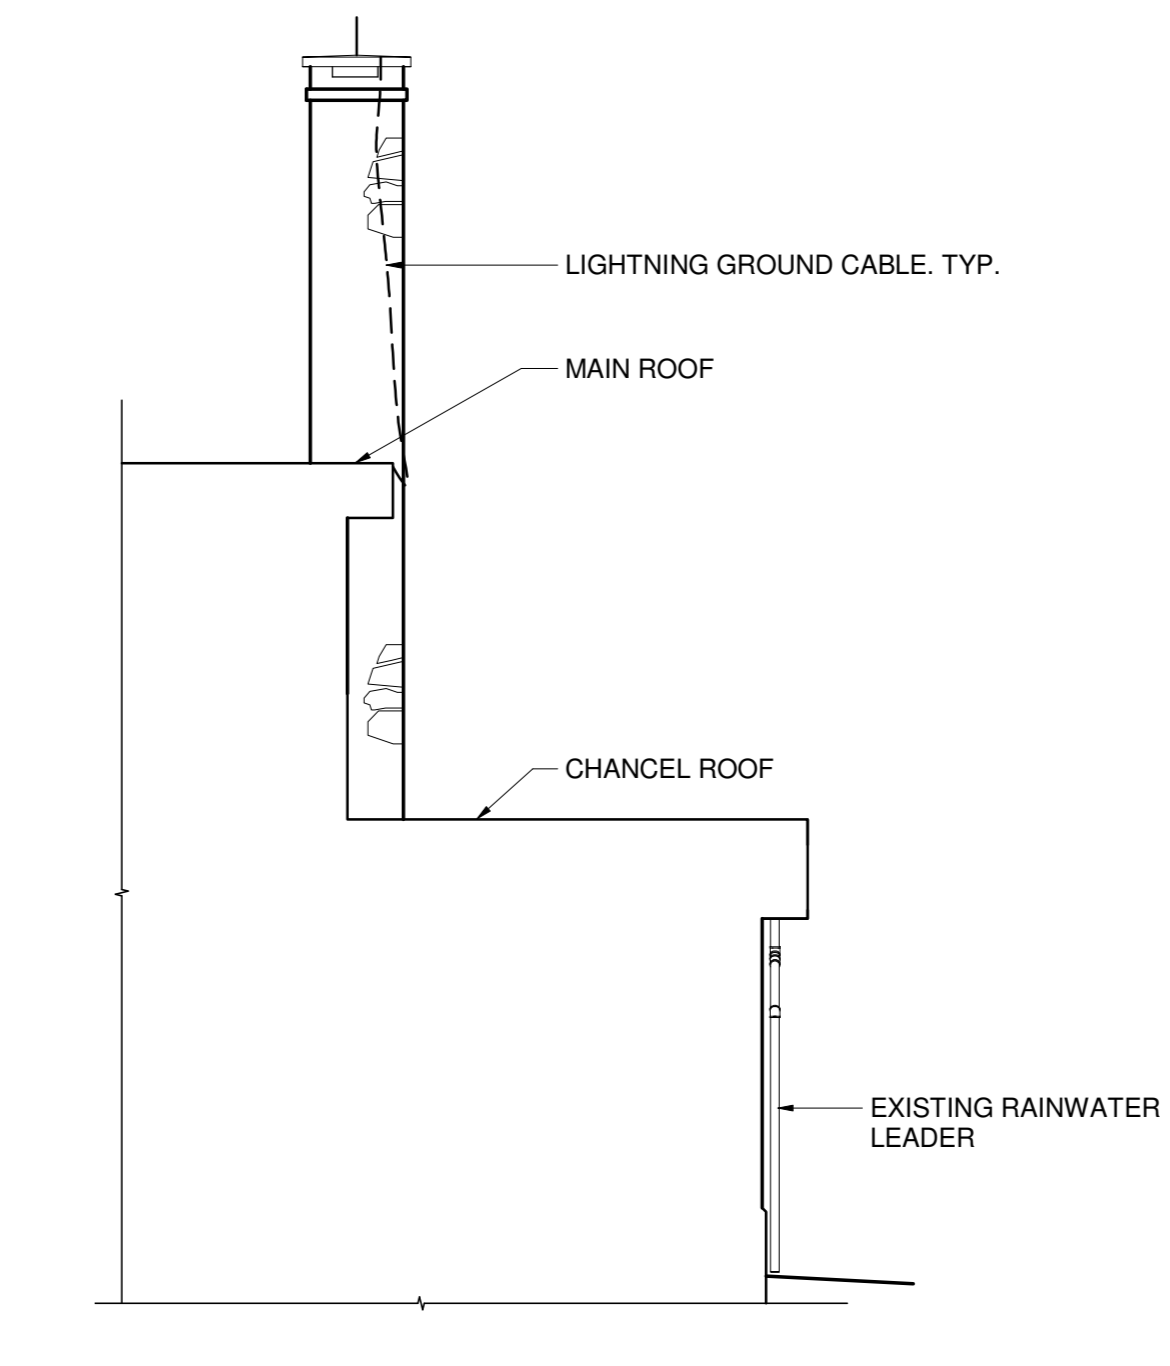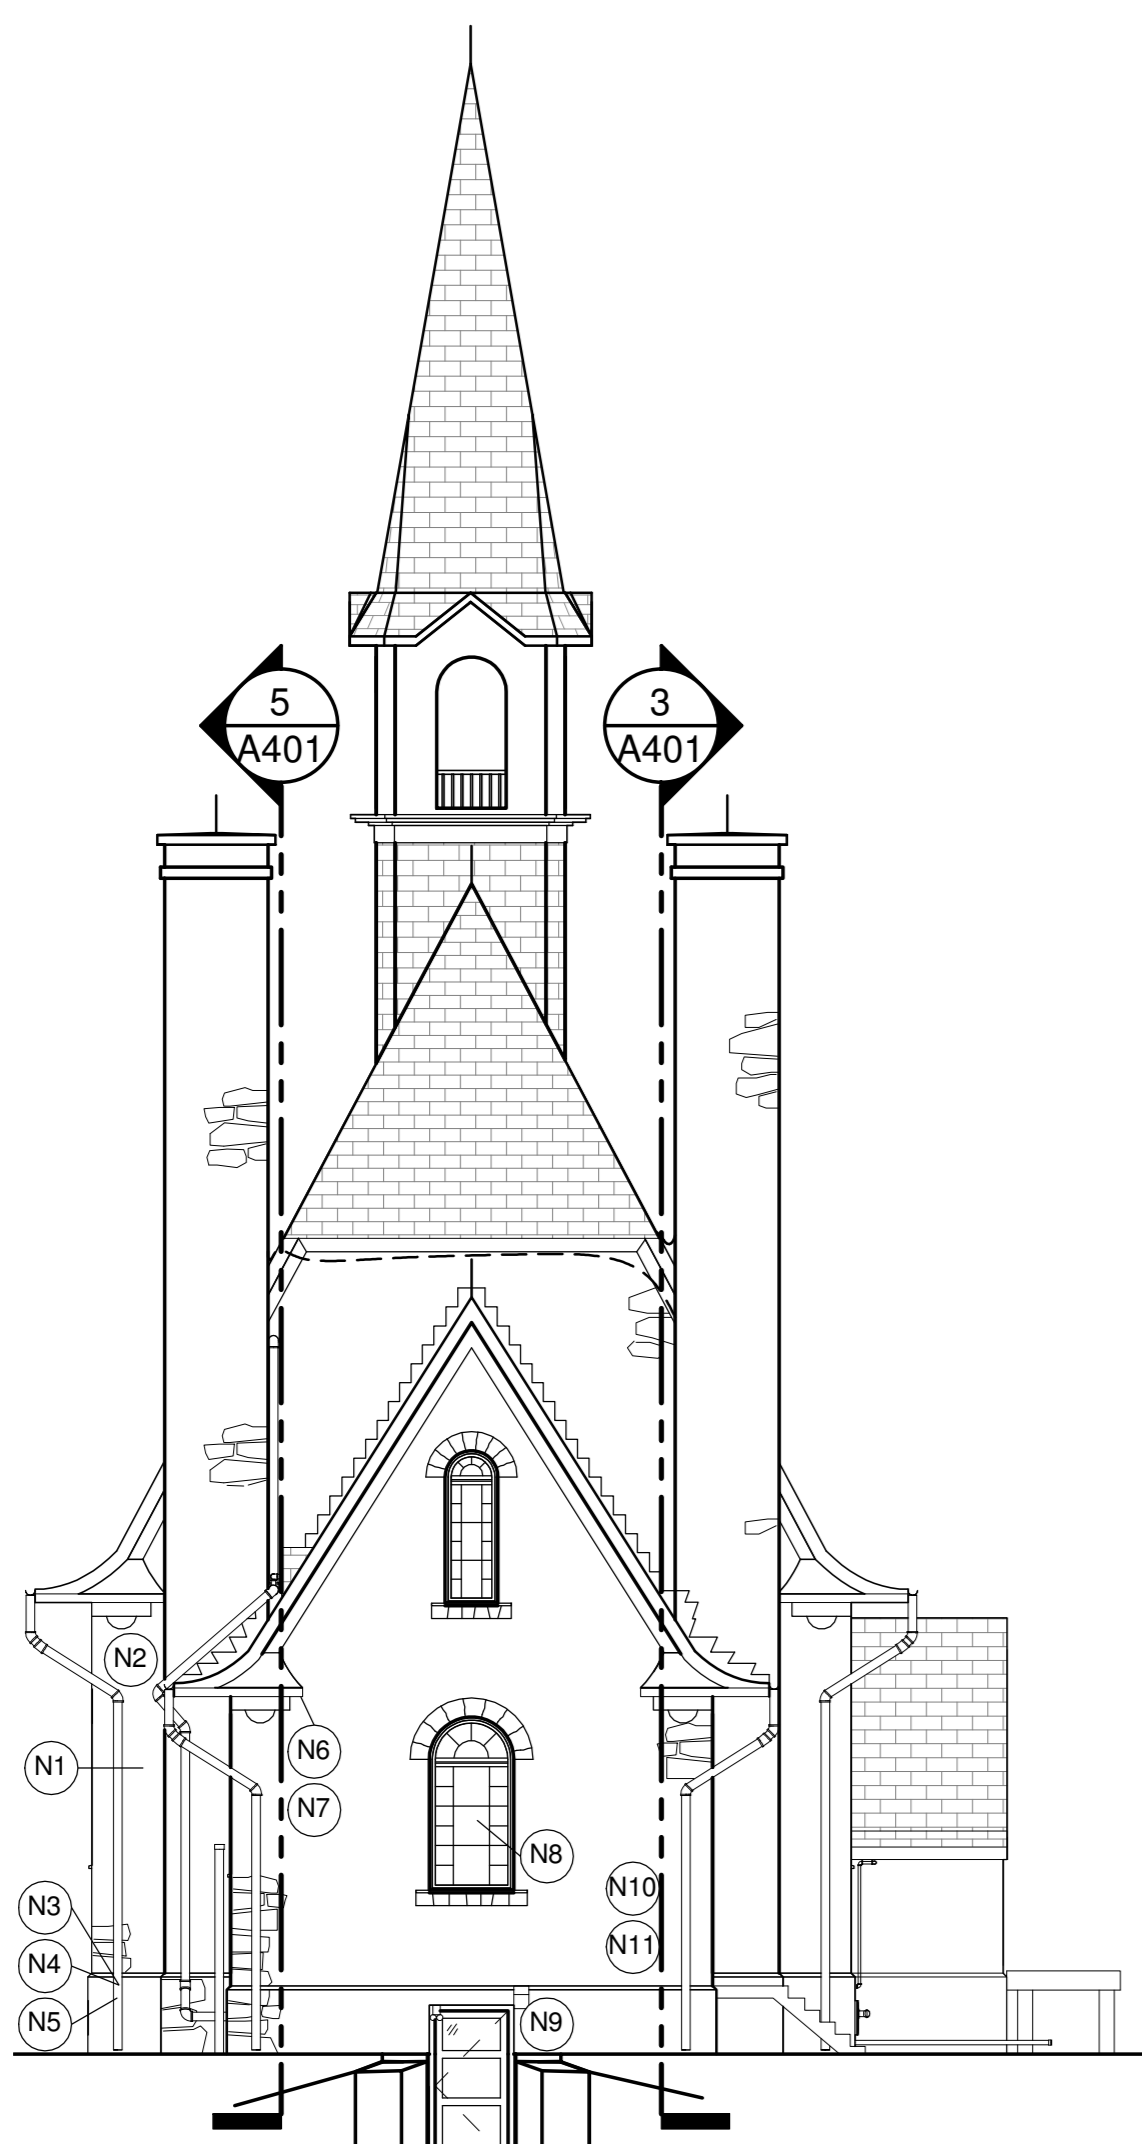


7
A401
1:100
EXISTING NORTH (REAR) ELEVATION

8
A401
1:100
EXISTING EAST ELEVATION

3
A401
1:100
EAST ELEVATION OF WEST CHIMNEY

SCALE : 1:100
0m 1m 2m 3m 4m 5m 6m 7m 8m 9m 10m

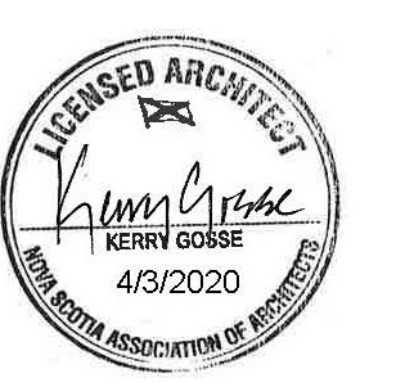


1	ISSUED FOR TENDER	03 APRIL 2020
revisions	Author	date

project
**GRAND-PRÉ NATIONAL HISTORIC SITE
 MEMORIAL CHURCH
 AND MONUMENTS
 REPOINTING**

drawing
**EXISTING PLANS AND
 ELEVATIONS**

designed Designer
 date 07/08/19
 drawn Author
 date 07/08/19
 approved Approver
 date 07/08/19
 Tender
 PWGSC Project Manager Administrateur de projets TPSGC
 project number
1241

drawing no.
A401
 no. du dessin

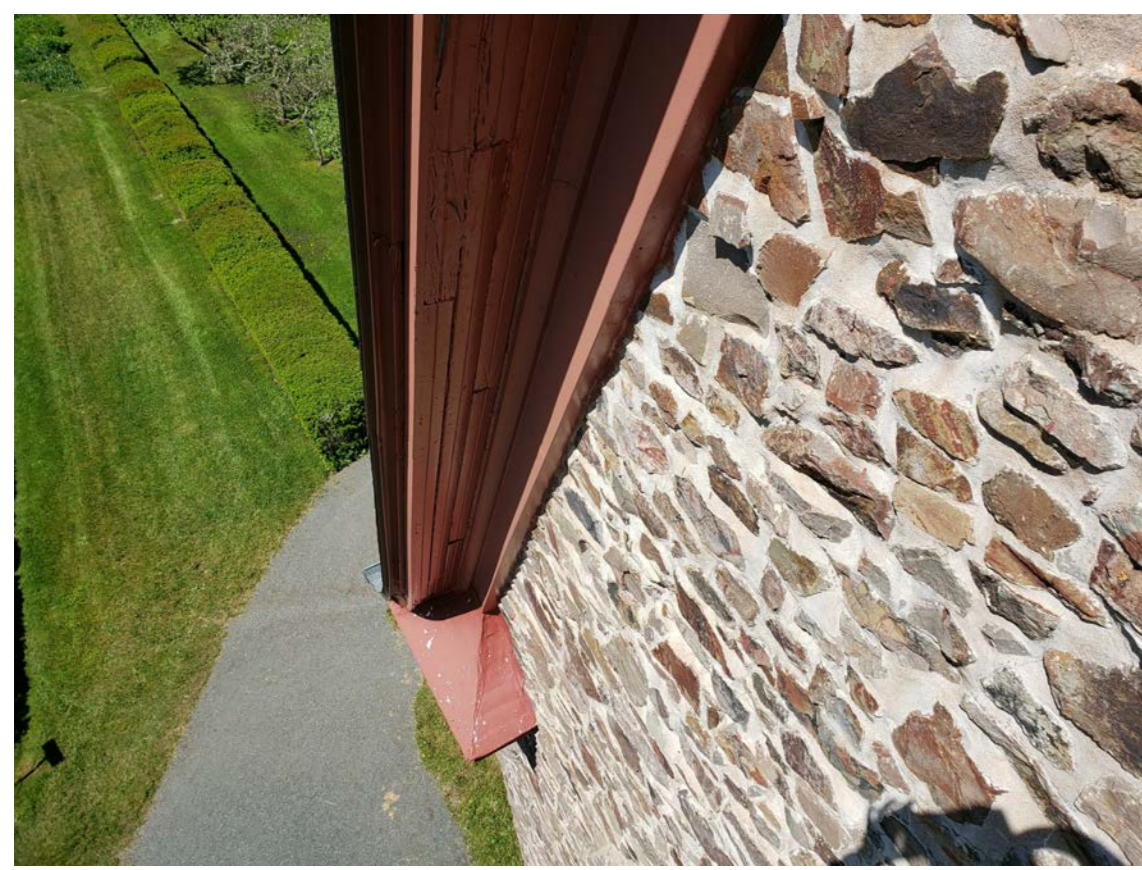

S1 ROTTEN WOOD SOFFIT




S2 PEELING PAINT, ROTTEN AND WEATHERED WOOD ON LUNETTE WINDOW, SOFFIT AND RAKE RETURN. LUNETTE WINDOW INSTALLED BACKWARDS



S3 PEELING PAINT, ROTTEN AND WEATHERED WOOD ON LUNETTE WINDOW SASH



S4 PEELING PAINT, ROTTEN AND WEATHERED ON LUNETTE WINDOW FRAME

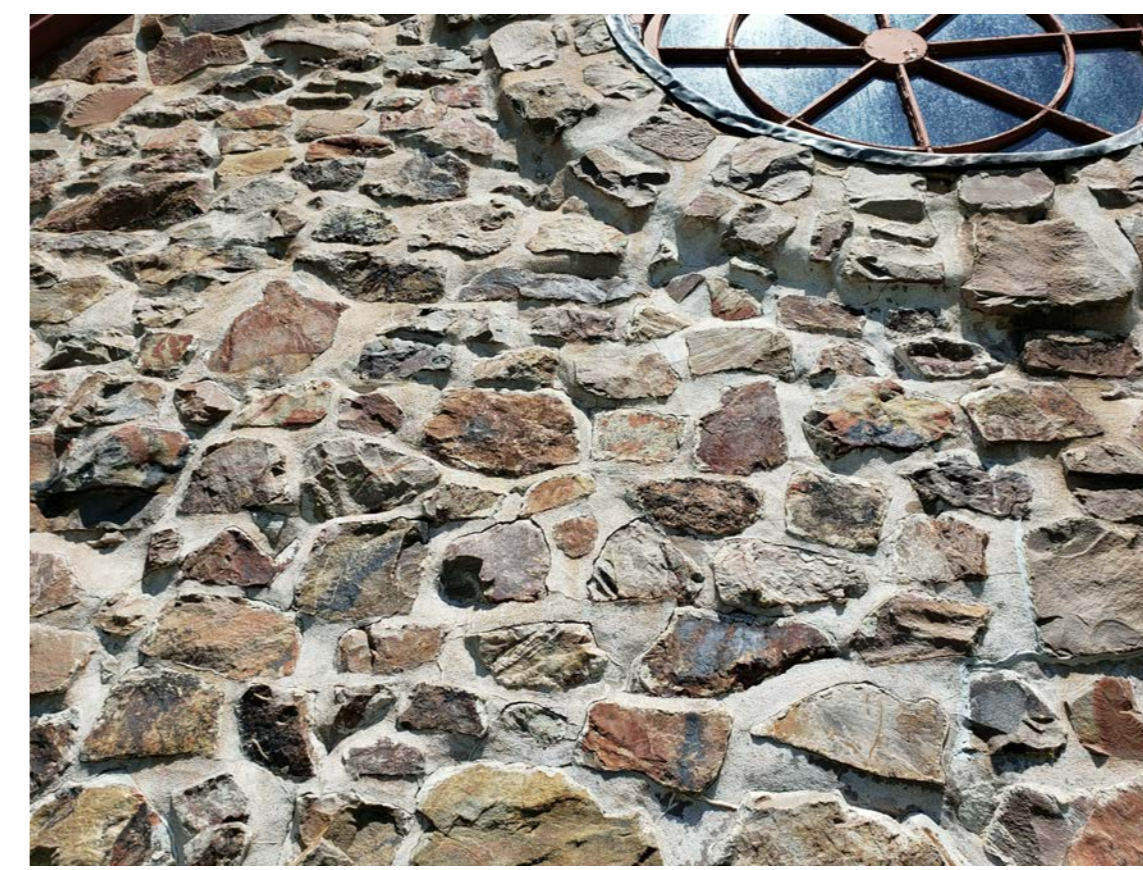

S5 CRACKED MORTAR, OPEN JOINTS AND PREVIOUS MORTAR REPAIRS



S6 PREVIOUS PATCH REPAIR OF CONCRETE BLOCK ARCH



S7 MINOR DAMAGE TO LEDGE OF CAST IRON PILASTER



S8 DETERIORATION OF CONCRETE BLOCK ARCH INCLUDING EFFLORESCENCE, WEATHERING AND OPEN JOINTS



S9 DETERIORATION OF CONCRETE BLOCK ARCH INCLUDING EFFLORESCENCE, WEATHERING AND OPEN JOINTS



S10 PEELING PAINT ON RAKE RETURN, ROTTED WOOD SOFFIT



S11 PEELING PAINT, ROTTEN AND WEATHERED WOOD ON WINDOW FRAME, FAILED CAULKING



S12 PEELING PAINT, ROTTEN AND WEATHERED WOOD ON WINDOW FRAME, FAILED CAULKING



S13 PEELING PAINT, ROTTEN AND WEATHERED WOOD ADJACENT CAST IRON PILASTER



S14 PEELING PAINT, AND MISSING FASTENERS ON LEAD FLASHING AT PILASTER



S15 PEELING PAINT, ROTTEN AND WEATHERED WOOD, PEELING PAINT ON CAP FLASHING



S16 WOOD AND FLASHING DETACHMENT



S17 PEELING PAINT, ROTTEN AND WEATHERED WOOD ON DOOR FRAMES



S18 PANEL TO SOUTHWEST OF DOORS



S19 PANEL TO SOUTHWEST OF DOOR HAS CRACKED MORTAR, OPEN JOINTS AND PREVIOUS MORTAR REPAIRS



S20 PANEL TO SOUTHWEST OF DOORS




S21 PANEL TO SOUTHWEST OF DOOR HAS CRACKED MORTAR AND EFFLORESCENCE IN JAMB



S22 PANEL TO SOUTHWEST OF DOOR HAS CRACKED MORTAR, OPEN JOINTS AND PREVIOUS MORTAR REPAIRS




S23 SANDSTONE CORNER STONE IS CHIPPED AND EXFOLIATING

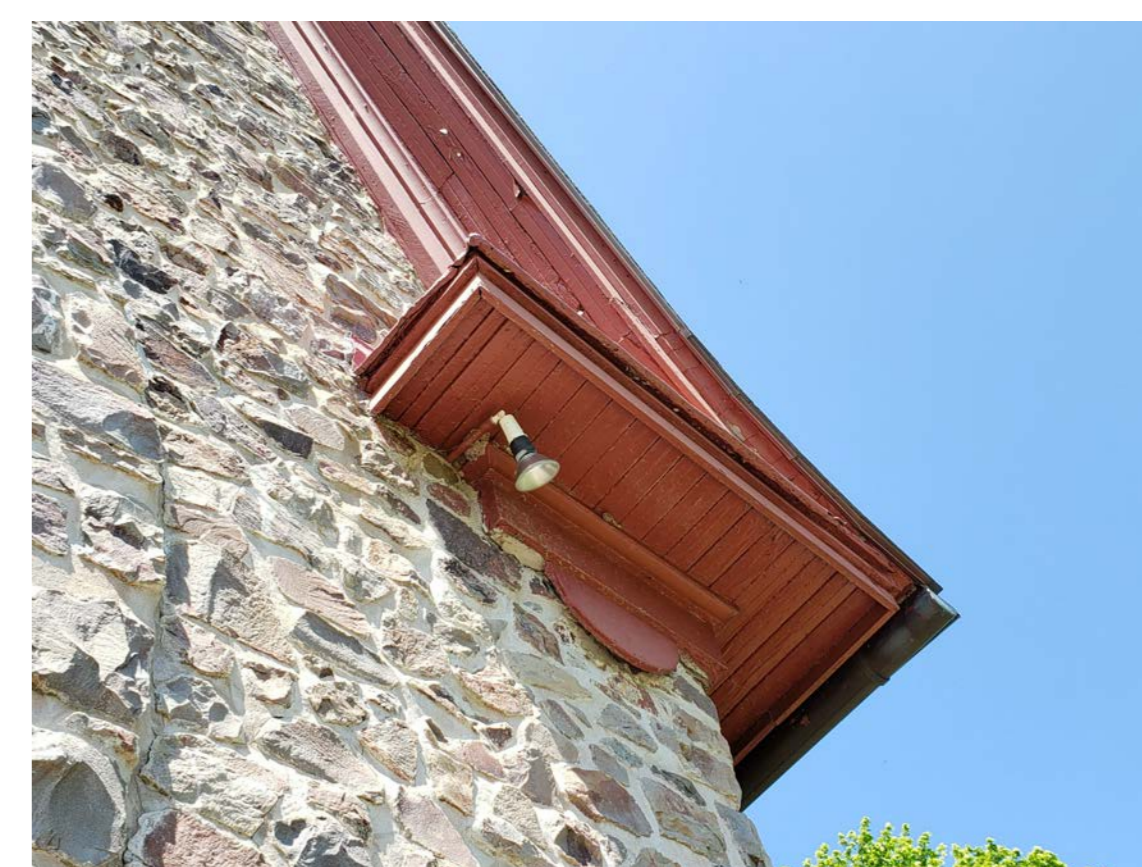

S24 CRACK AT OUTSIDE EDGE OF ARCH. GAP BEHIND WOOD MEDALLION, PEELING PAINT, ROTTEN AND WEATHERED WOOD ON SOFFIT



S25 SOUTH ELEVATION OF SOUTHWEST PORCH

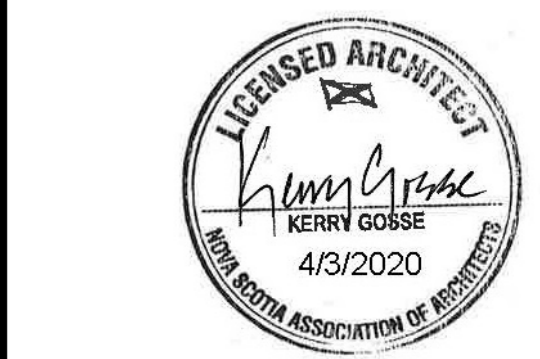

1	ISSUED FOR TENDER	02 APRIL 2020
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project

**GRAND-PRÉ NATIONAL HISTORIC SITE
MEMORIAL CHURCH AND MONUMENTS
REPOINTING**

drawing
SOUTH ELEVATION - PHOTOS

designed Designer
date 06/20/19
drawn LL
date 06/20/19
approved Approver
date 06/20/19

Tender
PWGSC Project Manager Administrateur de projets TPSCG
project number
1241
drawing no.
A402



W1 MORTAR IN GOOD CONDITION BELOW NORTHWEST CONCRETE STAIR




W2 PREVIOUS CONCRETE REPAIR AND ORGANIC GROWTH ON CONCRETE STAIR AND SILL



W3 CRACKED MORTAR AND OPEN JOINTS AT CORNERS, VARIOUS MATERIALS AND COLOURS ON DOWNSPOUT



W4 EFFLORESCENCE ON BACKSIDE OF CHIMNEY, SATURATES MORTAR AND STONE AT END OF GUTTER, WATER DAMAGE AND ORGANIC GROWTH BELOW, PEELING PAINT ON FAKE RETURN FLASHING, GAP BEHIND WOOD MEDALLION

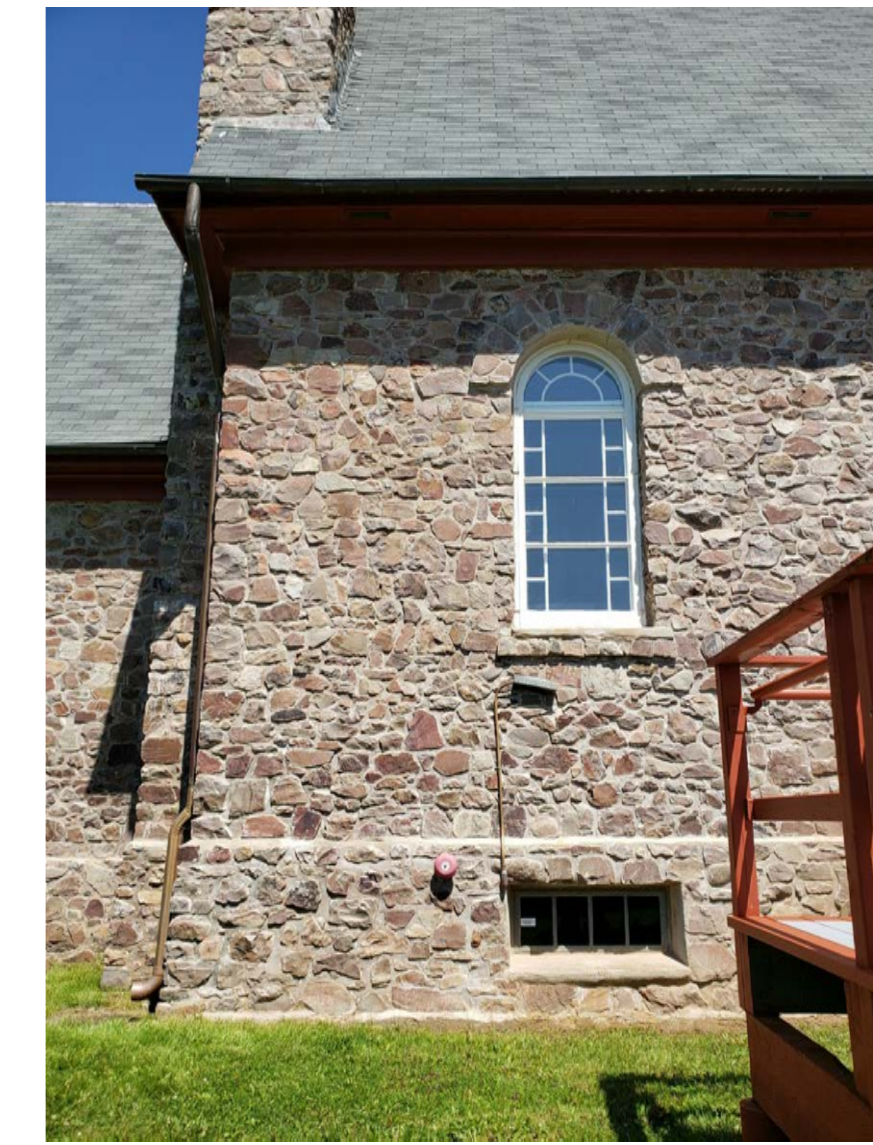


W5 CRACKING AND OPEN JOINTS AT CORNER, MORTAR CAP ON PLINTH DAMAGED



W6 MORTAR DAMAGE AT HEAD OF ROUGH OPENING, ORGANIC GROWTH ON CONCRETE SILL, ALUMINUM FRAME WINDOW STAINED



W7 CRACKED MORTAR, OPEN JOINTS, ORGANIC GROWTH AND PREVIOUS MORTAR REPAIRS AT CORNER OF SOUTHWEST PORCH

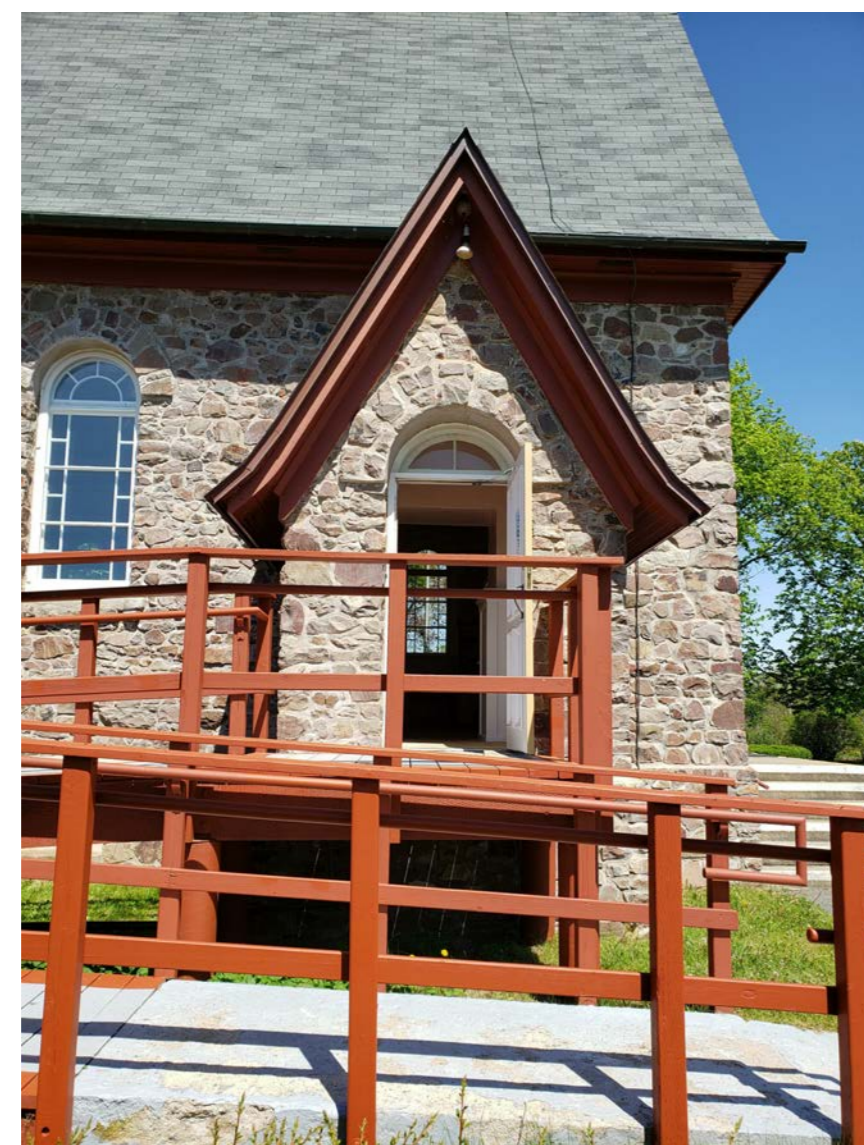

W8 SOUTHWEST PORCH



W9 CRACKED MORTAR, OPEN JOINTS, ORGANIC GROWTH AND PREVIOUS MORTAR REPAIRS BELOW LANDING AT SOUTHWEST PORCH



W10 LOSS OF BINDER FROM MORTAR AND MISSING STONE LANDING AT SOUTHWEST PORCH



W11 SAND (LOSS OF BINDER) FROM MORTAR JOINT BELOW LANDING AT SOUTHWEST PORCH



W12 SAND (LOSS OF BINDER) FROM MORTAR JOINT BELOW LANDING AT SOUTHWEST PORCH



W13 PEELING PAINT, ROTTEN AND WEATHERED WOOD ON SOUTHWEST PORCH SOFFIT AND FASCIA




W14 STAINING ON ROOF SHINGLES, LEAKING COPPER GUTTER



W15 CRACKING AND OPEN JOINTS AT CORNER, CRACKED MORTAR AT JOINT BELOW PROFILED FRIEZE



N1 EFFLORESCENCE ON BACKSIDE OF CHIMNEY, PEELING PAINT ON RAKE RETURN FLASHING

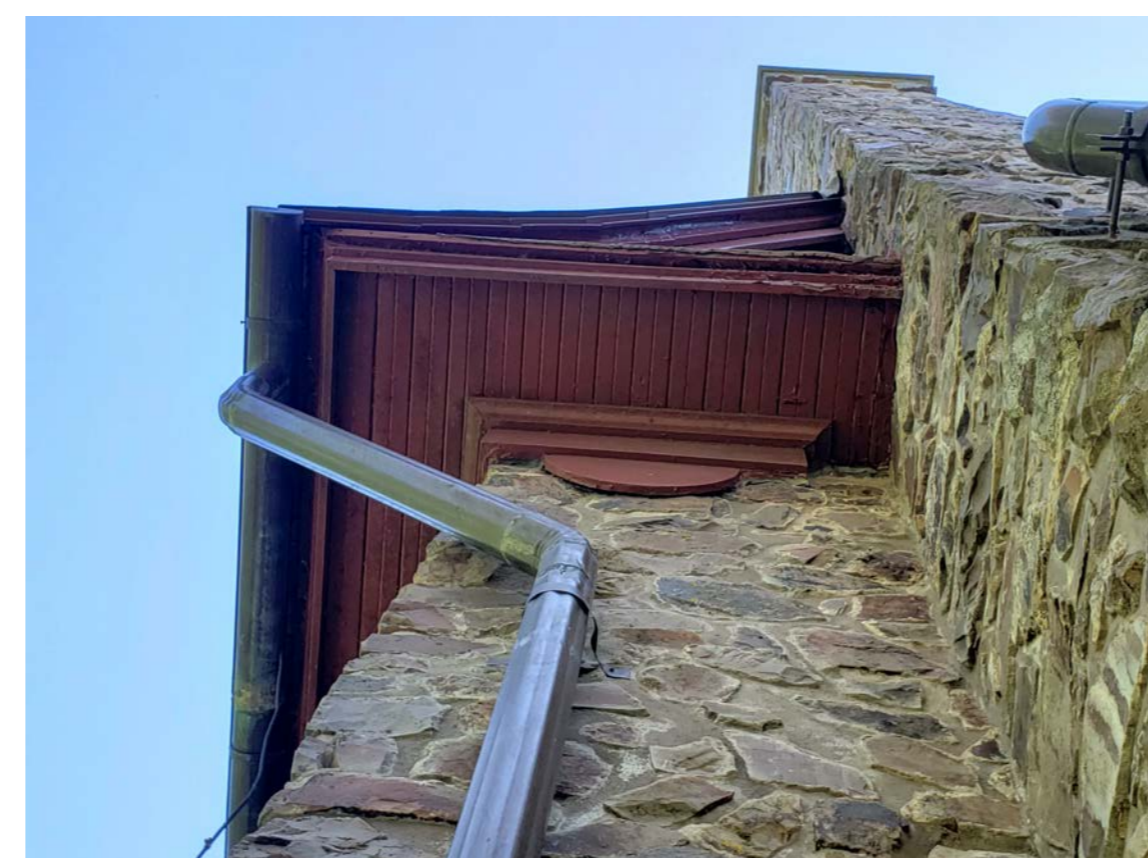


N2 GAP BEHIND WOOD MEDALLION, ROTTEN WOOD ADJACENT CHIMNEY, LEAKING COPPER GUTTER, DETACHED RAINWATER LEADER STRAP



N3 DAMAGED AND CORRODED COPPER RAINWATER LEADER, MAKESHIFT REPAIR WITH ZIP TIES




N4 CORRODED COPPER RAINWATER LEADER, CORRODED MISCELLANEOUS FASTENERS

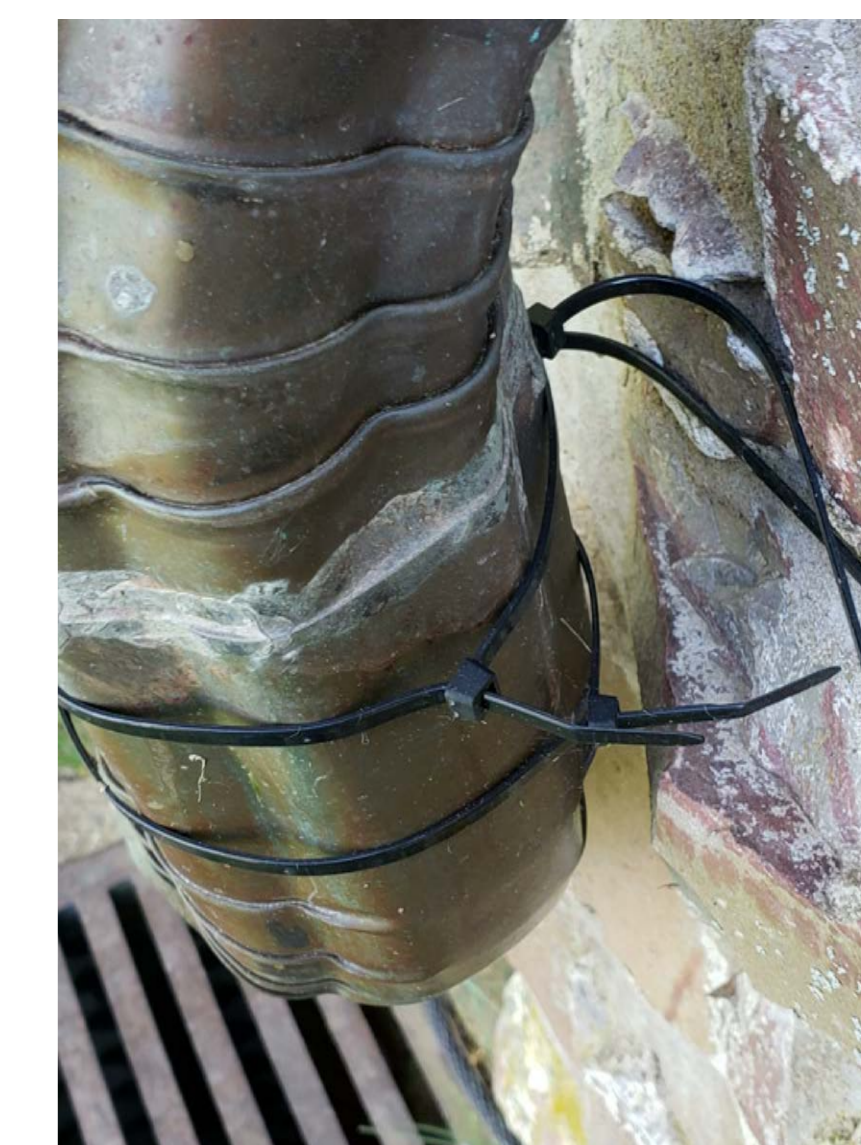

N5 MAKESHIFT REPAIR WITH ZIP TIES



N6 GAP BEHIND WOOD MEDALLION, ORGANIC GROWTH ON ROTTEN WOOD

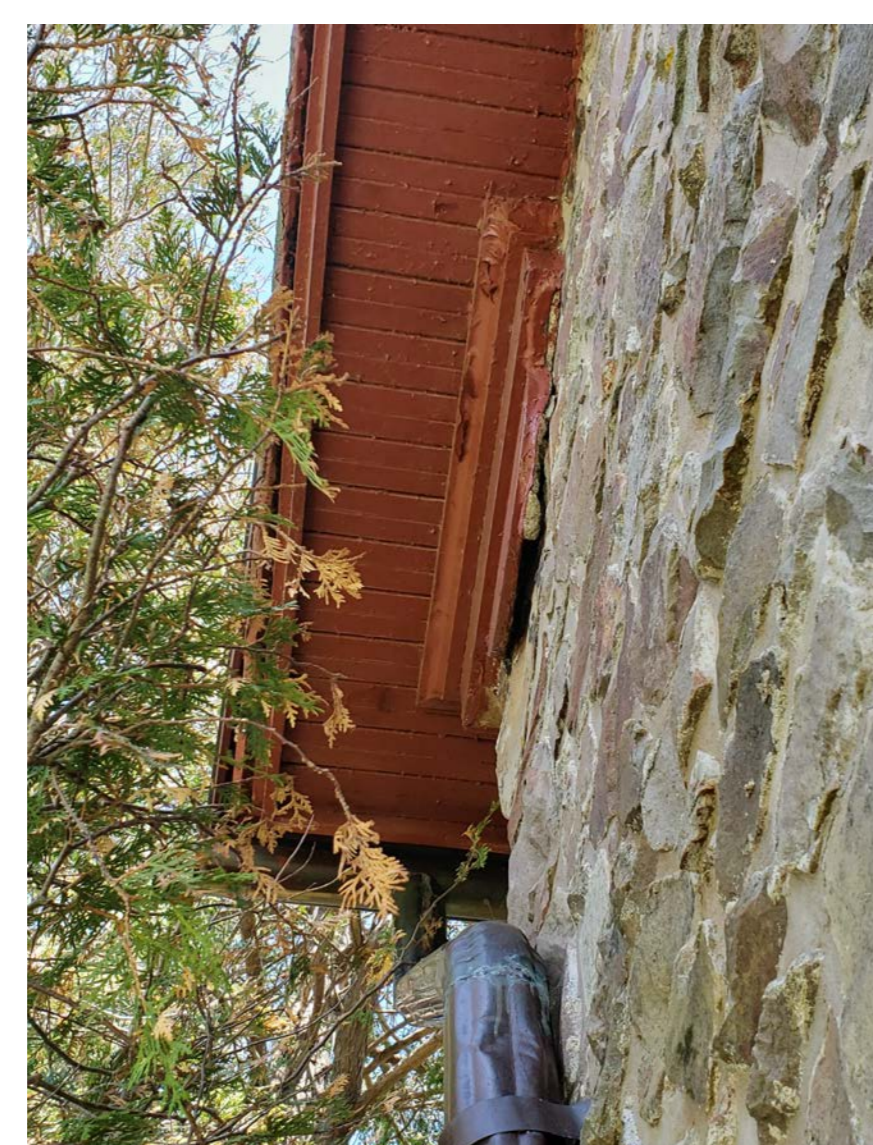

N7 GAP BEHIND WOOD MEDALLION



N8 PREVIOUS MORTAR REPAIRS AROUND WINDOW, CRACK AND PREVIOUS REPAIR AT HEAD OF ROUGH OPENING



N9 NORTH CHANCEL BASEMENT ENTRANCE, SATURATED BRICK AND MORTAR BELOW END OF WINDOWSILL, ORGANIC GROWTH ON PLINTH



N10 CRACKING AND OPEN JOINTS AT CORNER, ORGANIC GROWTH ON PLINTH




N11 ORGANIC GROWTH ON PLINTH, PREVIOUS MORTAR REPAIR, CRACKED MORTAR AND MISSING STONE AT BASE OF PLINTH




1	ISSUED FOR TENDER	02 APRIL 2020
revisions	Author	date

project
**GRAND-PRÉ NATIONAL HISTORIC SITE
 MEMORIAL CHURCH AND MONUMENTS REPOINTING**
 drawing
WEST & NORTH ELEVATION - PHOTOS


designed	Designer	conçu
date	06/20/19	
drawn	Author	dessiné
date	06/20/19	
approved	Approver	approuvé
date	06/20/19	
Tender	Submission	
PWGSC Project Manager	Administrateur de projets TPSGC	
project number	no. du projet	1241
drawing no.	no. du dessin	A403

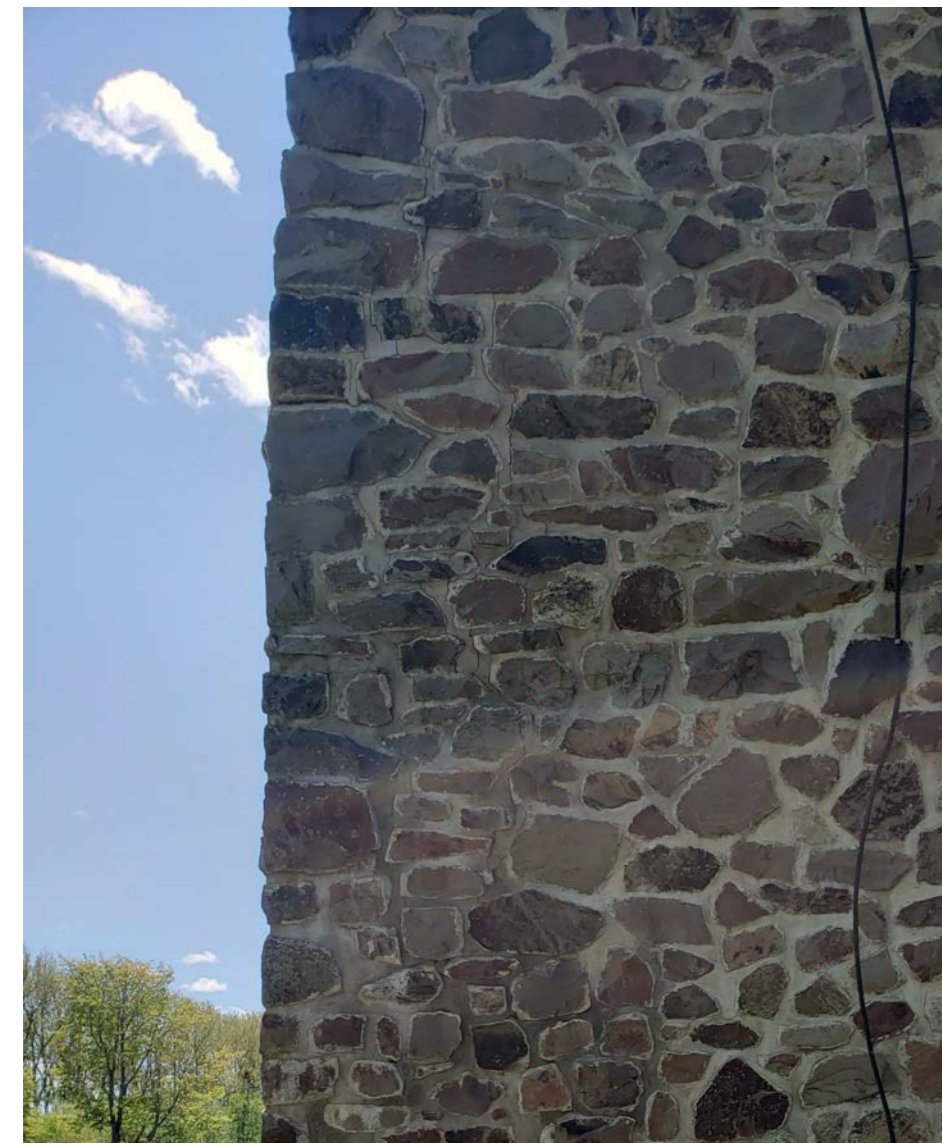


E1 CRACKED MORTAR, OPEN JOINTS AND PREVIOUS MORTAR REPAIRS AT SOUTHEAST CORNER OF NAVE

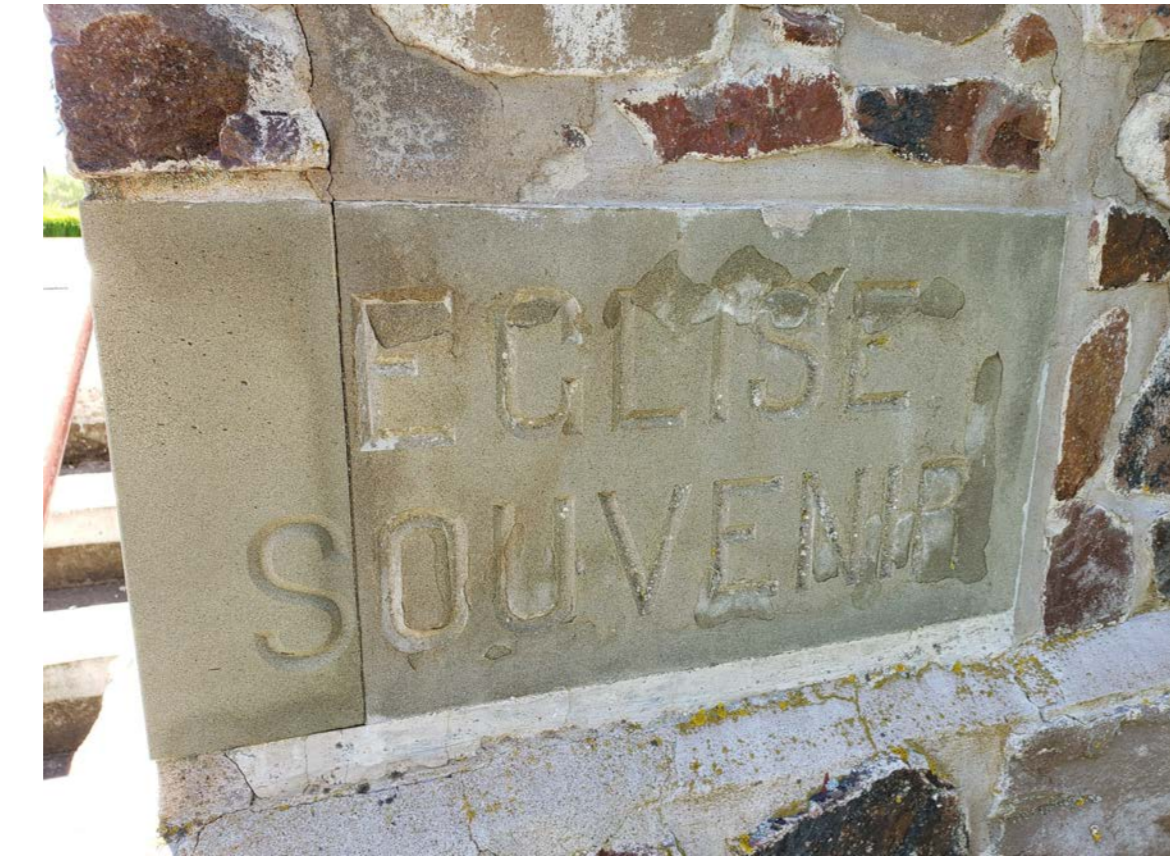


E2 SANDSTONE CORNER STONE IS CHIPPED AND EXFOLIATING, OPEN AND CRACKED MORTAR JOINTS, PREVIOUS MORTAR REPAIR

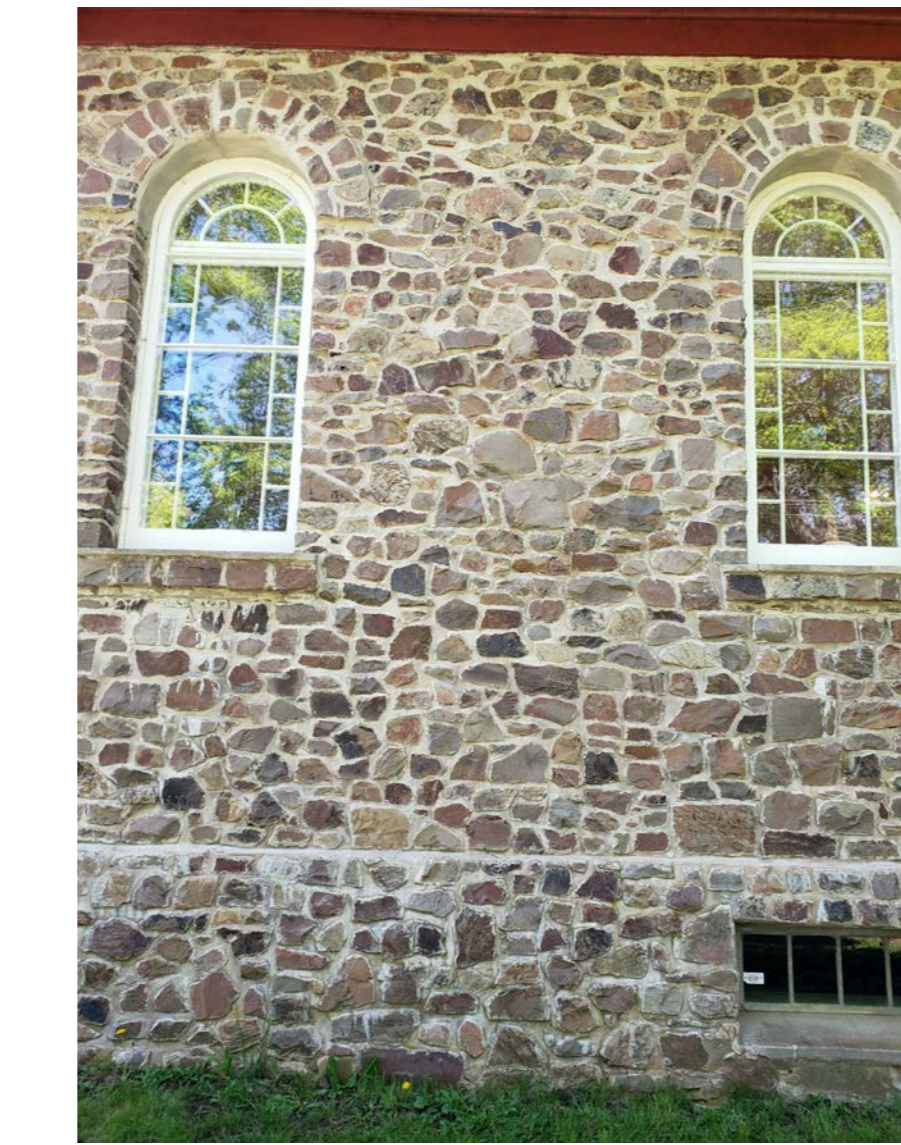


E3 EFFLORESCENCE, CRACKED MORTAR, OPEN JOINTS AND PREVIOUS MORTAR REPAIRS BELOW WINDOWS AND AT TOP OF PLINTH

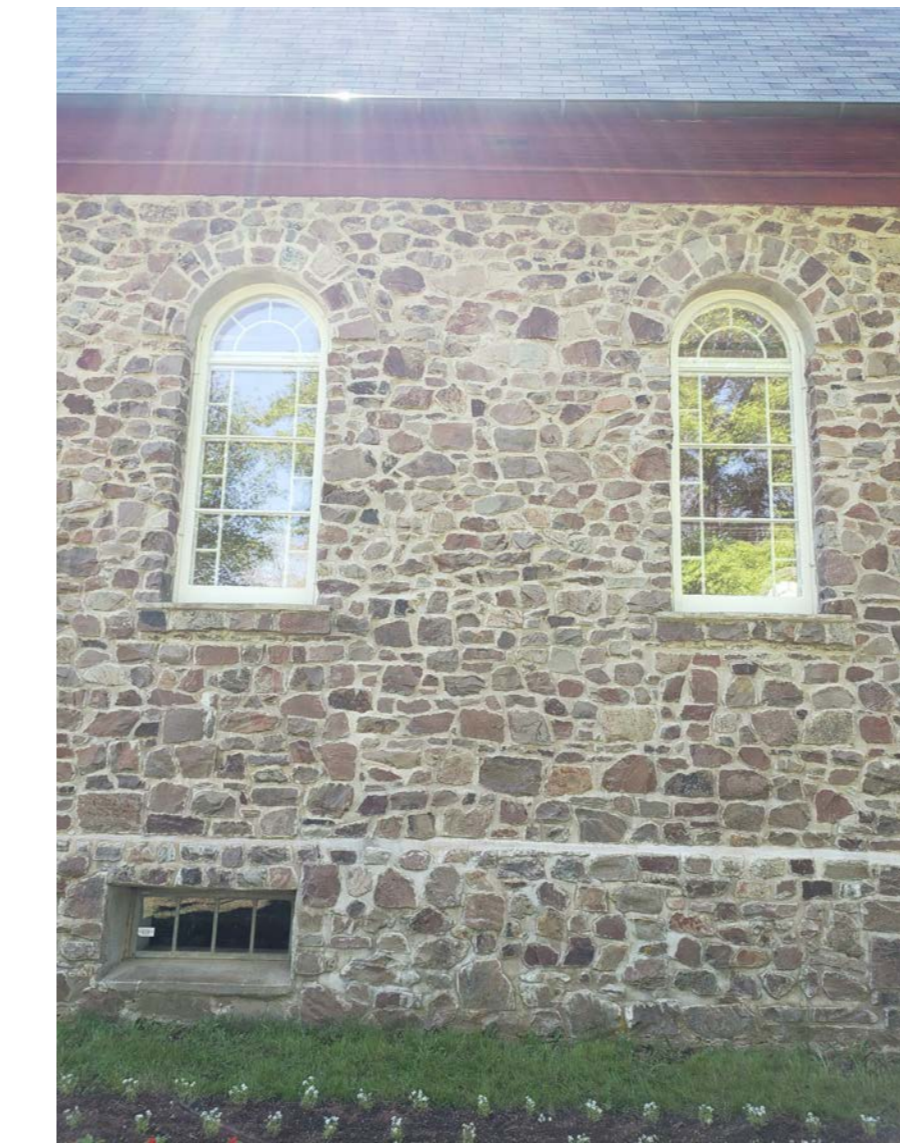


E4 BROKEN STONE AND CONCRETE WINDOWSILLS, CRACKED MORTAR, OPEN JOINTS AND PREVIOUS MORTAR REPAIRS BELOW WINDOWS, CRACKED MORTAR CANT AT TOP OF PLINTH

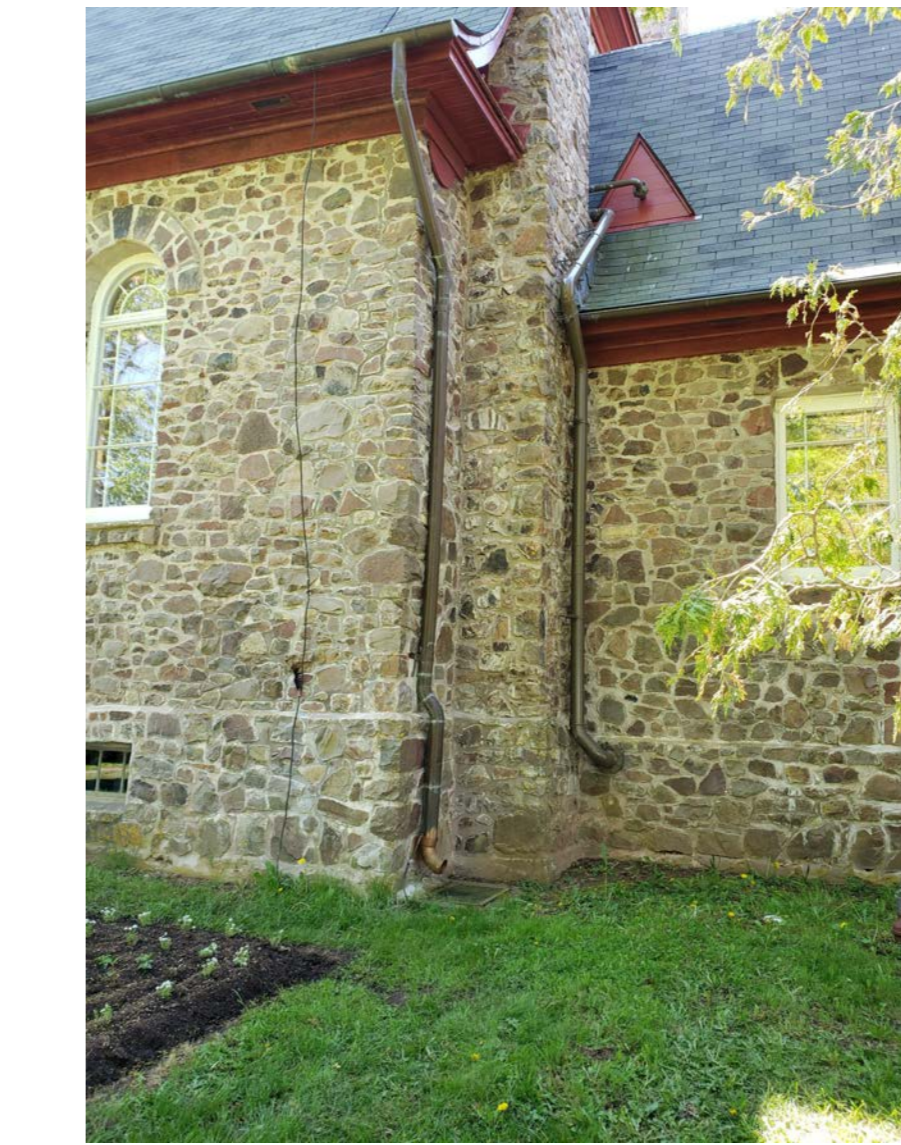

E5 CRACKED MORTAR, OPEN JOINTS AND PREVIOUS MORTAR REPAIRS AT NORTHEAST CORNER OF NAVE, ORGANIC GROWTH ON CHIMNEY

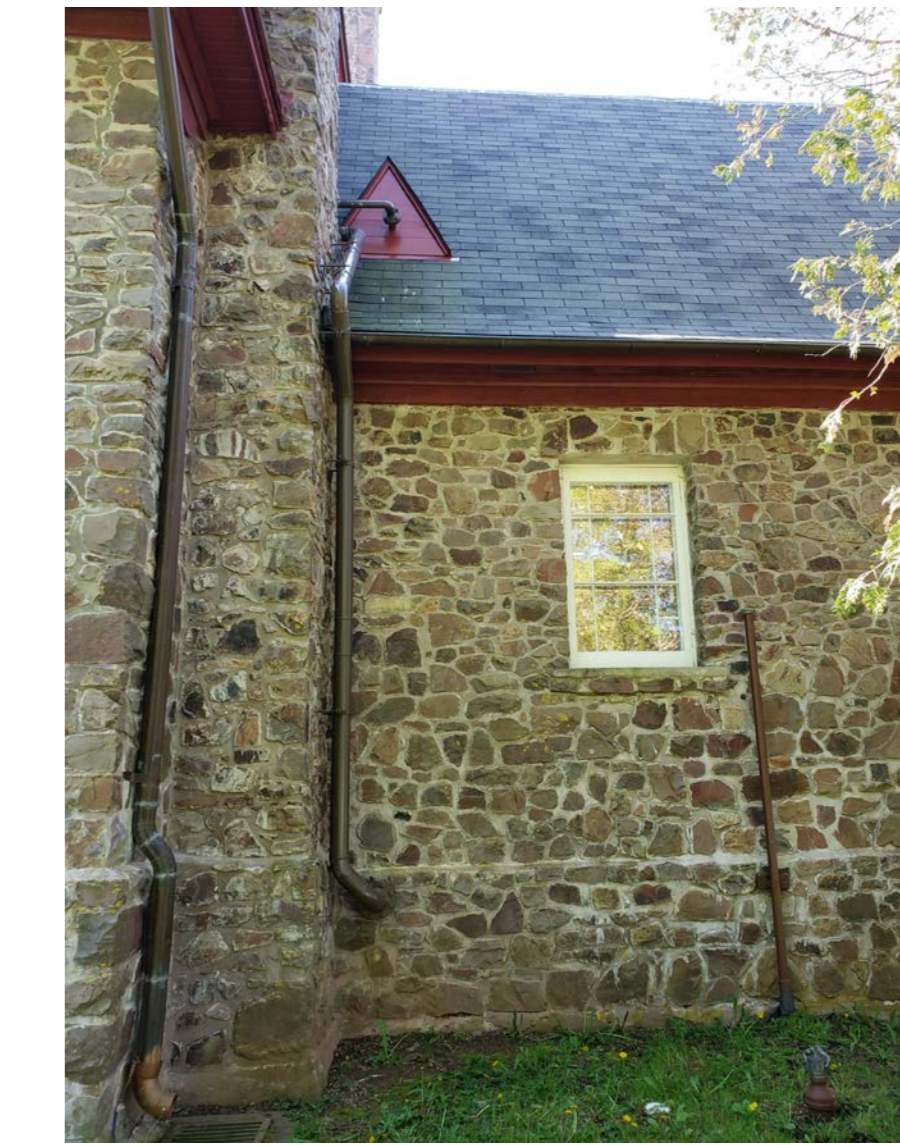

E6 CRACKED MORTAR, OPEN JOINTS EFFLORESCENCE AND PREVIOUS MORTAR REPAIRS BELOW WINDOW AND AT BASE OF PLINTH

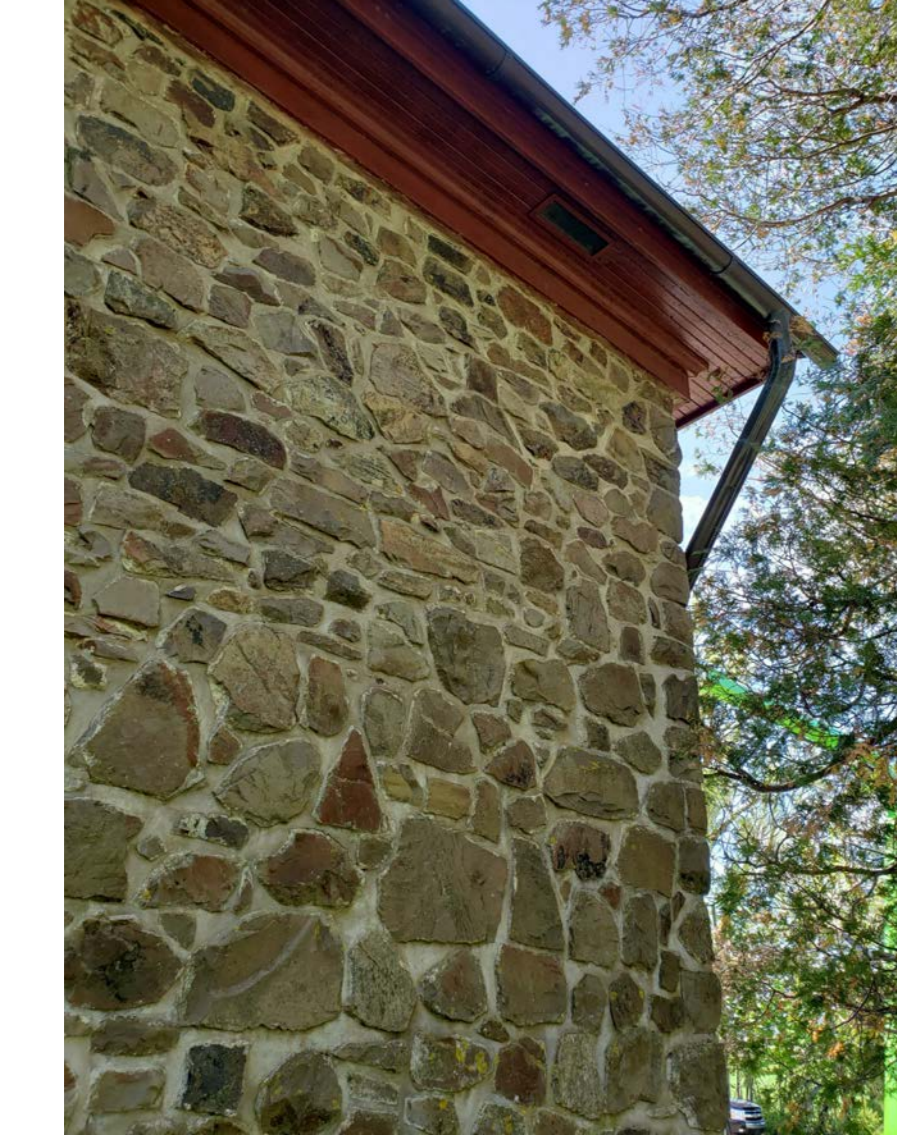

E7 CRACKED MORTAR, OPEN JOINTS EFFLORESCENCE AND PREVIOUS MORTAR REPAIRS AT NORTHEAST CORNER OF CHANCEL



E8 CRACKED MORTAR, EFFLORESCENCE, OPEN JOINTS AND ORGANIC GROWTH AT NORTHEAST CORNER OF CHANCEL



E9 CRACKED MORTAR, EFFLORESCENCE, AND OPEN JOINTS BEHIND OIL TANK VENT PIPE



E10 CRACKED MORTAR, EFFLORESCENCE, OPEN JOINTS AND ROTTEN WOOD BLOCKING BEHIND OIL TANK VENT PIPE



E11 POOR MORTAR REPAIR AT THROUGH WALL PENETRATION




RL1 4" DIAMETER COPPER RAINWATER LEADER



RL2 1 1/2" WIDE COPPER RAINWATER LEADER STRAP




RL3 3 1/2" LEG ON COPPER RAINWATER LEADER STRAP

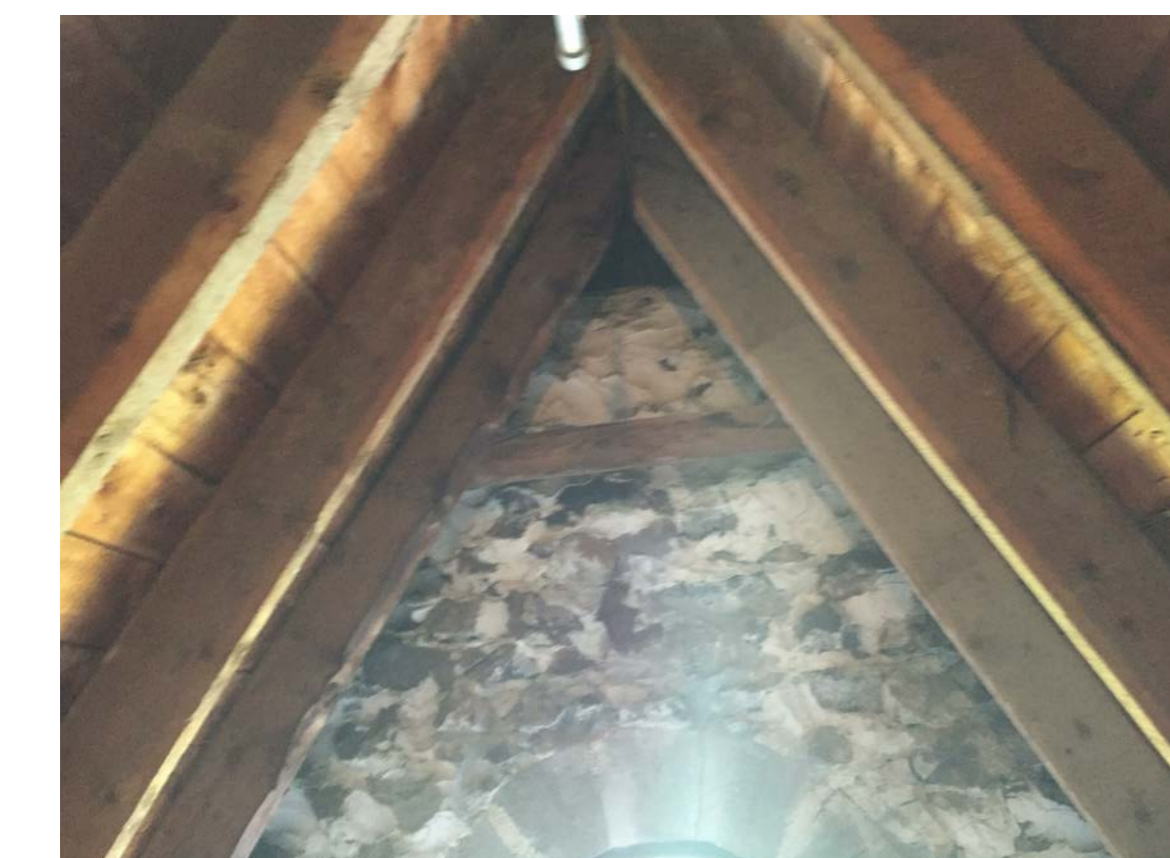


I1 INTERIOR FACE OF NORTH CHANCEL WALL



I2 INTERIOR PORTION OF NORTH NAVE WALL BELOW CHANCEL ROOF AND ACCESS TO ATTIC ABOVE NAVE

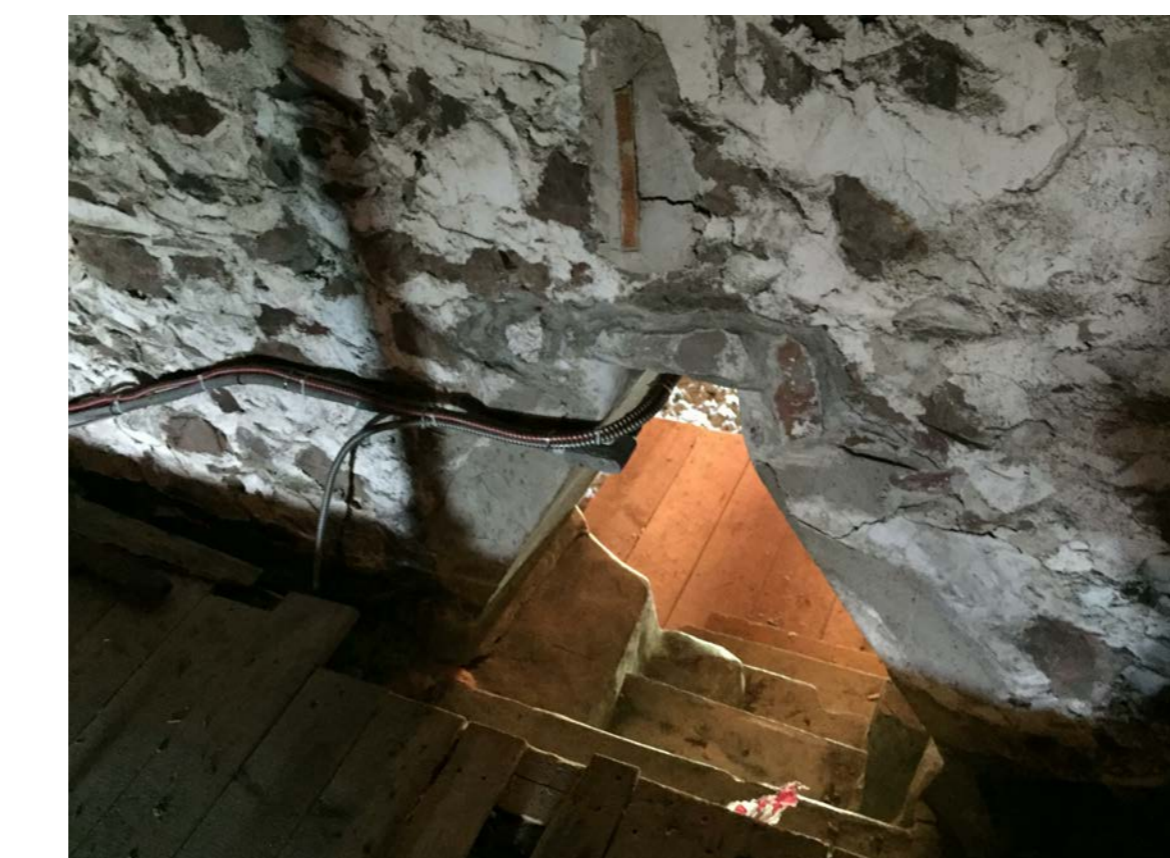

I3 INTERIOR FACE OF NORTH NAVE WALL

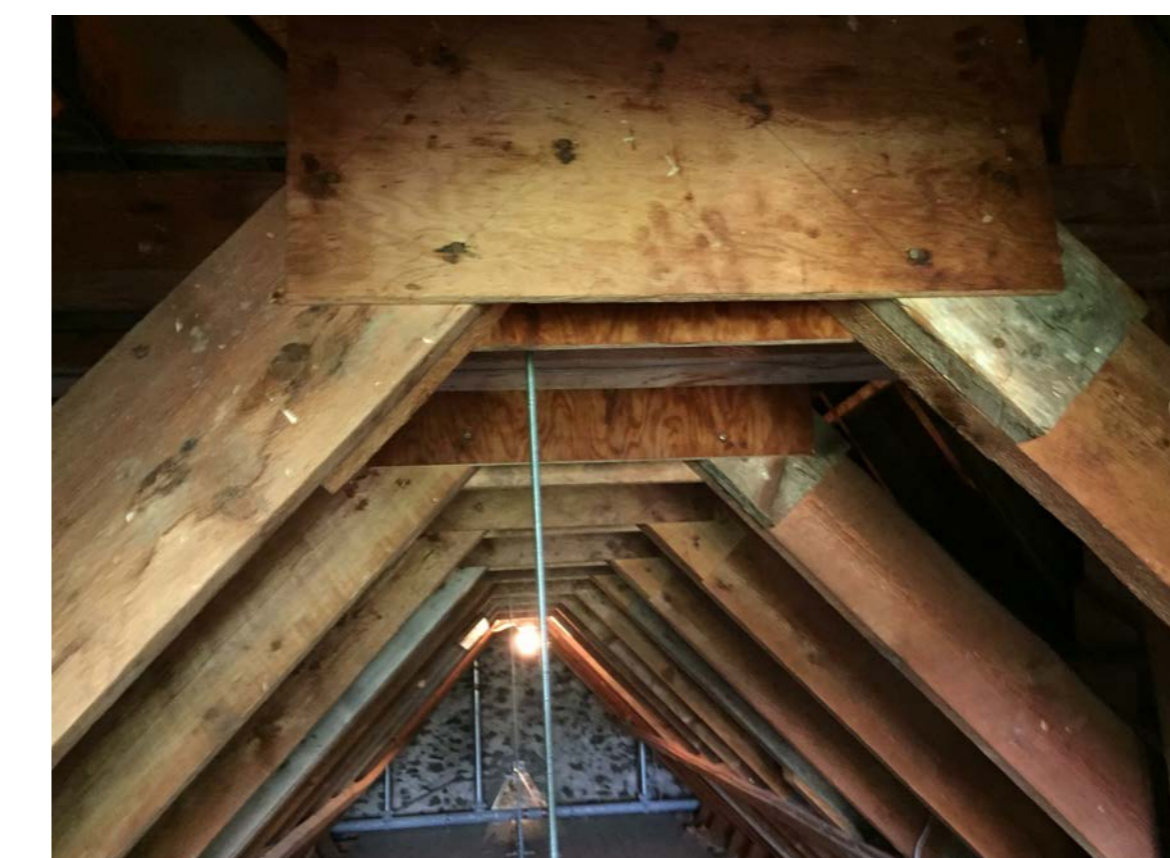

I4 NAVE ROOF RAFTERS AND GUSSET PLATES



I5 NAVE ROOF RAFTERS AND GUSSET PLATES



I6 INTERIOR FACE OF SOUTH NAVE WALL, BRICK ARCH WITH LATCH AND PLASTER INFILL



1	ISSUED FOR TENDER	02 APRIL 2020
revisions	Author	date
project	project	

**GRAND-PRÉ NATIONAL HISTORIC SITE
MEMORIAL CHURCH AND MONUMENTS REPOINTING**

EAST ELEVATION, RAINWATER LEADERS & INTERIOR - PHOTOS

designed Designer	conçu
date	06/20/19
drawn Author	dessiné
date	06/20/19
approved Approver	approuvé
date	06/20/19
Tender	Soumission
PWGC Project Manager	Administrateur de projets TPSGC
project number	no. du projet
	1241
drawing no.	no. du dessin
	A404







DEMOLITION KEYNOTES


- 101 REMOVE EAVESTROUGHS AND RAINWATER LEADERS. RETAIN COPPER PORTIONS. DISPOSE OF UNSALVAGABLE BRACKETS AND ASSOCIATED HARDWARE.
- 102 LABEL EACH ELEMENT OF WOOD SOFFIT BY LOCATION AND REMOVE. SALVAGE MATERIAL IN GOOD CONDITION. REPLICATE MATERIAL IN POOR CONDITION BEFORE DISCARDING.
- 103 LABEL EACH ELEMENT OF WOOD FASCIA AND MOLDINGS BY LOCATION AND REMOVE. SALVAGE MATERIAL IN GOOD CONDITION. REPLICATE MATERIAL IN POOR CONDITION BEFORE DISCARDING.
- 104 SOFFIT TO REMAIN IN PLACE. SCRAPE AND CLEAN AS PER SPECIFICATION.
- 105 LABEL EACH ELEMENT OF THE RAKE RETURN CONSTRUCTION ASSEMBLY BY LOCATION AND REMOVE. SALVAGE ITEMS IN GOOD CONDITION FOR RE-INSTALLATION. REPLICATE MATERIALS IN POOR CONDITION BEFORE DISCARDING.
- 106 REMOVE FLASHING FROM TOP OF RAKE RETURN TO REVIEW CONDITION OF UNDERLYING WOOD COMPONENTS. NOTIFY PCA REPRESENTATIVE FOR DIRECTION ON FURTHER REMOVALS.
- 107 LABEL EACH ELEMENT OF THE HALF-ROUND DECORATIVE BRACKET BY LOCATION AND REMOVE. SALVAGE MATERIAL IN GOOD CONDITION FOR RE-INSTALLATION. REPLICATE MATERIAL IN POOR CONDITION BEFORE DISCARDING.
- 108 REMOVE LUNETTE WINDOW. CRATE AND TRANSPORT TO PCA WORKSHOP AT 5881 MAIN ST. HWY 9, ST. ANDREWS, MANITOBA R1A 4A8. PROTECT OPENINGS DURING FULL DURATION OF WORK. REFER TO SPEC.
- 109 REMOVE DOORS AND HARDWARE. PROTECT AND TRANSPORT TO PCA ON-SITE WORKSHOP AT MAINTENANCE BUILDING. PROTECT OPENINGS DURING FULL DURATION OF WORK. REFER TO SPEC.
- 110 LEAVE IN PLACE AND PROTECT STAIN GLASS WINDOW AND SUPPORTS CAST IRON FRAMEWORK AND PILASTERS.
- 111 REMOVE COLLAR FLASHING FROM PILASTERS AND RETAIN FOR RE-INSTALLATION. FLASHING TO BE REVIEWED BY PCA REPRESENTATIVE PRIOR TO RE-INSTALLATION.
- 112 LABEL BY LOCATION THE STONE CLADDING, DISMANTLE AND RETAIN. CAREFULLY REMOVE ALL MORTAR AND STORE IN A SPECIFIED LOCATION. CONSULTANT AND PCA REPRESENTATIVE TO REVIEW CONDITIONS OF CORE PRIOR TO RE-INSTALLATION OF STONE.
- 113 RAKE OUT MORTAR JOINTS FOR THE STONE VOUSSOIRS, SPRINGERS AND KEYSTONE OF THE LUNETTE WINDOW AND STAINED GLASS WINDOW ARCH.
- 114 RAKE OUT 100% OF MORTAR JOINTS TO SOUND MORTAR.
- 115 TEMPORARILY DETACH GROUND WIRE AND LIGHTNING ROD AS NECESSARY TO FACILITATE STONE REPAIRS.
- 116 REVIEW MORTAR WINDOW SILLS FOR CONDITION. REMOVE FAILED MORTAR WHERE REQUIRED.
- 117 REMOVE CAULKING FROM AROUND PERIMETER OF WINDOWS.
- 118 LEAVE WINDOWS IN PLACE AND SCRAPE LOOSE PAINT FROM FRAME.
- 119 REMOVE MORTAR CANT AT TOP OF PLINTH.
- 120 HAND CLEAN AND WASH WITH MILD DETERGENT TO REMOVE ORGANIC GROWTH OR STAINING.
- 121 CLEAN EFFLORESCENCE FROM STONE.
- 122 CUT OUT CRACK IN MORTAR HEADER TO STABLE MATERIAL.
- 123 RAKE OUT LOCALIZED CRACKED MORTAR JOINTS.
- 124 WOOD RAMP OUTLINE. (N.I.C)
- 125 REVIEW CONDITION OF MORTAR, LEAD FLASHING AND CRICKETS. REPORT BACK TO PCA REPRESENTATIVE.
- 126 REMOVE DECKING AND SUPPORTING JOISTS AT LANDING AS REQUIRED FOR ACCESS TO STONE WORK BELOW. SUPPORTING STRUCTURE TO REMAIN.
- 127 CLEAN ANODIZED ALUMINUM WINDOW FRAMES.
- 128 REMOVE AND REPLACE EXISTING HANDRAIL.
- 129 PROTECT EXISTING SANDSTONE CORNERSTONE THRU DURATION OF PROJECT.
- 130 LOCATION OF EXISTING CATCHBASIN TO REMAIN.

GENERAL NOTES


1. REMOVE MORTAR/CAULKING AROUND THROUGH-WALL PENETRATIONS.
2. REMOVE ALL MISCELLANEOUS ACCESSORIES e.g. PLUGS, PINS, FASTENERS, LIGHT FIXTURES. BLOCKING AND STRAPS REQUIRED TO PERFORM MASONRY REPAIRS AND REPOINTING.
3. NEW STONE TO MATCH EXISTING.

DEMOLITION LEGEND

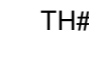
-  DENOTES APPROXIMATE LOCATION OF STONE TO BE REMOVED. CONFIRM LOCATION & EXTENT ON SITE. ASSUME 20% ADDITIONAL STONE REMOVAL AND RESETTING.
-  DENOTES APPROXIMATE AREA OF MORTAR RAKE OUT REQUIRED.
-  DENOTES ITEMS TO BE PROTECTED.
-  DENOTES ITEMS TO BE REMOVED.
-  DEMOLITION KEYNOTE (* DENOTES DEMO WORK)
-  DENOTES LOCATION OF TEST HOLES

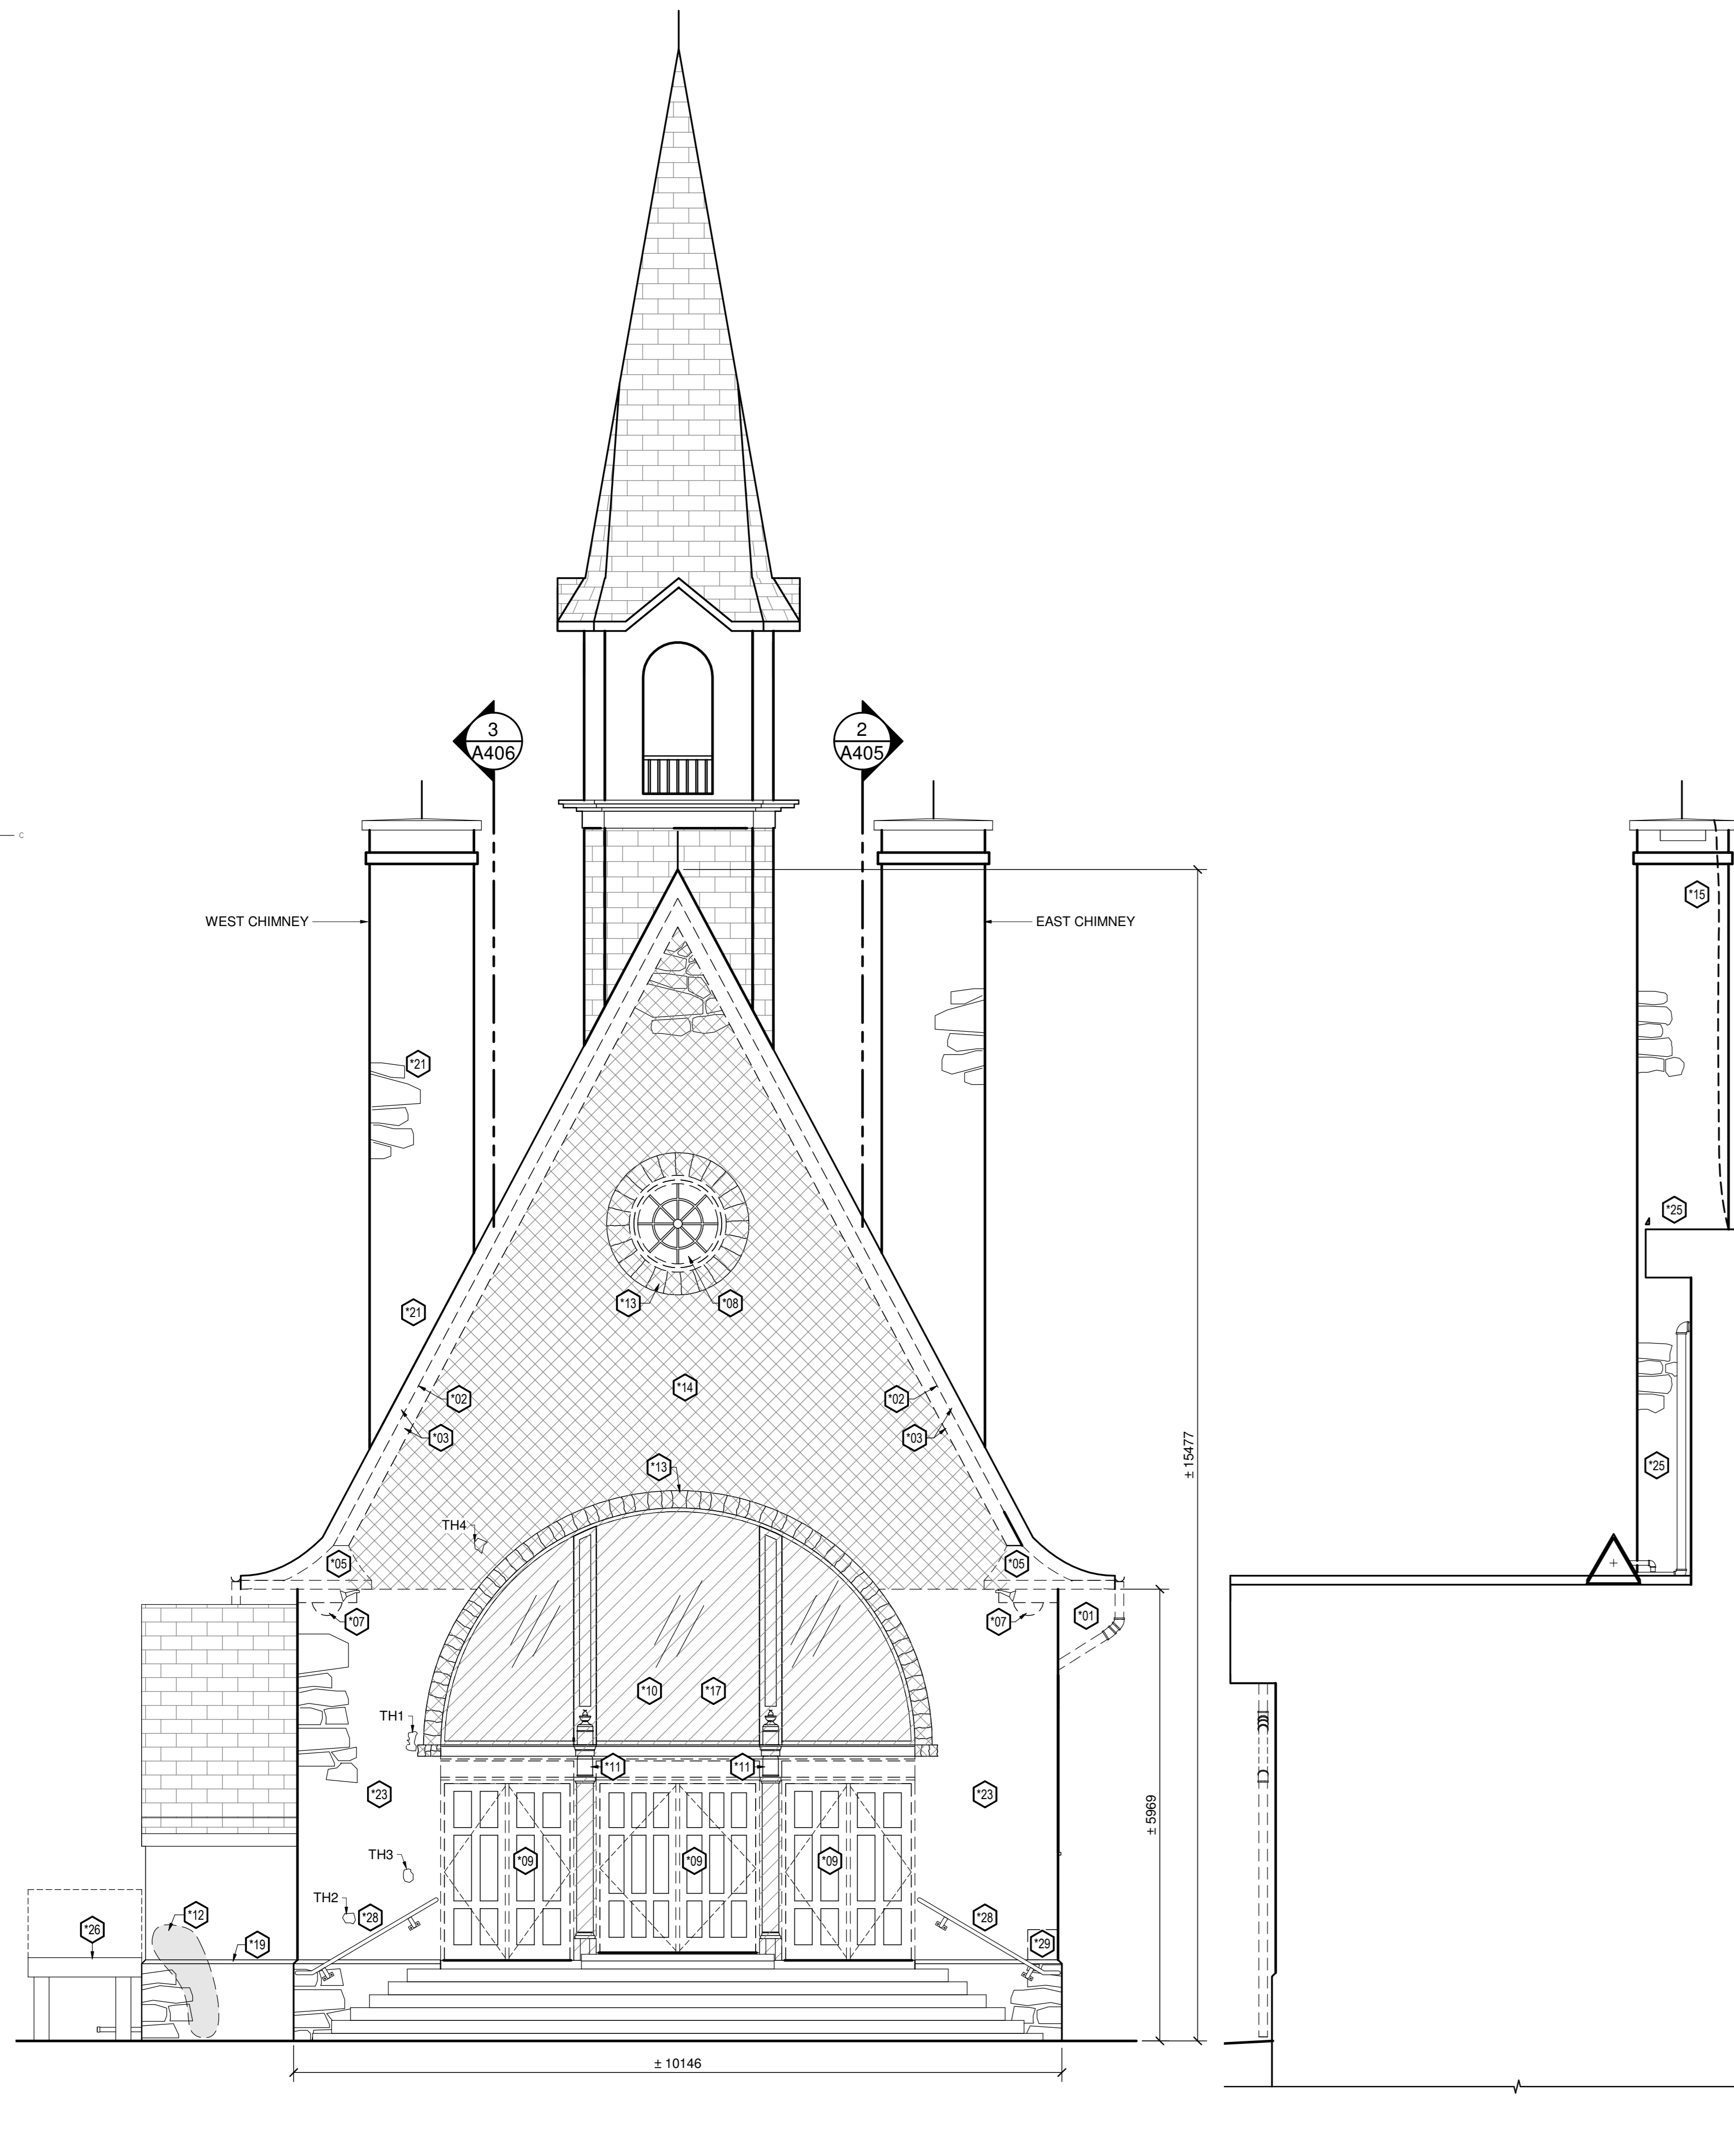


1 DEMOLITION SOUTH (FRONT) ELEVATION
A405 1:50

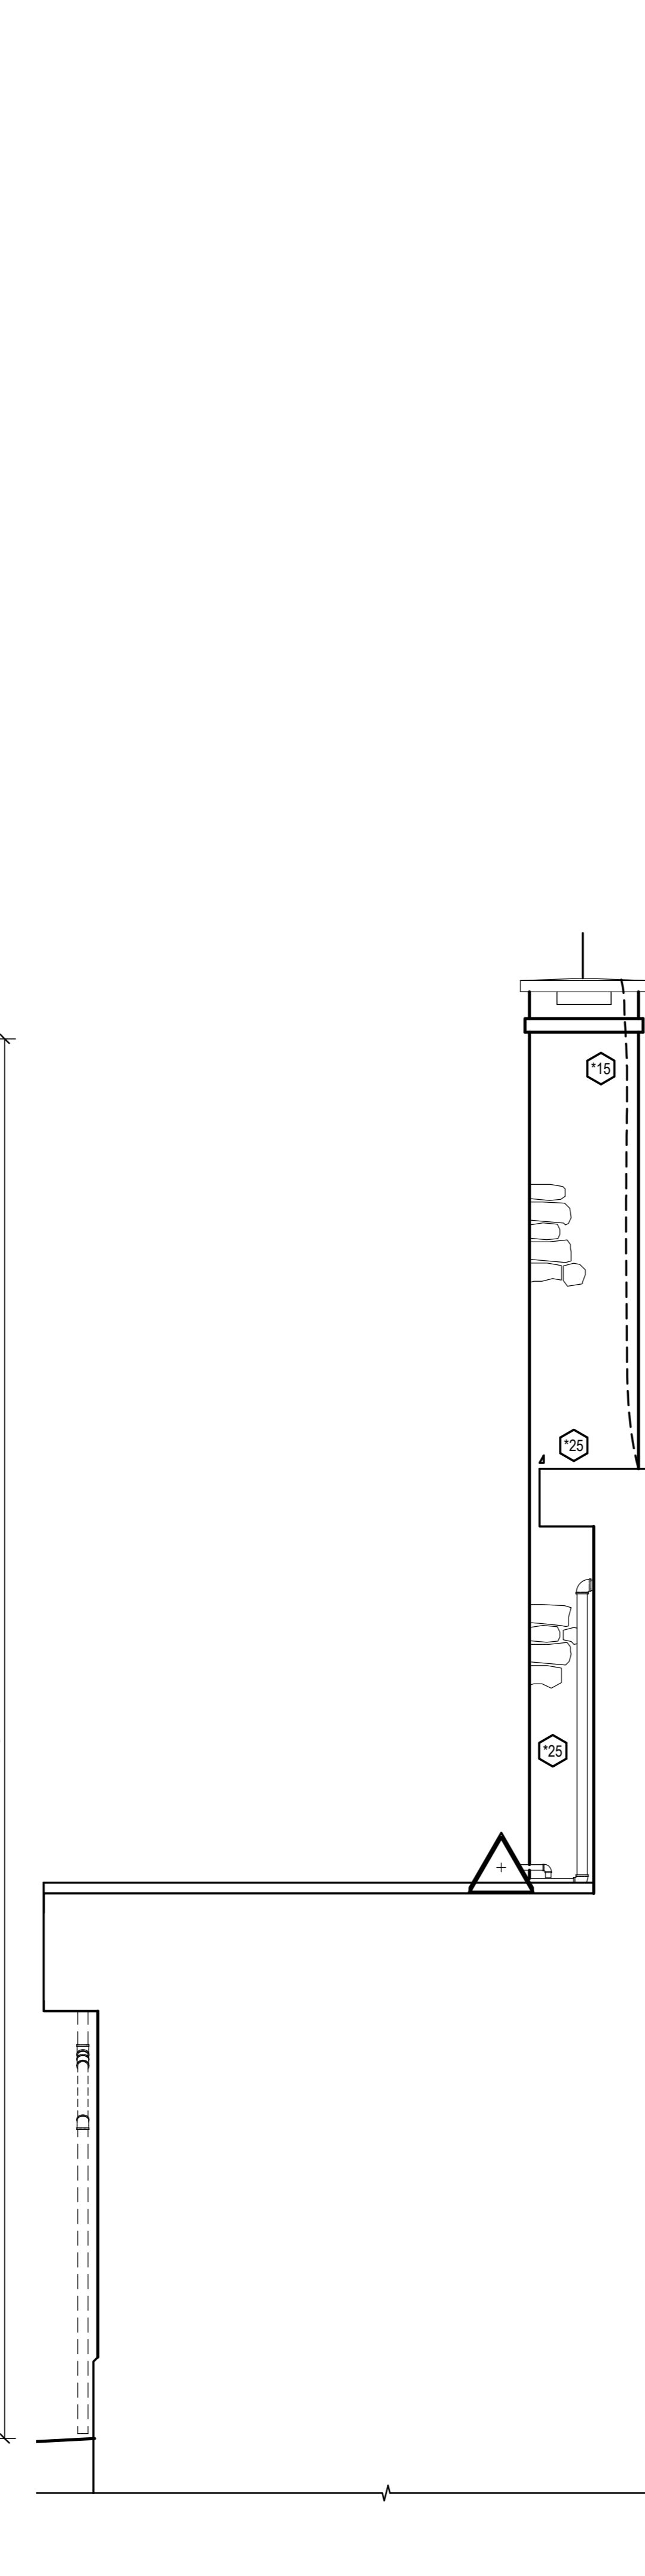

2 WEST ELEVATION OF EAST CHIMNEY
A405 1:50

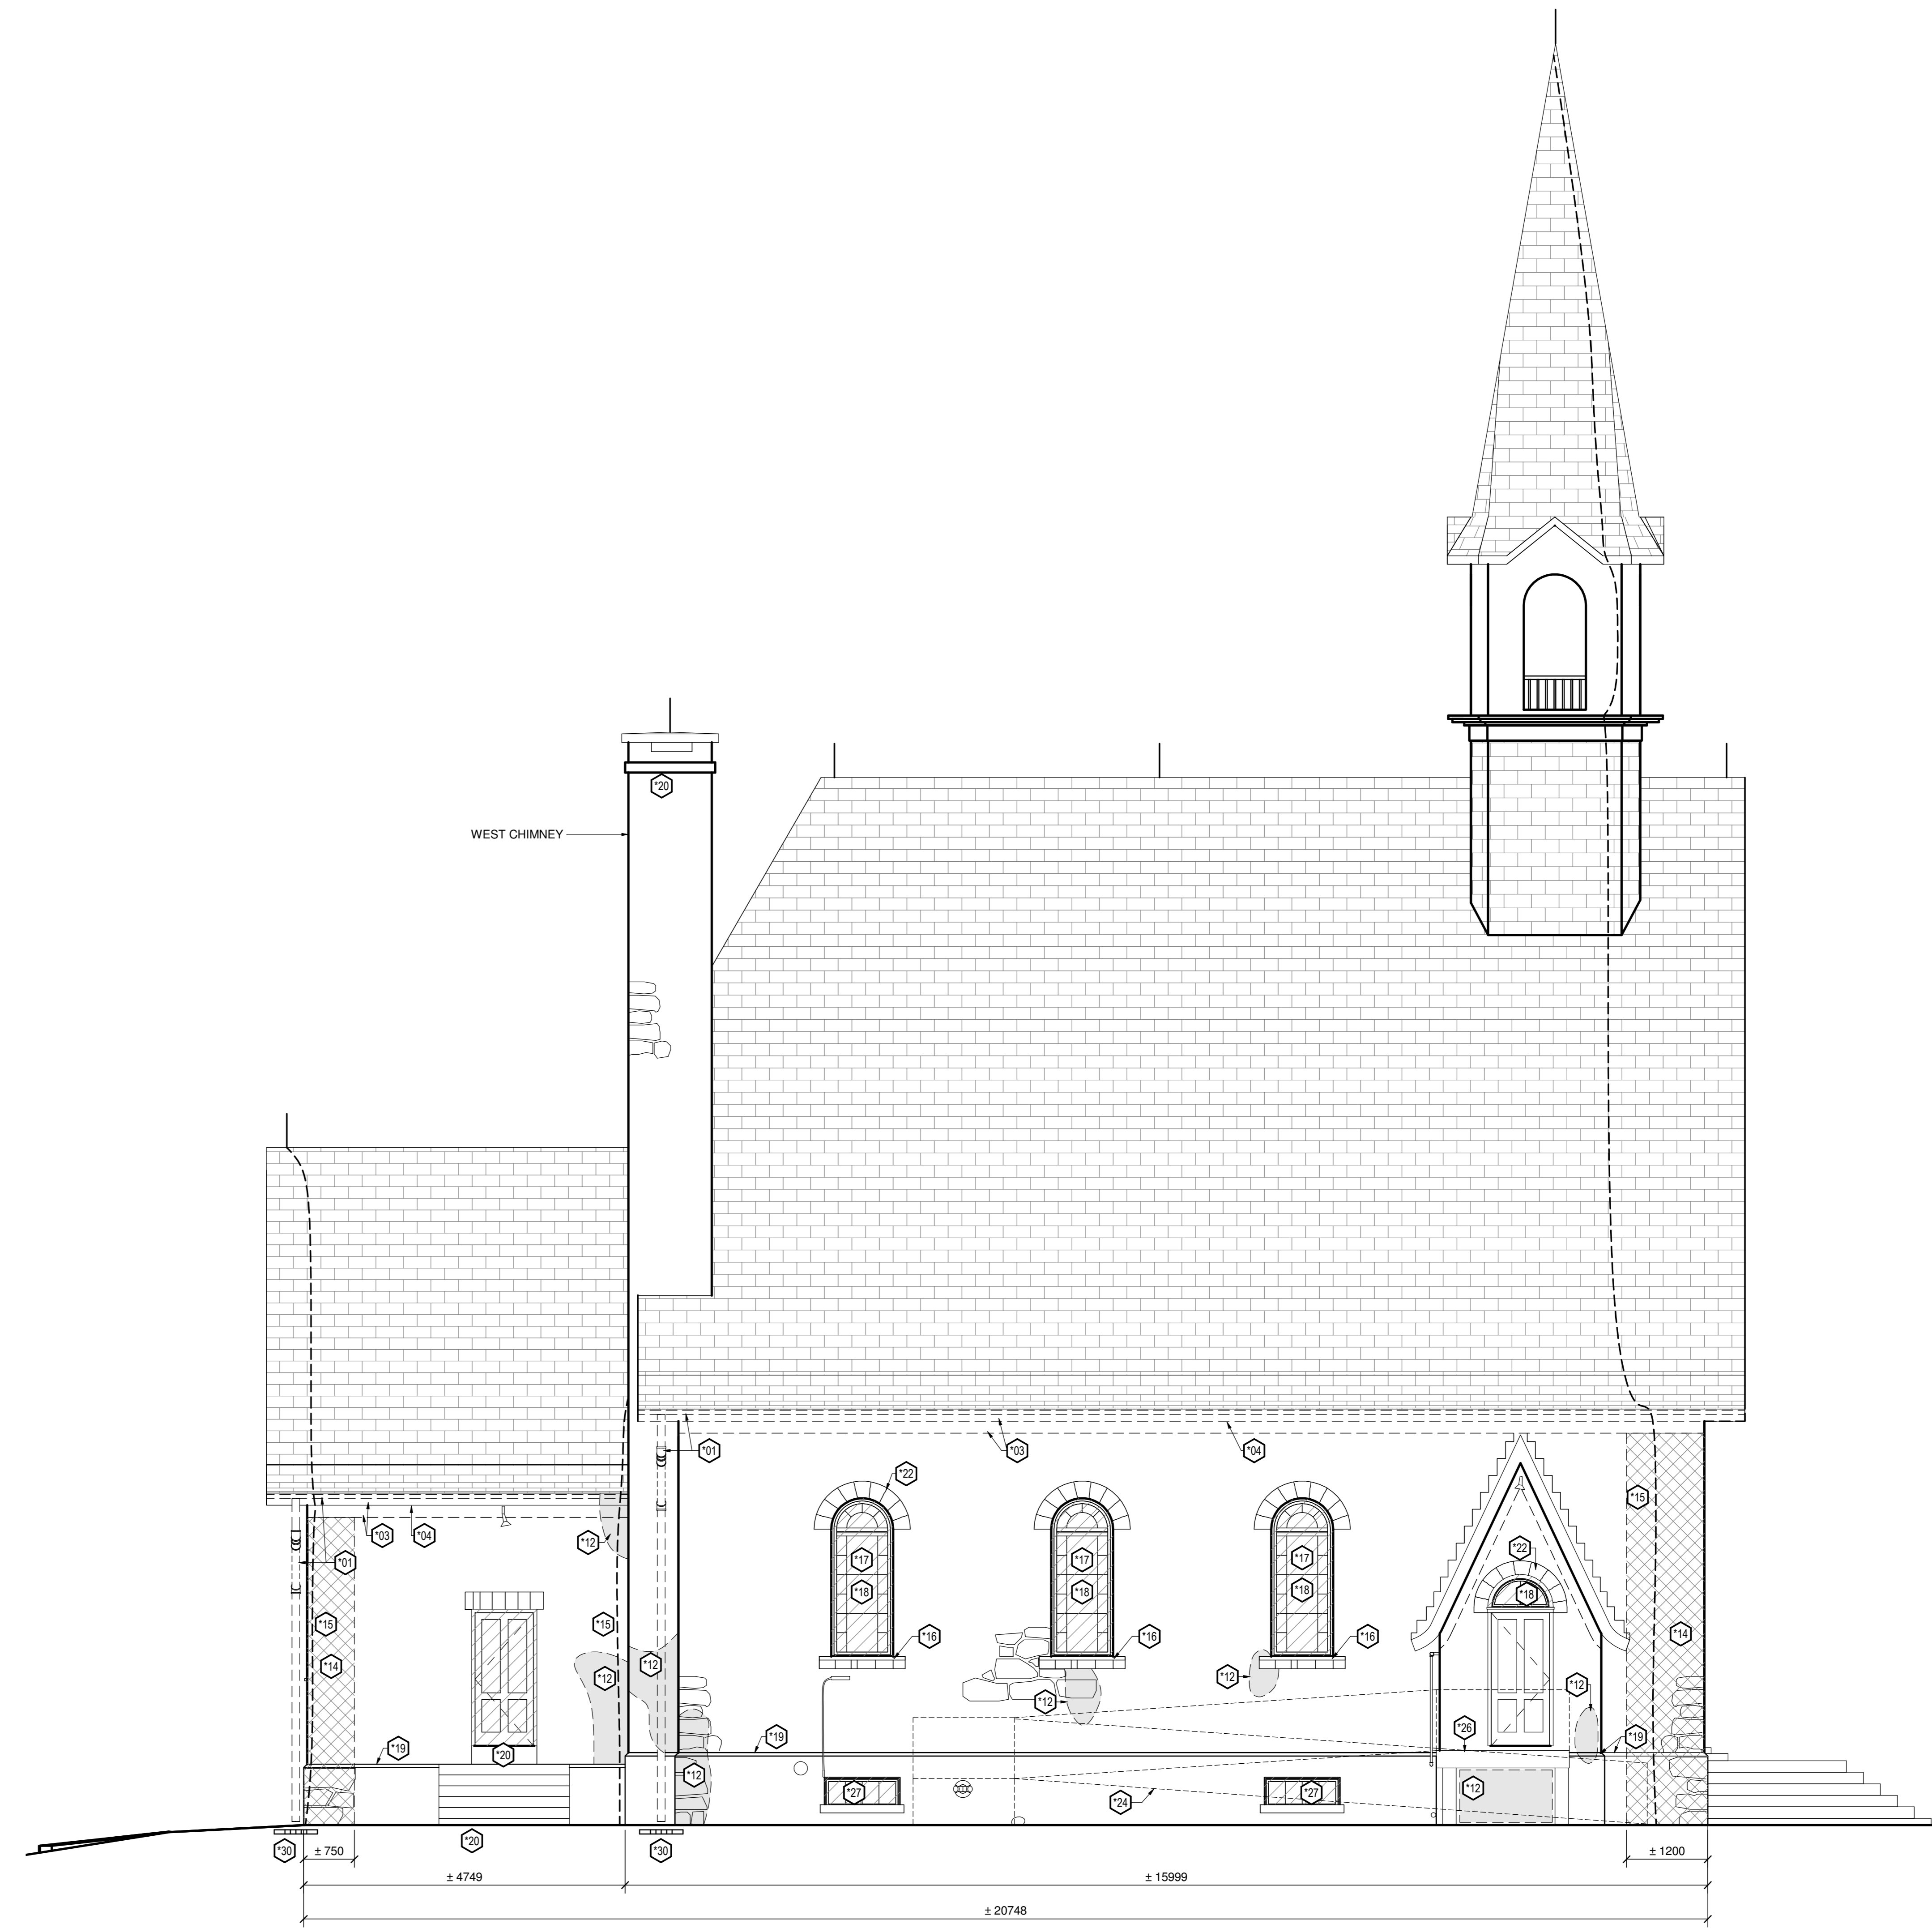

3 DEMOLITION WEST ELEVATION
A405 1:50

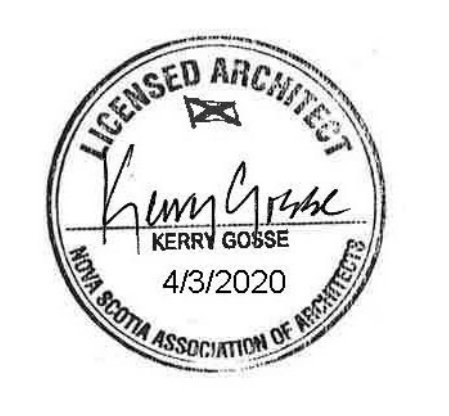

1	ISSUED FOR TENDER	03 APRIL 2020
revisions		date
project	GRAND-PRÉ NATIONAL HISTORIC SITE MEMORIAL CHURCH AND MONUMENTS REPOINTING	
drawing	DEMOLITION ELEVATIONS	
designed	Designer	corpu
date	06/17/19	
drawn	MG	dessiné
date	06/17/19	
approved	Approver	approuvé
date	06/17/19	
Tender	Submission	
PWGSC Project Manager	Administrateur de projets TPSGC	
project number	no. du projet	
	1241	
drawing no.	no. du dessin	
	A405	






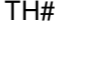
DEMOLITION KEYNOTES

- 101 REMOVE EAVESTROUGHS AND RAINWATER LEADERS. RETAIN COPPER PORTIONS. DISPOSE OF UNSALVAGABLE BRACKETS AND ASSOCIATED HARDWARE.
- 102 LABEL EACH ELEMENT OF WOOD SOFFIT BY LOCATION AND REMOVE. SALVAGE MATERIAL IN GOOD CONDITION. REPLICATE MATERIAL IN POOR CONDITION BEFORE DISCARDING.
- 103 LABEL EACH ELEMENT OF WOOD FASCIA AND MOLDINGS BY LOCATION AND REMOVE. SALVAGE MATERIAL IN GOOD CONDITION. REPLICATE MATERIAL IN POOR CONDITION BEFORE DISCARDING.
- 104 SOFFIT TO REMAIN IN PLACE. SCRAPE AND CLEAN AS PER SPECIFICATION.
- 105 LABEL EACH ELEMENT OF THE RAKE RETURN CONSTRUCTION ASSEMBLY BY LOCATION AND REMOVE. SALVAGE ITEMS IN GOOD CONDITION FOR RE-INSTALLATION. REPLICATE MATERIALS IN POOR CONDITION BEFORE DISCARDING.
- 106 REMOVE FLASHING FROM TOP OF RAKE RETURN TO REVIEW CONDITION OF UNDERLYING WOOD COMPONENTS. NOTIFY PCA REPRESENTATIVE FOR DIRECTION ON FURTHER REMOVALS.
- 107 LABEL EACH ELEMENT OF THE HALF-ROUND DECORATIVE BRACKET BY LOCATION AND REMOVE. SALVAGE MATERIAL IN GOOD CONDITION FOR RE-INSTALLATION. REPLICATE MATERIAL IN POOR CONDITION BEFORE DISCARDING.
- 108 REMOVE LUNETTE WINDOW. CRATE AND TRANSPORT TO PCA WORKSHOP AT 5981 MAIN ST. HWY 9, ST. ANDREWS, MANITOBA R1A 4A8. PROTECT OPENINGS DURING FULL DURATION OF WORK. REFER TO SPEC.
- 109 REMOVE DOORS AND HARDWARE. PROTECT AND TRANSPORT TO PCA ON-SITE WORKSHOP AT MAINTENANCE BUILDING. PROTECT OPENINGS DURING FULL DURATION OF WORK. REFER TO SPEC.
- 110 LEAVE IN PLACE AND PROTECT STAIN GLASS WINDOW AND SUPPORTS. CAST IRON FRAMEWORK AND PILASTERS.
- 111 REMOVE COLLAR FLASHING FROM PILASTERS AND RETAIN FOR RE-INSTALLATION. FLASHING TO BE REVIEWED BY PCA REPRESENTATIVE PRIOR TO RE-INSTALLATION.
- 112 LABEL BY LOCATION THE STONE GLADDING. DISMANTLE AND RETAIN. CAREFULLY REMOVE ALL MORTAR AND STONE IN A SPECIFIED LOCATION. CONSULTANT AND PCA REPRESENTATIVE TO REVIEW CONDITIONS OF CORE PRIOR TO RE-INSTALLATION OF STONE.
- 113 RAKE OUT MORTAR JOINTS FOR THE STONE VOUSOIRS, SPRINGERS AND KEYSTONE OF THE LUNETTE WINDOW AND STAINED GLASS WINDOW ARCH.
- 114 RAKE OUT 100% OF MORTAR JOINTS TO SOUND MORTAR.
- 115 TEMPORARILY DETACH GROUND WIRE AND LIGHTNING ROD AS NECESSARY TO FACILITATE STONE REPAIRS.
- 116 REVIEW MORTAR WINDOW SILLS FOR CONDITION. REMOVE FAILED MORTAR WHERE REQUIRED.
- 117 REMOVE CAULKING FROM AROUND PERIMETER OF WINDOWS.
- 118 LEAVE WINDOWS IN PLACE AND SCRAPE LOOSE PAINT FROM FRAME.
- 119 REMOVE MORTAR CANT AT TOP OF PLINTH.
- 120 HAND CLEAN AND WASH WITH MILD DETERGENT TO REMOVE ORGANIC GROWTH OR STAINING.
- 121 CLEAN EFFLORESCENCE FROM STONE.
- 122 CUT OUT CRACK IN MORTAR HEADER TO STABLE MATERIAL.
- 123 RAKE OUT LOCALIZED CRACKED MORTAR JOINTS.
- 124 WOOD RAMP OUTLINE. (N.I.C)
- 125 REVIEW CONDITION OF MORTAR, LEAD FLASHING AND CRICKETS. REPORT BACK TO PCA REPRESENTATIVE.
- 126 REMOVE DECKING AND SUPPORTING JOISTS AT LANDING AS REQUIRED FOR ACCESS TO STONE WORK BELOW. SUPPORTING STRUCTURE TO REMAIN.
- 127 CLEAN ANODIZED ALUMINUM WINDOW FRAMES.
- 128 REMOVE AND REPLACE EXISTING HANDRAIL.
- 129 PROTECT EXISTING SANDSTONE CORNERSTONE THRU DURATION OF PROJECT.
- 130 LOCATION OF EXISTING CATCHBASIN TO REMAIN.

GENERAL NOTES

1. REMOVE MORTAR/CAULKING AROUND THROUGH-WALL PENETRATIONS.
2. REMOVE ALL MISCELLANEOUS ACCESSORIES e.g. PLUGS, PINS, FASTENERS, LIGHT FIXTURES, BLOCKING AND STRAPS REQUIRED TO PERFORM MASONRY REPAIRS AND REPOINTING.
3. NEW STONE TO MATCH EXISTING.

DEMOLITION LEGEND

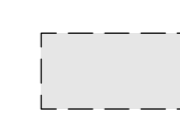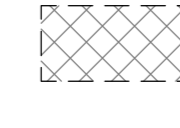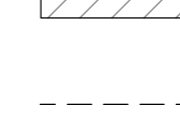
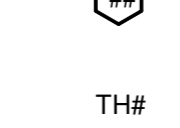
-  DENOTES APPROXIMATE LOCATION OF STONE TO BE REMOVED. CONFIRM LOCATION & EXTENT ON SITE. ASSUME 20% ADDITIONAL STONE REMOVAL AND RESETTING.
-  DENOTES APPROXIMATE AREA OF MORTAR RAKE OUT REQUIRED.
-  DENOTES ITEMS TO BE PROTECTED.
-  DENOTES ITEMS TO BE REMOVED.
-  DEMOLITION KEYNOTE (" DENOTES DEMO WORK)
-  DENOTES LOCATION OF TEST HOLES



1 DEMOLITION NORTH (REAR) ELEVATION
A406 1:50

2 DEMOLITION EAST ELEVATION
A406 1:50

3 EAST ELEVATION OF WEST CHIMNEY
A405 1:50

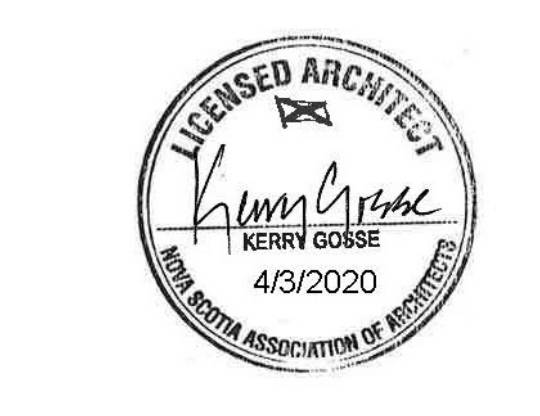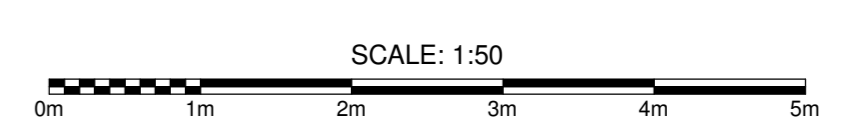

1	ISSUED FOR TENDER	03 APRIL 2020
revisions	author	date

project
GRAND-PRÉ NATIONAL HISTORIC SITE MEMORIAL CHURCH AND MONUMENTS REPOINTING

drawing
DEMOLITION ELEVATIONS

designed Designer	conçu
date	07/08/19
drawn Author	dessiné
date	07/08/19
approved Approver	approuvé
date	07/08/19

Tender
PWGSC Project Manager Administrateur de projets TPSGC
project number


1241
drawing no. A406 no. du dessin

NEW CONSTRUCTION KEYNOTES


- 01 TEST EXISTING COPPER EAVESTROUGH AND RAINWATER LEADERS FOR LEAKS AND REPAIR PRIOR TO REINSTALLATION. BRACKETS AND HARDWARE TO BE COPPER AND ALL SAME STYLE.
- 02 RE-INSTALL WOOD SOFFIT ACCORDING TO LOCATION. REPAIR WITH NEW MATERIAL TO MATCH EXISTING PROFILE AND MATERIAL. WOOD FILL, SAND AND PAINT.
- 03 RE-INSTALL WOOD FASCIA AND MOLDINGS ACCORDING TO LOCATION. REPAIR WITH NEW MATERIAL TO MATCH EXISTING PROFILE AND MATERIAL. WOOD FILL, SAND AND PAINT.
- 04 RE-INSTALL RAKE RETURN CONSTRUCTION ASSEMBLY. SEE DETAIL SHEET A701.
- 05 RE-INSTALL HALF-ROUND DECORATIVE BRACKETS ACCORDING TO LOCATION. REPAIR WITH NEW MATERIAL TO MATCH EXISTING PROFILE AND MATERIAL. WOOD FILL, SAND AND PAINT.
- 06 ARRANGE TRANSPORT FROM PCA WORKSHOP OF RESTORED LUNETTE WINDOW AND RE-INSTALL. SEE DETAIL SHEET A702.
- 07 ARRANGE TRANSPORT FROM PCA WORKSHOP OF RESTORED DOORS AND RECONDITIONED HARDWARE AND RE-INSTALL.
- 08 MAINTAIN PROTECTION OF STAIN GLASS WINDOW. REMOVE PROTECTION FROM CAST-IRON PILASTERS, SCRAPE, RE-INSTALL COLLAR FLASHING AND PAINT.
- 09 REPOINT 100% OF RAKED OUT JOINTS. SEE DETAILS SHEET A701
- 10 REPAIR AND REPOINT RAKED OUT JOINTS OF VOUSSOIRS, SPRINGERS AND KEYSTONES OF LUNETTE WINDOW AND STAINED GLASS WINDOW ARCH.
- 11 RE-INSTALL TEMPORARILY REMOVED GROUND WIRE AND LIGHTNING ROD.
- 12 RESET EXISTING STONE CLADDING IN SAME LOCATION AS REMOVED. INSTALL SPIRAL TIES IN JOINTS EVERY 300mm TO SUIT RANDOM PATTERN OF STONE. SEE DETAIL SHEET A701.
- 13 LIGHT DRESS SANDSTONE CORNERSTONES AND RETOOL EDGES OF NUMBERS. TREAT WITH STONE CONSOLIDATION PRODUCT.
- 14 REPAIR FAILED WINDOW SILLS WITH SAME MATERIAL. ALLOW TO CURE AND COAT WITH CEMENTITIOUS WATERPROOFING COATING. SEE SPECIFICATION.
- 15 TOUCH UP PAINT ON WINDOW FRAMES, ALLOW PAINT AND ADJACENT MORTAR TO DRY/CURE PRIOR TO RE-CAULKING.
- 16 BUILD UP NEW MORTAR CANT. SEE DETAIL SHEET A701.
- 17 LOCATION OF EXISTING CATCHBASIN TO REMAIN.

GENERAL NOTES


- 1. RE-CAULK AROUND THROUGH WALL PENETRATIONS AFTER FRONT POINTING HAS CURED.
- 2. RE-INSTALL ONLY THE REQUIRED ACCESSORIES. DO NOT FASTEN THROUGH STONE. USE STAINLESS STEEL FASTENERS UNLESS NOTED OTHERWISE.
- 3. INSTALL NEW STONE AS REQUIRED. SEE DETAIL A701.
- 4. ALL MASONRY CLEANING TO BE COMPLETED IN COMPLIANCE WITH SPECIFICATION SECTION 04 03 04.13
- 5. ALL HOLES RESULTING FROM REMOVAL OF OBSOLETE PINS, PLUGS ETC. TO BE FILLED WITH COLOUR MATCHED MORTAR. ALL PINS, PLUGS TO BE RE-INSTATED ARE TO BE STAINLESS STEEL TO SUIT APPLICATION AND INSTALLED THROUGH MORTAR JOINTS.
- 6. ALL NEW WOOD MEMBERS TO BE PRIMED ON ALL SIDES AND PAINTED WITH 2 COATS. SEE SPECIFICATION.

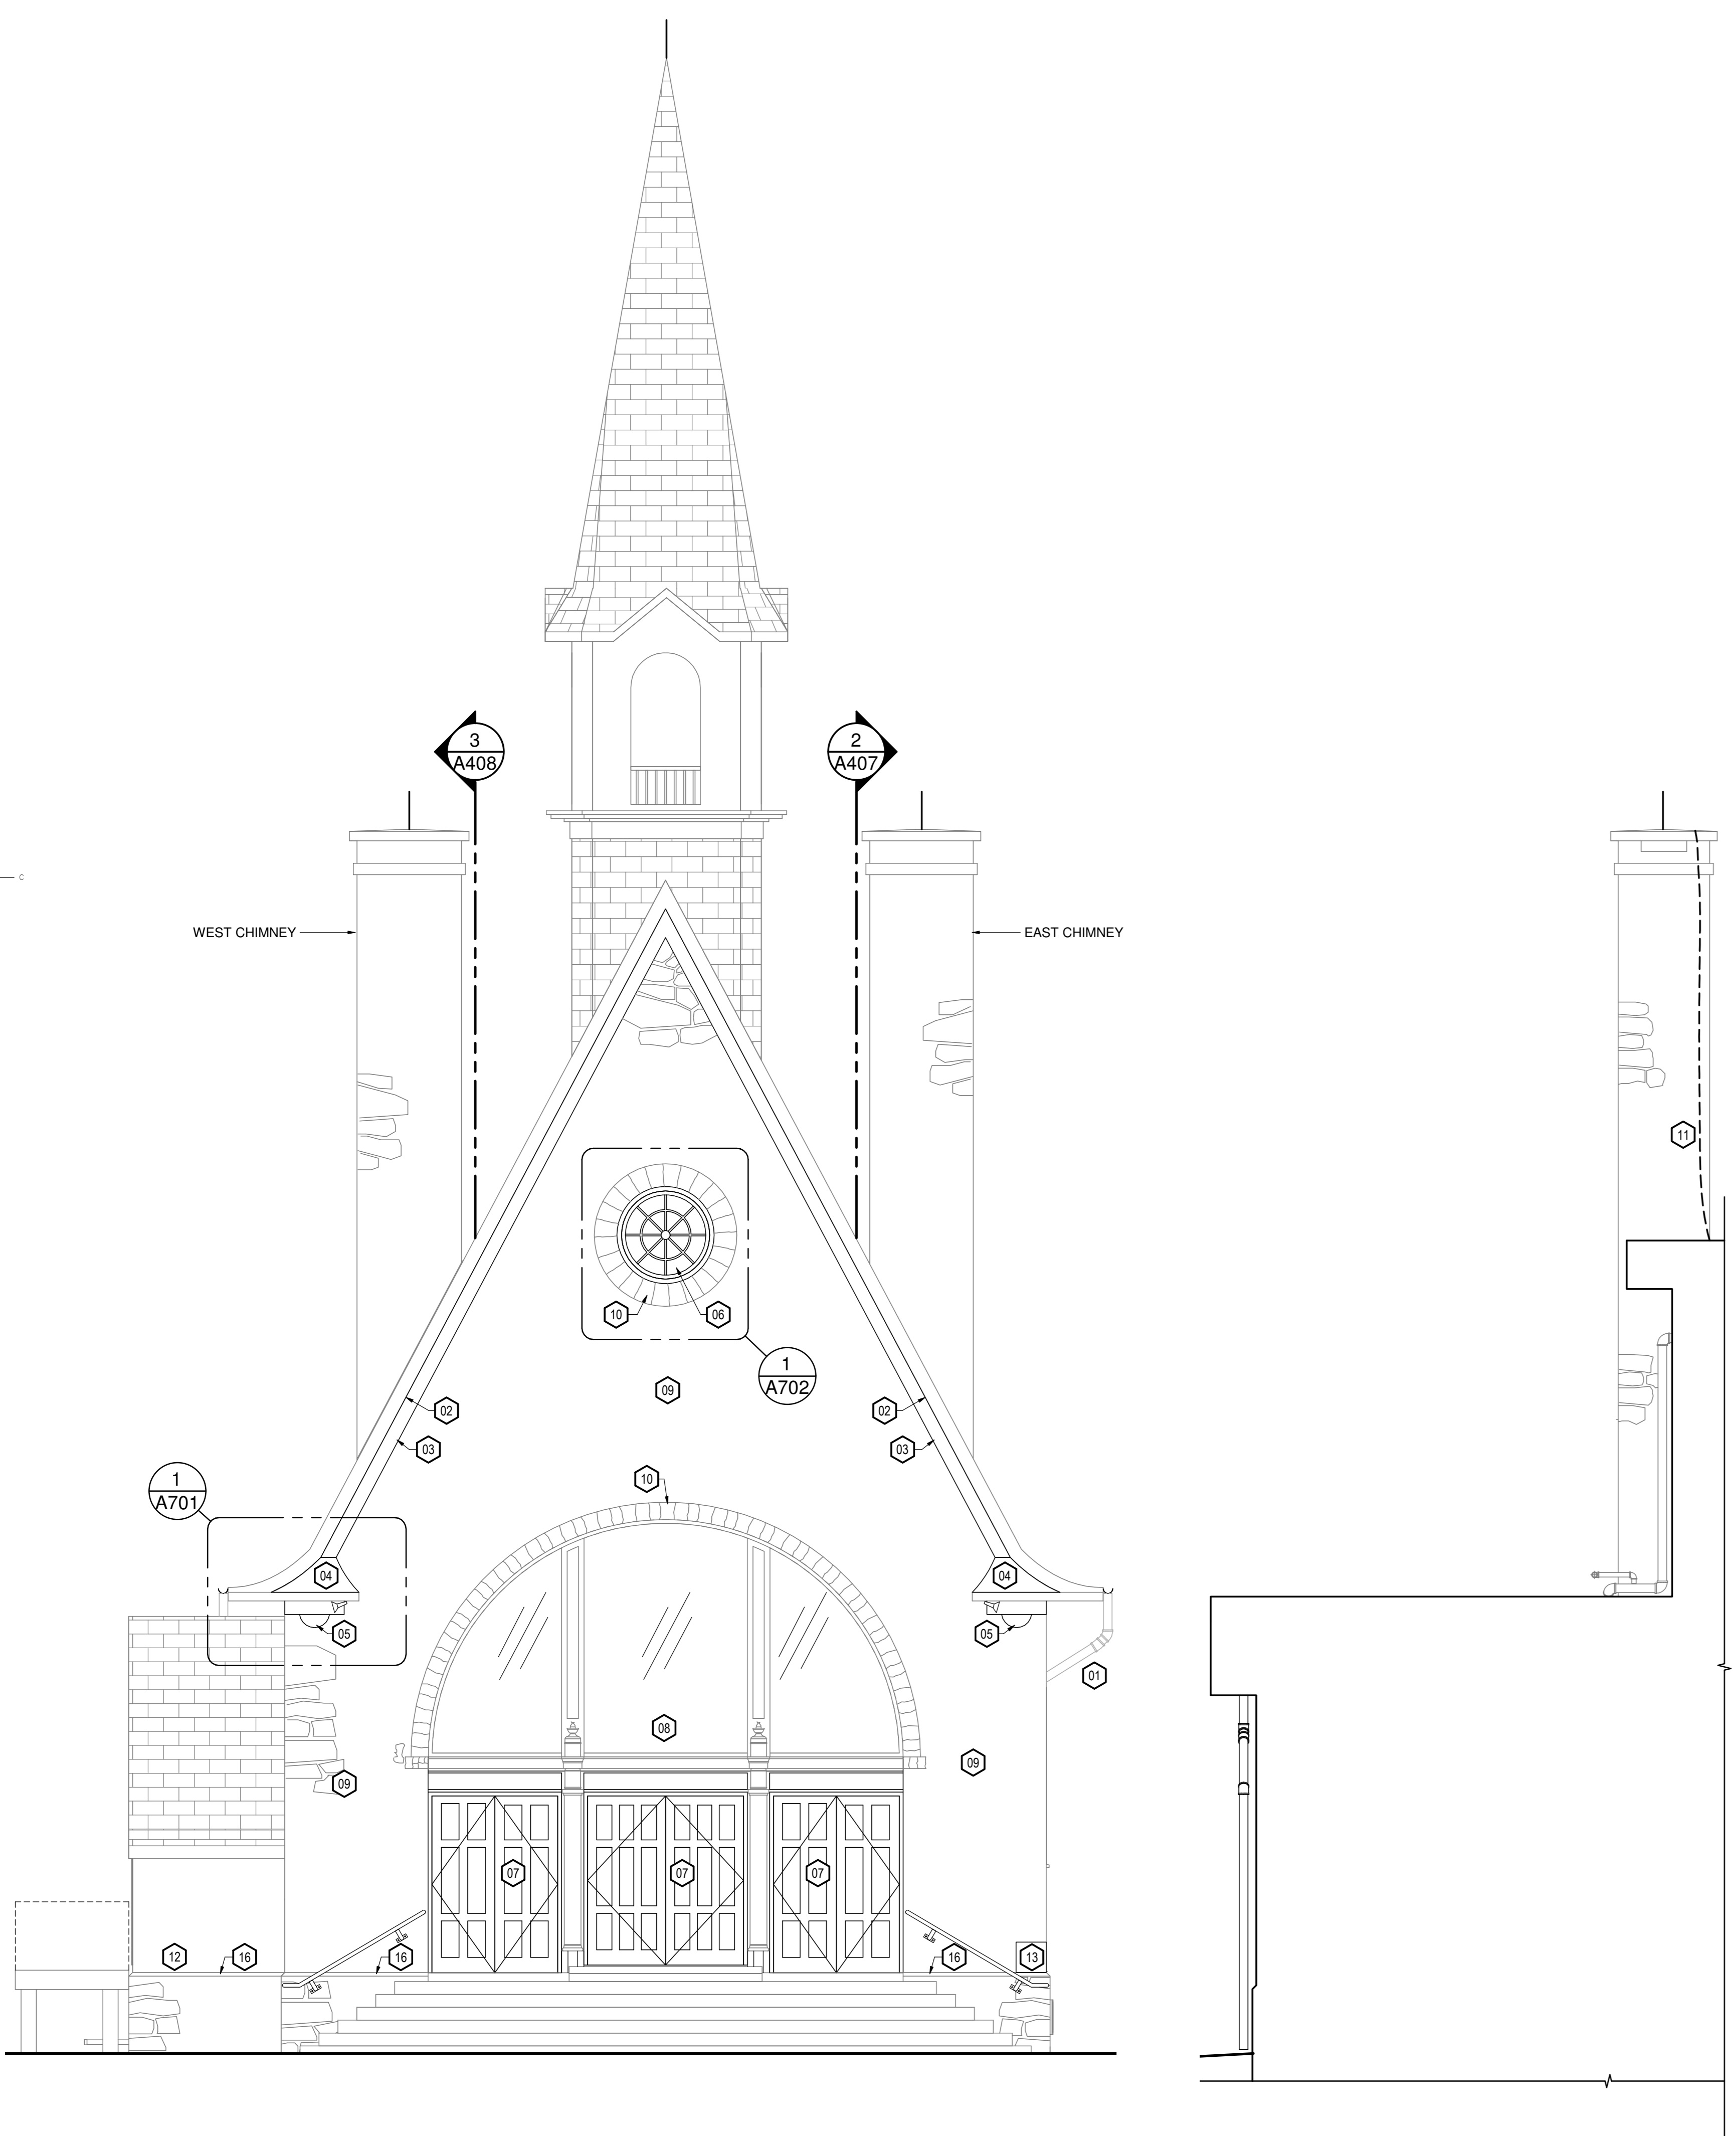

1 NEW SOUTH (FRONT) ELEVATION
A407 1:50

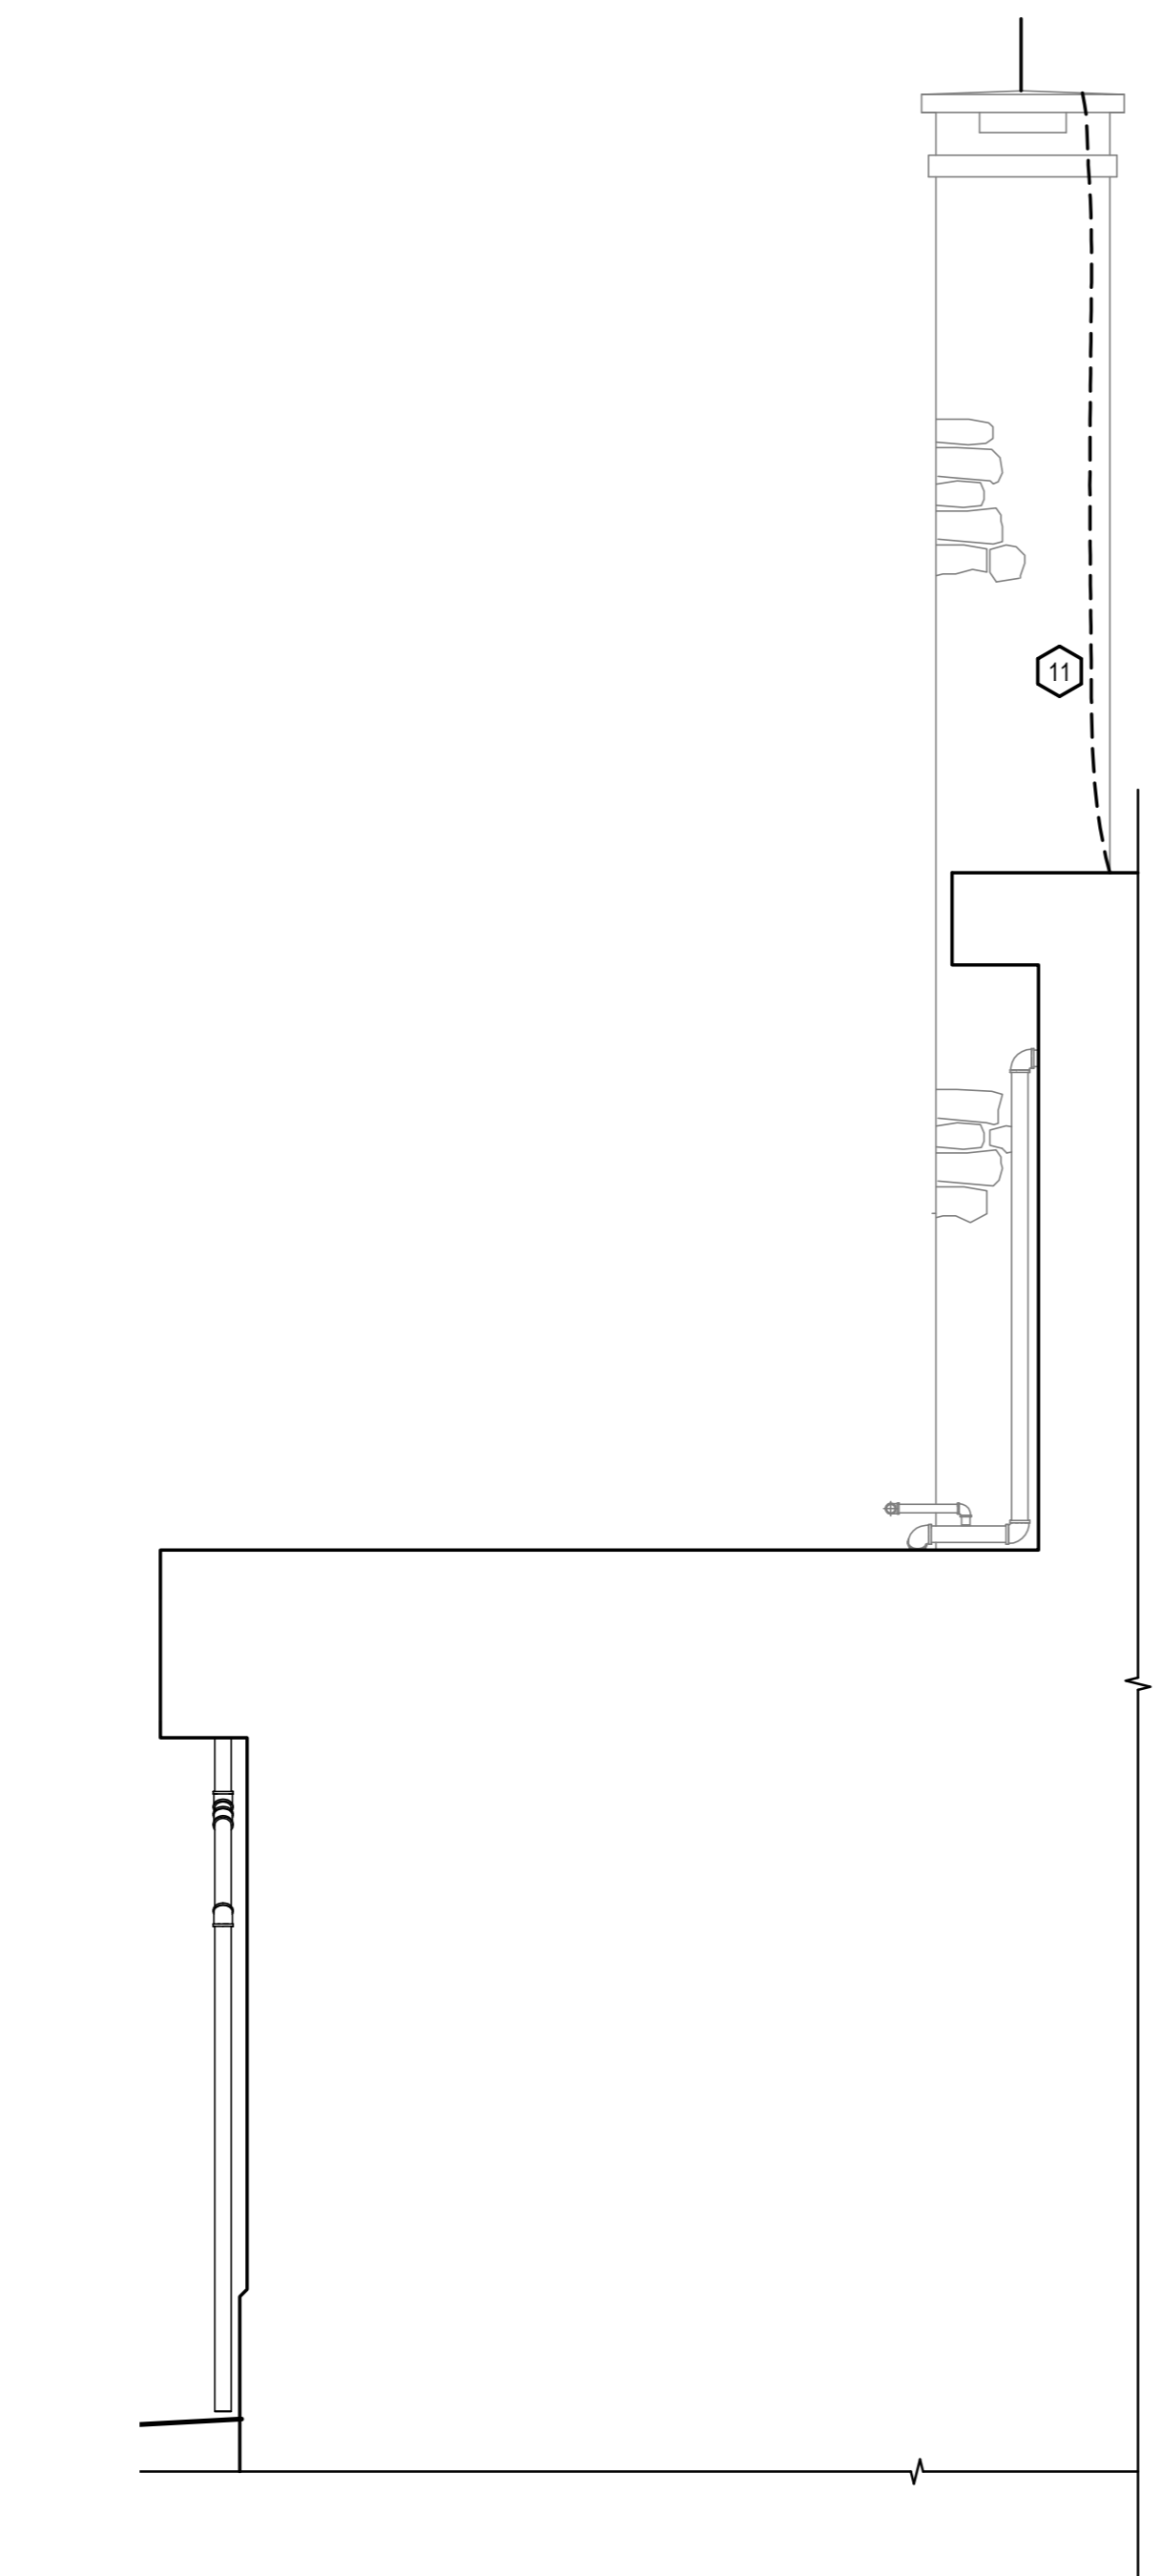


2 WEST ELEVATION OF EAST CHIMNEY
A407 1:50

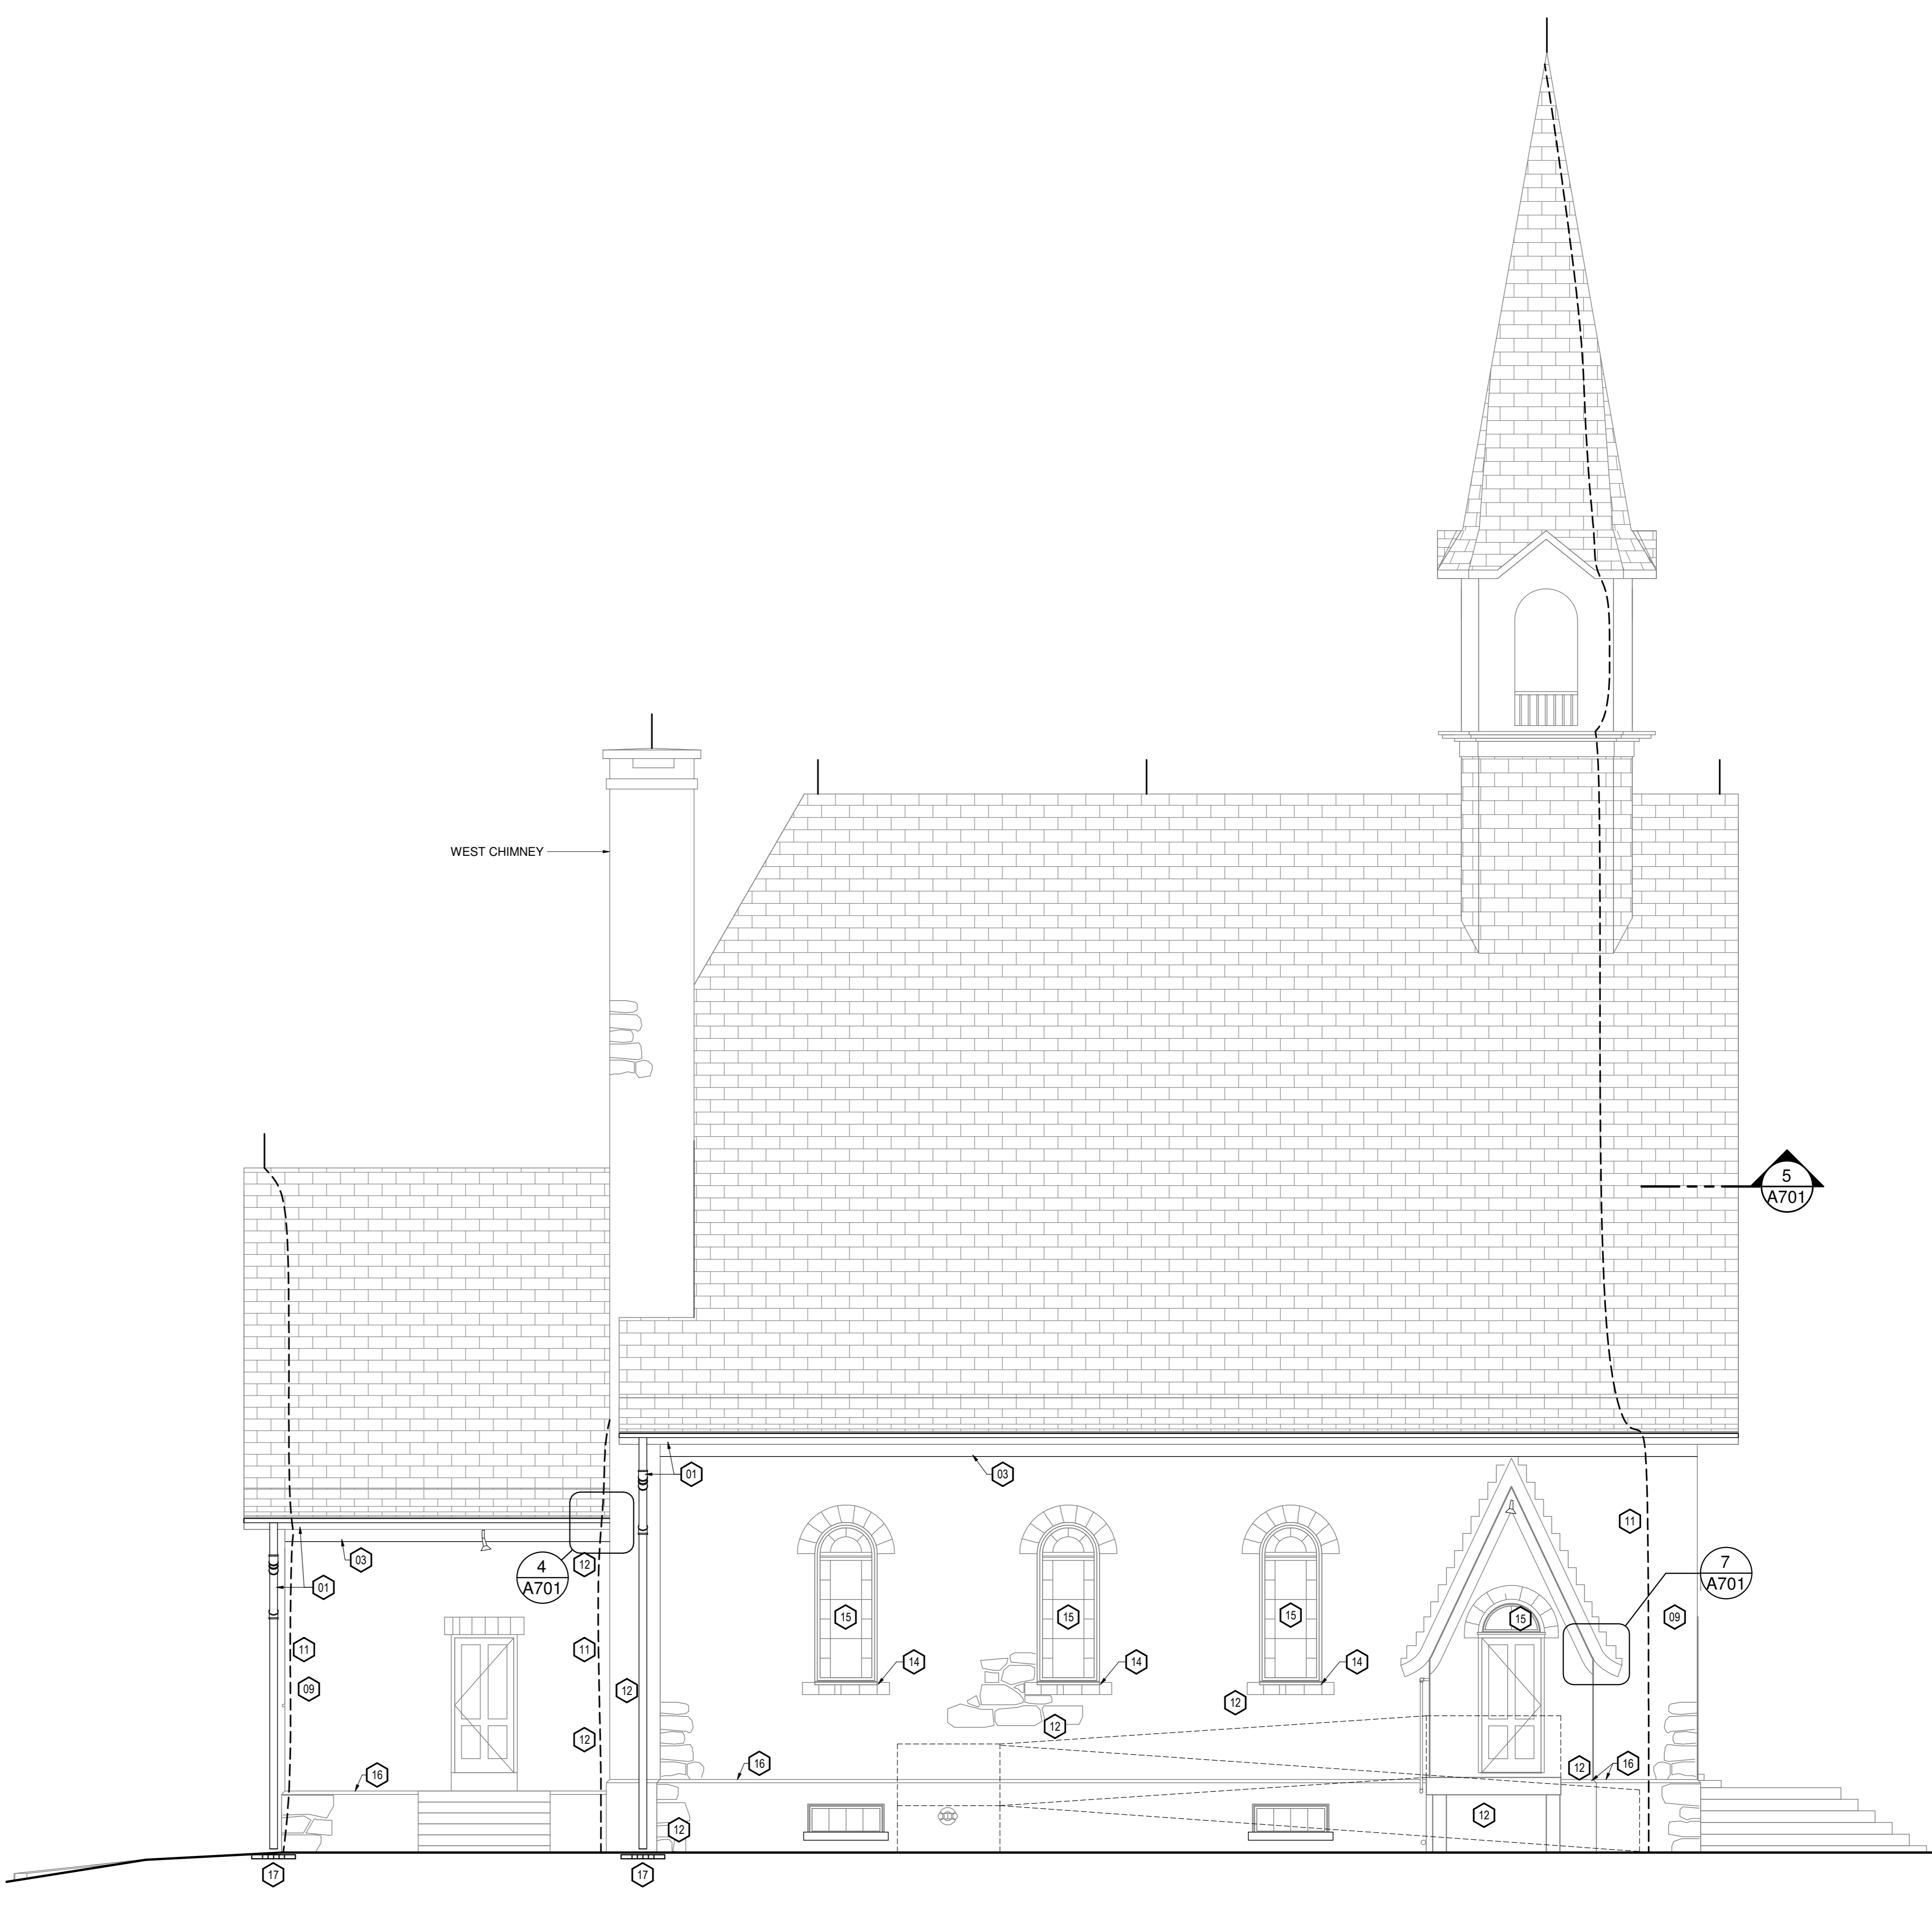

3 NEW WEST ELEVATION
A407 1:50

SCALE: 1:50
0m 1m 2m 3m 4m 5m

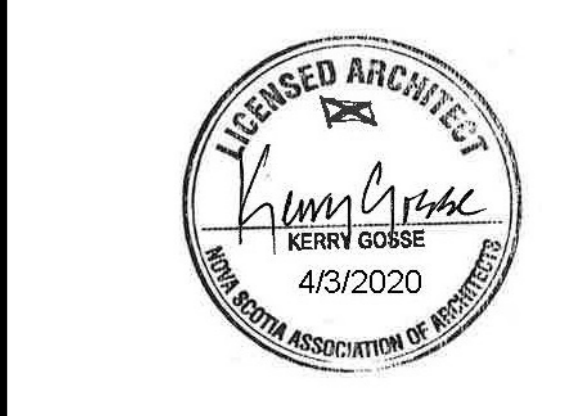

1	ISSUED FOR TENDER	02 APRIL 2020
revisions		date

project
**GRAND-PRÉ NATIONAL HISTORIC SITE
MEMORIAL CHURCH
AND MONUMENTS
REPOINTING**

drawing no. **NEW ELEVATIONS**


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date 06/18/19	
drawn MGL/L	dessiné
date 06/18/19	
approved Approver	approuvé
date 06/18/19	
Tender	Soumission
PWGSC Project Manager Administrateur de projets TPSGC	
project number	no. du projet
	1241
drawing no.	no. du dessin
	A407

NEW CONSTRUCTION KEYNOTES

- 01 TEST EXISTING COPPER EAVESTROUGH AND RAINWATER LEADERS FOR LEAKS AND REPAIR PRIOR TO REINSTALLATION. BRACKETS AND HARDWARE TO BE COPPER AND ALL SAME STYLE.
- 02 RE-INSTALL WOOD SOFFIT ACCORDING TO LOCATION. REPAIR WITH NEW MATERIAL TO MATCH EXISTING PROFILE AND MATERIAL. WOOD FILL, SAND AND PAINT.
- 03 RE-INSTALL WOOD FASCIA AND MOLDINGS ACCORDING TO LOCATION. REPAIR WITH NEW MATERIAL TO MATCH EXISTING PROFILE AND MATERIAL. WOOD FILL, SAND AND PAINT.
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- 09 REPOINT 100% OF RAKED OUT JOINTS. SEE DETAILS SHEET A701
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- 11 RE-INSTALL TEMPORARILY REMOVED GROUND WIRE AND LIGHTNING ROD.
- 12 RESET EXISTING STONE CLADDING IN SAME LOCATION AS REMOVED. INSTALL SPIRAL TIES IN JOINTS EVERY 300mm TO SUIT RANDOM PATTERN OF STONE. SEE DETAIL SHEET A701.
- 13 LIGHT DRESS SANDSTONE CORNERSTONES AND RETOOL EDGES OF NUMBERS. TREAT WITH STONE CONSOLIDATION PRODUCT.
- 14 REPAIR FAILED WINDOW SILLS WITH SAME MATERIAL. ALLOW TO CURE AND COAT WITH CEMENTITIOUS WATERPROOFING COATING. SEE SPECIFICATION.
- 15 TOUCH UP PAINT ON WINDOW FRAMES. ALLOW PAINT AND ADJACENT MORTAR TO DRY/CURE PRIOR TO RE-CAULKING.
- 16 BUILD UP NEW MORTAR CANT. SEE DETAIL SHEET A701.
- 17 LOCATION OF EXISTING CATCHBASIN TO REMAIN.

GENERAL NOTES

1. RE-CAULK AROUND THROUGH WALL PENETRATIONS AFTER FRONT POINTING HAS CURED.
2. RE-INSTALL ONLY THE REQUIRED ACCESSORIES. DO NOT FASTEN THROUGH STONE. USE STAINLESS STEEL FASTENERS UNLESS NOTED OTHERWISE.
3. INSTALL NEW STONE AS REQUIRED. SEE DETAIL A701.
4. ALL MASONRY CLEANING TO BE COMPLETED IN COMPLIANCE WITH SPECIFICATION SECTION 04 03 04.13
5. ALL HOLES RESULTING FROM REMOVAL OF OBSOLETE PINS, PLUGS ETC. TO BE FILLED WITH COLOUR MATCHED MORTAR. ALL PINS, PLUGS TO BE RE-INSTATED ARE TO BE STAINLESS STEEL TO SUIT APPLICATION AND INSTALLED THROUGH MORTAR JOINTS.
6. ALL NEW WOOD MEMBERS TO BE PRIMED ON ALL SIDES AND PAINTED WITH 2 COATS. SEE SPECIFICATION.

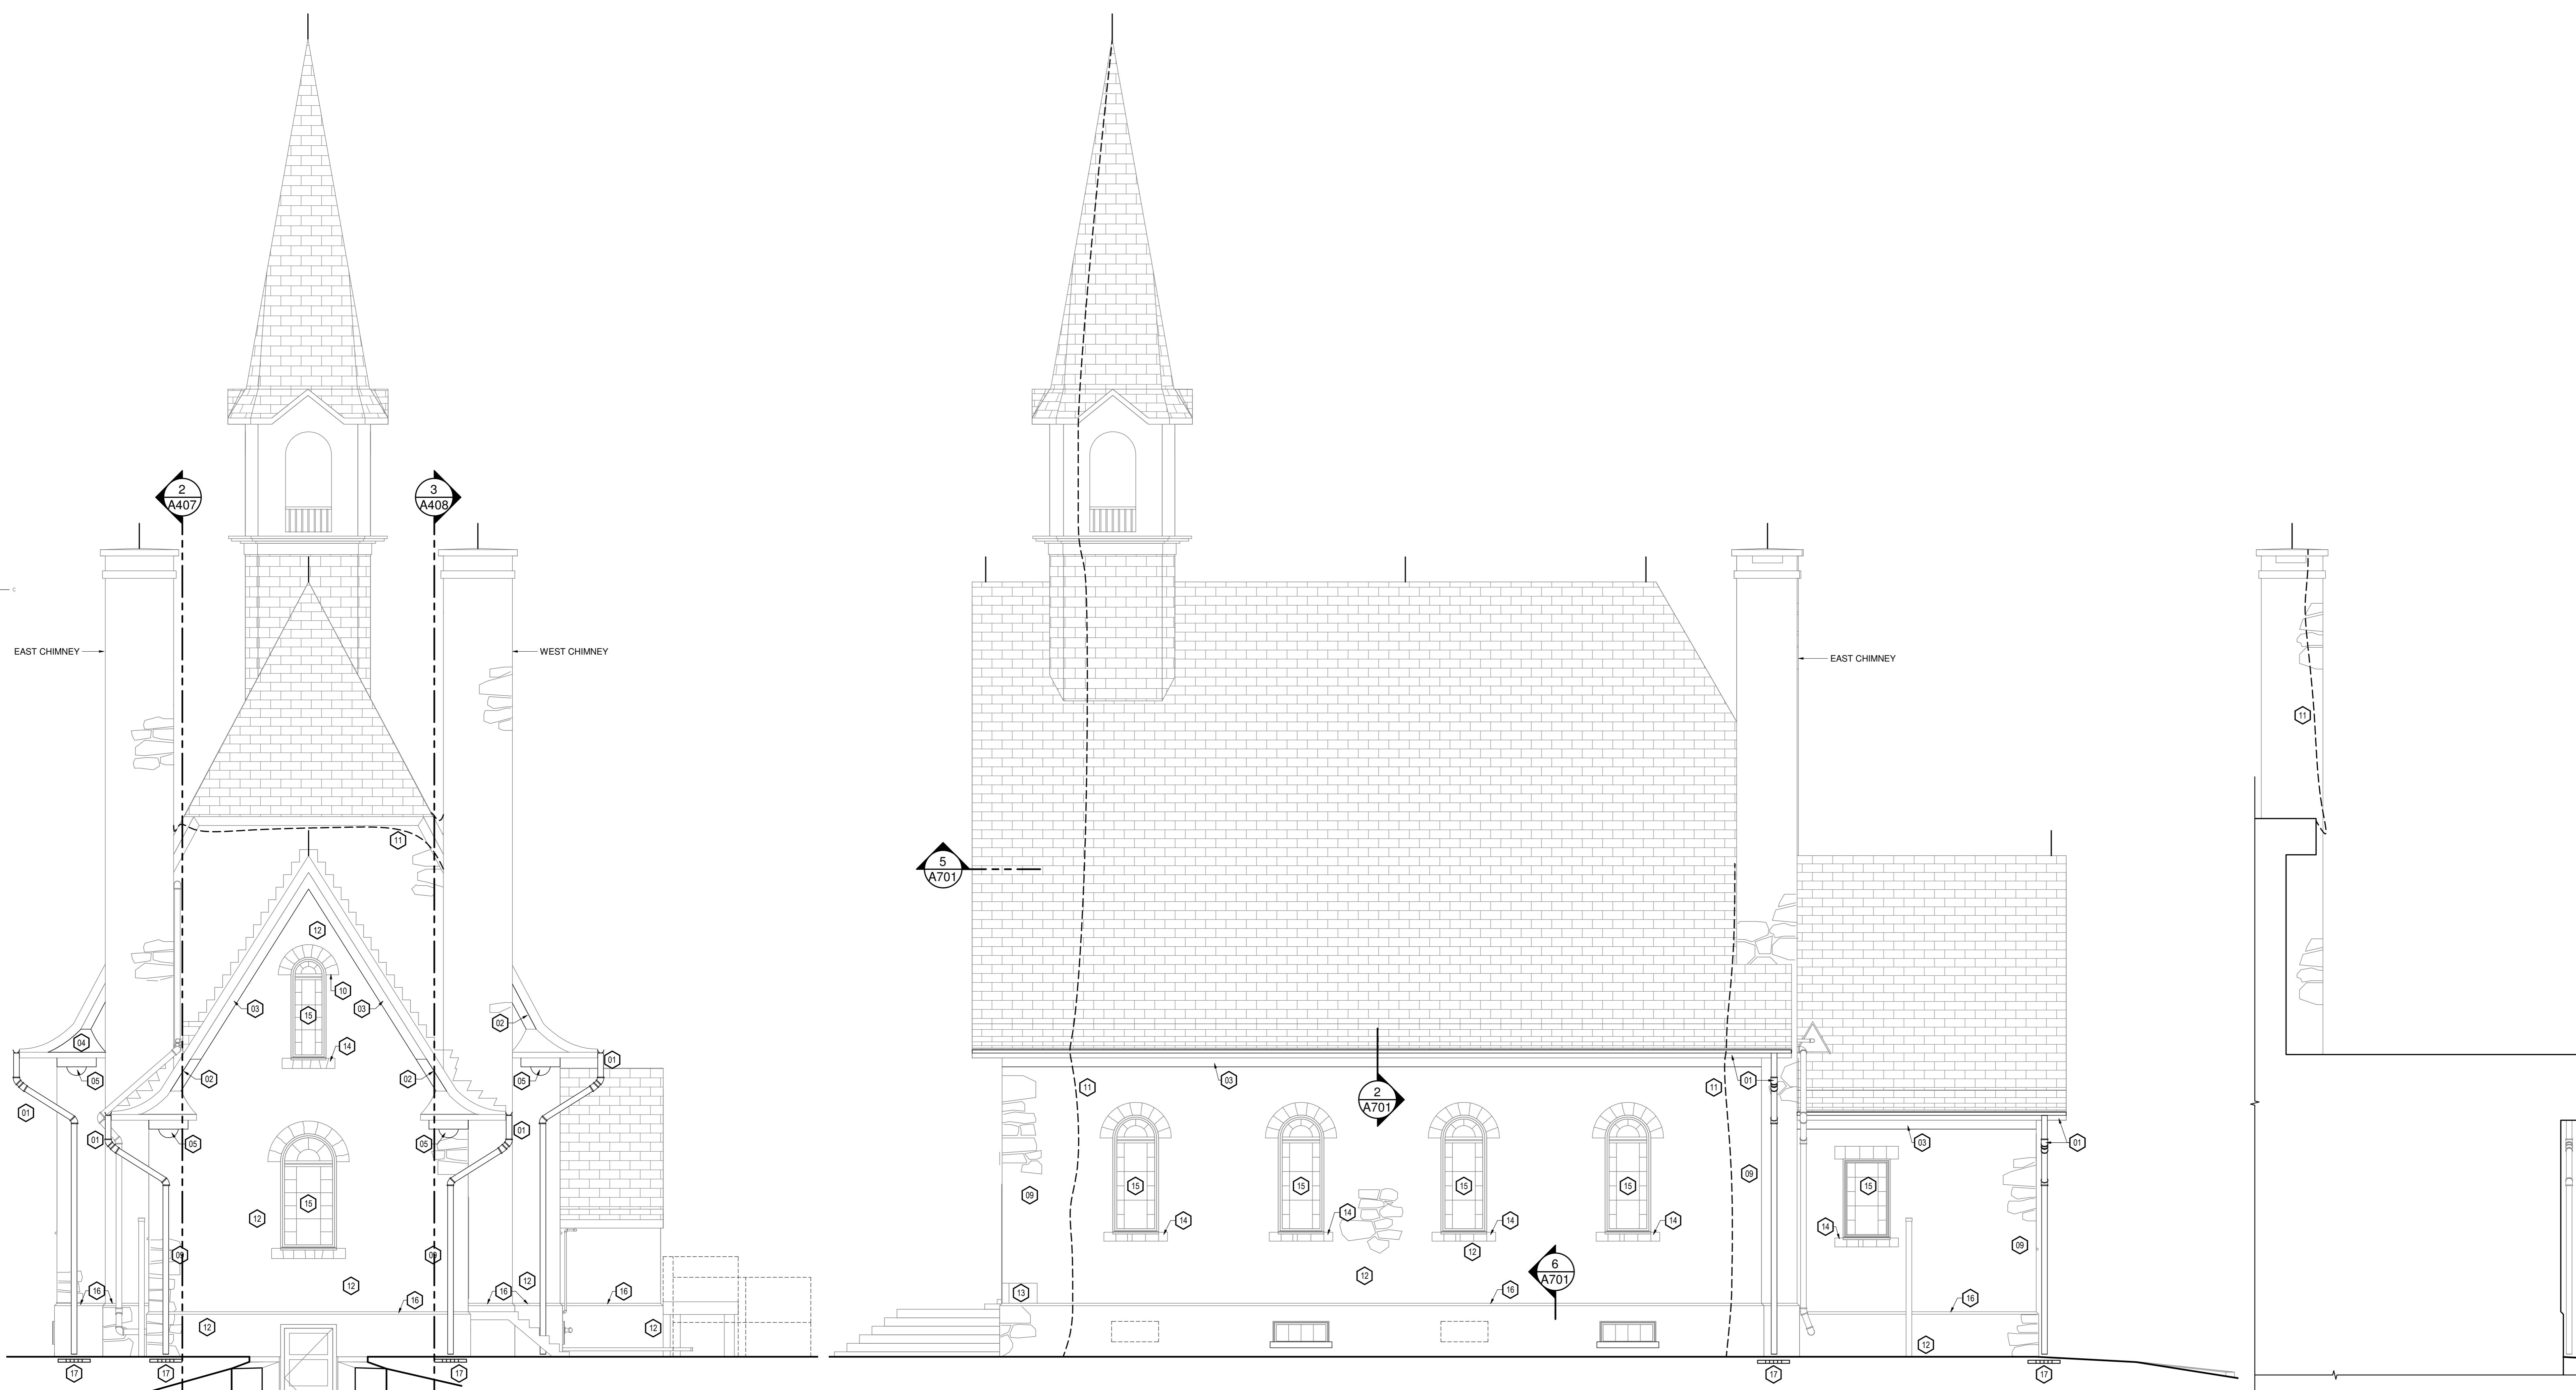

1 NEW NORTH (REAR) ELEVATION
 A408 1:50

2 NEW EAST ELEVATION
 A408 1:50

3 EAST ELEVATION OF WEST CHIMNEY
 A407 1:50




1	ISSUED FOR TENDER	02 APRIL 2020
revisions		date

project
GRAND-PRÉ NATIONAL HISTORIC SITE MEMORIAL CHURCH AND MONUMENTS REPOINTING
 drawing
NEW ELEVATIONS
 dessin


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date	07/10/19
drawn Author	dessiné
date	07/10/19
approved Approver	approuvé
date	07/10/19
Tender	Soumission
PWGSC Project Manager Administrateur de projets TPSGC	no. du projet
project number	1241
drawing no.	A408
no. du dessin	

SCALE: 1:50
 0m 1m 2m 3m 4m 5m

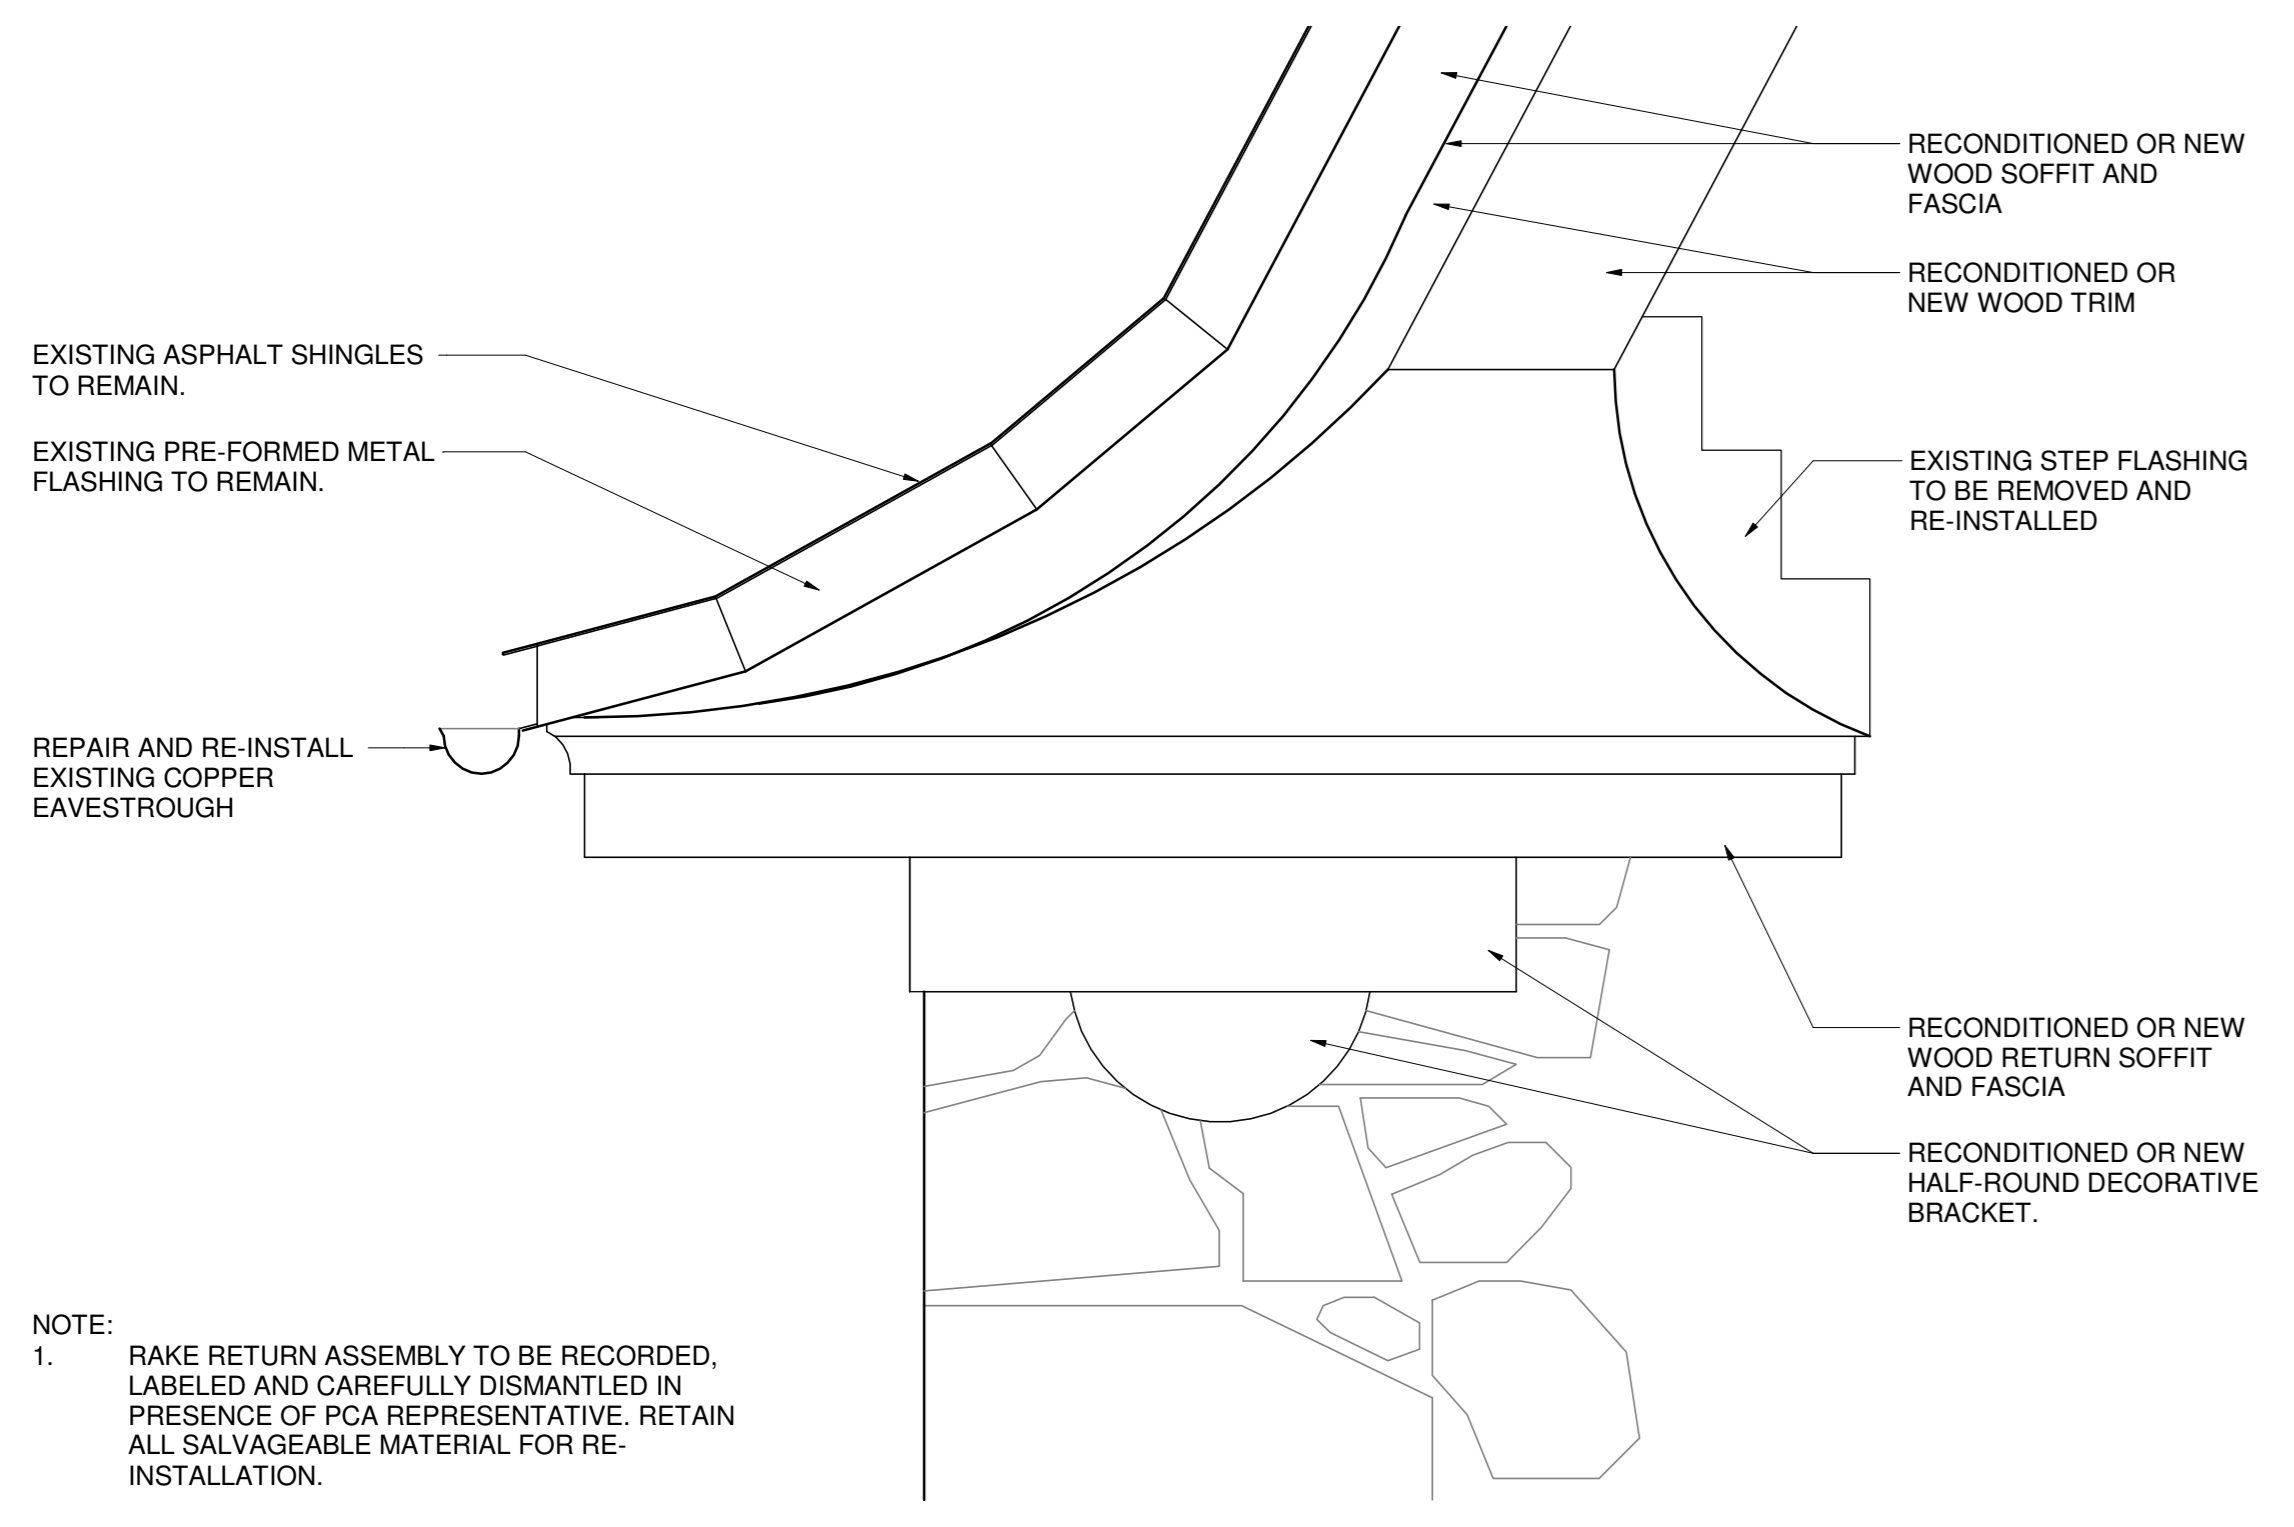

NOTE:
 1. RAKE RETURN ASSEMBLY TO BE RECORDED, LABELED AND CAREFULLY DISMANTLED IN PRESENCE OF PCA REPRESENTATIVE. RETAIN ALL SALVAGEABLE MATERIAL FOR RE-INSTALLATION.


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A407
 TYPICAL RAKE RETURN
 1:10

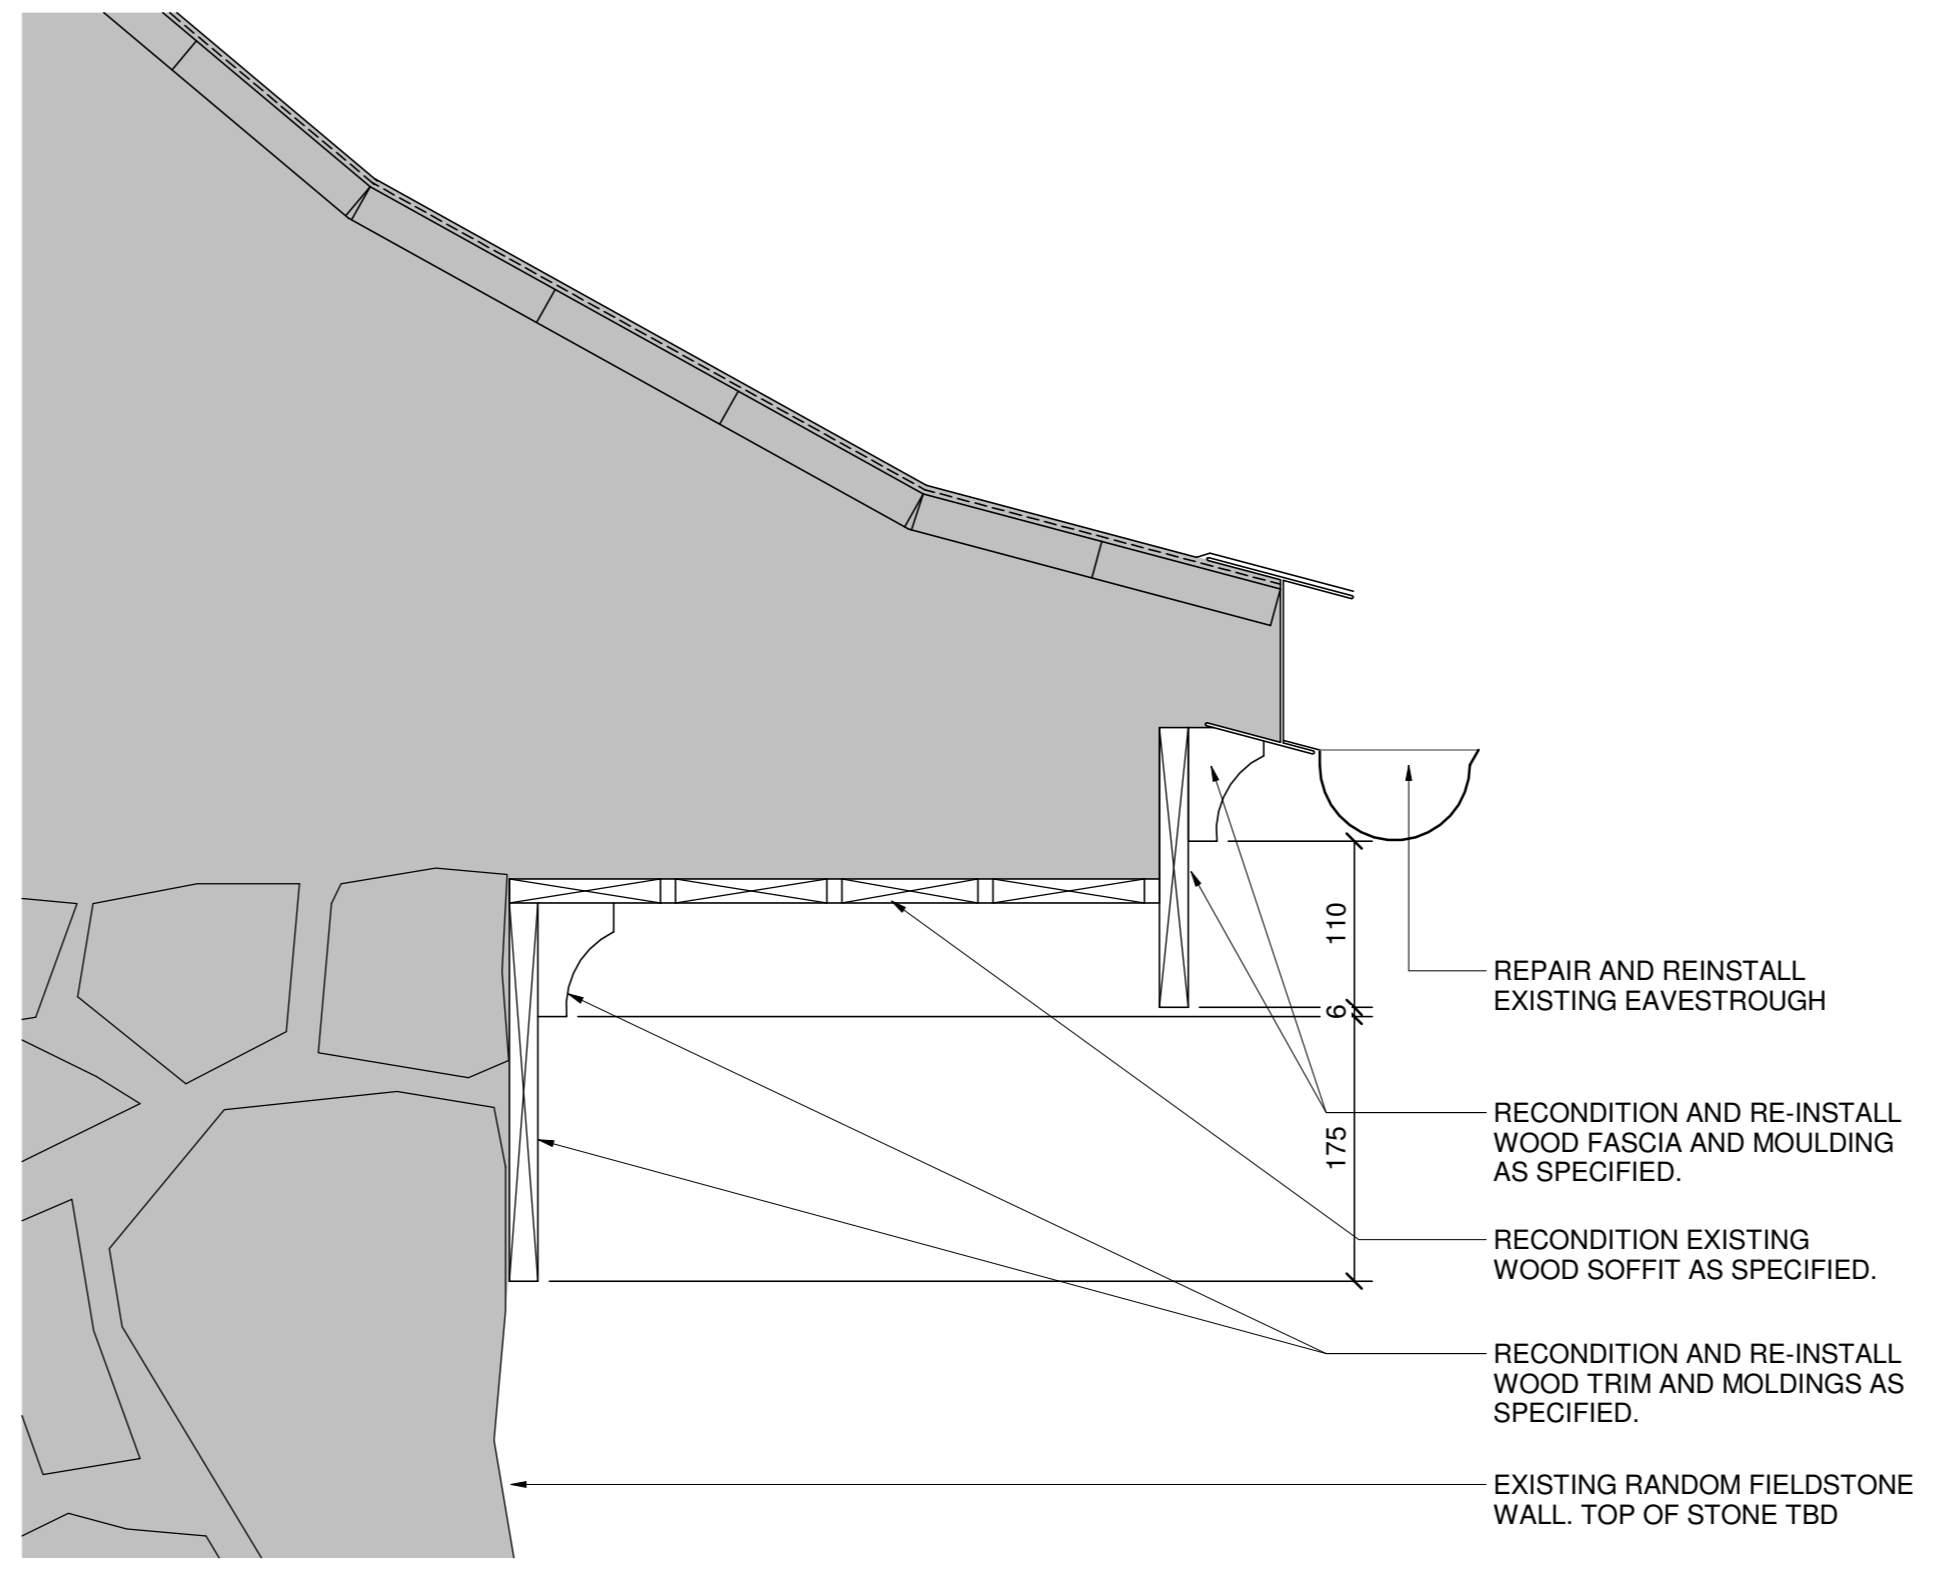

2
A408
 SECTION DETAIL AT SOFFIT
 1:5


GENERAL NOTES

- REPAIR, RE-INSTALL AND REPAINT ALL EXISTING WOOD COMPONENTS.
- WOOD COMPONENTS IN POOR CONDITION TO BE REPLICATED. ALL NEW WOOD MEMBERS TO BE PRIMED ON ALL SIDES AND PAINTED WITH 2 COATS. SEE SPECIFICATION.
- PAINT TO MATCH EXISTING.

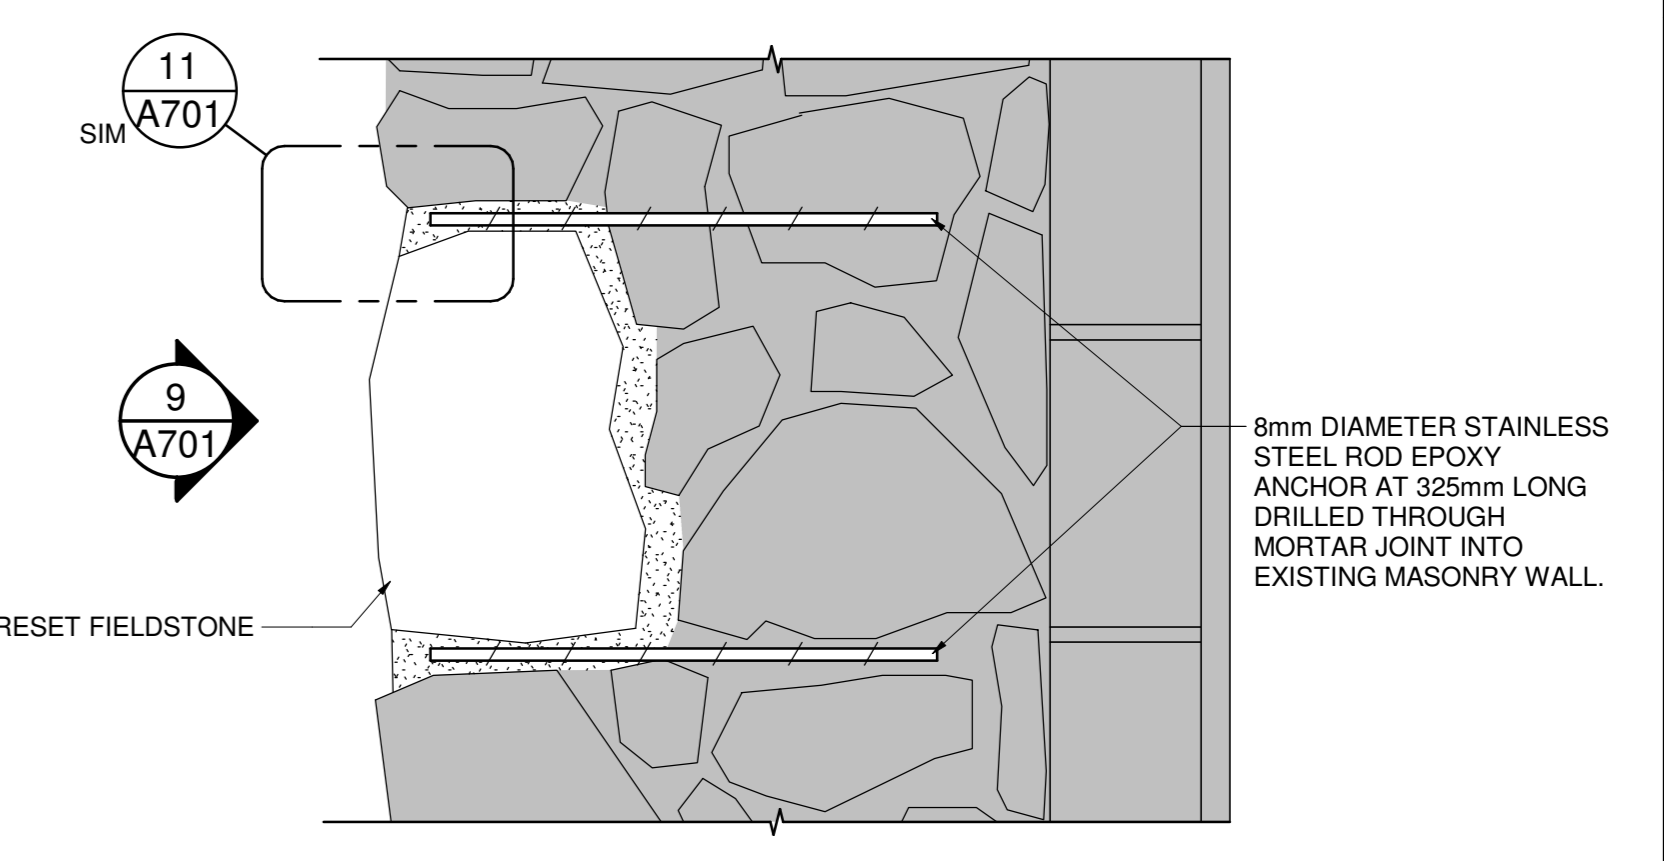


NOTE:
 1. FULLY BOND ALL SIDES OF EXISTING OR NEW STONE TO EXISTING MASONRY WALL. BEDDING MORTAR THICKNESS MAX. 20mm. ALLOW TO CURE BEFORE PLACEMENT OF FRONT POINTING MORTAR.
 2. SHOULD VOID IN EXISTING MASONRY WALL BE REVEALED UPON REMOVAL OF FACE STONE, FILL VOID WITH GROUT AND ALLOW TO CURE BEFORE RE-INSTALLATION / PLACEMENT OF STONE.


3
A701
 SECTION DETAIL OF RESET FIELDSTONE
 1:5

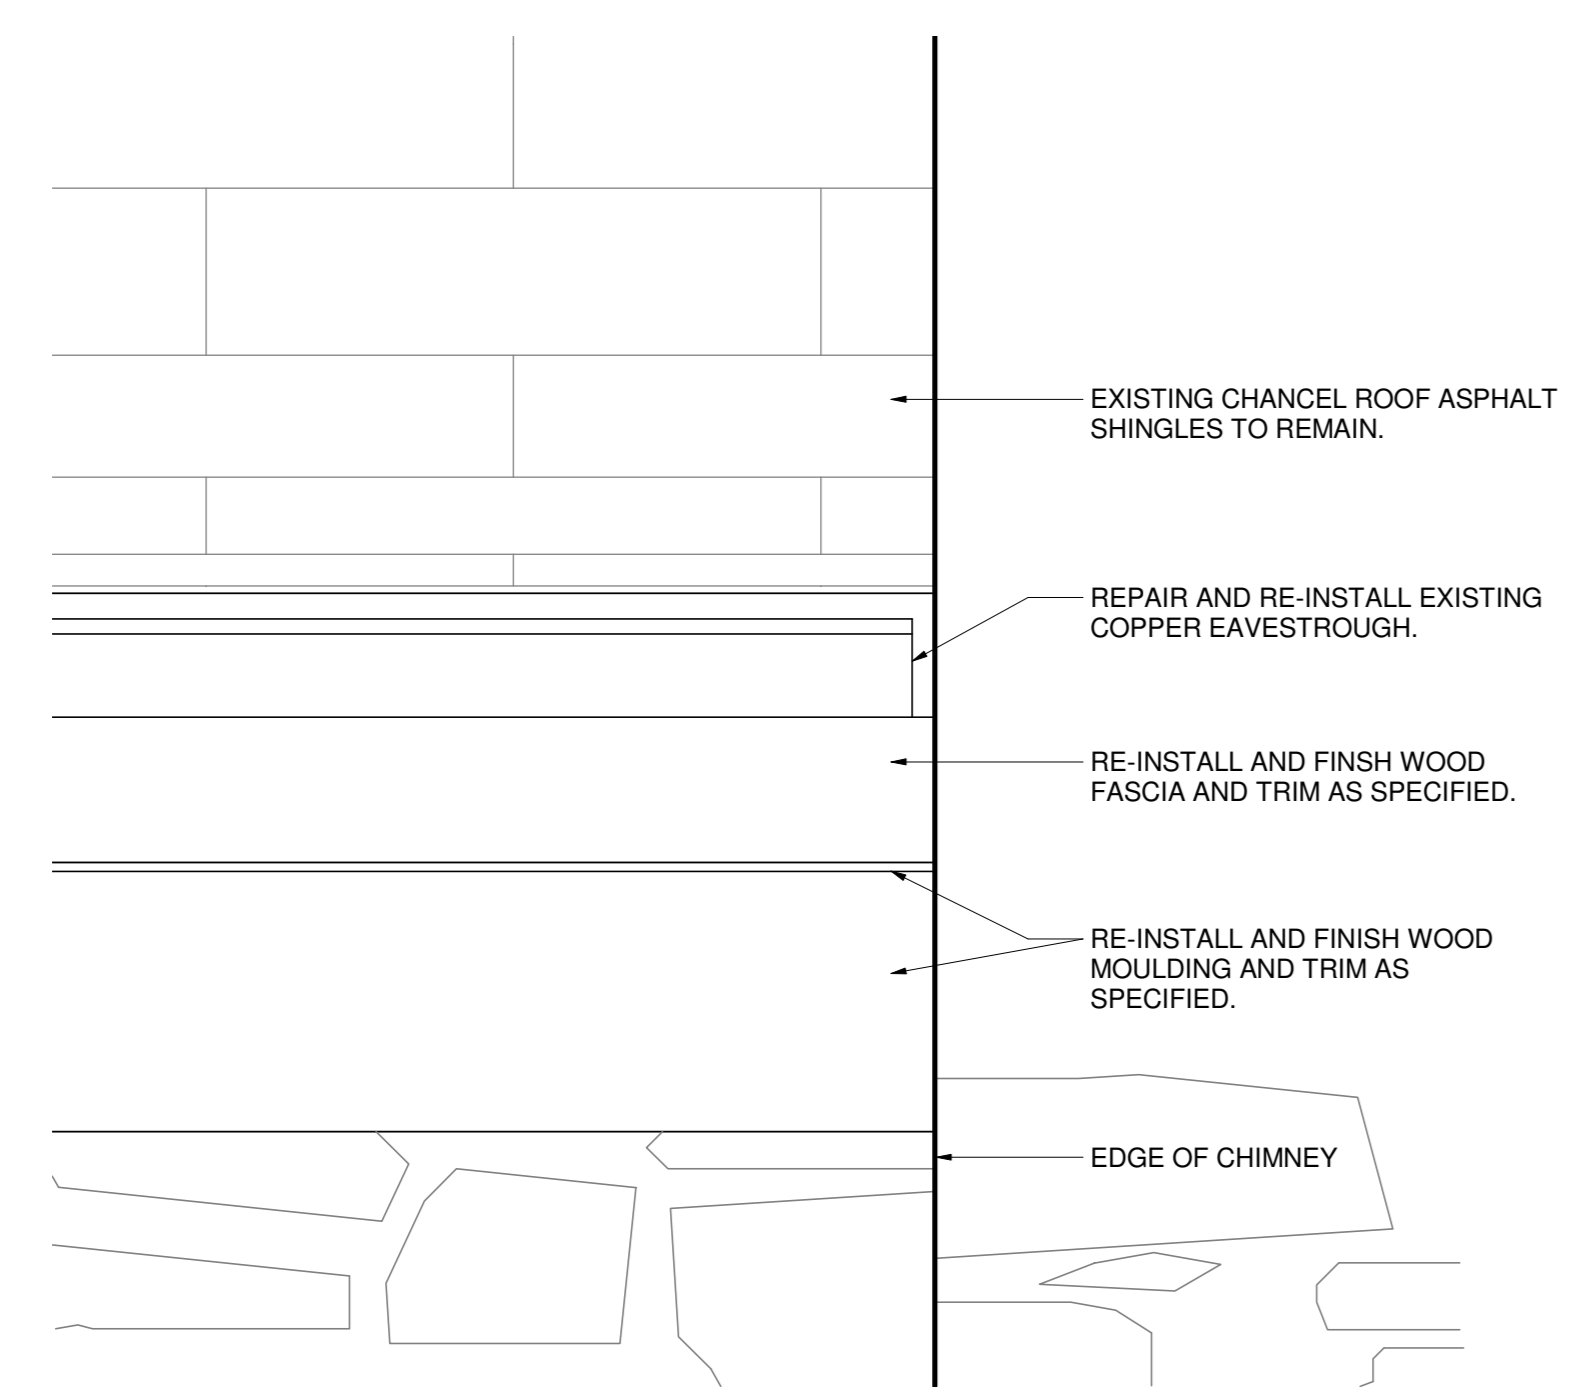


4
A407
 CHANCEL ROOF EDGE AT CHIMNEY
 1:5

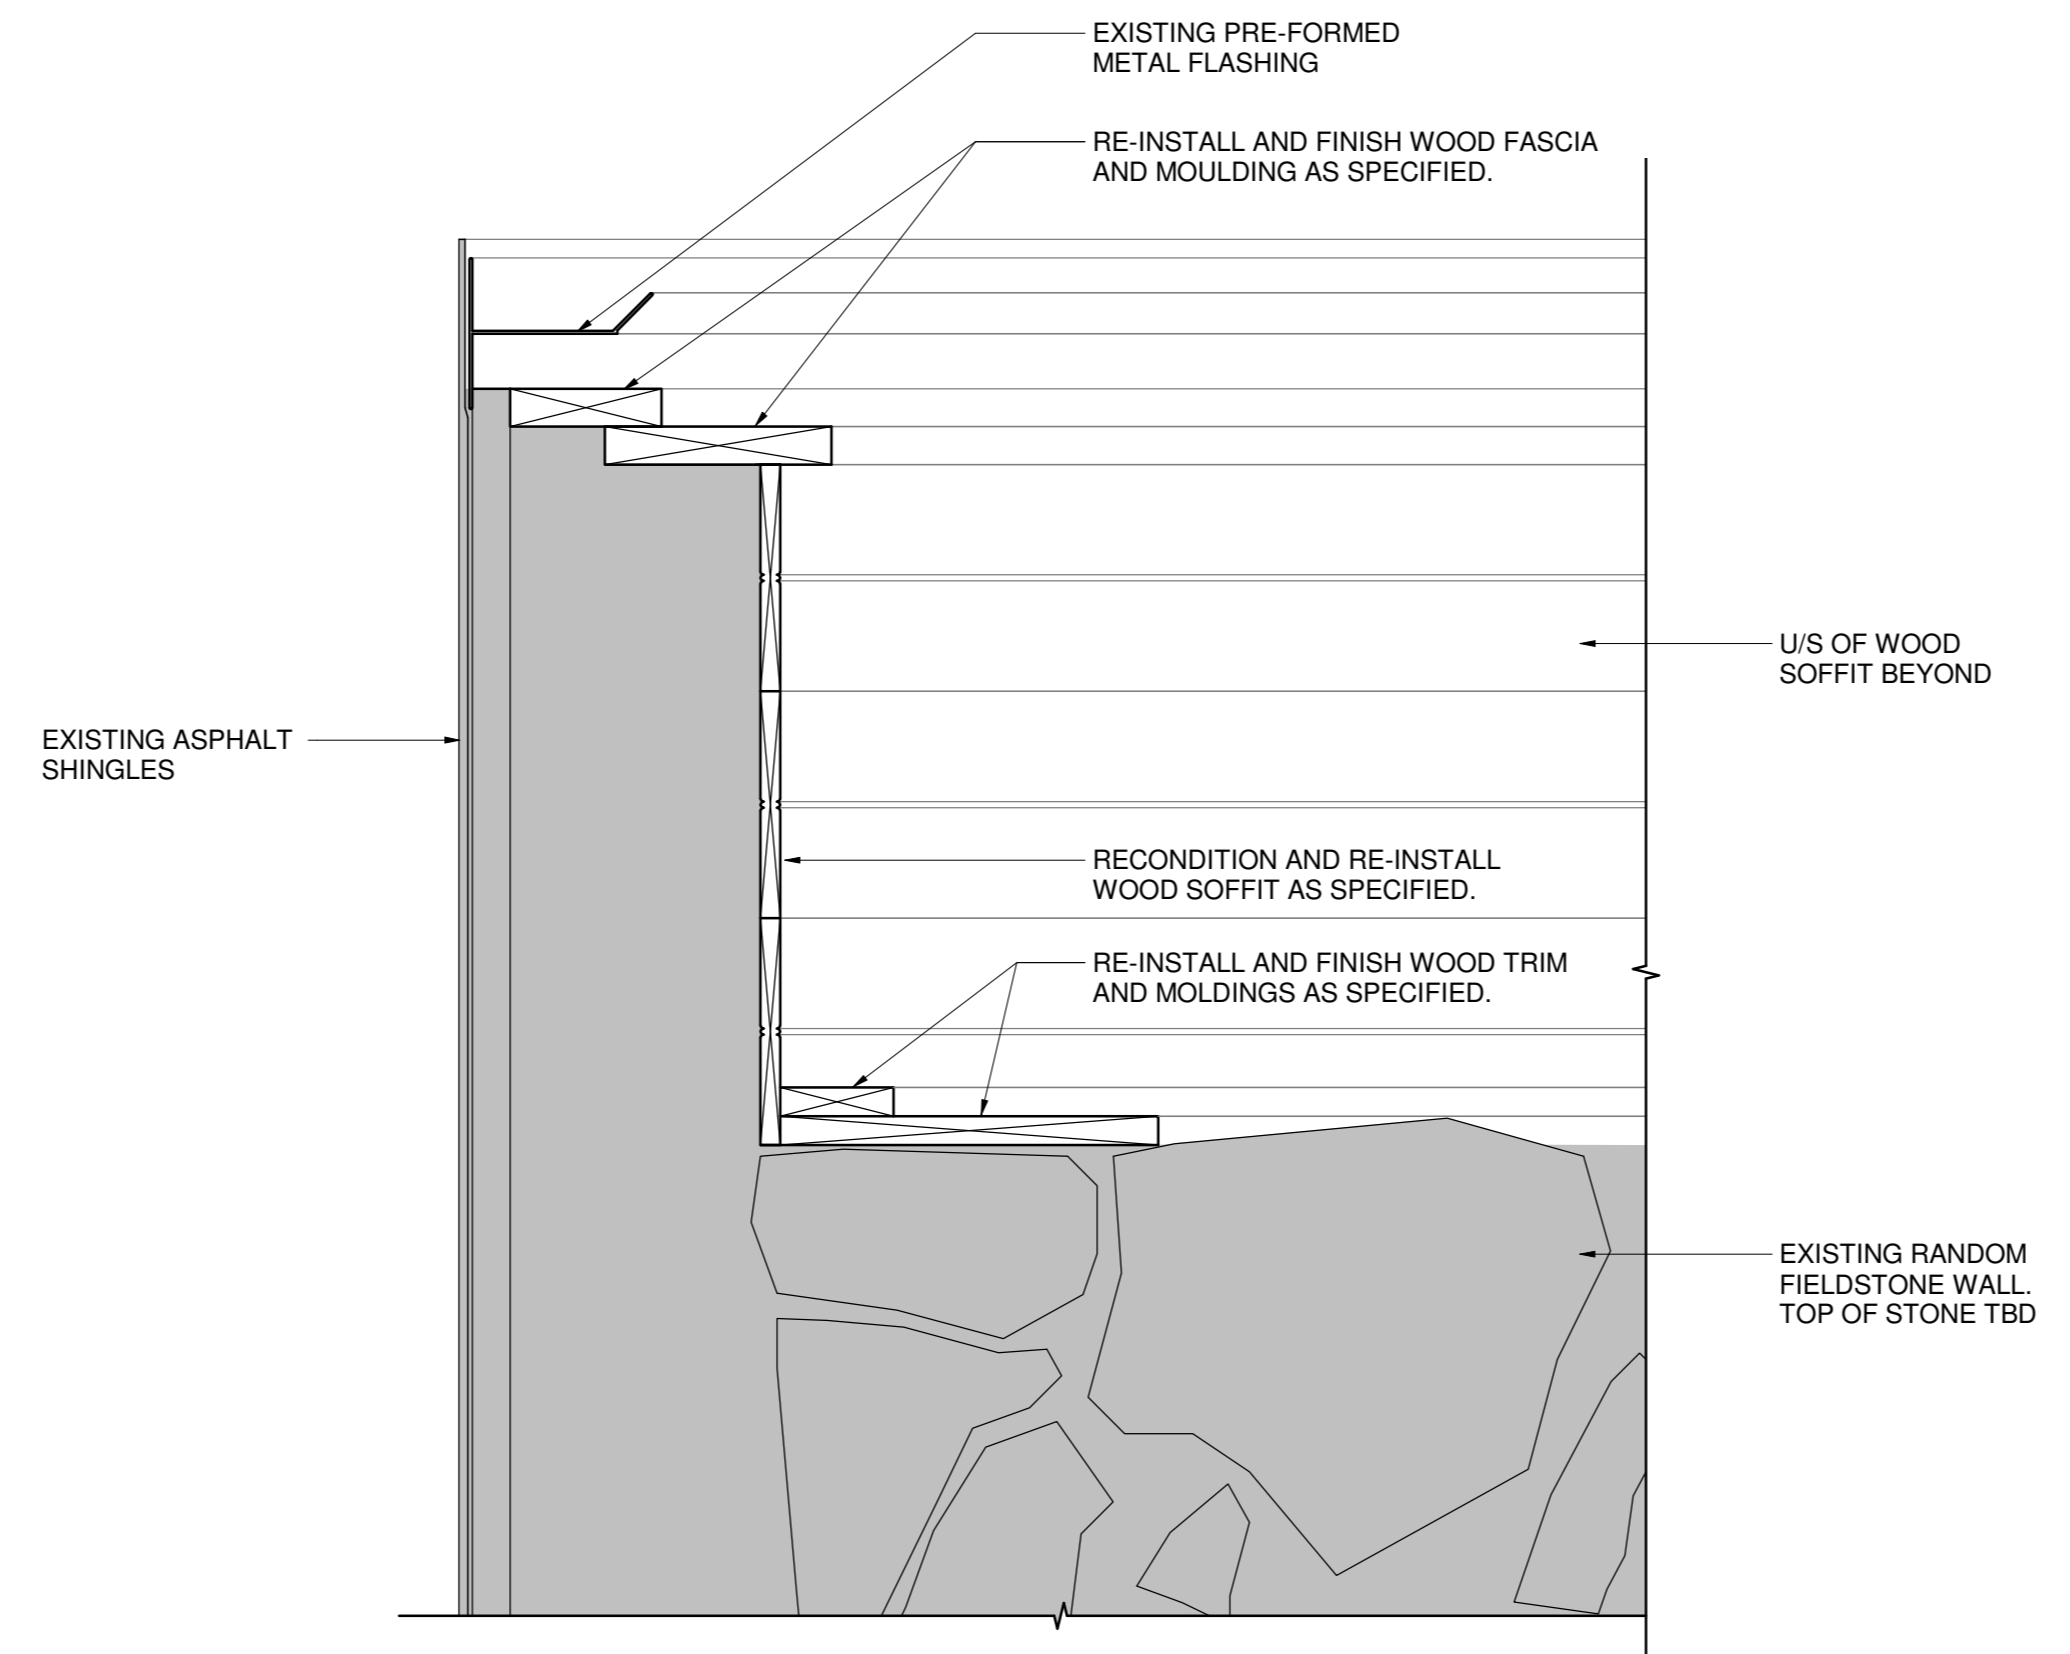


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A407
 SECTION DETAIL AT SOUTH GABLE END ROOF SOFFIT
 1:5

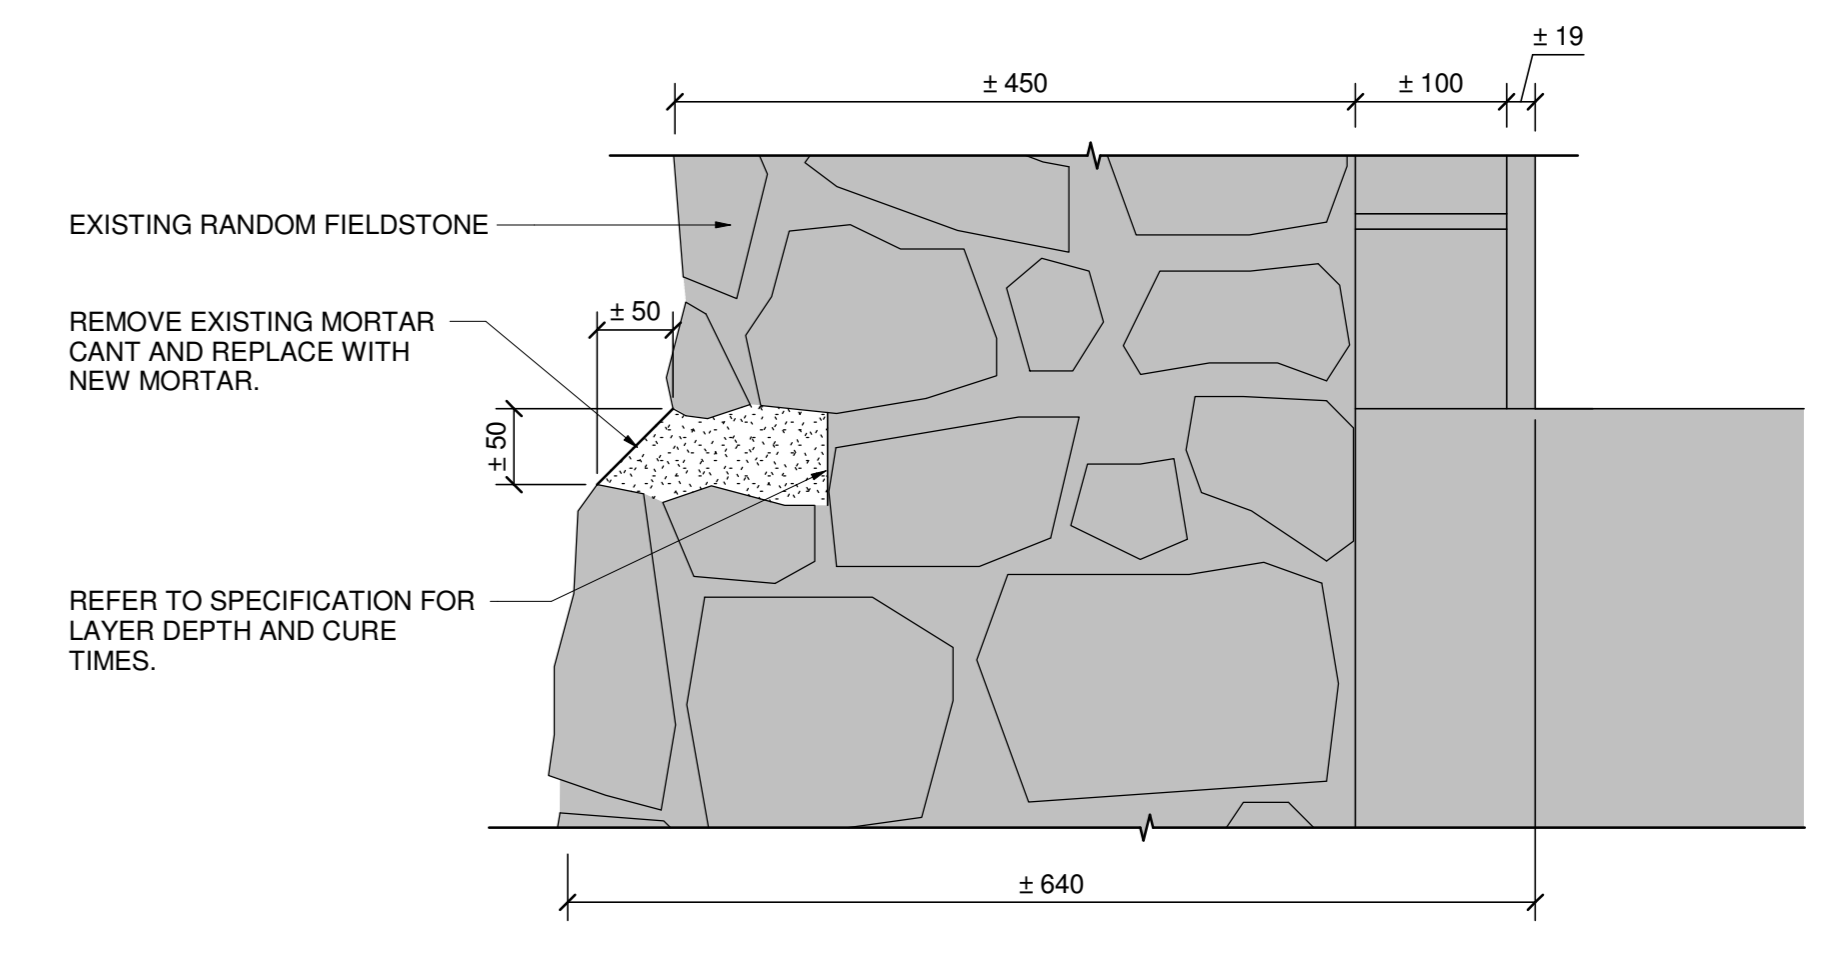


6
A408
 SECTION DETAIL AT MORTAR CANT
 1:5

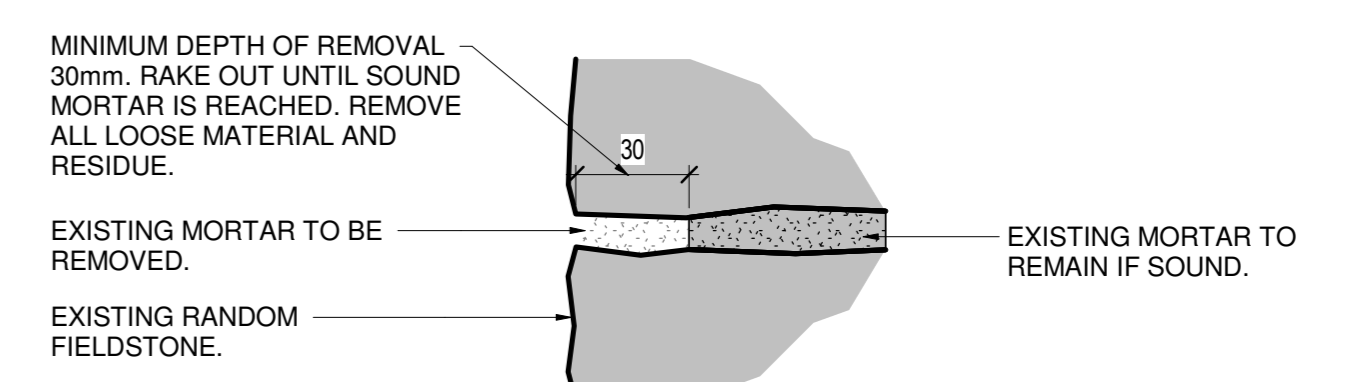


NOTES:
 1. CUT CENTER OF JOINT AND USE HAND TOOLS TO REMOVE REMAINING AS REQUIRED.
 2. ALL CRACKED, DETERIORATED, DEBONDED, AND/OR PORTLAND MORTAR TO BE REMOVED BACK TO SOUND MORTAR.
 3. REMOVE OVER-POINTING MORTAR FROM FACE OF STONE WITHOUT DAMAGING THE STONE AND BY USING HAND TOOLS.
 4. REMOVE ALL CAULKING.
 5. CLEAN OUT JOINTS WITH AIR, OR WASH WITH LOW PRESSURE WATER.

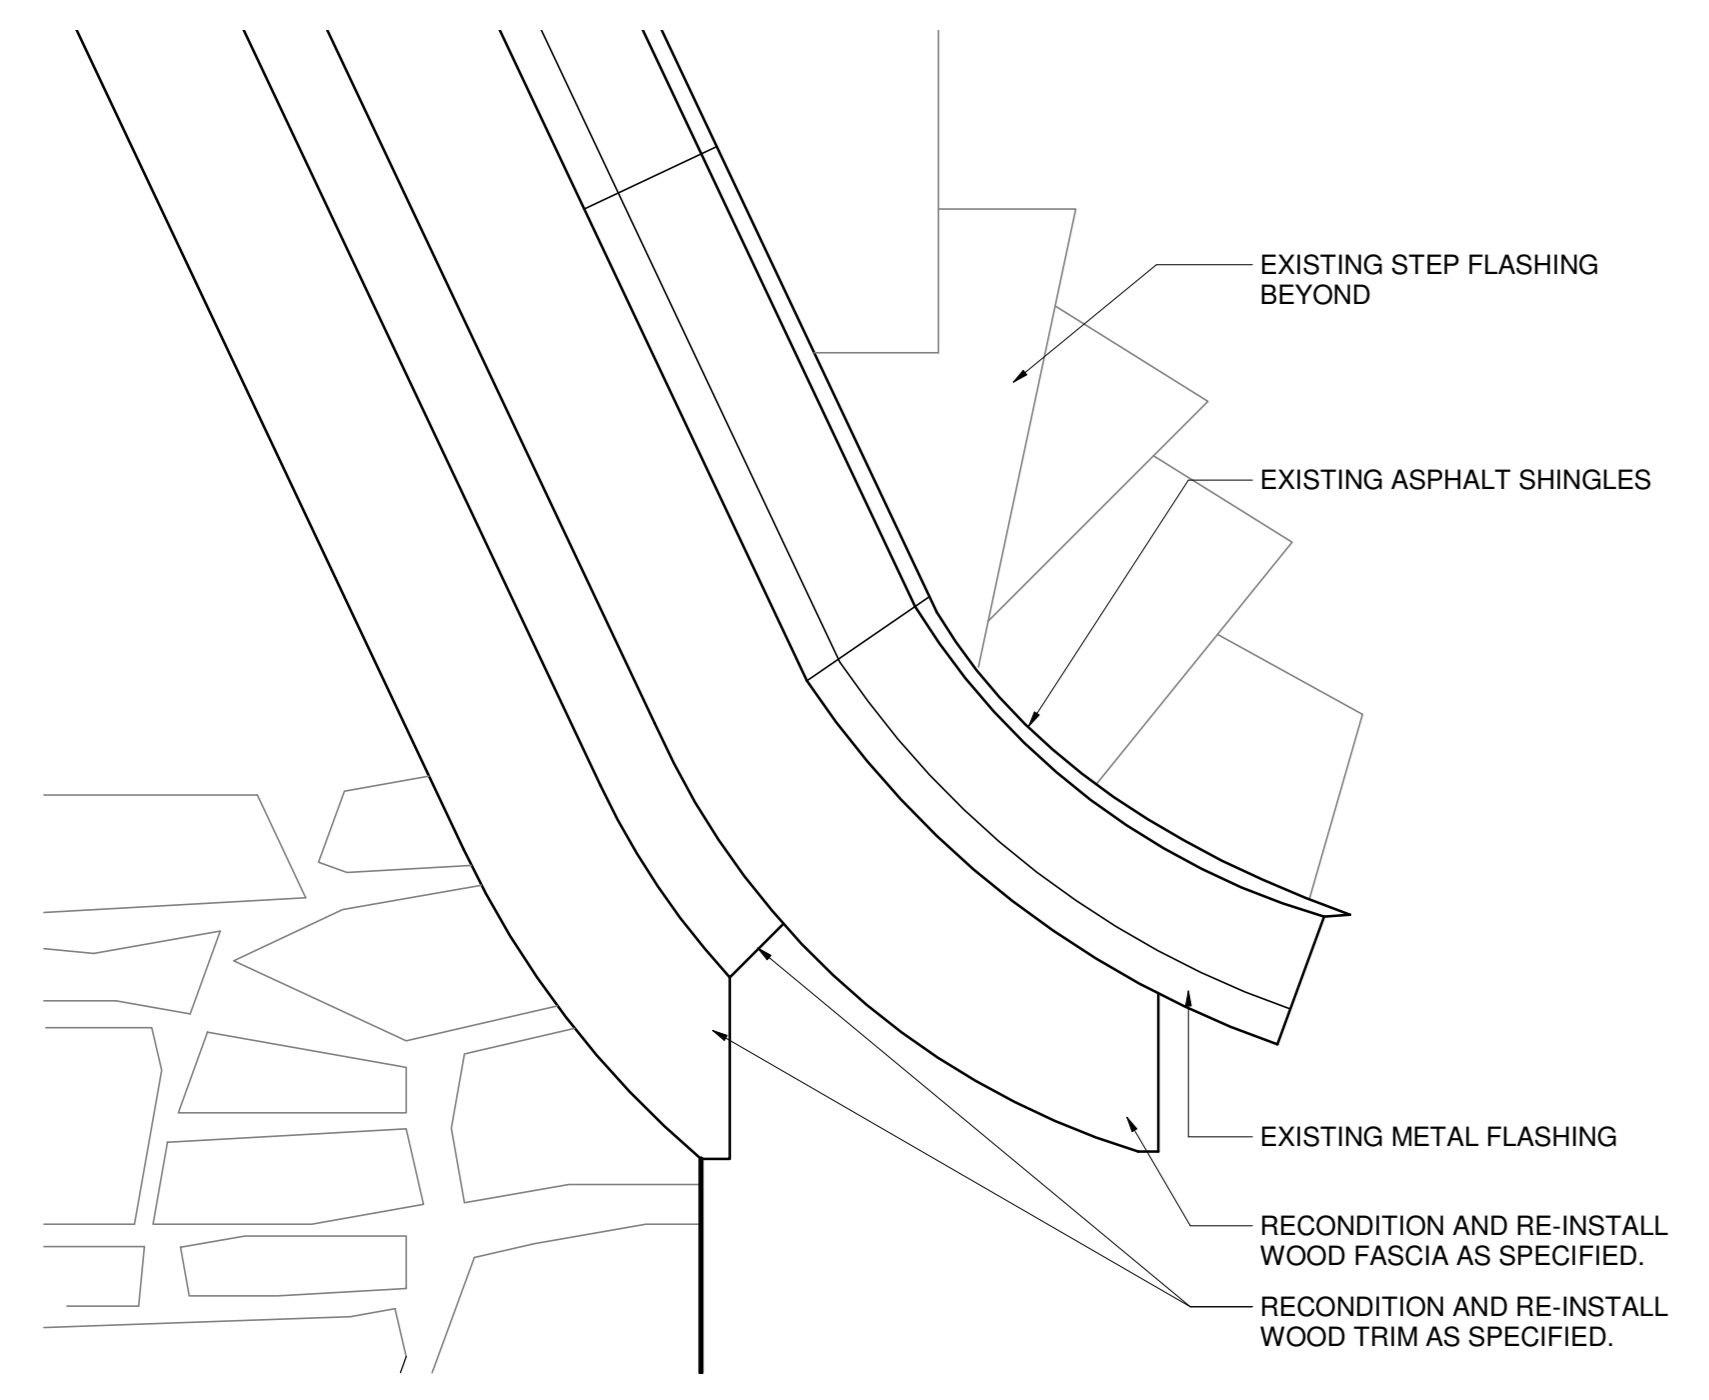

7
A407
 EAST PORCH ROOF EDGE
 1:5

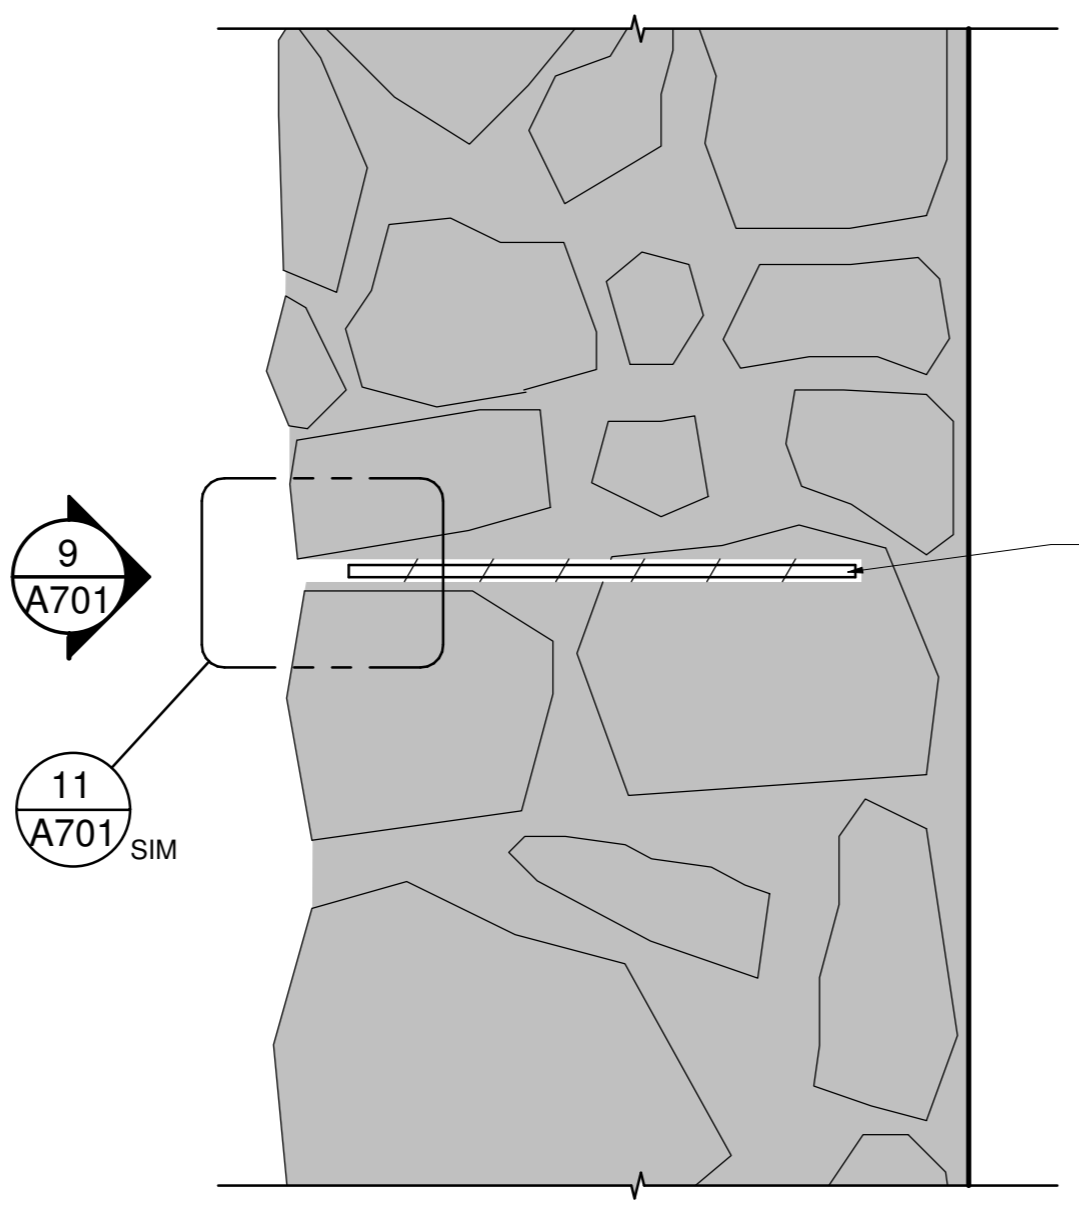


8
A701
 FIELDSTONE RETROFIT ANCHOR DETAIL
 N.T.S.

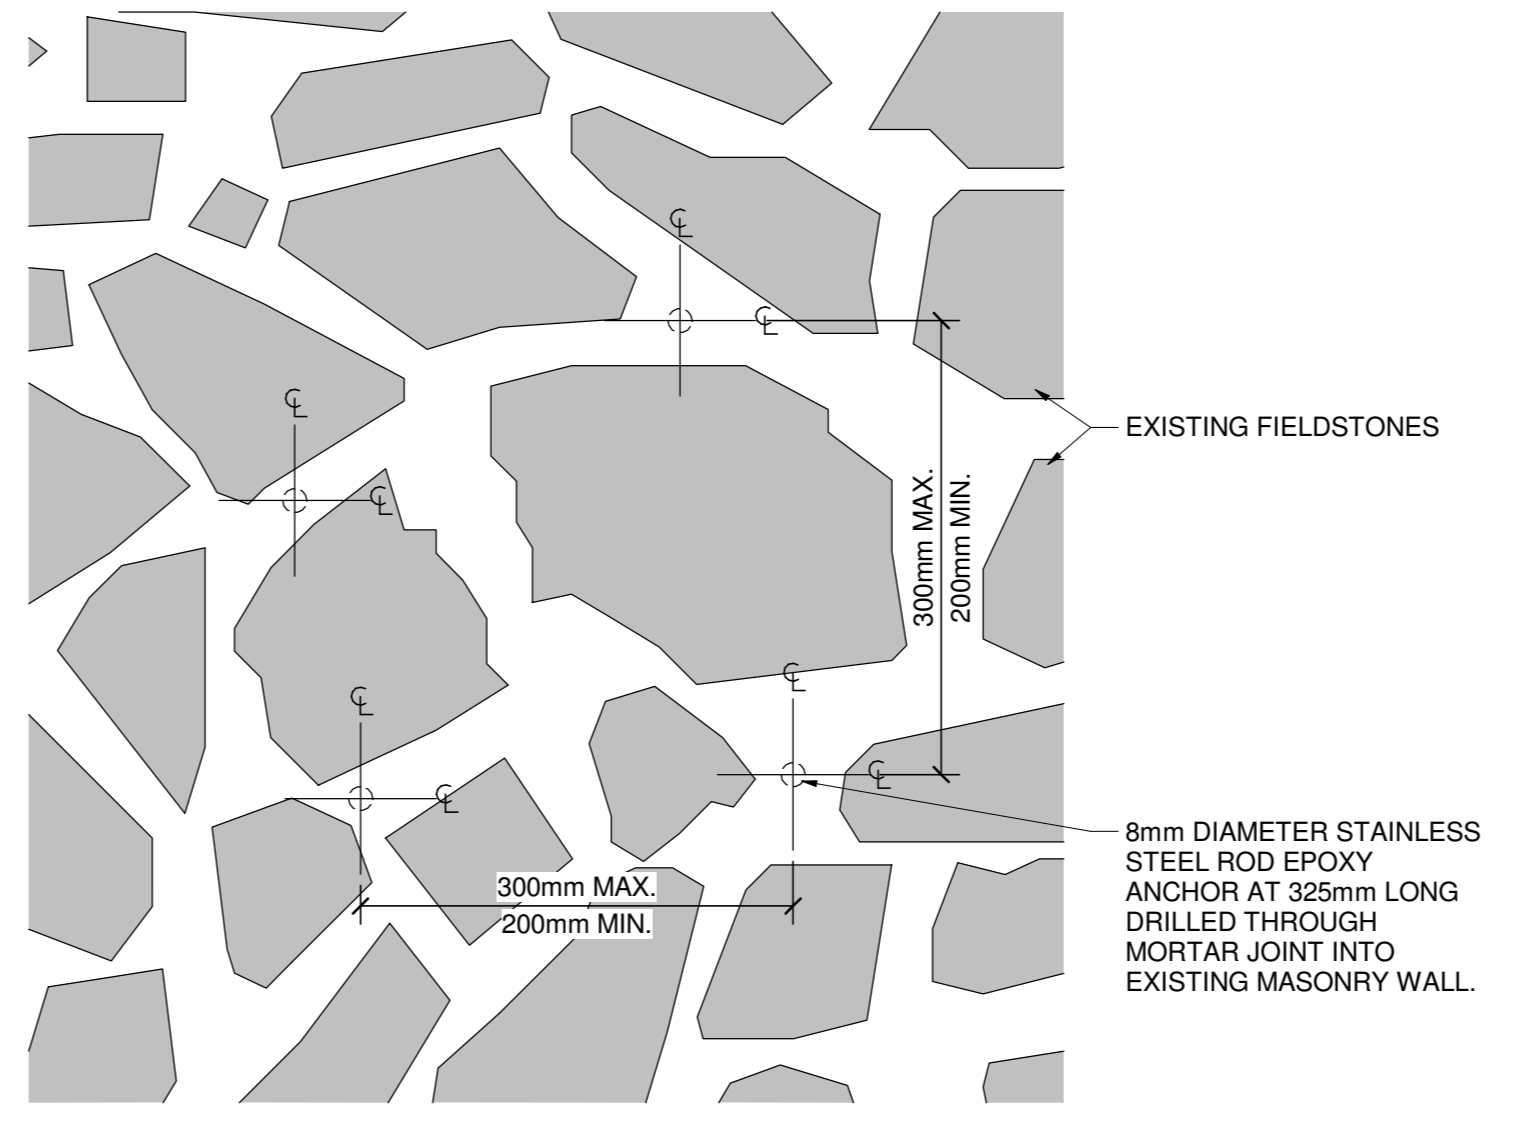


9
A701
 FIELDSTONE RETROFIT ANCHOR ELEVATION
 N.T.S.

10
A701
 TYPICAL RAKING OUT DETAIL
 N.T.S.

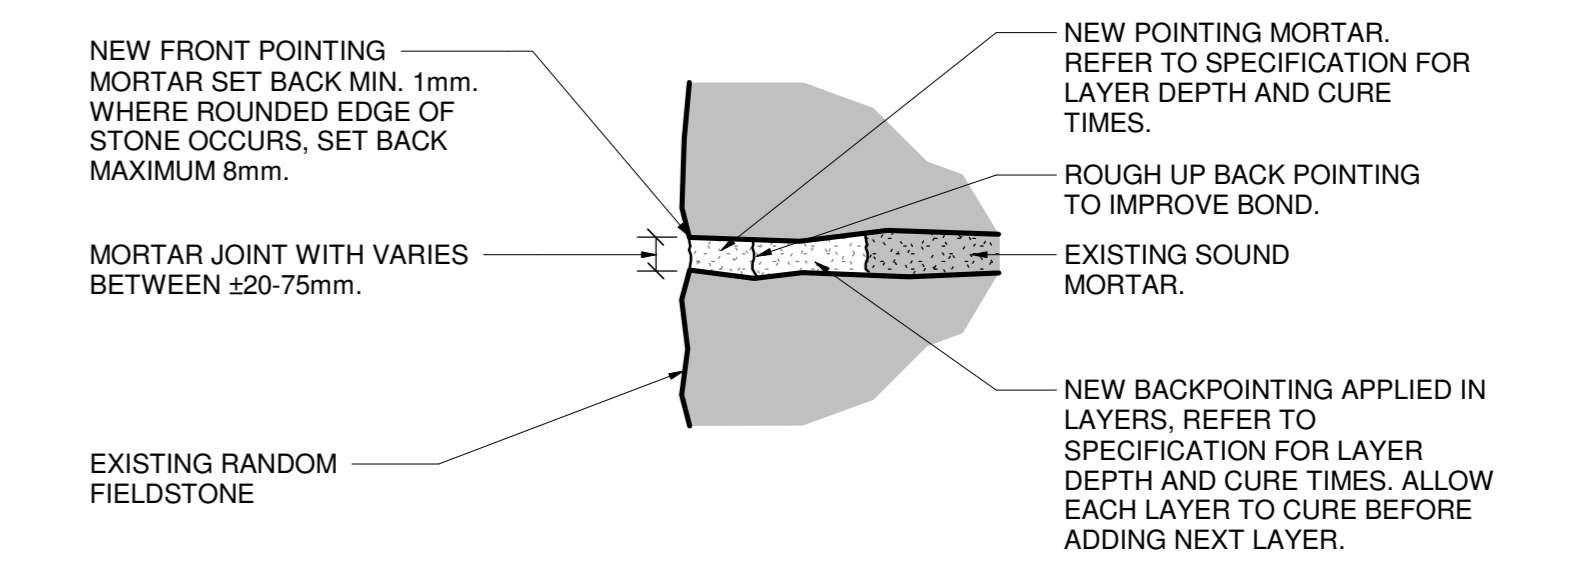

NOTES:
 1. CAREFULLY RAKE OUT AND CLEAN JOINT TO BE FREE OF LOOSE MATERIAL AND DUST.
 2. MAKE MASONRY REPAIRS PRIOR TO POINTING.
 3. DAMPEN STONE BEFORE POINTING TO IMPROVE BOND BETWEEN STONE AND MORTAR.
 4. DEEP VOIDS TO BE FILLED WITH MORTAR.
 5. FACE POINTING: COMPACT AND TOOL JOINT TO FLUSH PROFILE. REMOVE EXCESS MORTAR FROM FACE OF STONE. KEEP MOIST AND PROTECT PER MANUFACTURERS SPECIFICATIONS.

11
A701
 TYPICAL REPOINTING DETAIL
 N.T.S.



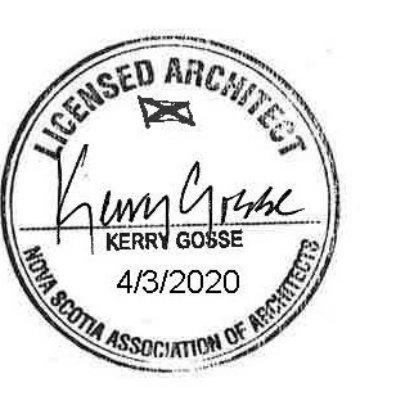


1	ISSUED FOR TENDER	02 APRIL 2020
revisions		date

project
 GRAND-PRÉ NATIONAL HISTORIC SITE
 MEMORIAL CHURCH AND MONUMENTS REPOINTING

drawing
 SECTIONS AND DETAILS

designed Designer	conpu
date	06/18/19
drawn	LL
date	06/18/19
approved Approver	approved
date	06/18/19
Tender	Submission
PWGSC Project Manager	Administrateur de projets TPSCG
project number	no. du projet
	1241
drawing no.	no. du dessin
	A701

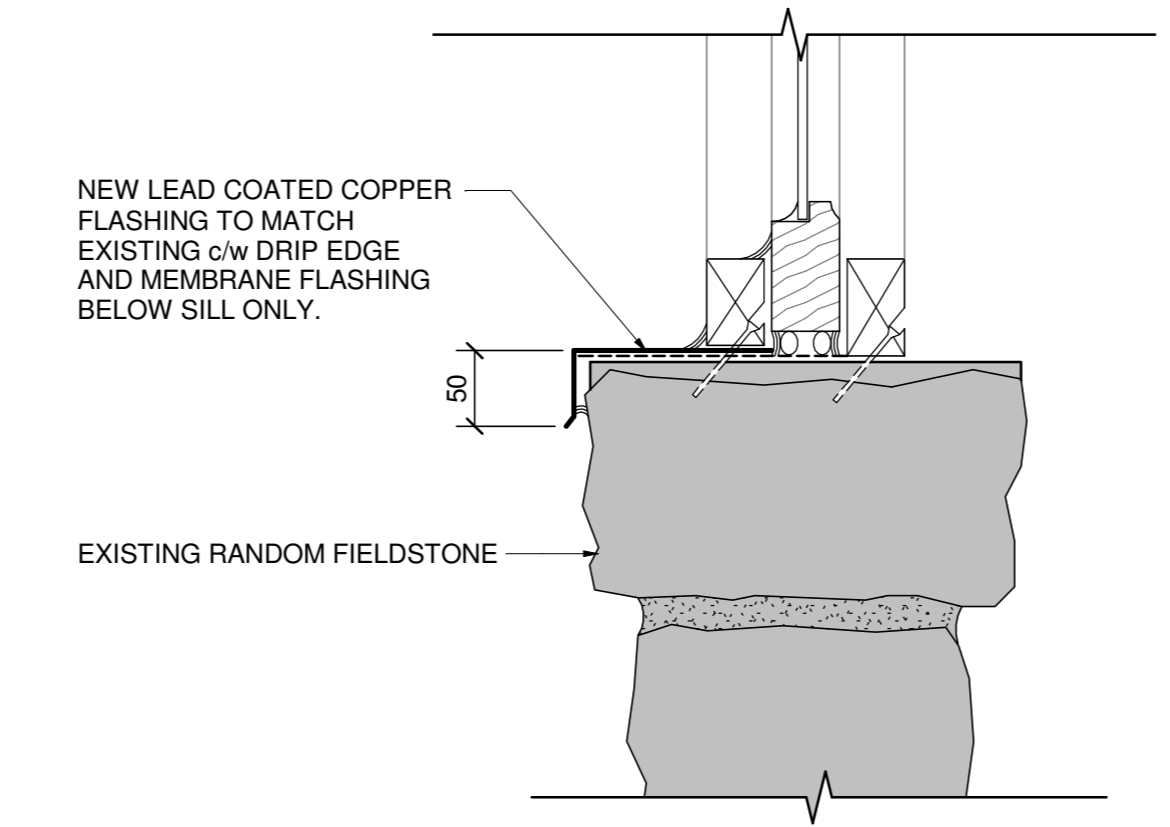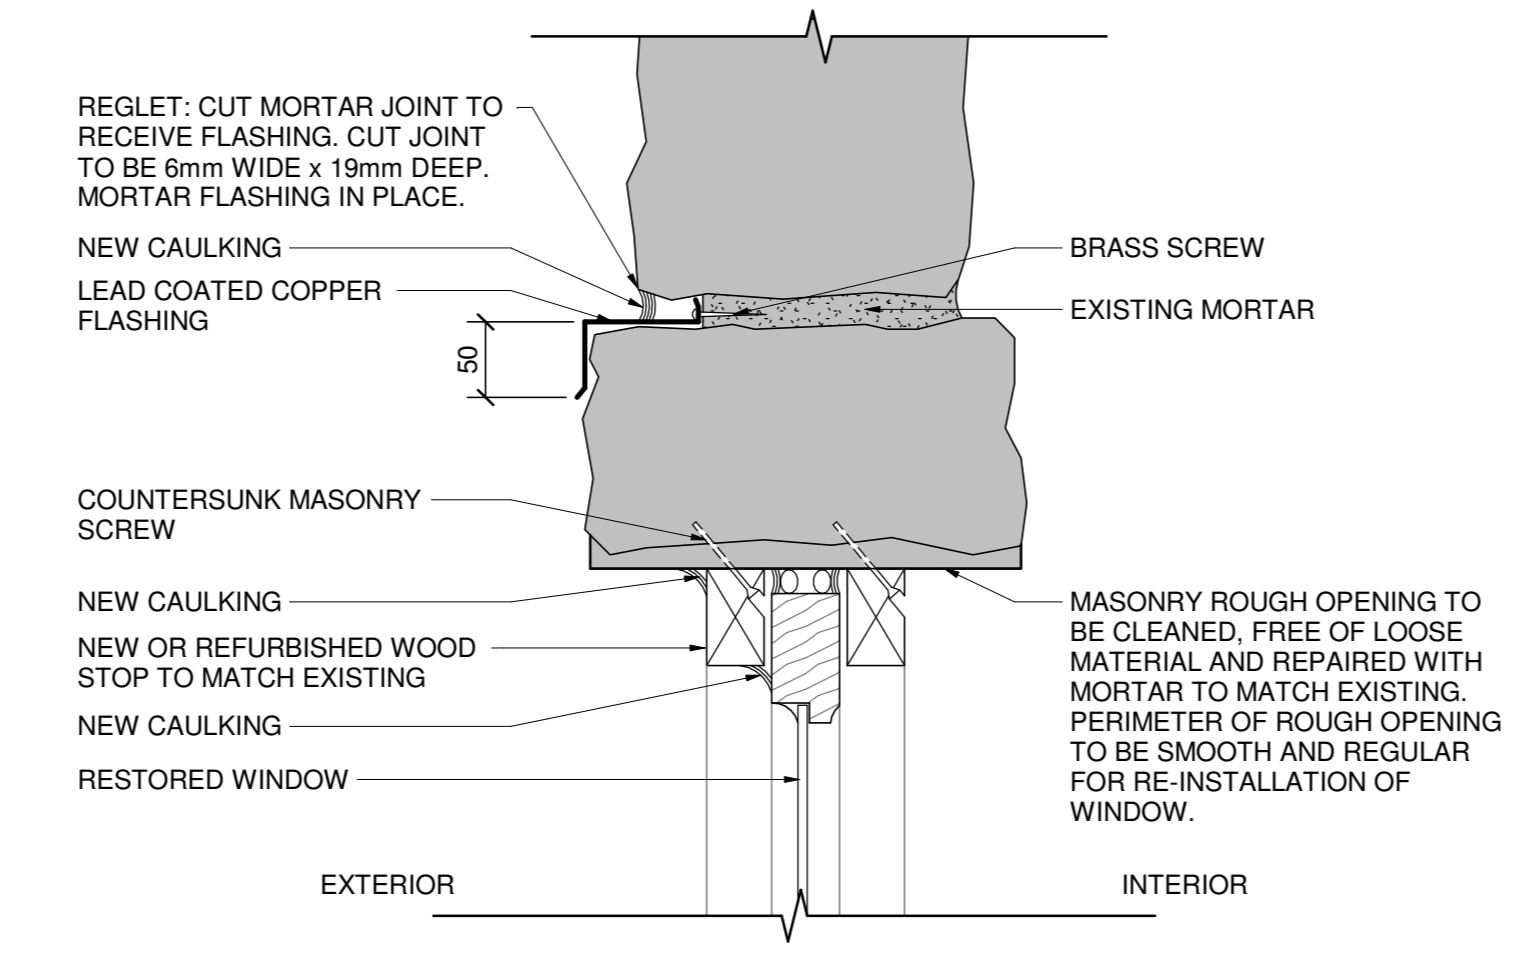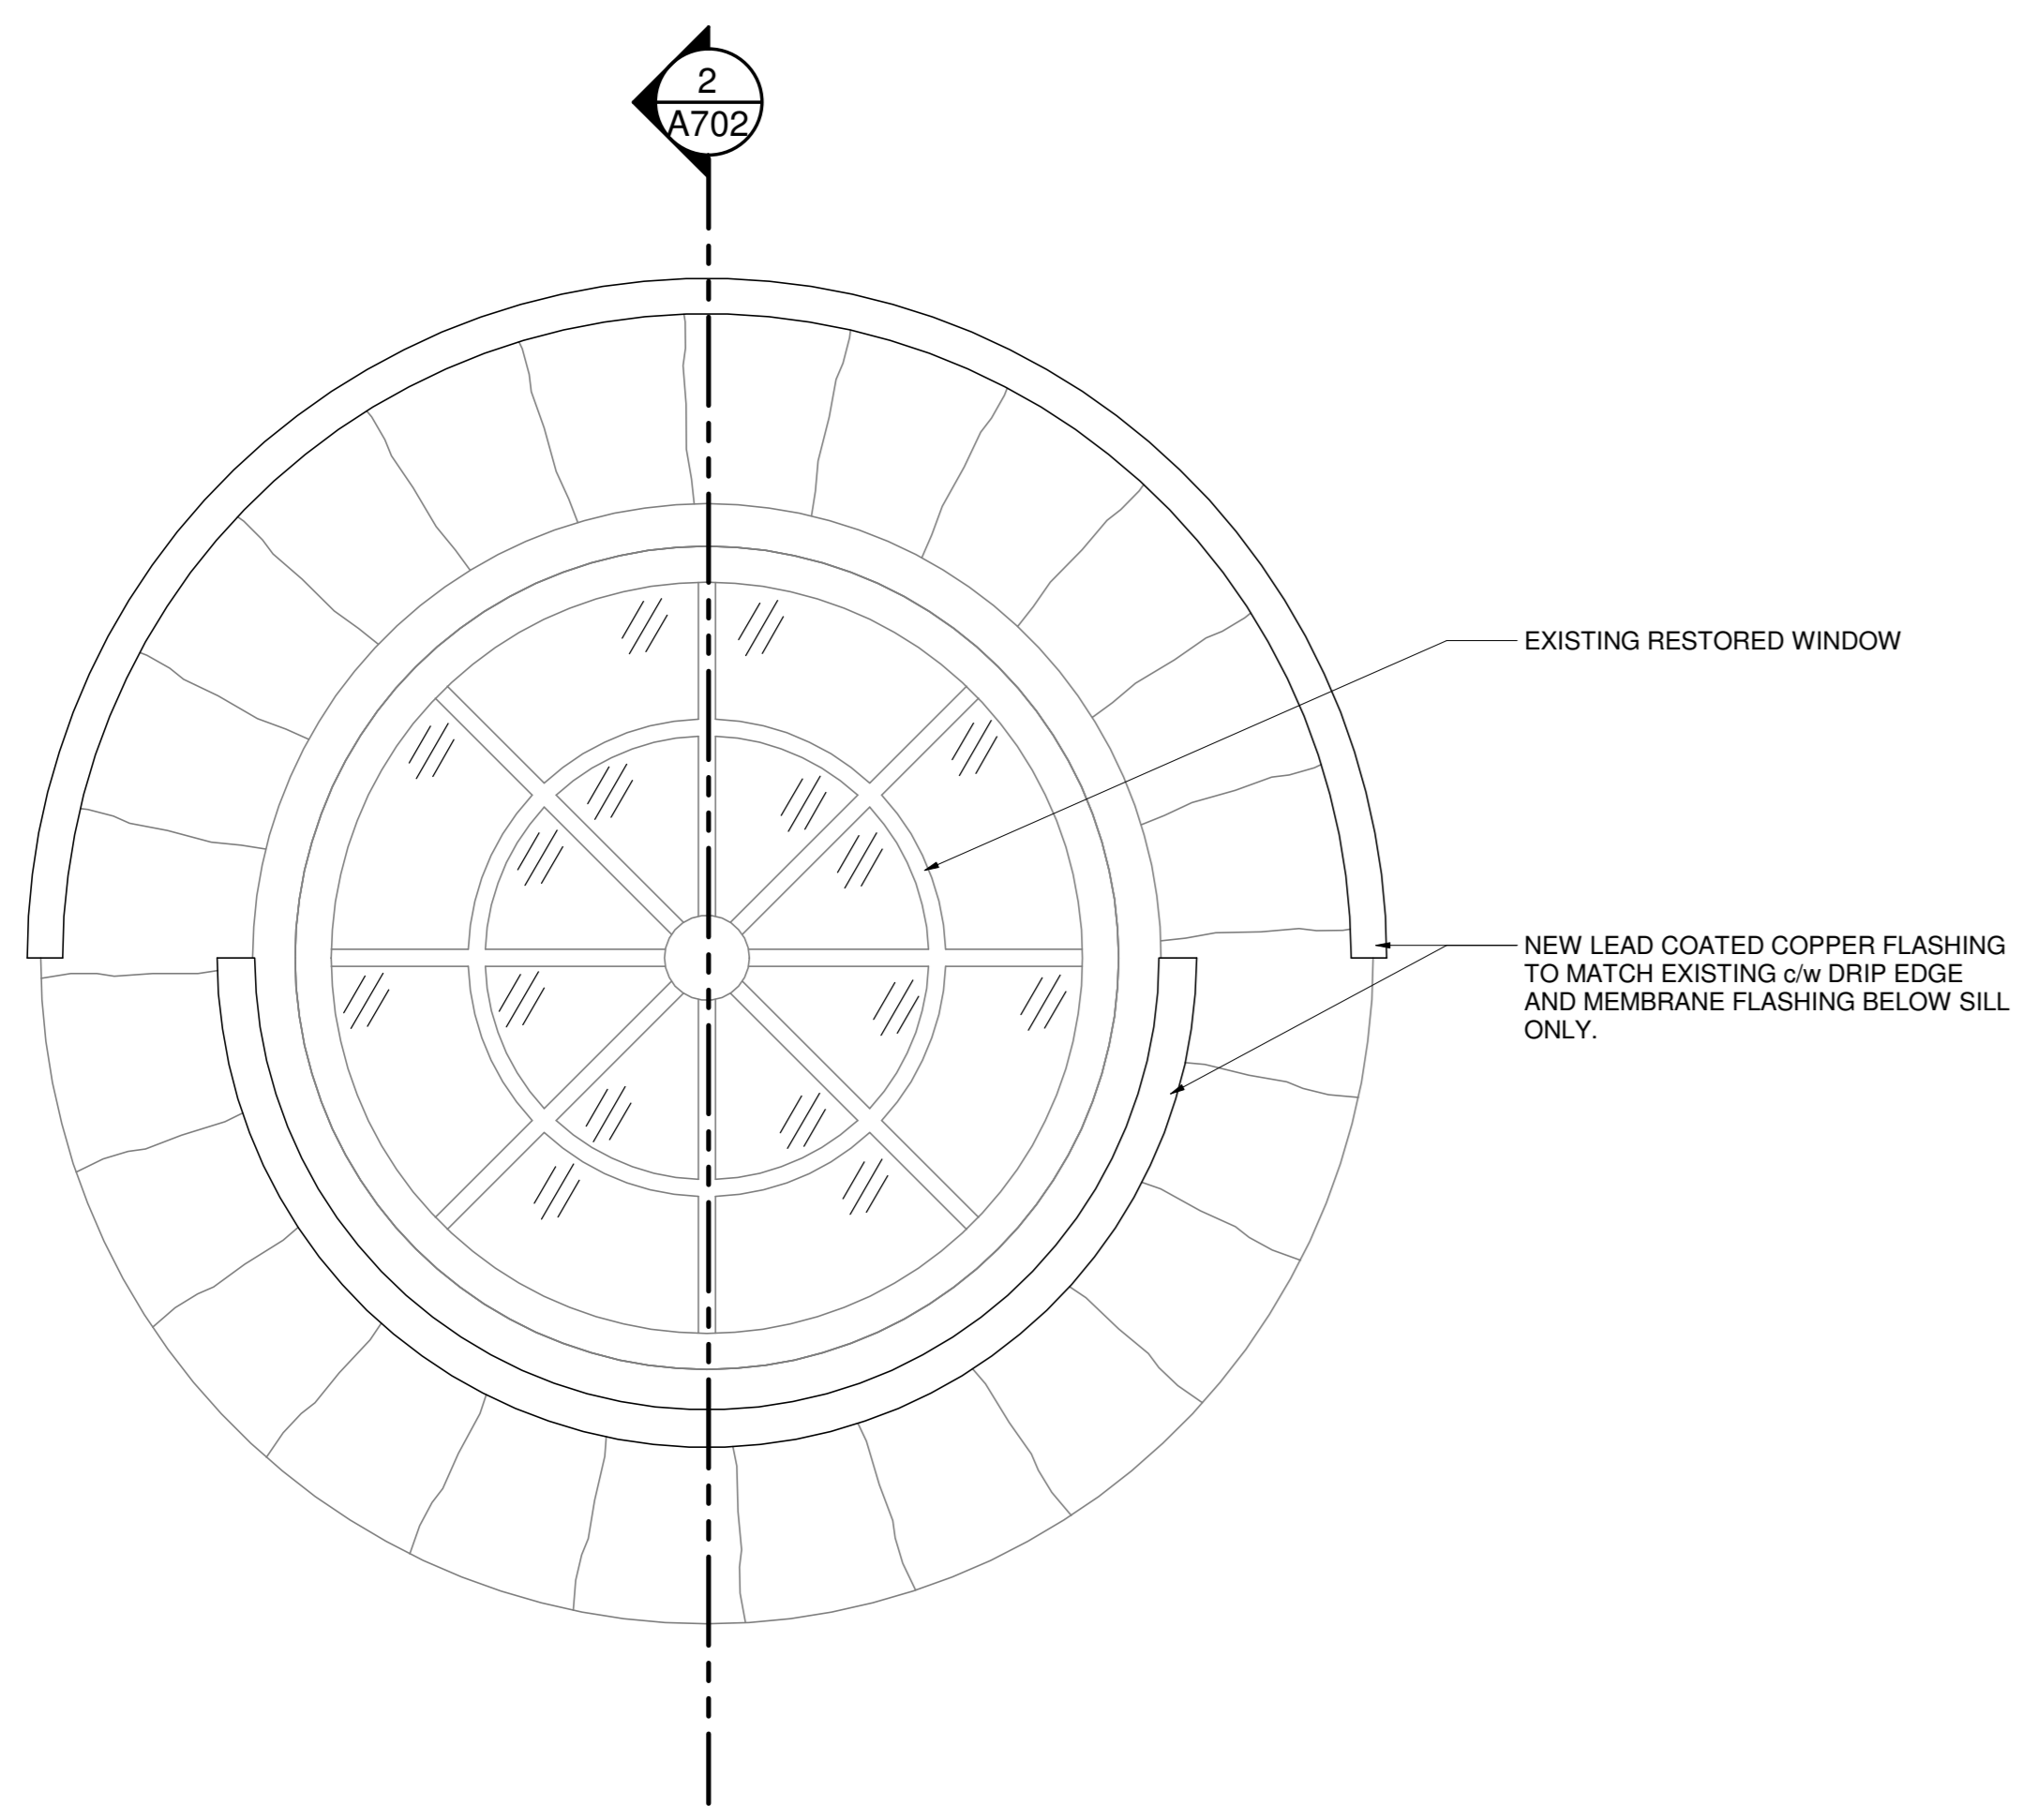

- NOTES:
- WOOD STOPS, TRIMS AND PROFILES TO BE RECORDED AND LABELED. SALVAGEABLE MATERIAL TO BE RETAINED FOR RE-INSTALLATION IN ORIGINAL LOCATION. EXISTING INSTALLATION METHOD TO BE CONFIRMED BY CONTRACTOR. REPORT DISCREPANCIES TO PCA REPRESENTATIVE.
 - LUNETTE WINDOW WAS PREVIOUSLY INSTALLED WITH INTERIOR SURFACE FACING THE EXTERIOR. WINDOW IS TO BE CAREFULLY REMOVED AND CRATED FOR TRANSPORTATION AS ADVISED BY PCA REPRESENTATIVE.
 - WINDOW TO BE RESTORED BY OTHERS.
 - WINDOW TO BE RE-INSTALLED AS PER DETAIL 2/A702.
 - MASONRY ROUGH OPENING TO BE CLEANED, FREE OF LOOSE MATERIAL AND REPAIRED WITH MORTAR TO MATCH EXISTING PERIMETER OF ROUGH OPENING TO BE SMOOTH AND REGULAR FOR RE-INSTALLATION OF WINDOW.
 - WINDOW TO BE PLACED PLUMB AND LEVEL WITHOUT TWISTING IN ROUGH OPENING.

1
A702 LUNETTE WINDOW ELEVATION
1:10

2
A702 SECTION DETAIL AT LUNETTE WINDOW
1:5





1	ISSUED FOR TENDER	03 APRIL 2020
revisions		date

project
**GRAND-PRÉ NATIONAL HISTORIC SITE
MEMORIAL CHURCH
AND MONUMENTS
REPOINTING**


drawing
**SECTIONS AND
DETAILS**

designed	Designer	conçu
date	07/10/19	
drawn	Author	dessiné
date	07/10/19	
approved	Approver	approuvé
date	07/10/19	
Tender		Soumission
PWGSC Project Manager	Administrateur de projets TPSCG	
project number		no. du projet
	1241	
drawing no.		no. du dessin
	A702	


- GENERAL NOTES:**
1. PHOTOGRAPHIC AND AS-FOUND DIMENSIONS TO BE DOCUMENTED PRIOR TO START OF WORK.
 2. REMOVE COPPER STATUE, PROTECT AND STORE FOR RE-INSTALLATION. PCA REPRESENTATIVE TO APPROVE METHOD AND BE PRESENT DURING LIFT.
 3. LABEL GRANITE STONES AND DISMANTLE MONUMENT. CAREFULLY REMOVE ALL EXISTING MORTAR. RETAIN STONES IN GOOD CONDITION FOR RE-USE. REPLACE STONES IN POOR CONDITION WITH NEW TO MATCH EXISTING STONE DIMENSIONS AND PROPERTIES.
 4. CLEAN ALL STONES FOR RE-USE PRIOR TO RE-INSTALLATION.
 5. NEW CONCRETE FOUNDATION. SEE STRUCTURAL.
 6. REBUILD GRANITE BASE TO EXISTING DIMENSIONS WITH COMPATIBLE MORTAR.

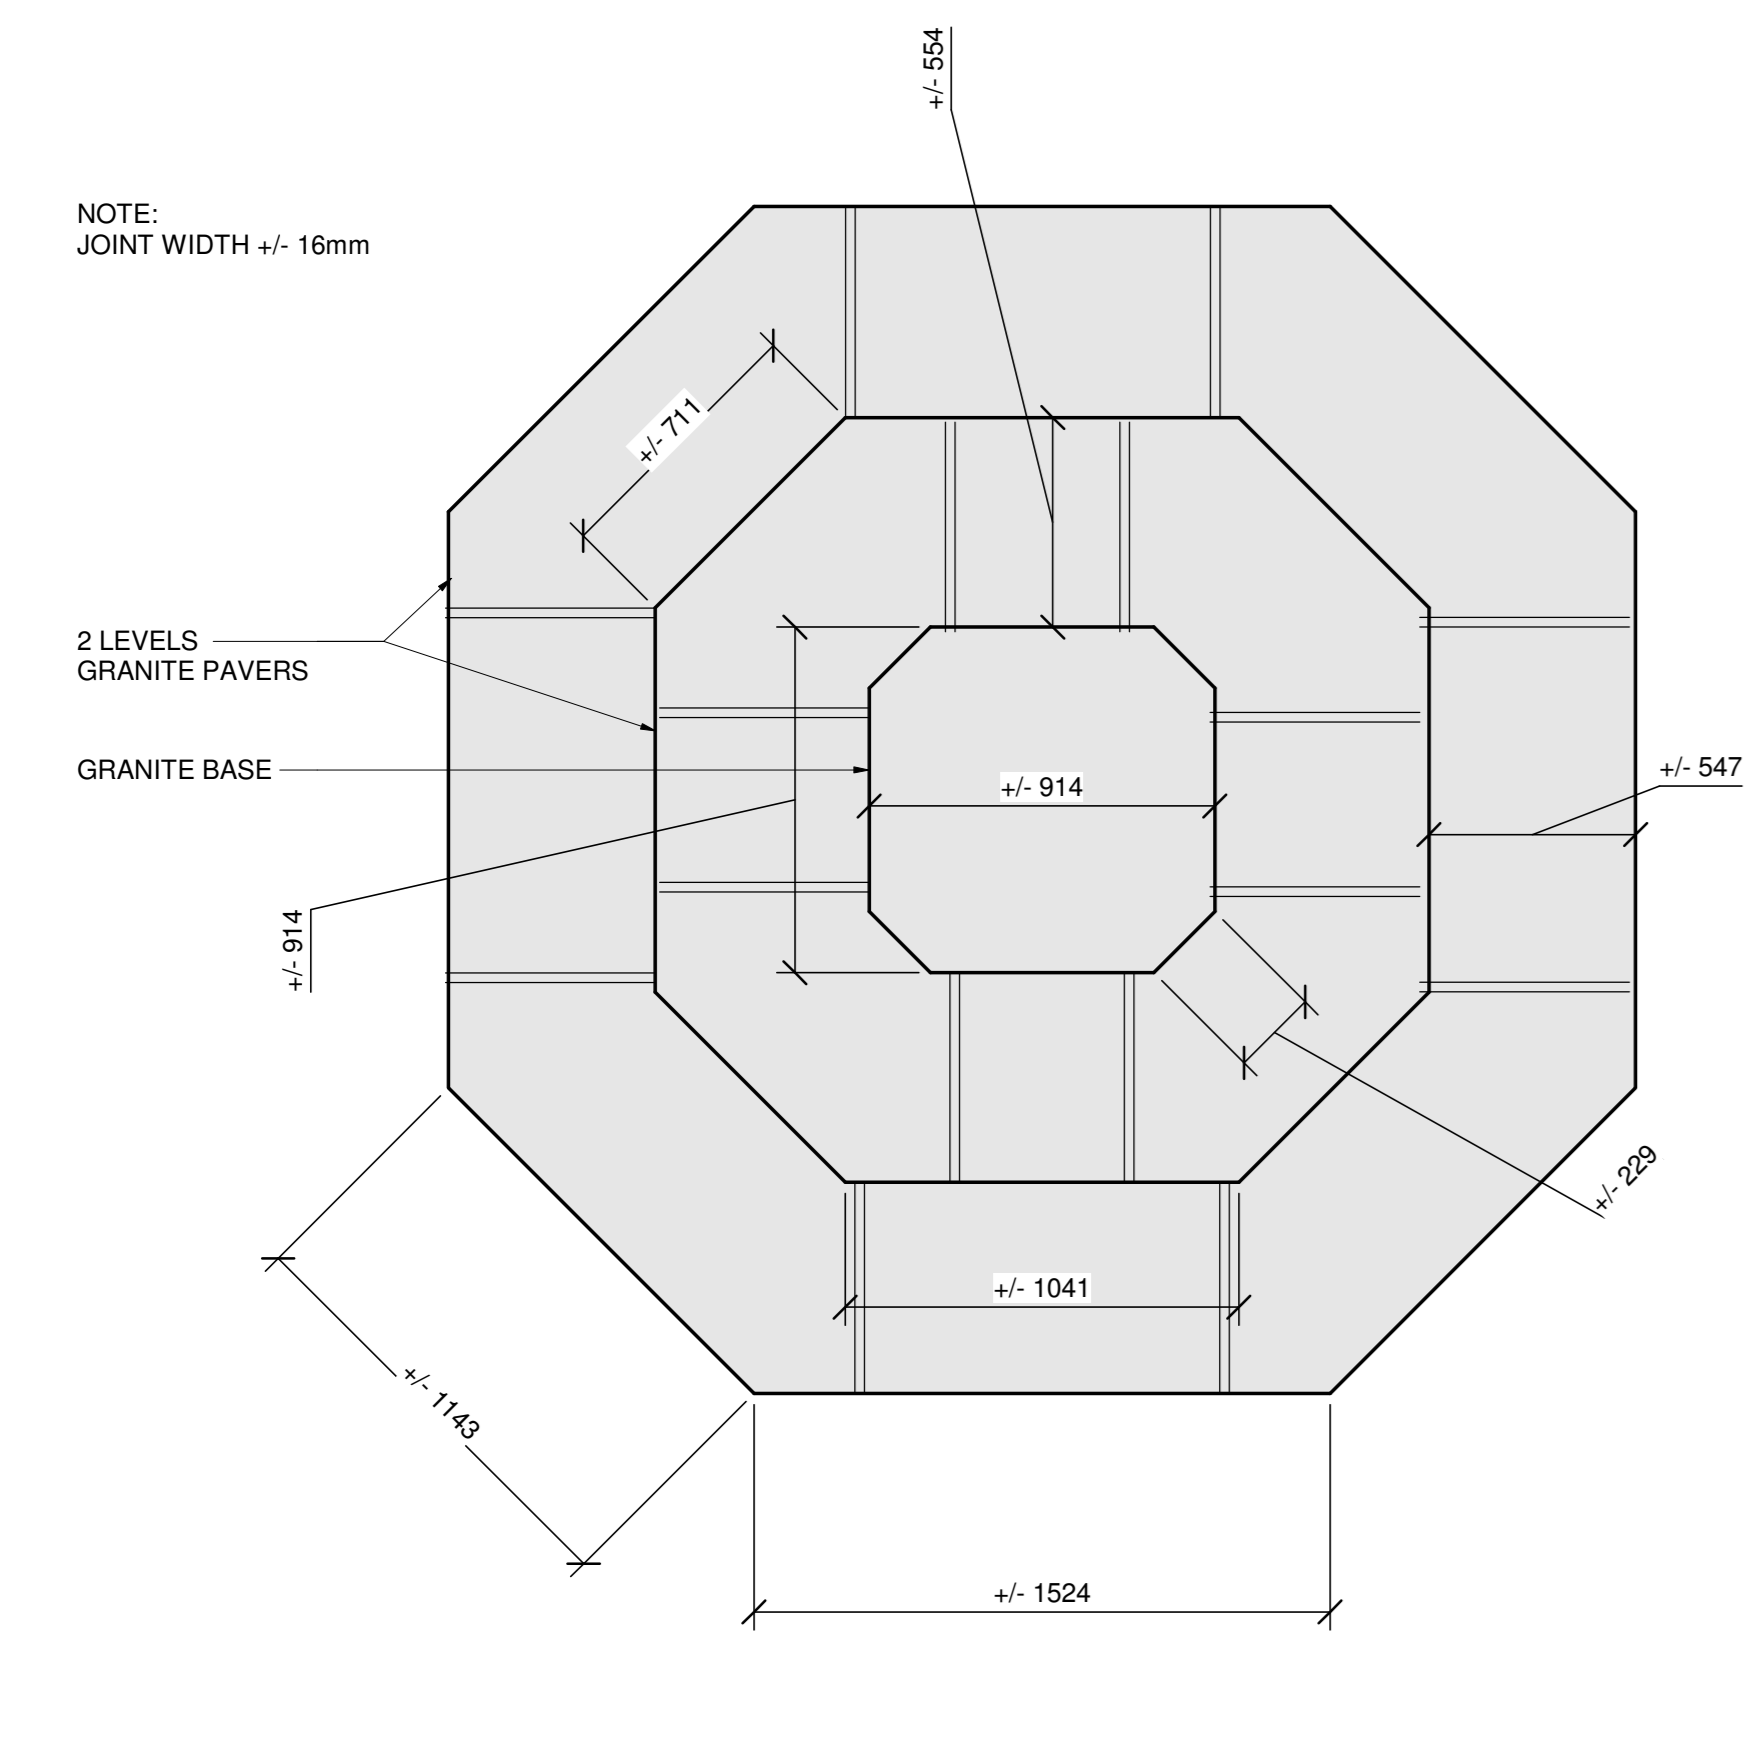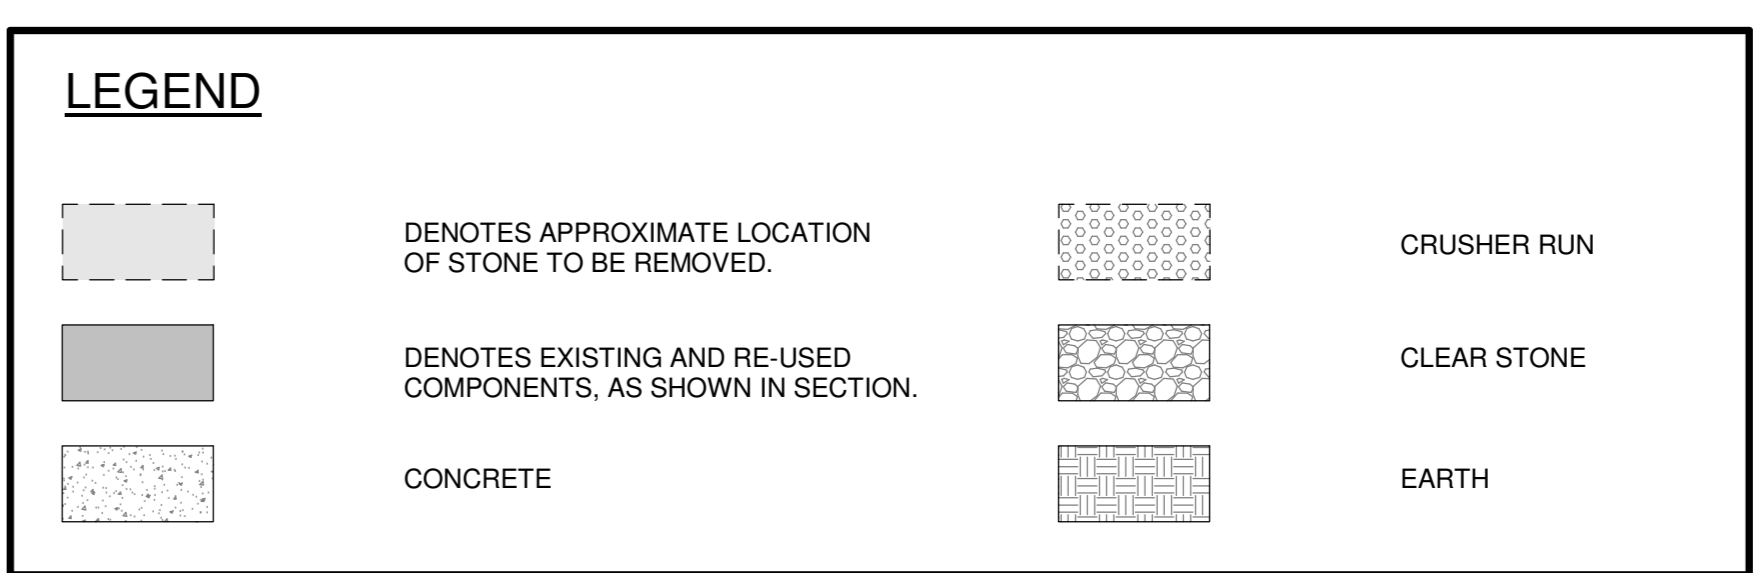


1 PLAN VIEW
 A901 1:20

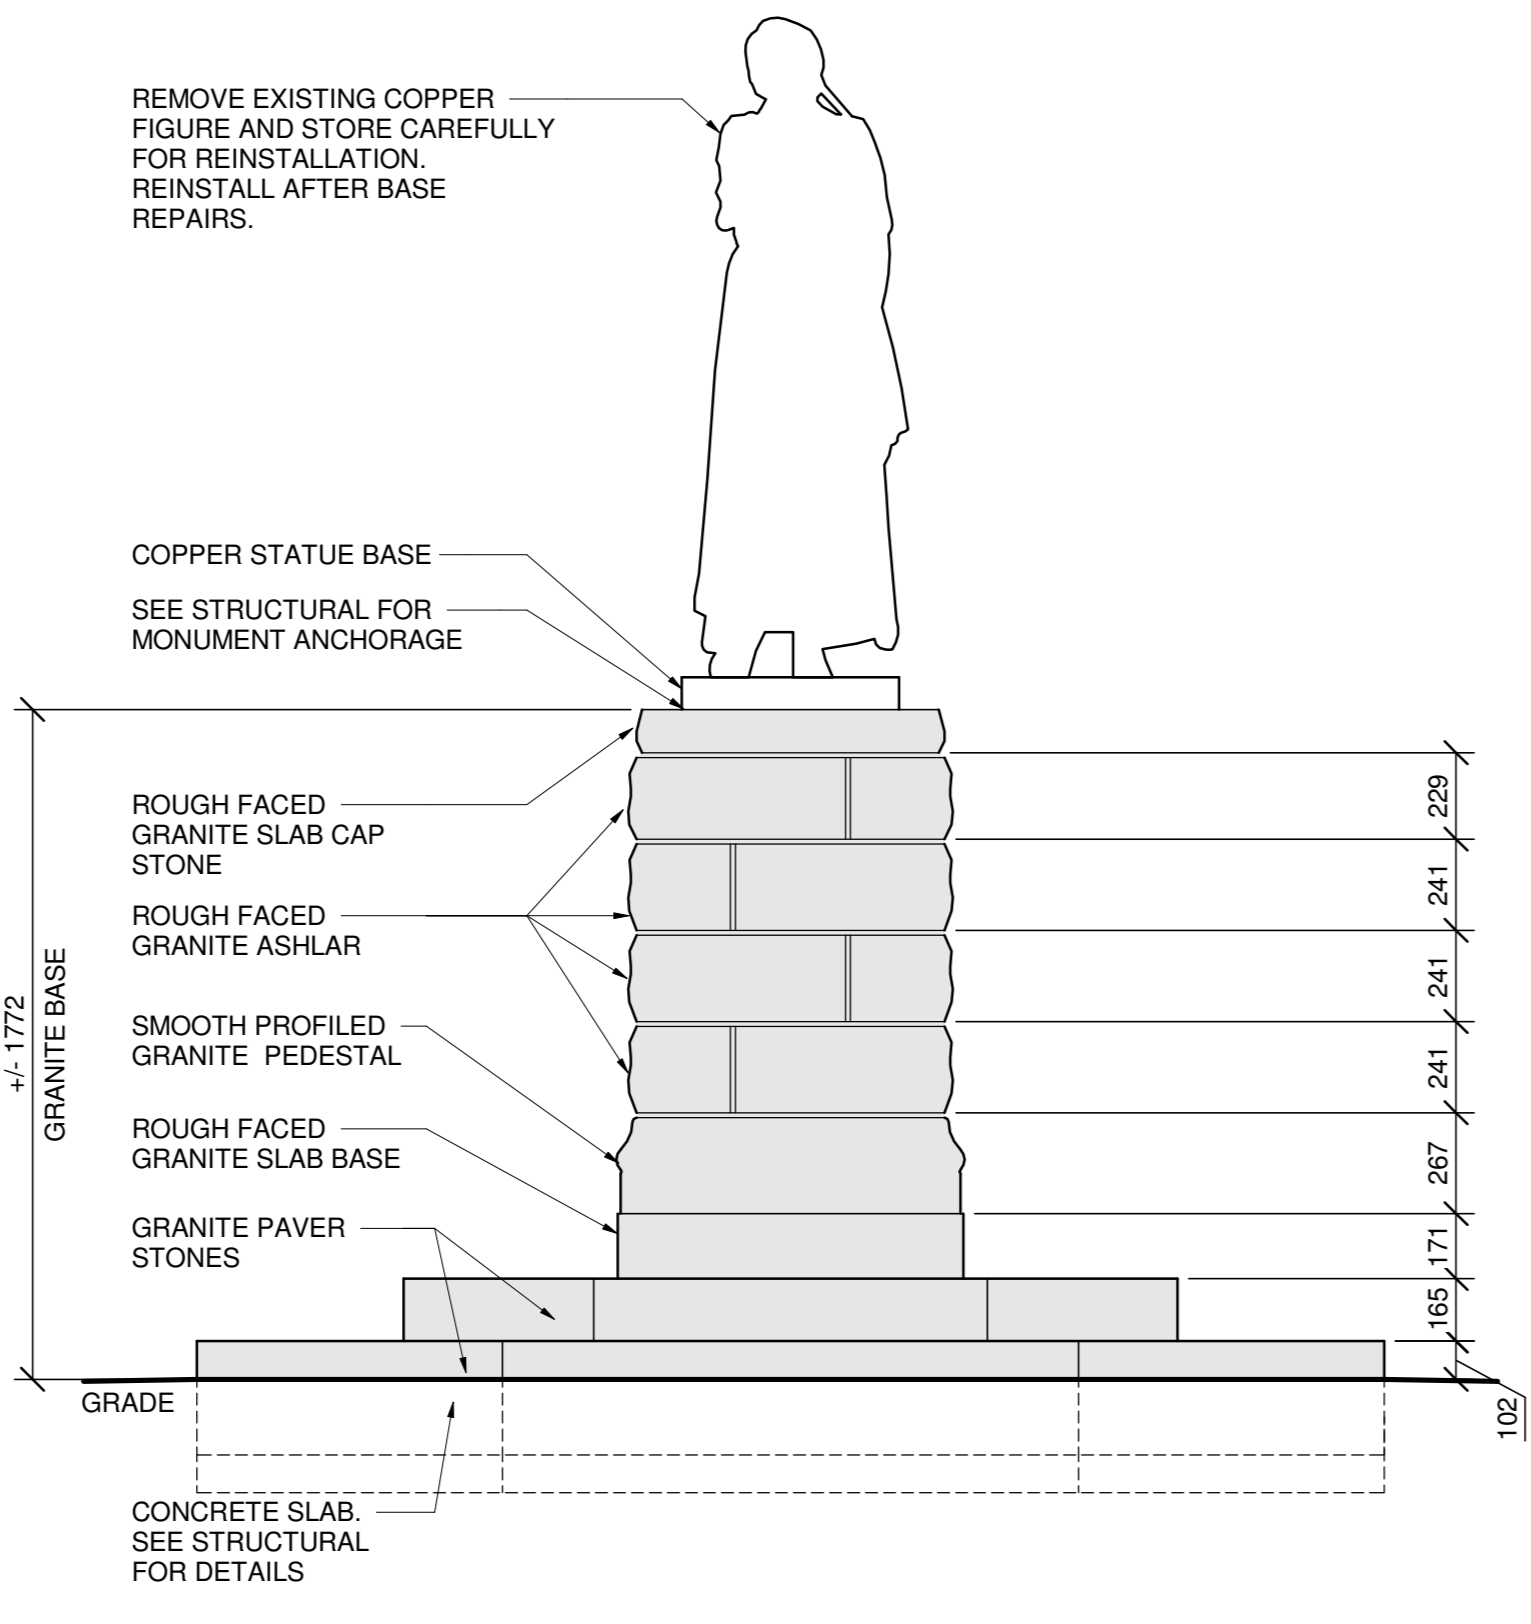


2 SOUTH (FRONT) ELEVATION
 A901 1:20

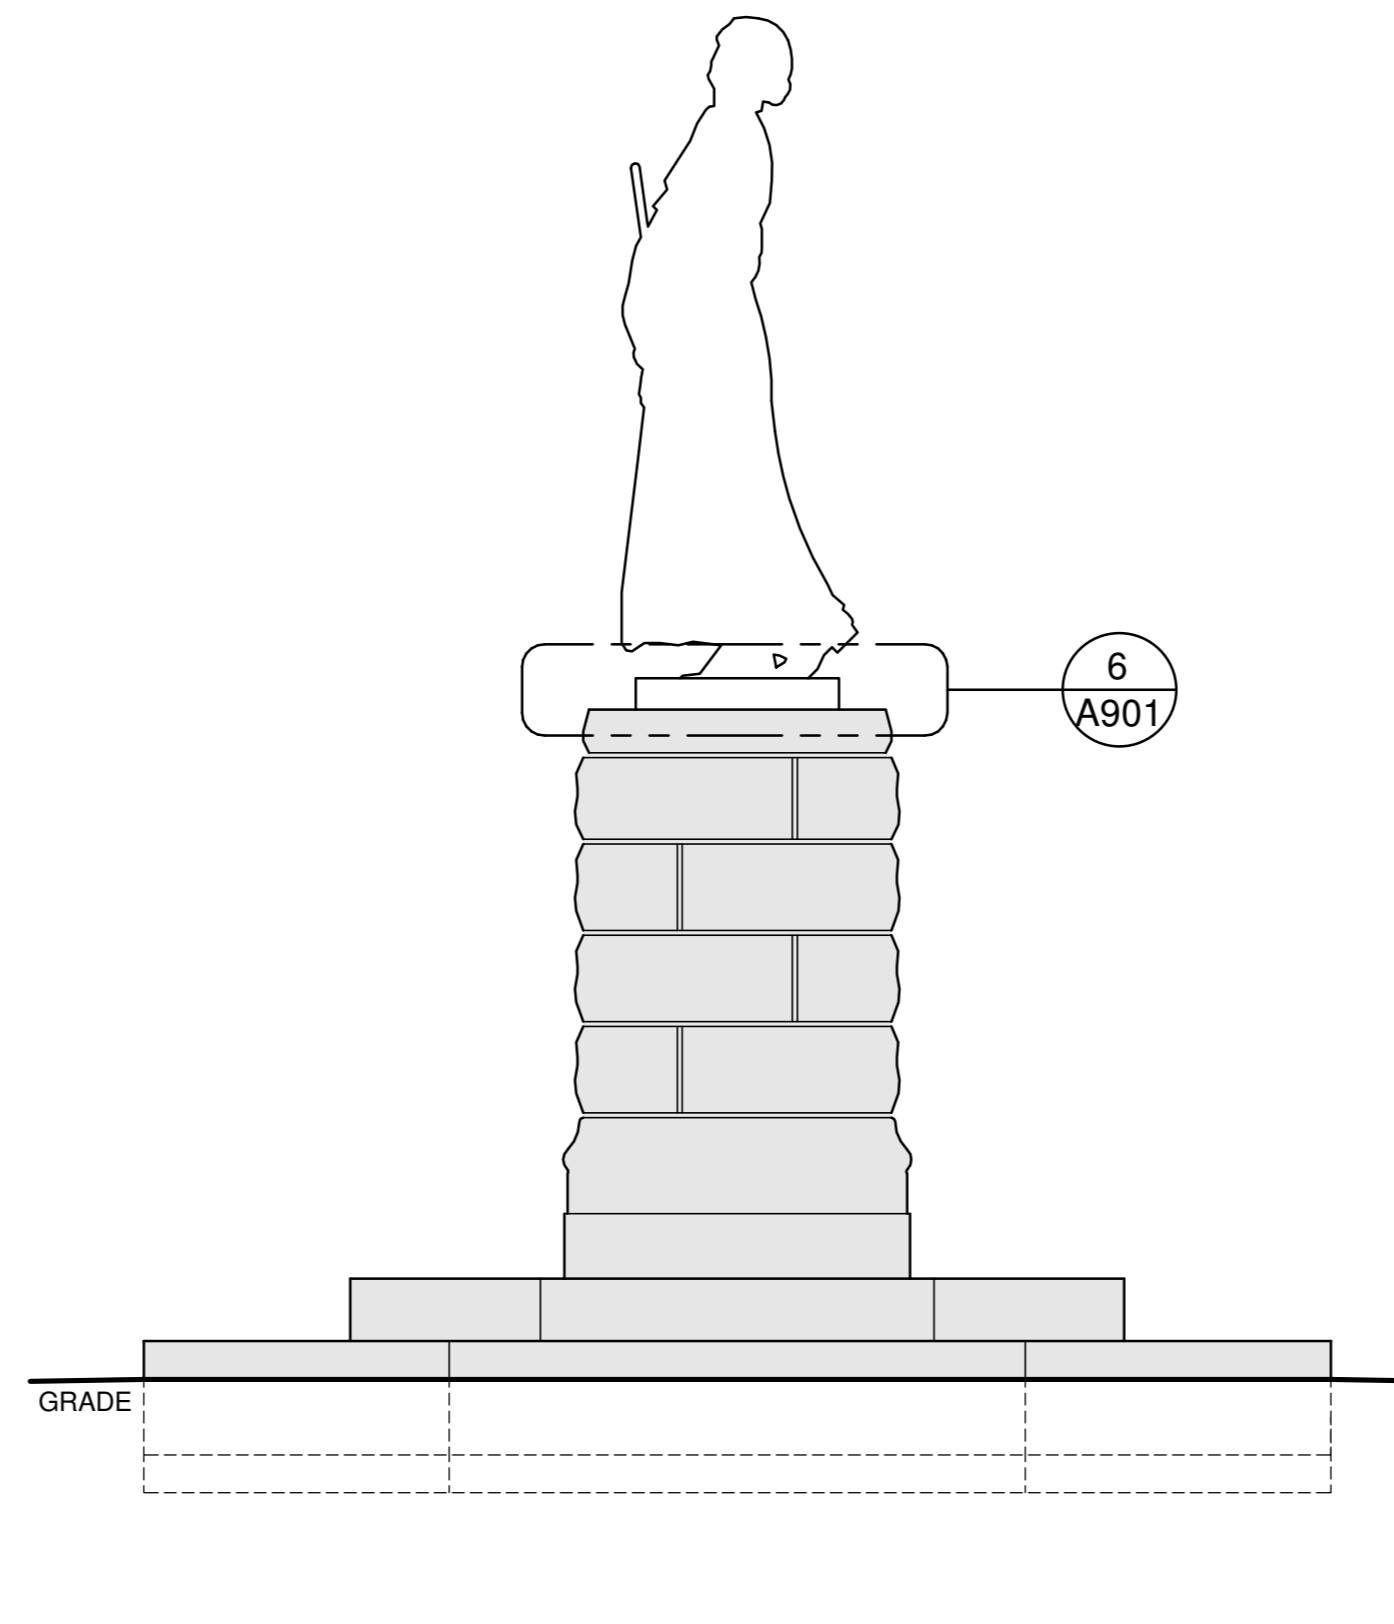

3 EAST ELEVATION
 A901 1:20

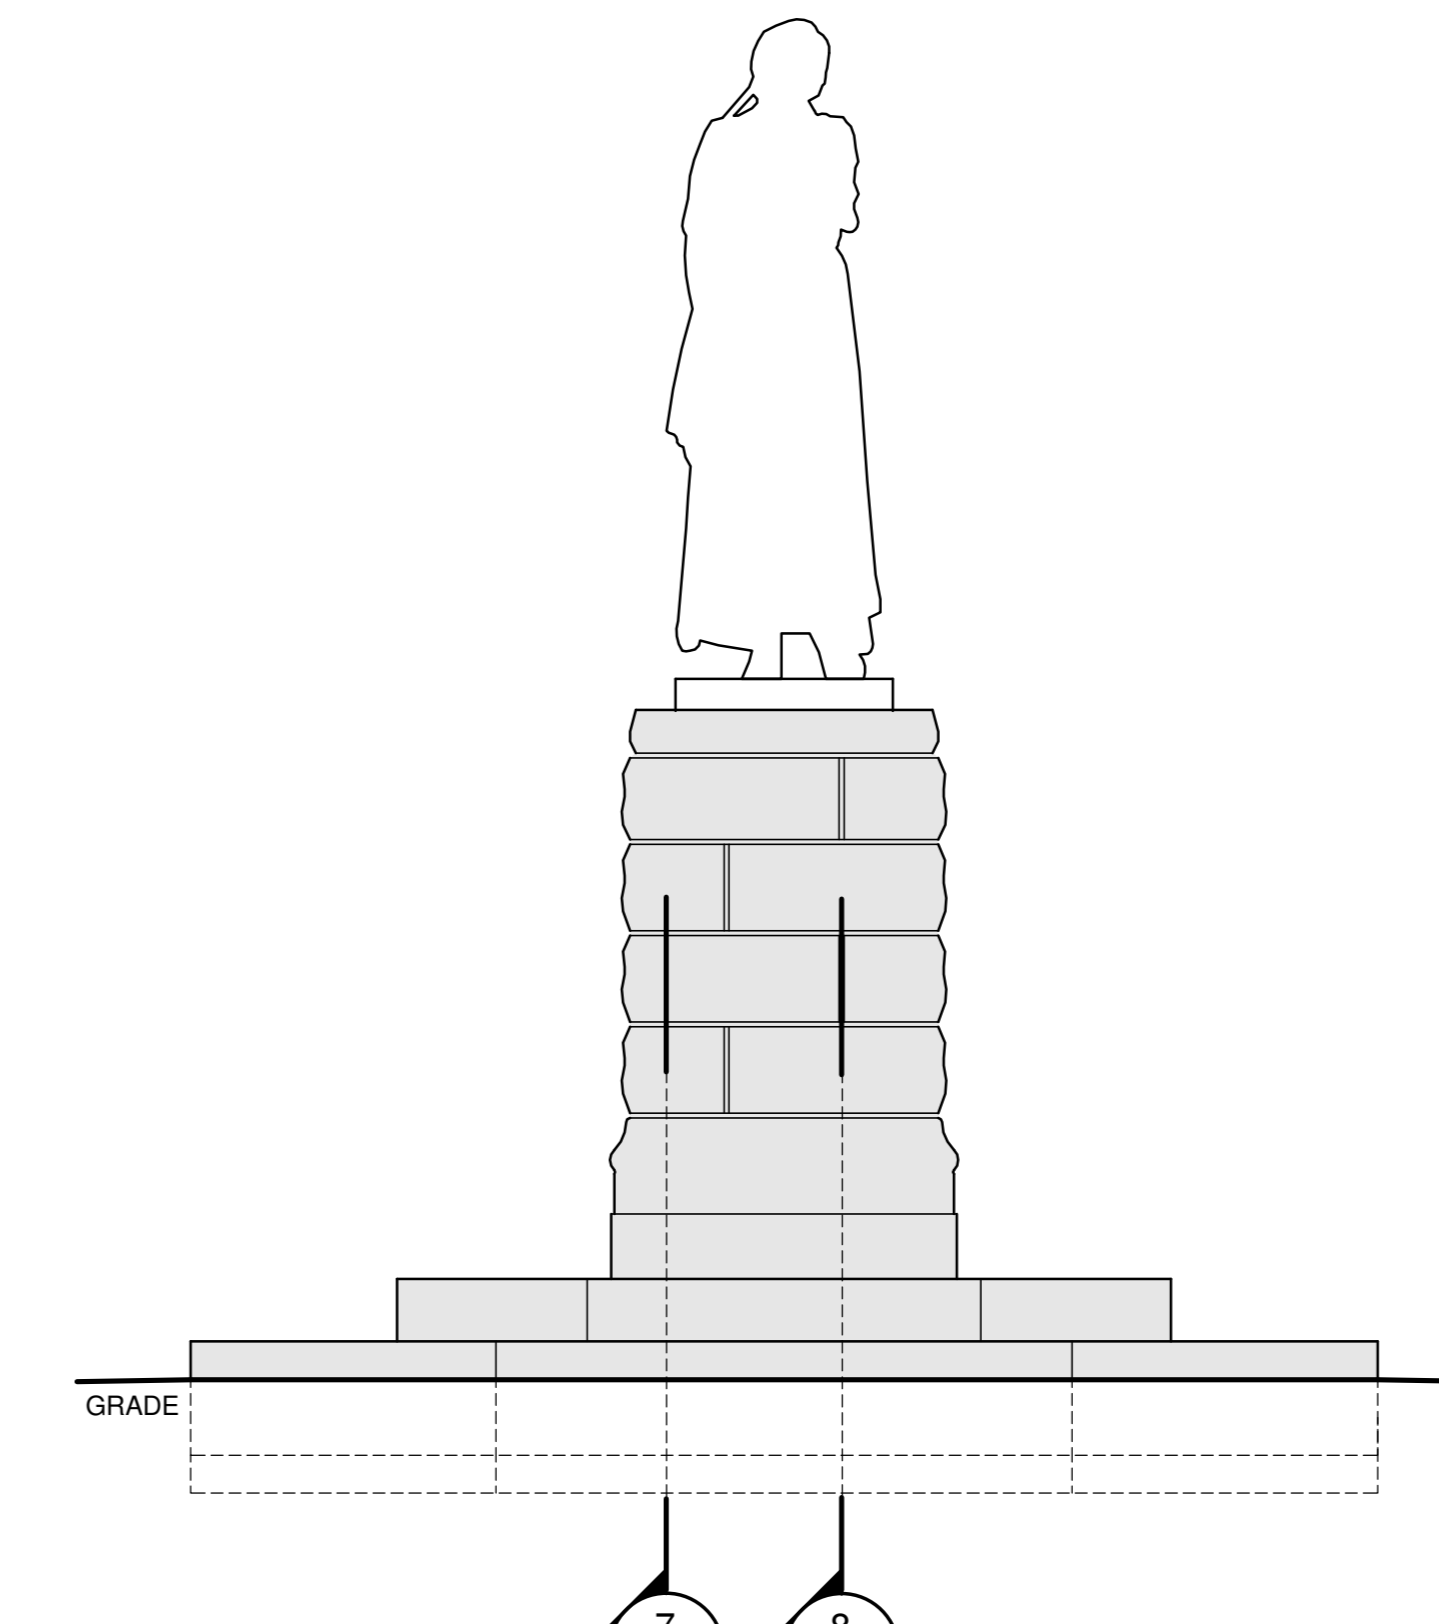

4 NORTH (REAR) ELEVATION
 A901 1:20

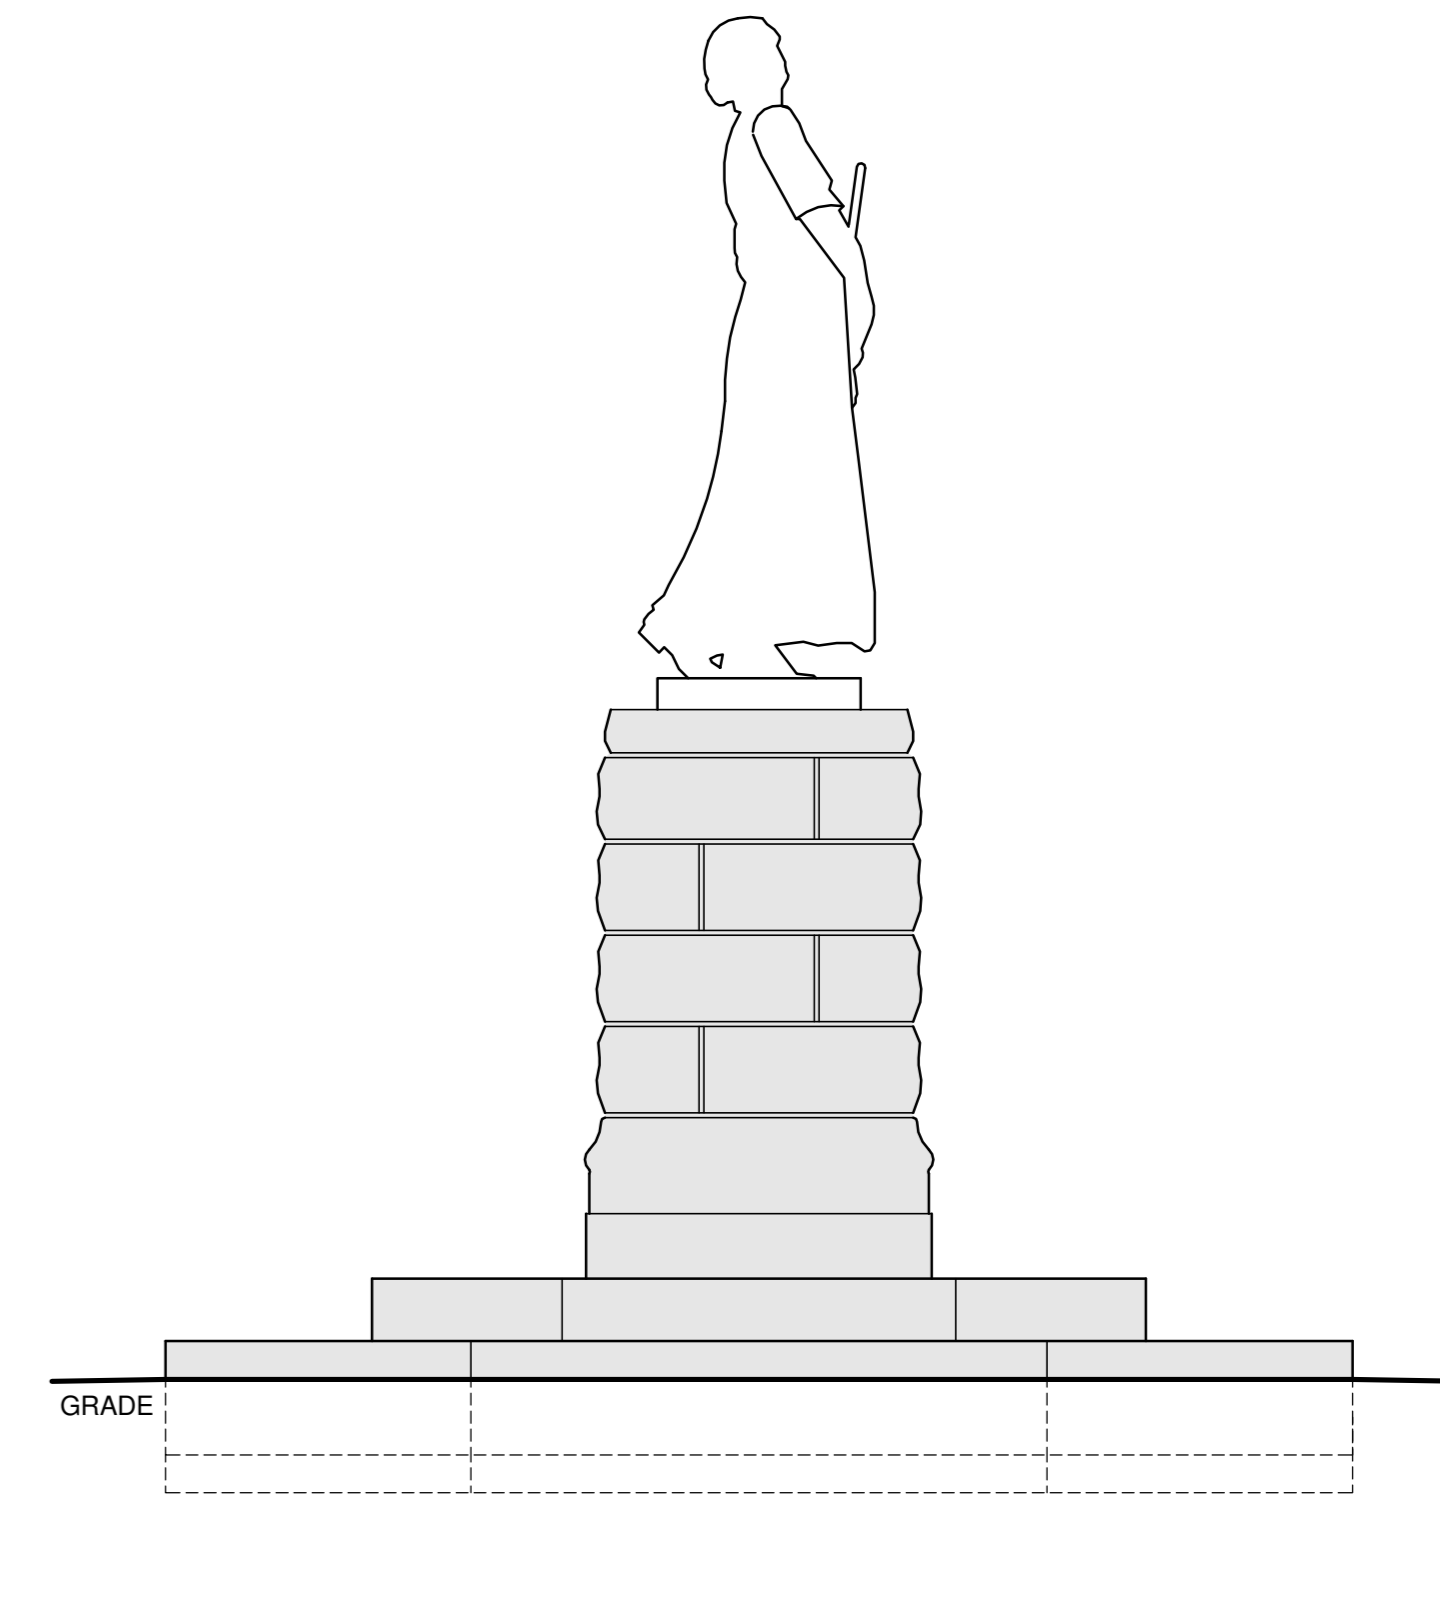


5 WEST ELEVATION
 A901 1:20




REMOVE PLAQUE AND RETAIN. PCA TO CLEAN PRIOR TO CONTRACTOR RE-INSTALLATION

SAMPLE OF CALCITE ENCRUSTATION.


EXISTING RUBBER WEEP TUBES TO BE REMOVED

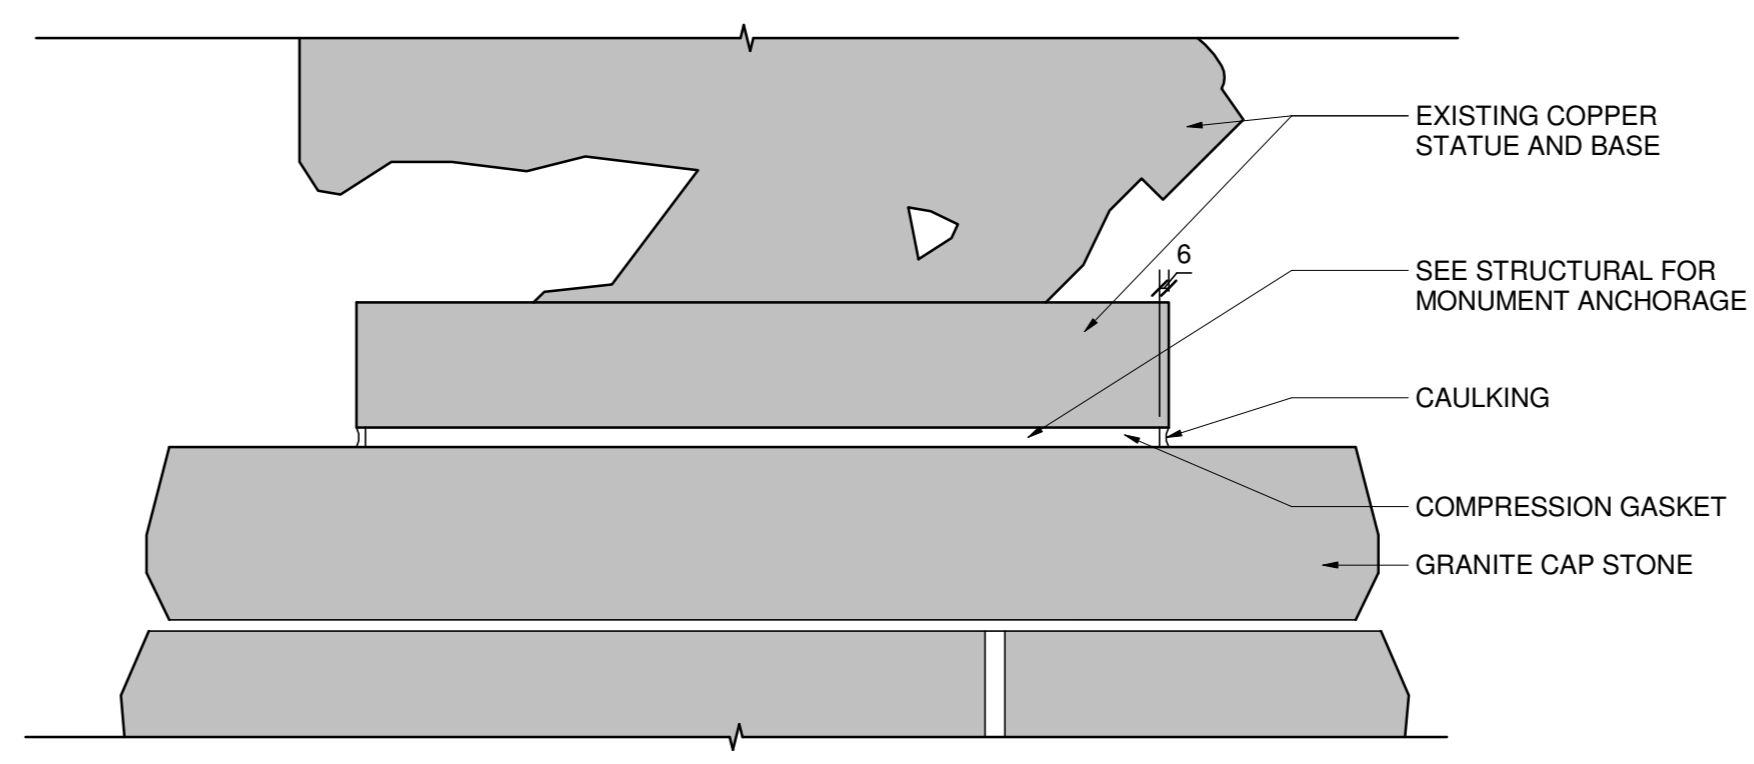

6 STATUE BASE DETAIL
 A901 1:5

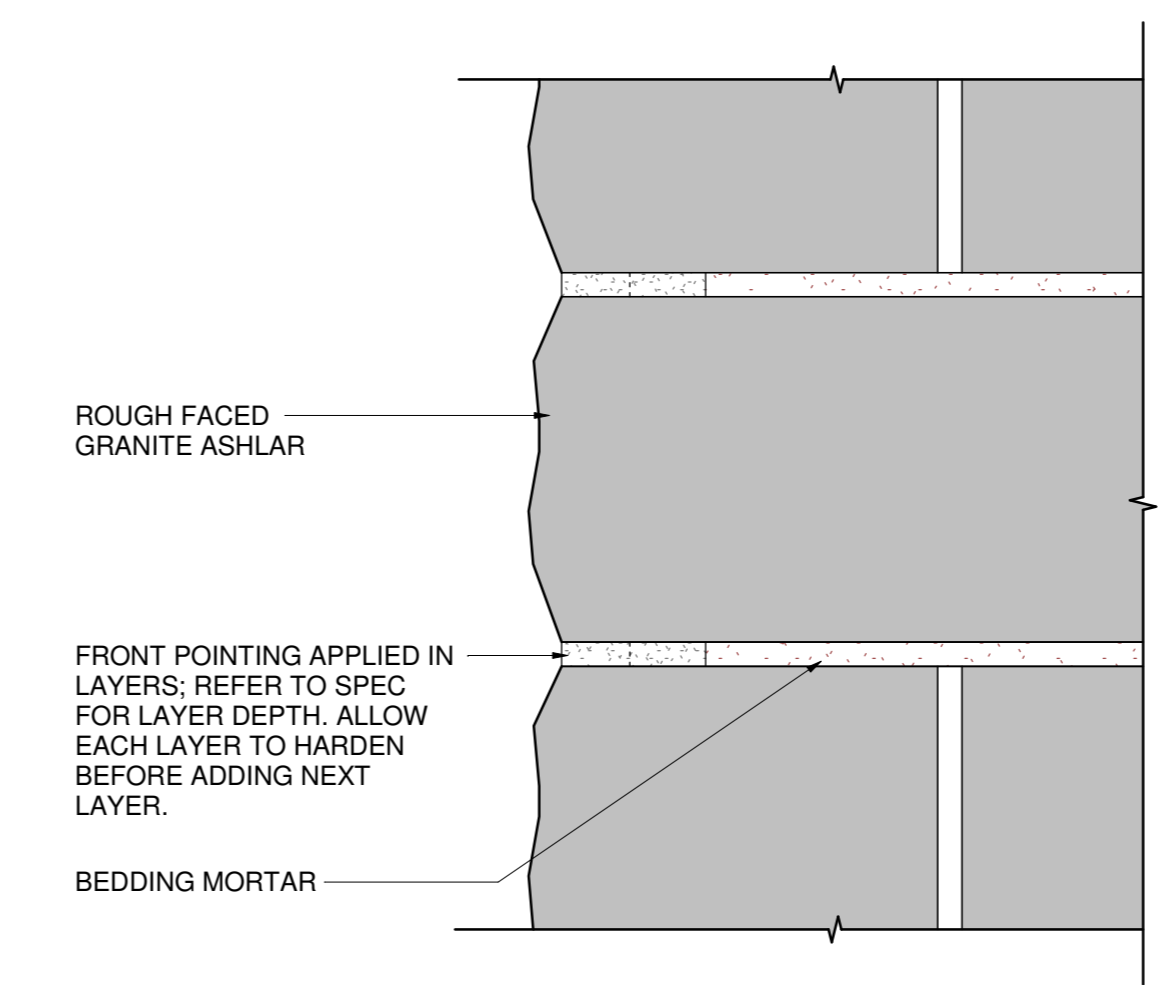


7 TYPICAL BEDDING AND FRONT POINTING DETAIL
 A901 1:5

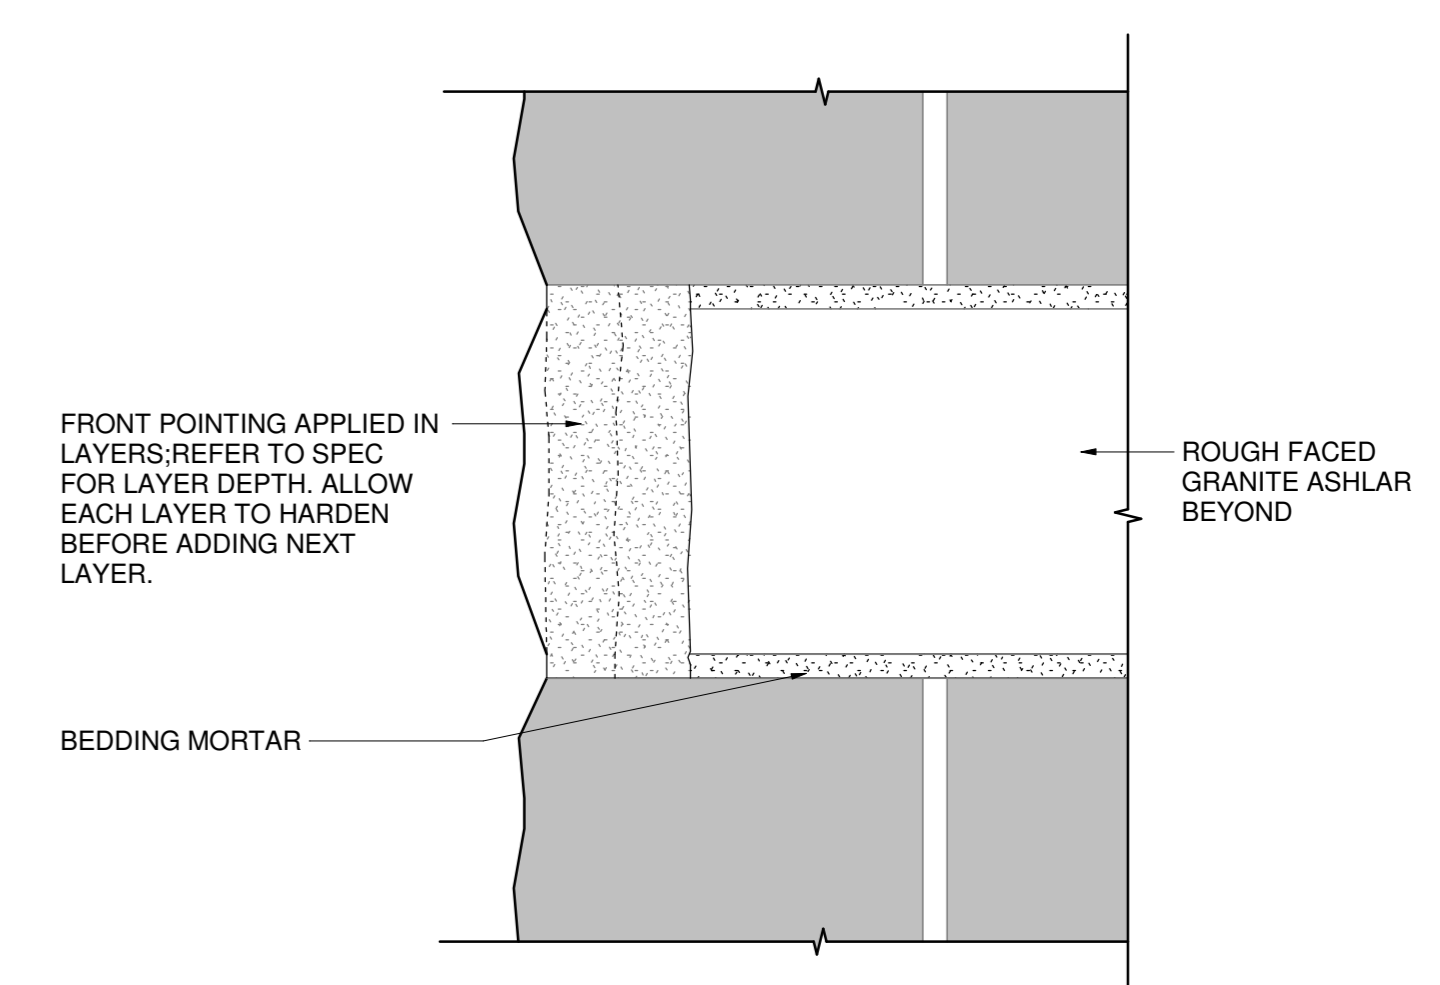

8 TYPICAL HEAD JOINT POINTING DETAIL
 A901 1:5

EXISTING PHOTOS - EVANGELINE MONUMENT

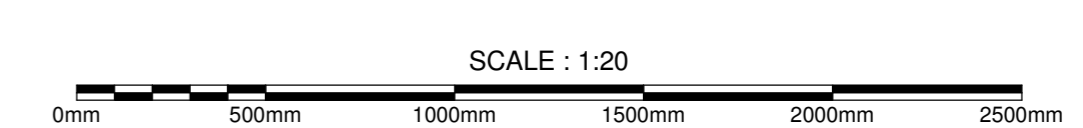







1	ISSUED FOR TENDER	02 APRIL 2020
revisions		date

project
 GRAND-PRÉ NATIONAL HISTORIC SITE
 MEMORIAL CHURCH AND MONUMENTS REPOINTING



drawing
 EVANGELINE MONUMENT

designed MT	conçu
date 08/28/19	
drawn LL/MG	dessiné
date 08/28/19	
approved KG	approuvé
date 08/28/19	
Tender	Soumission
PWGSC Project Manager	Administrateur de projets TPSCG
project number	no. du projet
1241	
drawing no.	no. du dessin
A901	

- GENERAL NOTES:**
- PHOTOGRAPHIC AND AS-FOUND DIMENSIONS TO BE DOCUMENTED PRIOR TO START OF WORK.
 - CAREFULLY REMOVE BUST, PROTECT AND STORE FOR REINSTALLATION.
 - LABEL FIELD STONES AND DISMANTLE PEDESTAL AND BACKING WALL, CAREFULLY REMOVE EXISTING MORTAR AND RETAIN STONES IN GOOD CONDITION FOR RE-INSTALLATION, REPLACE STONES IN POOR CONDITION WITH NEW TO MATCH EXISTING STONE DIMENSIONS AND PROPERTIES.
 - REMOVE EXISTING CONCRETE BASE AND STABILIZE GROUND BELOW MONUMENT.
 - POUR NEW CONCRETE BASE, SEE STRUCTURAL.
 - REBUILD PEDESTAL AND BACKING WALL TO EXISTING DIMENSIONS AND CONFIGURATION, USING COMPATIBLE MORTAR.

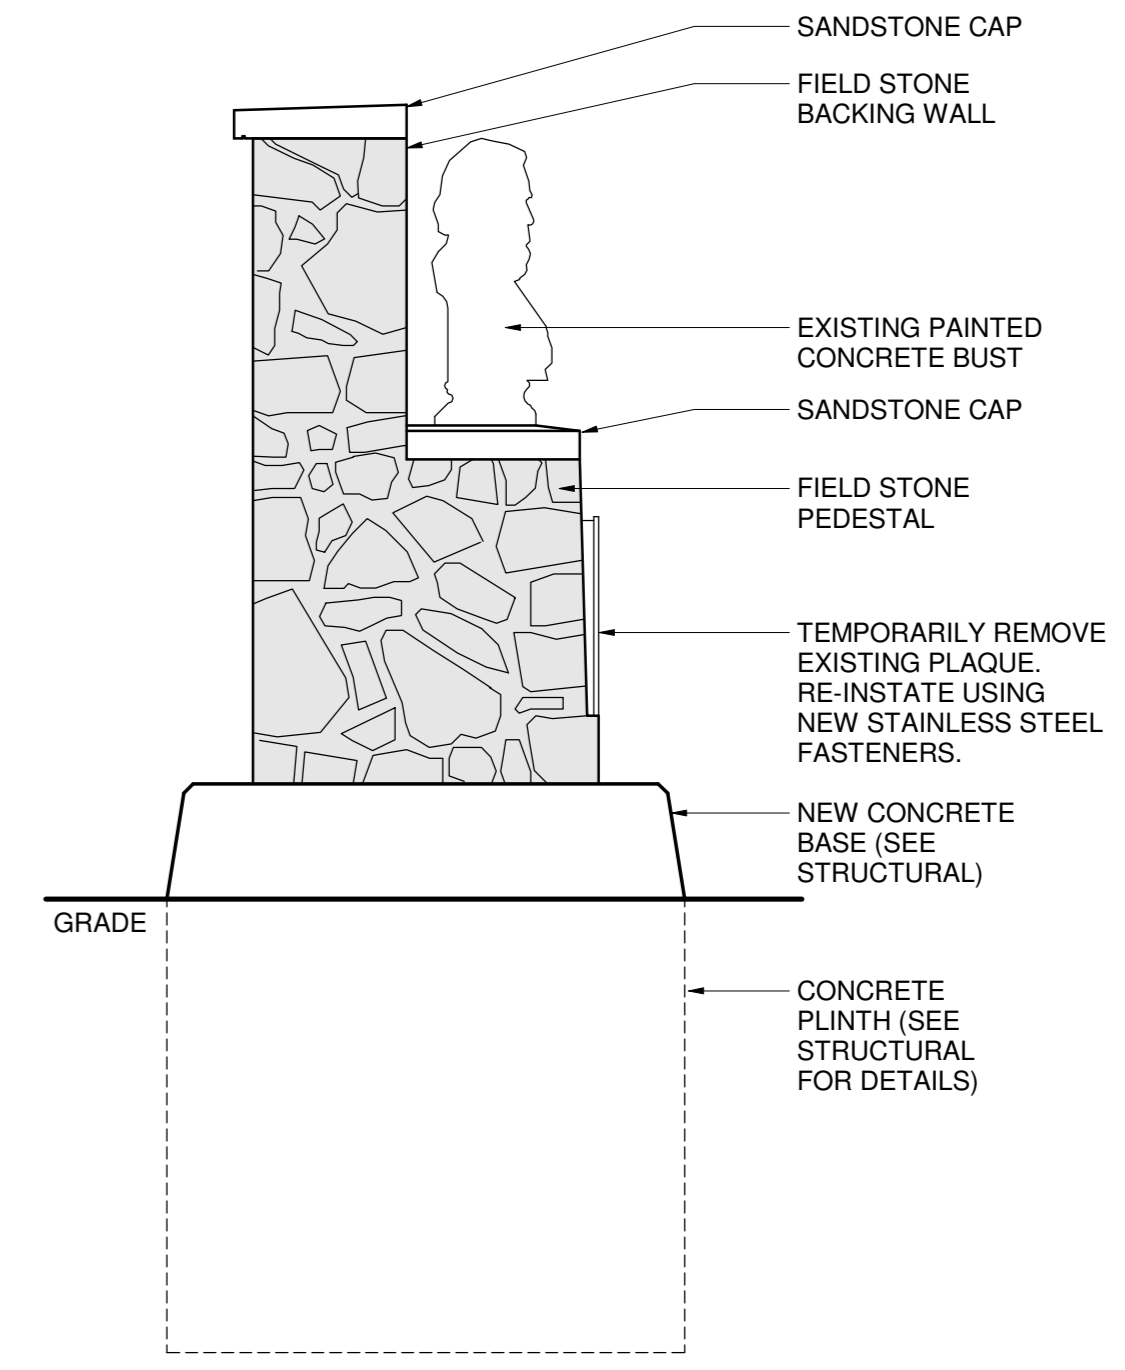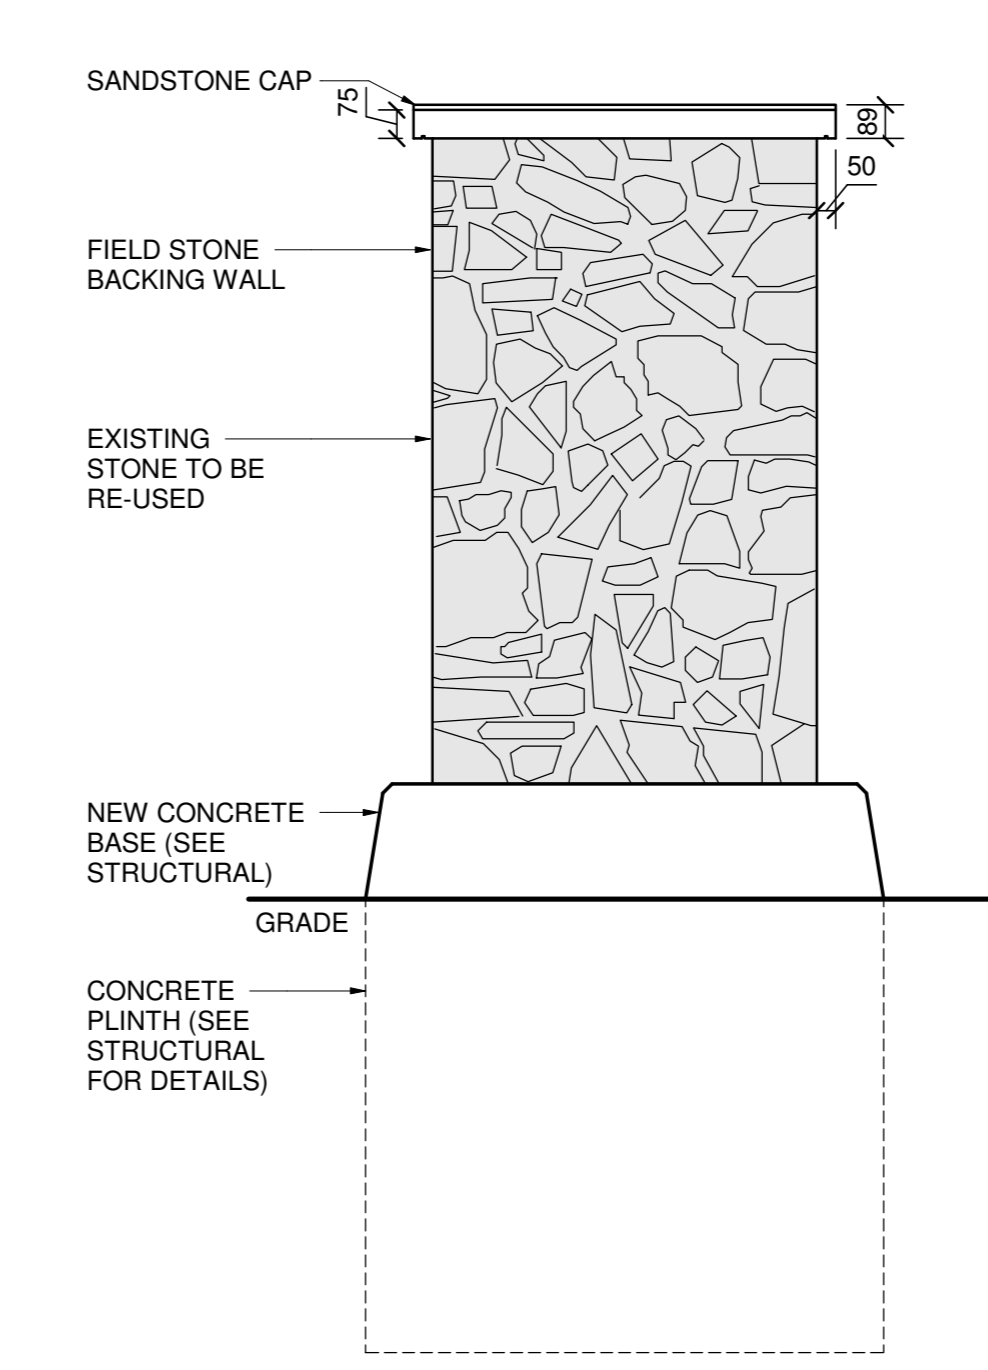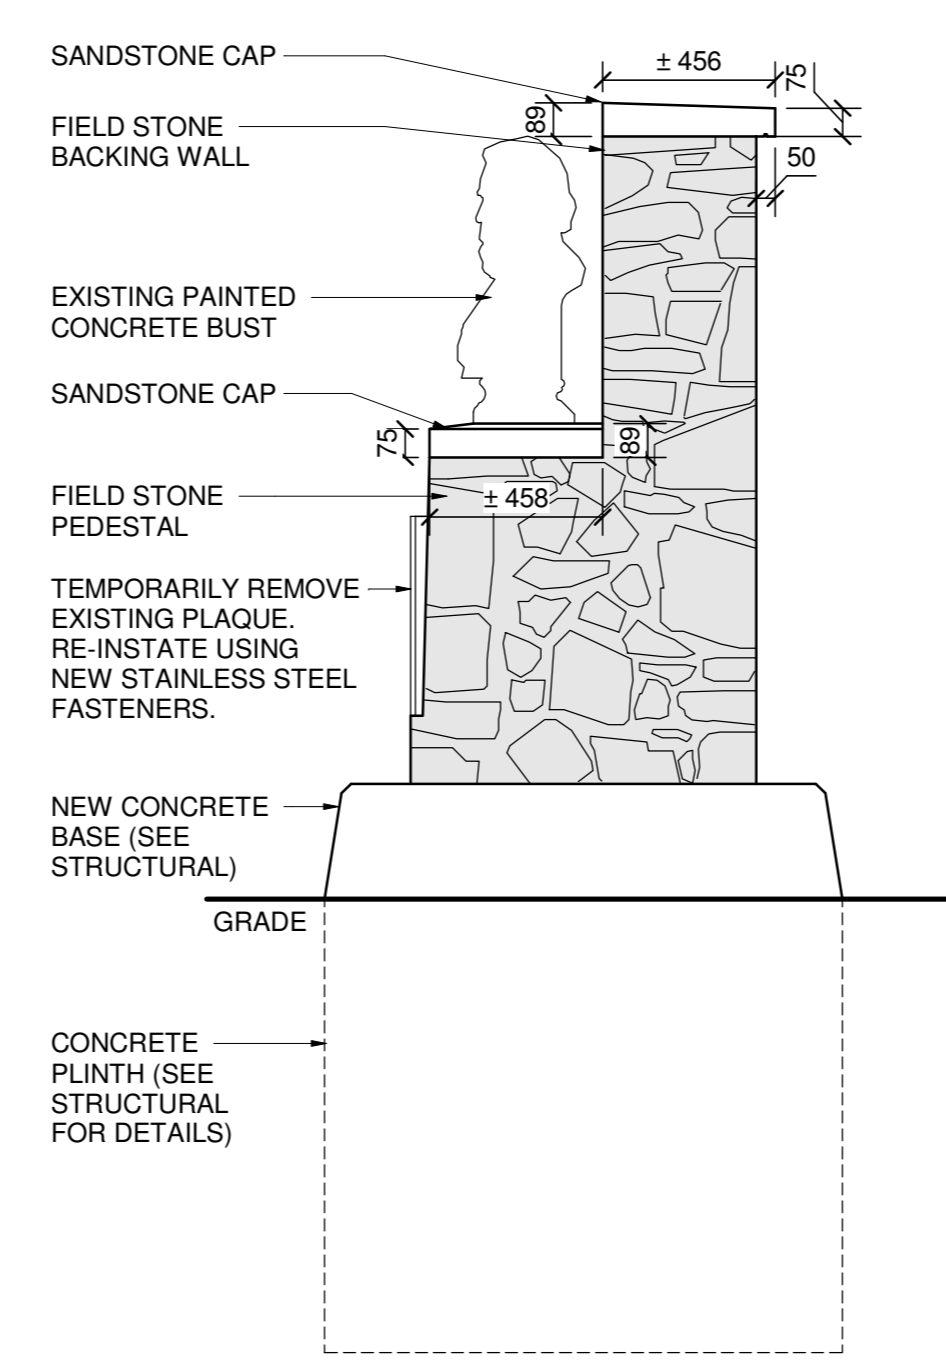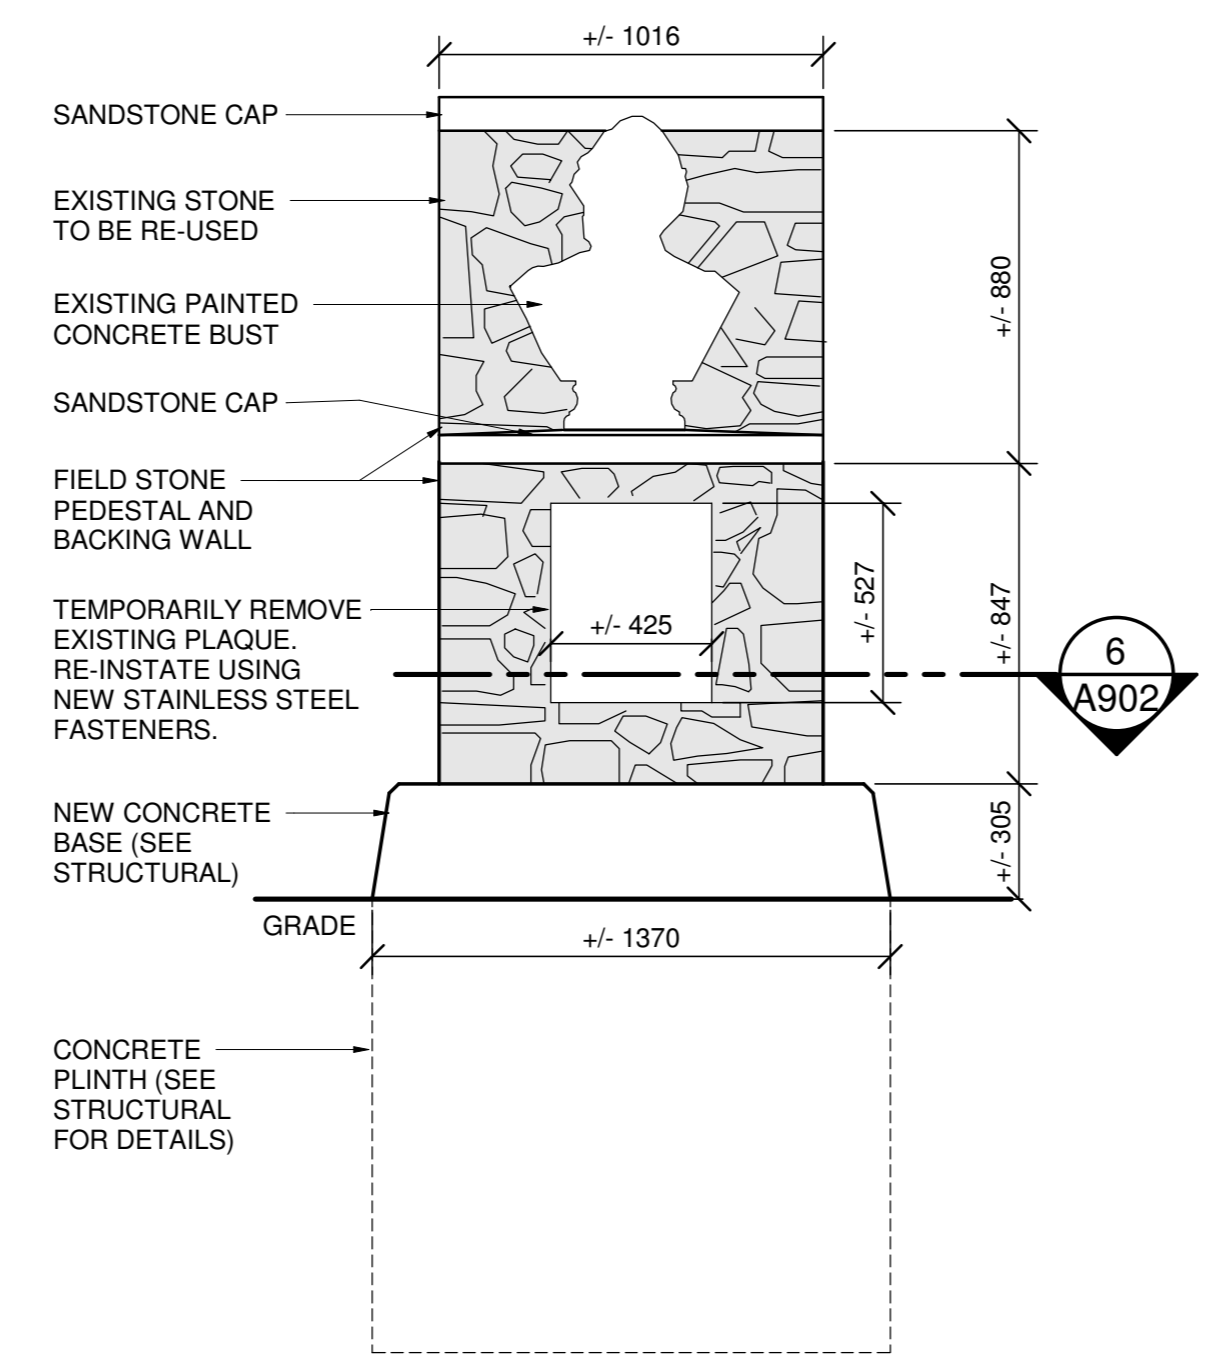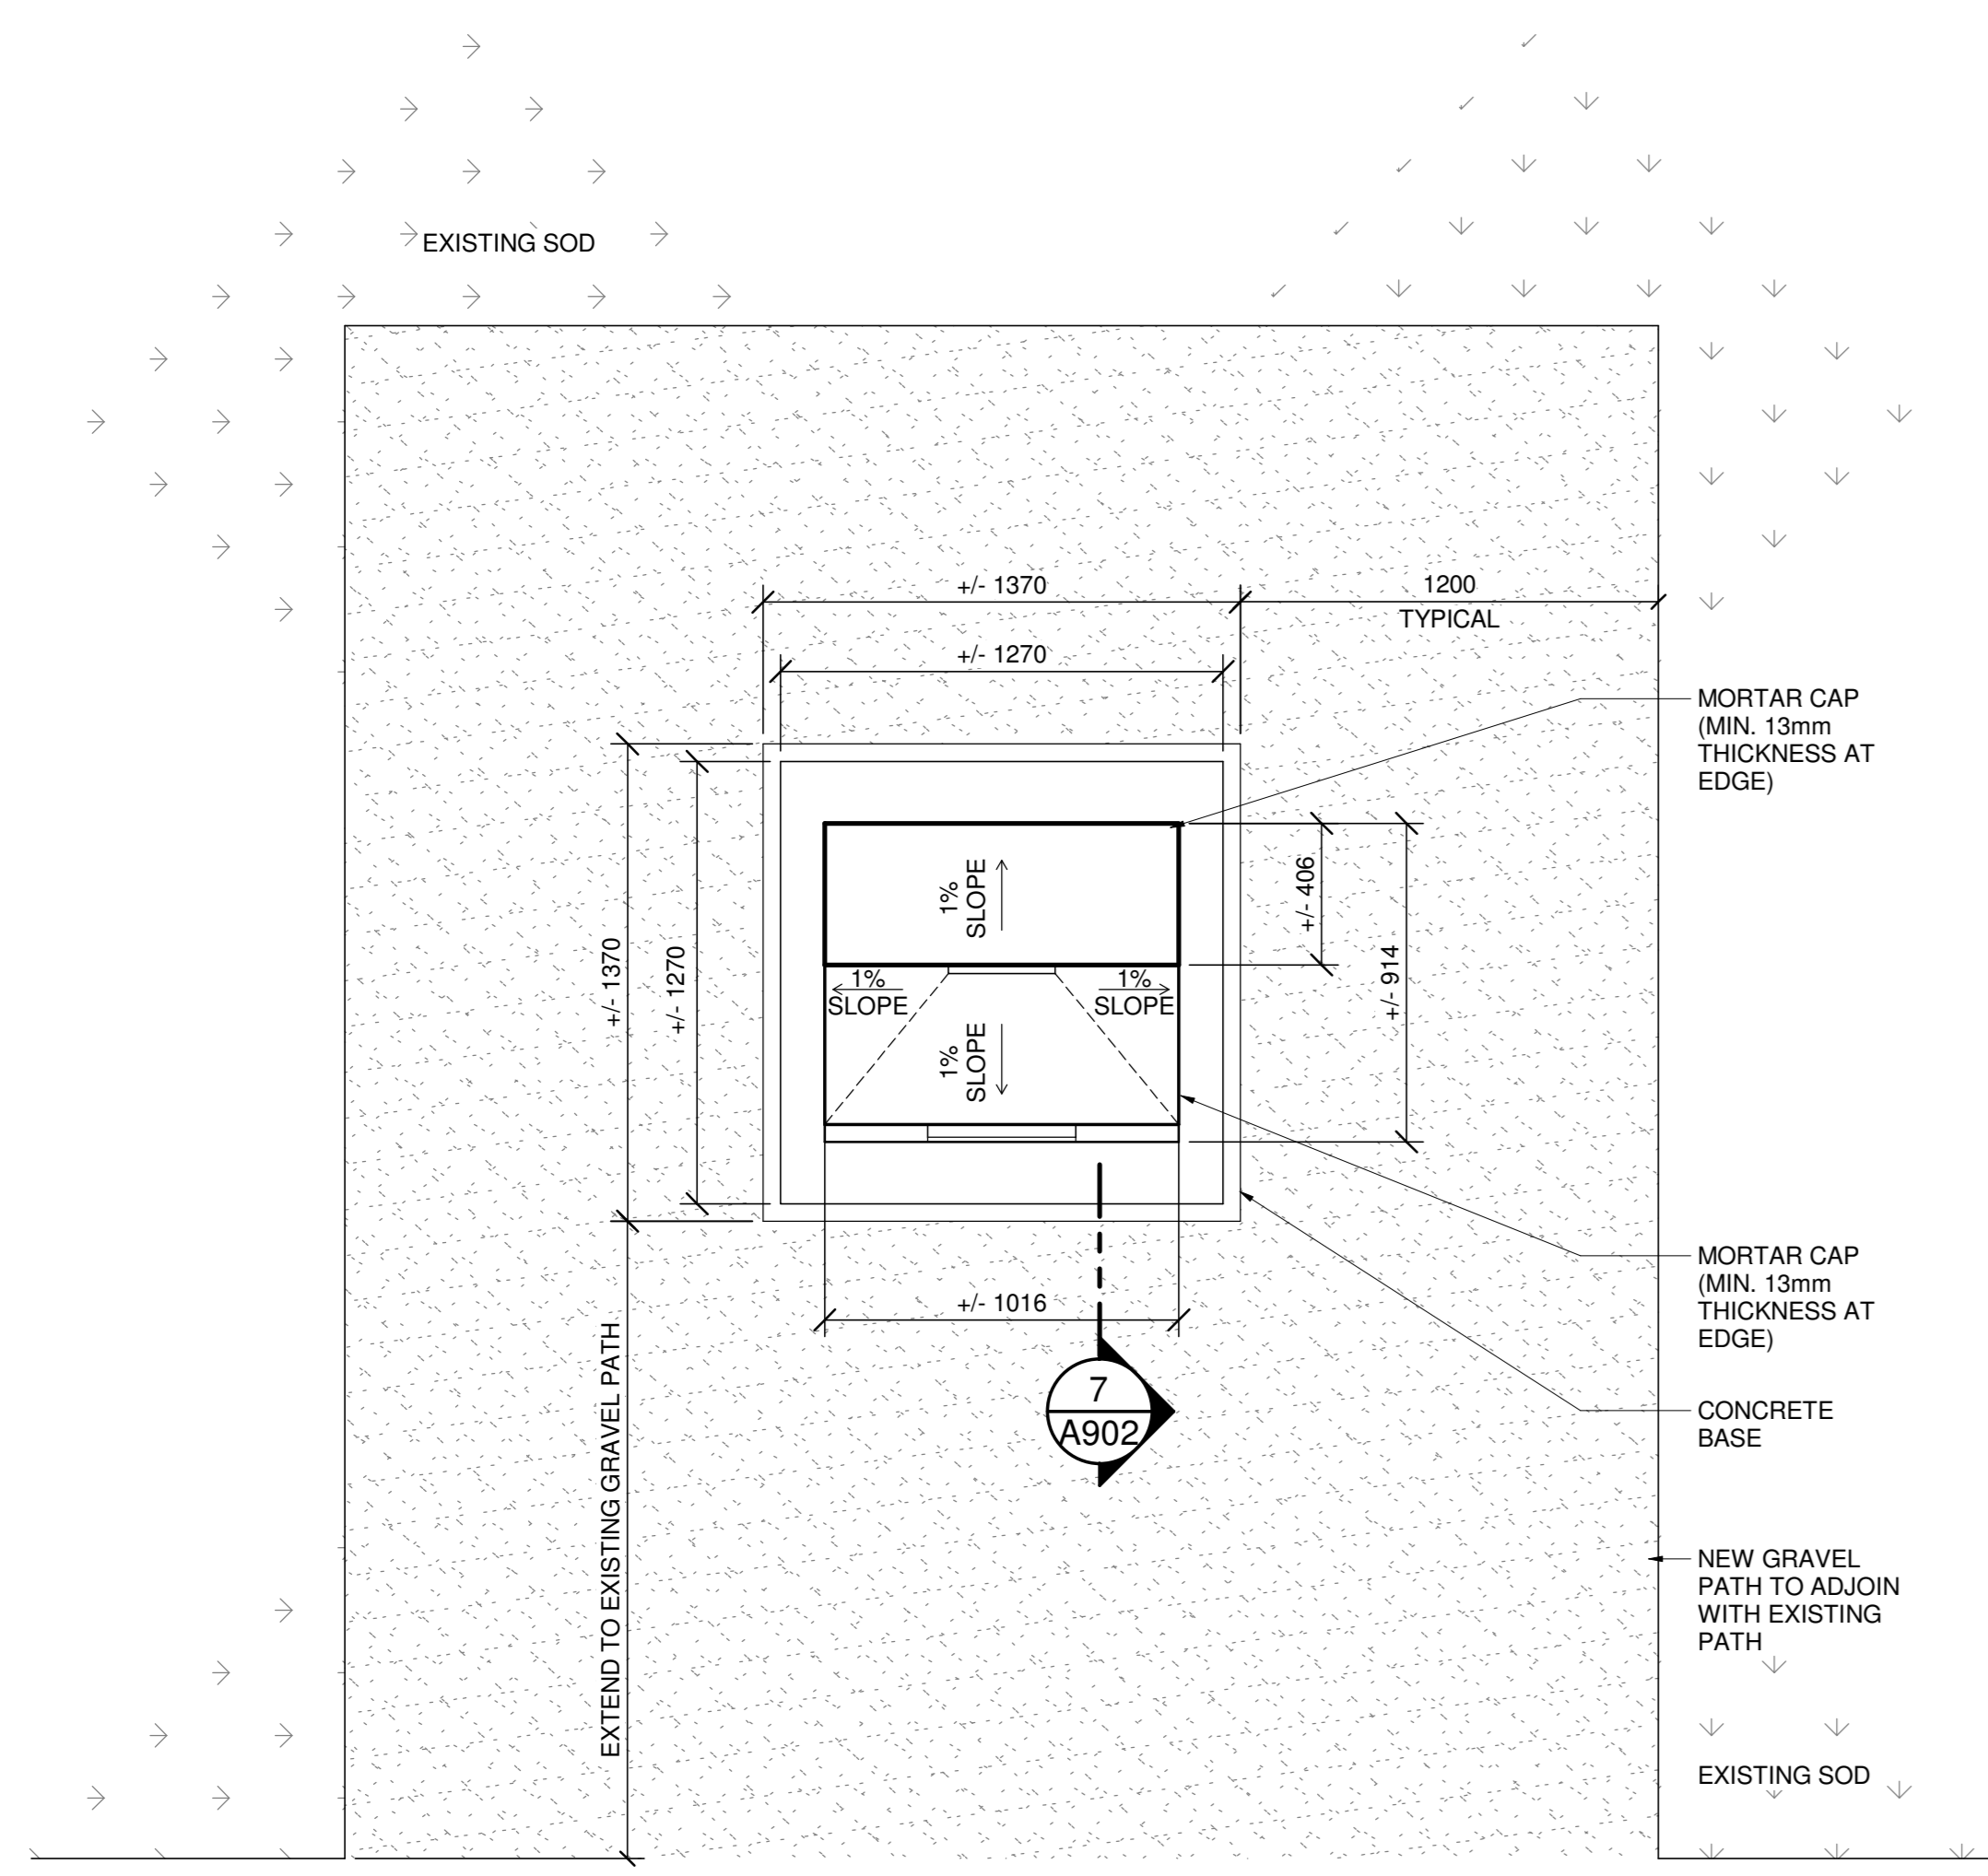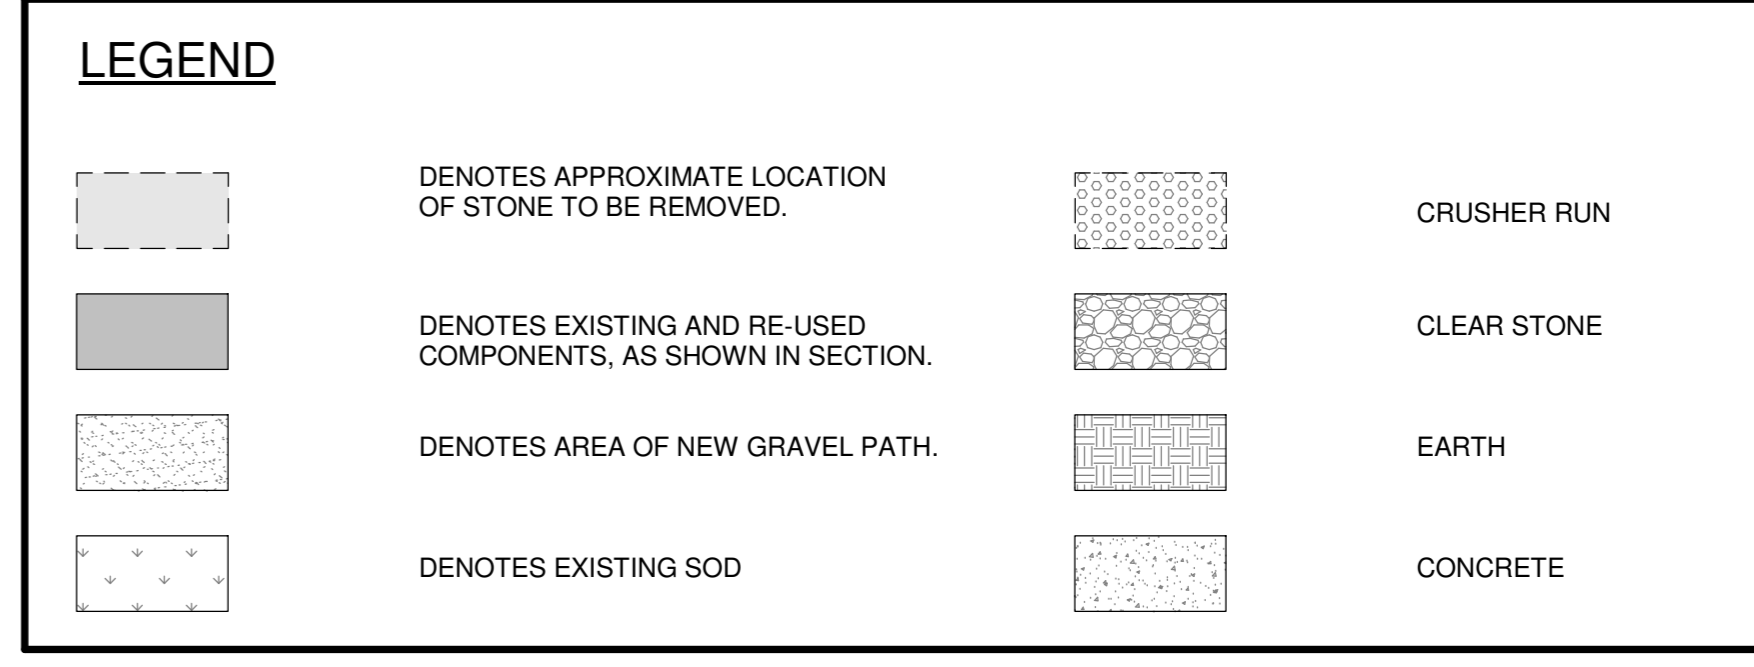


EXISTING PHOTOS - LONGFELLOW MONUMENT

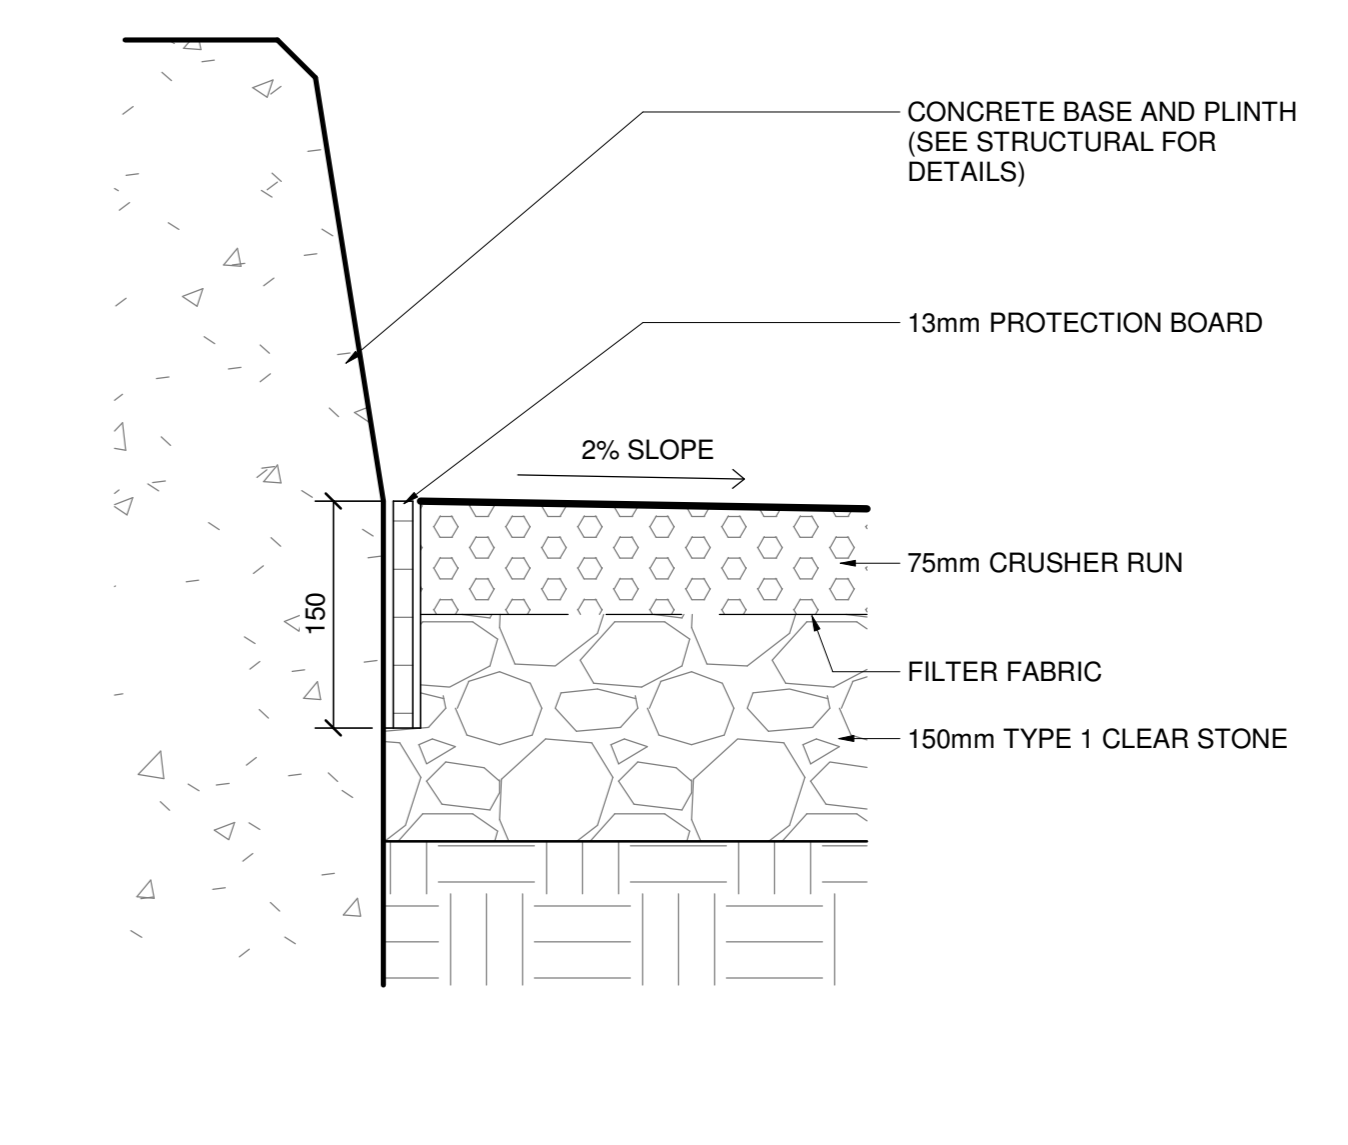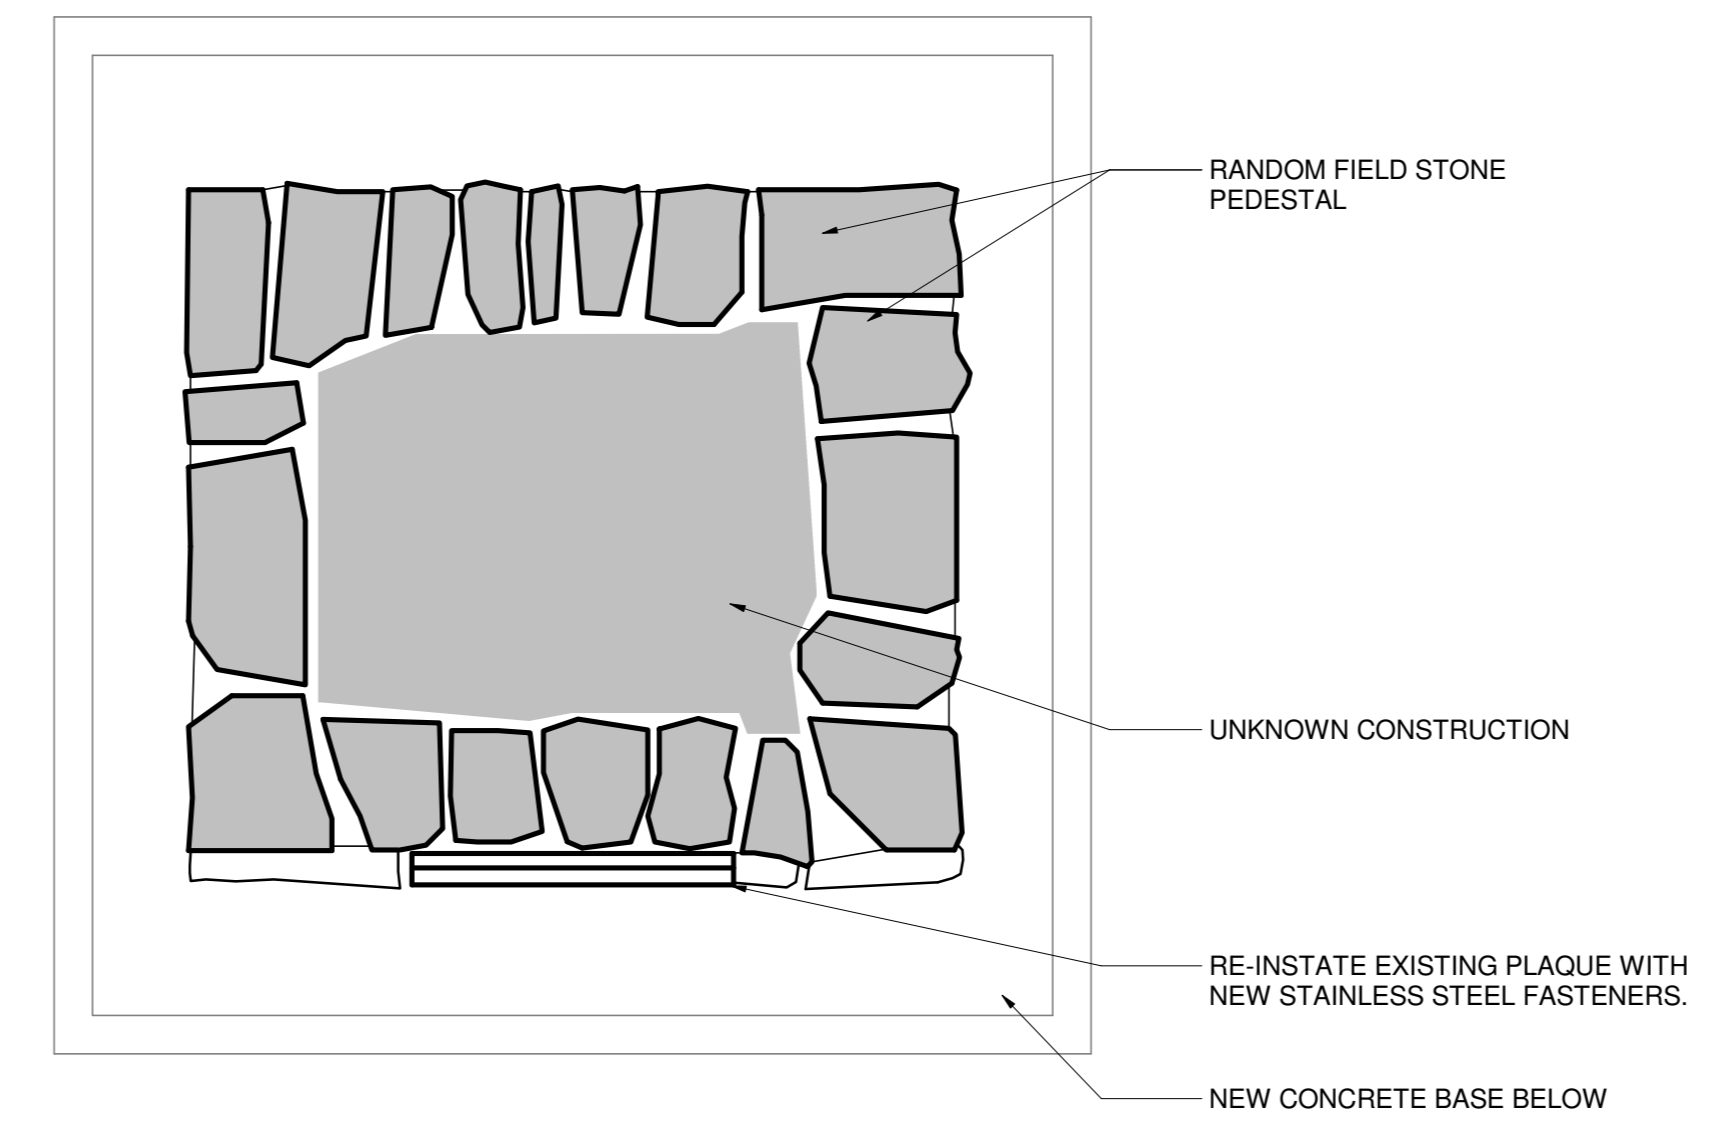


6 PLAN SECTION DETAIL
A902 1:10



7 BASE DETAIL
A902 1:5

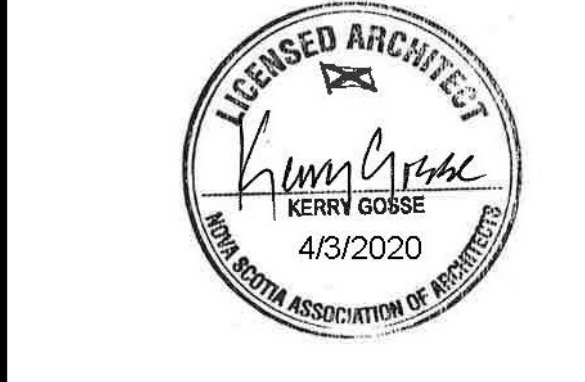


1	ISSUED FOR TENDER	02 APRIL 2020
revisions		date
project	GRAND-PRÉ NATIONAL HISTORIC SITE MEMORIAL CHURCH AND MONUMENTS REPOINTING	
drawing	LONGFELLOW MONUMENT	
designed	MT	conçu
date	08/28/19	
drawn	LL/MG	dessiné
date	08/28/19	
approved	KG	approuvé
date	08/28/19	
Tender	Submission	
PWGSC Project Manager	Administrateur de projets TPSGC	
project number	no. du projet	
	1241	
drawing no.	no. du dessin	
	A902	

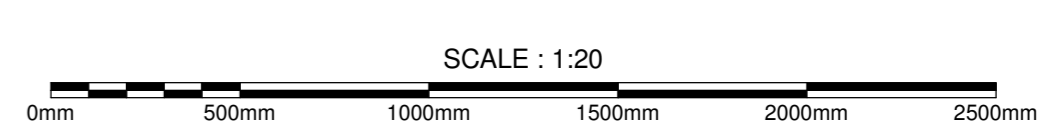


- GENERAL NOTES:**
1. PHOTOGRAPHIC AND AS-FOUND DIMENSIONS TO BE DOCUMENTED PRIOR TO START OF WORK.
 2. REMOVE PLAQUES. PROTECT AND STORE FOR RE-INSTALLATION.
 3. DISMANTLE THE TOP PORTION OF THE CROSS TO BELOW THE ARMS. CAREFULLY REMOVE MORTAR FROM STONES AND RETAIN STONES FOR RE-INSTALLATION.
 4. CUT OUT ALL FAILING MORTAR JOINTS TO SOUND MATERIAL.
 5. CLEAN REMAINING MORTAR AND STONES AS DIRECTED IN SPECIFICATION SECTION 04 03 01.13.2.2.3 TO REMOVE STAINING AND ORGANIC GROWTH.
 6. REPOINT MORTAR JOINTS.
 7. REBUILD TOP OF MONUMENT TO EXISTING DIMENSIONS AND CONFIGURATION WITH COMPATIBLE MORTAR.
 8. RE-INSTATE EXISTING PLAQUES WITH NEW STAINLESS STEEL FASTENERS.

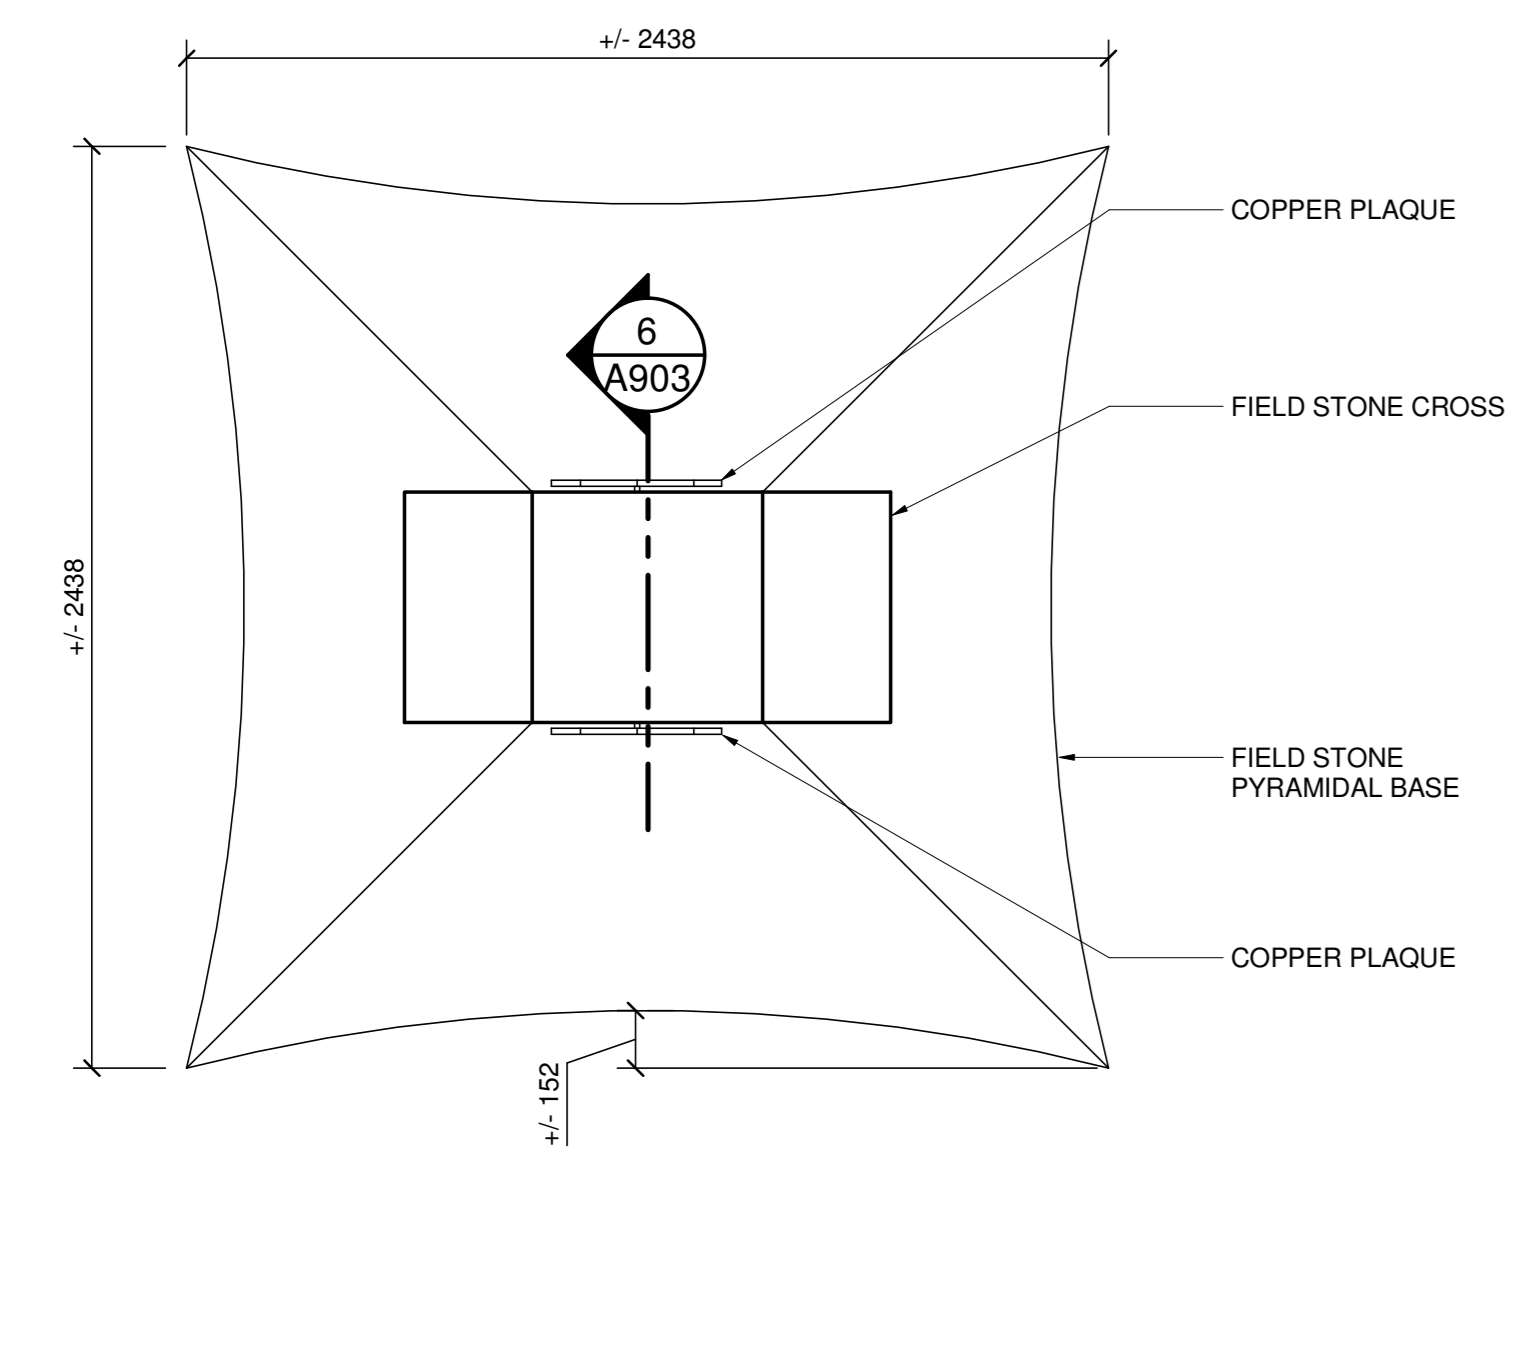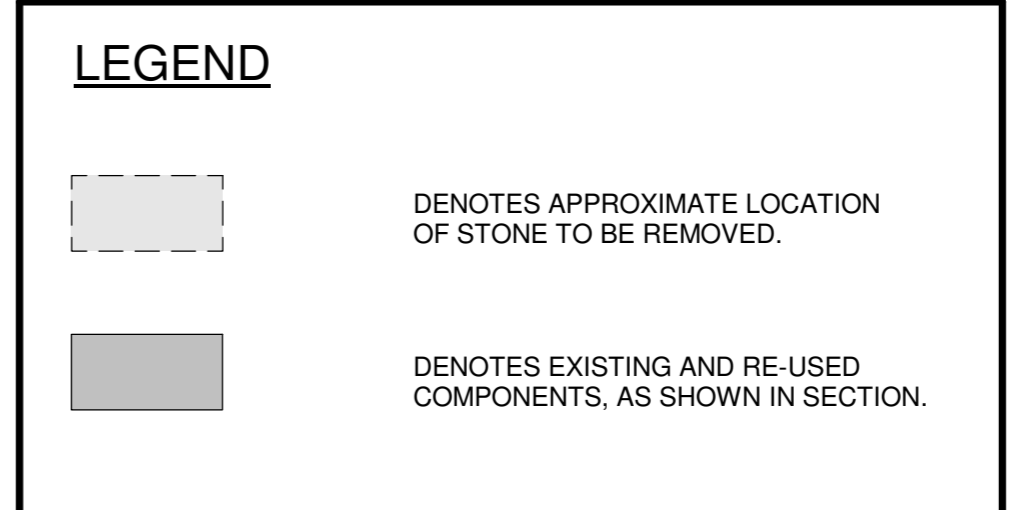


1 PLAN VIEW
A903 1:20

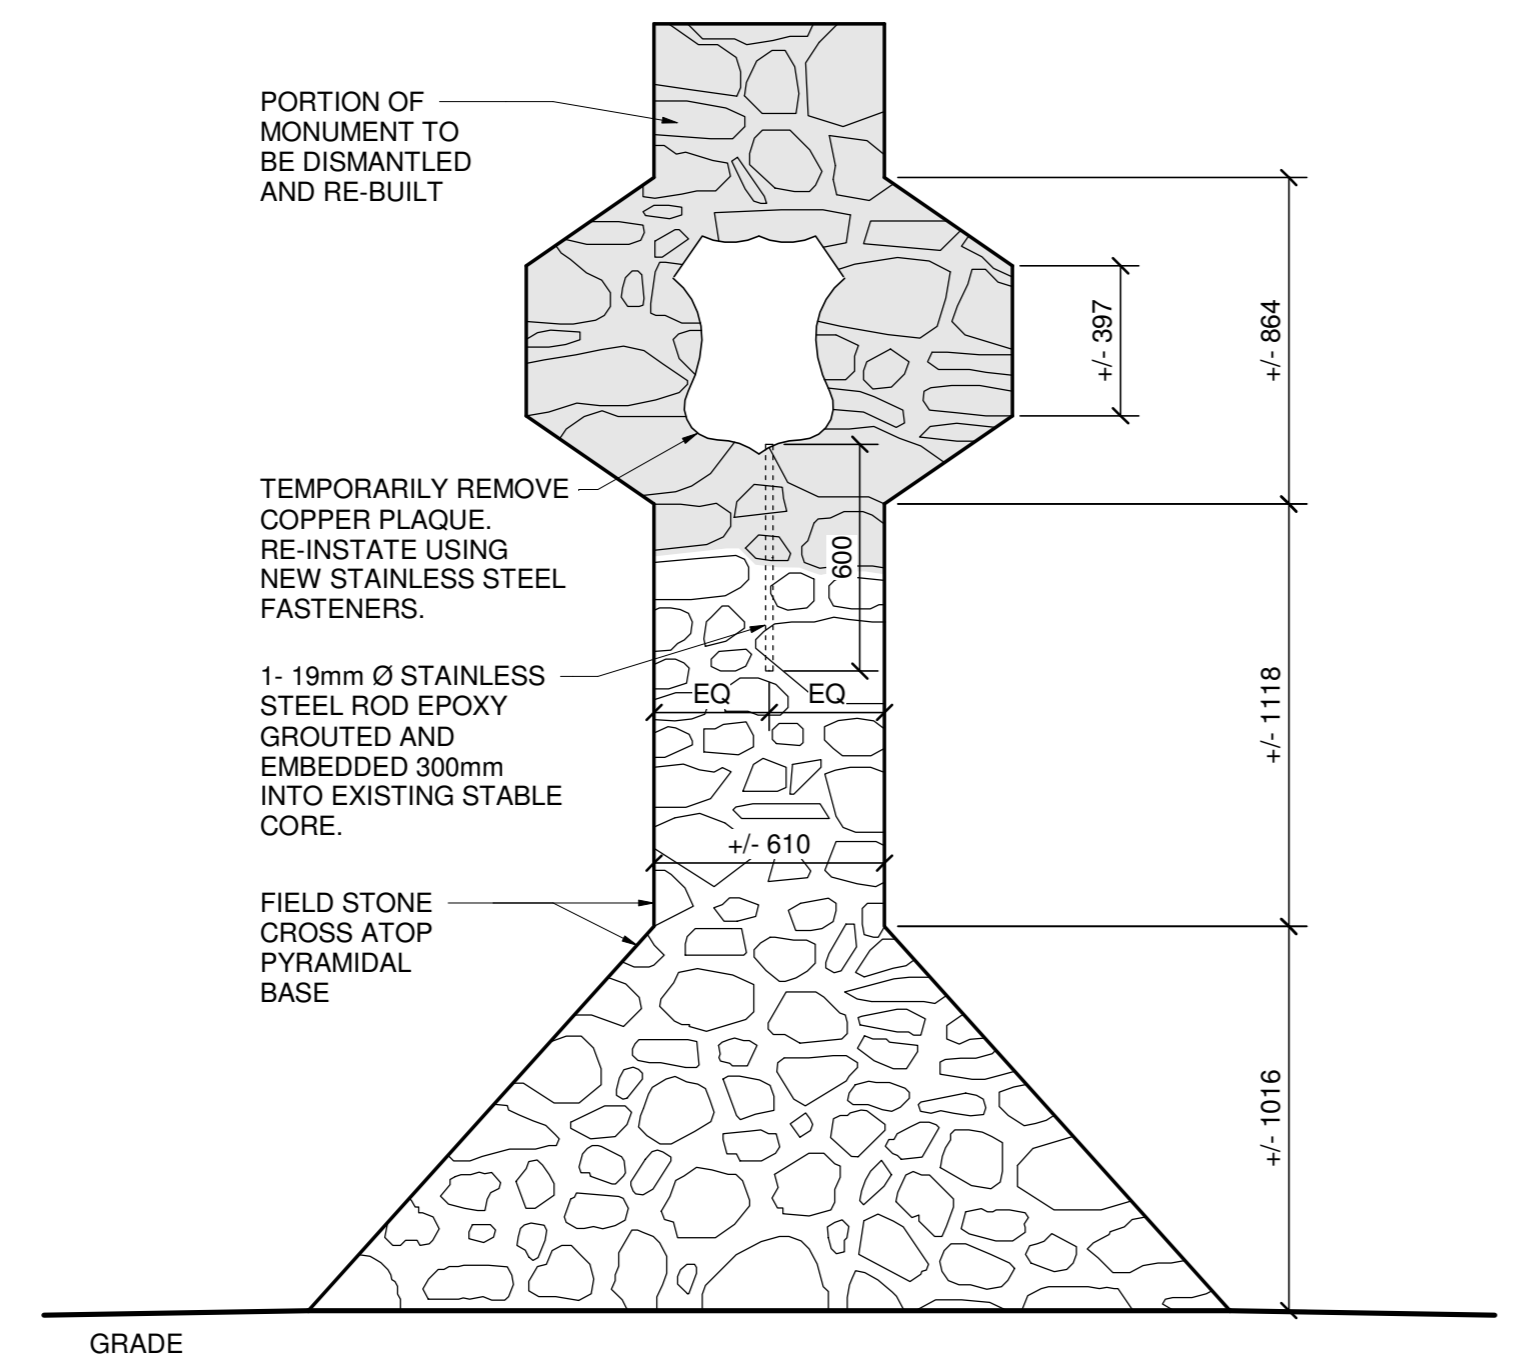


2 WEST (FRONT) ELEVATION
A903 1:20

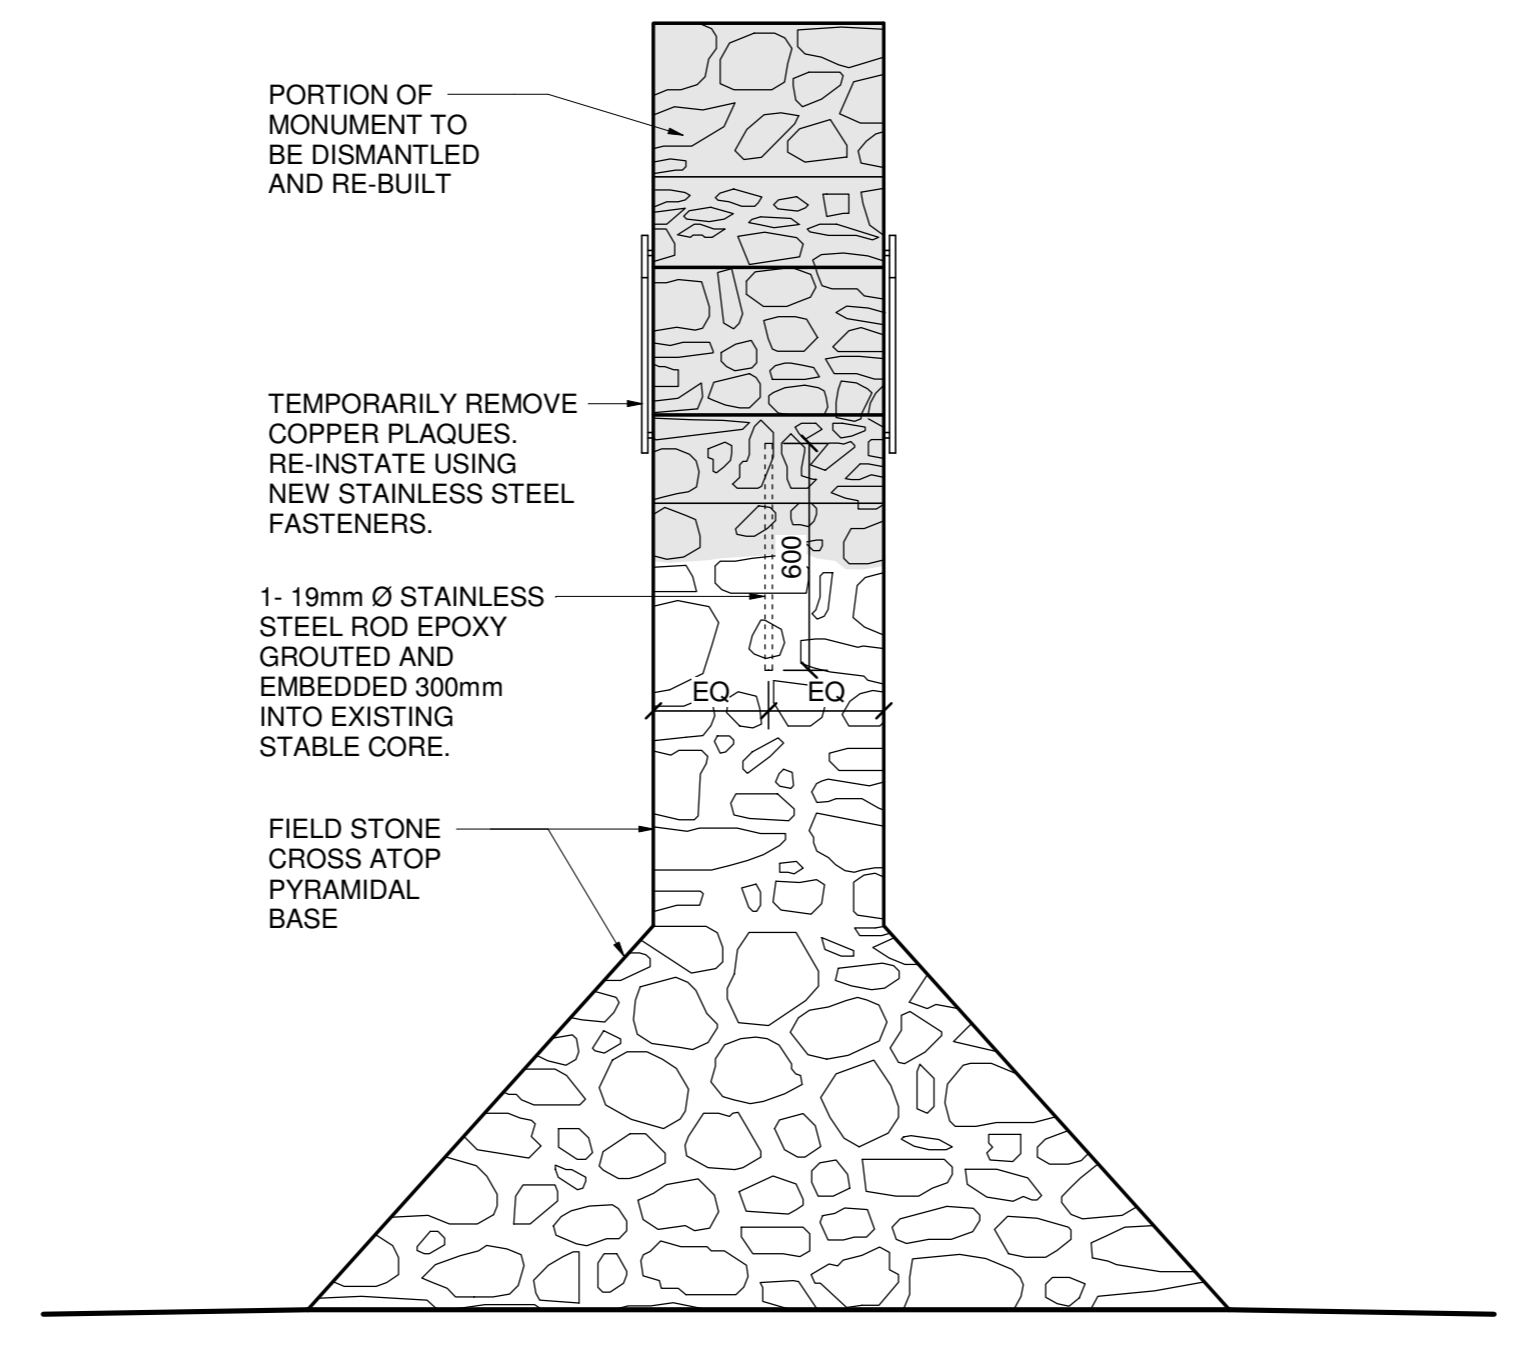


3 SOUTH ELEVATION
A903 1:20

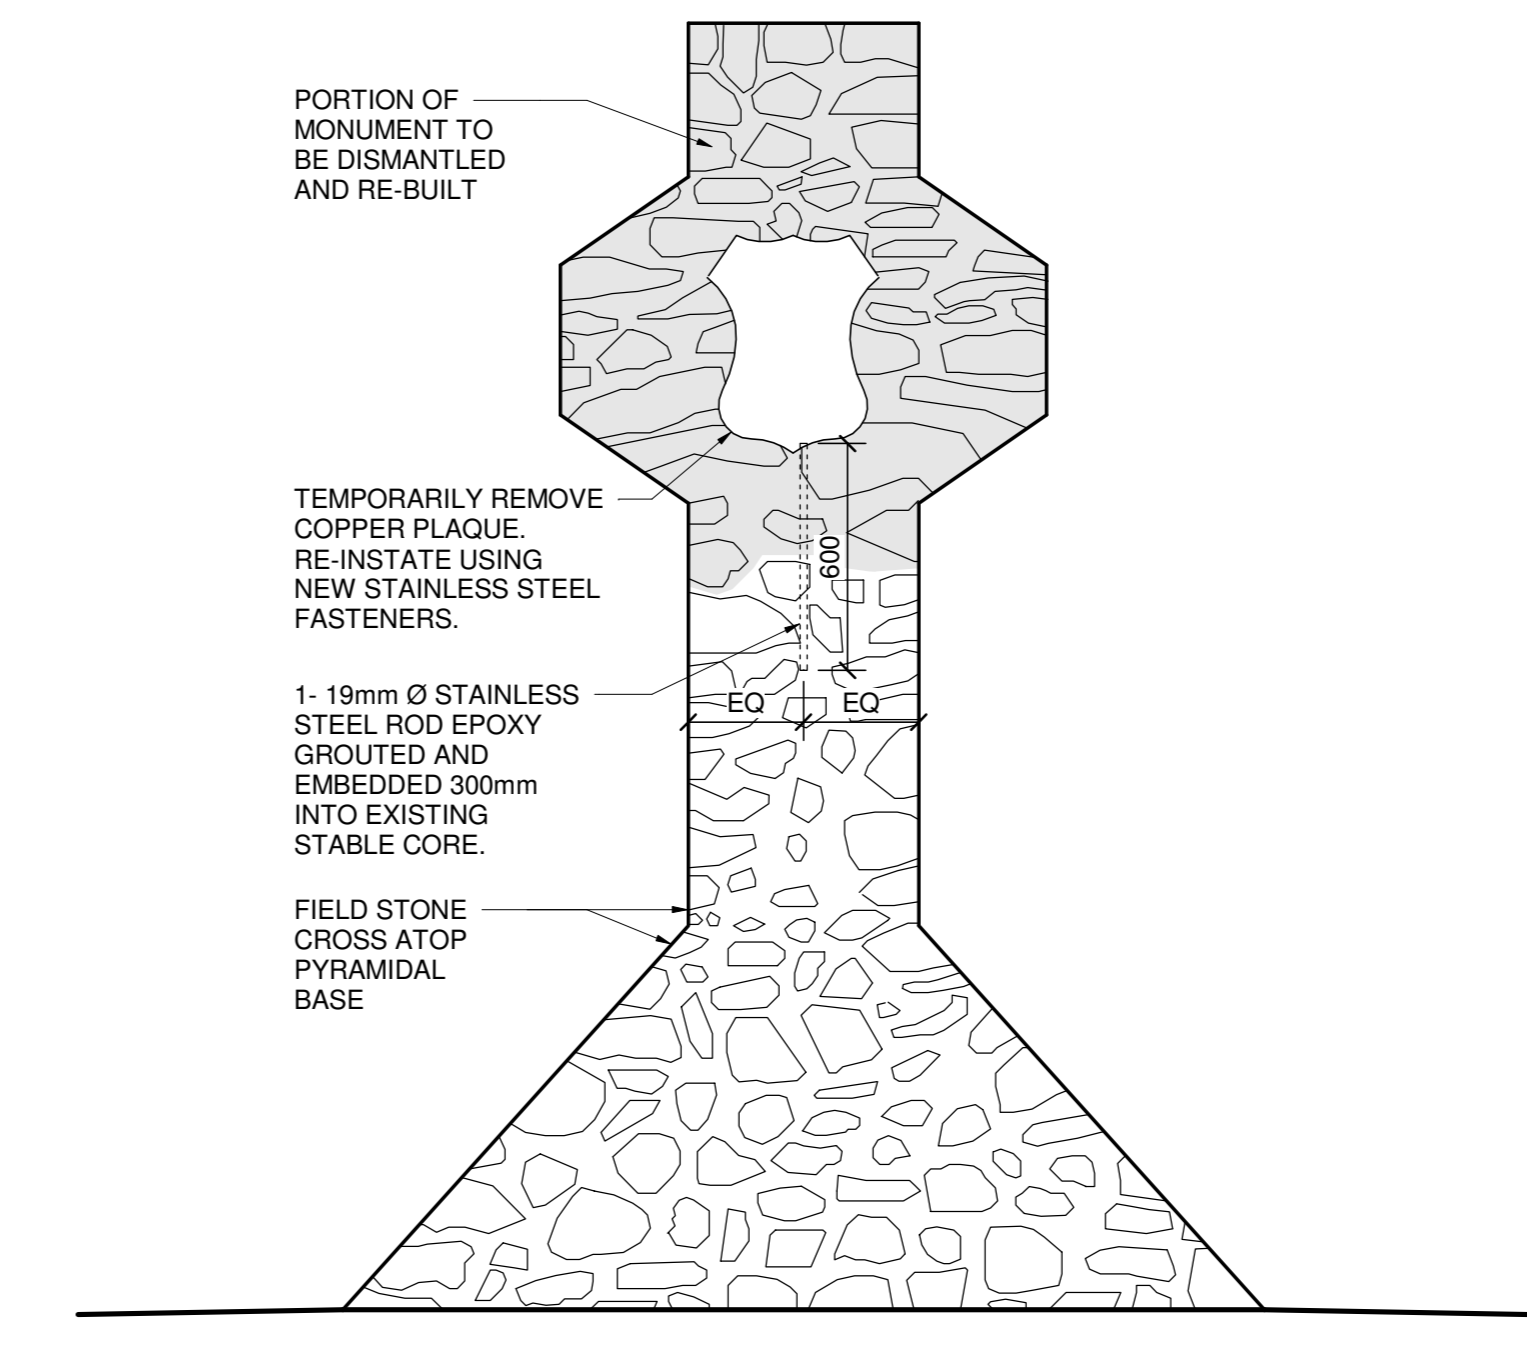

4 EAST (REAR) ELEVATION
A903 1:20

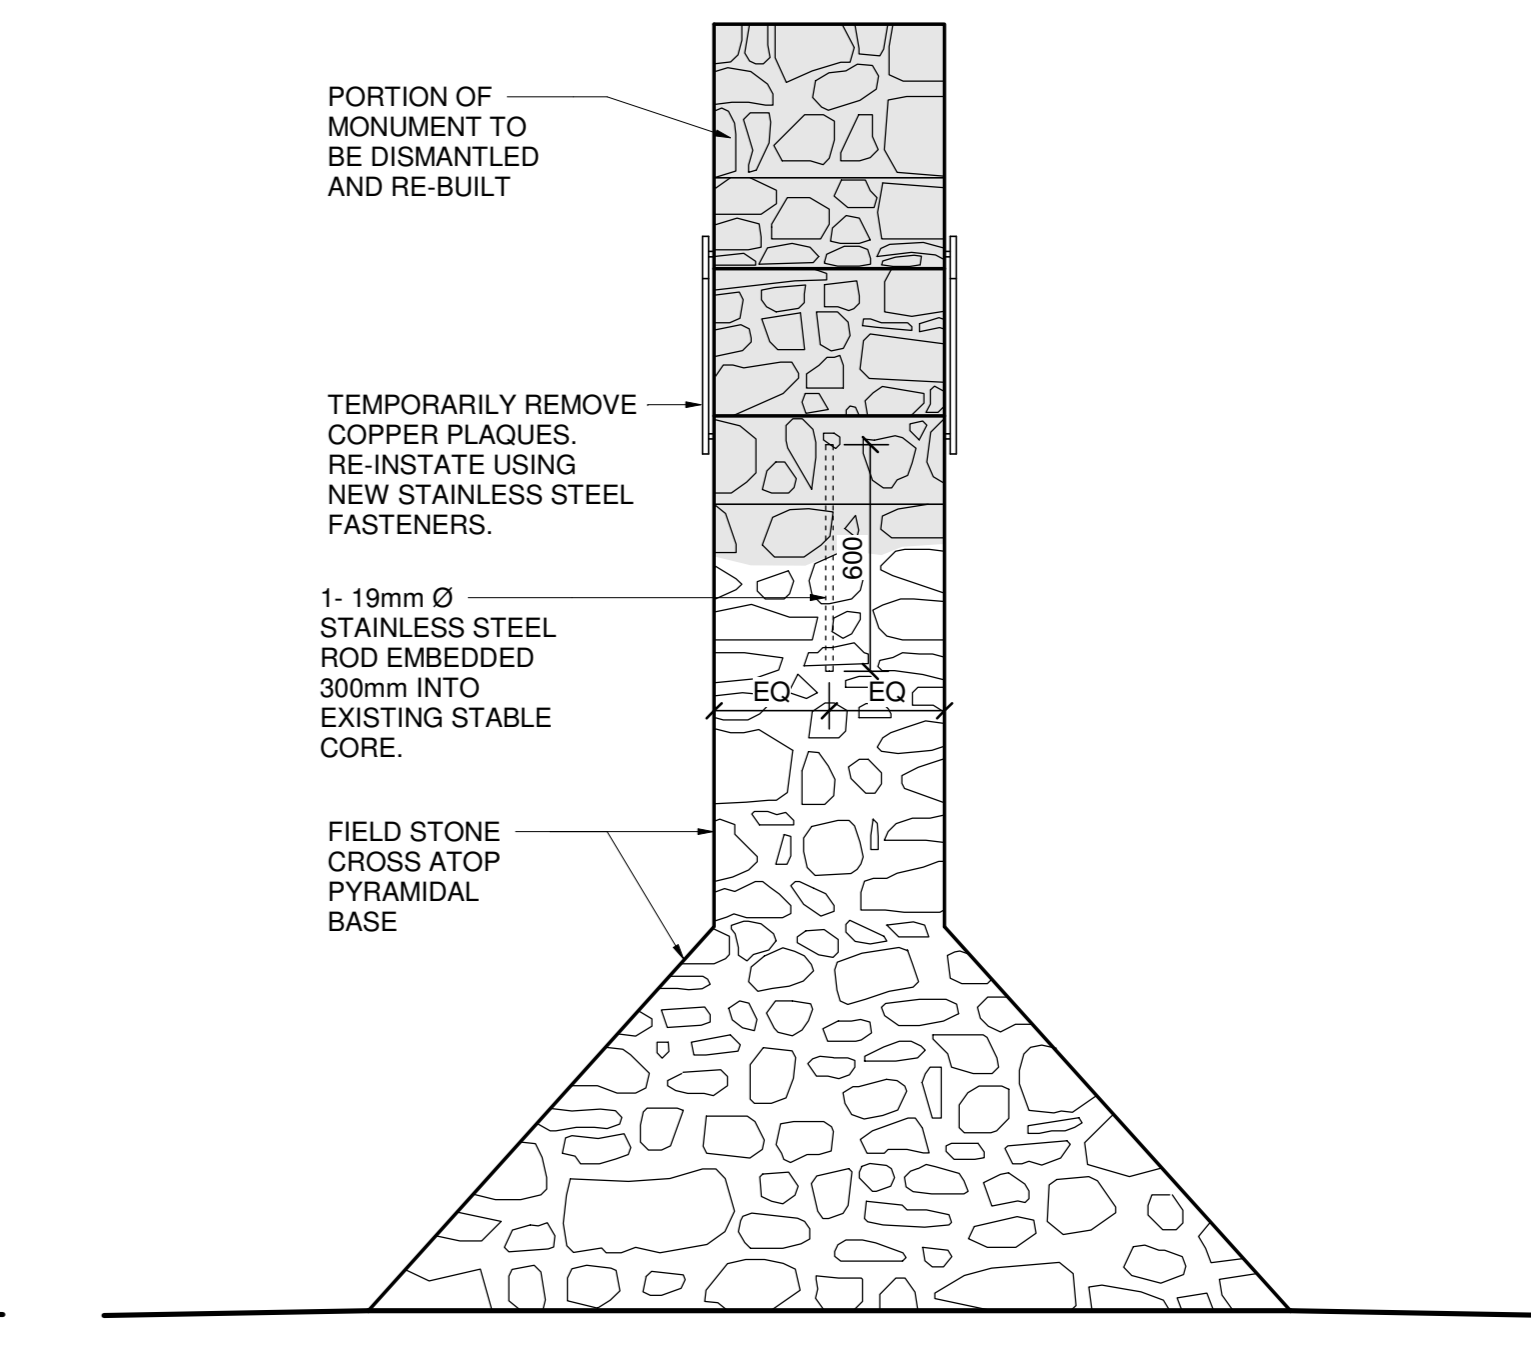


5 NORTH ELEVATION
A903 1:20

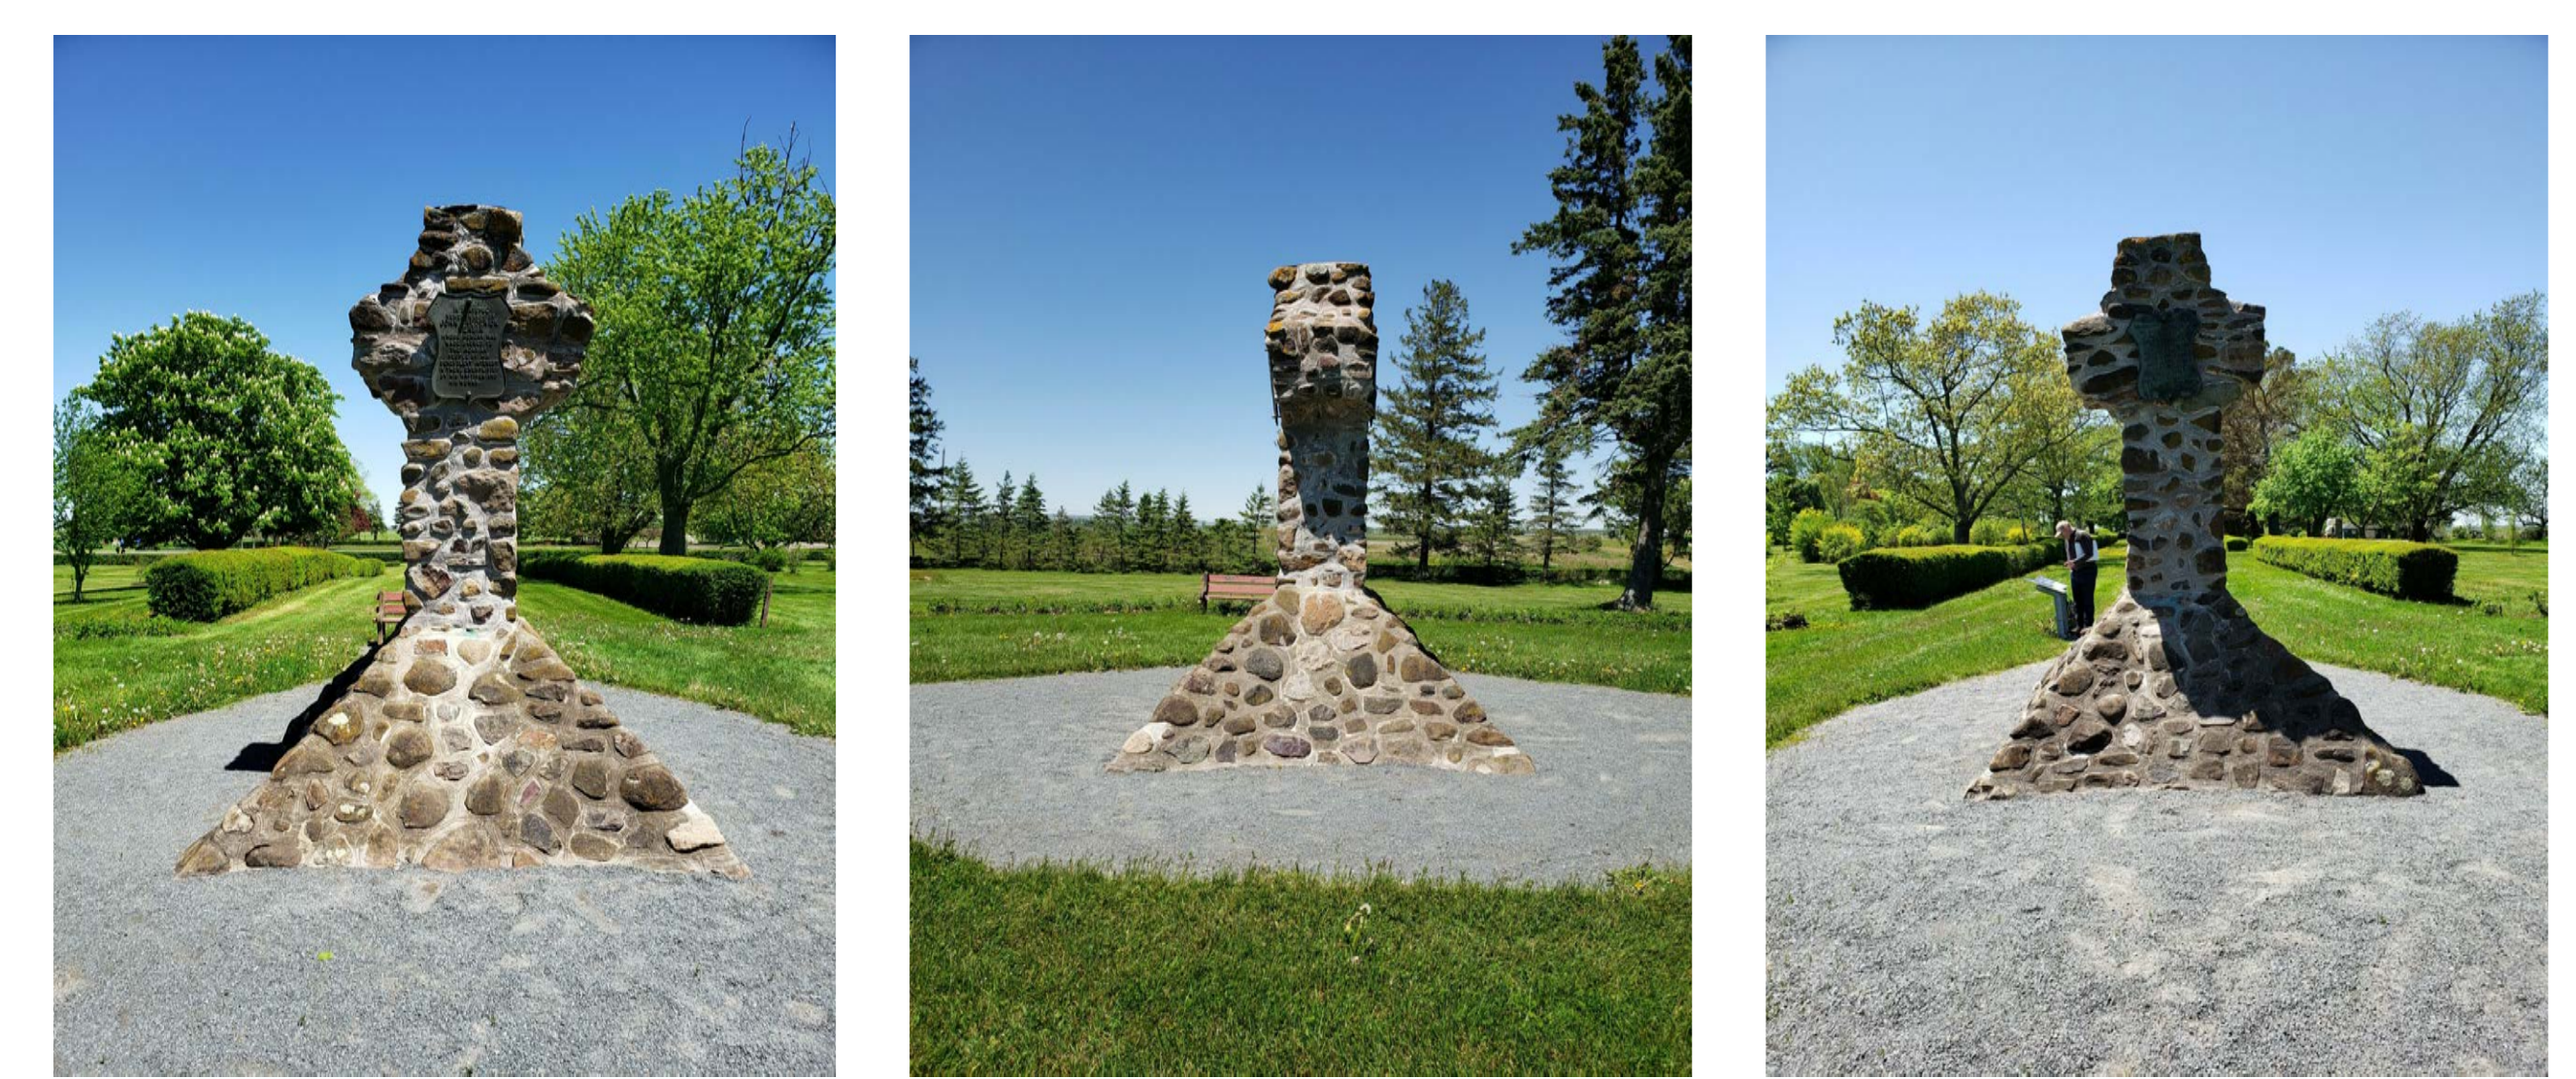


EXAMPLE OF ORGANIC GROWTH EXAMPLE OF STAINING

EXISTING PHOTOS - HERBIN CROSS


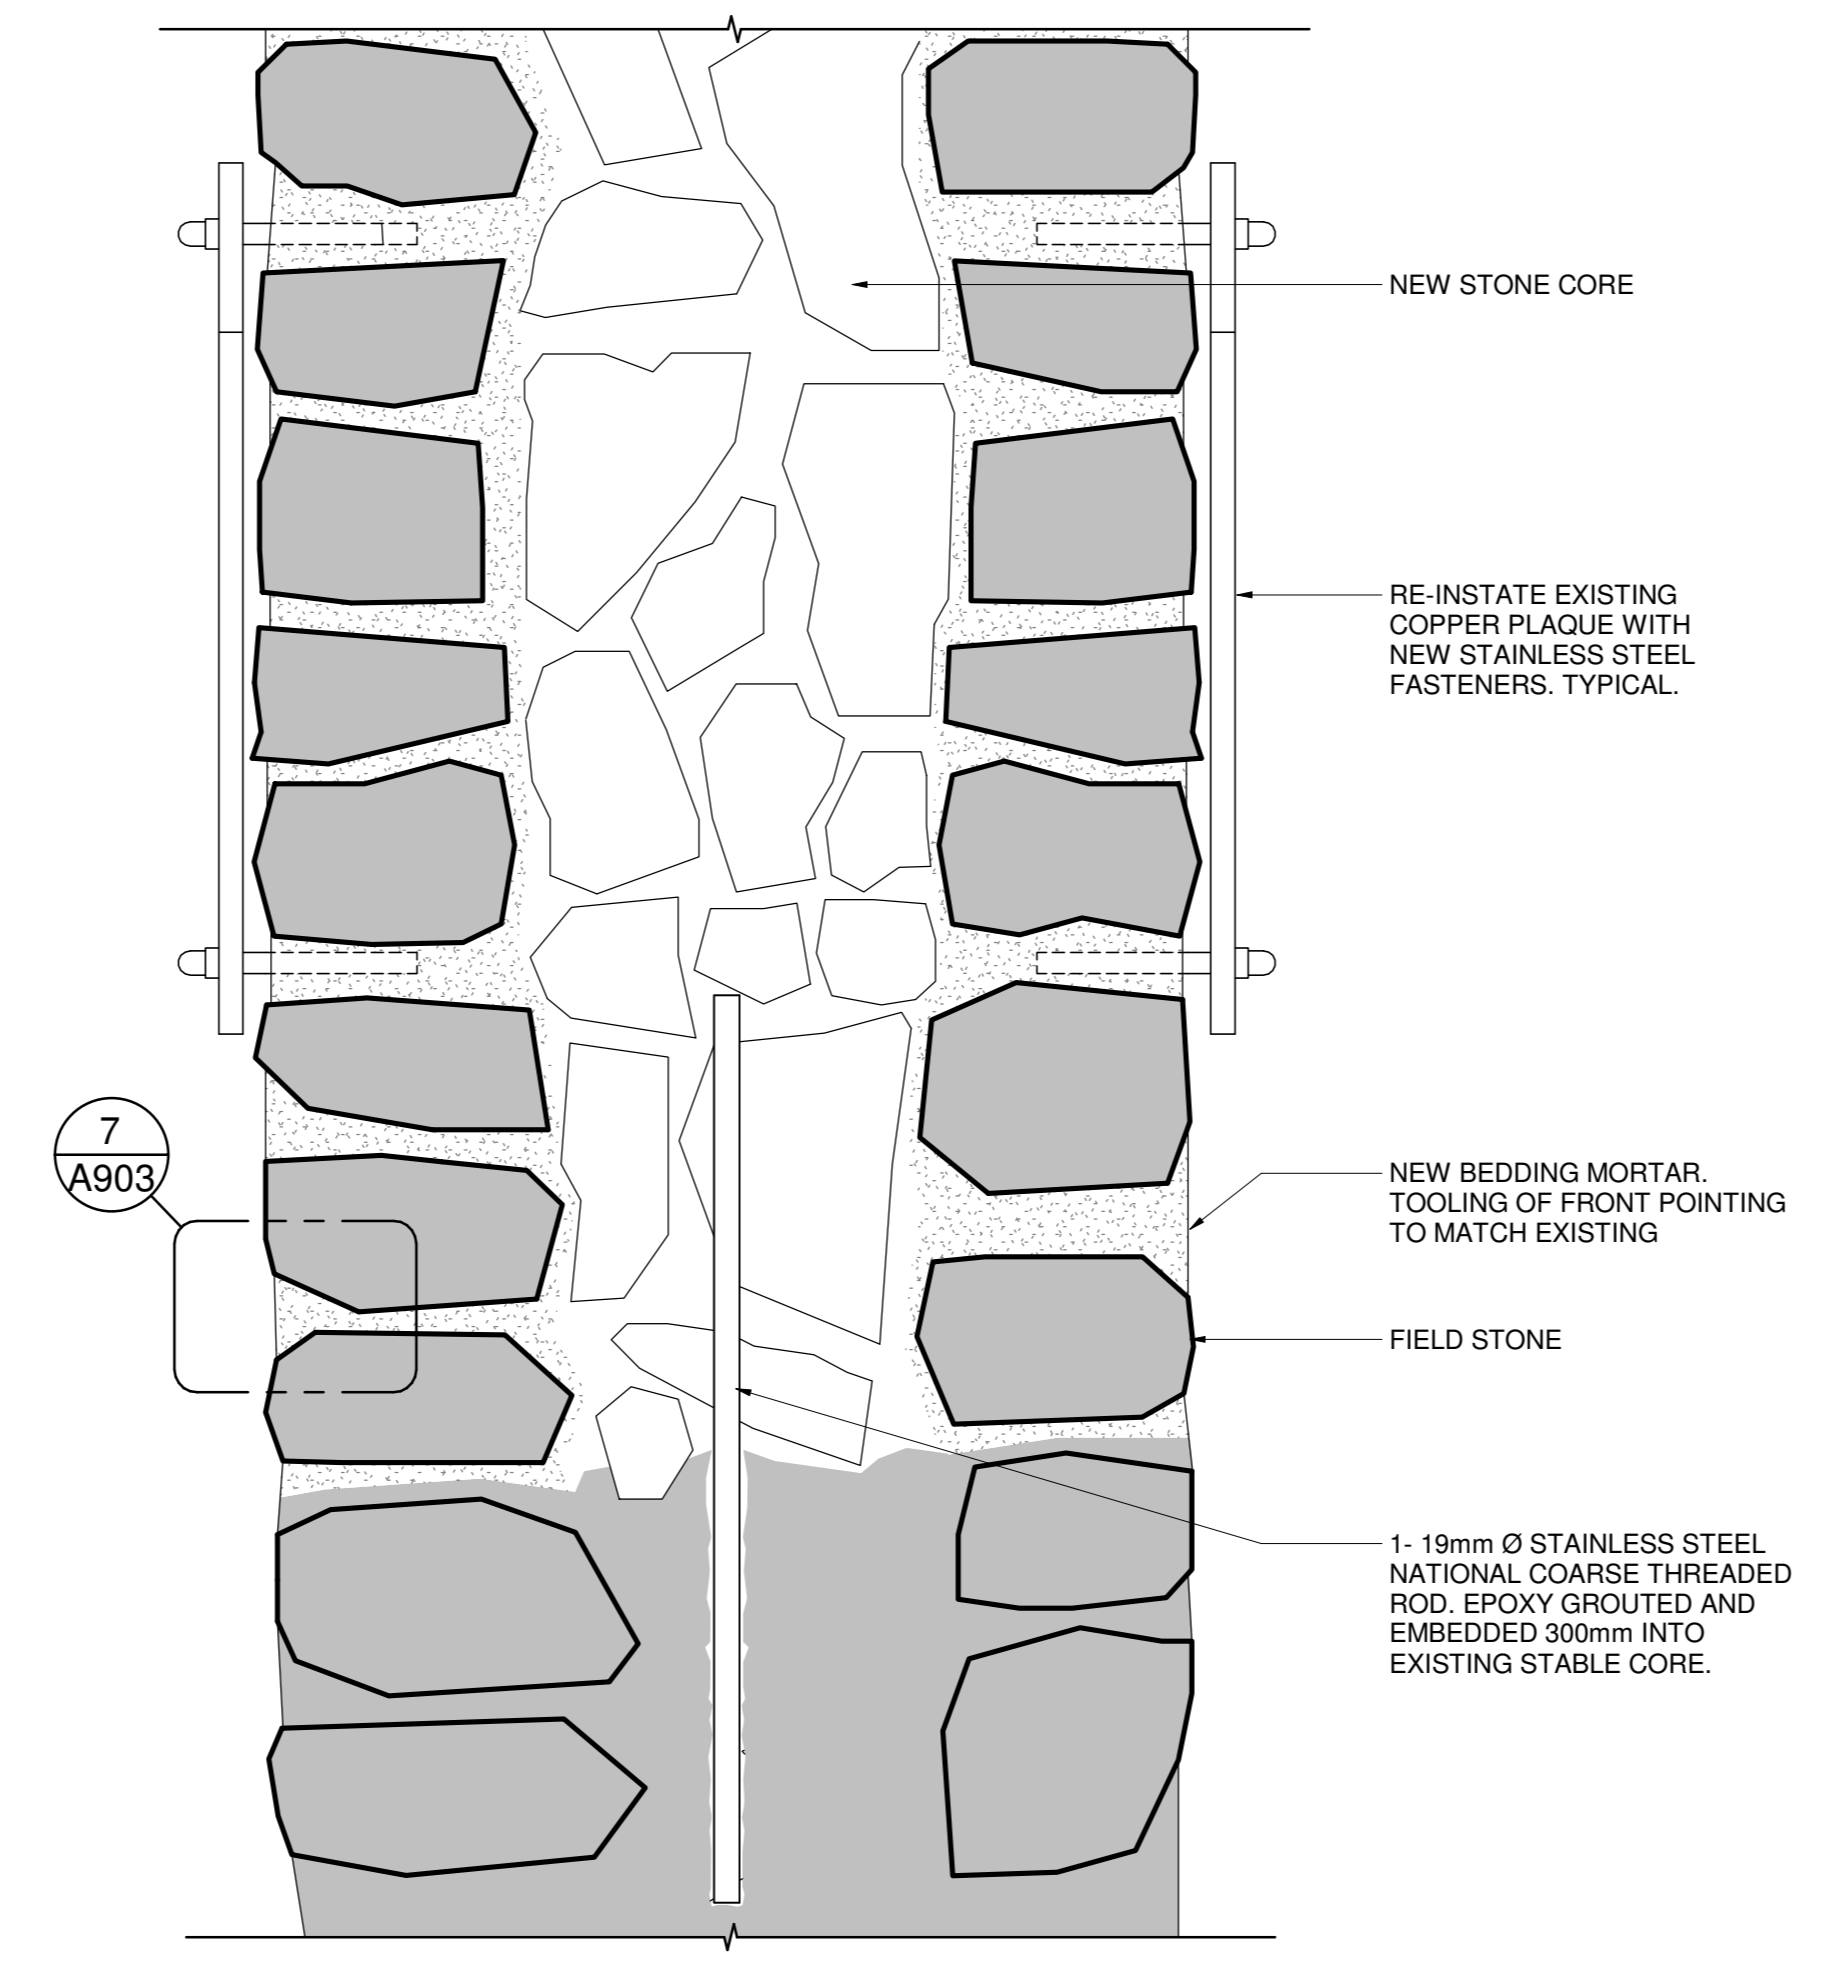


6 SECTION DETAIL
A903 1:5

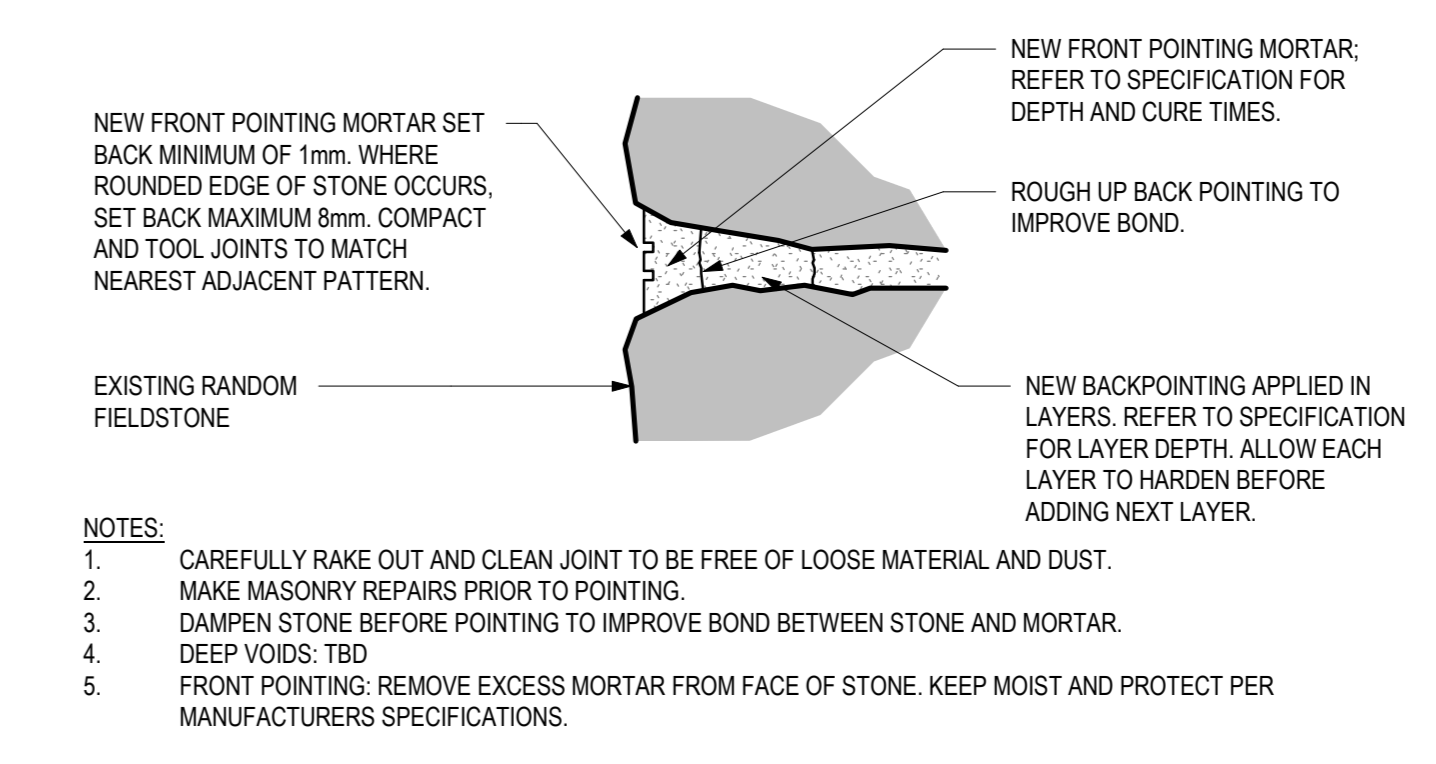

- NOTES:**
1. CAREFULLY RAKE OUT AND CLEAN JOINT TO BE FREE OF LOOSE MATERIAL AND DUST.
 2. MAKE MASONRY REPAIRS PRIOR TO POINTING.
 3. DAMPEN STONE BEFORE POINTING TO IMPROVE BOND BETWEEN STONE AND MORTAR.
 4. DEEP VOIDS: TBD
 5. FRONT POINTING: REMOVE EXCESS MORTAR FROM FACE OF STONE. KEEP MOIST AND PROTECT PER MANUFACTURERS SPECIFICATIONS.

7 HERBIN CROSS REPOINTING DETAIL
A903 N.T.S

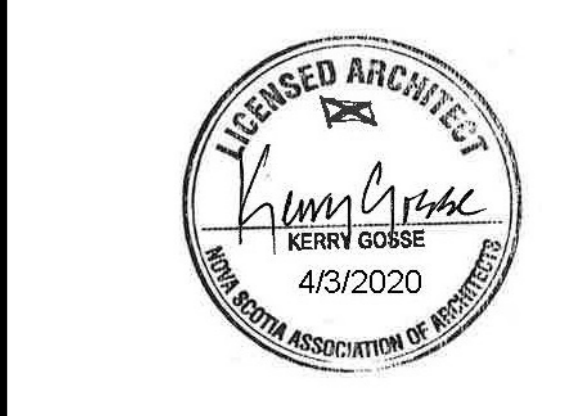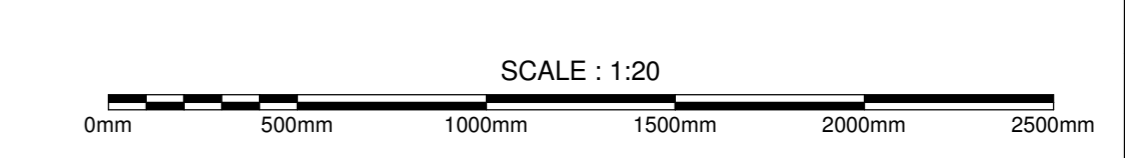


1	ISSUED FOR TENDER	03 APRIL 2020
revisions		date
project	GRAND-PRÉ NATIONAL HISTORIC SITE MEMORIAL CHURCH AND MONUMENTS REPOINTING	
drawing	HERBIN CROSS MONUMENT	
designed MT	corrup	
date	08/28/19	
drawn LL/MG	dessiné	
date	08/28/19	
approved KG	approuvé	
date	08/28/19	
Tender	Submission	
PWGCSC Project Manager	Administrateur de projets TPSCG	
project number	no. du projet	1241
drawing no.	no. du dessin	A903


- GENERAL NOTES:**
1. PHOTOGRAPHIC AND AS-FOUND DIMENSIONS TO BE DOCUMENTED PRIOR TO START OF WORK.
 2. REMOVE PLAQUE, PROTECT AND STORE FOR RE-INSTALLATION.
 3. DISMANTLE MONUMENT AND CAREFULLY REMOVE MORTAR FROM STONES AND RETAIN STONES FOR RE-INSTALLATION.
 4. POUR NEW CONCRETE BASE, SEE STRUCTURAL.
 5. CLEAN STONES, AS DIRECTED IN SPECIFICATION SECTION 04 03 01.13.2.2.3 TO REMOVE ORGANIC GROWTH.
 6. REBUILD MONUMENT TO EXISTING DIMENSIONS AND CONFIGURATION WITH COMPATIBLE MORTAR.
 7. NEW CONCRETE CAP TO MATCH EXISTING DIMENSIONS.
 8. RE-INSTATE EXISTING PLAQUE USING NEW STAINLESS STEEL FASTENERS.
 9. REGRADE AREA AROUND THE MONUMENT TO PROMOTE WATER SHEDDING AWAY FROM THE BASE.

LEGEND


- DENOTES APPROXIMATE LOCATION OF STONE TO BE REMOVED.
- DENOTES EXISTING AND RE-USED COMPONENTS, AS SHOWN IN SECTION.
- DENOTES AREA OF NEW GRAVEL PATH.
- DENOTES EXISTING SOD

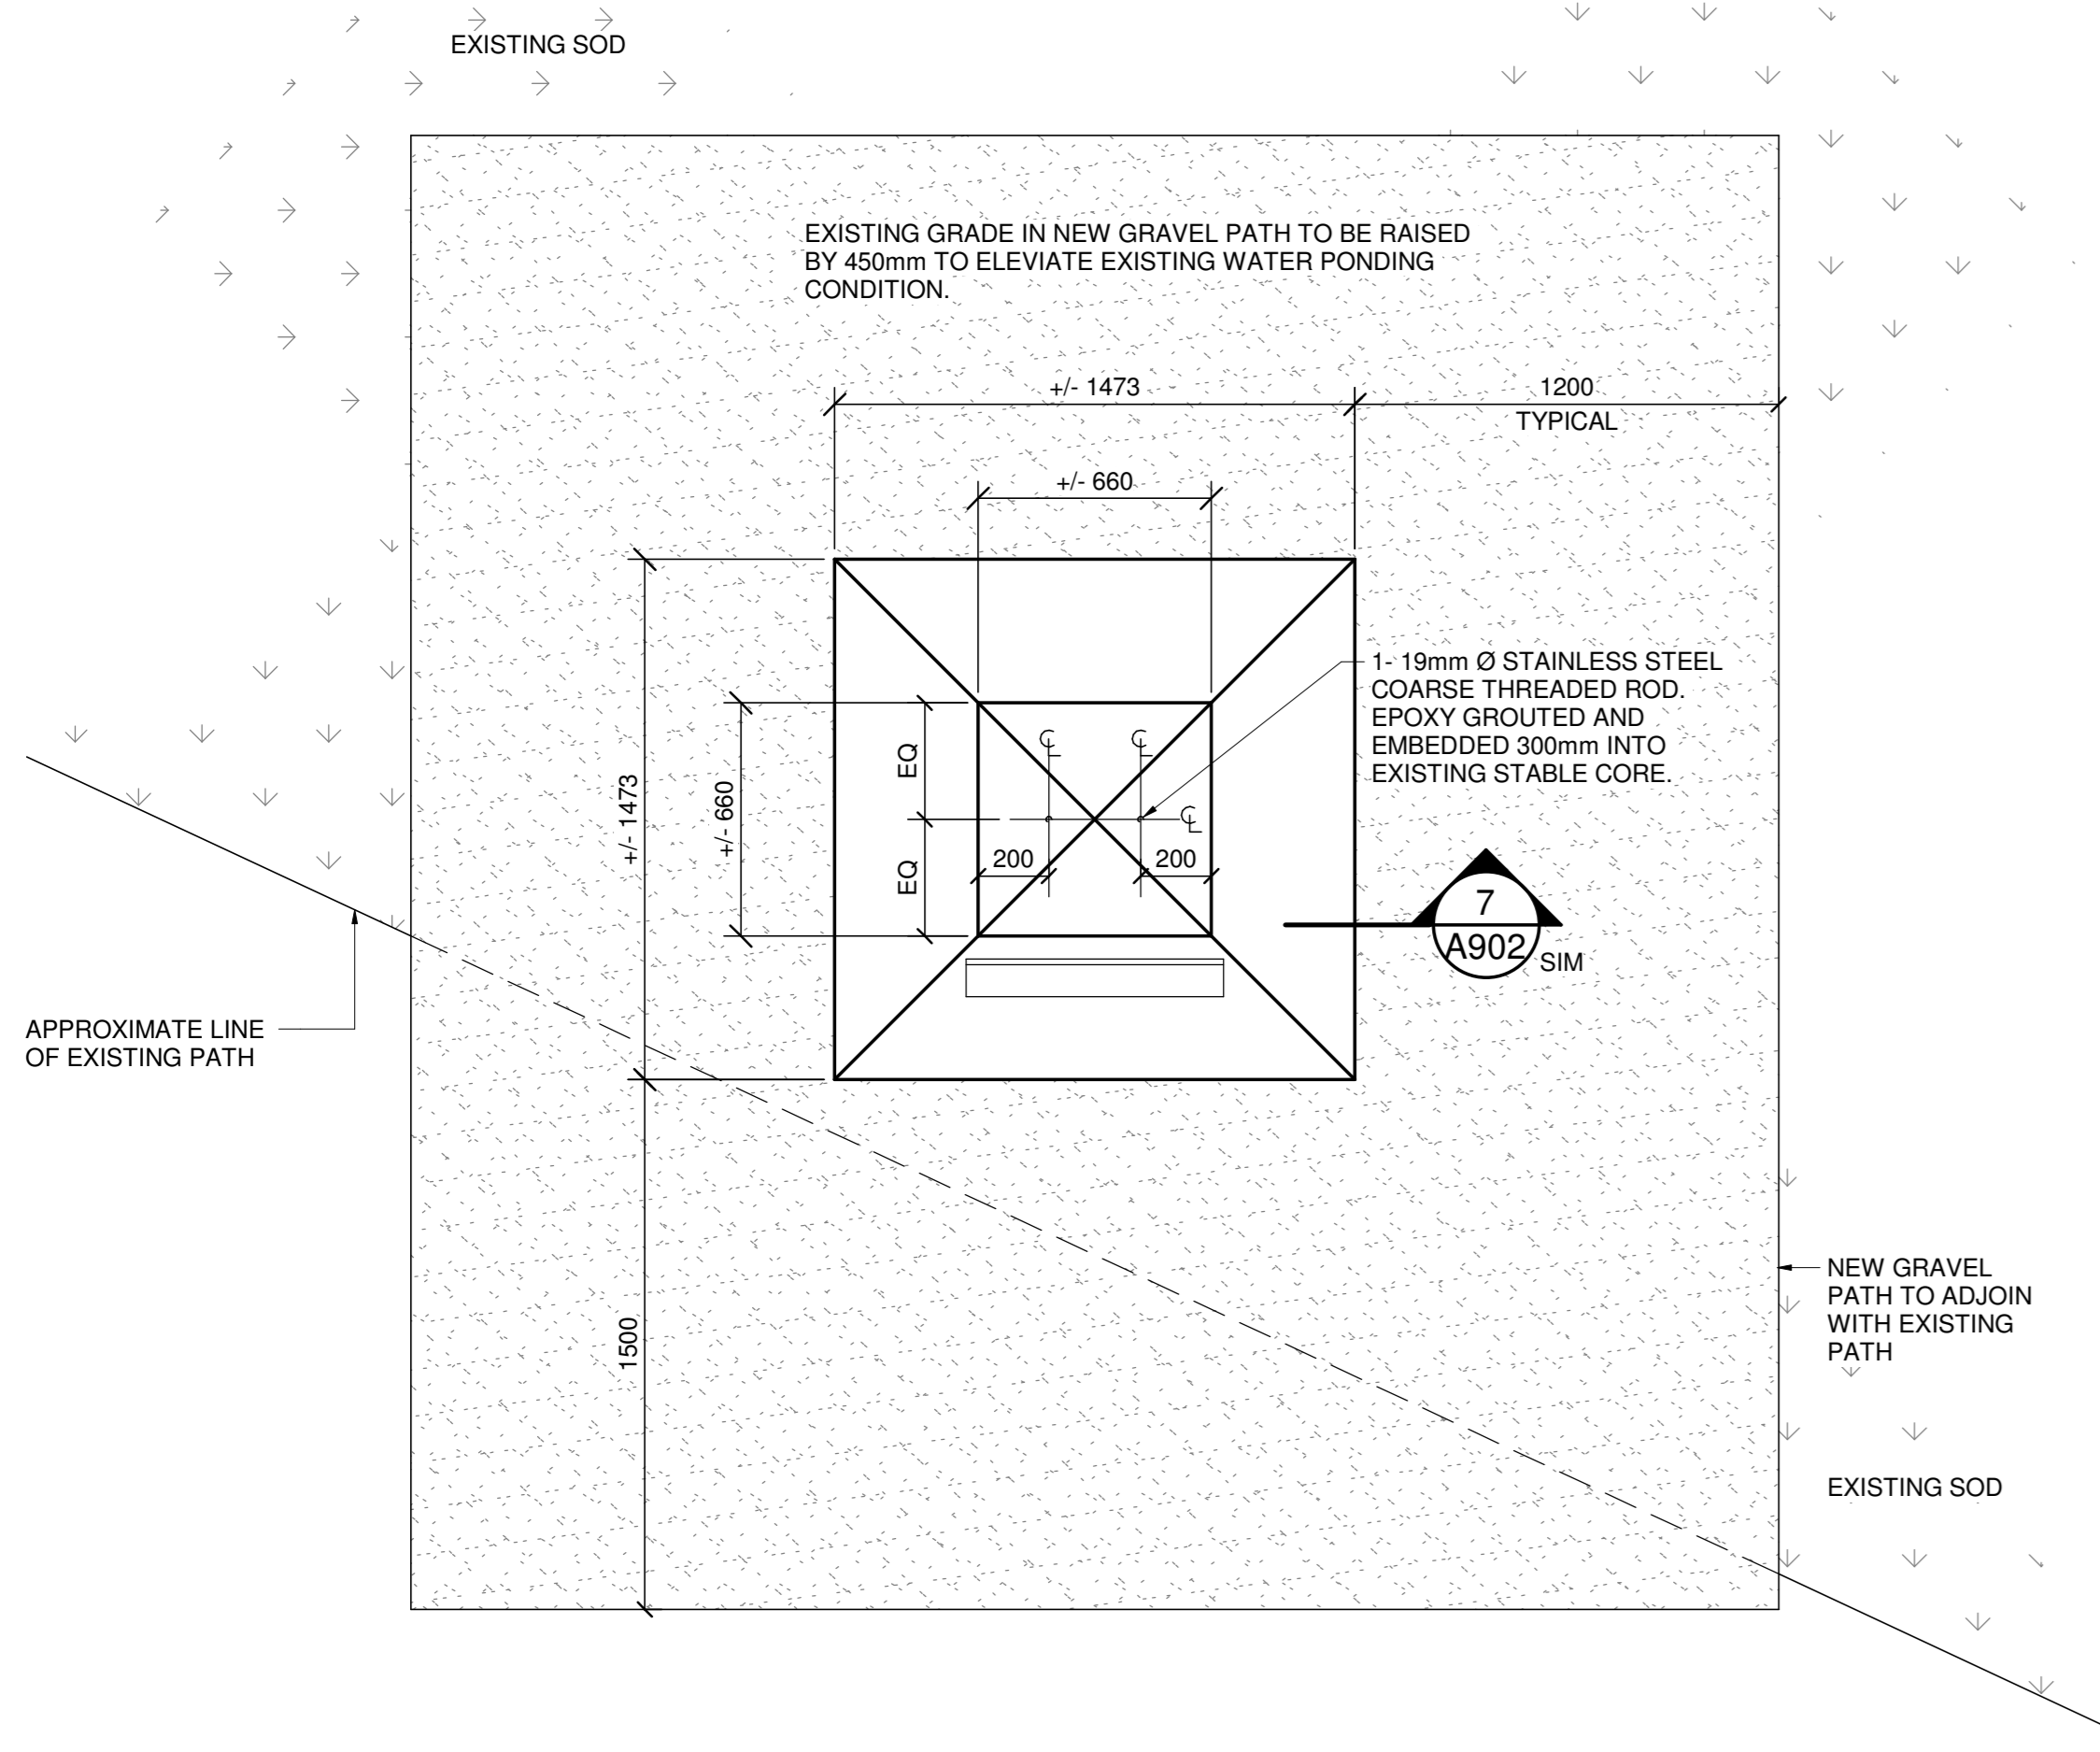


1 PLAN VIEW
A904 1:20

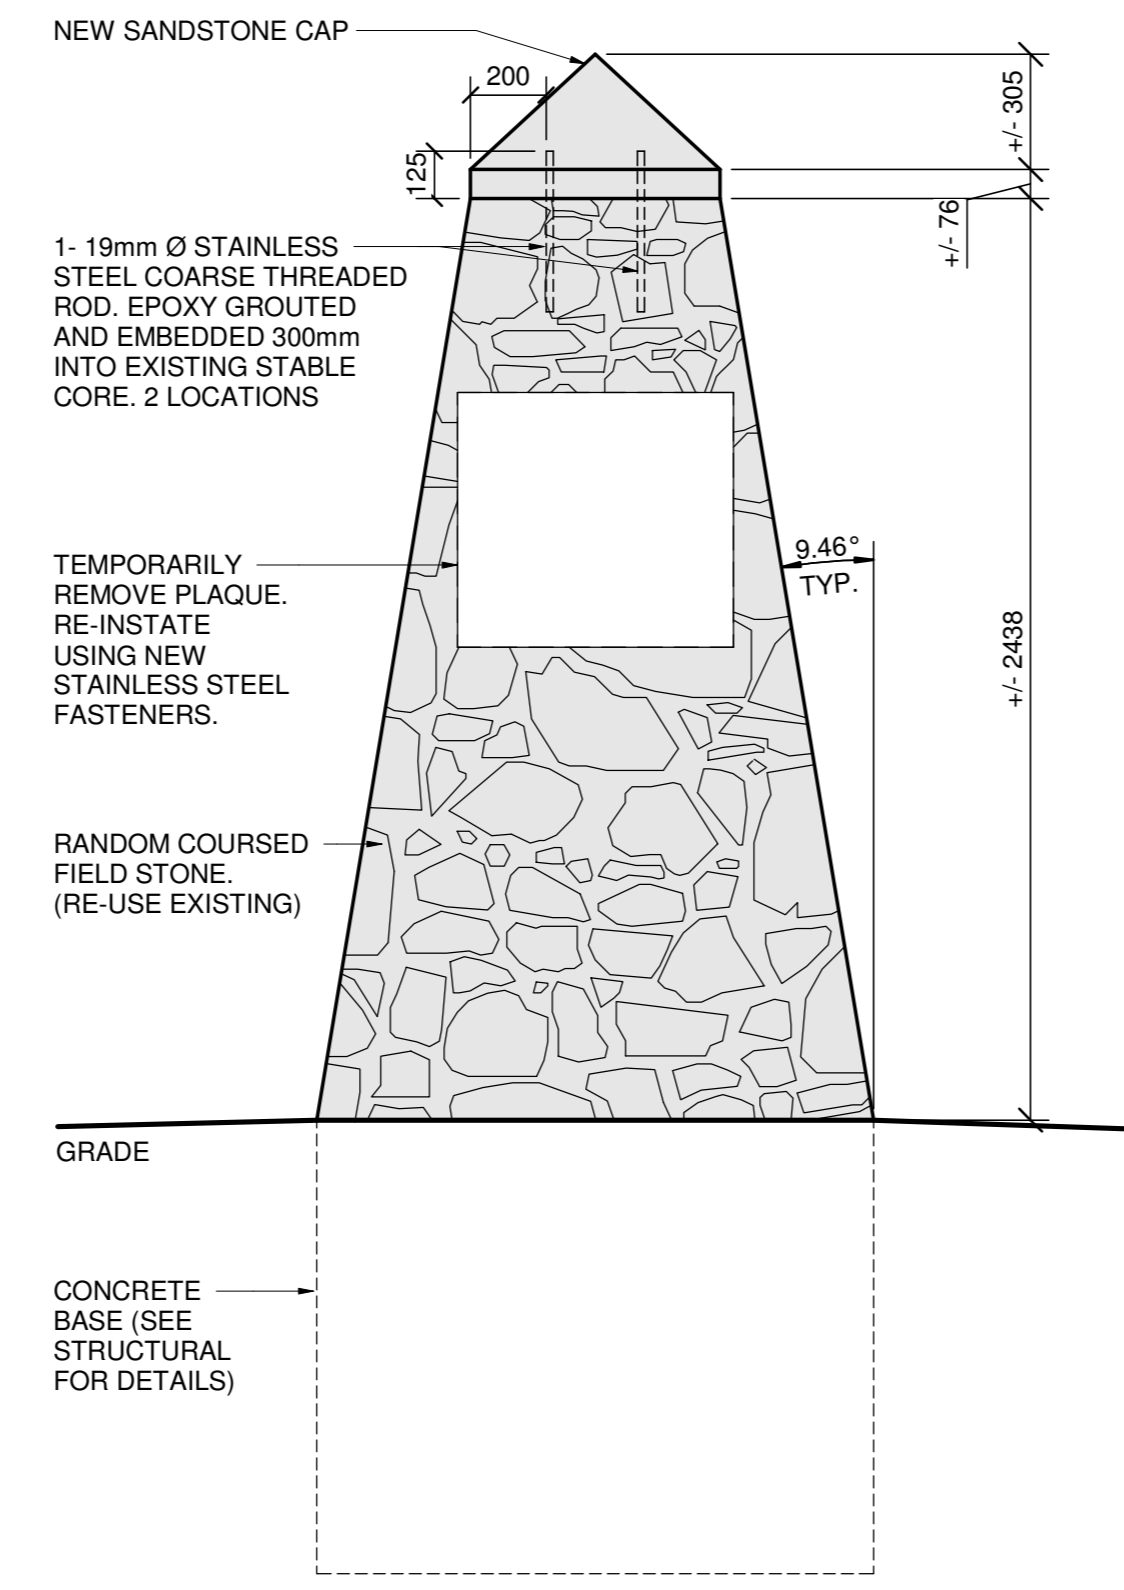


2 SOUTH (FRONT) ELEVATION
A904 1:20

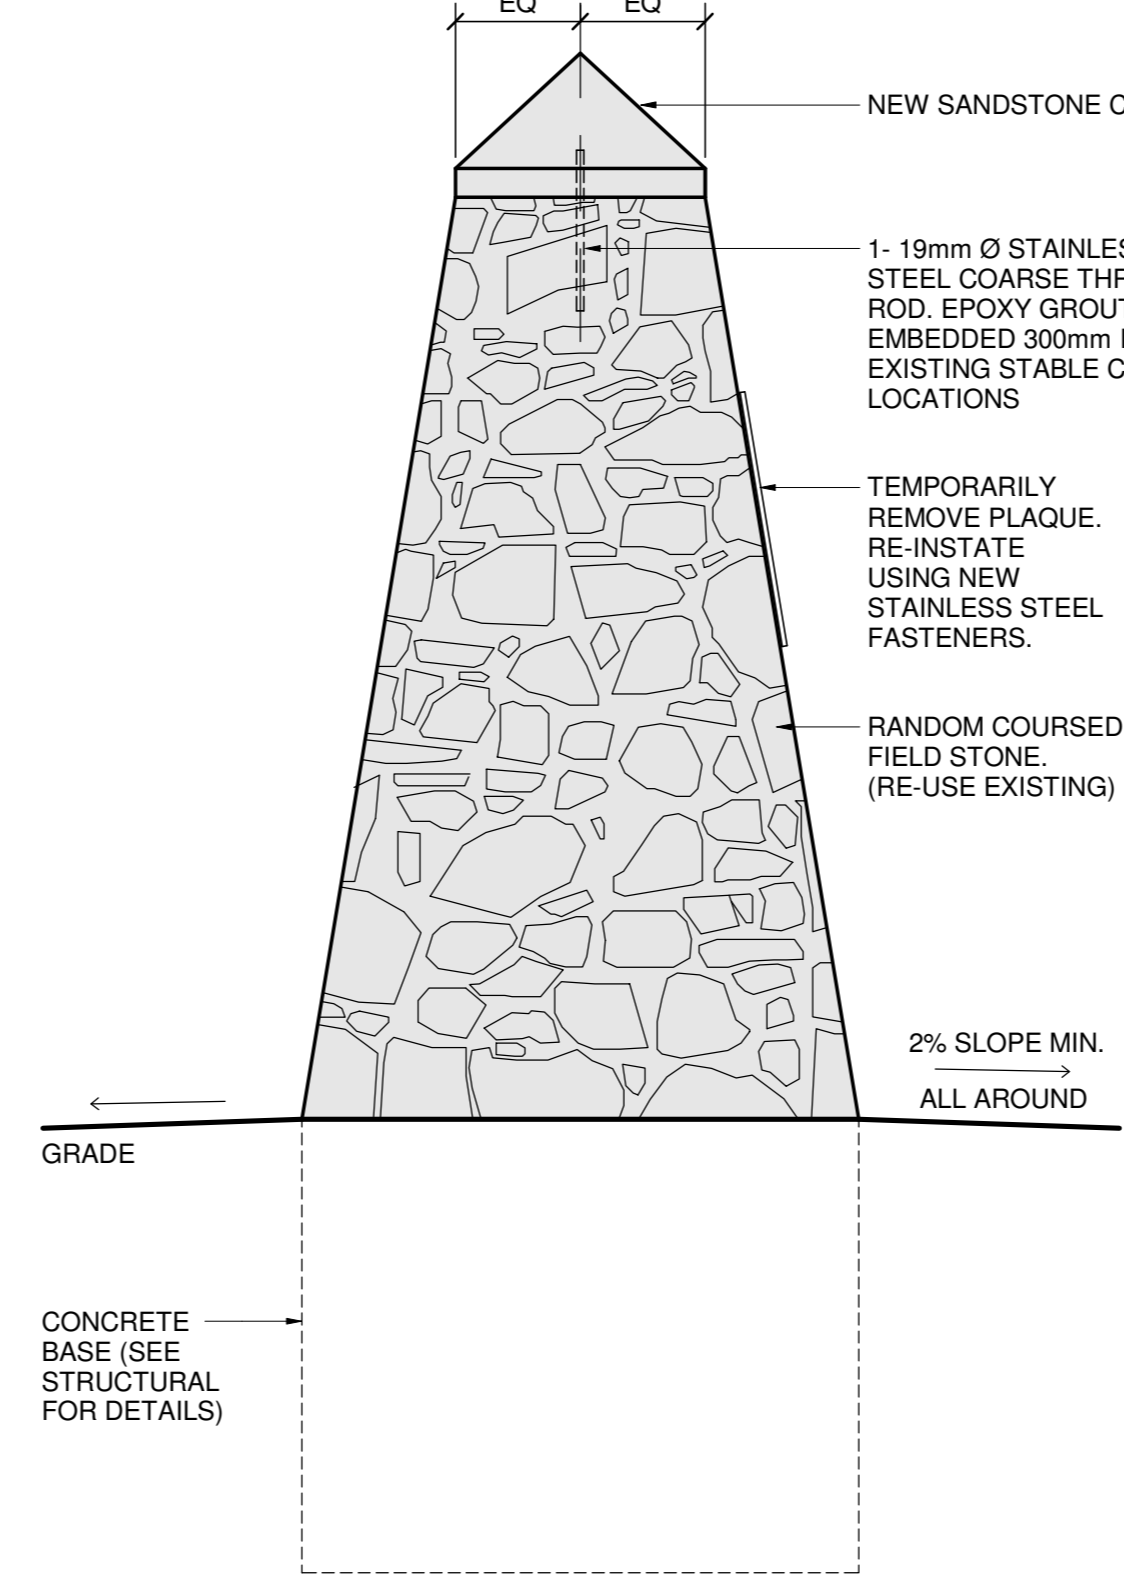

3 EAST ELEVATION
A904 1:20

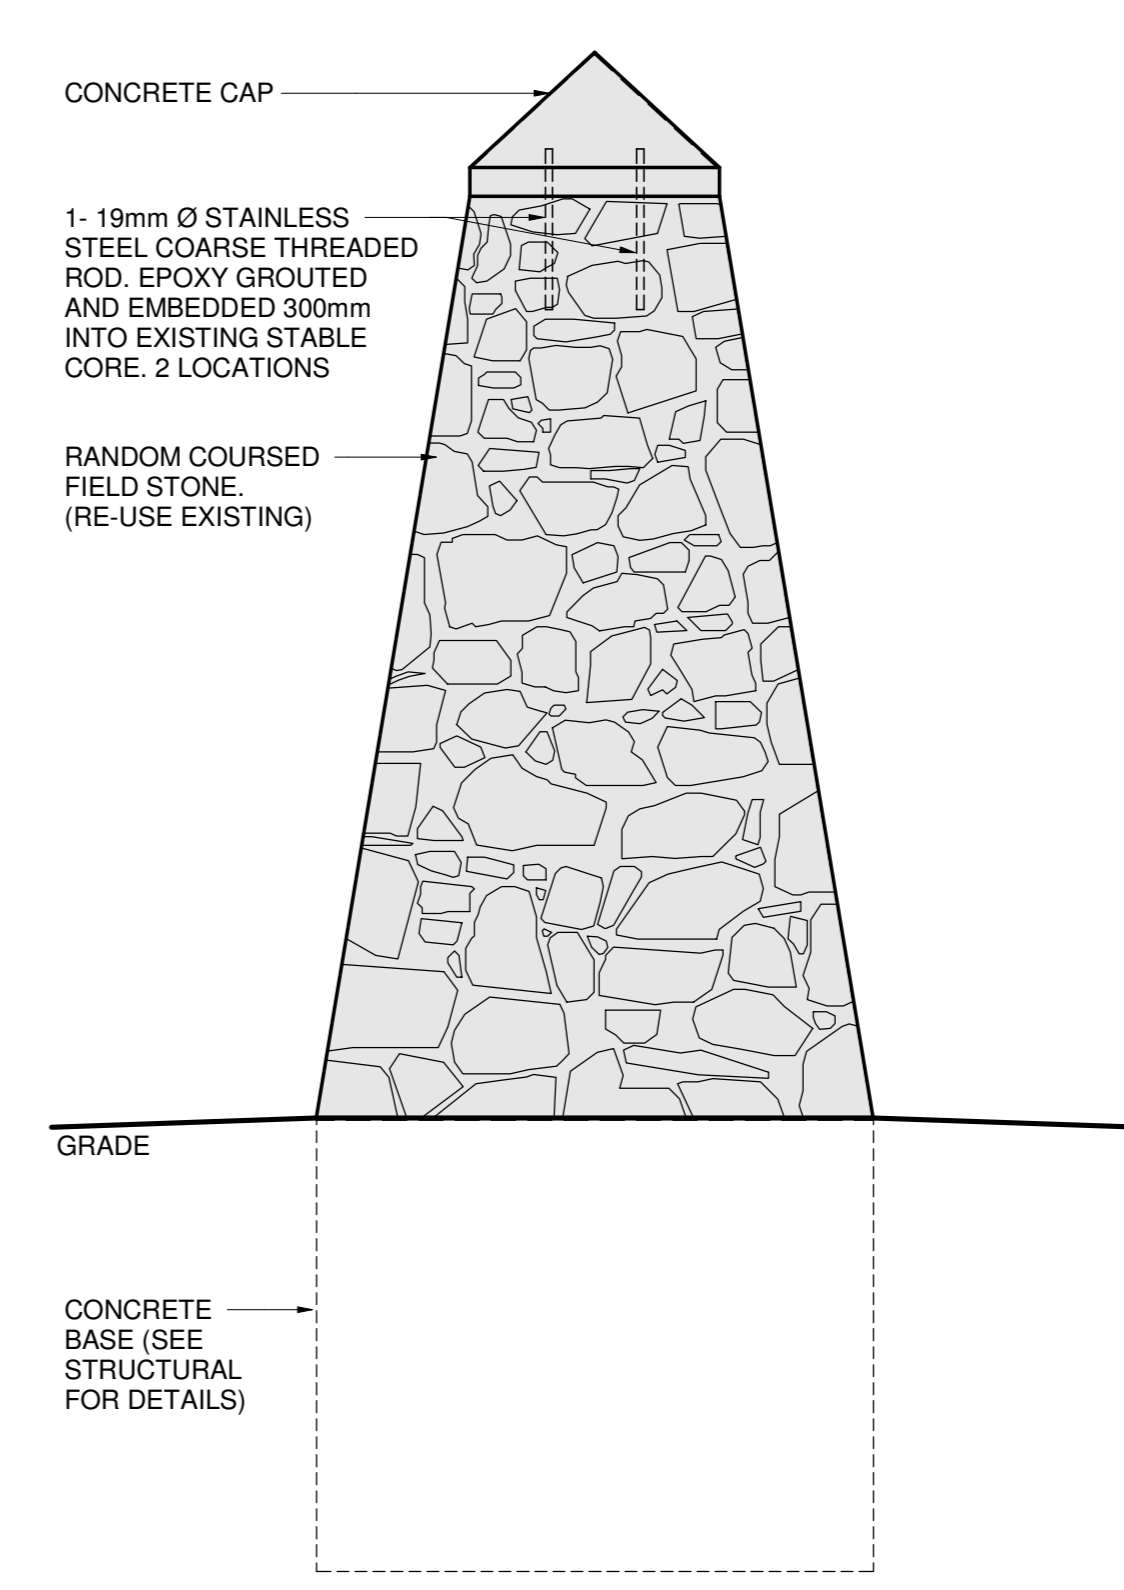

4 NORTH ELEVATION
A904 1:20

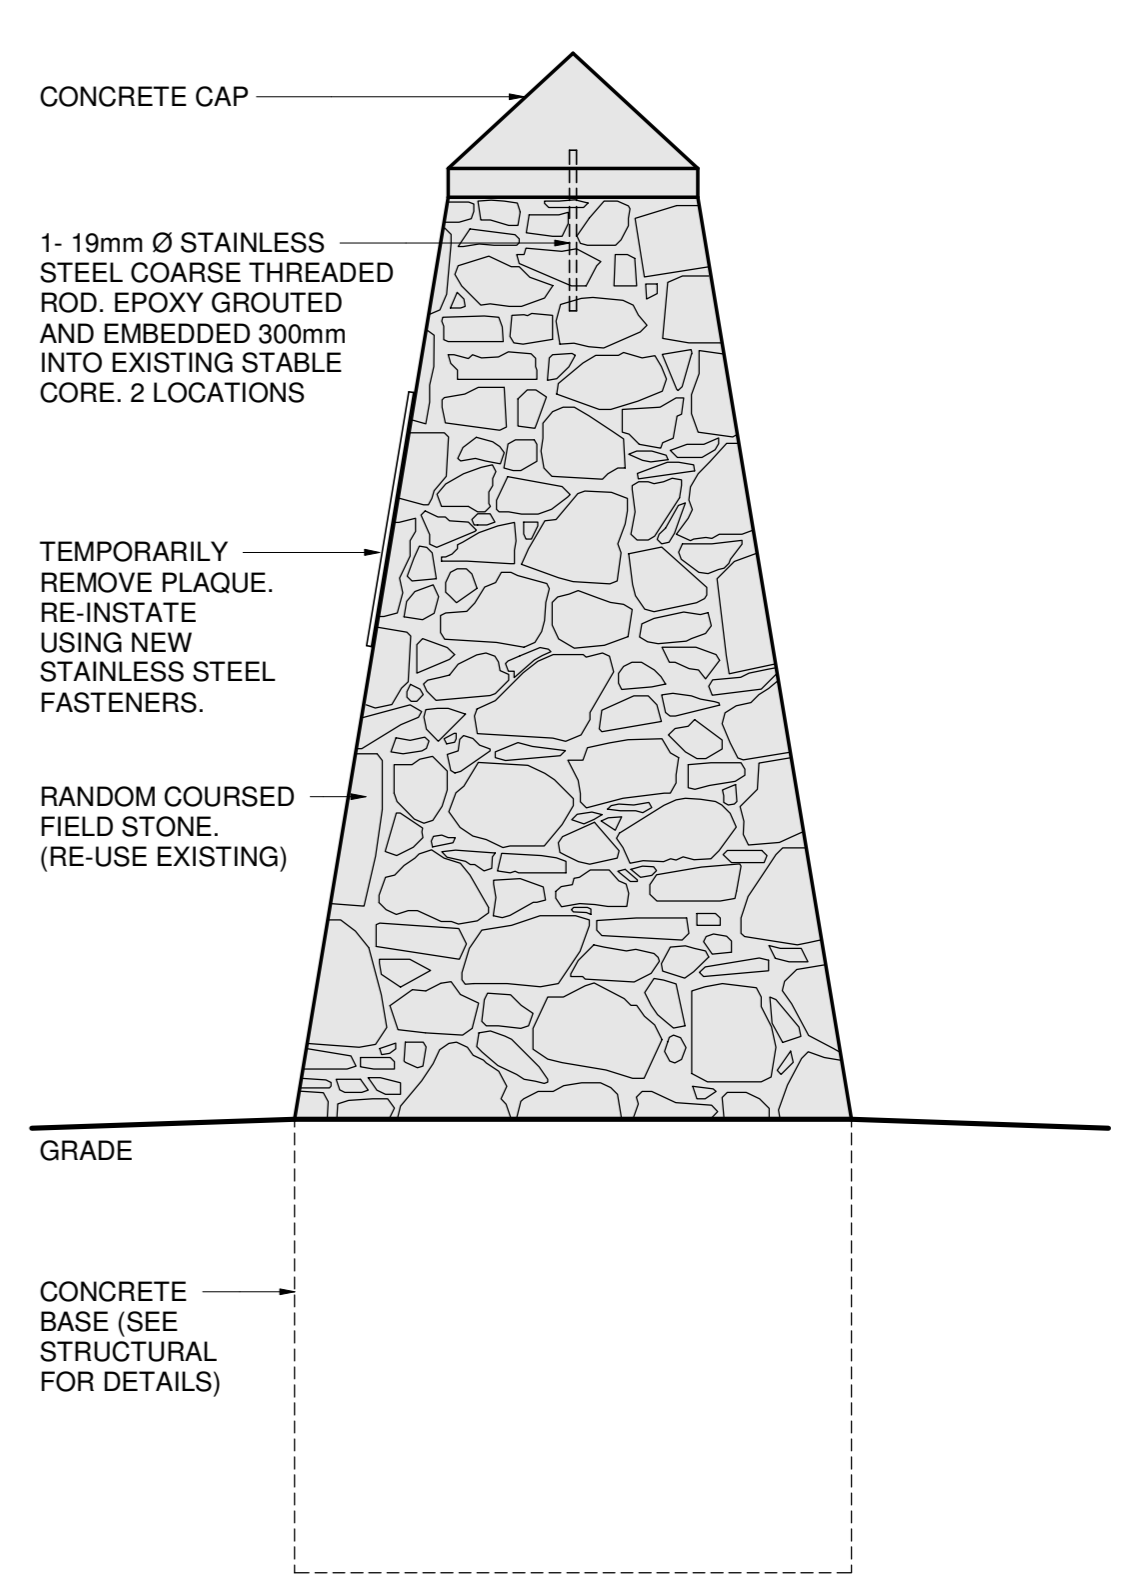

5 WEST ELEVATION
A904 1:20



EXISTING PHOTOS - PLANTERS MONUMENT



1	ISSUED FOR TENDER	03 APRIL 2020
revisions		date

project
**GRAND-PRÉ NATIONAL HISTORIC SITE
MEMORIAL CHURCH AND MONUMENTS
REPOINTING**

drawing
PLANTERS MONUMENT

designed MT
date 08/28/19
drawn LL/MG
date 08/28/19
approved KG
date 08/28/19

Tender
PWGSC Project Manager Administrateur de projets TPSCG
project number
1241

drawing no.
A904

